11-06-2020 LETTING ITEM 065

### STATE OF ILLINOIS

### **DEPARTMENT OF TRANSPORTATION**


A U SECTION COUNTY TOTAL SHEET SHEET SHEET SHEET SHEET SHEET NO 198 18-00517-00-TL WILL 72 1

FOR INDEX OF SHEETS, SEE SHEET NO. 2

### PLANS FOR PROPOSED FEDERAL AID HIGHWAY

F.A.U. 298 BLACK ROAD (C.H. 56)
IL RTE 59 (BROOK FOREST AVE) TO
U.S. RTE 30 (PLAINFIELD ROAD) / RAYNOR AVENUE
TRAFFIC SIGNAL MODERNIZATION AND
FIBER OPTIC COMMUNICATION SYSTEM
SECTION: 18-00517-00-TL
PROJECT NO.: 5XCE(712)
CITY OF JOLIET
WILL COUNTY

C-91-198-19

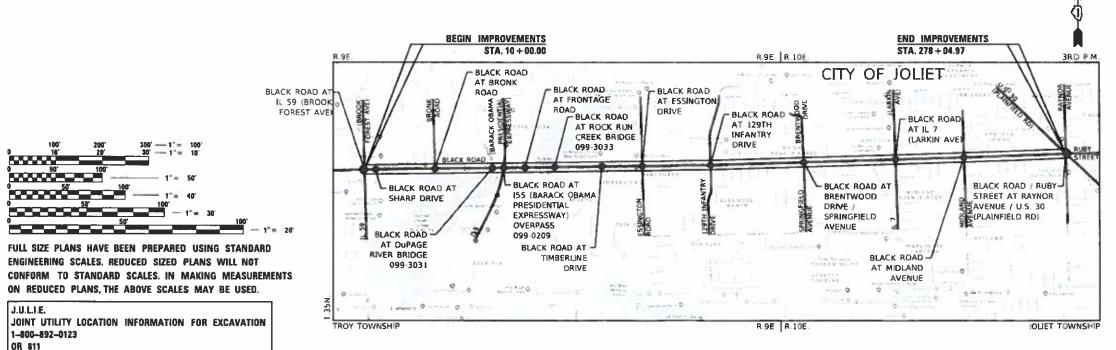

LOCATION OF SECTION INDICATED JU12 20, 2020 ILLINOIS LICENSE NO.: 062-055293 EXPIRATION DATE: NOVEMBER 30, 2021 DEPARTMENT OF TRANSPORTATION DISTRICT ONE ENGINEER OF LOCAL ROADS AND STREETS ALLOUS 27 20 20 andly Dright HOS

PRINTED BY THE AUTHORITY OF THE STATE OF ILLINOIS

PROJECT ENGINEER: ROSS J. HASEMAN, P.E. PROJECT MANAGER: DANIEL P. BRINKMAN, P.E.

LOCATION MAP

GROSS AND NET LENGTH = 26,805.97 FT. = 5.077 MILE

625 Forest Edge Drive • Vernon Hills, IL. 60061

Consulting Engineers & Surveyors

CONTRACT NO. 61G36

INEER: CARMEN E. RAMOS, P.E. SCHAUMBURG,

PROGRAM ENGINEER: CARM

AID

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### INDEX OF SHEETS: 2. GENERAL NOTES, INDEX OF SHEETS, AND HIGHWAY STANDARDS 3.-7. SUMMARY OF QUANTITIES 42. TRAFFIC SIGNAL MODERNIZATION PLAN - BLACK ROAD AT IL 59 (BROOK 8. FOREST AVE) 43. 9. CABLE PLAN, PHASE DESIGNATION DIAGRAM, AND EMERGENCY VEHICLE PREEMPTION SEOUENCE - BLACK ROAD AT IL 59 (BROOK FOREST AVE) 44. 10. TRAFFIC SIGNAL MODERNIZATION PLAN - BLACK ROAD AT SHARP DRIVE CABLE PLAN, PHASE DESIGNATION DIAGRAM, AND EMERGENCY VEHICLE 11. PREEMPTION SEQUENCE - BLACK ROAD AT SHARP DRIVE MAST ARM MOUNTED STREET NAME SIGNS AND SCHEDULE OF 12. QUANTITIES - BLACK ROAD AT SHARP DRIVE TRAFFIC SIGNAL MODERNIZATION PLAN - BLACK ROAD AT BRONK ROAD 13. 53. 14. CABLE PLAN, PHASE DESIGNATION DIAGRAM, AND EMERGENCY VEHICLE PREEMPTION SEQUENCE - BLACK ROAD AT BRONK ROAD 54. MAST ARM MOUNTED STREET NAME SIGNS AND SCHEDULE OF 15. 55 OUANTITIES - BLACK ROAD AT BRONK ROAD 16. TRAFFIC SIGNAL MODERNIZATION PLAN - BLACK ROAD AT EAST CABLE PLAN, PHASE DESIGNATION DIAGRAM, AND EMERGENCY VEHICLE 17. PREEMPTION SEQUENCE - BLACK ROAD AT EAST FRONTAGE ROAD MAST ARM MOUNTED STREET NAME SIGNS AND SCHEDULE OF 18. 59. QUANTITIES - BLACK ROAD AT FRONTAGE ROAD TRAFFIC SIGNAL MODERNIZATION PLAN - BLACK ROAD AT TIMBERLINE 19. CABLE PLAN, PHASE DESIGNATION DIAGRAM, AND EMERGENCY VEHICLE 20. PREEMPTION SEQUENCE - BLACK ROAD AT TIMBERLINE DRIVE 62 MAST ARM MOUNTED STREET NAME SIGNS AND SCHEDULE OF 21. OUANTITIES - BLACK ROAD AT TIMBERLINE DRIVE 22. TRAFFIC SIGNAL MODERNIZATION PLAN - BLACK ROAD AT ESSINGTON 63. CABLE PLAN, PHASE DESIGNATION DIAGRAM, AND EMERGENCY VEHICLE 23. PREEMPTION SEQUENCE - BLACK ROAD AT ESSINGTON ROAD 64 24. ADA GRADING PLAN - BLACK ROAD AT ESSINGTON ROAD 25. MAST ARM MOUNTED STREET NAME SIGNS AND SCHEDULE OF OUANTITIES - BLACK ROAD AT ESSINGTON ROAD 26. TRAFFIC SIGNAL MODERNIZATION PLAN - BLACK ROAD AT 129TH 27. CABLE PLAN PHASE DESIGNATION DIAGRAM AND EMERGENCY VEHICLE PREEMPTION SEQUENCE - BLACK ROAD AT 129TH INFANTRY DRIVE 28. ADA GRADING PLAN - BLACK ROAD AT 129TH INFANTRY DRIVE MAST ARM MOUNTED STREET NAME SIGNS AND SCHEDULE OF 29. QUANTITIES - BLACK ROAD AT 129TH INFANTRY DRIVE TRAFFIC SIGNAL MODERNIZATION PLAN - BLACK ROAD AT BRENTWOOD 30. DRIVE / SPRINGFIELD AVENUE CABLE PLAN, PHASE DESIGNATION DIAGRAM, AND EMERGENCY VEHICLE 31. PREEMPTION SEQUENCE - BLACK ROAD AT BRENTWOOD DRIVE / SPRINGFIELD AVENUE MAST ARM MOUNTED STREET NAME SIGNS AND SCHEDULE OF 32. QUANTITIES - BLACK ROAD AT BRENTWOOD DRIVE / 33. TRAFFIC SIGNAL MODERNIZATION PLAN - BLACK ROAD AT IL 7 (LARKIN 34. CABLE PLAN, PHASE DESIGNATION DIAGRAM, AND EMERGENCY VEHICLE PREEMPTION SEQUENCE - BLACK ROAD AT IL 7 (LARKIN AVE) 35. MAST ARM MOUNTED STREET NAME SIGNS AND SCHEDULE OF QUANTITIES - BLACK ROAD AT IL 7 (LARKIN AVE) 36. TRAFFIC SIGNAL MODERNIZATION PLAN - BLACK ROAD AT MIDLAND AVENUE

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39.-40.

HAMILTON TES, INC

GEWALT

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### INDEX OF SHEETS (CONT'D):

- 11. CABLE PLAN, PHASE DESIGNATION DIAGRAM, AND EMERGENCY VEHICLE PREEMPTION SEQUENCE BLACK ROAD / RUBY STREET AT RAYNOR AVENUE / U.S. 30 (PLAINFIELD RD)
- SCHEDULE OF QUANTITIES BLACK ROAD / RUBY STREET AT RAYNOR AVENUE / U.S. 30 (PLAINFIELD RD)
- INTERCONNECT JUNCTION BOX PLAN BLACK ROAD AT DUPAGE RIVER BRIDGE
- . INTERCONNECT JUNCTION BOX PLAN BLACK ROAD AT 155 BLACK ROAD (BARACK OBAMA PRESIDENTIAL EXPRESSWAY) OVERPASS
- 45. INTERCONNECT JUNCTION BOX PLAN BLACK ROAD AT ROCK RUN CREEK BRIDGE
  - BLACK ROAD INTERCONNECT PLAN AND PROFILE
- 47.-52. BLACK ROAD INTERCONNECT PLAN FROM IL 59 (BROOK FOREST AVE)
  TO U.S. 30 (PLAINFIELD RD) / RAYNOR AVENUE
- INTERCONNECT SCHEMATIC AND SCHEDULE OF QUANTITIES IDOT SYSTEMS 125 AND 142 / JOLIET SYSTEMS 1 AND 47
- 4. TRAFFIC CONTROL AND TRAFFIC STAGING SCHEMATIC STAGES 1 & 4
  - TRAFFIC CONTROL AND TRAFFIC STAGING SCHEMATIC STAGES 2 & 3
- LED ILLUMINATED SIGN DETAIL
  - BD-24 CURB OR CURB AND GUTTER REMOVAL AND REPLACEMENT
- 58. BE-1050 FIBER OPTIC INTERCONNECT CABINET
  - TC-8 ENTRANCE AND EXIT RAMP CLOSURE DETAILS
- 60. TC-9 TRAFFIC CONTROL DETAILS FOR FREEWAY SINGLE AND MULTI-LANE AND TC-10 TRAFFIC CONTROL AND PROTECTION FOR SIDE ROADS, INTERSECTIONS. AND DRIVEWAYS
- TC-13 DISTRICT ONE TYPICAL PAVEMENT MARKINGS
- TC-14 TRAFFIC CONTROL AND PROTECTION AT TURN BAYS (TO REMAIN OPEN TO TRAFFIC) AND TC-17 - TRAFFIC CONTROL DETAILS FOR FREEWAY SHOULDER CLOSURES AND PARTIAL RAMP CLOSURES
- TC-18 FREEWAY / EXPRESSWAY SIGNING FOR FLAGGING OPERATIONS AT WORK ZONE OPENINGS ON FREEWAYS / EXPRESSWAYS AND TC-22 - ARTERIAL ROAD INFORMATION SIGN
- 4. TC-25 TRAFFIC CONTROL DETAILS FOR FREEWAY CENTER LANE CLOSURE

PERPENDICULAR CLIRR RAMPS FOR SIDEWALKS

DIAGONAL CURB RAMPS FOR SIDEWALKS

- 65. TS-02 DISTRICT ONE MAST ARM MOUNTED STREET NAME SIGNS
- 66.-72. TS-05 DISTRICT ONE STANDARD TRAFFIC SIGNAL DESIGN DETAILS

### STATE STANDARDS:

424001-11

424006-04

424000-04	DIAGONAL CORD NAMES FOR SIDEWALKS
424011-04	CORNER PARALLEL CURB RAMPS FOR SIDEWALKS
424021-05	DEPRESSED CORNER FOR SIDEWALKS
701006-05	OFF-ROAD OPERATIONS, 2L, 2W, 15' (4.5 M) TO 24" (600 MM) FROM
	PAVEMENT EDGE
701011-04	OFF-ROAD MOVING OPERATIONS, 2L, 2W, DAY ONLY
701101-05	OFF-ROAD OPERATIONS, MULTILANE, 15' (4.5 M) TO 24" (600 MM)
	FROM PAVEMENT EDGE
701301-04	LANE CLOSURE, 2L, 2W, SHORT TIME OPERATIONS
701311-03	LANE CLOSURE, 2L, 2W MOVING OPERATIONS - DAY ONLY
701400-09	APPROACH TO LANE CLOSURE, FREEWAY/EXPRESSWAY
701401-12	LANE CLOSURE, FREEWAY/EXPRESSWAY
701402-12	LANE CLOSURE, FREEWAY/EXPRESSWAY, WITH BARRIER
701406-12	LANE CLOSURE, FREEWAY/EXPRESSWAY, DAY OPERATIONS ONLY
701411-09	LANE CLOSURE, MULTILANE, AT ENTRANCE OR EXIT RAMP, FOR
	SPEEDS ≥ 45 MPH
701416-11	LANE CLOSURE, FREEWAY/EXPRESSWAY, WITH CROSSOVER AND
	BARRIER
701426-09	LANE CLOSURE, MULTILANE, INTERMITTENT OR MOVING OPER., FOR
	SPEEDS ≥ 45 MPH
701427-05	LANE CLOSURE, MULTILANE, INTERMITTENT OR MOVING OPERATION,
	FOR SPEEDS ≤ 40 MPH
701428-01	TRAFFIC CONTROL, SETUP AND REMOVAL, FREEWAY/EXPRESSWAY
701446-10	TWO LANE CLOSURE, FREEWAY/EXPRESSWAY
701501-06	URBAN LANE CLOSURE, 2L, 2W, UNDIVIDED
701602-10	URBAN LANE CLOSURE, MULTILANE, 2W WITH BIDIRECTIONAL LEFT
	TURN LANE
701606-10	URBAN SINGLE LANE CLOSURE, MULTILANE, 2W WITH MOUNTABLE
	MEDIAN
701701-10	URBAN LANE CLOSURE, MULTILANE INTERSECTION
701801-06	SIDEWALK, CORNER OR CROSSWALK CLOSURE
701901-08	TRAFFIC CONTROL DEVICES

### **GENERAL NOTES (CONT'D):**

- 1. EASEMENTS FOR THE EXISTING UTILITIES, BOTH PUBLIC AND PRIVATE AND UTILITIES WITHIN PUBLIC RIGHTS-OF-WAY ARE SHOWN ON THE PLANS ACCORDING TO AVAILABLE RECORDS. THE CONTRACTOR SHALL BE RESPONSIBLE FOR DETERMINING THE EXACT LOCATION IN THE FIELD OF THESE UTILITY LINES AND THEIR PROTECTION FROM DAMAGE DUE TO CONSTRUCTION OPERATIONS. IF EXISTING UTILITY LINES OF ANY NATURE ARE ENCOUNTERED WHICH CONFLICT WITH NEW CONSTRUCTION, THE CONTRACTOR SHALL NOTIFY THE ENGINEER IMMEDIATELY SO THAT THE CONFLICT MAY BE RESOLVED.
- WHENEVER, DURING CONSTRUCTION OPERATIONS, ANY LOOSE MATERIAL IS DEPOSITED IN THE FLOW LINE OF GUTTERS, DRAINAGE STRUCTURES, DITCHES, ETC. SUCH THAT THE NATURAL FLOW LINE OF WATER IS OBSTRUCTED, THE LOOSE MATERIAL WILL BE REMOVED AT THE CLOSE OF EACH WORKING DAY. AT THE CONCLUSION OF CONSTRUCTION OPERATIONS, ALL DRAINAGE STRUCTURES AND FLOW LINES SHALL BE FREE FROM DIRT AND DEBRIS. THIS WORK SHALL BE CONSIDERED INCIDENTAL TO THE CONTRACT. THE CONTRACTOR'S FAILURE TO PROVIDE THE ABOVE WILL PRECLUDE ANY POSSIBLE ADDED COMPENSATION REQUESTED DUE TO DELAYS OR UNSUITABLE MATERIALS CREATED AS A RESULT THEREOF.
- 3. THE CONTRACTOR SHALL VERIFY ALL DIMENSIONS AND EXISTING CONDITIONS AFFECTING THEIR WORK WITH THE ACTUAL CONDITIONS AT THE JOB SITE PRIOR TO ORDERING MATERIALS. IN ADDITION, THE CONTRACTOR MUST VERIFY THE LINE AND GRADES. IF THERE ARE ANY DISCREPANCIES FROM WHAT IS SHOWN ON THE CONSTRUCTION PLANS, STANDARD SPECIFICATIONS AND/OR SPECIAL DETAILS, THE CONTRACTOR SHALL SECURE WRITTEN INSTRUCTION FROM THE ENGINEER PRIOR TO PROCEEDING WITH ANY PART OF THE WORK AFFECTED BY OMISSION OR DISCREPANCIES. FAILING TO SECURE SUCH INSTRUCTION, THE CONTRACTOR WILL BE CONSIDERED TO HAVE PROCEEDED AT HIS/HER OWN RISK AND EXPENSE AND NO ADDITIONAL COMPENSATION WILL BE PROVIDED FOR ANY COSTS INCURRED.
- ALL PAVEMENT DIMENSIONS ARE SHOWN TO EDGE OF PAVEMENT UNLESS OTHERWISE NOTED.
- 5. WHERE SECTION OR SUBSECTION MONUMENTS ARE ENCOUNTERED, THE ENGINEER SHALL BE NOTIFIED BEFORE THE MONUMENTS ARE REMOVED. THE CONTRACTOR SHALL CAREFULLY PRESERVE ALL PROPERTY MARKS AND MONUMENTS UNTIL THE OWNER, AUTHORIZED SURVEYOR OR AGENT HAS WITNESSED OR OTHERWISE REFERENCED THEIR LOCATION.
- 6. THE CONTRACTOR SHALL NOTIFY THE ENGINEER AT LEAST 72 HOURS PRIOR TO BEGINNING WORK.
- . THE CONTRACTOR SHALL PROVIDE TEMPORARY TOILET FACILITIES AND HAND SANITIZING STATIONS FOR THE USE OF ALL THE CONTRACTORS PERSONNEL EMPLOYED ON THE WORK SITE. THE FACILITIES SHALL BE MAINTAINED IN PROPER SANITARY CONDITION THROUGHOUT THE PROJECT. THE LOCATION OF THE TEMPORARY FACILITIES SHALL BE APPROVED BY THE ENGINEER.
- 8. THE CONTRACTOR IS RESPONSIBLE FOR COMPLYING WITH THE NPDES PERMIT AND SWPPP MANUAL. IF NO NPDES PERMIT OR SWPPP MANUAL IS NEEDED FOR THE PROJECT THE CONTRACTOR SHALL PERFORM SOIL EROSION SEDIMENT CONTROL BEST PRACTICES OR AS DIRECTED BY THE OWNER TO PREVENT ILLICIT DISCHARGES FROM THE SITE.
- THE CONTRACTOR SHALL CONTACT THE DISTRICT ONE TRAFFIC CONTROL SUPERVISOR FOR ARTERIALS AT KALPANA.KANNAN-HOSADURGA@ILLINOIS.GOV AT LEAST 72 HOURS BEFORE BEGINNING WORK.
- 10. THE CONTRACTOR SHALL REQUEST AND GAIN APPROVAL FROM THE ILLINOIS DEPARTMENT OF TRANSPORTATION'S EXPRESSWAY TRAFFIC OPERATIONS ENGINEER AT WWW.IDOTLCS.COM (24) HOURS IN ADVANCE OF ALL DAILY LANE, RAMP AND SHOULDER CLOSURES AND 7 DAYS IN ADVANCE OF ALL PERMANENT AND WEEKEND CLOSURES ON ALL FREEWAYS AND/OR EXPRESSWAYS IN DISTRICT ONE. THIS ADVANCE NOTIFICATION IS CALCULATED BASED ON WORKWEEK OF MONDAY THROUGH FRIDAY AND SHALL NOT INCLUDE WEEKENDS OR HOLIDAYS.

### UTILITY CONTACTS

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MICHAL ANN BEYKE
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VERIZON
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CHICAGO, IL 60661
(312) 612-5216
MARINO D. FERNANDEZ
mfernandez@telecom-eng.com

### STATE STANDARDS (CONT'D):

720016-04	MAST ARM MOUNTED STREET NAME SIGNS
780001-05	TYPICAL PAVEMENT MARKING
814001-03	HANDHOLES
857001-01	STANDARD PHASE DESIGNATION DIAGRAMS AND PHASE SEQUENCES
862001-01	UNINTERRUPTABLE POWER SUPPLY (UPS)
873001-02	TRAFFIC SIGNAL GROUNDING & BONDING
876001-04	PEDESTRIAN PUSH BUTTON POST
878001-10	CONCRETE FOUNDATION DETAILS
880006-01	TRAFFIC SIGNAL MOUNTING DETAILS

FIRER OPTIC INTERCONNECT CARINE

### **DISTRICT ONE DETAILS:**

BD-24

BF-1050

DE-1030	FIBER OF TIC INTERCONNECT CABINET
TC-8	ENTRANCE AND EXIT RAMP CLOSURE DETAILS
TC-9	TRAFFIC CONTROL DETAILS FOR FREEWAY SINGLE AND MULTI-LANE WEAVE
TC-10	TRAFFIC CONTROL AND PROTECTION FOR SIDE ROADS, INTERSECTIONS, AND DRIVEWAYS
TC-13	DISTRICT ONE TYPICAL PAVEMENT MARKINGS
TC-14	TRAFFIC CONTROL AND PROTECTION AT TURN BAYS (TO REMAIN OPEN TO TRAFFIC)
TC-17	TRAFFIC CONTROL DETAILS FOR FREEWAY SHOULDER CLOSURES AND PARTIAL RAMP CLOSURES
TC-18	FREEWAY / EXPRESSWAY SIGNING FOR FLAGGING OPERATIONS AT WORK ZONE OPENINGS ON FREEWAYS / EXPRESSWAYS
TC-22	ARTERIAL ROAD INFORMATION SIGN
TC-25	TRAFFIC CONTROL DETAILS FOR FREEWAY CENTER LANE CLOSURE SHOULDER LANE
TS-02	MAST ARM MOUNTED STREET NAME SIGNS
TS-05	STANDARD TRAFFIC SIGNAL DESIGN DETAILS

CURB OR CURB AND GUTTER REMOVAL AND REPLACEMENT

ILE NAME . DESIGNED . DPB REVISED -USER NAME = zwallsten dex\_Gennote,dgr DRAWN ZCW REVISED 2 388.800 PLOT SCALE = 1:20 HECKED DPB REVISED . PLOT DATE = 9/15/2020 DATE 8/21/2020 REVISED -

CABLE PLAN, PHASE DESIGNATION DIAGRAM, AND EMERGENCY VEHICLE PREEMPTION SEQUENCE - BLACK ROAD AT MIDLAND AVENUE

MAST ARM MOUNTED STREET NAME SIGNS AND SCHEDULE OF

TRAFFIC SIGNAL MODERNIZATION PLAN - BLACK ROAD / RUBY STREET

QUANTITIES - BLACK ROAD AT MIDLAND AVENUE

AT RAYNOR AVENUE / U.S. 30 (PLAINFIELD RD)

STATE OF ILLINOIS
DEPARTMENT OF TRANSPORTATION

GENERAL NOTES, INDEX OF SHEETS, AND HIGHWAY STANDARDS
BLACK ROAD INTERCONNECT

SCALE: None SHEET OF SHEETS STA. TO STA.

F.A. U. RECTION COUNTY SHEETS SHEETS NO.
298 18-00517-00-TL WILL 72 2

CONTRACT NO. 61G36

BLACK ROAD INTERCONNECT - BLACK BLACK ROAD BLACK ROAD / LOCATION BLACK ROAD BLACK ROAD BLACK ROAD BLACK ROAD ΑT BLACK ROAD BLACK ROAD RUBY STREET ROAD FROM IL 59 BLACK ROAD ΑT AT IL 7 AT U.S. 30 OF AT АТ AT ΑT ΑT 129TH INFANTRY BRENTWOOD DRIVE / ΑT (BROOK FOREST AVE) SUMMARY OF QUANTITIES WORK TO U.S. 30 (PLAINFIELD SHARP DRIVE BRONK DRIVE FRONTAGE ROAD ESSINGTON ROAD (LARKIN DRIVE) (PLAINFIELD RD) / TIMBERLINE DRIVE DRIVE SPRINGFIELD MIDLAND AVENUE RAYNOR AVENUE RD) / RAYNOR AVENUE AVENUE TRAFFIC SIGNALS TRAFFIC SIGNALS INTERCONNECT TYPE TRAFFIC SIGNALS SP CODE NO ITEM UNIT TOTAL 20200100 EARTH EXCAVATION CU YD 5 21301072 EXPLORATION TRENCH 72" DEPTH FOOT 100 42400200 PORTLAND CEMENT CONCRETE SIDEWALK 5 INCH 165 175 SQ FT 42400800 DETECTABLE WARNINGS 32 16 16 SQ FT 44000600 SIDEWALK REMOVAL 315 165 150 CU YD 22 66900200 NON-SPECIAL WASTE DISPOSAL 22 EACH 66900530 SOIL DISPOSAL ANALYSIS 13 13 66901001 REGULATED SUBSTANCES PRE-CONSTRUCTION PLAN LSUM 1 Y 66901003 REGULATED SUBSTANCES FINAL CONSTRUCTION LSUM 1 66901006 REGULATED SUBSTANCES MONITORING CAL DA 10 10 67000500 ENGINEER'S FIELD OFFICE, TYPE B 12 12 SHT NO. 67100100 MOBILIZATION L SUM 1 Z 70102620 TRAFFIC CONTROL AND PROTECTION, STANDARD 701501 L SUM 1 70102625 TRAFFIC CONTROL AND PROTECTION, STANDARD 701606 L SUM 1 1 \* CONSTRUCTION CODE 0042 \* SPECIALTY ITEM DESIGNED - DPB REVISED -SECTION SCHEDULE OF QUANTITIES STATE OF ILLINOIS

E A GEWALT HAMILTON ASSOCIATES, INC.

5388.800

DRAWN -ZCW REVISED -PLOT SCALE = 1:40 CHECKED - DPB REVISED -PLOT DATE = 9/16/2020 DATE - 8/21/2020 REVISED -

**DEPARTMENT OF TRANSPORTATION** 

**BLACK ROAD INTERCONNECT** SCALE: None SHEET OF SHEETS STA.

TO STA.

COUNTY TOTAL SHEET NO.
WILL 72 3 298 CONTRACT NO. 61G36

SUMMARY OF QUANTITIES WORK SHARP DRIVE BRONK DRIVE FRONTAGE ROAD ESSINGTON ROAD TIMBERLINE DRIVE DRIVE (LARKIN DRIVE) MIDLAND AVENUE (PLAINFIELD RD) / TO U.S. 30 (PLAINFIELD SPRINGEIELD. AVENUE RAYNOR AVENUE RD) / RAYNOR AVENUE TYPE TRAFFIC SIGNALS INTERCONNECT TRAFFIC SIGNALS SP CODE NO ITEM UNIT TOTAL 70102632 TRAFFIC CONTROL AND PROTECTION, STANDARD 701602 L SUM 70102635 TRAFFIC CONTROL AND PROTECTION, STANDARD 701701 L SUM 70102640 TRAFFIC CONTROL AND PROTECTION, STANDARD 701801 L SUM 1.00 72400310 REMOVE SIGN PANEL - TYPE 1 SQ FT 131.25 13.5 30 20.25 30 37.5 SQ FT 35 72400320 REMOVE SIGN PANEL - TYPE 2 35 FOOT 335 78000400 THERMOPLASTIC PAVEMENT MARKING - LINE 6" 335 78000600 THERMOPLASTIC PAVEMENT MARKING - LINE 12" FOOT 378 378 81028200 UNDERGROUND CONDUIT, GALVANIZED STEEL, 2" DIA. FOOT 21,437 21,437 81028220 UNDERGROUND CONDUIT, GALVANIZED STEEL, 3" DIA. FOOT 130 36 10 30 54 81028240 UNDERGROUND CONDUIT, GALVANIZED STEEL, FOOT 164 164 CONDUIT ATTACHED TO STRUCTURE, 2" DIA., GALVANIZED STEEL FOOT 81100600 522 522 SHT NO. 81300720 JUNCTION BOX, STAINLESS STEEL, ATTACHED TO STRUCTURE, 16" X 12" X 8" EACH 6 6 Z 81400100 HANDHOLE EACH 38 38 85000200 MAINTENANCE OF EXISTING TRAFFIC SIGNAL INSTALLATION EACH 12 1 1 1 1 2 1 1 1 1 \* SPECIALTY ITEM \* CONSTRUCTION CODE 0042 USER NAME = zwalisten DESIGNED - DPB REVISED -SECTION SCHEDULE OF QUANTITIES

BLACK ROAD

ΑТ

BLACK ROAD

ΑT

BLACK ROAD

ΑT

129TH INFANTRY

BLACK ROAD

AT

BRENTWOOD DRIVE /

BLACK ROAD

AT IL 7

BLACK ROAD

ΑT

E AN GEWALT HAMILTON ASSOCIATES, INC.

DRAWN - ZCW REVISED -PLOT SCALE = 1:20 CHECKED - DPB REVISED . PLOT DATE = 9/15/2020 DATE - 8/21/2020 REVISED -

LOCATION

OF

BLACK ROAD

ΑТ

BLACK ROAD

ΑT

BLACK ROAD

ΑT

STATE OF ILLINOIS **DEPARTMENT OF TRANSPORTATION** 

**BLACK ROAD INTERCONNECT** SCALE: None SHEET OF SHEETS STA. TO STA.

COUNTY TOTAL SHEET NO.
WILL 72 4 CONTRACT NO. 61G36

BLACK ROAD /

RUBY STREET

AT U.S. 30

INTERCONNECT - BLACK

ROAD FROM IL 59

(BROOK FOREST AVE)

BLACK ROAD BLACK ROAD BLACK ROAD / INTERCONNECT - BLACK LOCATION BLACK ROAD BLACK ROAD BLACK ROAD BLACK ROAD BLACK ROAD AT ΑT BLACK ROAD BLACK ROAD RUBY STREET ROAD FROM IL 59 OF ΑT ΑT ΑT ΑT AT 129TH INFANTRY BRENTWOOD DRIVE AT IL 7 ΑT AT U.S. 30 (BROOK FOREST AVE) SUMMARY OF QUANTITIES WORK SHARP DRIVE BRONK DRIVE FRONTAGE ROAD TIMBERLINE DRIVE ESSINGTON ROAD SPRINGFIELD (LARKIN DRIVE) (PLAINFIELD RD) / DRIVE MIDLAND AVENUE TO U.S. 30 (PLAINFIELD RAYNOR AVENUE RD) / RAYNOR AVENUE AVENUE TYPE TRAFFIC SIGNALS INTERCONNECT SP CODE NO ITEM UNIT TOTAL 86400100 TRANSCEIVER - FIBER OPTIC EACH 87300925 ELECTRIC CABLE IN CONDUIT, TRACER, NO. 14 1C FOOT 28,013 28,013 87301215 ELECTRIC CABLE IN CONDUIT, SIGNAL NO. 14 2C FOOT 3,503 65 701 842 869 1,026 87301225 ELECTRIC CABLE IN CONDUIT, SIGNAL NO. 14 3C FOOT 1,372 724 648 87301245 ELECTRIC CABLE IN CONDUIT, SIGNAL NO. 14 5C FOOT 458 458 87301255 ELECTRIC CABLE IN CONDUIT, SIGNAL NO. 14 7C FOOT 156 87502480 TRAFFIC SIGNAL POST, GALVANIZED STEEL 14 FT. EACH 1 EACH 87502500 TRAFFIC SIGNAL POST, GALVANIZED STEEL 16 FT. 1 87900200 DRILL EXISTING HANDHOLE EACH 31 2 2 5 18 88030020 SIGNAL HEAD, LED, 1-FACE, 3-SECTION, MAST-ARM MOUNTED EACH 14 4 3 7 88030050 SIGNAL HEAD, LED, 1-FACE, 3-SECTION, BRACKET MOUNTED EACH 12 4 5 3 88030100 SIGNAL HEAD, LED, 1-FACE, 5-SECTION, BRACKET MOUNTED EACH 6 4 1 1 88030110 SIGNAL HEAD, LED, 1-FACE, 5-SECTION, MAST-ARM MOUNTED EACH 4 6 1 1 88102717 PEDESTRIAN SIGNAL HEAD, LED, 1-FACE, BRACKET MOUNTED WITH COUNTDOWN TIMER EACH 34 6 4 8 8 \* SPECIALTY ITEM CONSTRUCTION CODE 0042 USER NAME ■ zwa#sten DESIGNED - DPB REVISED -

SHT NO. TS G I LA GEWALT HAMILTON

500,dgn 5388,800

DRAWN - ZCW PLOT SCALE = 1:20 CHECKED - DPB

PLOT DATE # 9/15/2020

REVISED -

DATE - 8/21/2020

REVISED .

REVISED .

STATE OF ILLINOIS **DEPARTMENT OF TRANSPORTATION** 

SCHEDULE OF QUANTITIES **BLACK ROAD INTERCONNECT** SCALE: None SHEET OF SHEETS STA, TO STA.

COUNTY SHEETS NO.

WILL 72 5 SECTION CONTRACT NO. 61G36

LOCATION BLACK ROAD BLACK ROAD BLACK ROAD BLACK ROAD BLACK ROAD ΑT ΑT BLACK ROAD BLACK ROAD RUBY STREET ROAD FROM IL 59 OF ΑT ΑT ΑT AT AT 129TH INFANTRY BRENTWOOD DRIVE AT IL 7 AT AT U.S. 30 (BROOK FOREST AVE) SUMMARY OF QUANTITIES WORK SHARP DRIVE BRONK DRIVE FRONTAGE ROAD TIMBERLINE DRIVE ESSINGTON ROAD SPRINGFIELD (LARKIN DRIVE) MIDLAND AVENUE (PLAINFIELD RD) / TO U.S. 30 (PLAINFIELD AVENUE RAYNOR AVENUE RD) / RAYNOR AVENUE TYPE TRAFFIC SIGNALS INTERCONNECT SP CODE NO ITEM UNIT TOTAL TRAFFIC SIGNAL BACKPLATE, LOUVERED, FORMED PLASTIC EACH 20 8 4 88800100 PEDESTRIAN PUSH-BUTTON EACH 34 8 8 89501410 RELOCATE EXISTING EMERGENCY VEHICLE PRIORITY SYSTEM, PHASING UNIT EACH 89502200 MODIFY EXISTING CONTROLLER EACH 1 1 1 89502210 MODIFY EXISTING CONTROLLER CABINET EACH 1 1 1 1 EACH 89502215 MODIFY EXISTING CONTROLLER FOUNDATION 2 1 1 89502375 REMOVE EXISTING TRAFFIC SIGNAL EQUIPMENT EACH 5 1,00 1.00 1.00 1 1.00 EACH 89502376 REBUILD EXISTING HANDHOLE 1 1 X0324599 ROD AND CLEAN EXISTING CONDUIT FOOT 800 800 X0327698 LED INTERNALLY ILLUMINATED STREET NAME SIGN EACH 23 3 4 4 4 4 X0327980 PAVEMENT MARKING REMOVAL - WATER BLASTING SQ FT 176 170 6 SHT NO. X1400081 FULL-ACTUATED CONTROLLER AND TYPE SUPER P CABINET (SPECIAL) EACH 2 1 1 X1400367 PEDESTRIAN SIGNAL POST, 10 FT. EACH 1 X1400378 PEDESTRIAN SIGNAL POST, 5 FT. EACH 8 2 2 4 \* CONSTRUCTION CODE 0042 DESIGNED - DPB REVISED -SECTION

CENALI HAMILTON TS SHT NO.

FILE NAME = SOO.dgn 
5388.800 
Sheet 4

 USER NAME
 = zwallsten
 DESIGNED
 DPB
 REVISED

 PLOT SCALE
 = 1:20
 CHECKED
 DPB
 REVISED

 PLOT DATE
 = 9/15/2020
 DATE
 8/21/2020
 REVISED

STATE OF ILLINOIS
DEPARTMENT OF TRANSPORTATION

SCHEDULE OF QUANTITIES
BLACK ROAD INTERCONNECT

SCALE: None SHEET OF SHEETS STA.

TO STA.

BLACK ROAD

BLACK ROAD

BLACK ROAD /

INTERCONNECT - BLACK

	*
NO. 7	**
TS SHT NO.7	*
TS	
GEWALT HAMILTON ASSOCIATES, INC.	
	F.
911/	5
	د


		SUMMARY OF QUANTITIES	W	ATION OF ORK	BLACK ROAD AT SHARP DRIVE	BLACK ROAD AT BRONK DRIVE	BLACK ROAD AT FRONTAGE ROAD	BLACK ROAD AT TIMBERLINE DRIVE	BLACK ROAD AT ESSINGTON ROAD	BLACK ROAD AT 129TH INFANTRY DRIVE	BLACK ROAD AT BRENTWOOD DRIVE / SPRINGFIELD AVENUE	BLACK ROAD AT IL 7 (LARKIN DRIVE)	BLACK ROAD AT MIDLAND AVENUE	BLACK ROAD / RUBY STREET AT U.S. 30 (PLAINFIELD RD) / RAYNOR AVENUE	INTERCONNECT - BLACE ROAD FROM IL 59 (BROOK FOREST AVE) TO U.S. 30 (PLAINFIELD RD) / RAYNOR AVENUE
SP	CODE NO	ITEM		YPE TOTAL	TRAFFIC SIGNALS	TRAFFIC SIGNALS	TRAFFIC SIGNALS	TRAFFIC SIGNALS	TRAFFIC SIGNALS	TRAFFIC SIGNALS	TRAFFIC SIGNALS	TRAFFIC SIGNALS	TRAFFIC SIGNALS	TRAFFIC SIGNALS	INTERCONNECT
-	10002 110		01411	TOTAL											
		ELECTRIC CARLE IN CONDUIT STREET NAME SIGN													
Y	X1400424	ELECTRIC CABLE IN CONDUIT, STREET NAME SIGN, NO. 14 3C, TYPE SOOW	FOOT	4,079		594	801		735	742	586		621		
Y	X4400220	CURB REMOVAL AND REPLACEMENT	FOOT	34					17	17					
		TRAFFIC CONTROL AND PROTECTION													
Y	X7011015	TRAFFIC CONTROL AND PROTECTION (EXPRESSWAYS)	L SUM	1											1
Y	X7240500	RELOCATE EXISTING SIGNS	EACH	2											
	X7240300	NELOCATE EXISTING SIGNS	EACH	2							2				
Y	X7330064	SIGN SUPPORT SPECIAL	EACH	1		1									
				-		-									
Y	X8620200	UNINTERRUPTABLE POWER SUPPLY, SPECIAL	EACH	5		1	1			1	1		1		
Y	X8710024	FIBER OPTIC CABLE IN CONDUIT, NO. 62.5/125, MM12F SM24F	FOOT	28,013											28,013
Y	X8780010	CONCRETE FOUNDATION, TYPE A 10-INCH DIAMETER	FOOT	36				8	8		4		16		
Y	Z0013798	CONSTRUCTION LAYOUT	L SUM	1			,								1
Y	Z0030850	TEMPORARY INFORMATION SIGNING	SQ FT	52											52
Y	Z0076600	TRAINEES	HOUR	500											
Y															
Y	Z0076604	TRAINEES TRAINING PROGRAM GRADUATE	HOUR	500											
	* SPECIAL	Y ITEM * CONSTRUCTION CODE 0042					:								

FILE NAME	USER NAME = zwallsten	DESIGNED -	DPB	REVISED -
SOO,dgn		DRAWN -	ZCW	REVISED -
5388,800	PLOT SCALE = 1;20	CHECKED .	DPB	REVISED -
Sheet 5	PLOT DATE = 9/15/2020	DATE -	8/21/2020	REVISED -


STATE	OF ILLINOIS	
DEPARTMENT	OF TRANSPORTATION	

SCHEDULE OF QUANTITIES BLACK ROAD INTERCONNECT							

RTE.	SECTION	COUNTY	SHEETS	NO,	
298	18-00517-00-T	L	WILL	72	7
		CONTRACT	NO. 6	1G36	
	ILLINOIS	D PROJECT			

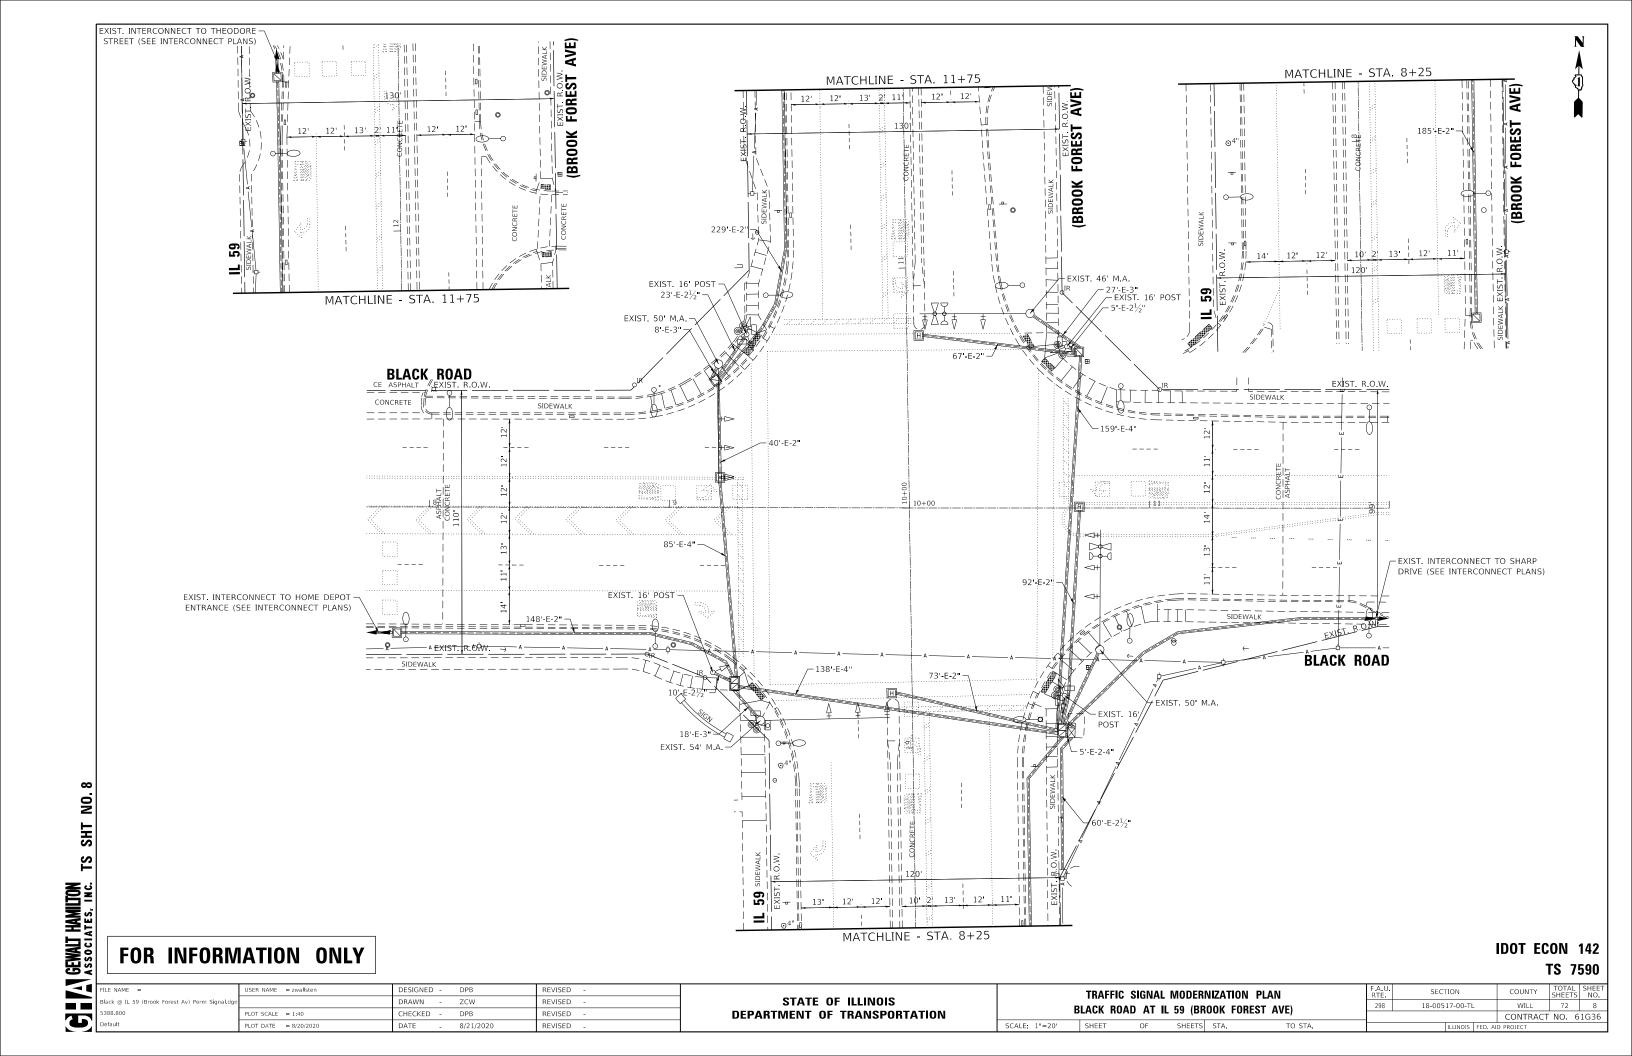



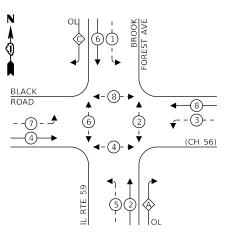

### LEGEND:

**★** PROTECTED PHASE

← -(\*)- - PROTECTED/PERMITTED PHASE


√-(\*)- PEDESTRIAN PHASE

OVERLAP OVERLAP

### **RIGHT TURN OVERLAP**

OVERLAP		PERMISSIVE		PROTECTED
LETTER		PHASE		PHASE
A	=	2	+	3
C	=	6	+	7

### **EXISTING EMERGENCY VEHICLE** PREEMPTION SEQUENCE

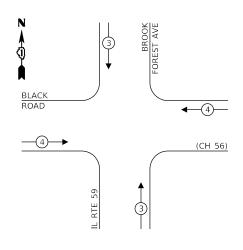

### TRAFFIC SIGNAL **ELECTRICAL SERVICE REQUIREMENTS** NO. OF LED % TOTAL

	TYPE	LAMPS	WATTAGE	OPERATION	WATTAGE
	SIGNAL (RED)	20	11	50	110
	(YELLOW)	20	20	5	20
	(GREEN)	20	12	45	108
	PERMISSIVE ARROW	24	10	10	24
,	PED. SIGNAL	8	20	100	160
:	CONTROLLER	1	100	100	100
;	UPS	1	25	100	25
•	VIDEO SYSTEM	-	150	100	=
	BLANK-OUT SIGN	-	25	5	=
5	FLASHER	-	-	50	•
	STREET NAME SIGN	4	120	50	240
•	LUMINAIRE	-	250	50	-
				TOTAL =	787

ENERGY COSTS TO:

### VILLAGE OF SHOREWOOD

ONE TOWNE CENTER BOULEVARD

SHOREWOOD, IL 60404

ENERGY SUPPLY: CONTACT: TIM COSLET PHONE: (815) 724-5010

COMPANY: COM-ED

ACCOUNT NUMBER:

JSER NAME = zwallsten DESIGNED - DPB REVISED ORAWN -ZCW REVISED HECKED REVISED PLOT DATE = 8/20/2020 8/21/2020 REVISED

STATE OF ILLINOIS **DEPARTMENT OF TRANSPORTATION**  CABLE PLAN, PHASE DESIGNATION DIAGRAM, AND EMERGENCY VEHICLE PREEMPTION SEQUENCE BLACK ROAD AT IL 59 (BROOK FOREST AVE)

SECTION COUNTY 18-00517-00-TL WILL 72 9 CONTRACT NO. 61G36

- EXIST. INTERCONNECT TO SHARP

DRIVE (SEE INTERCONNECT PLANS)

**IDOT ECON 142** 

TS 7590

## BOULEVARD (SEE INTERCONNECT PLANS) **PHASE DESIGNATION: BLACK ROAD**

Black Rd 

TRACER CABLE | EXIST. INTERCONNECT TO HOME DEPOT -ENTRANCE (SEE INTERCONNECT PLANS)

EXIST. INTERCONNECT TO VERTIN

TRACER

U D

THE TRAFFIC SIGNAL CONTROL EQUIPMENT FOR THIS PROJECT SHALL BE "ECONOLITE"

TO MATCH THE EXISTING ADJACENT SYSTEM.

FOR INFORMATION ONLY

1#6

**CABLE PLAN** 

R Y G

Black Rd

(CH 56)

TRACER

CABLE

3#20)-

GEWALT |

5

Black @ Sharp Perm Signal dgn

USER NAME = zwallsten	DESIGNED -	DPB	REVISED -	
	DRAWN -	ZCW	REVISED -	
PLOT SCALE = 1:40	CHECKED -	DPB	REVISED -	
PLOT DATE = 8/20/2020	DATE -	8/21/2020	REVISED -	


**DEPARTMENT OF TRANSPORTATION** SCALE: 1"=20' SHEET

TRAFFIC SIGNAL MODERNIZATION PLAN BLACK ROAD AT SHARP DRIVE

SECTION COUNTY SHEETS NO.


WILL 72 10 18-00517-00-TL CONTRACT NO. 61G36

**IDOT ECON 142** 

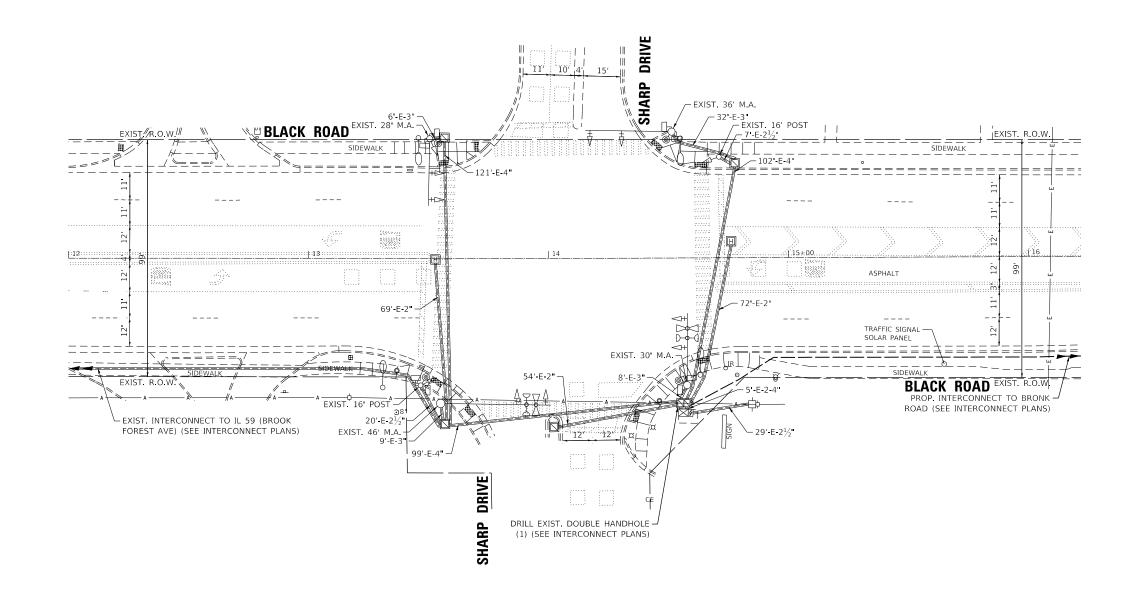

STATE OF ILLINOIS

### **EXISTING CONTROLLER SEQUENCE**

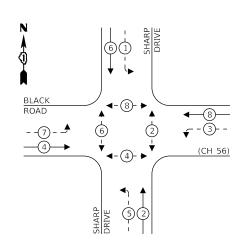

### LEGEND:


**◆ \* PROTECTED PHASE** 

← -(\*)- - PROTECTED/PERMITTED PHASE

√-(\*)- ► PEDESTRIAN PHASE

OL OVERLAP

### **EXISTING EMERGENCY VEHICLE** PREEMPTION SEQUENCE

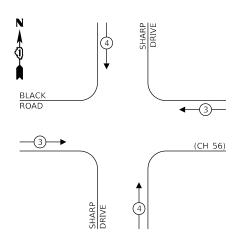

### TRAFFIC SIGNAL **ELECTRICAL SERVICE REQUIREMENTS**

			NO. OF	LED	%	TOTAL
	TYPE		LAMPS	WATTAGE	OPERATION	WATTAGE
	SIGNAL	(RED)	12	11	50	66
		(YELLOW)	12	20	5	12
		(GREEN)	12	12	45	65
	PERMISSI	IVE ARROW	16	10	10	16
7	PED. SIG	NAL	8	20	100	160
-	CONTRO	LLER	1	100	100	100
<u>8</u>	UPS		-	25	100	25
	VIDEO S	YSTEM	-	150	100	-
SHT	BLANK-O	UT SIGN	-	25	5	-
ᇰ	FLASHER		-	-	50	-
	STREET I	NAME SIGN	-	120	50	-
S	LUMINAIF	RE	-	250	50	-
•					TOTAL =	444

### VILLAGE OF SHOREWOOD

ONE TOWNE CENTER BOULEVARD

VILLAGE OF SHOREWOOD, IL 604 SHOREWOOD, IL 60404

ENERGY SUPPLY: CONTACT: TIM COSLET PHONE: (815) 724-5010

COMPANY: COM-ED

ACCOUNT NUMBER:

lack @ Sharp Perm Cable.dgr

GEWALT ASSOCIA

G

JSER NAME = zwallsten DESIGNED -REVISED DRAWN -ZCW REVISED HECKED -DPB REVISED PLOT DATE = 8/20/2020 REVISED 8/21/2020

STATE OF ILLINOIS **DEPARTMENT OF TRANSPORTATION**  CABLE PLAN, PHASE DESIGNATION DIAGRAM, AND EMERGENCY VEHICLE PREEMPTION SEQUENCE BLACK ROAD AT SHARP DRIVE

SHARP DRIVE

PUSHBUTTON "D"

D-O-()

PUSHBUTTON "A"

NUMBER OF GROUND -CABLES AS PER PLAN

(3#20)-

(CH 56)

LTRACER

CABLE

SECTION 18-00517-00-TL WILL 72 11 CONTRACT NO. 61G36 SHEETS STA.

PUSH BUTTON "A" SHALL PLACE A CALL IN PHASES 2 AND 4.

PHASES 4 AND 6.

PHASES 6 AND 8.

SHARP DRIVE

TRACER,

CABLE

### EXIST. INTERCONNECT TO IL 59 (BROOK -FOREST AVE) (SEE INTERCONNECT PLANS)

### PUSH BUTTON "B" SHALL PLACE A CALL IN

PUSH BUTTON "C" SHALL PLACE A CALL IN

PUSH BUTTON "D" SHALL PLACE A CALL IN PHASES 2 AND 8.

### THE TRAFFIC SIGNAL CONTROL EQUIPMENT FOR THIS PROJECT SHALL BE "ECONOLITE" TO MATCH THE EXISTING ADJACENT SYSTEM.

### PUSHBUTTON "C" **BLACK ROAD** PUSHBUTTON "B"

### **CABLE PLAN**

SCALE: None

1#6

**IDOT ECON 142** 

- PROP. INTERCONNECT TO BRONK

ROAD (SEE INTERCONNECT PLANS)

### **SCHEDULE OF QUANTITIES**

ITEM DESCRIPTION	UNITS	TOTAL QTY.
MAINTENANCE OF EXISTING TRAFFIC SIGNAL INSTALLATION	EACH	1

### **IDOT ECON 142**

USER NAME = zwallsten DESIGNED - DPB REVISED -DRAWN -ZCW REVISED -REVISED -PLOT SCALE = 1:40 CHECKED -DPB PLOT DATE = 8/20/2020 DATE -8/21/2020 REVISED .

STATE OF ILLINOIS
DEPARTMENT OF TRANSPORTATION

SCHEDULE OF QUANTITIES BLACK ROAD AT SHARP DRIVE SCALE: None SHEET OF SHEETS STA. TO STA.

COUNTY TOTAL SHEET NO.
WILL 72 12
CONTRACT NO. 61G36 SECTION 18-00517-00-TL

**BLACK ROAD** 

EXIST. 16 POST -27 -E-2½ -15 -E-2½ -BLACK ROAD EXIST. R.O.W. TRAFFIC SIGNAL -SOLAR PANEL •6'-E-3" - = = = = =

THE FOLLOWING ITEMS SHALL BE REMOVED BY THE CONTRACTOR AND SHALL BE DISPOSED OF BY THEM OUTSIDE THE RIGHT-OF-WAY AT THEIR EXPENSE. THE SALVAGE VALUE OF THE REMOVED EQUIPMENT

SHALL BE REFLECTED IN THE CONTRACT BID PRICE.

— 272′-Е-2**"** 

3 EACH STREET NAME SIGN

SHT

### **IDOT ECON 142**

EXIST. R.O.W.

BLACK ROAD

PROP. INTERCONNECT TO FRONTAGE -ROAD (SEE INTERCONNECT PLANS)

\_ 157'-E-2"

DRILL EXIST. HANDHOLE (1)

(SEE INTERCONNECT PLANS)

GEWALT HAMILTON ASSOCIATES, INC. JSER NAME = zwallsten DESIGNED -REVISED SECTION TRAFFIC SIGNAL MODERNIZATION PLAN STATE OF ILLINOIS DRAWN -ZCW REVISED 5 18-00517-00-TL WILL 72 13 BLACK ROAD AT BRONK ROAD 88.800 LOT SCALE = 1:40 REVISED **DEPARTMENT OF TRANSPORTATION** CONTRACT NO. 61G36 SCALE: 1"=20' SHEET PLOT DATE = 8/20/2020

Black Rd

<u> 121'-E-3'</u>

EXIST 16 POST

LED SIGN TO BE MOUNTED -/ TO MAST ARM RISER

− 51'-E-2½**"** 

-EXIST. 16' POST

**ROAD** 

BRONK

– 100'-E-4**"** 

EXIST. 24' M.A.

EXIST. 16' POST -


12'-E-2½'

33'-E-2½" -

130 E-2 -32 E-2½ EXIST. 16 POST

ASPHALT

EXIST. 22' M.A.

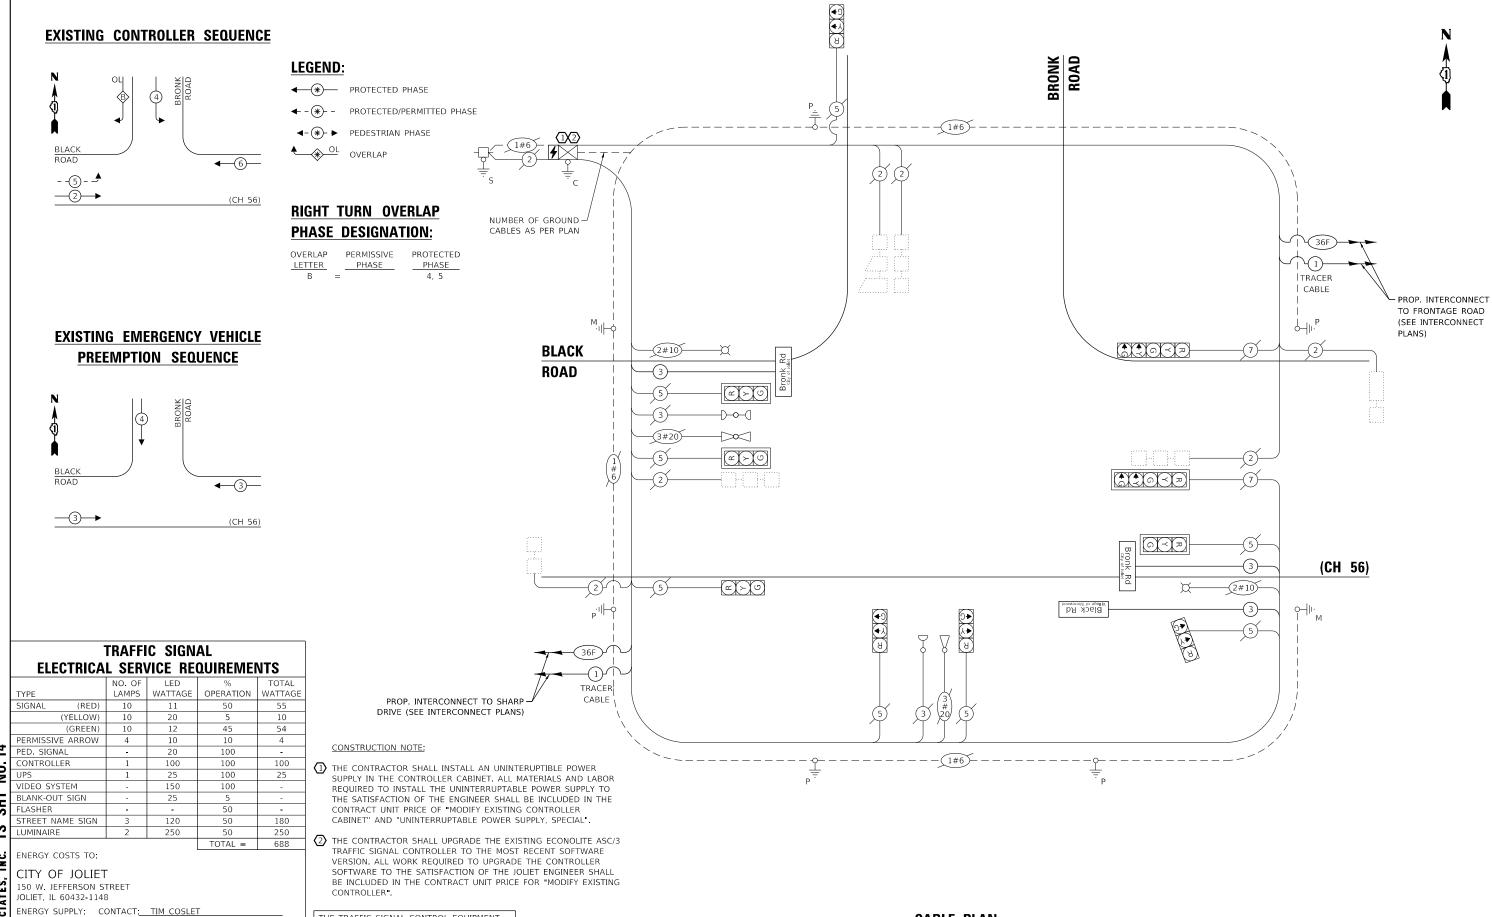

GEWALT ASSOCIA

**5** 

ACCOUNT NUMBER: lack @ Bronk Perm Cable.dgr 88.800

PHONE: (815) 724-5010 COMPANY: COM-ED

> JSER NAME = zwallsten DESIGNED - DPB REVISED DRAWN -ZCW REVISED HECKED -DPB REVISED PLOT DATE = 8/20/2020 REVISED 8/21/2020

THE TRAFFIC SIGNAL CONTROL EQUIPMENT FOR THIS PROJECT SHALL BE "ECONOLITE"

TO MATCH THE EXISTING ADJACENT SYSTEM.

STATE OF ILLINOIS **DEPARTMENT OF TRANSPORTATION** 

CABLE PLAN, PHASE DESIGNATION DIAGRAM, AND EMERGENCY VEHICLE PREEMPTION SEQUENCE BLACK ROAD AT BRONK ROAD

**CABLE PLAN** 


WILL 72 14

**IDOT ECON 142** 

SECTION 18-00517-00-TL CONTRACT NO. 61G36 SHEETS STA.



DESIGN	AREA	SIGN PANEL	SHEETING	QTY.
SERIES	(SQ FT)	TYPE	TYPE	REQUIRED
D	6.75	1	ZZ	1

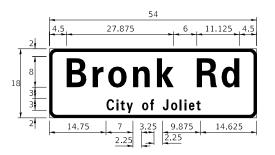


DESIGN	AREA	SIGN PANEL	SHEETING	QTY.
SERIES	(SQ FT)	TYPE	TYPE	REQUIRED
D	6.75	1	ZZ	2

NOTE: FOR ADDITIONAL DESIGN AND INSTALLATION INFORMATION PLEASE SEE DISTRICT ONE MAST ARM MOUNTED STREET NAME SIGNS DETAIL.

### **SCHEDULE OF QUANTITIES**

ITEM DESCRIPTION	UNITS	TOTAL QTY.
REMOVE SIGN PANEL - TYPE 1	SQ FT	20.25
MAINTENANCE OF EXISTING TRAFFIC SIGNAL INSTALLATION	EACH	1
MODIFY EXISTING CONTROLLER	EACH	1
MODIFY EXISTING CONTROLLER CABINET	EACH	1
LED INTERNALLY ILLUMINATED STREET NAME SIGN	EACH	3
ELECTRIC CABLE IN CONDUIT, STREET NAME SIGN, NO. 14 3C, TYPE SOOW	FOOT	594
SIGN SUPPORT SPECIAL	EACH	1
UNINTERRUPTABLE POWER SUPPLY, SPECIAL	EACH	1

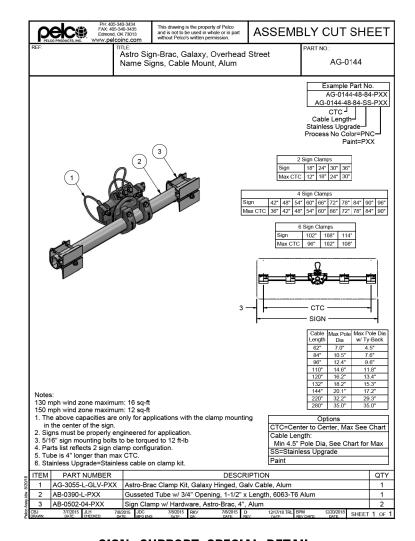

### SIGN SUPPORT SPECIAL DETAIL

### **IDOT ECON 142**

FILE NAME =
Black @ Bronk Sign.dgn
5388.800
Default

**TS SHT NO. 15** 

 USER NAME
 = zwalisten
 DESIGNED
 DPB
 REVISED

 DRAWN
 ZCW
 REVISED

 PLOT SCALE
 = 1:40
 CHECKED
 DPB
 REVISED

 PLOT DATE
 = 8/20/2020
 DATE
 8/21/2020
 REVISED


STATE OF ILLINOIS
DEPARTMENT OF TRANSPORTATION


L.E.D. ILLUMINATED MAST ARM MOUNTED STREET NAME SIGNS
AND SCHEDULE OF QUANTITIES
BLACK ROAD AT BRONK ROAD

SCALE: None SHEET OF SHEETS STA. TO STA.

SCALE: None SHEET OF SHEETS STA. TO STA.

STALE: NAME SIGNS
RTE. SECTION COUNTY TOTAL SHEETS NO.
298 18-00517-00-TL WILL 72 15
CONTRACT NO. 6 1/36

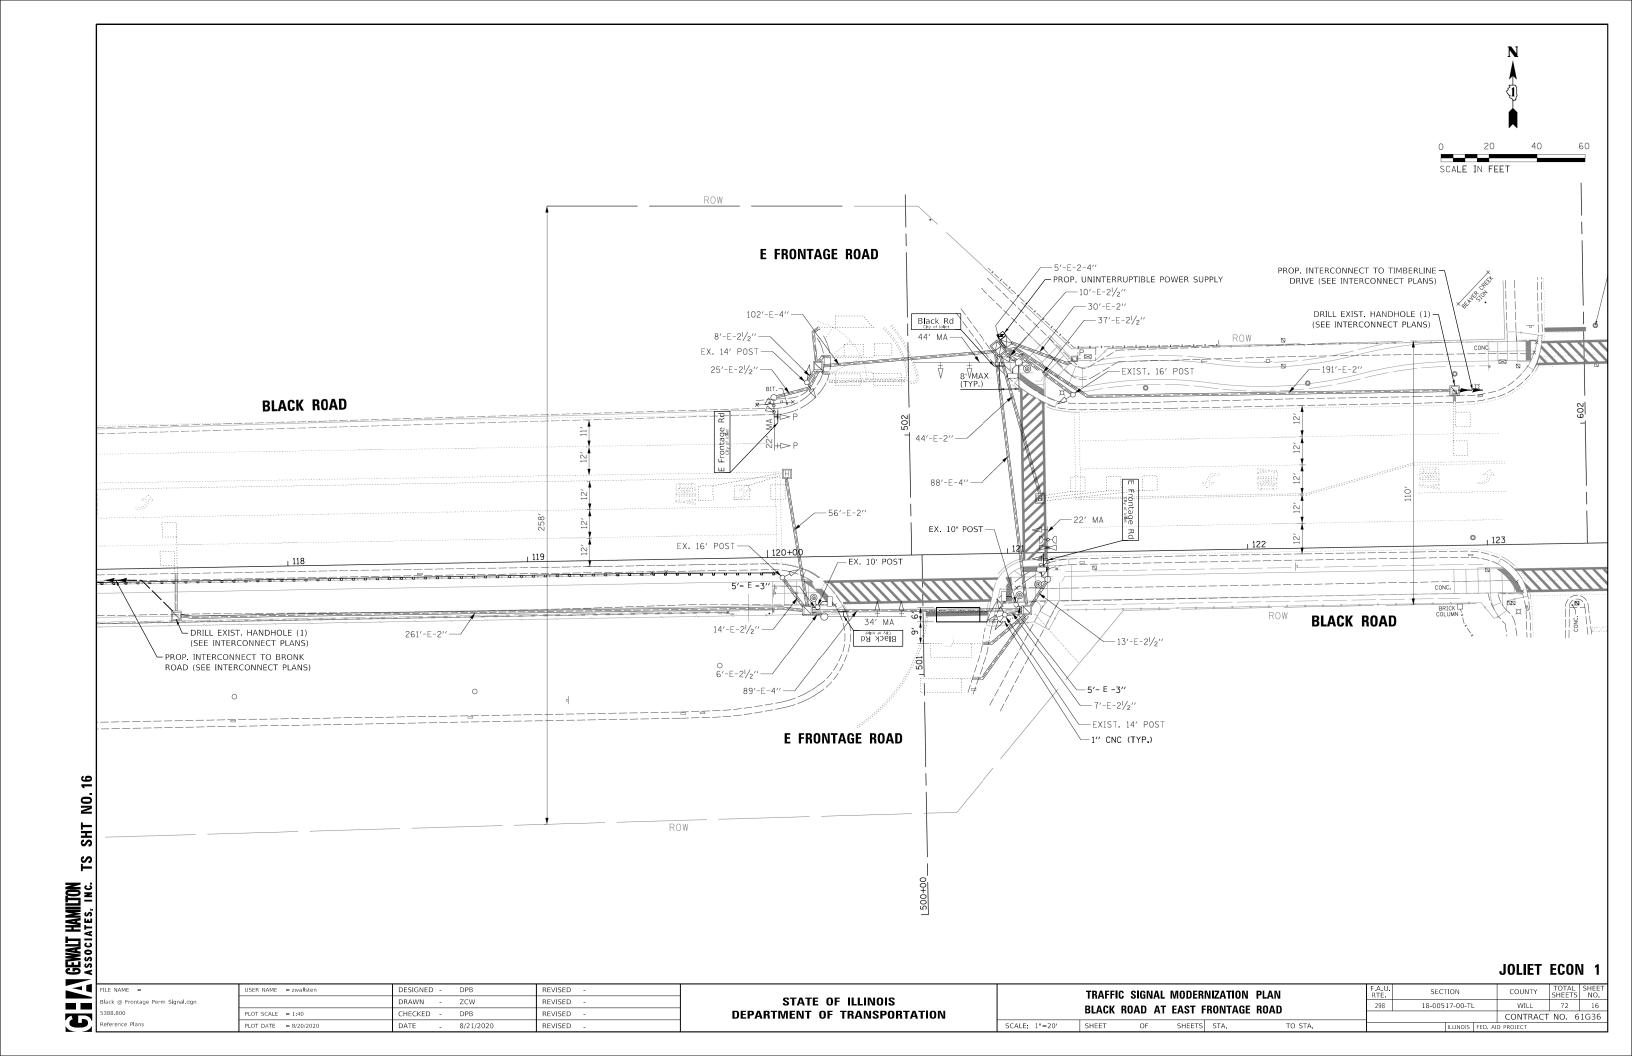


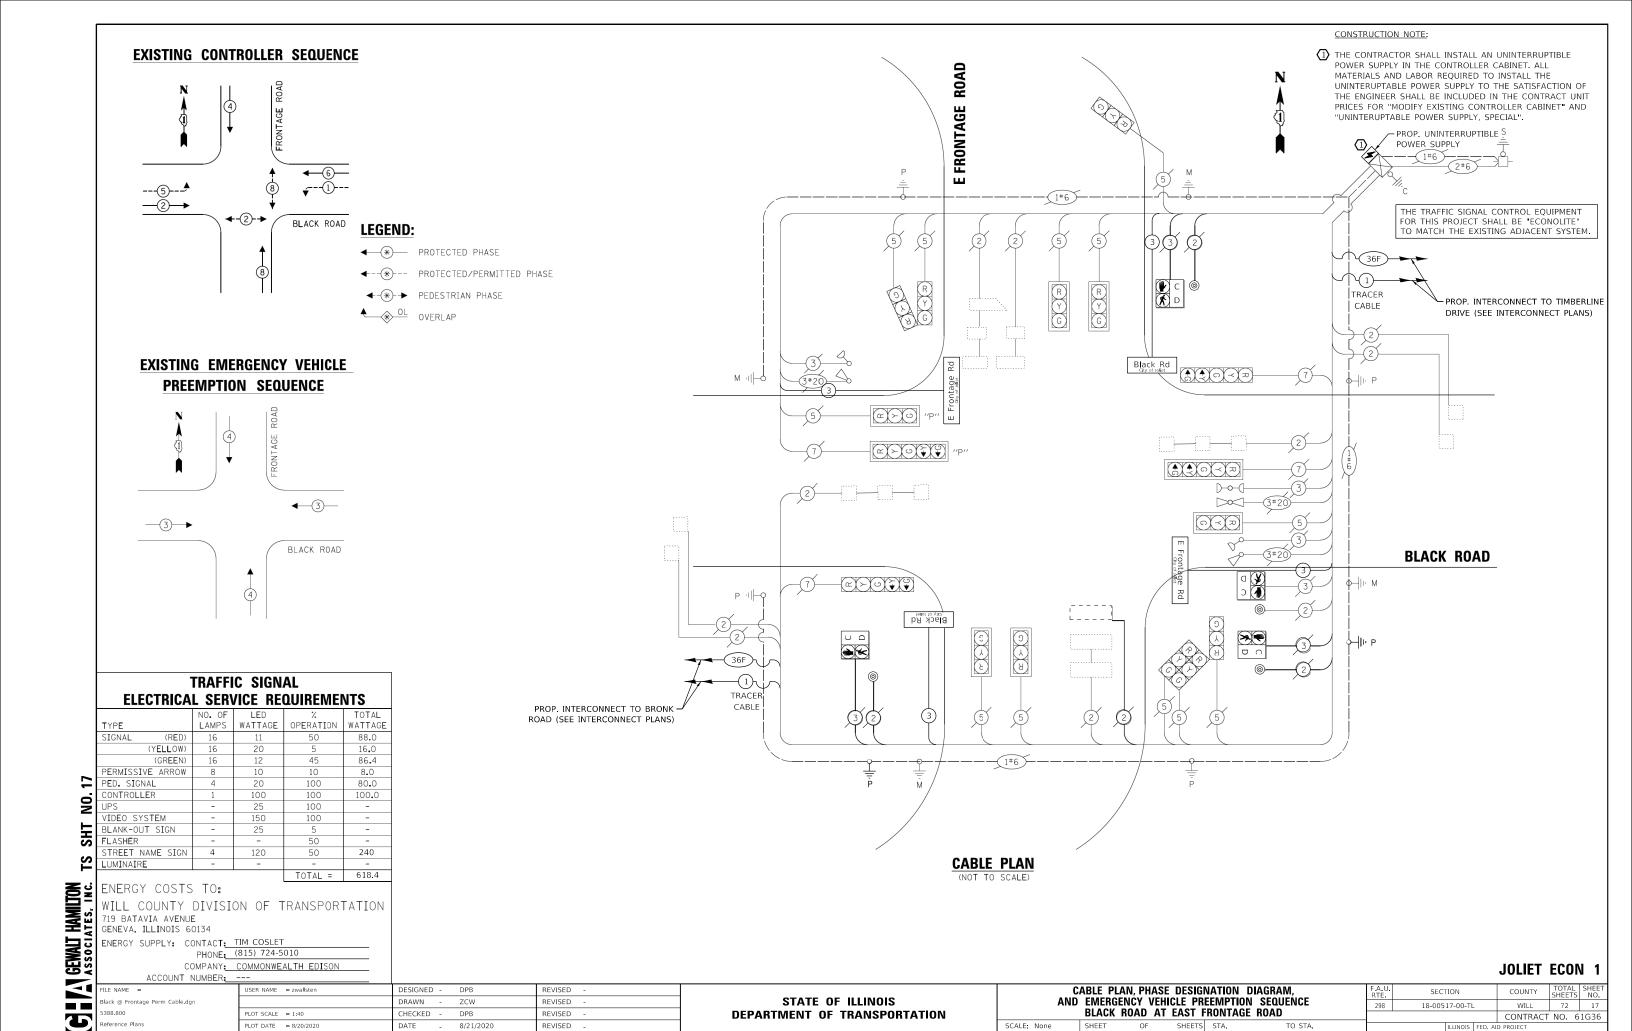

DATE


8/21/2020

REVISED

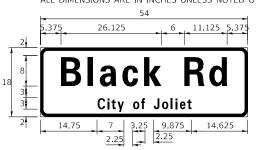

DESIGN	AREA	SIGN PANEL	SHEETING	QTY.
SERIES	(SQ FT)	TYPE	TYPE	REQUIRED
D	6.75	1	ZZ	2

ALL DIMENSIONS ARE IN INCHES UNLESS NOTED OTHERWISE

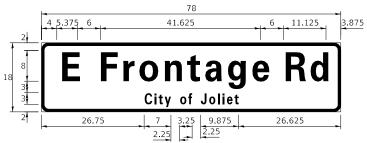

DESIGN	AREA	SIGN PANEL	SHEETING	QTY.
SERIES	(SQ FT)	TYPE	TYPE	REQUIRED
D	9.75	2	ZZ	2

NOTE: FOR ADDITIONAL DESIGN AND INSTALLATION INFORMATION PLEASE SEE DISTRICT ONE MAST ARM MOUNTED STREET NAME SIGNS DETAIL.

### **SCHEDULE OF QUANTITIES**

ITEM DESCRIPTION	UNITS	TOTAL QTY.
REMOVE SIGN PANEL - TYPE 2	SQ FT	13.5
MAINTENANCE OF EXISTING TRAFFIC SIGNAL INSTALLATION	EACH	1
MODIFY EXISTING CONTROLLER CABINET	EACH	1
LED INTERNALLY ILLUMINATED STREET NAME SIGN	EACH	4
ELECTRIC CABLE IN CONDUIT, STREET NAME SIGN, NO. 14 3C, TYPE SOOW	FOOT	801
UNINTERRUPTABLE POWER SUPPLY, SPECIAL	EACH	1

**TS SHT NO.18** 

G V GEWALT HAMILTON ASSOCIATES, INC.

JSER NAME = zwallsten DESIGNED - DPB REVISED DRAWN -ZCW REVISED PLOT SCALE = 1:40 CHECKED -DPB REVISED PLOT DATE = 8/20/2020 REVISED 8/21/2020

STATE OF ILLINOIS **DEPARTMENT OF TRANSPORTATION** 


SCALE: None

SCHEDULE OF QUANTITIES BLACK ROAD AT EAST FRONTAGE ROAD OF SHEETS STA.

18-00517-00-TL WILL 72 18 CONTRACT NO. 61G36


**JOLIET ECON 1** 

SECTION

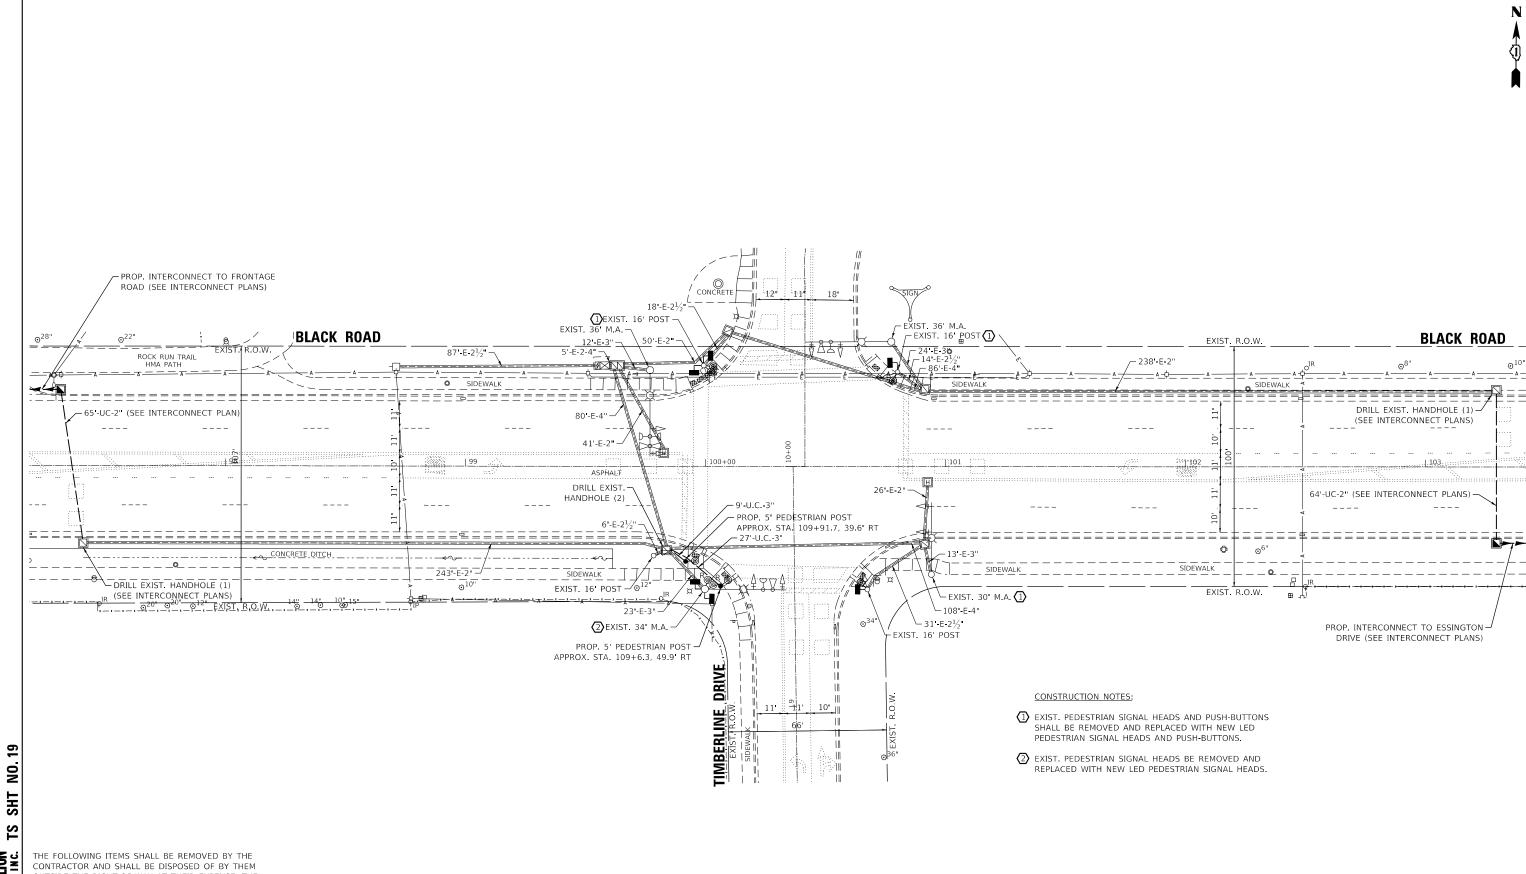

VALT HAMILTON OCIATES, INC.	THE FOLLOWING ITEMS SHALL CONTRACTOR AND SHALL BE OUTSIDE THE RIGHT-OF-WAY A SALVAGE VALUE OF THE REMO SHALL BE REFLECTED IN THE	DISPOSED OF BY THEM AT THEIR EXPENSE. THE DVED EQUIPMENT CONTRACT BID PRICE.							
GEN	6 EACH PEDESTRIAN SIGNA 6 EACH PEDESTRIAN PUSH-	*							JOLIET ECON 1
$ \mathbf{I} $	FILE NAME =	USER NAME = zwallsten	DESIGNED - DPB	REVISED -		TRAFFIC SIGNAL MODERNIZATION PLAN	F.A.U. RTF	SECTION	COUNTY TOTAL SHEET NO.
	Black @ Timberline Perm Signal.dgn		DRAWN - ZCW	REVISED -	STATE OF ILLINOIS		298	18-00517-00-TL	WILL 72 19
	5388.800	PLOT SCALE = 1:40	CHECKED - DPB	REVISED -	DEPARTMENT OF TRANSPORTATION	BLACK ROAD AT TIMBERLINE DRIVE			CONTRACT NO. 61G36
	Default	PLOT DATE = 8/20/2020	DATE - 8/21/2020	REVISED -		SCALE: 1"=20' SHEET OF SHEETS STA. TO STA.		ILLINOIS FED.	AID PROJECT

### **EXISTING CONTROLLER SEQUENCE**

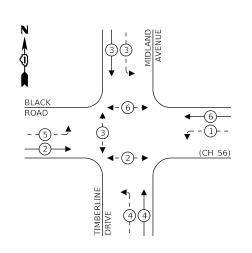


### LEGEND:

**★** PROTECTED PHASE ← -(\*)- - PROTECTED/PERMITTED PHASE

√-(\*)- PEDESTRIAN PHASE

OVERLAP OVERLAP

### PREEMPTION SEQUENCE

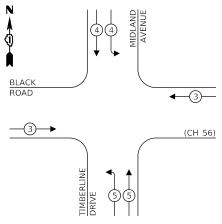

### TRAFFIC SIGNAL **ELECTRICAL SERVICE REQUIREMENTS**

	TYPE	LAMPS	WATTAGE	OPERATION	WATTAGE
	SIGNAL (RED)	12	11	50	66
	(YELLOW)	12	20	5	12
	(GREEN)	12	12	45	64.8
_	PERMISSIVE ARROW	4	10	10	4
20	PED. SIGNAL	8	20	100	160
<u>.</u>	CONTROLLER	1	100	100	100
NO.	UPS	1	25	100	25
	VIDEO SYSTEM	-	150	100	-
SHT	BLANK-OUT SIGN	-	25	5	-
S	FLASHER	-	-	50	-
	STREET NAME SIGN	4	120	50	240
S	LUMINAIRE	4	250	50	500
•				TOTAL =	1,171.8

ENERGY COSTS TO:

GEWALT |

G

CITY OF JOLIET

150 W. JEFFERSON STREET JOLIET, IL 600432-1148

ENERGY SUPPLY: CONTACT: TIM COSLET PHONE: (815) 724-5010

COMPANY: COM-ED ACCOUNT NUMBER:

lack @ Timberline Perm Cable.don

JSER NAME = zwallsten DESIGNED -REVISED DRAWN -REVISED ZCW HECKED DPB REVISED PLOT DATE = 8/20/2020 REVISED DATE 8/21/2020

THE TRAFFIC SIGNAL CONTROL EQUIPMENT FOR THIS PROJECT SHALL BE "ECONOLITE" TO MATCH THE EXISTING ADJACENT SYSTEM.

### **CABLE PLAN**

1#6

(F) (S)

CABLE PLAN, PHASE DESIGNATION DIAGRAM, AND EMERGENCY VEHICLE PREEMPTION SEQUENCE

SECTION 18-00517-00-TL

**JOLIET ECON 1** WILL 72 20


TRACER CABLE

(CH 56)

- PROP. INTERCONNECT TO ESSINGTON ROAD (SEE

INTERCONNECT PLANS)

### **EXISTING EMERGENCY VEHICLE**

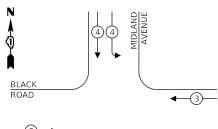

# NUMBER OF GROUND CABLES AS PER PLAN

2#10)-**BLACK ROAD** -(3#20)

TRACER

CABLE

PROP. INTERCONNECT TO E. FRONTAGE ROAD (SEE INTERCONNECT PLANS)

TIMBERLINE DRIVE

STATE OF ILLINOIS **DEPARTMENT OF TRANSPORTATION** 

**BLACK ROAD AT TIMBERLINE DRIVE** SCALE: None

TIMBERLINE

RYG

Black Rd

2#10

1#6)-

SHEETS STA.

CONTRACT NO. 61G36

NO. OF LED % TOTAL

# G V GEWALT HAMILTON TS SHT NO. 21

ITEM DESCRIPTION	UNITS	TOTAL QTY.
UNDERGROUND CONDUIT, GALVANIZED STEEL, 3" DIA.	FOOT	36
MAINTENANCE OF EXISTING TRAFFIC SIGNAL INSTALLATION	EACH	1
ELECTRIC CABLE IN CONDUIT, SIGNAL NO. 14 2C	FOOT	65
DRILL EXISTING HANDHOLE	EACH	2
PEDESTRIAN SIGNAL HEAD, LED, 1-FACE, BRACKET MOUNTED WITH COUNTDOWN TIMER	EACH	6
PEDESTRIAN PUSH-BUTTON	EACH	6
REMOVE EXISTING TRAFFIC SIGNAL EQUIPMENT	EACH	1
PEDESTRIAN SIGNAL POST, 5 FT.	EACH	2
CONCRETE FOUNDATION, TYPE A 10-INCH DIAMETER	FOOT	8

**SCHEDULE OF QUANTITIES** 

### **JOLIET ECON 1**


USER NAME = zwallsten DESIGNED - DPB REVISED -DRAWN - ZCW REVISED -REVISED -PLOT SCALE = 1:40 CHECKED -DPB PLOT DATE = 8/20/2020 8/21/2020 REVISED .

STATE OF ILLINOIS
DEPARTMENT OF TRANSPORTATION

SCHEDULE OF QUANTITIES BLACK ROAD AT TIMBERLINE DRIVE OF SHEETS STA. TO STA.

SCALE: None

COUNTY TOTAL SHEET NO.
WILL 72 21
CONTRACT NO. 61G36 SECTION 18-00517-00-TL

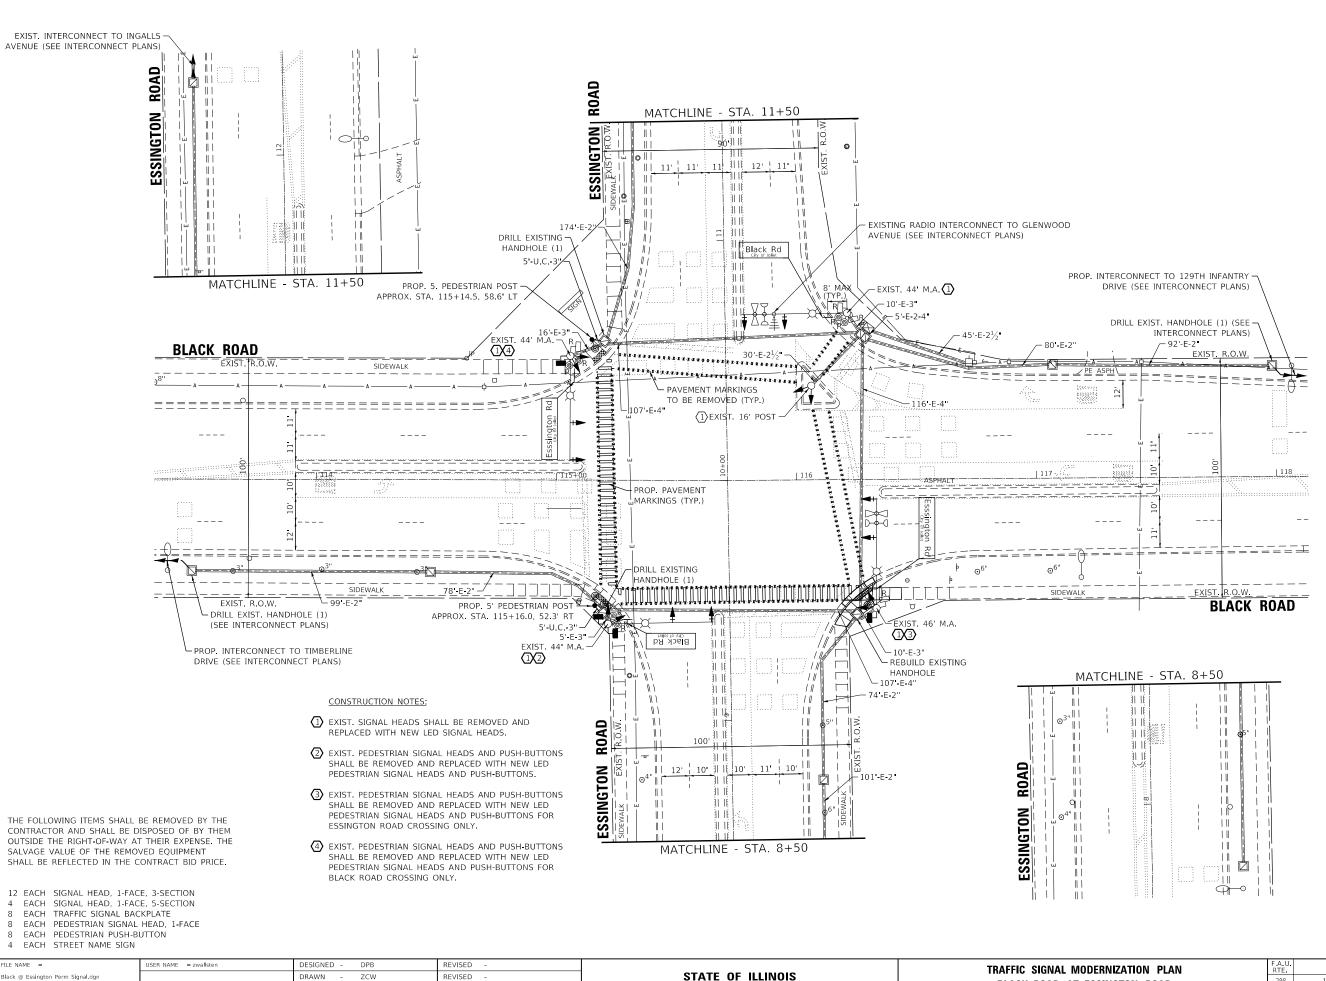


SHT

GEWALT ASSOCIA

JOLIET ECON 1

FLE NAME = USER NAME = 2Wallsten DESIGNED - DPB REVISED -

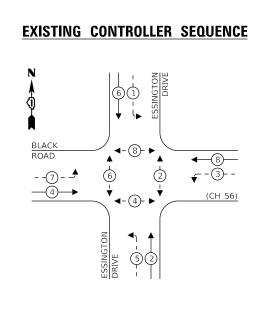

ROAD

--(7) - 🍜


**-**4**-**►

LEGEND:

**∢**-(\*)- ▶

6

### **EXISTING AND PROPOSED EMERGENCY VEHICLE** PREEMPTION SEQUENCE

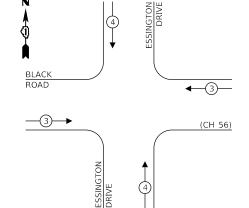

### TRAFFIC SIGNAL **ELECTRICAL SERVICE REQUIREMENTS** NO. OF LED

TYPE	LAMPS	WATTAGE	OPERATION	WATTAGE
SIGNAL (RED)	16	11	50	88
(YELLOW)	16	20	5	16
(GREEN)	16	12	45	86.4
PERMISSIVE ARROW	8	10	10	8
PED. SIGNAL	4	20	100	80
CONTROLLER	1	100	100	100
UPS	1	25	100	25
VIDEO SYSTEM	-	150	100	-
BLANK-OUT SIGN	-	25	5	-
FLASHER	-	-	50	-
STREET NAME SIGN	4	120	50	240
LUMINAIRE	4	250	50	500
			TOTAL =	1,143.4

ENERGY COSTS TO:

CITY OF JOLIET

150 W. JEFFERSON STREET JOLIET, IL 60432-1148

ENERGY SUPPLY: CONTACT: TIM COSLET PHONE: (815) 724-5010


COMPANY: COM-ED

ACCOUNT NUMBER:

lack @ Essington Perm Cable don

JSER NAME = zwallsten DESIGNED -REVISED DRAWN -ZCW REVISED HECKED DPB REVISED PLOT DATE = 8/20/2020 REVISED 8/21/2020

THE TRAFFIC SIGNAL CONTROL EQUIPMENT FOR THIS PROJECT SHALL BE "ECONOLITE" TO MATCH THE EXISTING ADJACENT SYSTEM.

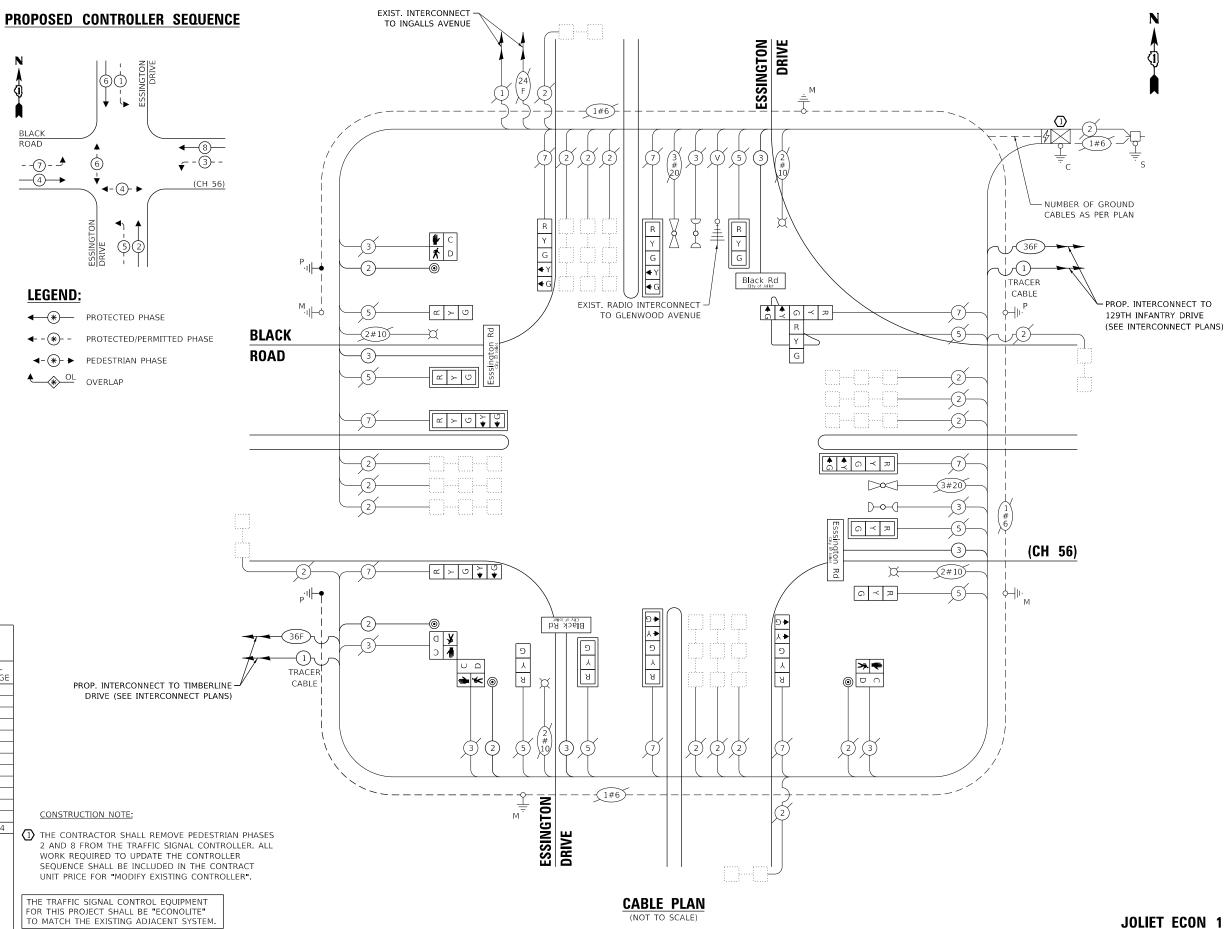

SCALE: None

STATE OF ILLINOIS

**DEPARTMENT OF TRANSPORTATION** 

CABLE PLAN, PHASE DESIGNATION DIAGRAM, AND EMERGENCY VEHICLE PREEMPTION SEQUENCE

BLACK ROAD AT ESSINGTON ROAD

SHEETS STA.

SECTION

18-00517-00-TL


WILL 72 23

CONTRACT NO. 61G36

### SHT NO. 23 Z


GEWALT ASSOCIA

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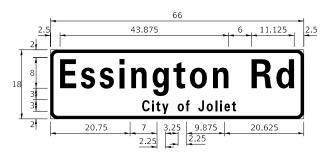


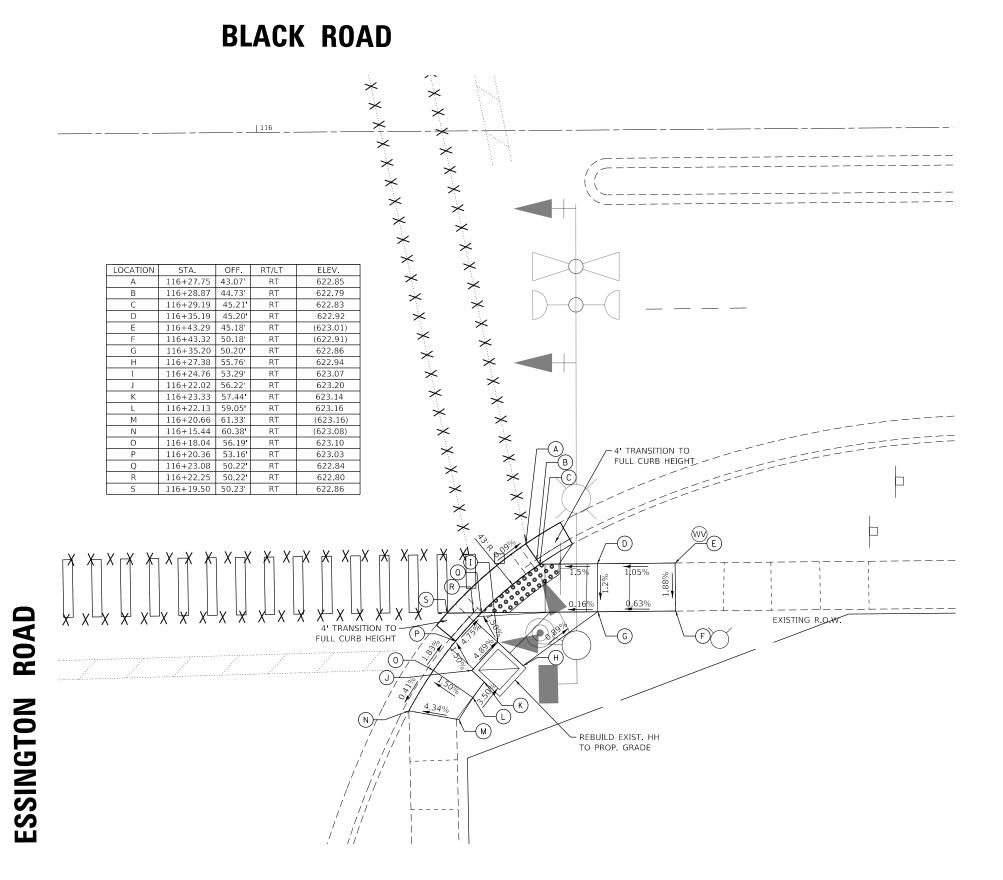JSER NAME = zwallsten DESIGNED -DPB REVISED SECTION ADA GRADING PLAN COUNTY SHEETS NO.

WILL 72 24 STATE OF ILLINOIS DRAWN -ZCW REVISED 18-00517-00-TL BLACK ROAD AT ESSINGTON ROAD PLOT SCALE = 1:10 CHECKED -DPB REVISED **DEPARTMENT OF TRANSPORTATION** CONTRACT NO. 61G36 PLOT DATE = 8/20/2020 SCALE: 1"=5" OF SHEETS STA. 8/21/2020

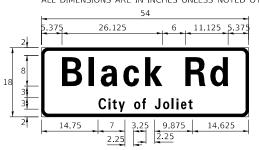

DESIGN	AREA	SIGN PANEL	SHEETING	QTY.
SERIES	(SQ FT)	TYPE	TYPE	REQUIRED
D	6.75	1	ZZ	2



DESIGN	AREA	SIGN PANEL	SHEETING	QTY.
SERIES	(SQ FT)	TYPE	TYPE	REQUIRED
D	8.25	1	ZZ	2

NOTE: FOR ADDITIONAL DESIGN AND INSTALLATION INFORMATION PLEASE SEE DISTRICT ONE MAST ARM MOUNTED STREET NAME SIGNS DETAIL.


### **SCHEDULE OF QUANTITIES**


ITEM DESCRIPTION	UNITS	TOTAL QTY.
PORTLAND CEMENT CONCRETE SIDEWALK 5 INCH	SQ FT	165
DETECTABLE WARNINGS	SQ FT	16
SIDEWALK REMOVAL	SQ FT	165
REMOVE SIGN PANEL - TYPE 1	SQ FT	30
THERMOPLASTIC PAVEMENT MARKING - LINE 12"	FOOT	378
UNDERGROUND CONDUIT, GALVANIZED STEEL, 3" DIA.	FOOT	10
MAINTENANCE OF EXISTING TRAFFIC SIGNAL INSTALLATION	EACH	1
ELECTRIC CABLE IN CONDUIT, SIGNAL NO. 14 2C	FOOT	701
DRILL EXISTING HANDHOLE	EACH	2
SIGNAL HEAD, LED, 1-FACE, 3-SECTION, MAST-ARM MOUNTED	EACH	4
SIGNAL HEAD, LED, 1-FACE, 3-SECTION, BRACKET MOUNTED	EACH	4
SIGNAL HEAD, LED, 1-FACE, 5-SECTION, BRACKET MOUNTED	EACH	4
SIGNAL HEAD, LED, 1-FACE, 5-SECTION, MAST-ARM MOUNTED	EACH	4
PEDESTRIAN SIGNAL HEAD, LED, 1-FACE, BRACKET MOUNTED WITH COUNTDOWN TIMER	EACH	4
TRAFFIC SIGNAL BACKPLATE, LOUVERED, FORMED PLASTIC	EACH	8
PEDESTRIAN PUSH-BUTTON	EACH	4
MODIFY EXISTING CONTROLLER	EACH	1
MODIFY EXISTING CONTROLLER CABINET	EACH	1
REMOVE EXISTING TRAFFIC SIGNAL EQUIPMENT	EACH	1
REBUILD EXISTING HANDHOLE	EACH	1
LED INTERNALLY ILLUMINATED STREET NAME SIGN	EACH	4
PAVEMENT MARKING REMOVAL - WATER BLASTING	SQ FT	170
PEDESTRIAN SIGNAL POST, 5 FT.	EACH	2
ELECTRIC CABLE IN CONDUIT, STREET NAME SIGN, NO. 14 3C, TYPE SOOW	FOOT	735
CURB REMOVAL AND REPLACEMENT	FOOT	17
CONCRETE FOUNDATION, TYPE A 10-INCH DIAMETER	FOOT	8


### **TS SHT NO. 25**


L.E.D. ILLUMINATED MAST ARM MOUNTED STREET NAME SIGNS						F.A.U. RTE		
AND SCHEDULE OF QUANTITIES BLACK ROAD AT ESSINGTON ROAD						298		
	BLAC	K KUAD	AI F221	NGTUN	KUAD			
SCALE: None	SHEET	OF	SHEETS	STA.	TO S	TA.		_

SECTION

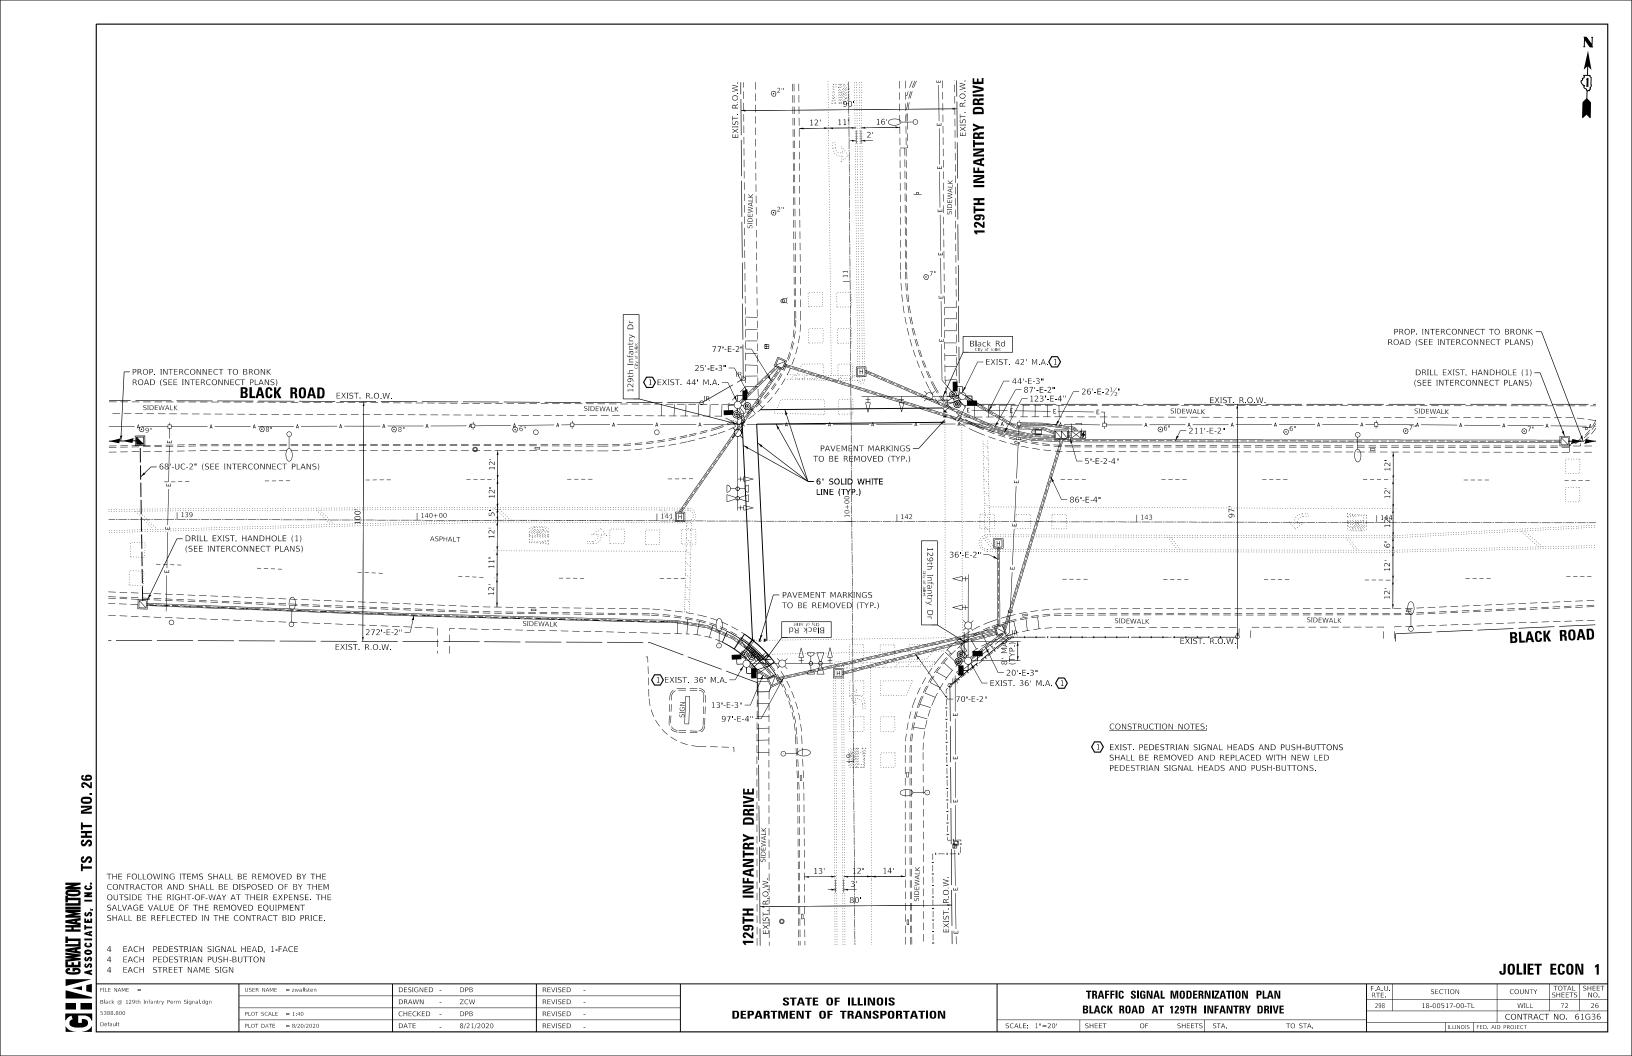

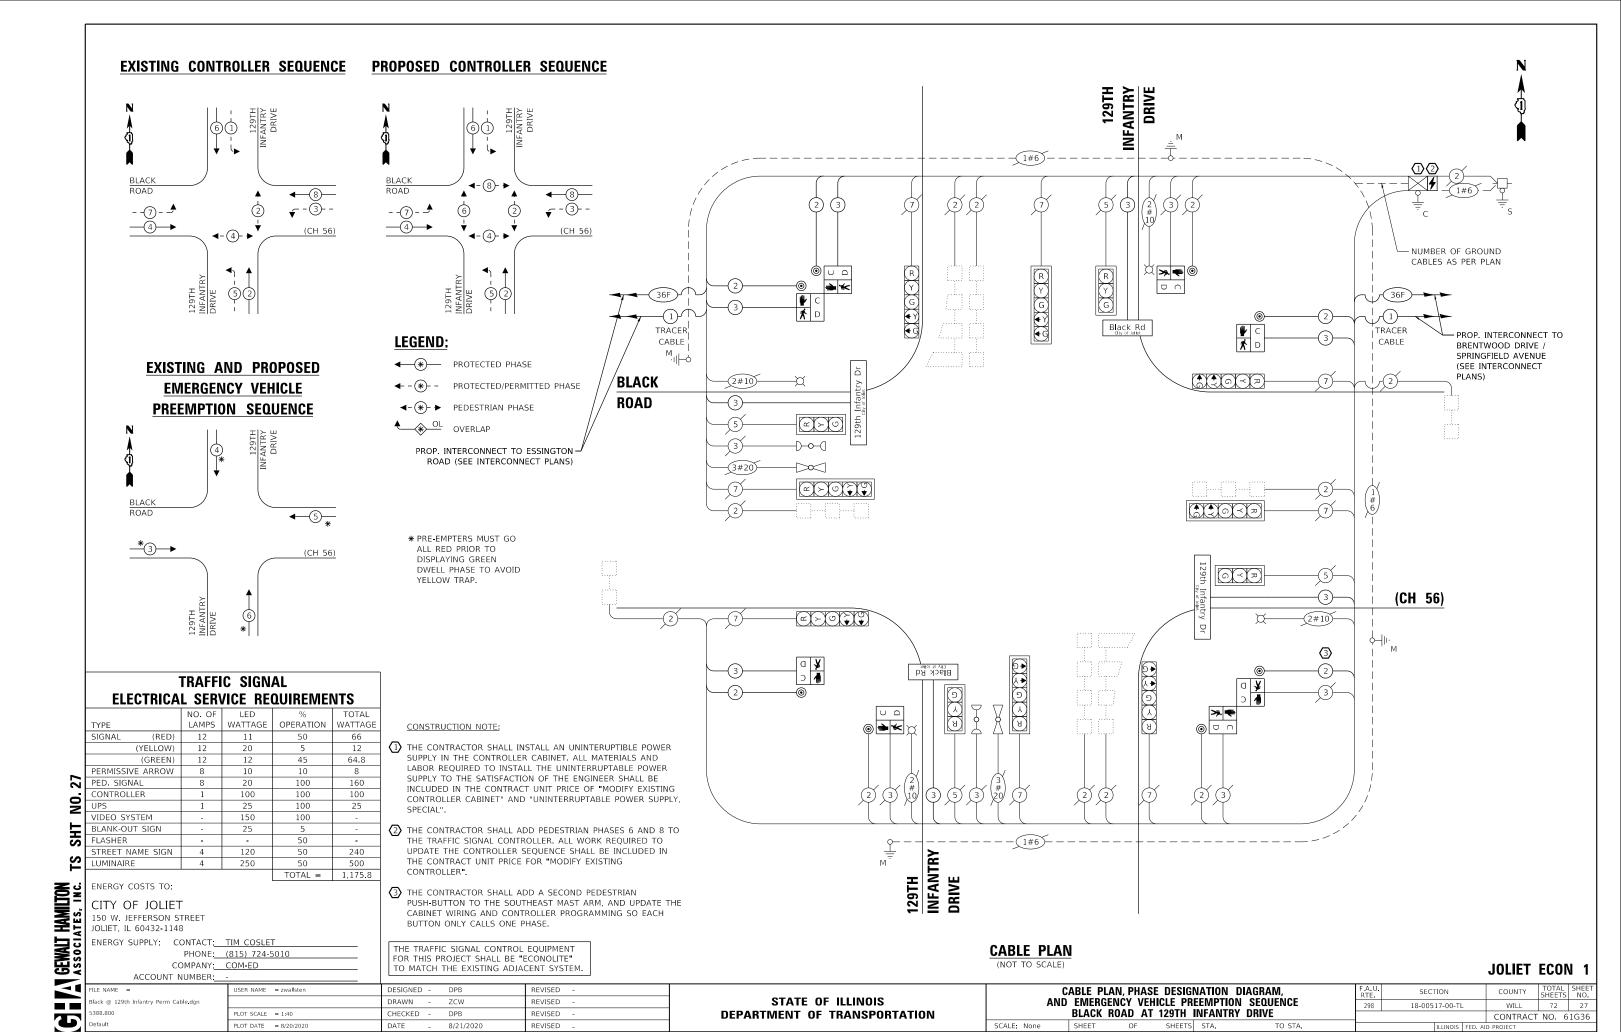


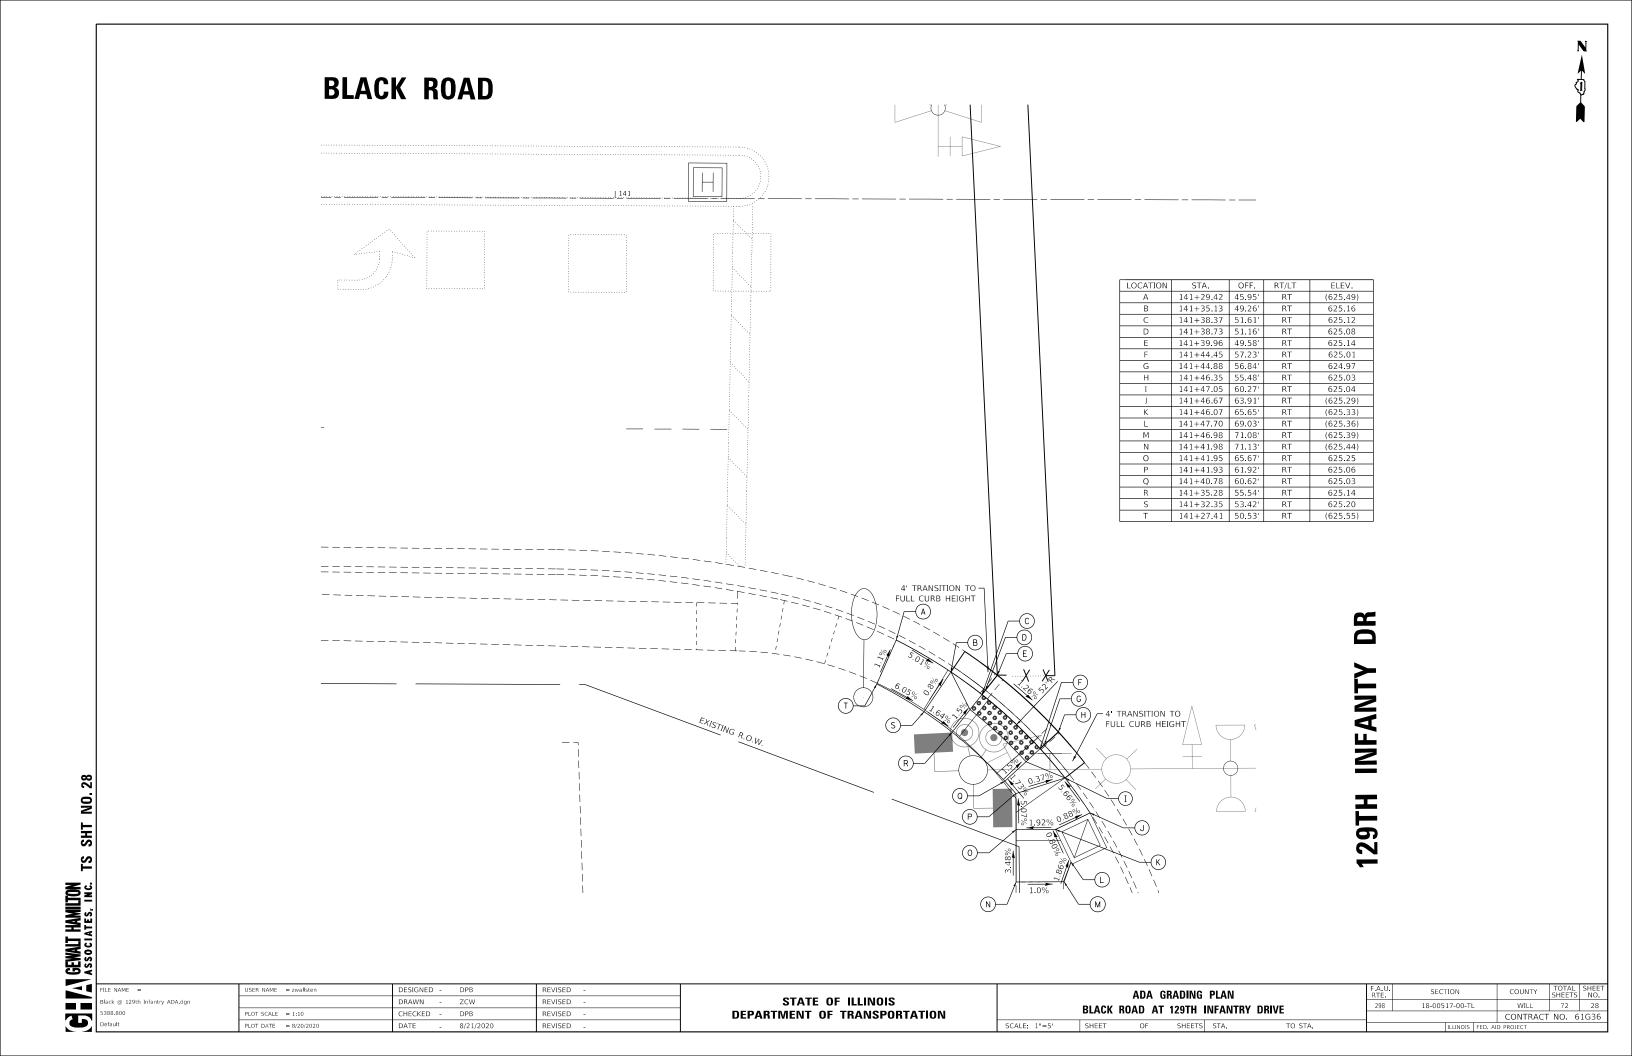

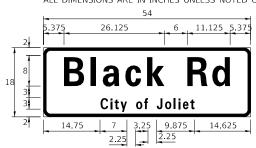

DESIGN	AREA	SIGN PANEL	SHEETING	QTY.
SERIES	(SQ FT)	TYPE	TYPE	REQUIRED
D	6.75	1	ZZ	2

ALL DIMENSIONS ARE IN INCHES UNLESS NOTED OTHERWISE

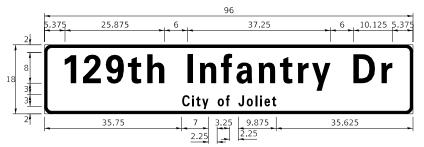

DESIGN	AREA	SIGN PANEL	SHEETING	QTY.
SERIES	(SQ FT)	TYPE	TYPE	REQUIRED
D	12	2	ZZ	2

### **SCHEDULE OF QUANTITIES**

ITEM DESCRIPTION	UNITS	TOTAL QTY.
EARTH EXCAVATION	CU YD	5
PORTLAND CEMENT CONCRETE SIDEWALK 5 INCH	SQ FT	175
DETECTABLE WARNINGS	SQ FT	16
SIDEWALK REMOVAL	SQ FT	150
REMOVE SIGN PANEL - TYPE 1	SQ FT	37.5
THERMOPLASTIC PAVEMENT MARKING - LINE 6"	FOOT	335
MAINTENANCE OF EXISTING TRAFFIC SIGNAL INSTALLATION	EACH	1
ELECTRIC CABLE IN CONDUIT, SIGNAL NO. 14 2C	FOOT	842
ELECTRIC CABLE IN CONDUIT, SIGNAL NO. 14 3C	FOOT	724
PEDESTRIAN SIGNAL HEAD, LED, 1-FACE, BRACKET MOUNTED WITH COUNTDOWN TIMER	EACH	8
PEDESTRIAN PUSH-BUTTON	EACH	8
MODIFY EXISTING CONTROLLER	EACH	1
MODIFY EXISTING CONTROLLER CABINET	EACH	1
REMOVE EXISTING TRAFFIC SIGNAL EQUIPMENT	EACH	1
LED INTERNALLY ILLUMINATED STREET NAME SIGN	EACH	4
PAVEMENT MARKING REMOVAL - WATER BLASTING	SQ FT	6
ELECTRIC CABLE IN CONDUIT, STREET NAME SIGN, NO. 14 3C, TYPE SOOW	FOOT	742
CURB REMOVAL AND REPLACEMENT	FOOT	17
UNINTERRUPTABLE POWER SUPPLY, SPECIAL	EACH	1

G V GEWALT HAMILTON ASSOCIATES, INC.

Black @ 129th Infantry Sign.dgn


JSER NAME = zwallsten DESIGNED - DPB REVISED DRAWN -ZCW REVISED CHECKED -REVISED PLOT DATE = 8/20/2020 REVISED 8/21/2020

### STATE OF ILLINOIS **DEPARTMENT OF TRANSPORTATION**


L.E.D. ILLUMINATED MAST ARM MOUNTED STREET NAME SIGNS						
AND SCHEDULE OF QUANTITIES BLACK ROAD AT 129TH INFANTRY DRIVE						2
	BLACK	KUAD AI	1291H I	INFANT	RY DRIVE	
SCALE: None	SHEET	OF	SHEETS	STA.	TO STA.	

SECTION

**JOLIET ECON 1** 

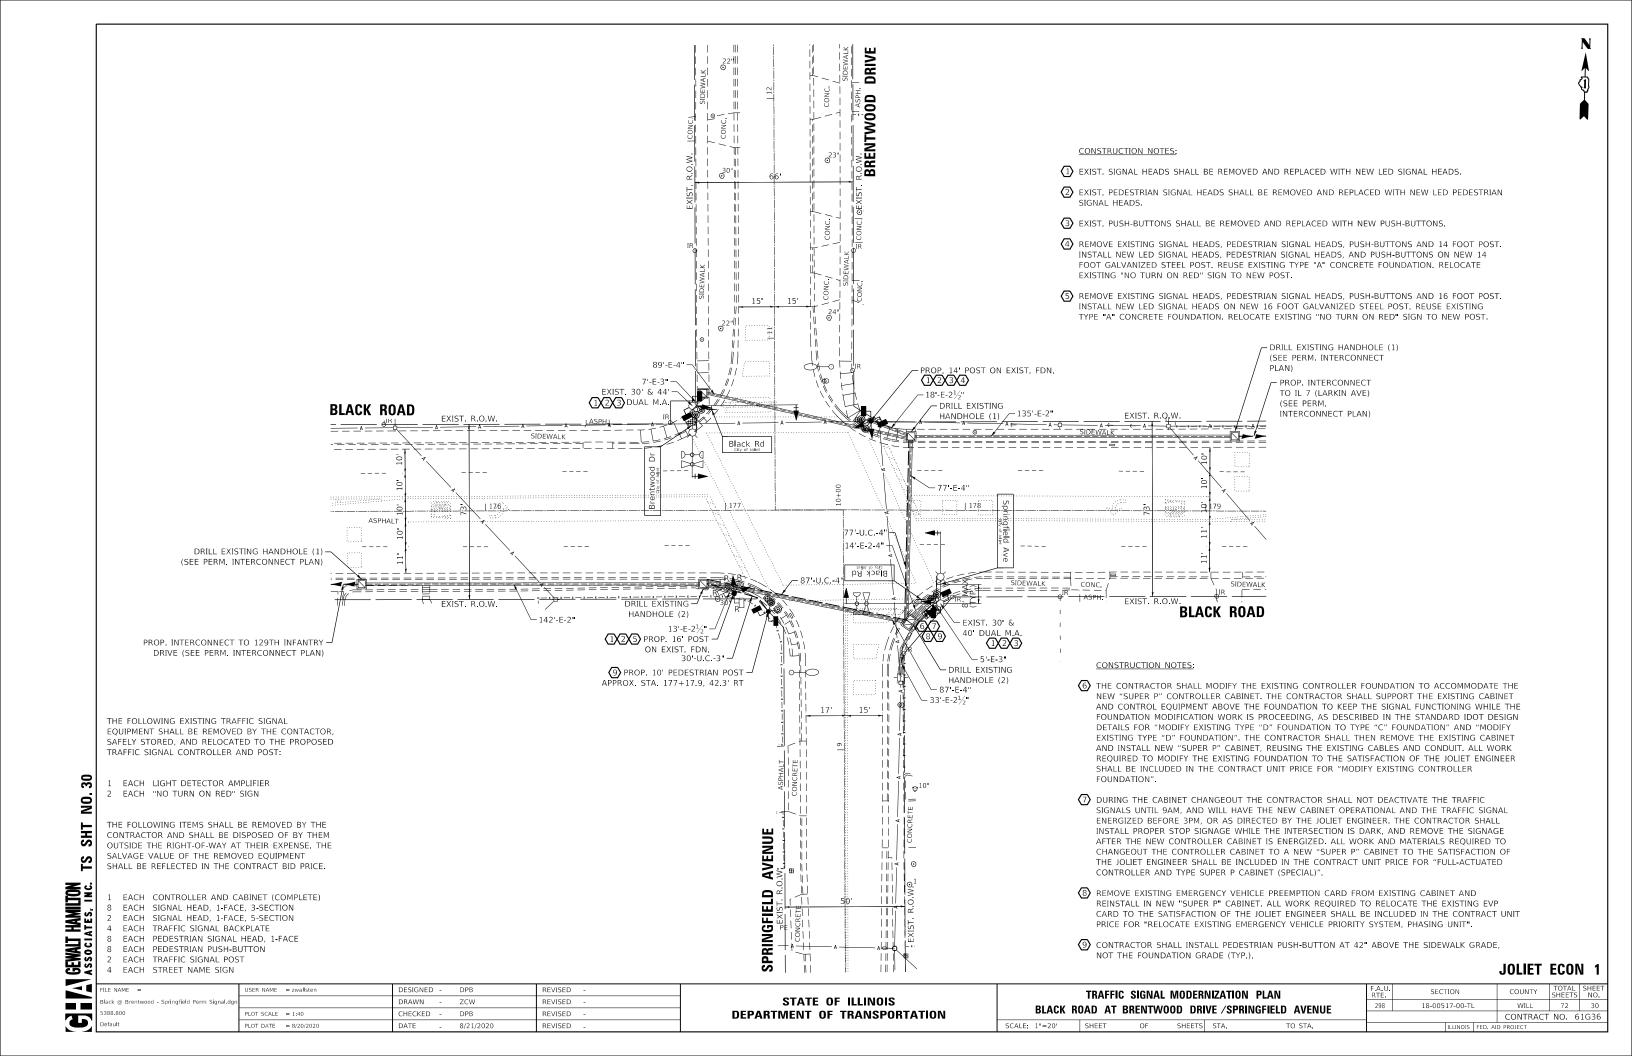

### **EXISITNG CONTROLLER SEQUENCE**

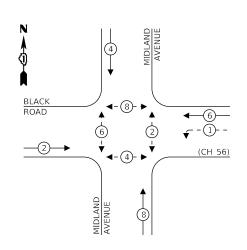

### LEGEND:


**★** PROTECTED PHASE

← -(\*)- - PROTECTED/PERMITTED PHASE

√-(\*)- ► PEDESTRIAN PHASE

♦ OL OVERLAP

### **EXISTING EMERGENCY VEHICLE** PREEMPTION SEQUENCE

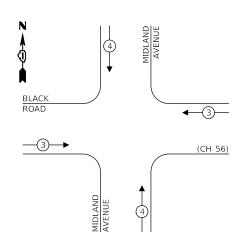

### TRAFFIC SIGNAL **ELECTRICAL SERVICE REQUIREMENTS** NO. OF LED % TOTAL

	TYPE	LAMPS	WATTAGE	OPERATION	WATTAGE
	SIGNAL (RED)	10	11	50	55
	(YELLOW)	10	20	5	10
	(GREEN)	10	12	45	54
	PERMISSIVE ARROW	4	10	10	4
31	PED. SIGNAL	8	20	100	160
	CONTROLLER	1	100	100	100
N0	UPS	1	25	100	25
	VIDEO SYSTEM	-	150	100	-
SHT	BLANK-OUT SIGN	-	25	5	-
S	FLASHER	-	-	50	-
	STREET NAME SIGN	-	120	50	-
TS	LUMINAIRE	2	250	50	250
•				TOTAL =	658

ENERGY COSTS TO:

GEWALT |

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### CITY OF JOLIET

150 W. JEFFERSON STREET JOLIET, IL 60432-1148

ENERGY SUPPLY: CONTACT: TIM COSLET

JSER NAME = zwallsten DESIGNED -REVISED DRAWN -REVISED lack @ Brentwood - Springfield Perm Cable o ZCW HECKED DPB REVISED PLOT DATE = 8/20/2020 REVISED DATE 8/21/2020

### **CONSTRUCTION NOTE:**

1 MAST ARM CURRENTLY HAS ONE PEDESTRIAN PUSH-BUTTON. THE CONTRACTOR SHALL INSTALL A SECOND PUSH-BUTTON, WITH A NEW 2 CONDUCTOR CABLE.

THE TRAFFIC SIGNAL CONTROL EQUIPMENT FOR THIS PROJECT SHALL BE "ECONOLITE"

### (CH 56) - ~ > o <del>></del> o (2#10) Black Rd TRACER CABLE PROP. INTERCONNECT TO -129TH INFANTRY DRIVE 1#6 SPRINGFIELD AVENUE NUMBER OF GROUND CABLES AS PER PLAN

### **CABLE PLAN**

SHEET

CABLE PLAN, PHASE DESIGNATION DIAGRAM, AND EMERGENCY VEHICLE PREEMPTION SEQUENCE BLACK ROAD AT BRENTWOOD DRIVE /SPRINGFIELD AVENUE SHEETS STA.

BRENTWOOD DRIVE

R Y G

1#6)-

1

-(2#10)-

**BLACK** 

**ROAD** 

Black Rd

SECTION 18-00517-00-TL WILL 72 31 CONTRACT NO. 61G36

**JOLIET ECON 1** 


TRACER CABLE

PROP. INTERCONNECT TO IL 7 (LARKIN AVE)

### TO MATCH THE EXISTING ADJACENT SYSTEM.


### PHONE: (815) 724-5010 COMPANY: COM-ED ACCOUNT NUMBER:

STATE OF ILLINOIS **DEPARTMENT OF TRANSPORTATION** 

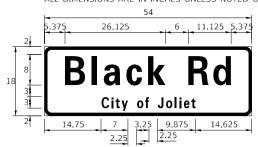


DESIGN	AREA	SIGN PANEL	SHEETING	QTY.
SERIES	(SQ FT)	TYPE	TYPE	REQUIRED
D	6.75	1	ZZ	2

ALL DIMENSIONS ARE IN INCHES UNLESS NOTED OTHERWISE

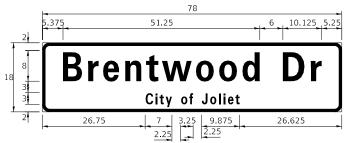

DESIGN	AREA	SIGN PANEL	SHEETING	QTY.
SERIES	(SQ FT)	TYPE	TYPE	REQUIRED
D	9.75	1	ZZ	1

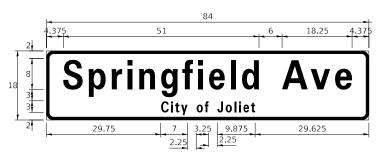

DESIGN	AREA	SIGN PANEL	SHEETING	QTY.
SERIES	(SQ FT)	TYPE	TYPE	REQUIRED
D	10.5	1	ZZ	1

NOTE: FOR ADDITIONAL DESIGN AND INSTALLATION INFORMATION PLEASE SEE DISTRICT ONE MAST ARM MOUNTED STREET NAME

### **SCHEDULE OF QUANTITIES**

ITEM DESCRIPTION	UNITS	TOTAL QTY.
REMOVE SIGN PANEL - TYPE 2	SQ FT	35
UNDERGROUND CONDUIT, GALVANIZED STEEL, 3" DIA.	FOOT	30
UNDERGROUND CONDUIT, GALVANIZED STEEL, 4" DIA.	FOOT	164
MAINTENANCE OF EXISTING TRAFFIC SIGNAL INSTALLATION	EACH	1
ELECTRIC CABLE IN CONDUIT, SIGNAL NO. 14 2C	FOOT	869
ELECTRIC CABLE IN CONDUIT, SIGNAL NO. 14 3C	FOOT	648
ELECTRIC CABLE IN CONDUIT, SIGNAL NO. 14 5C	FOOT	458
ELECTRIC CABLE IN CONDUIT, SIGNAL NO. 14 7C	FOOT	156
TRAFFIC SIGNAL POST, GALVANIZED STEEL 14 FT.	EACH	1
TRAFFIC SIGNAL POST, GALVANIZED STEEL 16 FT.	EACH	1
DRILL EXISTING HANDHOLE	EACH	5
SIGNAL HEAD, LED, 1-FACE, 3-SECTION, MAST-ARM MOUNTED	EACH	3
SIGNAL HEAD, LED, 1-FACE, 3-SECTION, BRACKET MOUNTED	EACH	5
SIGNAL HEAD, LED, 1-FACE, 5-SECTION, BRACKET MOUNTED	EACH	1
SIGNAL HEAD, LED, 1-FACE, 5-SECTION, MAST-ARM MOUNTED	EACH	1
PEDESTRIAN SIGNAL HEAD, LED, 1-FACE, BRACKET MOUNTED WITH COUNTDOWN TIMER	EACH	8
TRAFFIC SIGNAL BACKPLATE, LOUVERED, FORMED PLASTIC	EACH	4
PEDESTRIAN PUSH-BUTTON	EACH	8
RELOCATE EXISTING EMERGENCY VEHICLE PRIORITY SYSTEM, PHASING UNIT	EACH	1
MODIFY EXISTING CONTROLLER FOUNDATION	EACH	1
REMOVE EXISTING TRAFFIC SIGNAL EQUIPMENT	EACH	1
LED INTERNALLY ILLUMINATED STREET NAME SIGN	EACH	4
FULL-ACTUATED CONTROLLER AND TYPE SUPER P CABINET (SPECIAL)	EACH	1
PEDESTRIAN SIGNAL POST, 10 FT.	EACH	1
ELECTRIC CABLE IN CONDUIT, STREET NAME SIGN, NO. 14 3C, TYPE SOOW	FOOT	586
RELOCATE EXISTING SIGNS	EACH	2
UNINTERRUPTABLE POWER SUPPLY, SPECIAL	EACH	1
CONCRETE FOUNDATION, TYPE A 10-INCH DIAMETER	FOOT	4

**TS SHT NO.32** 

G V GEWALT HAMILTON ASSOCIATES, INC.

Black @ Brentwood - Springfield Sign.dgn


JSER NAME = zwallsten DESIGNED -DPB REVISED DRAWN -ZCW REVISED CHECKED -DPB REVISED PLOT DATE = 8/20/2020 REVISED 8/21/2020


STATE OF ILLINOIS **DEPARTMENT OF TRANSPORTATION** 

L.E.D. ILLUMINATED MAST ARM MOUNTED STREET NAME SIGNS AND SCHEDULE OF QUANTITIES BLACK ROAD AT BRENTWOOD DRIVE /SPRINGFIELD AVENUE SCALE: None SHEET SHEETS STA.

**JOLIET ECON 1** 18-00517-00-TL WILL 72 32 CONTRACT NO. 61G36

SECTION

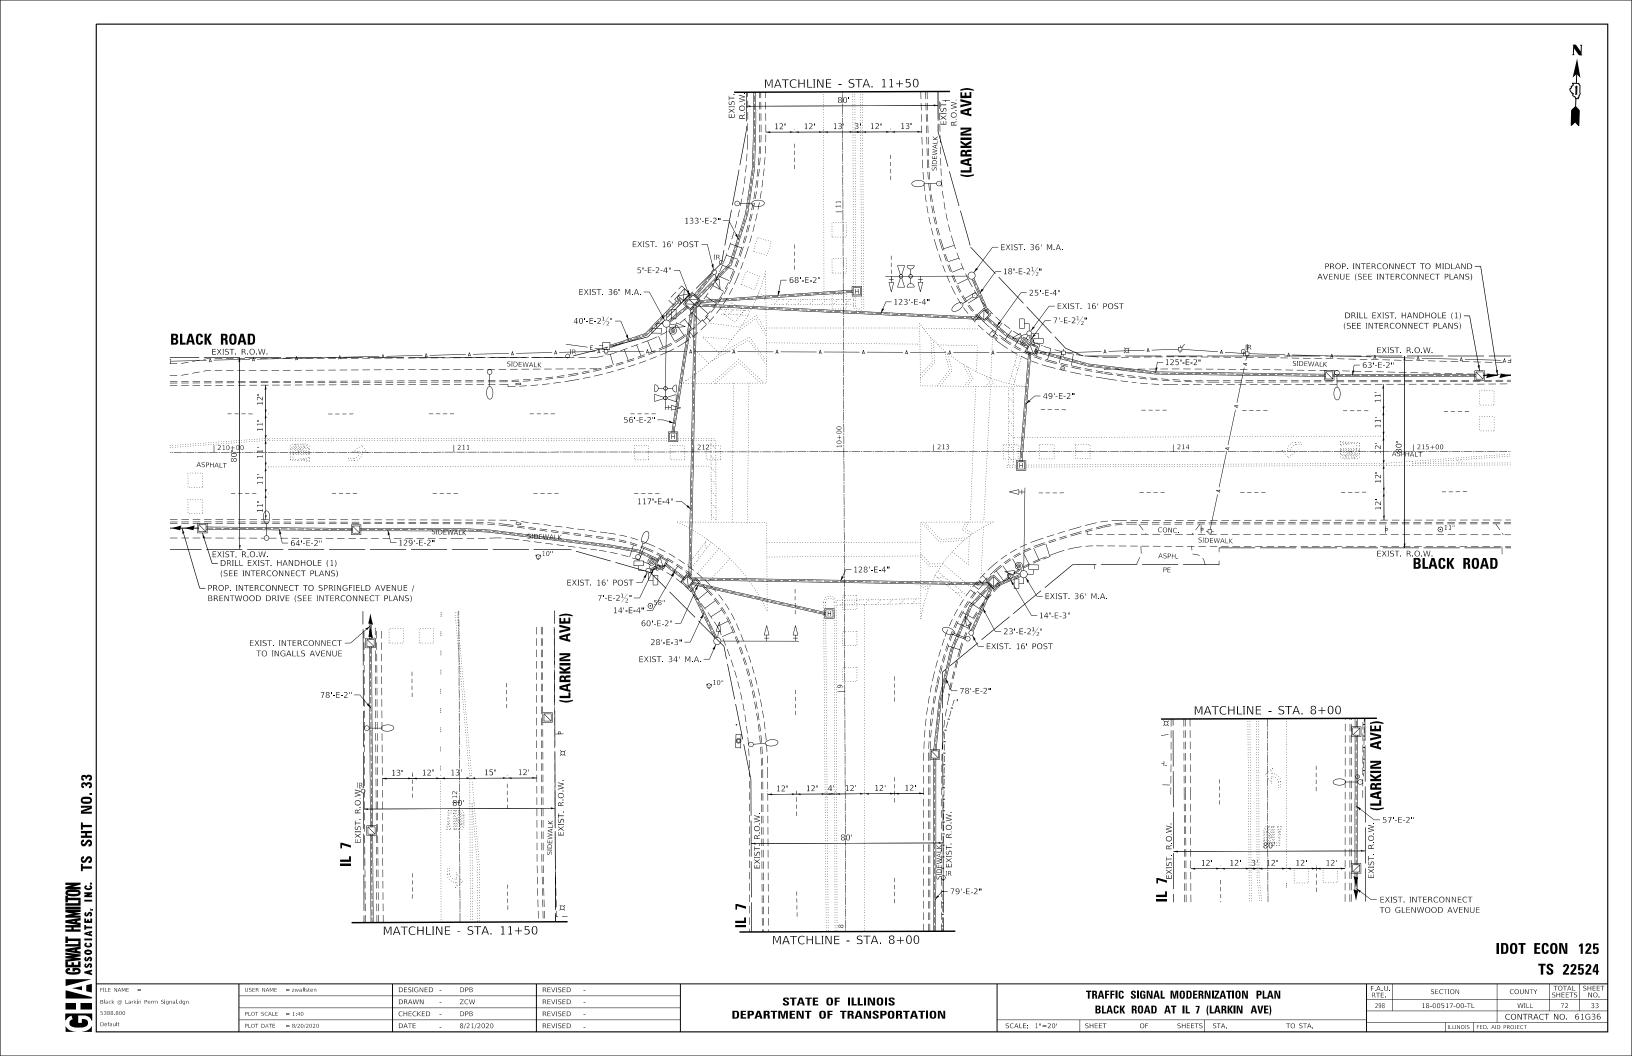

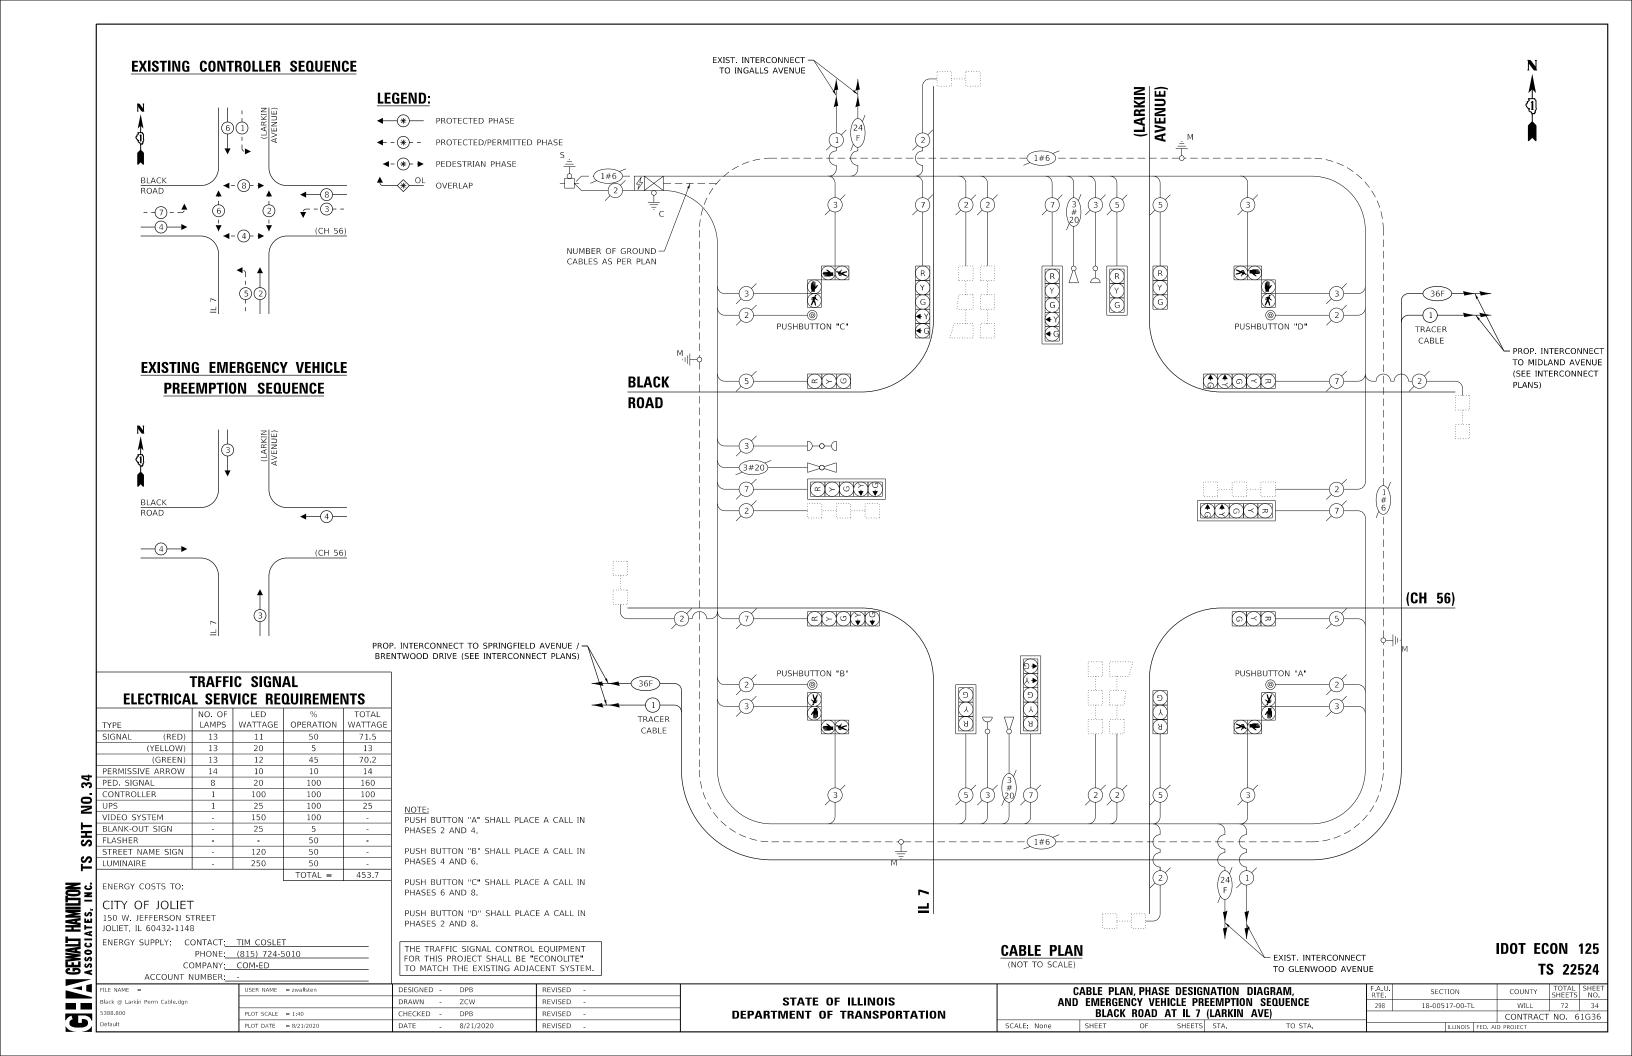

ITEM DESCRIPTION	UNITS	TOTAL QTY.
MAINTENANCE OF EXISTING TRAFFIC SIGNAL INSTALLATION	EACH	1

**SCHEDULE OF QUANTITIES** 

ASSOCIATES, INC. TS SHT NO.35

EITE NAME =
Black @ Tarkin Sidu du
2388.800
Default

USER NAME = zwallsten DESIGNED - DPB REVISED -DRAWN -ZCW REVISED -REVISED -PLOT SCALE = 1:40 CHECKED -PLOT DATE = 8/20/2020

STATE OF ILLINOIS
DEPARTMENT OF TRANSPORTATION

SCHEDULE OF QUANTITIES BLACK ROAD AT IL 7 (LARKIN AVE) OF SHEETS STA.

TS 22524 COUNTY TOTAL SHEET NO.
WILL 72 35
CONTRACT NO. 61G36 SECTION 18-00517-00-TL

IDOT ECON 125

**DEPARTMENT OF TRANSPORTATION** 

**JOLIET ECON 1** 

CONTRACT NO. 61G36

72

WILL

18-00517-00-TL

**BLACK ROAD AT MIDLAND AVENUE** 

SCALE: 1"=20"

SHT

GEWALT ASSOCIA

**T** 

ack @ Midland Perm Signal.dgn

PLOT DATE = 8/20/202

DRAWN

ZCW

DPB


8/21/2020

REVISED

REVISED

REVISED

#### **EXISTING CONTROLLER SEQUENCE**

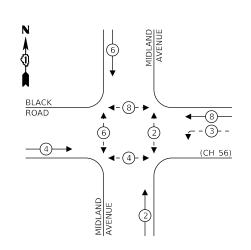

#### LEGEND:


**★** PROTECTED PHASE

← -(\*)- - PROTECTED/PERMITTED PHASE

√-(\*)- PEDESTRIAN PHASE

♦ OL OVERLAP

#### **EXISTING EMERGENCY VEHICLE** PREEMPTION SEQUENCE

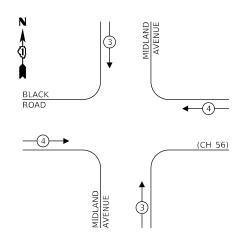

#### TRAFFIC SIGNAL **ELECTRICAL SERVICE REQUIREMENTS** NO. OF LED

	TYPE	LAMPS	WATTAGE	OPERATION	WATTAGE
	SIGNAL (RED)	12	11	50	66
	(YELLOW)	12	20	5	12
	(GREEN)	12	12	45	64.8
	PERMISSIVE ARROW	4	10	10	4
,	PED. SIGNAL	8	20	100	160
:	CONTROLLER	1	100	100	100
	UPS	1	25	100	25
•	VIDEO SYSTEM	-	150	100	=
	BLANK-OUT SIGN	-	25	5	=
,	FLASHER	-	-	50	
	STREET NAME SIGN	4	120	50	240
•	LUMINAIRE	4	250	50	500
				TOTAL =	1,171.8

ENERGY COSTS TO:

CITY OF JOLIET

150 W. JEFFERSON STREET JOLIET, IL 600432-1148

ENERGY SUPPLY: CONTACT: TIM COSLET PHONE: (815) 724-5010

COMPANY: COM-ED ACCOUNT NUMBER:

lack @ Midland Perm Cable.dgr

JSER NAME = zwallsten PLOT DATE = 8/20/2020

TO MATCH THE EXISTING ADJACENT SYSTEM. DESIGNED -REVISED

ZCW

DPB

8/21/2020

DRAWN -

HECKED

DATE

#### NUMBER OF GROUND CABLES AS PER PLAN ≫. ₹ TRACER Black Rd CABLE - PROP. INTERCONNECT TO RAYNOR AVENUE / PLAINFIELD ROAD (U.S. 30) (SEE INTERCONNECT PLANS) **BLACK** 2#10 ROAD 1)---(1 (CH 56) - ~ > o <del>></del> o 2#10 Black Rd 1) Я TRACER CABLE PROP. INTERCONNECT TO LARKIN-AVENUE (SEE INTERCONNECT PLANS) - 1#6 MIDLAND AVENUE **CABLE PLAN**

1#6)-

MIDLAND

THE TRAFFIC SIGNAL CONTROL EQUIPMENT FOR THIS PROJECT SHALL BE "ECONOLITE"

REVISED

REVISED

REVISED

#### **JOLIET ECON 1**

STATE OF ILLINOIS **DEPARTMENT OF TRANSPORTATION** SCALE: None


CABLE PLAN, PHASE DESIGNATION DIAGRAM, AND EMERGENCY VEHICLE PREEMPTION SEQUENCE SECTION **BLACK ROAD AT MIDLAND AVENUE** SHEETS STA.

18-00517-00-TL WILL 72 37 CONTRACT NO. 61G36


### SHT NO. 37 TS

GEWALT |

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DESIGN	AREA	SIGN PANEL	SHEETING	QTY.
SERIES	(SQ FT)	TYPE	TYPE	REQUIRED
D	6.75	1	ZZ	2

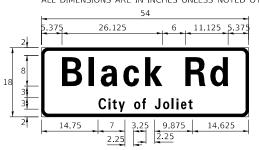

DESIGN	AREA	SIGN PANEL	SHEETING	QTY.
SERIES	SERIES (SQ FT)		TYPE	REQUIRED
D	8.25	1	ZZ	2

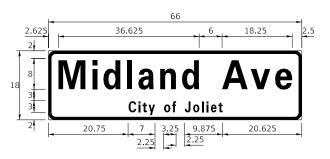NOTE: FOR ADDITIONAL DESIGN AND INSTALLATION INFORMATION PLEASE SEE DISTRICT ONE MAST ARM MOUNTED STREET NAME SIGNS DETAIL.

#### **SCHEDULE OF QUANTITIES**

ITEM DESCRIPTION	UNITS	TOTAL QTY.
REMOVE SIGN PANEL - TYPE 1	SQ FT	30
UNDERGROUND CONDUIT, GALVANIZED STEEL, 3" DIA.	FOOT	54
MAINTENANCE OF EXISTING TRAFFIC SIGNAL INSTALLATION	EACH	1
ELECTRIC CABLE IN CONDUIT, SIGNAL NO. 14 2C	FOOT	1,026
DRILL EXISTING HANDHOLE	EACH	4
SIGNAL HEAD, LED, 1-FACE, 3-SECTION, MAST-ARM MOUNTED	EACH	7
SIGNAL HEAD, LED, 1-FACE, 3-SECTION, BRACKET MOUNTED	EACH	3
SIGNAL HEAD, LED, 1-FACE, 5-SECTION, BRACKET MOUNTED	EACH	1
SIGNAL HEAD, LED, 1-FACE, 5-SECTION, MAST-ARM MOUNTED	EACH	1
PEDESTRIAN SIGNAL HEAD, LED, 1-FACE, BRACKET MOUNTED WITH COUNTDOWN TIMER	EACH	8
TRAFFIC SIGNAL BACKPLATE, LOUVERED, FORMED PLASTIC	EACH	8
PEDESTRIAN PUSH-BUTTON	EACH	8
RELOCATE EXISTING EMERGENCY VEHICLE PRIORITY SYSTEM, PHASING UNIT	EACH	1
MODIFY EXISTING CONTROLLER FOUNDATION	EACH	1
REMOVE EXISTING TRAFFIC SIGNAL EQUIPMENT	EACH	1
LED INTERNALLY ILLUMINATED STREET NAME SIGN	EACH	4
FULL-ACTUATED CONTROLLER AND TYPE SUPER P CABINET (SPECIAL)	EACH	1
PEDESTRIAN SIGNAL POST, 5 FT.	EACH	4
ELECTRIC CABLE IN CONDUIT, STREET NAME SIGN, NO. 14 3C, TYPE SOOW	FOOT	621
UNINTERRUPTABLE POWER SUPPLY, SPECIAL	EACH	1
CONCRETE FOUNDATION, TYPE A 10-INCH DIAMETER	FOOT	16

TS SHT NO.38

G V GEWALT HAMILTON ASSOCIATES, INC.


JSER NAME = zwallsten DESIGNED - DPB REVISED DRAWN -ZCW REVISED PLOT SCALE = 1:40 CHECKED -DPB REVISED PLOT DATE = 8/20/2020 REVISED DATE 8/21/2020

**DEPARTMENT OF TRANSPORTATION** 

L.E.D. ILLUMINATED MAST ARM MOUNTED STREET NAME SIGNS AND SCHEDULE OF QUANTITIES **BLACK ROAD AT MIDLAND AVENUE** SCALE: None OF SHEETS STA.

**JOLIET ECON 1** COUNTY COUNTY SHEETS NO.
WILL 72 38 18-00517-00-TL CONTRACT NO. 61G36

SECTION

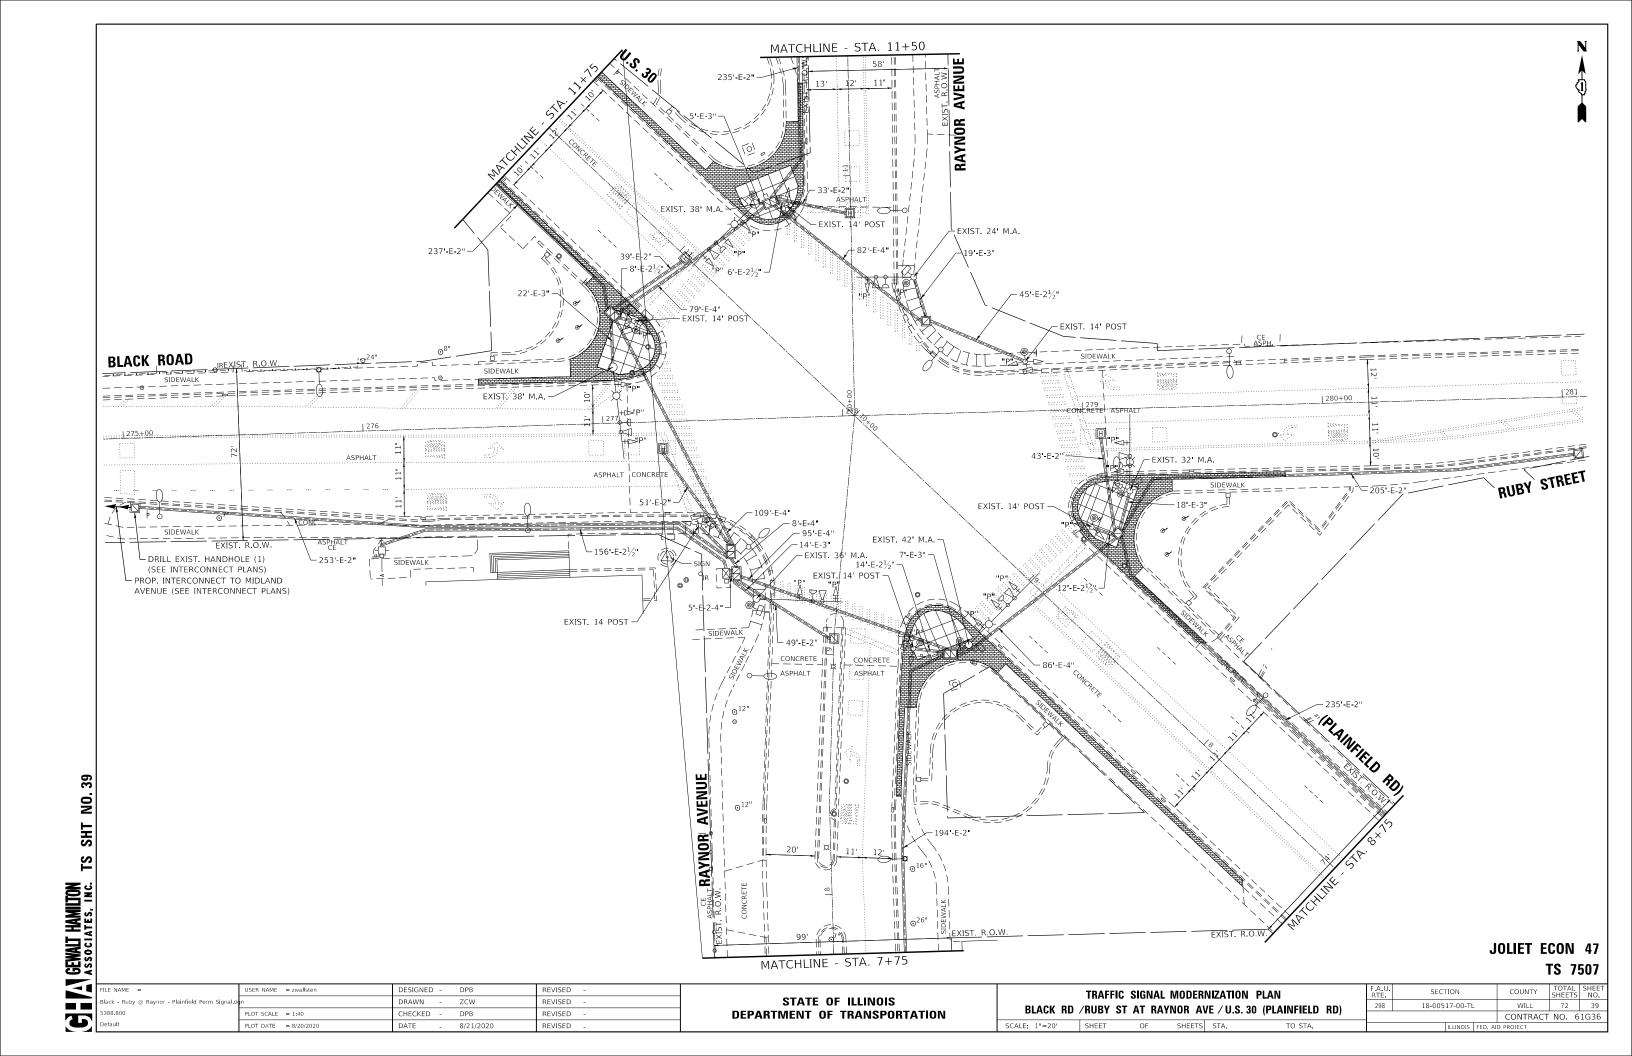

JSER NAME = zwallsten DESIGNED -DPB REVISED DRAWN -ZCW REVISED PLOT SCALE = 1:40 CHECKED -DPB REVISED 8/21/2020 REVISED

STATE OF ILL DEPARTMENT OF TRA

TRAFFIC SIGNAL MODERNIZATION PLAN BLACK RD /RUBY ST AT RAYNOR AVE / U.S. 30 (PLAINFIELD RD)

AVENUE

COUNTY TOTAL SHEET NO.


WILL 72 40


CONTRACT NO. 61G36 SECTION 18-00517-00-TL

**JOLIET ECON 47** 

TS 7507

MATCHLINE - STA. 7+75 AVENUE RAYNOR SINGE EXIST. INTERCONNECT TO DOUGLAS STREET

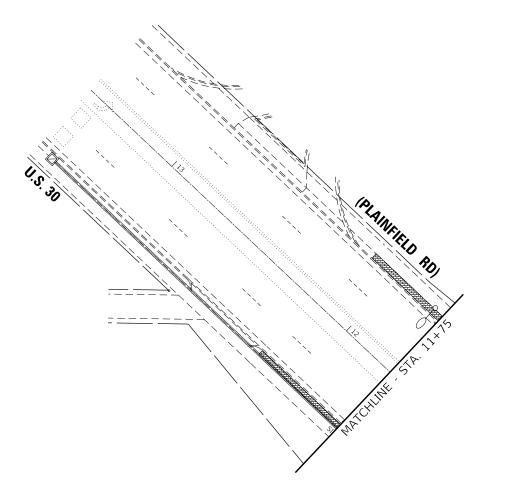


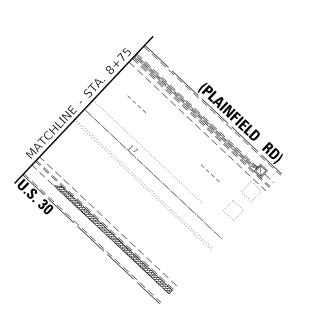

MATCHLINE - STA. 11+50

LINOIS	
ANSPORTATION	

RAYNOR

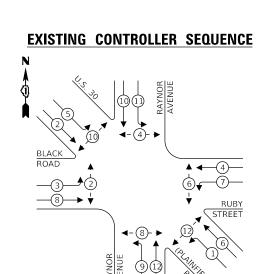

#### LEGEND:

**★** PROTECTED PHASE

← -(\*)- - PROTECTED/PERMITTED PHASE

**BLACK ROAD** 

> TRACER CABLE


NUMBER OF GROUND -CABLES AS PER PLAN

PROP. INTERCONNECT TO MIDLAND -

AVENUE (SEE INTERCONNECT PLAN)

√-(\*)- ► PEDESTRIAN PHASE

♦ OL OVERLAP

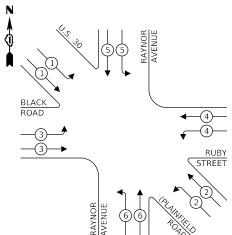

#### TRAFFIC SIGNAL **ELECTRICAL SERVICE REQUIREMENTS**

NO. OF LED % TOTAL

TYPE	LAMPS	WATTAGE	OPERATION	WATTAGE
SIGNAL (RED)	29	11	50	159.5
(YELLOW)	29	20	5	116
(GREEN)	29	12	45	156.6
PERMISSIVE ARROW	-	10	10	-
PED. SIGNAL	12	20	100	240
CONTROLLER	1	100	100	100
UPS	1	25	100	25
VIDEO SYSTEM	-	150	100	-
BLANK-OUT SIGN	-	25	5	-
FLASHER	-	-	50	-
STREET NAME SIGN	-	120	50	-
LUMINAIRE	4	250	50	500
			TOTAL =	1,297.1

ENERGY COSTS TO:

GEWALT ASSOCIA

CITY OF JOLIET

150 W. JEFFERSON STREET JOLIET, IL 600432-1148

ENERGY SUPPLY: CONTACT: TIM COSLET PHONE: (815) 724-5010

COMPANY: COM-ED ACCOUNT NUMBER:

JSER NAME = zwallsten DESIGNED -DRAWN -ZCW REVISED REVISED PLOT DATE = 8/20/2020 REVISED 8/21/2020

THE TRAFFIC SIGNAL CONTROL EQUIPMENT FOR THIS PROJECT SHALL BE "ECONOLITE" TO MATCH THE EXISTING ADJACENT SYSTEM.

STATE OF ILLINOIS **DEPARTMENT OF TRANSPORTATION** 

RAYNOR AVENUE

EXIST. INTERCONNECT

TO DOUGLAS STREET

**CABLE PLAN** 

CABLE PLAN, PHASE DESIGNATION DIAGRAM, AND EMERGENCY VEHICLE PREEMPTION SEQUENCE BLACK RD /RUBY ST AT RAYNOR AVE / U.S. 30 (PLAINFIELD RD) SHEETS STA.

RAYNOR AVENUE

SECTION 18-00517-00-TL WILL 72 41 CONTRACT NO. 61G36

**RUBY** 

**STREET** 

**JOLIET ECON 47** TS 7507

# **EXISTING EMERGENCY VEHICLE** PREEMPTION SEQUENCE

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# G V GEWALT HAMILTON TS SH

#### **SCHEDULE OF QUANTITIES**

ITEM DESCRIPTION	UNITS	TOTAL QTY.
MAINTENANCE OF EXISTING TRAFFIC SIGNAL INSTALLATION	EACH	1

JOLIET ECON 47 TS 7507

 USER NAME
 = zwalisten
 DESIGNED
 DPB
 REVISED

 DRAWN
 ZCW
 REVISED

 PLOT SCALE
 = 1:40
 CHECKED
 DPB
 REVISED

 PLOT DATE
 = 8/20/2020
 DATE
 8/21/2020
 REVISED

STATE OF ILLINOIS
DEPARTMENT OF TRANSPORTATION


SCHEDULE OF QUANTITIES


BLACK RD /RUBY ST AT RAYNOR AV /PLAINFIELD RD /U.S. 30

SCALE: None SHEET OF SHEETS STA. TO STA.

A.U. SECTION COUNTY TOTAL SHEETS NO.
98 18-00517-00-TL WILL 72 42

CONTRACT NO. 61G36

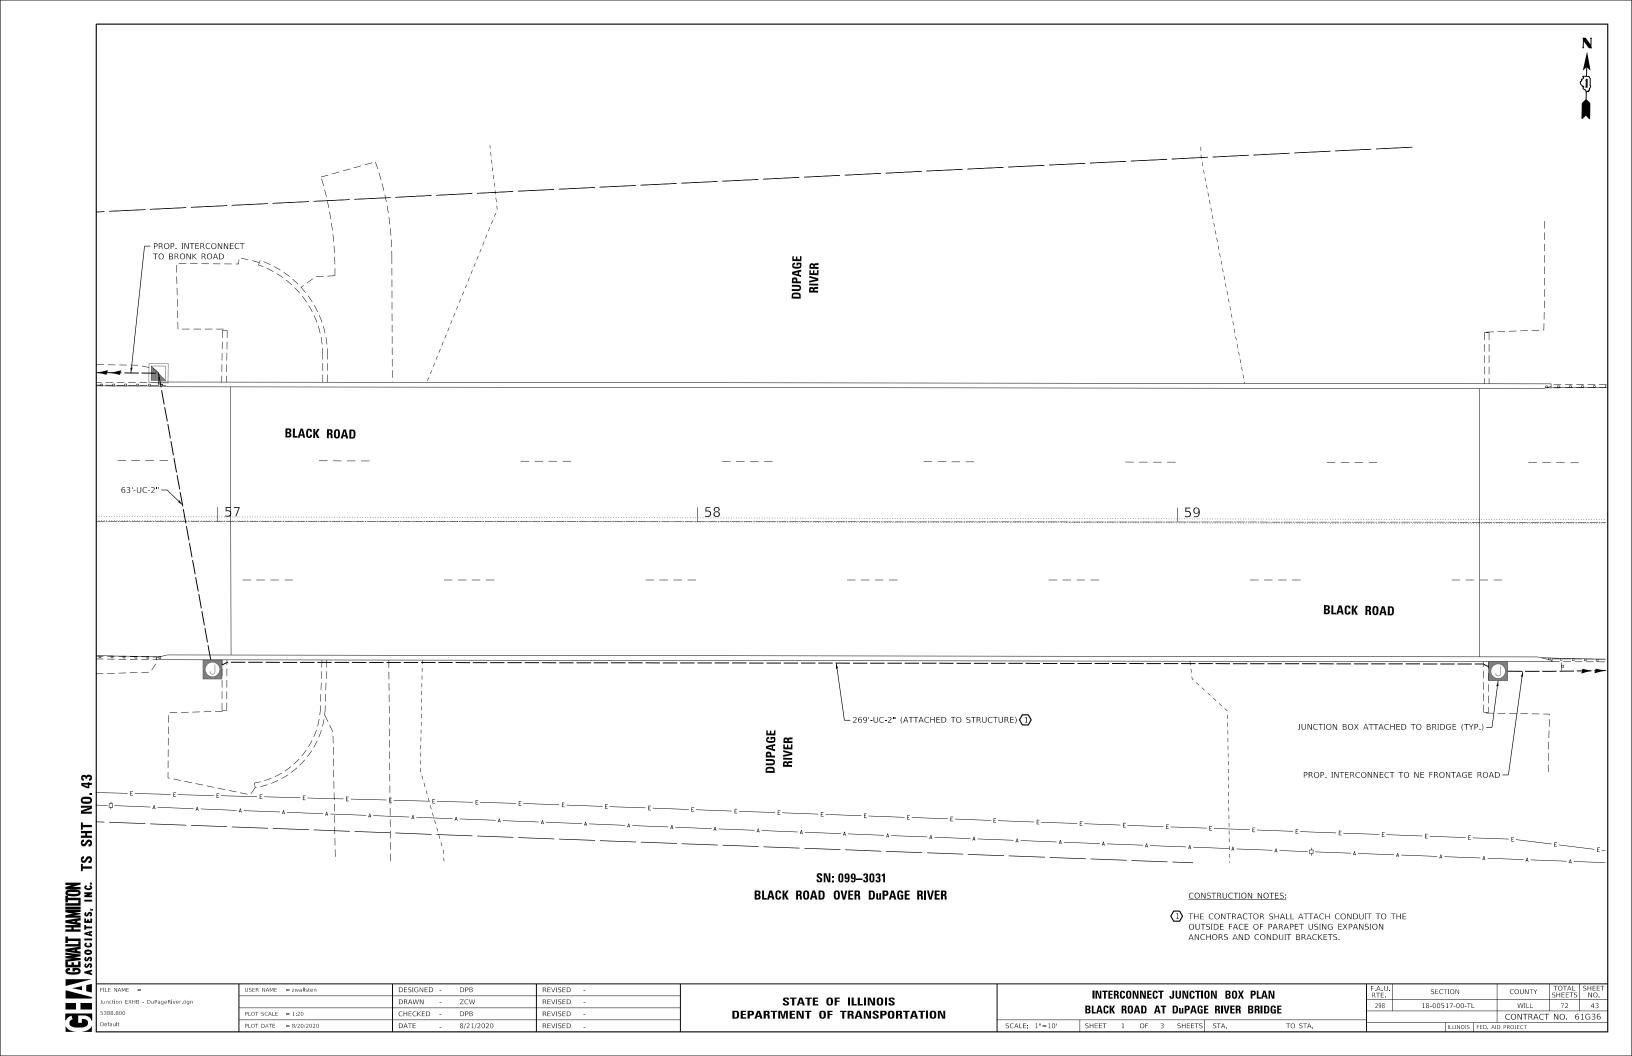

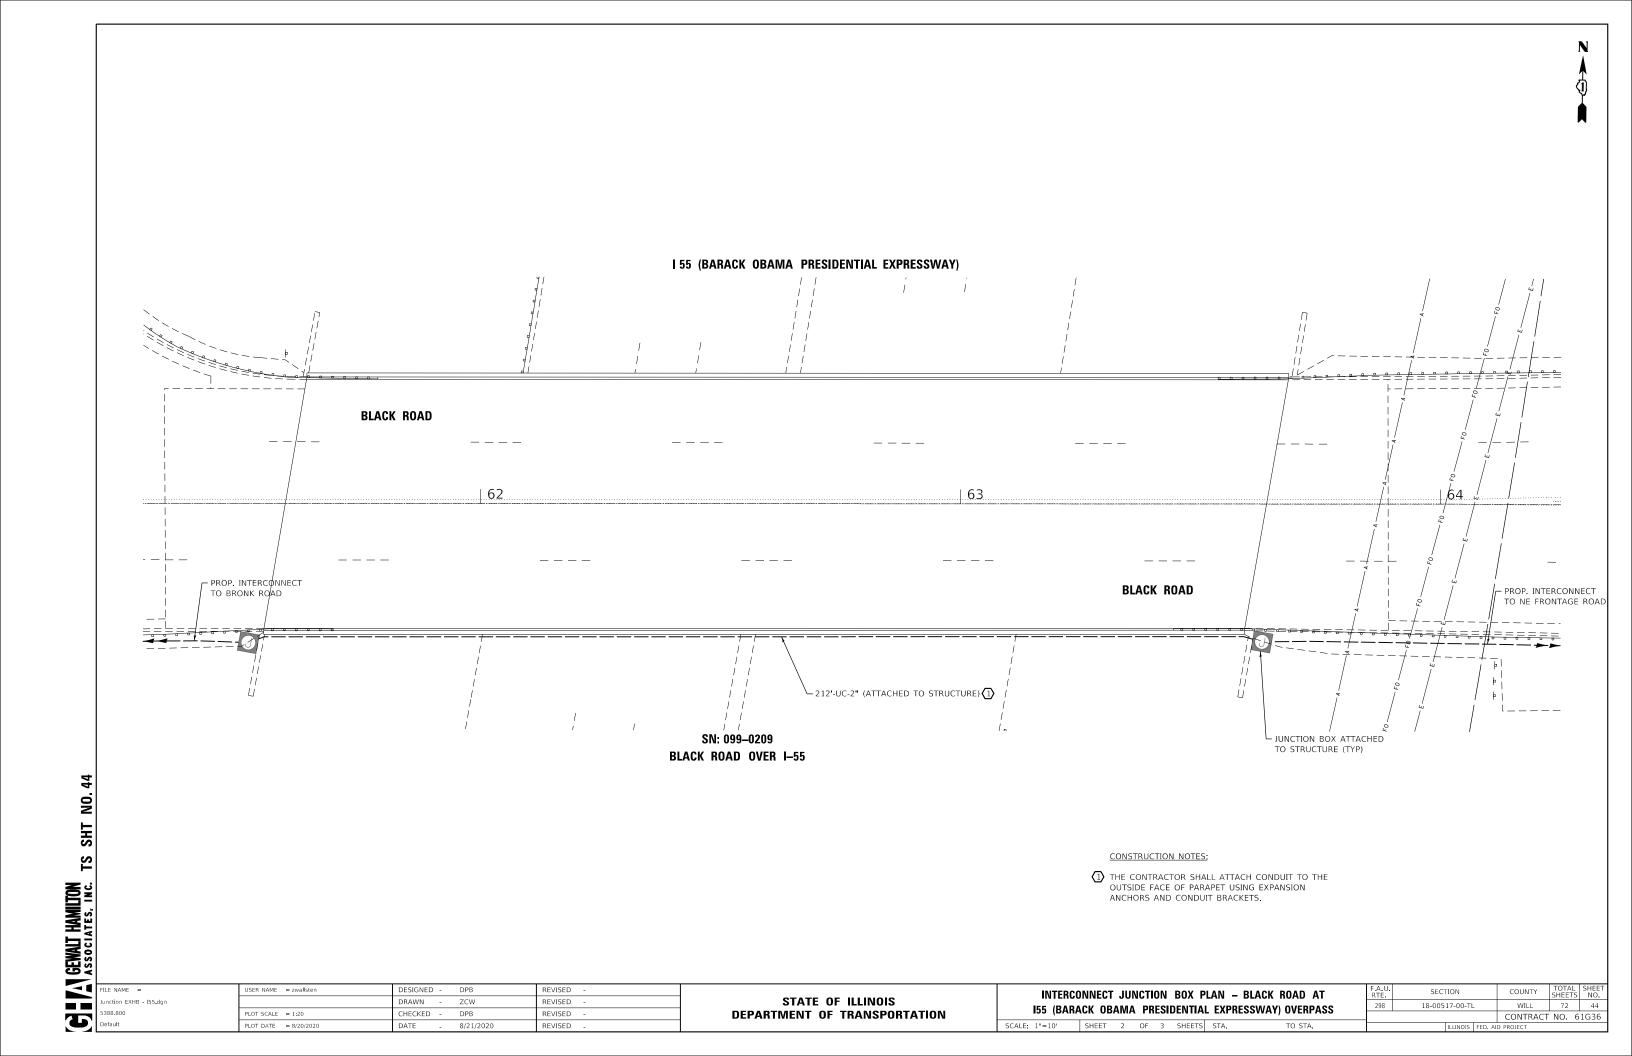


unction EXHB - RockRunCreek.dan


388.800


SN: 099-3033 BLACK ROAD OVER ROCK RUN CREEK CONSTRUCTION NOTES: THE CONTRACTOR SHALL ATTACH CONDUIT TO THE OUTSIDE FACE OF PARAPET USING EXPANSION ANCHORS AND CONDUIT BRACKETS. USER NAME = zwallsten DESIGNED - DPB REVISED SECTION INTERCONNECT JUNCTION BOX PLAN STATE OF ILLINOIS DRAWN -ZCW REVISED 18-00517-00-TL BLACK ROAD AT ROCK RUN CREEK BRIDGE DPB REVISED **DEPARTMENT OF TRANSPORTATION** PLOT DATE = 8/20/2020 SCALE: 1"=10' SHEET 3 OF 3 SHEETS STA. 8/21/2020


COUNTY SHEETS NO.
WILL 72 45


CONTRACT NO. 61G36

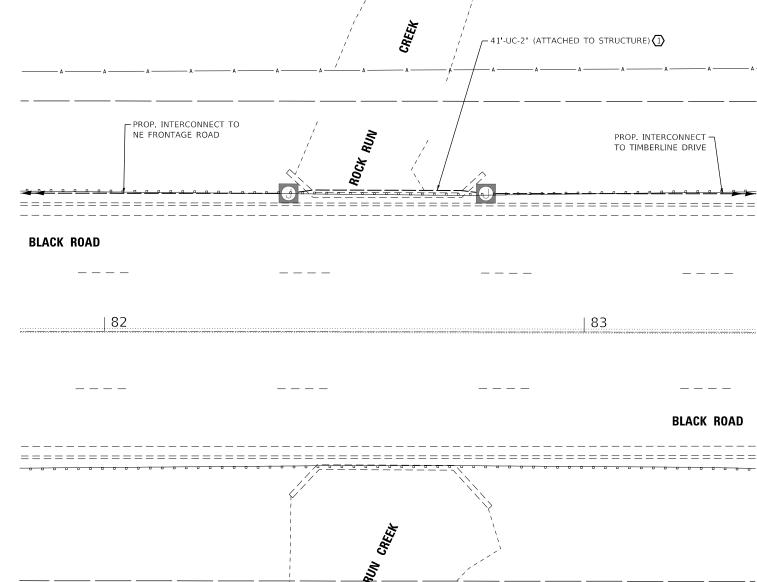


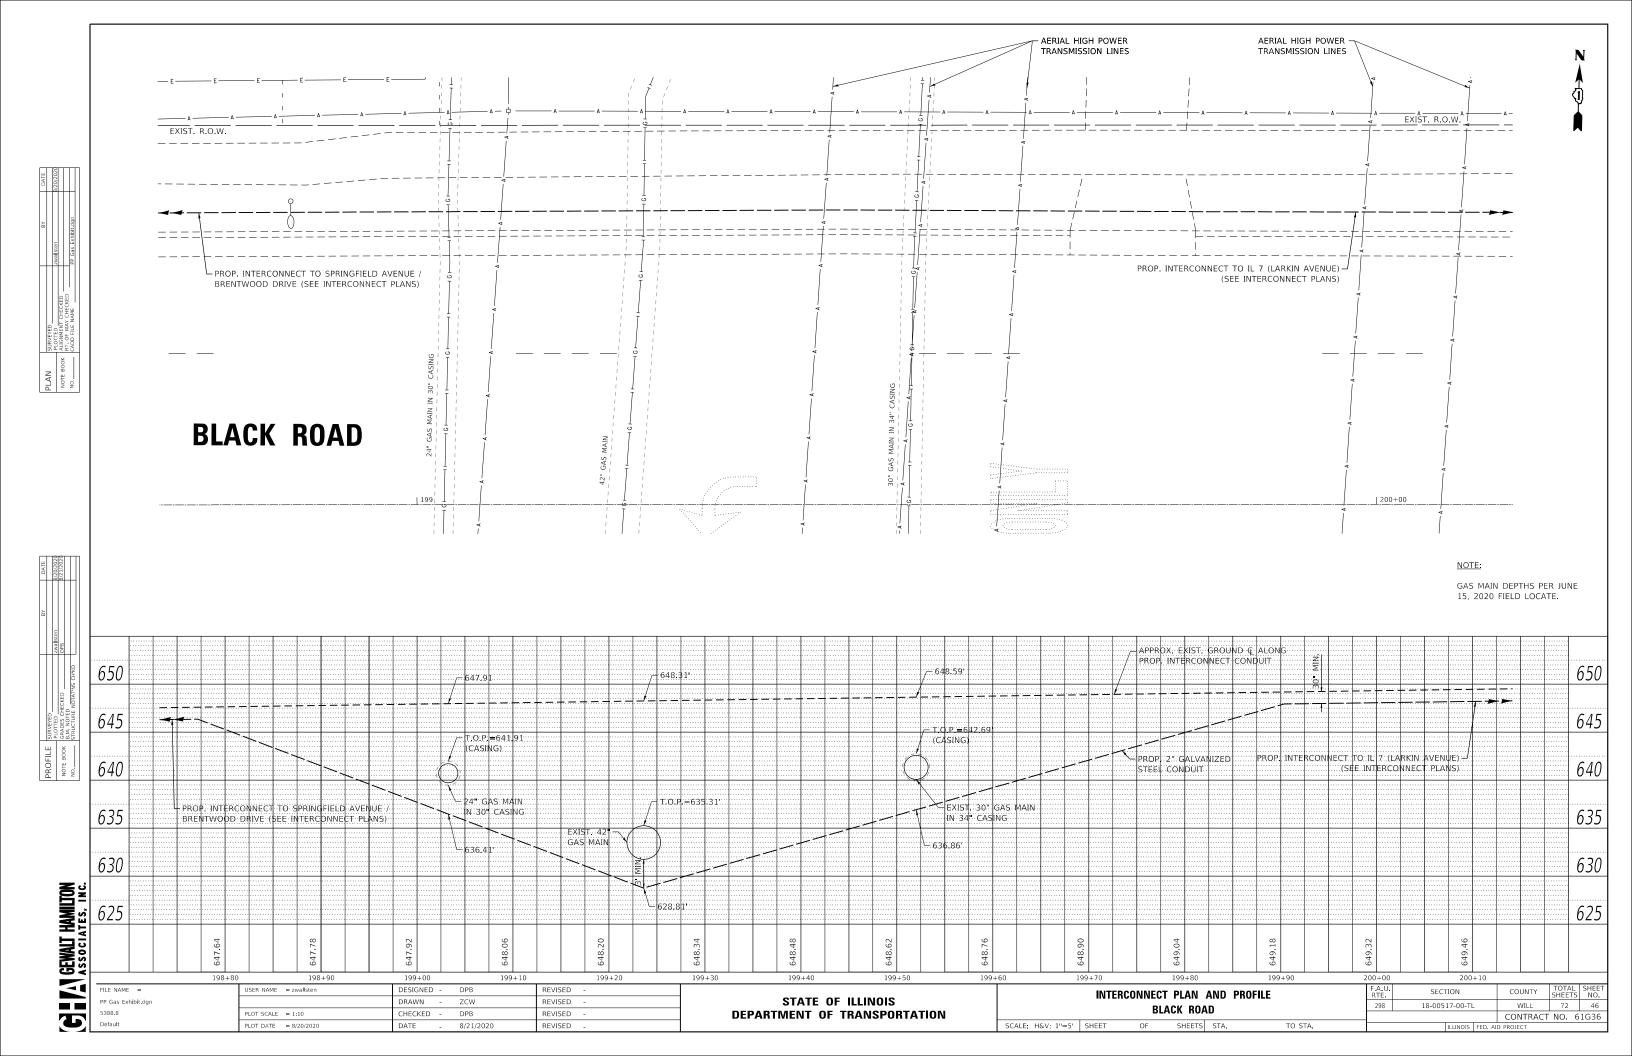


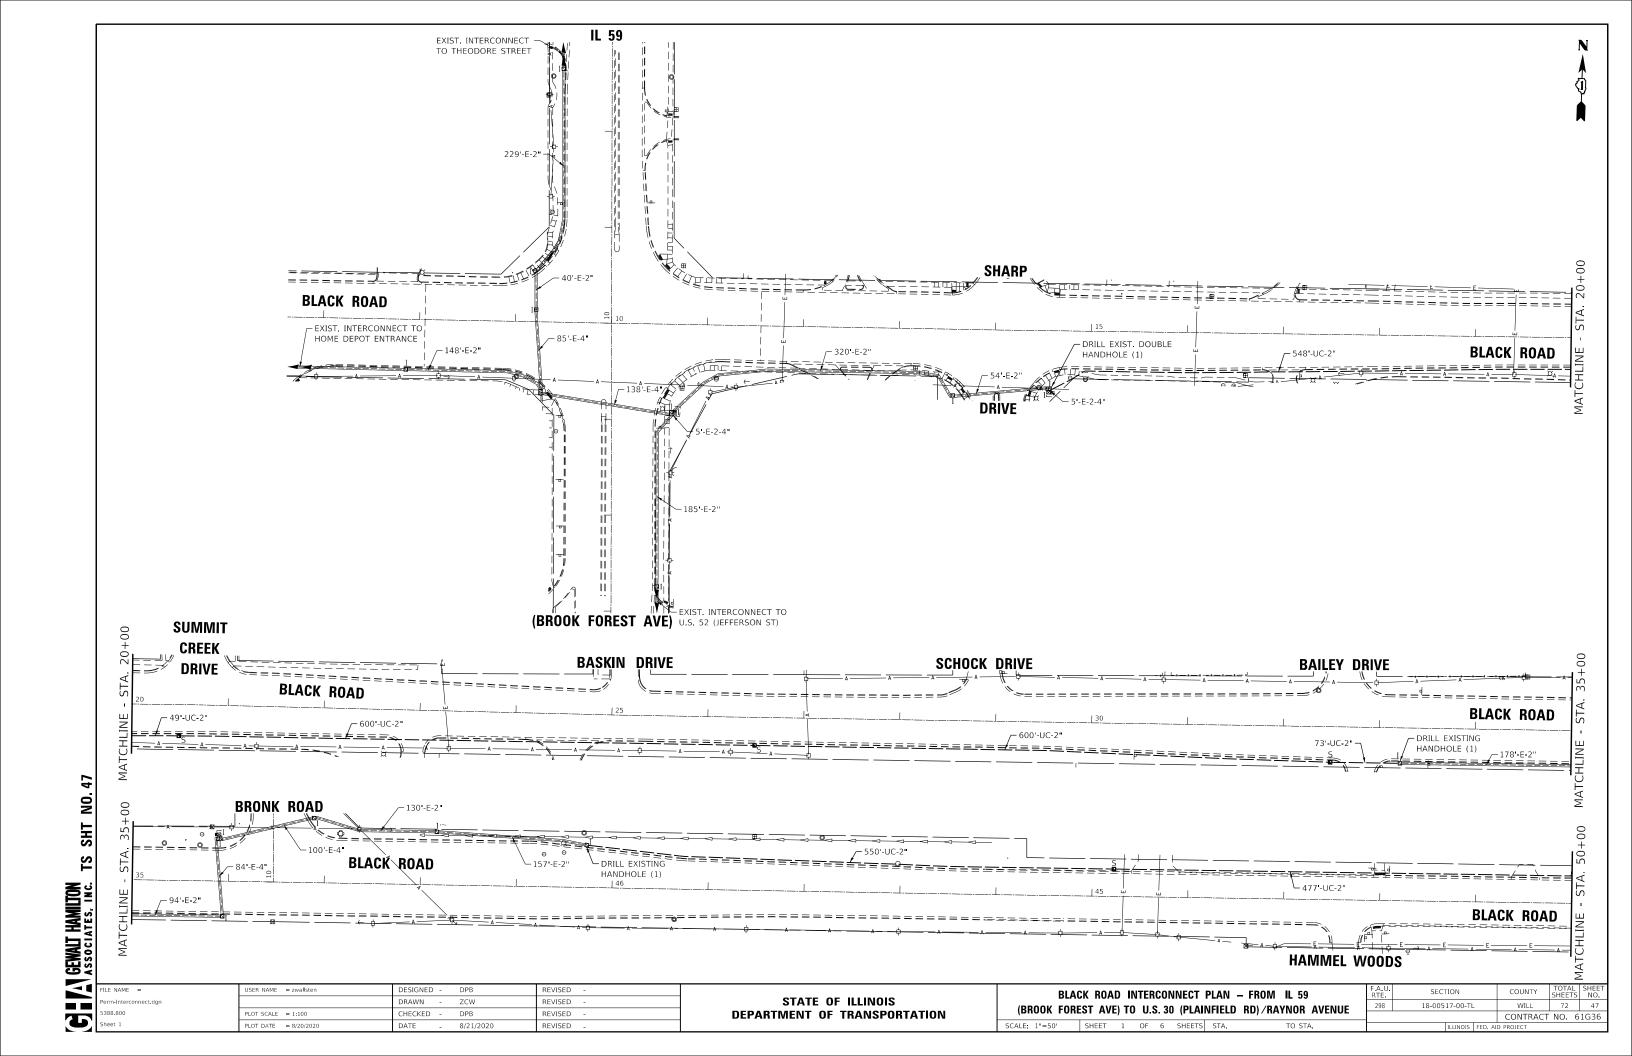


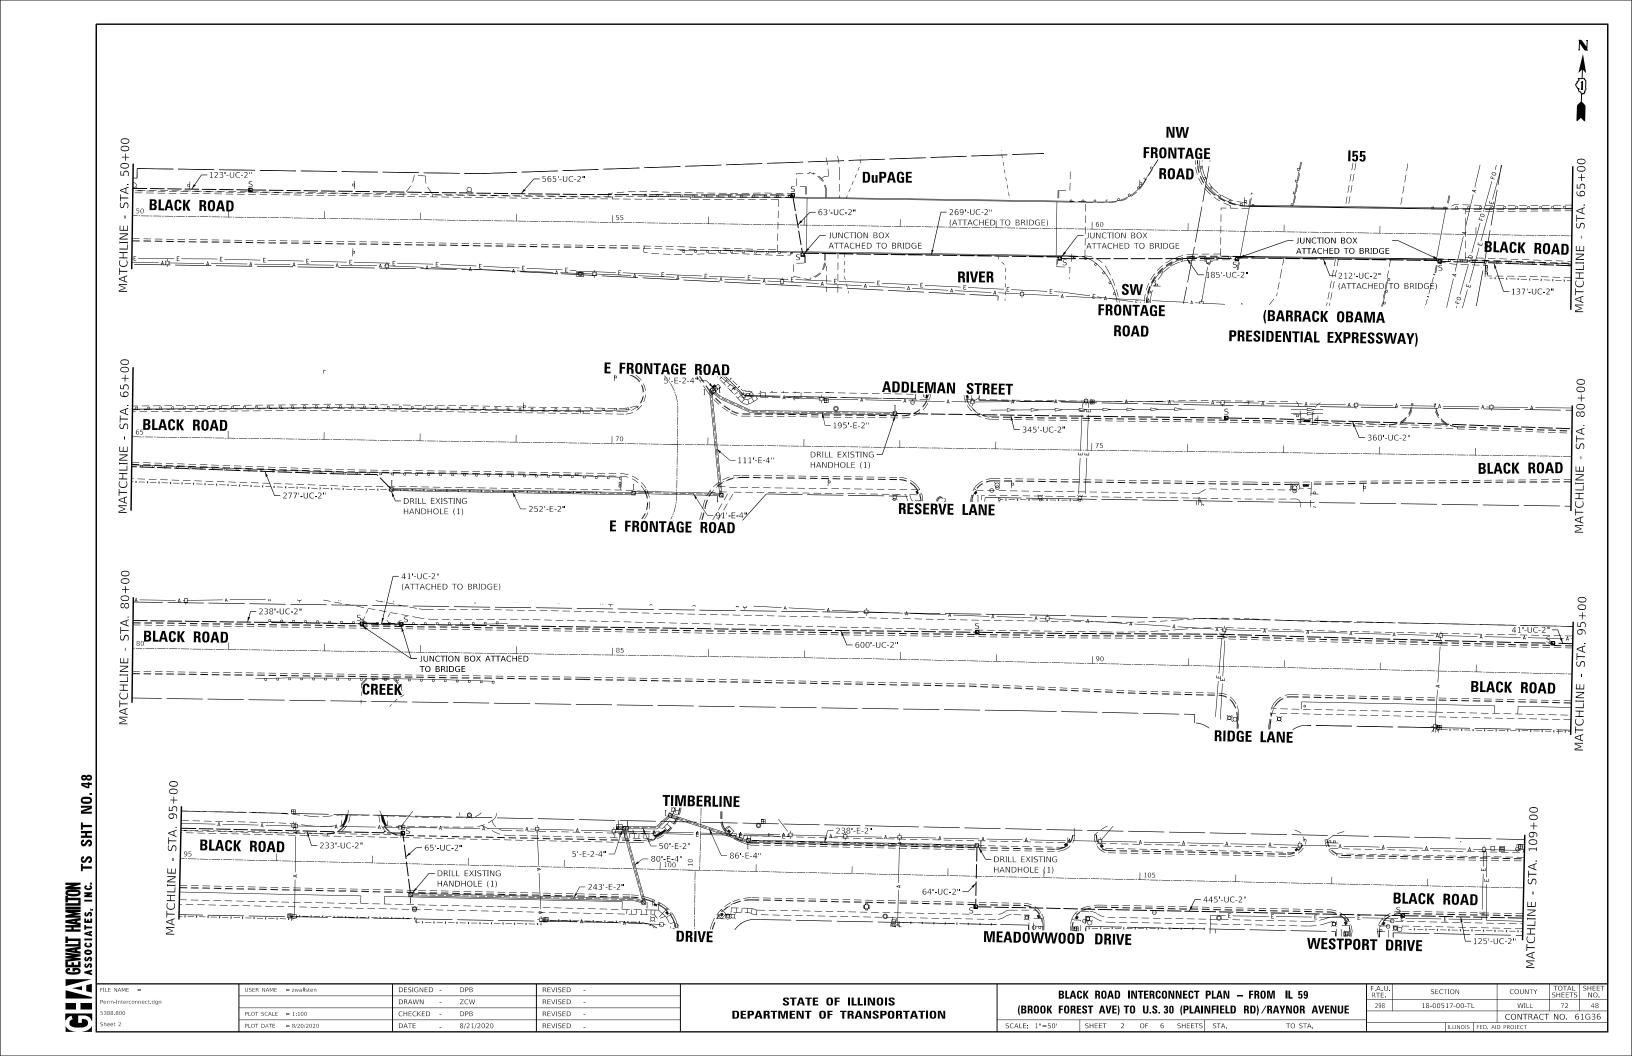

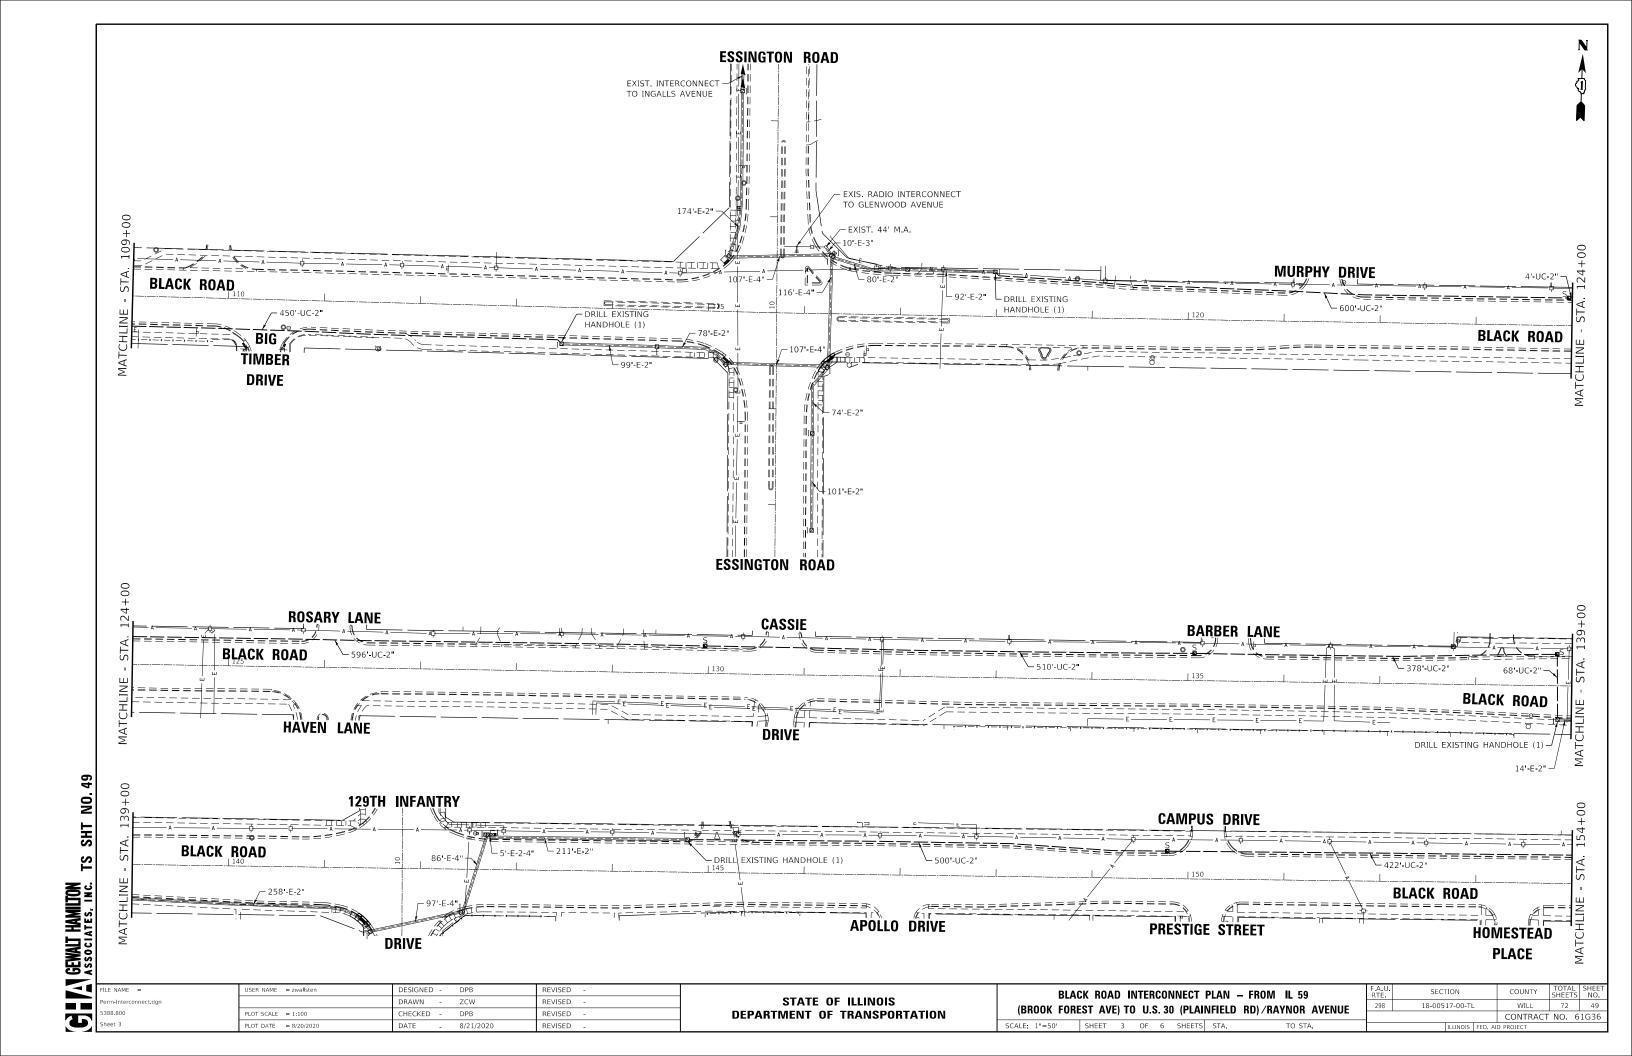

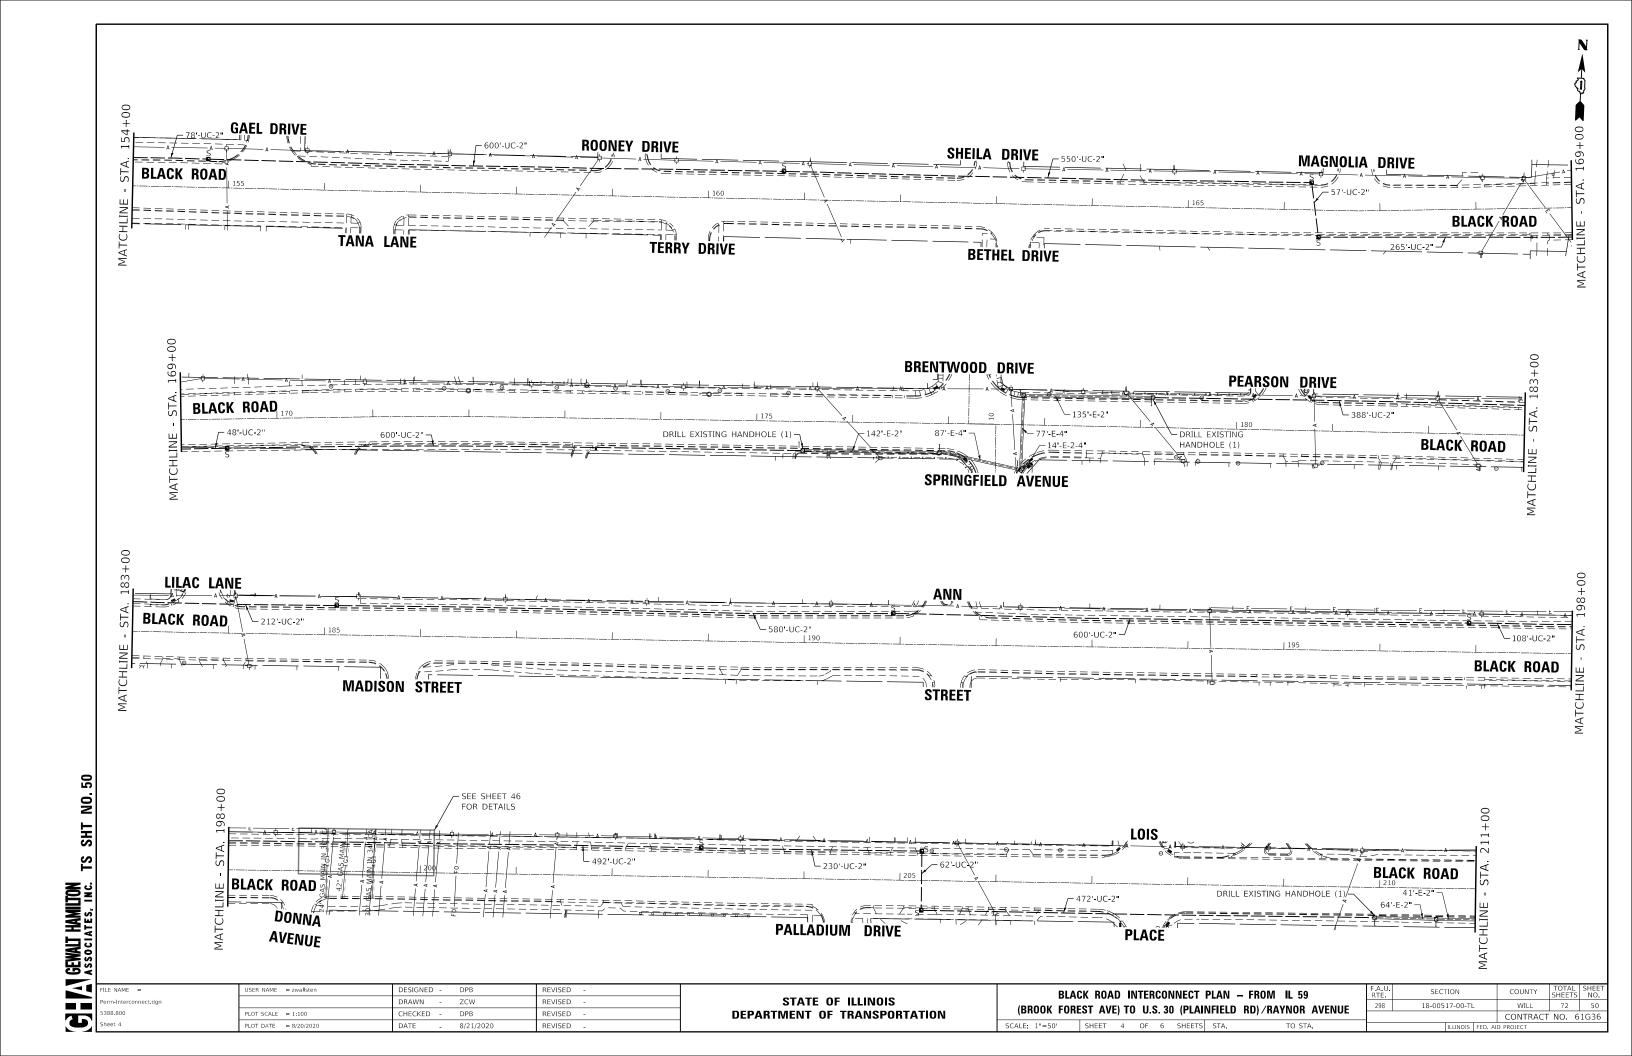

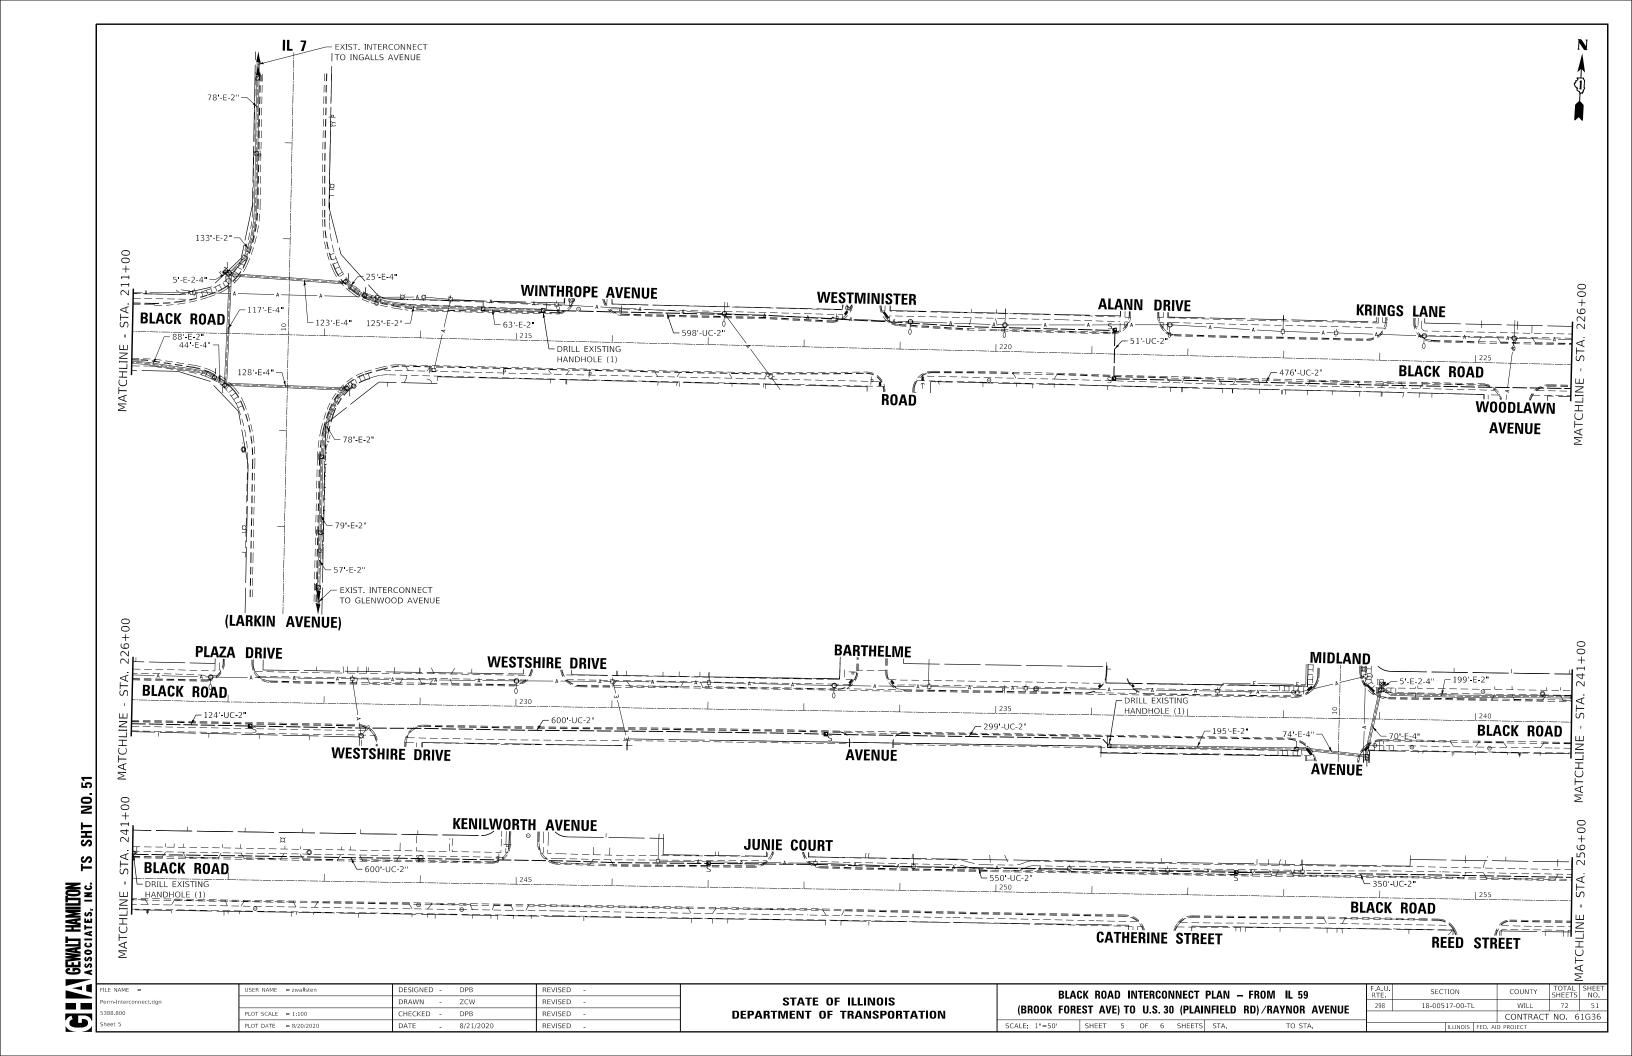

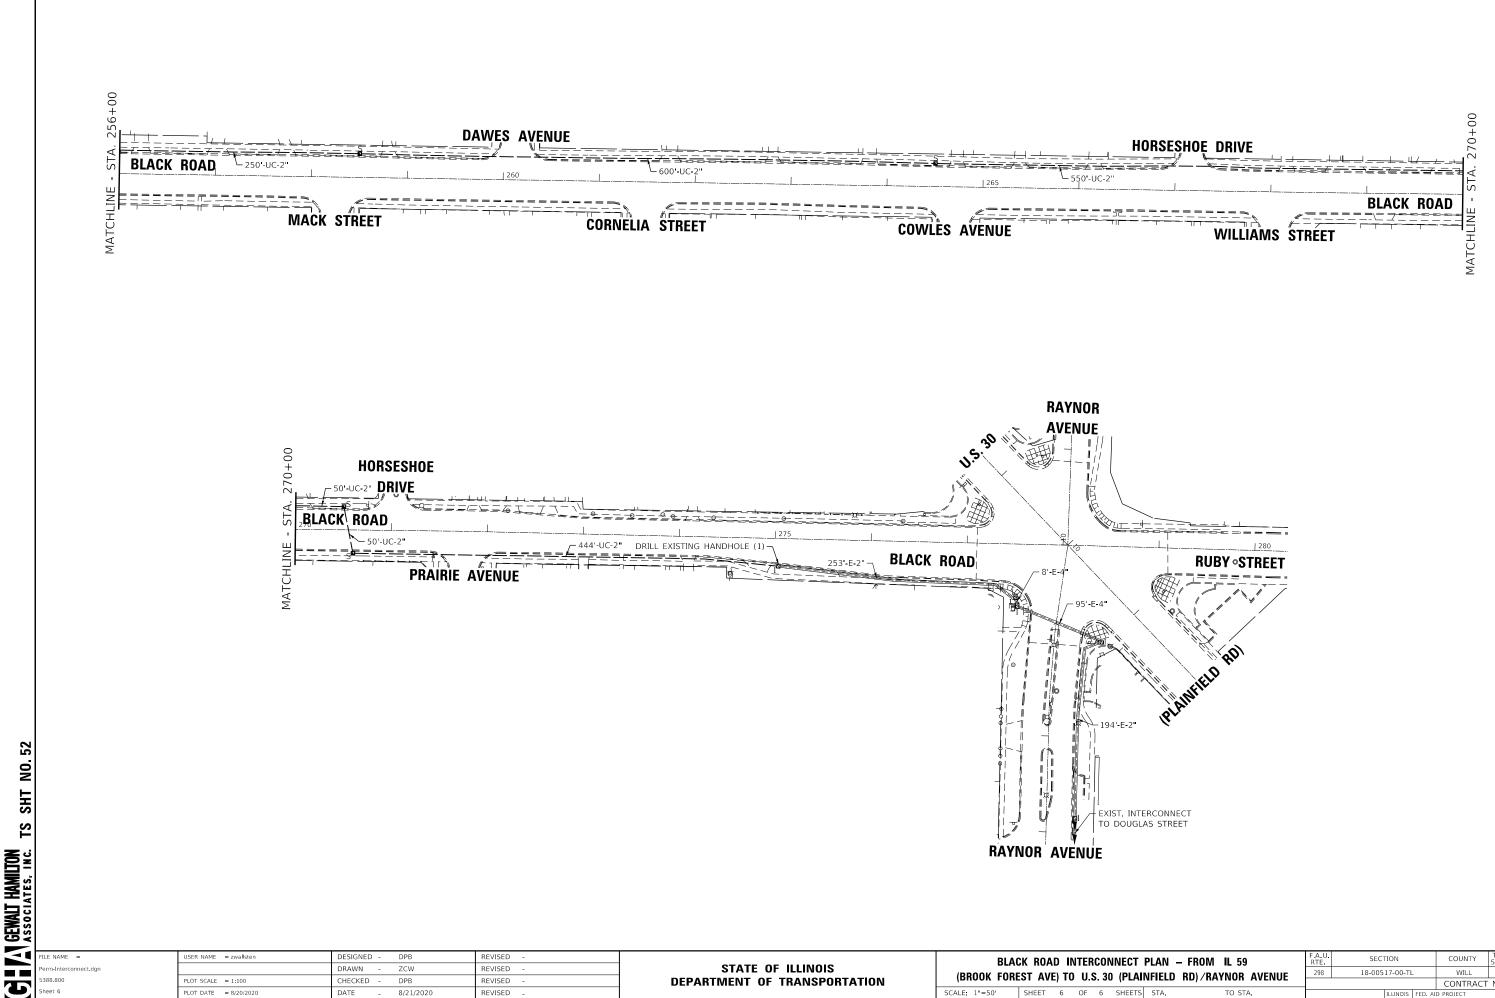

SECTION BLACK ROAD INTERCONNECT PLAN - FROM IL 59 18-00517-00-TL


STATE OF ILLINOIS **DEPARTMENT OF TRANSPORTATION** 


(BROOK FOREST AVE) TO U.S. 30 (PLAINFIELD RD)/RAYNOR AVENUE SCALE: 1"=50' SHEET 6 OF 6 SHEETS STA.


CONTRACT NO. 61G36

LOT SCALE = 1:100


DRAWN ZCW REVISED REVISED

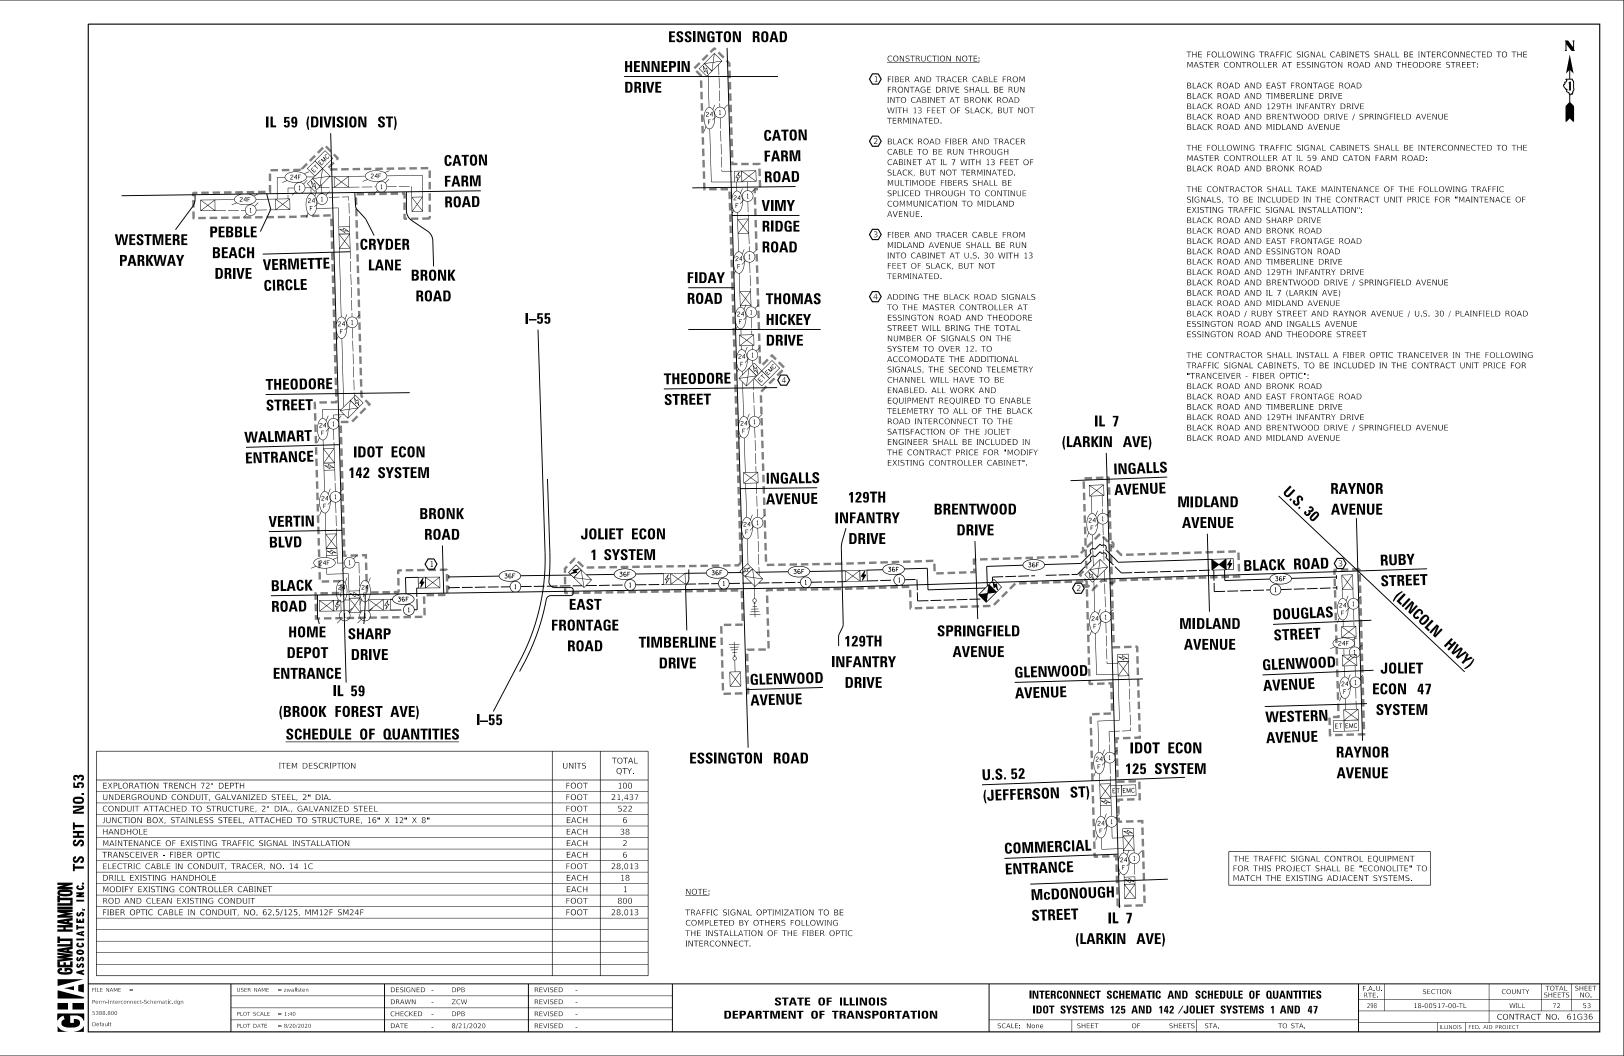

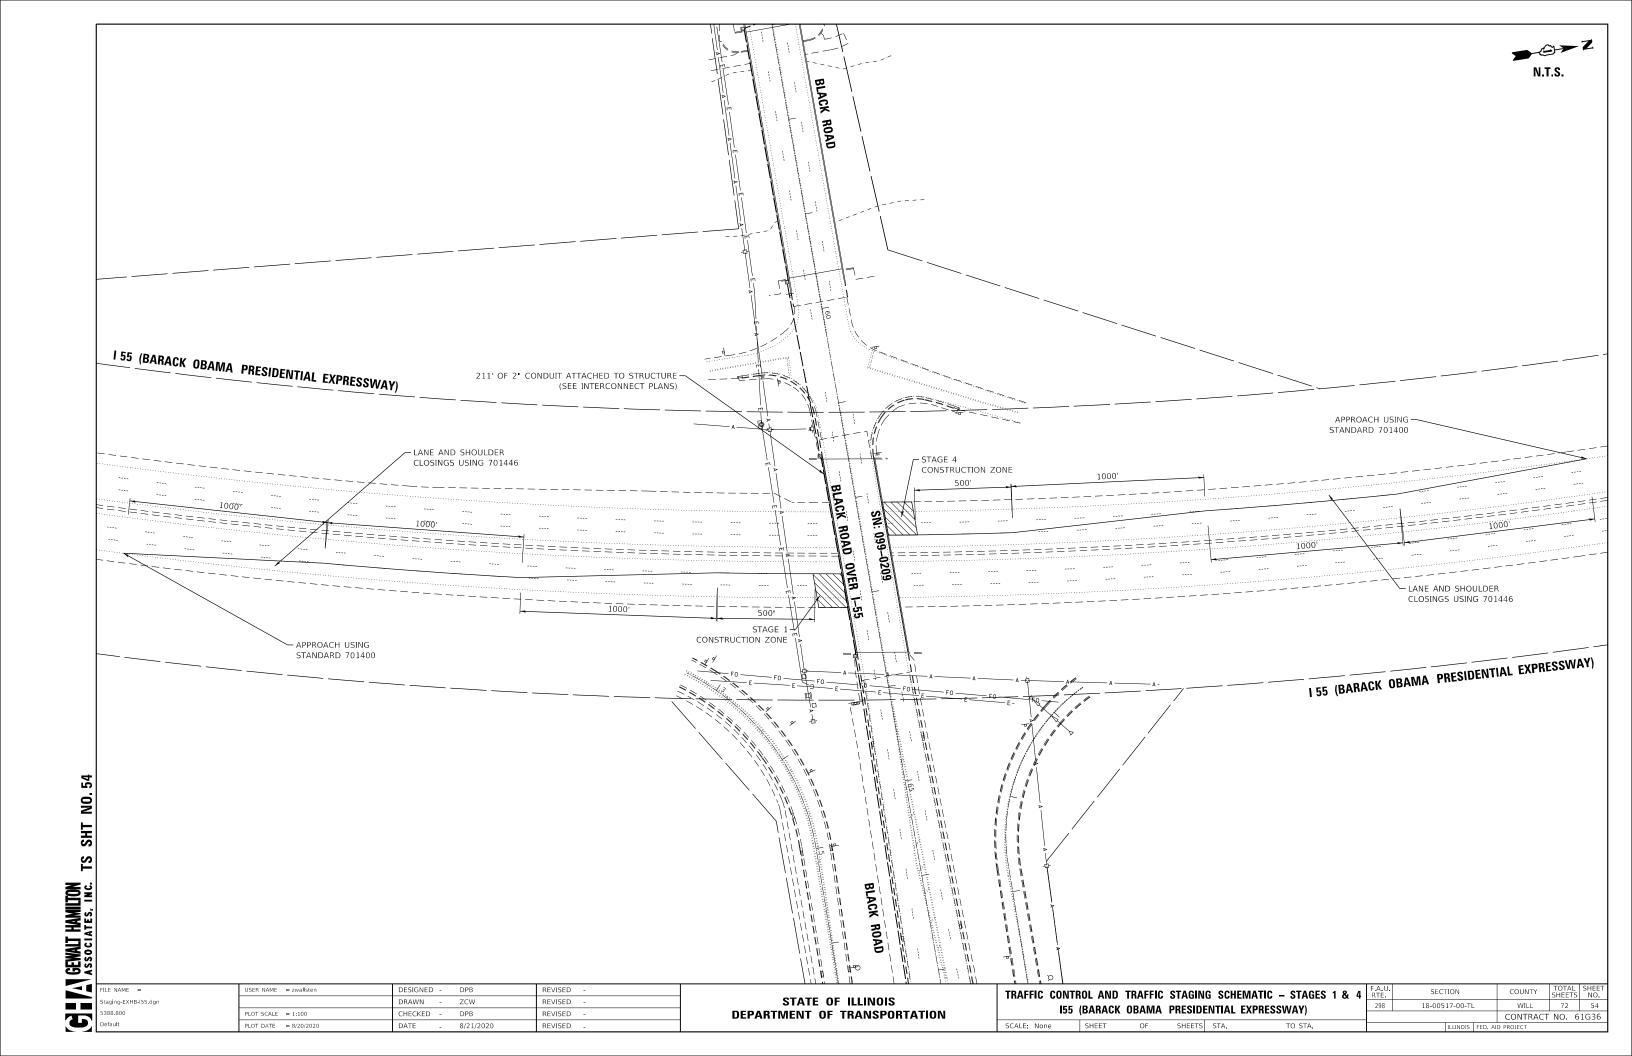

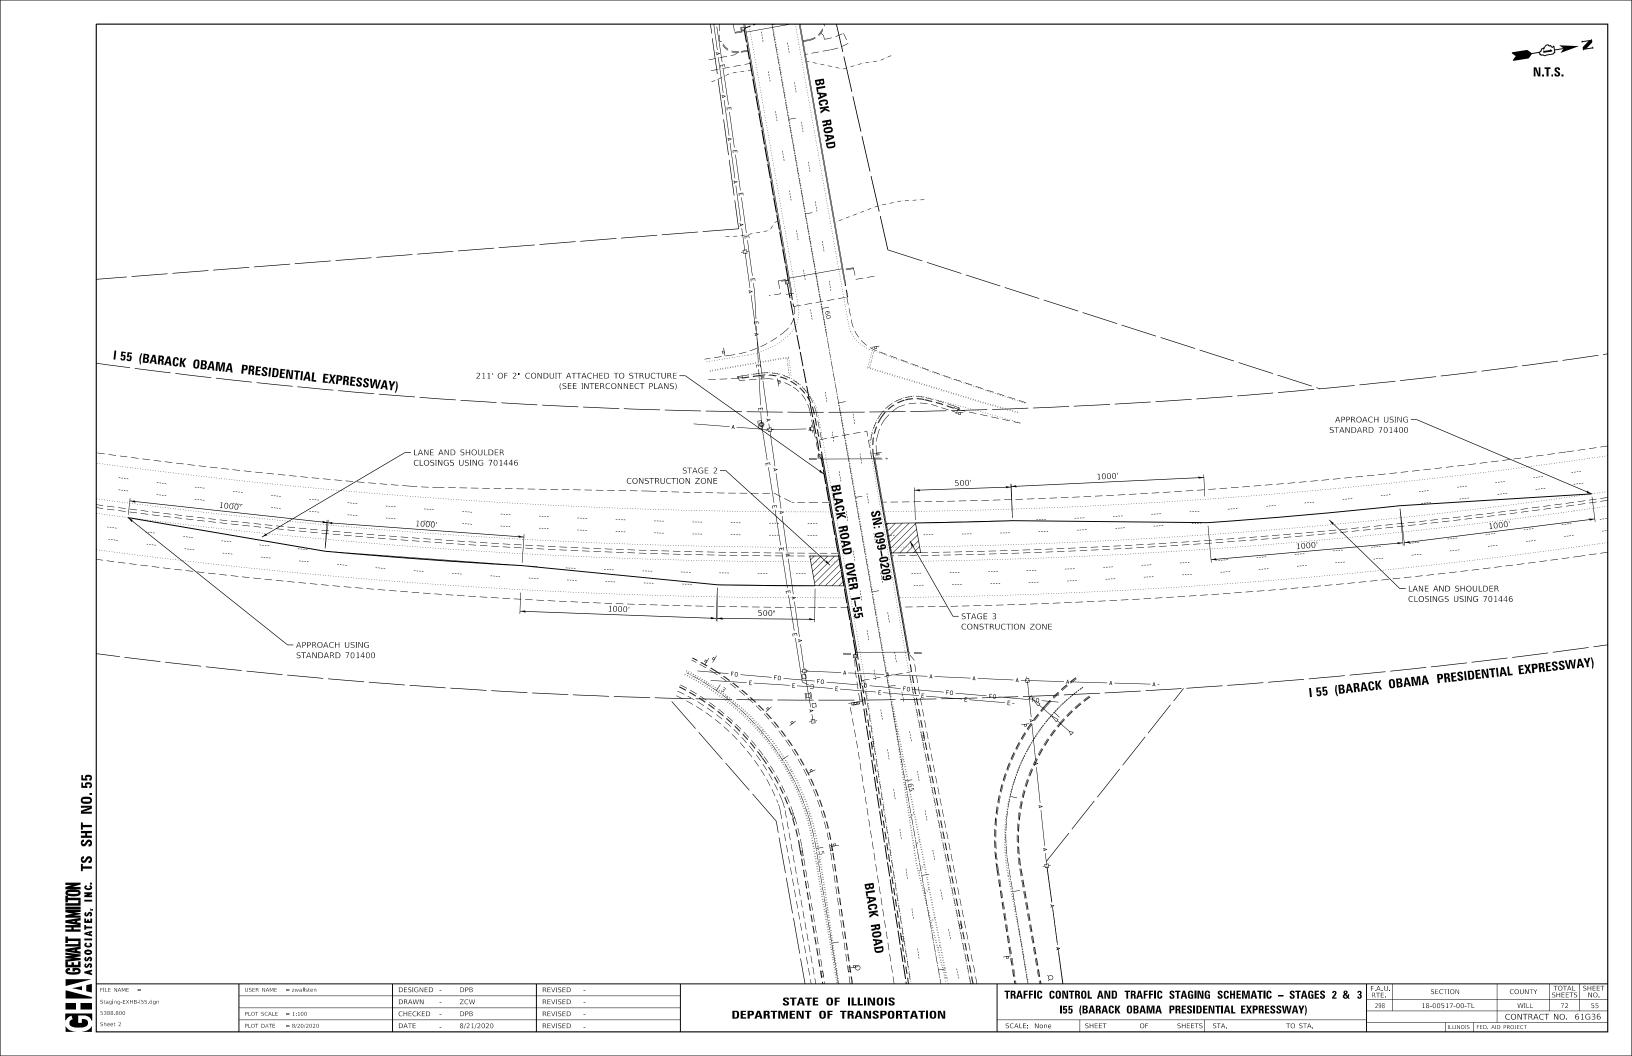



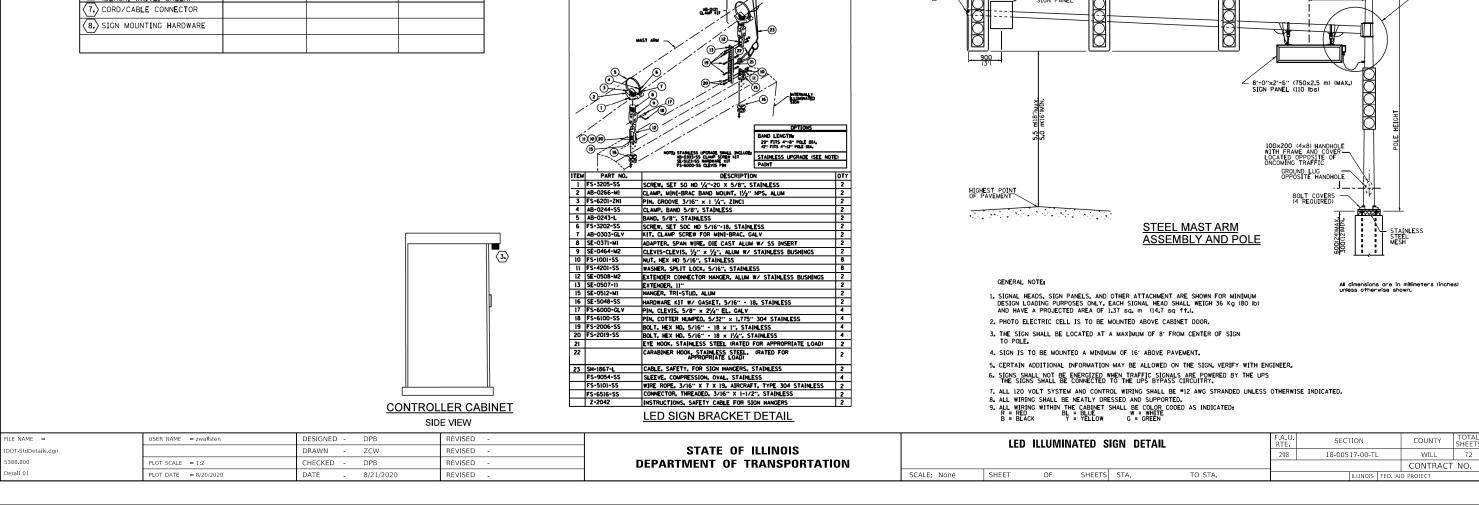

#### LED SIGN WIRING DETAIL

7 CORD CONNECTORS -

8 HANGERS BY PELCO

SIGN

SIGN

SIGN

SIGN

3

2 POSTION TERMINAL (MARATHON 1502 DJSV)

 $\langle 1 \rangle$ 

CABINET MAIN

BREAKER 40A OR 50A

BREAKER

---#8 AWG

2 POSTION TERMINAL BLOCK

PEC

INDUSTRIAL CONTROL RELAY


1111

PHOTO ELECTRIC CELL

5 IN-LINE FUSE

---

DESCRIPTION	MANUFACTURER	MODEL	NOTES
1. CIRCUIT BREAKER		15 AMPERE	
2. TERMINAL BLOCK			
3. PHOTO ELECTRIC CONTROL			
4. CONTRACTOR (INDUSTRIAL CONTROL RELAY)			BOLT ON W/SCREW TERMINAL
5. INLINE FUSE HOLDER WITH 5 AMP FUSE			
6. ELECTRIC CABLE, No. 14, 3/C (BLACK, WHITE, GREEN)			
(7.) CORD/CABLE CONNECTOR			
8. SIGN MOUNTING HARDWARE			

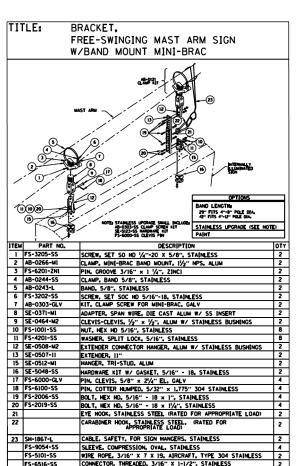


BRACKET — ASSEMBLY

LED SIGN ENLARGED CABLE CONNECTOR DETAIL

(NOT TO SCALE)

SAFETY HOOK -TYPICAL TWO PLACES

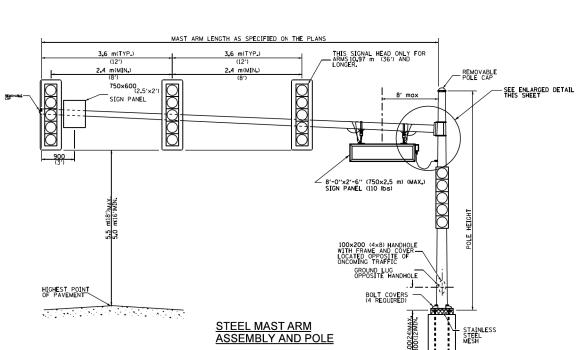

STEEL COMBINATION MAST ARM ASSEMBLY AND POLE

MAST ARM LENGTH AS SPECIFIED ON THE PLANS

3.6 m(typ.)

2.4 m(min.) (8') 

REMOVABLE -

LED SIGN ENLARGED

(NOT TO SCALE)

CABLE CONNECTOR DETAIL

HIGHEST POINT OF PAVEMENT

4.5 kg (9.9 lb), 0.09 sq m(1 sq f+) — CAMERA OR DETECTOR

THIS SIGNAL HEAD ONLY FOR -ARMS 10.97 m (36') AND LONGER.


8'-0"x2'-6" (750x2.5 m) (MAX.) SIGN PANEL (110 lbs)

75×125 (3×5) HANDHOLE WITH FRAME AND COVER

SEE ENLARGED DETAIL THIS SHEET

STAINLESS STEEL MESH

LED ILLUMINATED SIGN DETAIL							F.A.U. RTE	SECTION	COUNTY	TOTAL SHEETS	SHEET NO.
							298	18-00517-00-TL	WILL	72	56
									CONTRACT	NO. 6	1G36
	SCALE: None	SHEET	OF	SHEETS	STA.	TO STA.	ILLINOIS FED. AID PROJECT				

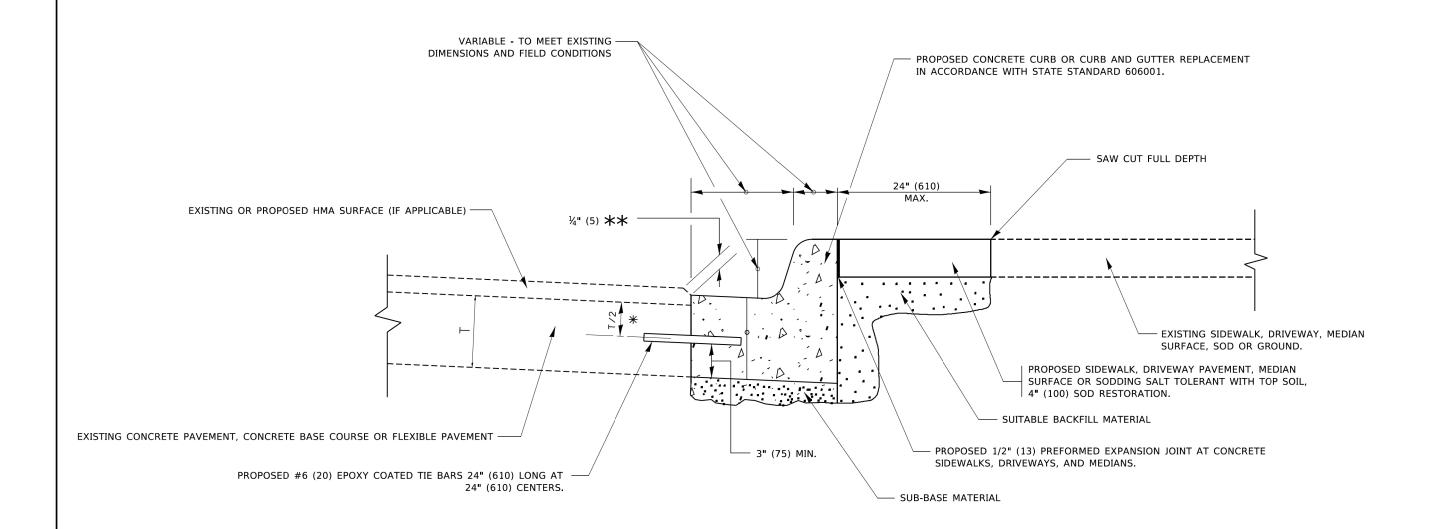

- X 3" (75) MINIMUM FROM TOP AND BOTTOM OF THE CONCRETE PAVEMENT OR BASE COURSE.
- $\star\star$  IF THE FINAL SURFACE OF THE PAVEMENT IS CONCRETE, THE GUTTER IS TO BE FLUSH WITH THE PAVEMENT.

#### **CURB OR CURB AND GUTTER REMOVAL AND REPLACEMENT**


ALL DIMENSIONS ARE IN INCHES (MILLIMETERS) UNLESS OTHERWISE SHOWN.

TS SHT NO 57

GEWALT HAMILTON ASSOCIATES, INC.

STATE OF ILLINOIS
DEPARTMENT OF TRANSPORTATION

SCALE: NONE

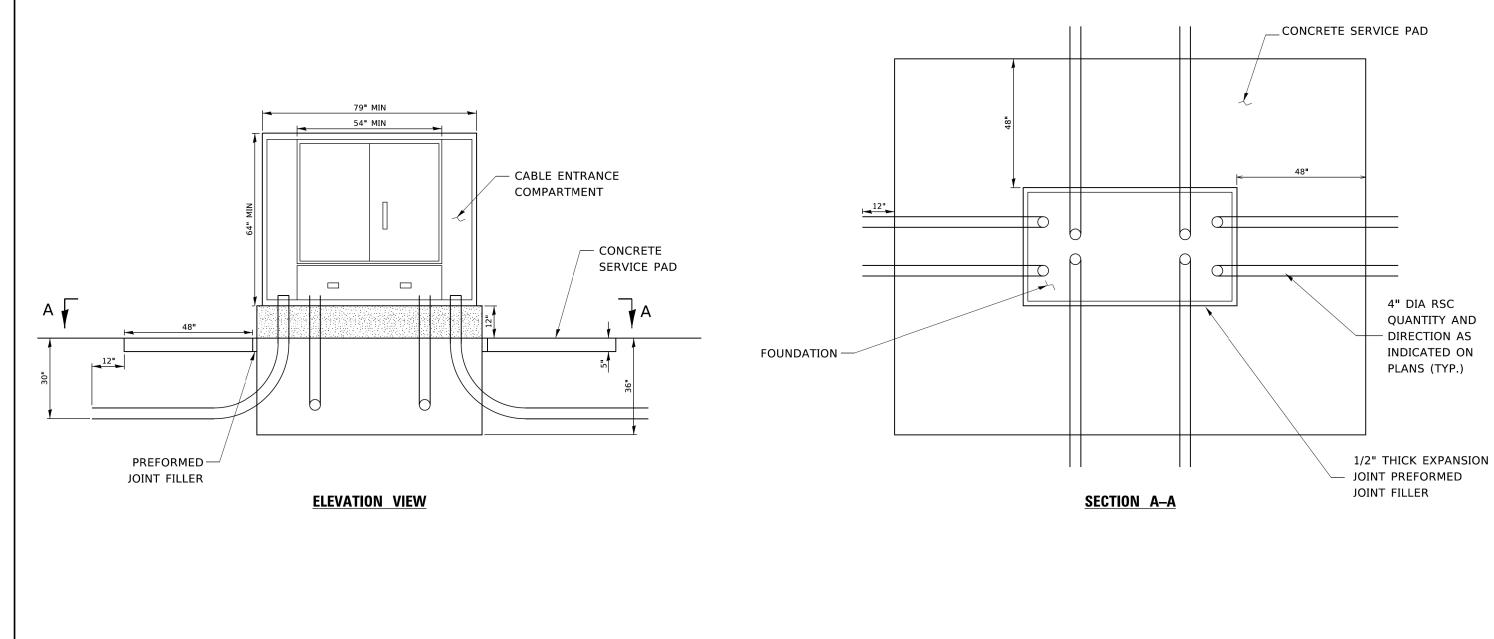

NOTES:

CABINET:

ALUMINUM 5052-H32

HARDWARE:

TYPE 304 STAINLESS STEEL

POLYESTER POWDER COATED GRAY

3/16" STEEL E.I.A. / T.I.A. SPACING (10-32 THREADS)

REVISED

REVISED

REVISED

REVISED

- 05-02-16

3 POINT LATCH, LATCH CONTROL SWITCH, PIANO HINGE, WIND STOP

CABLE ENTRANCE COMPARTMENT:

FOUR SLACK STORAGE BRACKETS WITH HEAVY DUTY VELCRO STRAPS TO SECURE CABLES, TWO ENTRY HOLES FOR BRINGING CABLES INTO THE MAIN CABINET

MAIN CABINET:


2-9"-23" ADJUSTABLE WIDTH RACKS, ADJUSTABLE FRONT TO REAR POSITION (43" TALL) 2-19"-23" ADJUSTABLE WIDTH RACKS, SWING OUT (40" TALL) 166" OF TOTAL INCHES OF RACK SPACE (95 RU) 4-15" WATT SHATTER-SHIELD LIGHT FIXTURES


SCALE: NONE

SEWALT HAMILTON ASSOCIATES, INC. JSER NAME = zwallsten DESIGNED - R. TOMSONS DOT-StdDetails.dgn DRAWN PLOT SCALE = 1:2 CHECKED G DOT D1 STANDARD BE1050 PLOT DATE = 8/20/2020 DATE

**TS SHT NO.58** 

				F.A.U. RTE	SECTION	COUNTY TOT.		
FIBER OPTIC INTERCONNECT CABINET					18-00517-00-TL	WILL	72	58
					BE-1050	CONTRACT NO. 61G36		1G36
	SHEET 1 OF 1 SHEET	s STA	TO STA		TILLINOIS FED AT	DROIECT		

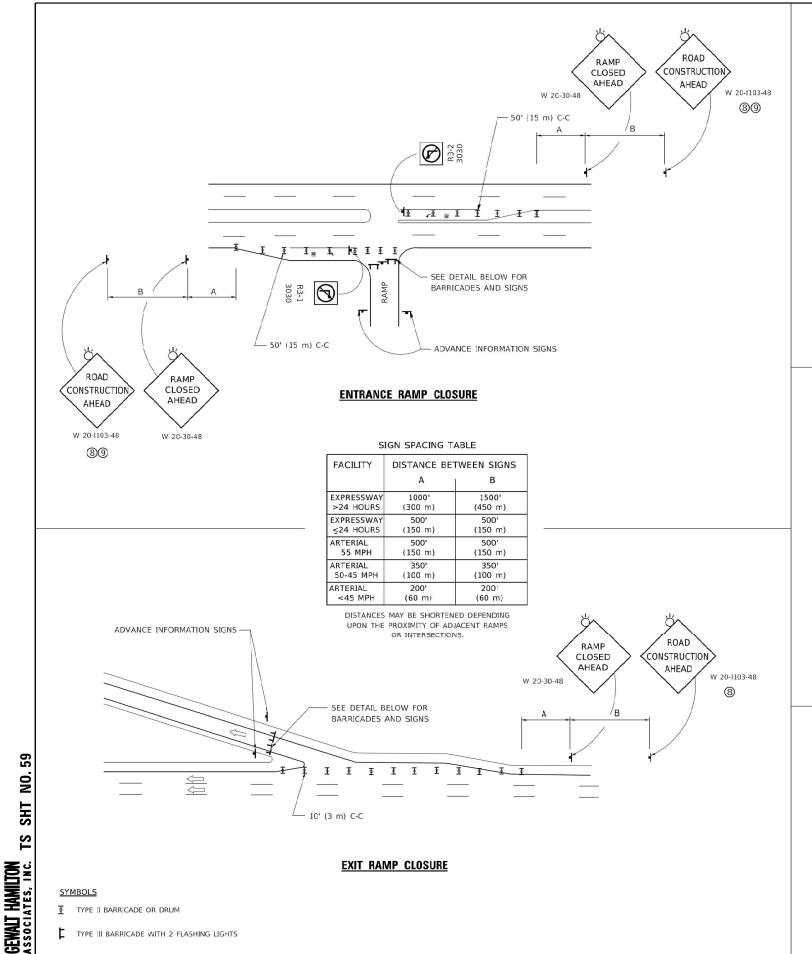

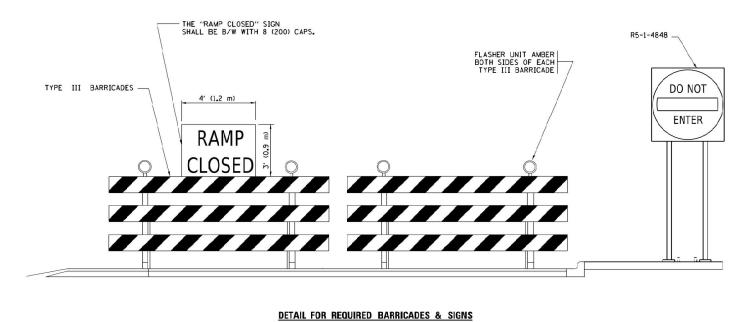


#### RAMP CLOSURE ADVANCE INFORMATION SIGN

#### RAMP CLOSURE ADVANCE WARNING SIGN

RAMP CLOSED 10' (3 m)

> BLACK LEGEND ON ORANGE BACKGROUND MOUNTED DIAGONALLY E MOD FONT 1 (25) BORDER

THESE SIGNS ARE REQUIRED ON ALL THE EXIT GUIDE SIGNS FOR EXIT RAMPS THAT WILL BE CLOSED FOR MORE THAN FOUR (4) CONSECUTIVE DAYS

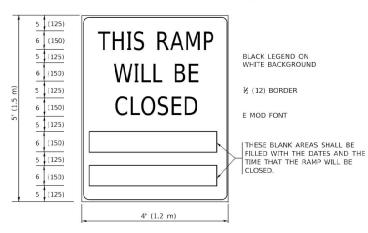

THESE SIGNS ARE REQUIRED ON BOTH SIDES OF THE RAMP, MINIMUM OF 1 WEEK IN ADVANCE OF THE CLOSURE

THESE SIGNS SHALL BE FABRICATED AND PAID FOR ACCORDING TO THE TEMPORARY INFORMATION SIGNING SPECIAL PROVISION

#### GENERAL NOTES:

- CONES MAY BE SUBSTITUTED FOR DRUMS OR TYPE II BARRICADES DURING DAY OPERATIONS. CONES SHALL BE 1 A MINIMUM OF 28 (700) HIGH.
- (2) VERTICAL BARRICADES SHALL NOT BE USED FOR RAMP CLOSURES.
- 3 A FLAGGER SHALL BE POSITIONED AT EACH CLOSED RAMP THAT IS OPEN TO CONSTRUCTION VEHICLES, PRECEEDED BY A W20-7 FLAGGER WARNING SIGN.
- 4 ALL ROUTE MARKERS AND TRAILBLAZER ASSEMBLIES WHICH DIRECT MOTORISTS TO A CLOSED ENTRANCE RAMP SHALL BE COVERED WHEN THE RAMP IS CLOSED FOR MORE THAN FOUR (4) DAYS.

SHEET 1

5 THE SIGNING AND BARRICADING WHICH IS REQUIRED BY THIS DETAIL SHALL BE INCLUDED IN THE COST OF TRAFFIC CONTROL AND PROTECTION (EXPRESSWAYS).

SCALE: NONE


- 6 AUTHORIZATION FROM THE DISTRICT'S BUREAU OF TRAFFIC IS REQUIRED FOR ALL RAMP CLOSURES.
- THE RAMP CLOSURE ADVANCE INFORMATION SIGNS SHALL BE ERECTED IF THE CLOSURE TIME EXCEEDS TWENTY-FOUR (24) HOURS, ADDITIONAL ADVANCE WARNING SIGNS ON EXIT GUIDE SIGNING WILL BE REQUIRED FOR EXIT RAMP CLOSURES THAT EXCEED FOUR (4) DAYS IN LENGTH
- (8) ROAD CONSTRUCTION AHEAD SIGNS MAY BE OMITTED WHEN THIS DETAIL IS USED IN CONJUNCTION WITH OTHER TRAFFIC CONTROL THAT ALREADY INCLUDES A ROAD CONSTRUCTION AHEAD SIGN.
- ARTERIAL ROAD CONSTRUCTION AHEAD SIGNS SHALL BE INSTALLED ON THE LEFT SIDE OF TRAFFIC IF THE MEDIAN IS MORE THAN 10 FT WIDE.

ALL DIMENSIONS ARE IN INCHES (MILLIMETERS)
UNLESS OTHERWISE SHOWN.


ILE NAME = REVISED - S.P.B.\_01-07 JSER NAME = zwallster DESIGNED - D.W.S. REVISED -DT-StdDetails.dor DRAWN . S.P.B. 12-09 88 800 HECKED -REVISED -M.D.\_06-13 OT D1 STANDARD TC08 LOT DATE = 9/15/2020 M.D. 01-18 DATE 02-83 REVISED -

T


ENTRANCE AND EXIT RAMP				F.A. U. RTE. SECTION				COUNTY	TOTAL SHEETS	SHEET NO.		
CLOSURE DETAILS		298	18-00517-00-TL			WILL	72	59				
GLOSORE_DETAILS				TC-08 CONTRA					Г NO. 6	1G36		
	1 0	1	SHEETS	STA	TO STA			HILMIOIC	CCD AT	DEPOSECT		

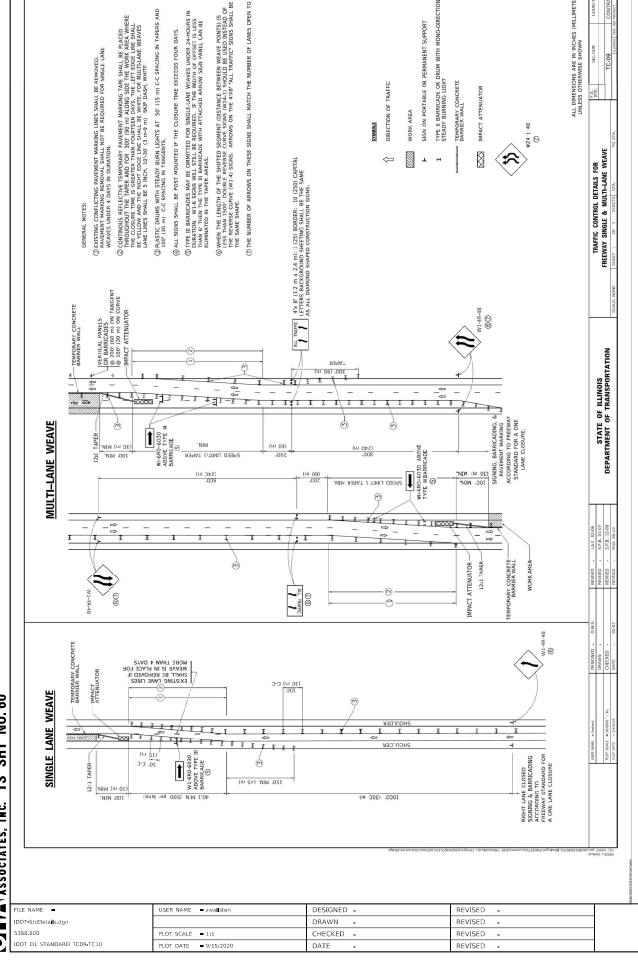

STATE OF ILLINOIS
DEPARTMENT OF TRANSPORTATION

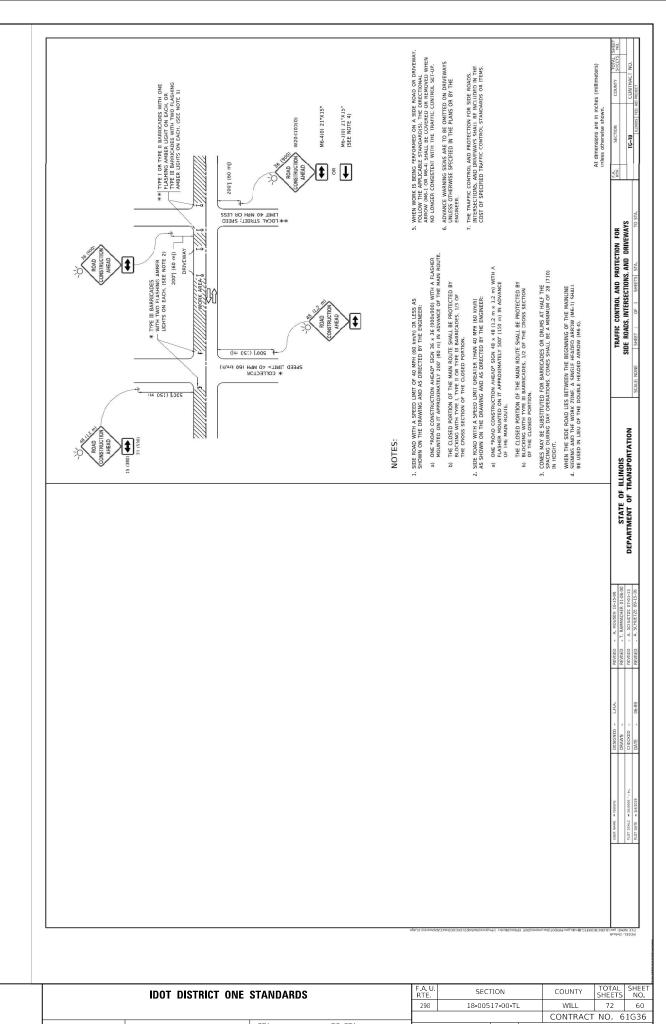

TO STA.

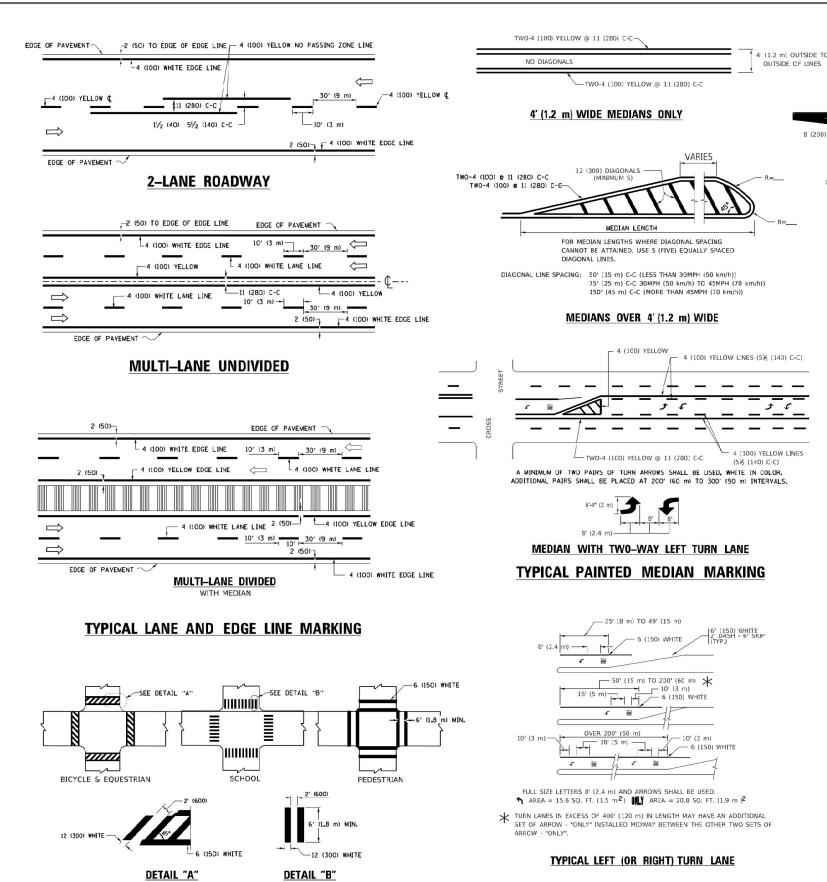

TYPICAL TURN LANE MARKING

| Combination |

		<u> </u>	Ollie	
TYPE OF MARKING	WIDTH OF LINE	PATTERN	COLOR	SPACING / REMARKS
CENTERLINE ON 2 LANE PAVEMENT	4 (100)	SKIP-DASH	YELLOW	10' (3 m) LINE WITH 30' (9 m) SPACE
CENTERLINE ON MULTI-LANE UNDIVIDED PAVEMENT	2 @ 4 (100)	SOLID	YELLOW	11 (280) C-C
NO PASSING ZONE LINES: FOR ONE DIRECTION FOR BOTH DIRECTIONS	4 (100) 2 @ 4 (100)	SOLID SOLID	YELLOW YELLOW	5½, (140) C-C FROM SKIP-DASH CENTERLINE 11 (280) C-C OMIT SKIP-DASH CENTERLINE BETWEEN
LANE LINES	4 (100) 5 (125) ON FREEWAYS	SKIP-DASH SKIP-DASH	WHITE WHITE	10' (3 m) LINE WITH 30' (9 m) SPACE
DOTTED LINES (EXTENSIONS OF CENTER, LANE OR TURN LANE MARKINGS)	SAME AS LINE BEING EXTENDED	SKIP-DASH	SAME AS LINE BEING EXTENDED	2' (600) LINE WITH 6' (1.8 m) SPACE
EDGE LINES	4 (100)	SOLID	YELLOW-LEFT WHITE-RIGHT	OUTLINE MEDIANS IN YELLOW
TURN LANE MARKINGS	6 (150) LINE; FULL SIZE LETTERS & SYMBOLS (8' (2.4m))	SOLID	WHITE	SEE TYPICAL TURN LANE MARKING DETAIL
TWO WAY LEFT TURN MARKING	2 @ 4 (100) EACH DIRECTION 8' (2.4m) LEFT ARROW	SKIP-DASH AND SOLID IN PAIRS	YELLOW	10' (3 m) LINE WITH 30' (9 m) SPACE FOR SKIP-DASH; 3½ (140) C-C DETWECN SOLID LINE AND SKIP-DASH LINE SEE TYPICAL TWO-WAY LEFT TURN MARKING DETAIL
CROSSWALK LINES (PEDESTRIAN) A. DIAGONALS (BIKE & EQUESTRIAN) B. LONGITUDINAL BARS (SCHOOL)	2 @ 6 (150) 12 (300) @ 45° 12 (300) @ 90°	SOLID SOLID SOLID	WHITE WHITE WHITE	NOT LESS THAN 6' (1.8 m) APART 2' (600) APART 2' (600) APART 5' (600) APART SEE TYPICAL CROSSWALK MARKING DETAILS.
STOP LINES	24 (600)	SOLID	WHITE	PLACE 4" (1.2 m) IN ADVANCE OF AND PARALLEL TO CROSSWALK, IF PRESENT. OTHERWISE, PLACE AT DESIDED STO-PING POINT. PARALLEL TO CROSSROAD CENTERLINE, WHERE POSSIBLE
PAINTED MEDIANS	2 @ 4 (100) WITH 12 (300) DIAGONALS @ 45° NO DIAGONALS USED FOR 4' (1.2 m) WIDE MEDIANS	SOLID	YELLOW: TWO WAY TRAFFIC WHITE: ONE WAY TRAFFIC	11 (280) C-C FOR THE DOUBLE LINE SEE TYPICAL PAINTED MEDIAN MARKING.
GORE MARKING AND CHANNELIZING LINES	8 (200) WITH 12 (300) DIAGONALS @ 45°	SOLID	WHITE	DIAGONALS: 15' (4.5 m) C-C (LESS THAN 30MPH (50 km/h)) 20' (6 m) C-C 30MPH (50 km/h) TO 45MPH (70 km/h)) 30' (9 m) C-C (OVER 45MPH (70 km/h))
RAILROAD CROSSING	24 (600) TRANSVERSE LINES; "RR" IS 6' (1.8 m) LETTERS: 16 (400) LINE FOR "X"	SOLID	WHITE	SEE STATE STANDARD 780001 AREA OF: "R"=3.6 SQ. FT. (0.33 m ZEACH "X"=54.0 SQ. FT. (5.0 m Z
SHOULDER DIAGONALS (REQUIRED FOR SHOULDERS_> 8')	12 (300) @ 45°	SOLID	WHITE - RIGHT YELLOW - LEFT	50' (15 m) C-C (LESS THAN 30MPH (50 km/h)) 75' (25 m) C-C (30 MPH (50 km/h) TO 45MPH (70 km/h)) 150' (45 m) C-C (OVER 45MPH (70 km/h))
U TURN ARROW	SEE DETAIL	SOLID	WHITE	16.3 SF
2 ARROW COMBINATION LEFT AND U TURN	SEE DETAIL	SOLID	WHITE	30.4 SF

FOR FURTHER DETAILS ON PAVEMENT MARKING REFER TO STANDARD SPECIFICATIONS FOR ROAD AND BRIDGE CONSTRUCTION AND STATE STANDARD 780001.

SCALE: NONE

12 (300) WHITE DIAGONALS

ISLAND OFFSET FROM PAVEMENT EDGE

8 (200) WHITE -

ISLAND AT PAVEMENT EDGE

TYPICAL ISLAND MARKING

RAISED

@ 10' (3 m) OR LESS SPACING

All dimensions are in inches (millimeters) unless otherwise shown.

FILE NAME -	USER NAME ■ zwallsten	DESIGNED - EVERS	REVISED - C. JUCIUS 09-09-09
IDOT-StdDetails.dgn		DRAWN -	REVISED - C. JUCIUS 07-01-13
5388.800	PLOT SCALE = 1:1	CHECKED -	REVISED - C. JUCIUS 12-21-15
IDOT D1 STANDARD TC13	PLOT DATE = 9/15/2020	DATE - 03-19-90	REVISED - C. JUCIUS 04-12-16

TYPICAL CROSSWALK MARKING


 $f{ imes}$  MARKINGS SHALL BE INSTALLED PARALLEL TO THE CENTERLINE OF THE ROAD WHICH IT CROSSES


SHT


TS


G V GEWALT HAMILTON ASSOCIATES, INC.

	DIS	TRICT OF	NE		F.A.U. RTE	SECTION	COUNTY	TOTAL SHEETS	SHEET NO.
TVD	CAL DAY	/EMENIT	MARKINGS		298	18-00517-00-TL	WILL	72	61
	UAL I A	LIVILIAI	MAIIKINGS			TC-13	CONTRACT	NO. 6	1G36
SHEET 1	OF 2	SHEETS	STA	TO STA		HILIMOIC CED A	D DROIECT		

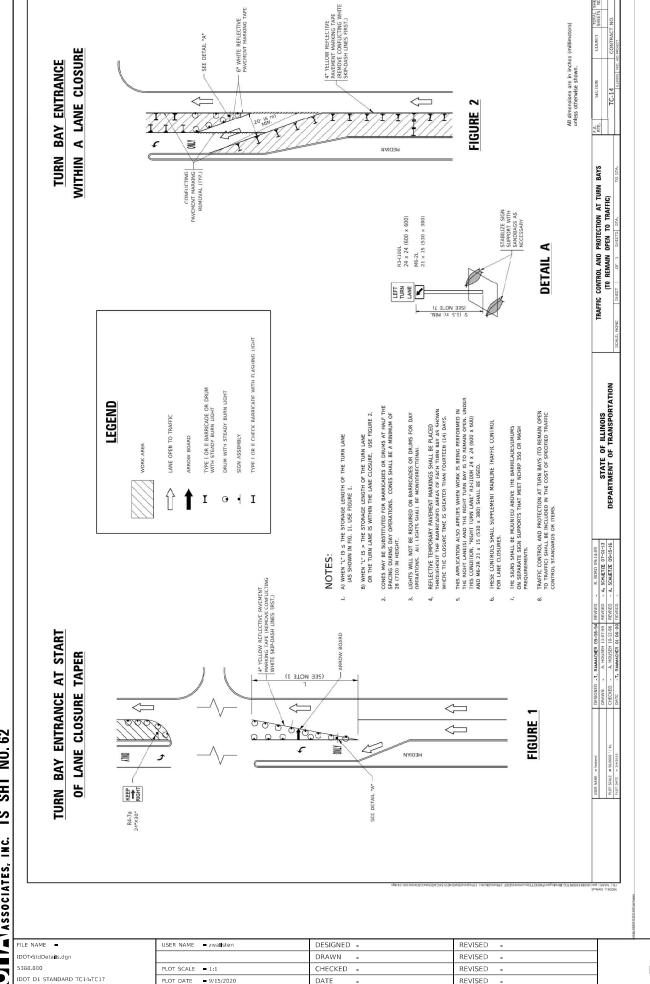

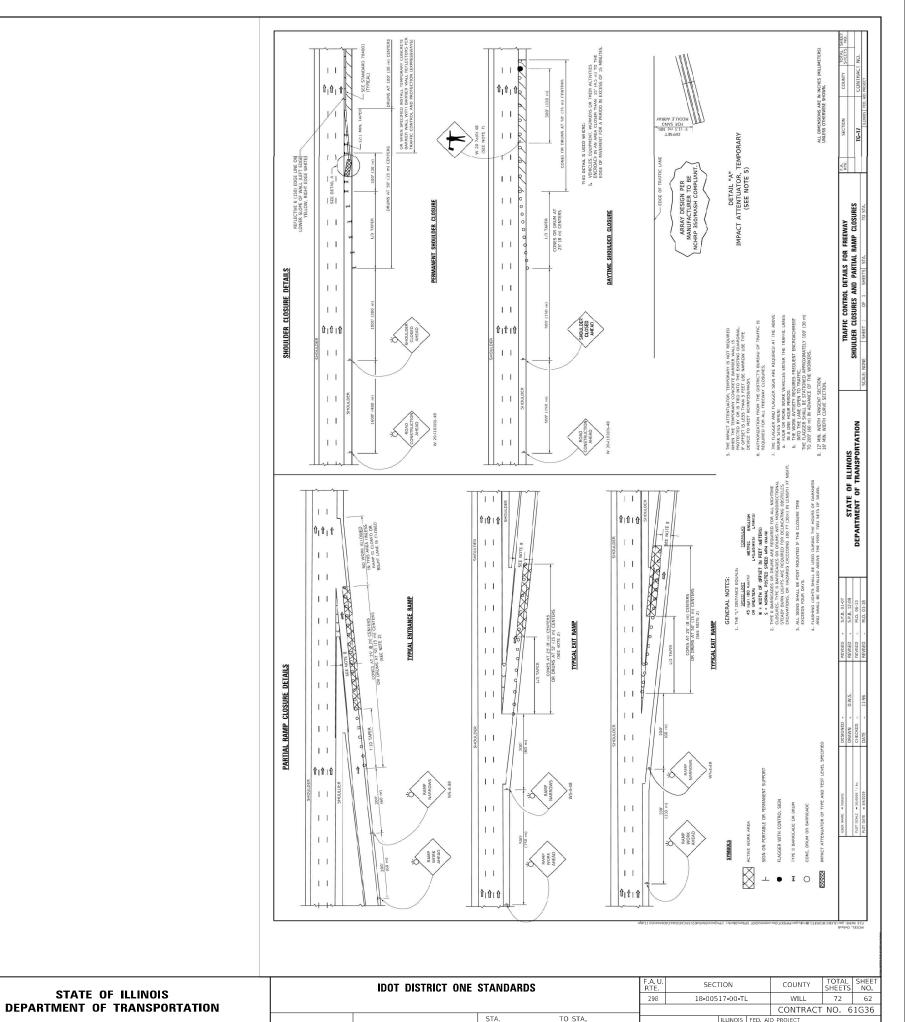

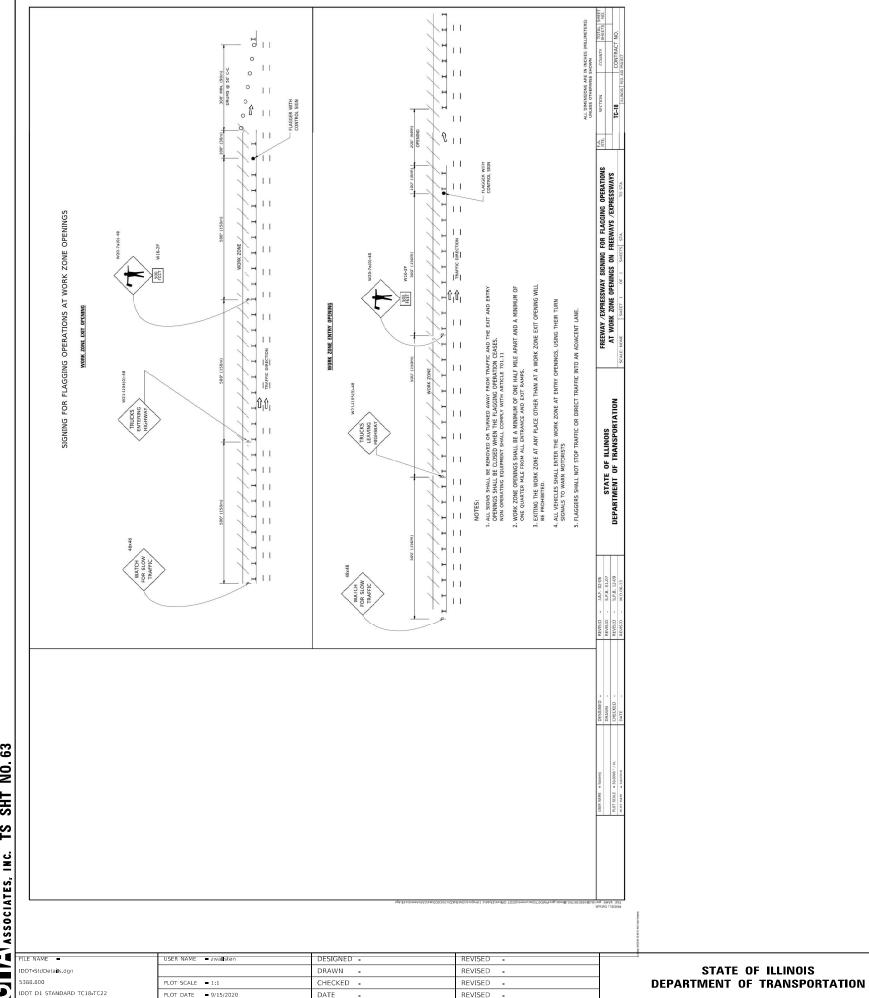

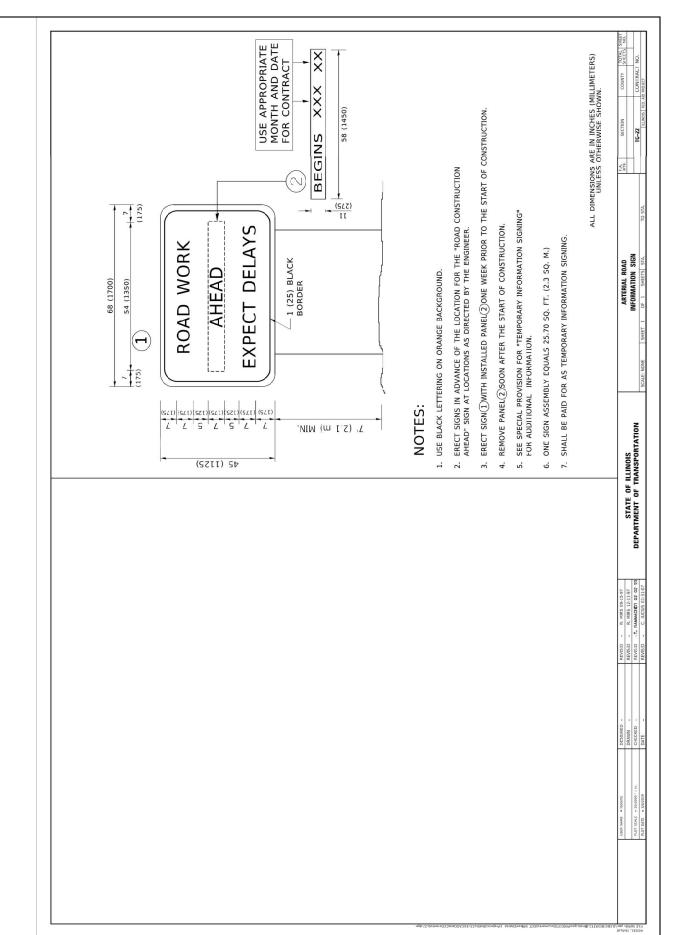

TO STA.

**IDOT DISTRICT ONE STANDARDS** 

COUNTY SHEETS NO.
WILL 72 63
CONTRACT NO. 61G36

SECTION

18-00517-00-TL

#### **CENTER LANE CLOSURE** TYPE I CHECK BARRICADES > DRUMS AT 50' (15 m) CENTERS AT 100' (30 m) CENTERS 06) ARROW BOARD DISPLAYING-DOUBLE ARROW PATTERN 500 CENTE 1111 LANE CLOSE \*W9-3-48 \* W9-3a-48 SIGNING & BARRICADING ACCORDING TO FREEWAY STANDARD FOR A ONE LANE CLOSURE INSTALLATION SEQUENCE 1. CLOSE LANES 1&2 NOTES: ACTIVE <u>8</u> WORK AREA 1. DRUMS WITH STEADY BURN LIGHTS SHT SHALL BE USED AT 50' (15 m) CENTERS ON ALL TAPERS AND TANGENTS IN 2. ERECT INSIDE LANE 2 TAPER ADVANCE OF WORK AREA. TS 2. CLOSURE SHALL BE USED ONLY FOR OPERATIONS LASTING 72 HOURS GEWALT HAMILTON ASSOCIATES, INC. OR LESS. 3. OPEN LANE 2 BY RELOCATING FIRST TAPER 3. CENTER LANE CLOSURE CONFIGURATION NON-ACTIVE IS NOT TO BE USED WITH WORKERS WORK AREA 4. REMOVE CLOSURE IN REVERSE ORDER

DESIGNED -

ORAWN -

DATE

HECKED -

REVISED - J.A.F. 04-03

REVISED - S.P.B. 01-07

REVISED - S.P.B. 12-09

REVISED -

ILE NAME =

88.800

5

DT-StdDetails.dor

OT D1 STANDARD TC25


JSER NAME = zwallsten


PLOT DATE = 9/15/2020


#### SHOULDER LANE

NOTE:

CLOSURE SHALL BE USED ONLY FOR OPERATIONS LASTING

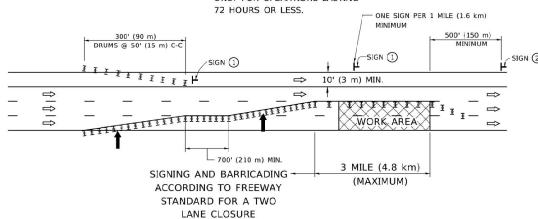

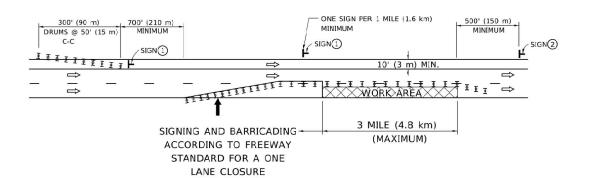

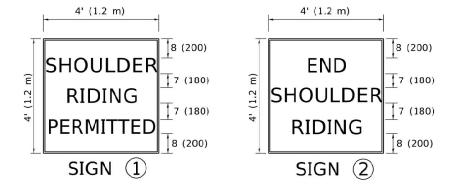

6 (150) SERIES "C" LEGEND BLACK LEGEND WHITE REFLECT. BACKGROUND 1 (25) BORDER

#### **SYMBOLS**

DIRECTION OF TRAFFIC

ARROWBOARD

ACTIVE WORK AREA

► SIGN ON PORTABLE OR PERMANENT SUPPORT ★

SCALE: NONE


TYPE II BARRICADE, OR DRUM WITH MONO-DIRECTIONAL STEADY BURN LIGHT


ALL DIMENSIONS ARE IN INCHES (MILLIMETERS) UNLESS OTHERWISE SHOWN


\* ALL SIGNS SHALL BE MOUNTED AT A MINIMUM HEIGHT OF 5' (1.5 m).

TRAFFIC CONTROL DETAILS FOR FREEWAY	F.A.U. RTE	SECTION		COUNTY	TOTAL SHEETS	SHEET NO.
CENTER LANE CLOSURE SHOULDER LANE	298	18-00517-00-TL	-	WILL	72	64
CLIVIEN LANE GEOSONE SHOOLDEN LANE		TC-25		CONTRACT	NO. 6	1G36
SHEET 1 OF 1 SHEETS STA. TO S	STA.	ILLINOIS	FED. AID	PROJECT		

#### SIGN PANEL - TYPE 1 OR TYPE 2

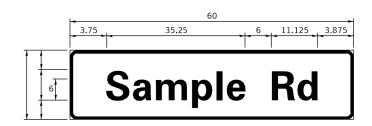

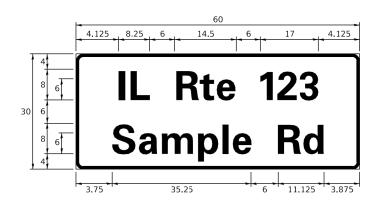

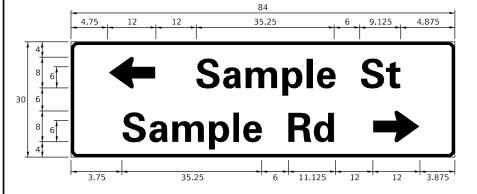

#### IGN PANEL SHEETING (SQ FT) REQUIRED D OR C 1 OR 2 ZZ

#### **COMMON STREET NAME ABBREVIATIONS AND WIDTHS**

NAME	ABBREVATION	WIDTH	(INCH)
NAME	ADDREVATION	SERIES "C"	SERIES "D"
AVENUE	Ave	15.000	18.250
BOULEVARD	Blvd	17.125	20.000
CIRCLE	Cir	11.125	13.000
COURT	Ct	8. 250	9.625
DRIVE	Dr	8.625	10.125
HIGHWAY	Hwy	18.375	22.000
ILLINOIS	ΙL	7. 000	8. 250
LANE	Ln	9.125	10.750
PARKWAY	Pkwy	23. 375	27.375
PLACE	PΙ	7.125	7. 750
ROAD	Rd	9.625	11.125
ROUTE	Rte	12.625	14.500
STREET	St	8. 000	9.125
TERRACE	Ter	12.625	14.625
TRAIL	Tr	7. 750	9.125
UNITED STATES	US	10.375	12.250

#### **GENERAL NOTES**

- 1. WHERE MAST ARM MOUNTED STREET NAME SIGNS ARE SPECIFIED, THE MAST ARM ASSEMBLY AND POLES SHALL BE DESIGNED TO SUPPORT THE LOADINGS CALLED FOR ON STANDARDS 877001, 877002, 877006, 877011 AND 877012, AS APPLICABLE, PLUS TWO (2) SIGN PANELS 2'-6" x 8'-0" MOUNTED AS SHOWN. THE DESIGN SHALL BE IN ACCORDANCE WITH THE REQUIREMENTS OF THE CURRENT "STANDARD SPECIFICATIONS FOR STRUCTURAL SUPPORTS FOR HIGHWAY SIGNS. LUMINAIRES. AND TRAFFIC SIGNALS" AS PUBLISHED BY THE AMERICAN ASSOCIATION OF STATE HIGHWAY AND TRANSPORTATION OFFICIALS FOR 80 M.P.H. WIND VELOCITY.
- 2. ALL SIGNS SHALL CONSIST OF A WHITE LEGEND AND BORDER (TYPE ZZ SHEETING) ON A GREEN BACKGROUND (TYPE ZZ
- 3. THE SIGN LENGTH SHALL BE IN 6-INCH INCREMENTS, BUT THE OVERALL LENGTH SHALL NOT EXCEED 8'-0". ALL BORDERS IF POSSIBLE, BUT MAY BE REDUCED TO 5" WHEN SPACING IS CRITICAL, A MINIMUM OF 2-1/2" SHALL BE INCLUDED BETWEEN THE WORD AND THE RIGHT AND LEFT EDGES OF THE SIGN.
- 4. A PREFERRED METHOD FOR THE SIGN DESIGN IS TO USE SERIES "D" LETTER ON A ONE-LINE SIGN 18" IN HEIGHT AND A MAXIMUM OF 8'-0" IN WIDTH, IF SERIES "D" DOES NOT FIT ON A 8"-0" SIGN, THEN SERIES "C" SHOULD BE TRIED, IF SERIES "C" DOES NOT FIT ON A 8'-0" SIGN, A 30" HIGH TWO-LINE SIGN CAN BE USED. THE CROSSROAD DESIGNATION AS TO STREET, AVENUE, ETC. SHOULD BE SPELLED OUT ON THE SECOND LINE, IF THE ABBREVIATION CANNOT FIT ON THE FIRST LINE.
- 5. LED ILLUMINATED STREET NAME SIGNS CAN BE USED IN PLACE OF REGULAR SIGN PANELS BUT ANY SPECIAL WORDING AND SYMBOLOGY MUST BE APPROVED BY THE DEPARTMENT. GENERAL DESIGN REQUIREMENT AS LISTED ABOVE (COLOR, FONT, SIZE, ETC.) MUST BE FOLLOWED.
- 6. SIGNFIX ALUMINUM CHANNEL FRAMING SYSTEM SHALL BE USED FOR ALL SIGNS ATTACHED TO SIGNAL POLES AND POSTS.

LOCAL SUPPLIERS: PARTS LISTING:

- J.O. HERBERT COMPANY, INC. MIDLOTHIAN, VA

- WESTERN REMAC, INC.

WOODRIDGE, IL

SIGN CHANNEL SIGN SCREWS BRACKETS

PART #HPN053 (MED. CHANNEL) 1/4" x 14 x 1" H.W.H. #3 SELE TAPPING WITH NEOPRENE WASHER

PART #HPN034 (UNIVERSAL)


CHANNEL CLAMPS WITH STAINLESS STEEL STRAPPING

SCALE:


OTHER BRANDS OF MOUNTING HARDWARE ARE ACCEPTABLE, BASED UPON THE DEPARTMENT'S APPROVAL AND COMPATIBILITY WITH THE CHANNEL/BRACKET OF THE ABOVE PRODUCT.

#### **MOUNTING LOCATION**

ARM OR POLE MOUNTED

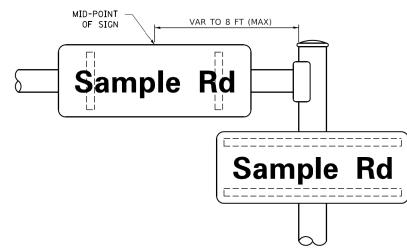

#### **SUPPORTING CHANNELS**

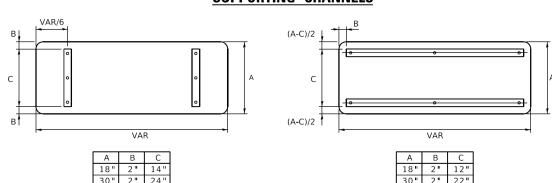

#### STANDARD ALPHABETS SPACING CHART

(8") UPPER CASE AND (6") LOWER CASE

	FHWA SEF	RIES "C"		FHWA SERIES "D"					
CHARACTER	(INCH)	WIDTH (INCH)	RIGHT SPACING (INCH)	CHARACTER	(INCH)	WIDTH (INCH)	RIGHT SPACINO (INCH)		
Α	0.240	5.122	0.240	Α	0.240	6.804	0.240		
В	0.880	4.482	0.480	В	0.960	5.446	0.400		
C	0.720	4.482	0.720	С	0.800	5.446	0.800		
D E	0.880 0.880	4.482 4.082	0.720 0.480	D E	0.960 0.960	5.446 4.962	0.800		
F	0.880	4.082	0.480	F	0.960	4. 962	0. 400		
G	0.720	4. 482	0.720	G	0.800	5. 446	0.800		
H	0.880	4.482	0.880	Н	0.960	5.446	0.960		
I	0.880	1.120	0.880	I	0.960	1.280	0.960		
J	0.240	4.0B2	0.880	J	0.240	5.122	0.960		
K	0.880	4.482	0.480	K	0.960	5.604	0.400		
L	0.880	4.082	0.240	L	0.960	4.962	0.240		
M	0.880	5. 284	0.880	M	0.960	6. 244	0.960		
N 0	0.880 0.720	4.482 4.722	0.880 0.720	N O	0.960 0.800	5. 446 5. 684	0.960		
P	0.120	4. 482	0.720	P	0.960	5. 446	0. 240		
<u> </u>	0.720	4. 722	0.720	Q	0.800	5. 684	0.800		
R	0.880	4.482	0.480	R	0.960	5.446	0.400		
S	0.480	4.482	0.480	S	0.400	5.446	0.400		
T	0.240	4.082	0.240	Т	0.240	4.962	0.240		
U	0.880	4.482	0.880	U	0.960	5.446	0.960		
V	0.240	4.962	0.240	V	0.240	6.084	0.240		
W	0.240	6.084	0.240	W	0.240	7. 124	0.240		
X	0.240 0.240	4.722	0.240	X Y	0.400	5.446	0.400		
Y Z	0. 480	5. 122 4. 482	0.240 0.480	Z	0.240 0.400	6.884 5.446	0.400		
	0.320	3.842	0.480	a	0.400	4.562	0.720		
b	0.720	4.082	0.480	b	0.800	4. 802	0.480		
С	0.480	4.002	0.240	С	0.480	4. 722	0.240		
d	0.480	4.082	0.720	d	0.480	4.802	0.800		
е	0.480	4.082	0.320	е	0.480	4.722	0.320		
f	0.320	2.480	0.160	f	0.320	2.882	0.160		
g	0.480	4.082	0.720	g	0.480	4.802	0.800		
h i	0.720 0.720	4.082	0.640	h i	0.800	4.722 1.280	0.720		
<u>'</u>	0.720	1.120 2.320	0.720 0.720		0.800	2.642	0.800		
k	0.720	4. 322	0.160	k	0.800	5. 122	0.160		
ī	0.720	1.120	0.720	ı i	0.800	1. 280	0.800		
m	0.720	6.724	0.640	m	0.800	7. 926	0.720		
n	0.720	4.082	0.640	n	0.800	4.722	0.720		
0	0.480	4.0B2	0.480	0	0.480	4.882	0.480		
Р	0.720	4.082	0.480	р	0.800	4.802	0.480		
q	0.480	4.082	0.720	q	0.480	4.802	0.800		
s s	0.720 0.320	2. 642 3. 362	0.160	r s	0.800 0.320	3. 042 3. 762	0.160		
†	0.320	2.882	0.080	t	0.320	3. 762	0.080		
u	0.640	4.082	0.720	u	0.720	4. 722	0.800		
٧	0.160	4.722	0.160	V	0.160	5.684	0.160		
w	0.160	7.524	0.160	w	0.160	9.046	0.160		
×	0.000	5. 202	0.000	Х	0.000	6. 244	0.000		
У	0.160	4.962	0.160	у	0.160	6.004	0.160		
Z	0.240	3. 362	0.240	Z 1	0.240	4.002	0.240		
2	0.720 0.480	1.680 4.482	0.880 0.480	2	0.800 0.800	2.000 5.446	0.960		
3	0.480	4.482	0.480	3	1.440	5. 446	0.800		
4	0.240	4. 962	0.720	4	0.160	6. 004	0.960		
5	0.480	4.482	0.480	5	0.800	5. 446	0.800		
6	0.720	4.482	0.720	6	0.800	5.446	0.800		
7	0.240	4.482	0.720	7	0.560	5.446	0.560		
8	0.480	4.482	0.480	8	0.800	5.446	0.800		
9	0.480	4.482	0.480	9	0.800	5.446	0.800		
0	0.720	4. 722	0.720	0	0.800	5.684	0.800		
-	0.240	2.802	0.240	-	0.240	2.802	0.240		

GEWALT HAMILTON ASSOCIATES, INC. T

**TS SHT NO 65** 

OT-StdDetails.dgr 88.800 OT D1 STANDARD TS02

JSER NAME = zwallsten LP 07/01/2015 DESIGNED - LP/IP REVISED DRAWN REVISED LOT SCALE = 1:2 HECKED REVISED PLOT DATE = 8/20/2020 REVISED DATE

		DIS	STRICT O	NE		F.A.U. RTE	
M	IAST ARM	MOUN	ITEN STI	REFT I	NAME SIGNS	298	
14	IASI AIIWI	WIOOI	VILD 311	ILLI I	IVAIVIL SIGNS		Τ
	SHEET	OF	SHEETS	STA.	TO STA.		_

F.A.U. RTE	SECTION	COUNTY	TOTAL SHEETS	SHEET NO.	
298	18-00517-00-TL	WILL	72	65	
TS-02			CONTRACT	NO. 6	1G36
	ILLINOIS	FED. AL	D. PROJECT		

#### TRAFFIC SIGNAL LEGEND

(NOT TO SCALE)

ITEM	<u>EXISTING</u>	PROPOSED	<u>ITEM</u>	<u>EXISTING</u>	PROPOSED	<u>ITEM</u>	<u>EXISTING</u>	<u>PROPOSED</u>
CONTROLLER CABINET		lacktriangle	HANDHOLE -SQUARE -ROUND			SIGNAL HEAD -(P) PROGRAMMABLE SIGNAL HEAD		R R Y
COMMUNICATION CABINET	ECC	СС	HEAVY DUTY HANDHOLE					G G G ←Y ←Y ←G ←G
MASTER CONTROLLER	ЕМС	MC	-SQUARE -ROUND	H ®	⊞ 19		€G €G P	4Y 4G 4G P
MASTER MASTER CONTROLLER	ЕММС	ммс	DOUBLE HANDHOLE			SIGNAL HEAD WITH BACKPLATE	<b>a a a</b>	
UNINTERRUPTABLE POWER SUPPLY	4	<b>7</b>	JUNCTION BOX		•	-(P) PROGRAMMABLE SIGNAL HEAD -(RB) RETROREFLECTIVE BACKPLATE		R R Y G G
SERVICE INSTALLATION -(P) POLE MOUNTED	- <u>-</u> -	- <b>■</b> -P	RAILROAD CANTILEVER MAST ARM	$X \longrightarrow X$	X <del>OX X</del>			G G G G G G G G G G G G G G G G G G G
SERVICE INSTALLATION			RAILROAD FLASHING SIGNAL	<del>∑⊙</del> ∑	X⊕X		P RB	P RB
-(G) GROUND MOUNTED -(GM) GROUND MOUNTED METERED	$\boxtimes^{G} \boxtimes^{GM}$	<b>⊠</b> <sup>G</sup> <b>⊠</b> <sup>GM</sup>	RAILROAD CROSSING GATE	₹0₹>	X•X-	PEDESTRIAN SIGNAL HEAD		
TELEPHONE CONNECTION	ET	Т	RAILROAD CROSSBUCK	₹	*	AT RAILROAD INTERSECTIONS	<b>©</b>	乔
STEEL MAST ARM ASSEMBLY AND POLE	<u> </u>	<u> </u>	RAILROAD CONTROLLER CABINET		<b>≯</b> ∢	PEDESTRIAN SIGNAL HEAD	<b>C</b> C	<b>₽</b> C <b>★</b> D
ALUMINUM MAST ARM ASSEMBLY AND POLE		·	UNDERGROUND CONDUIT (UC),			WITH COUNTDOWN TIMER	<b>(A)</b> D	<b>★</b> □
STEEL COMBINATION MAST ARM	0 <del>\</del>	•*	GALVANIZED STEEL TEMPORARY SPAN WIRE,			ILLUMINATED SIGN "NO LEFT TURN"/"NO RIGHT TURN"		
ASSEMBLY AND POLE WITH LUMINAIRE SIGNAL POST			TETHER WIRE, AND CABLE	C	CD.	NUMBER OF CONDUCTORS, ELECTRIC	- /	_
-(BM) BARREL MOUNTED - TEMPORARY	0	● ● BM	SYSTEM ITEM	5	SP IP	CABLE NO. 14, UNLESS NOTED OTHERWISE. ALL DETECTOR LOOP CABLE TO BE SHIELDED		
WOOD POLE	$\otimes$	•	INTERSECTION ITEM REMOVE ITEM	1	IP R	GROUND CABLE IN CONDUIT,	1#6	<del></del>
GUY WIRE	>-	>-	RELOCATE ITEM		RL	NO. 6 SOLID COPPER (GREEN)		
SIGNAL HEAD	$\rightarrow$	-	ABANDON ITEM		A	ELECTRIC CABLE IN CONDUIT, TRACER NO. 14 1/C	1	
SIGNAL HEAD WITH BACKPLATE	+>	+	CONTROLLER CABINET AND		RCF	COAXIAL CABLE	<u> </u>	<u> </u>
SIGNAL HEAD OPTICALLY PROGRAMMED	→ P + P	- <b>▶</b> P + <b>▶</b> P	FOUNDATION TO BE REMOVED		RCF		-/	
FLASHER INSTALLATION -(FS) SOLAR POWERED	op F op FS	•► FS	MAST ARM POLE AND FOUNDATION TO BE REMOVED		RMF	VENDOR CABLE  COPPER INTERCONNECT CABLE,		
	ы⊳ <sup>F</sup> ы⊳ <sup>FS</sup>	<b>₽</b> ► <b>F</b> S	SIGNAL POST AND FOUNDATION TO BE REMOVED		RPF	NO. 18, 3 PAIR TWISTED, SHIELDED	6#18	<del></del>
PEDESTRIAN SIGNAL HEAD	-0	-1	DETECTOR LOOP, TYPE I			FIBER OPTIC CABLE -NO. 62.5/125, MM12F -NO. 62.5/125, MM12F SM12F		
PEDESTRIAN PUSH BUTTON -(APS) ACCESSIBLE PEDESTRIAN PUSH BUTTON	<pre></pre>		PREFORMED DETECTOR LOOP	PP	PP	-NO. 62.5/125, MM12F SM24F	24F)	24F)
RADAR DETECTION SENSOR	R	R	SAMPLING (SYSTEM) DETECTOR	5 (5)	S S			—(36F)—
VIDEO DETECTION CAMERA	V 1	<b>V</b> ■	INTERSECTION AND SAMPLING (SYSTEM) DETECTOR	IS (IS)	IS (S)			
RADAR/VIDEO DETECTION ZONE			QUEUE AND SAMPLING (SYSTEM) DETECTOR	QS QS	QS QS	GROUND ROD -(C) CONTROLLER -(M) MAST ARM	<u> </u>	$\frac{1}{T}^{C} \stackrel{\triangle}{\downarrow}^{M} \stackrel{\triangle}{\downarrow}^{P} \stackrel{\triangle}{\downarrow}^{S}$
PAN, TILT, ZOOM (PTZ) CAMERA	PTZ	PTZ	WIRELESS DETECTOR SENSOR	<b>®</b>	<b>®</b>	-(P) POST -(S) SERVICE		
EMERGENCY VEHICLE LIGHT DETECTOR	$\bowtie$	<b>◄</b>	WIRELESS ACCESS POINT		-			
CONFIMATION BEACON	<b>○</b> —(]	•-(			_			
WIRELESS INTERCONNECT	o <del>+1   </del>	• <del>।   </del>						
WIRELESS INTERCONNECT RADIO REPEATER	ERR	RR						

STATE OF ILLINOIS
DEPARTMENT OF TRANSPORTATION

SECTION

18-00517-00-TL

TS-05 CON I

DISTRICT ONE

STANDARD TRAFFIC SIGNAL DESIGN DETAILS

SHEET 1 OF 7 SHEETS STA.

COUNTY SHEETS NO.

WILL 72 66

CONTRACT NO. 61G36

JSER NAME = zwallsten

PLOT DATE = 8/20/2020

PLOT SCALE = 1:2

DESIGNED - IP

DRAWN - IP

CHECKED - LP


REVISED

REVISED


REVISED

- 2. THE NUMBER OF LOOP TURNS SHALL BE AS RECOMMENDED BY THE AMPLIFIER MANUFACTURER. ALL ADJACENT SIDES OF THE LOOPS SHALL BE INSTALLED IN SUCH A WAY THAT THE CURRENT FLOW IS IN THE SAME DIRECTION TO REINFORCE ITS MAGNETIC FIELDS FOR SMALL VEHICLE DETECTION.
- 3. EACH LOOP LEAD-IN SHALL BE IDENTIFIED AND PERMANENTLY TAGGED IN THE HANDHOLE. EACH LEAD-IN CABLE TAG SHALL INDICATE THE LOCATION OF THE LOOP, LOOP ROTATION (CLOCKWISE/COUNTERCLOCKWISE), LOOP LEAD-IN DIRECTION (IN OR OUT), LOOP CABLE NUMBER AND LOCATION IN CABINET, AND NUMBER OF TURNS IN THE DETECTOR LOOPS IN WATER PROOF INK AS INDICATED ON THE DISTRICT 1 STANDARD TRAFFIC SIGNAL DESIGN DETAIL. THE CONTRACTOR SHALL MARK LOOP LOCATIONS ON RECORD DRAWINGS AND PRESENT TO THE ENGINEER AFTER FINAL INSPECTION. LOOPS SHALL BE MARKED BY LANE AND LOOP NUMBER. SEE DETAIL BELOW.
- 4. ALL LOOP CABLE SHALL BE FASTENED WITH PLASTIC TIE WRAP TO THE HANDHOLE HOOKS.
- 5. IN ASPHALT PAVEMENT, LOOPS SHOULD BE PLACED IN THE BINDER AND DIVEHOLES MARKED AT THE CURB WITH A SAW-CUT. THE SAW-CUT SHALL BE CUT IN ACCORDANCE WITH LOCAL AND E.P.A. DUST CONTROL REQUIREMENTS. DETECTOR LOOP(S) SHALL NOT BE INSTALLED IN WET CONDITIONS AND THE SAW-CUTS MUST BE FREE OF DEBRIS AND RESIDUE SUCH AS DUST AND WATER WHICH IS TO BE ACHIEVED BY THE USE OF COMPRESSED AIR, WIRE BRUSHING AND HEAT DRYING ACCORDING TO SEALANT MANUFACTURER REQUIREMENTS. THE DETECTOR WIRE SHALL BE HELD IN PLACE BY THE USE OF FORM WEDGES. WEDGES SHALL BE SPACED NO MORE THAN 18" (450 mm) APART.
- 6. LOOP SPLICES SHALL BE SOLDERED USING A SOLDERING IRON. BLOW TORCHES OR OTHER DEVICES WHICH OXIDIZE COPPER CABLE SHALL NOT BE ALLOWED FOR SOLDERING OPERATIONS. SEE DETAIL BELOW RIGHT.
- 7. PREFORMED DETECTOR LOOPS SHALL BE USED, AS SHOWN ON THE PLANS, WHERE NEW CONCRETE PAVEMENT IS PROPOSED. THE INSTALLATION OF PREFORMED LOOPS SHALL BE IN ACCORDANCE WITH THE DISTRICT 1 SPECIFICATIONS OR AS DIRECTED BY THE ENGINEER.

#### **LOOP LEAD-IN CABLE TAG**

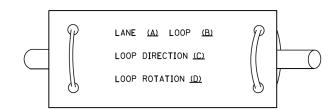



- A. LANE 1 IS THE LANE CLOSEST TO THE CENTERLINE OF THE ROADWAY
- B. LOOP #1 IS THE LOOP IN THE LANE CLOSEST TO THE INTERSECTION
- C. LABEL LOOP CABLE "IN" OR LOOP CABLE "OUT".
- D. LABEL LOOP CABLE CLOCKWISE OR LOOP CABLE COUNTERCLOCKWISE.

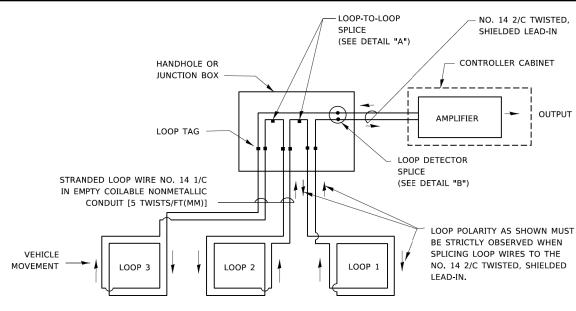

#### **DETECTOR LOOP WIRING SCHEMATIC**

- LOOPS SHALL BE SPLICED IN SERIES. SAW-CUTS SHALL BE A MINIMUM WIDTH OF 5/16" (8 mm).
- SAW-CUT DEPTHS SHALL BE 3" (75 mm). IF IN CONCRETE,
- THE SAW-CUT DEPTH SHALL BE TO THE TOP OF THE REINFORCEMENT.
- LOOP CORNERS SHALL BE DRILLED WITH A 2" (50 mm) DIAMETER CORE.

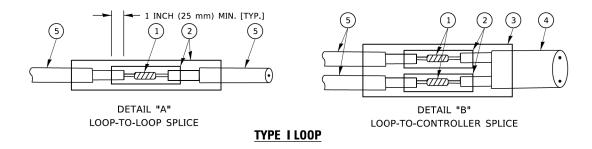

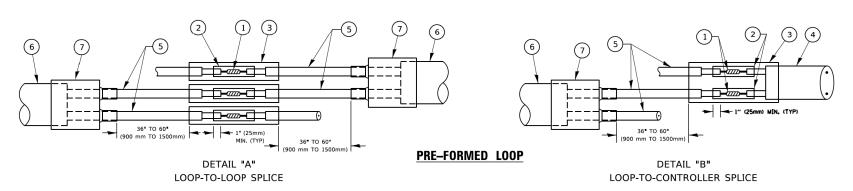

#### LOOP DETECTOR SPLICE

- (1) WESTERN UNION SPLICE SOLDERED WITH ROSIN CORE FLUX. ALL EXPOSED SURFACES OF THE SOLDER SHALL BE SMOOTH. THE WESTERN UNION SPLICES SHALL BE STAGGERED.
- (2) WCSMW 30/100 HEAT SHRINK TUBE, MINIMUM LENGTH 3" (75 mm), UNDERWATER GRADE.
- (3) WCS 200/750 HEAT SHRINK TUBE, MINIMUM LENGHT 6" (150 mm), UNDERWATER GRADE.

SCALE: NONE

(4) NO. 14 2/C TWISTED, SHIELDED CABLE.

- 5 LOOP CONDUCTOR WITH FLEXIBLE PLASTIC TUBE. PRE-FORMED LOOP
- (6) XL POLYOLEFIN 2 CONDUCTOR
- (7) BREAKOUT SEALS. TYCO CBR-2 OR APPROVED EQUAL

WILL

72

CONTRACT NO. 61G36

JSER NAME = zwallster DESIGNED LE NAME = REVISED OT-StdDetails.dgr DRAWN REVISED 88 800 HECKED REVISED OT D1 STANDARD TS05b PLOT DATE = 8/20/2020 REVISED DATE

STATE OF ILLINOIS **DEPARTMENT OF TRANSPORTATION** 

DISTRICT ONE 18-00517-00-TL STANDARD TRAFFIC SIGNAL DESIGN DETAILS TS-05 SHEET 2 OF 7 SHEETS STA.


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#### TRAFFIC SIGNAL MAST ARM AND SIGNAL POST


MAST ARM MOUNTED SIGNALS IN EXISTING, PROPOSED OR FUTURE SIDEWALK/BICYCLE PATH AREA. INTERSECTION SHOWN WITH PEDESTRIAN SIGNALS AND

PEDESTRIAN PUSHBUTTON DETECTORS.




- 2. REFER TO THE TRAFFIC SIGNAL EQUIPMENT OFFSET TABLE.
- 3. PROVIDE A LEVEL ALL-WEATHER SURFACE (CONCRETE SIDEWALK. ASPHALT BICYCLE PATH SURFACE OR MATCHING MATERIAL TO THE ADJACENT SURFACE) UP TO THE MAST ARM SHAFT OR
- 4. THE FACE OF THE PEDESTRIAN PUSHBUTTON SHALL BE PARALLEL TO THE CROSSWALK TO BE USED.
- 5. THE LOCATIONS AND INSTALLATION OF PEDESTRIAN SIGNAL HEADS AND PEDESTRIAN PUSHBUTTONS SHALL MEET THE REQUIREMENTS OF THE MUTCD AND INFORMATION FOUND IN THE "AMERICANS WITH DISABILITIES ACT ACCESSIBILITY GUIDELINES FOR BUILDINGS AND FACILITIES."
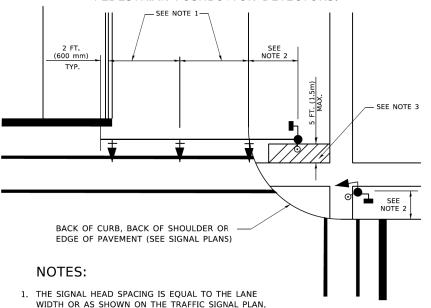
#### PEDESTRIAN SIGNAL POST PEDESTRIAN PUSH BUTTON POST

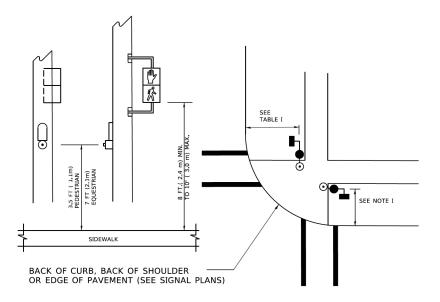

#### NOTES:

- 1. REFER TO THE TRAFFIC SIGNAL EQUIPMENT OFFSET TABLE.
- 2. PROVIDE A LEVEL ALL-WEATHER SURFACE (CONCRETE SIDEWALK, ASPHALT BICYCLE PATH SURFACE OR MATCHING MATERIAL TO THE ADJACENT SURFACE) UP TO THE PEDESTRIAN SIGNAL POST OR THE PEDESTRIAN PUSH BUTTON POST.
- 3. THE FACE OF THE PEDESTRIAN PUSHBUTTON SHALL BE PARALLEL TO THE CROSSWALK TO BE USED.
- 4. THE LOCATIONS AND INSTALLATION OF PEDESTRIAN SIGNAL HEADS AND PEDESTRIAN PUSHBUTTONS SHALL MEET THE REQUIREMENTS OF THE MUTCD AND INFORMATION FOUND IN THE "AMERICANS WITH DISABILITIES ACT ACCESSIBILITY GUIDELINES FOR BUILDINGS AND FACILITIES."

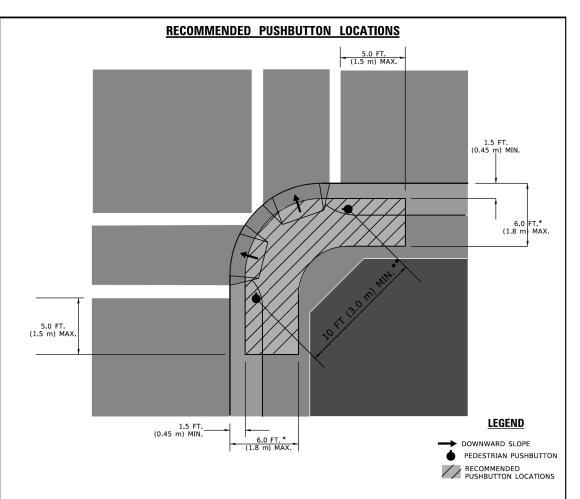

- WHERE THERE ARE CONSTRAINTS THAT MAKE IT IMPRACTICAL TO PLACE THE PEDESTRIAN PUSHBUTTON BETWEEN 1.5 FT (0.45 m) AND 6 FT ( 1.8 m) FROM THE EDGE OF THE CURB. SHOULDER, OR PAVEMENT. IT SHOULD NOT BE FURTHER THAN 10 FT (3 m) FROM THE EDGE OF CURB, SHOULDER, OR PAVEMENT.
- WHERE THERE ARE CONSTRAINTS ON A PARTICULAR CORNER THAT MAKE IT IMPRACTICAL TO PROVIDE THE 10 FT (3 m) SEPERATION BETWEEN THE TWO PEDESTRIAN PUSHBUTTONS, THE PUSHBUTTONS MAY BE PLACED CLOSER TOGETHER OR ON THE SAME POLE.

#### NOTES:

- 1. PEDESTRIAN SIGNAL HEADS SHALL BE MOUNTED WITH THE BOTTOM OF THE SIGNAL HOUSING INCLUDING BRACKETS NOT LESS THAN 8 FT (2.4 m) OR MORE THAN 10 FT (3 m) ABOVE SIDEWALK LEVEL, AND SHALL BE POSITIONED AND ADJUSTED TO PROVIDE MAXIMUM VISIBILITY AT THE BEGINNING OF THE CONTROLLED CROSSWALK.
- 2. THE BOTTOM OF THE SIGNAL HOUSING (INCLUDING BRACKETS) OF A VEHICULAR SIGNAL FACE THAT IS NOT LOCATED OVER A HIGHWAY SHALL BE AT LEAST 8 FT (2.4 m) BUT NOT MORE THAN 19 FT (5.8 m) ABOVE THE SIDEWALK OR, IF THERE IS NO SIDEWALK, ABOVE THE PAVEMENT GRADE AT THE CENTER OF THE ROADWAY.
- 3. THE BOTTOM OF THE SIGNAL HOUSING AND ANY RELATED ATTACHMENTS TO A SIGNAL FACE LOCATED OVER ANY PORTION OF A HIGHWAY SHALL BE ACCORDING TO CURRENT STATE STANDARDS 877001, 877002, 877006, 877011 AND 877012 WITH A MINIMUM OF 16 FT (5.0 m) AND A MAXIMUM OF 18 FT. (5.5 m) FROM THE HIGHEST POINT OF PAVEMENT
- 4. THE BOTTOM OF THE TEMPORARY SPAN WIRE MOUNTED SIGNAL HOUSING AND ANY RELATED ATTACHMENTS TO A SIGNAL FACE LOCATED OVER ANY PORTION OF A HIGHWAY SHALL BE ACCORDING TO CURRENT STATE STANDARD 880001 WITH A MINIMUM OF 17 FT (5.18 m) FROM THE HIGHEST POINT OF PAVEMENT.
- 5. THE TOP OF THE SIGNAL HOUSING OF A SIGNAL FACE LOCATED OVER ANY PORTION OF A HIGHWAY SHALL NOT BE MORE THAN 25.6 FT (7.8 m) ABOVE THE PAVEMENT.

#### TRAFFIC SIGNAL EQUIPMENT OFFSET

TRAFFIC SIGNAL EQUIPMENT	COMBINATION CONCRETE CURB AND GUTTER (MINIMUM DISTANCE FROM BACK OF CURB TO CENTERLINE OF FOUNDATION)	SHOULDER/NON-CURBED AREA (MINIMUM DISTANCE FROM EDGE OF PAVEMENT TO CENTERLINE OF FOUNDATION)
TRAFFIC SIGNAL MAST ARM POLE	6 FT (1.8m)	SHOULDER WIDTH + 2 FT (0.6m), MINIMUM 10 FT (3.0m)
TRAFFIC SIGNAL POST	4 FT (1.2m)	SHOULDER WIDTH + 2 FT (0.6m), MINIMUM 10 FT (3.0m)
PEDESTRIAN SIGNAL POST	4 FT (1.2m)	SHOULDER WIDTH + 2 FT (0.6m), MINIMUM 10 FT (3.0m)
PEDESTRIAN PUSHBUTTON POST	4 FT (1.2m)	SHOULDER WIDTH + 2 FT (0.6m), MINIMUM 10 FT (3.0m)
TEMPORARY WOOD POLE	6 FT (1.8m)	SHOULDER WIDTH + 2 FT (0.6m), MINIMUM 10 FT (3.0m)
CONTROLLER CABINET	6 FT (1.8m) MINIMUM DISTANCE SEE NOTE 2	SHOULDER WIDTH + 6 FT (1.8m), MINIMUM 16 FT (4.9m) SEE NOTE 3.
SERVICE INSTALLATION, GROUND MOUNT	6 FT (1.8m) MINIMUM DISTANCE SEE NOTE 2	SHOULDER WIDTH + 6 FT (1.8m), MINIMUM 16 FT (4.9m) SEE NOTE 3.

#### NOTES:

- 1. CONTACT THE "AREA TRAFFIC SIGNAL MAINTENANCE AND OPERATIONS ENGINEER" FOR ASSISTANCE IN LOCATING THE TRAFFIC SIGNAL EQUIPMENT WHEN THERE ARE CONFLICTS WITH DITCHES OR THE MINIMUM OFFSET DISTANCES CANNOT BE MET.
- 2. MINIMUM DISTANCE FROM THE BACK OF CURB TO THE ROADWAY SIDE OF THE FOUNDATION.
- 3. MINIMUM DISTANCE FROM THE EDGE OF PAVEMENT TOTHE ROADWAY SIDE OF THE FOUNDATION.
- 4. ANY CHANGES TO THE OFFSETS OF THE FOUNDATIONS, FROM THE MINIMUM DISTANCES LISTED IN THE "TRAFFIC SIGNAL EQUIPMENT OFFSET" CHART AND THE TRAFFIC SIGNAL INSTALLATION PLAN, COULD EFFECT THE PLACEMENT OF THE SIGNAL HEADS, PEDESTRIAN SIGNAL HEADS AND THE PEDESTRIAN PUSHBUTTONS, THE SIGNAL HEAD PLACEMENT ON THE MAST ARMS SHALL REMAIN AS PER THE TRAFFIC SIGNAL INSTALLATION PLAN AND THE "TRAFFIC SIGNAL MAST ARM AND SIGNAL POST" DETAIL ABOVE. THE PROPOSED MAST ARM LENGTHS MAY NEED TO BE REVISED TO MEET THE ABOVE REQUIREMENTS. THE PEDESTRIAN SIGNAL HEADS AND PEDESTRIAN PUSHBUTTONS MUST MEET THE REQUIREMENTS UNDER THE DETAILS ON THIS SHEET.


SCALE: NONE


#### JSER NAME = zwallsten DESIGNED LE NAME = REVISED OT-StdDetails.dgr DRAWN REVISED 88 800 HECKED REVISED OT D1 STANDARD TS05c PLOT DATE = 8/20/2020 DATE REVISED


#### STATE OF ILLINOIS **DEPARTMENT OF TRANSPORTATION**

		DIST	RICT OF	NE		F.A.U. RTE	SECTION	COUNTY	TOTAL SHEETS	
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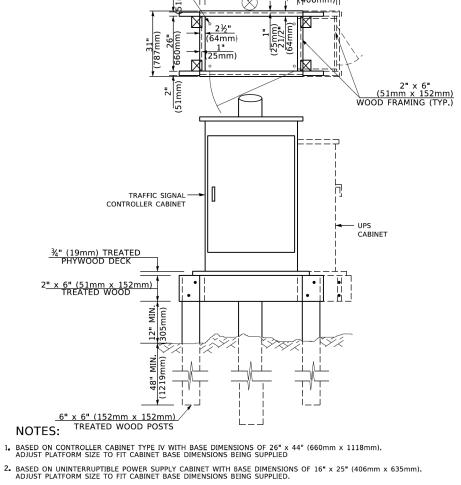
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**CONTROLLER CABINETS** 

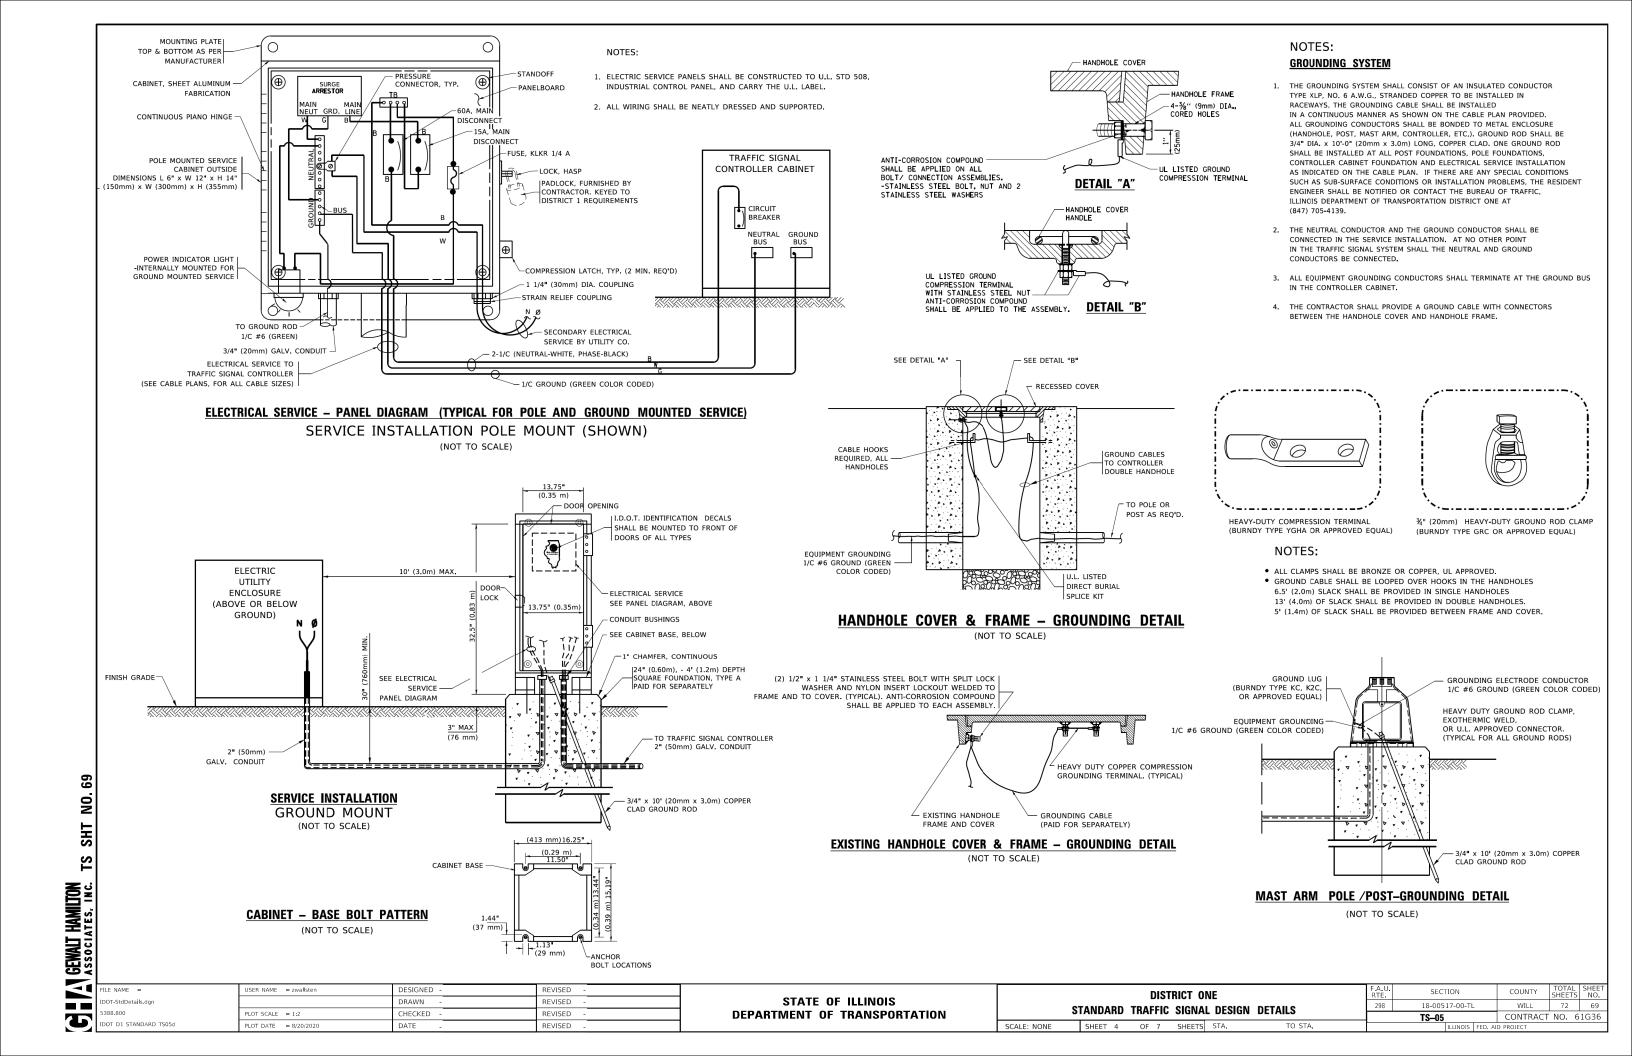

65" (SEE NOTE 4) (1651mm)

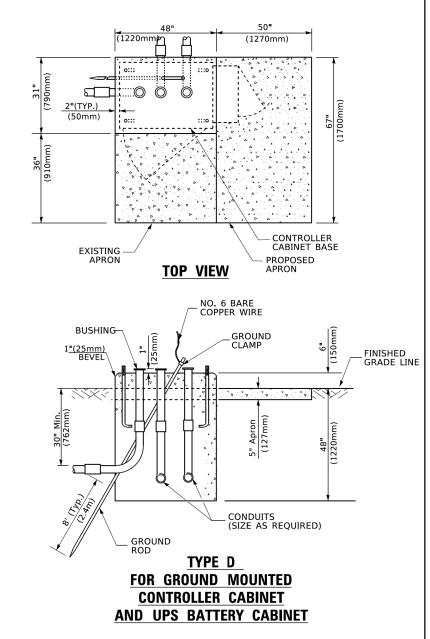49" (SEE NOTE 3) (1245mm)

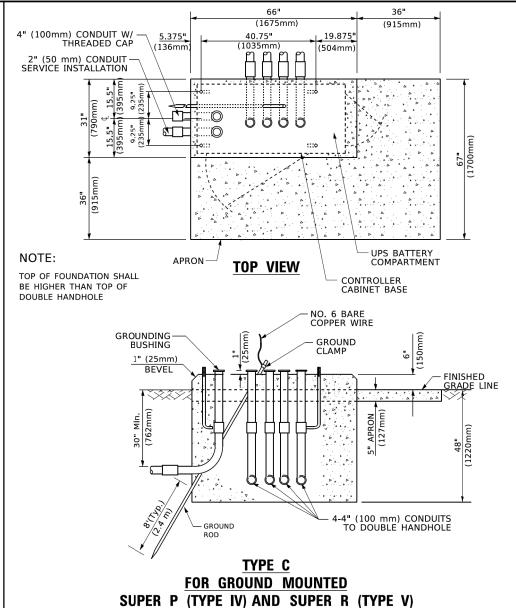SEE NOTE 5-

- $\ensuremath{\mathfrak{Z}_{\bullet}}$  PLATFORM SIZE FOR CONTROLLER CABINET TYPE IV.
- 4. PLATFORM SIZE FOR CONTROLLER CABINET TYPE IV AND UNINTERRUPTIBLE POWER SUPPLY CABINET.
- 5. DRILLED HOLES THROUGH THE PLATFORM BASE TO MATCH THE CONTROLLER CABINET BOLT TEMPLATE. FASTEN THE CONTROLLER CABINET TO THE PLATFORM WITH CARRIAGE BOLTS, WASHERS AND NUTS,
- 6. FASTEN ALL SUPPORT WOOD FRAMING TO THE WOOD POSTS WITH 2 LAG SCREWS FOR EACH CONNECTION..

#### TEMPORARY SIGNAL CONTROLLER **WOOD SUPPORT PLATFORM**

CABLE SLACK LENGTH	FEET	METER
HANDHOLE	6.5	2.0
DOUBLE HANDHOLE	13.0	4.0
SIGNAL POST	2.0	0.6
MAST ARM	2.0	0.6
CONTROLLER CABINET	1.5	0.5
FIBER OPTIC AT CABINET	13.0	4.0
ELECTRIC SERVICE AT (CABINET OR SERVICE LOCATION)	1.5	0.5
GROUND CABLE (SIGNAL POST, MAST ARM, CABINET)	1.5	0.5
GROUND CABLE (BETWEEN FRAME AND COVER)	5.0	1.6

VERTICAL CABLE LENGTH	FEET	METER
MAST ARM POLE ( MAST ARM MOUNTED SIGNAL HEAD)		
(L = MAST ARM LENGTH - DISTANCE TO SIGNAL HEAD FROM END OF ARM)	20.0+L	6.0+L
BRACKET MOUNTED (MAST ARM POLE OR SIGNAL POLE)	13.0	4.0
PEDESTRIAN PUSH BUTTON	6.0	2.0
SERVICE INSTALLATION POLE MOUNT TO SERVICE DROP	13.5	4.1
SERVICE INSTALLATION POLE MOUNT TO GROUND	13.5	4.1
SERVICE INSTALLATION GROUND MOUNT	6.0	2.0
FOUNDATION (SIGNAL POST, MAST ARM POLE, CONTROLLER CABINET, SERVICE-GROUND MOUNT)	3.0	1.0

#### **VERTICAL CABLE LENGTH**

#### **CABLE SLACK**

FOUNDATION	DEPTH
TYPE A - Signal Post	4'-0" (1.2m)
TYPE C - CONTROLLER W/ UPS	4'-0" (1.2m)
TYPE D - CONTROLLER	4'-0" (1.2m)
SERVICE INSTALLATION, GROUND MOUNT, TYPE A - SQUARE	4'-0" (1.2m)

#### **DEPTH OF FOUNDATION**

SCALE: NONE

Mas	st Arm Length	① Foundation Depth	Foundation Diameter	Spiral Diameter	Quantity of Rebars	Size of Rebars
Less	than 30′ (9 <b>.</b> 1 m)	10'-0" (3.0 m)	30" (750mm)	24" (600mm)	8	6(19)
	than or equal to	13'-6" (4 <sub>4</sub> 1 m)	30" (750mm)	24" (600mm)	8	6(19)
30' (9.1	m) and less than 40' (12.2 m)	11'-0'' (3 <sub>4</sub> 4 m)	36" (900mm)	30" (750mm)	12	7(22)
	than or equal to 2 m) and less than 50' (15.2 m)	13'-0'' (4 <sub>*</sub> 0 m)	36" (900mm)	30" (750mm)	12	7(22)
	r than or equal to 5.2 m) and up to 55' (16.8 m)	15'-0'' (4.6 m)	36" (900mm)	30" (750mm)	12	7(22)
	r than or equal to 8 m) and less than 65' (19.8 m)	21'-0" (6.4 m)	42" (1060mm)	36" (900mm)	16	8(25)
	- than or equal to 9.8 m) and up to 75'(22.9 m)	25'-0" (7 <b>.</b> 6 m)	42" (1060mm)	36" (900mm)	16	8(25)


- 1. These foundation depths are for sites which have cohesive soils (clayey silt, sandy clay, etc.) along the length of the shaft, with an average Unconfined Compressive Strength (Ou) > 1.0 tsf (100 kpa). This strength shall be verified by boring data prior to construction or with testing by the Engineer during foundation drilling. The Bureau of Bridges & structures should be contacted for a revised design if other conditions are encountered.
- 2. Combination mast arm assemblies under 55 feet (16.8 m) shall use 36" (900 mm) diameter foundations.
- 3. Combination mast arm assemblies under 56 feet (16.8 m) through 75 feet (22.9 m) shall use 42" (1060 mm) diameter foundations
- 4. For most arm assemblies with dual arms refer to state standard 878001..

#### DEPTH OF MAST ARM FOUNDATIONS, TYPE E

l	FILE NAME =	USER NAME = zwallsten	DESIGNED -	REVISED -
	IDOT-StdDetails.dgn		DRAWN -	REVISED -
i	5388.800	PLOT SCALE = 1:2	CHECKED -	REVISED -
	IDOT D1 STANDARD TS05e	PLOT DATE = 8/20/2020	DATE -	REVISED -

STATE	. OF	ILLINOIS
DEPARTMENT	0F	TRANSPORTATION

		DISTRICT ONE IDARD TRAFFIC SIGNAL DESIGN DETAILS	F.A.U. RTE	SEC	TION		COUNTY	TOTAL SHEETS				
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<u> </u>	IANDAND	INALLIC	SIGNAL	DESIGN	DETAILS	_	TS-05			CONTRACT	NO. 6	1G36
	SHEET 5	OF 7	SHEETS	STA.	TO STA.			ILLINOIS	FED. All	D PROJECT		

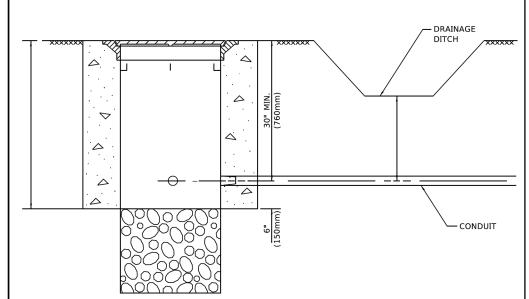

#### NOTES:

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OT D1 STANDARD TS05f


- 1. CONDUIT DEPTH SHALL BE A MINIMUM OF 30" (760mm) BELOW THE BOTTOM OF THE DRAINAGE DITCH OR ANY SLOPING GROUND
- 2. THE MINIMUM CONDUIT DEPTH APPLIES TO ALL CONDUIT PLACED UNDER ROADWAY PAVEMENT, MULTI-USE PATHS, SIDEWALKS AND SOIL SURFACES.
- 3. THE MINIMUM CONDUIT DEPTH APPLIES TO ALL HANDHOLES, HEAVY DUTY HANDHOLES AND DOUBLE HANDHOLES.

JSER NAME = zwallster

LOT SCALE = 1:2

PLOT DATE = 8/20/202

#### HANDHOLE WITH MINIMUM CONDUIT DEPTH (NOT TO SCALE)

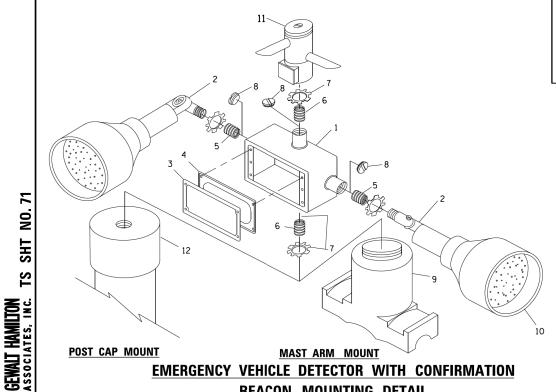

**BEACON MOUNTING DETAIL** 

DESIGNED

DRAWN

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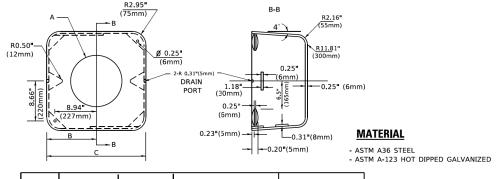
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(915mm) 40.75" (1035mm) CONTROLLER CABINET BASE PROPOSED-**TOP VIEW** APRON -NO. 3 DOWEL 18" (450mm NO. 6 BARE COPPER WIRE LONG (8 REQ.) BUSHING-GROUND CLAMP EXISTING-ANCHOR BOLTS **FINISHED** GRADE LINE BEVEL (225mm) -EXISTING CONDUITS EXISTING GROUND ROD MODIFY EXISTING TYPE "D" FOUNDATION TO TYPE "C" FOUNDATION (NOT TO SCALE)

ITEM	NO. IDENTIFICATION
1	OUTLET BOX- GALV. 21 CU.IN. (0.000344 CU-M)
2	LAMP HOLDER AND COVER
3	OUTLET BOX COVER
4	RUBBER COVER GASKET
5	REDUCING BUSHING
6	¾"(19 mm) CLOSE NIPPLE
7	¾"(19 mm) LOCKNUT
8	¾"(19 mm) HOLE PLUG
9	SADDLE BRACKET - GALV.
10	6 WATT PAR 38 LED FLOOD LAMP
11	DETECTOR UNIT
12	POST CAP [18 FT. (5.4 m) POST MIN.]


- 1. ALL ELECTRICAL ITEMS, EXCEPT ITEMS #2 AND #11 SHALL BE ALUMINUM OR
- 2. ITEM #1- OZ/GEDNEY FSX-1-50 OR EQUIVALENT ITEM #2- MULBERRY CON-O-SHADE LAMP SHIELD OR EQUIVALENT ITEM #9- "BAND-IT" SADDLE BRACKET OR EQUIVALENT
- 3. WHEN POST MOUNTING IS SPECIFIED, ITEM #9 SHALL NOT BE REQUIRED. THE DETECTION UNIT SHALL BE MOUNTED DIRECTLY ON TOP OF THE CAP BY DRILLING AND TAPPING A 3/4 "(19 mm) HOLE WITH PIPE THREADS. THE POST CAP SHALL EITHER BE SCREWED TO THE TOP OF THE POST OR A MINIMUM OF 3 TIGHTENING SCREWS SHALL BE REQUIRED ON EACH CAP.



Α	B C HEIGHT		WEIGHT	
VARIES	9.5"(241mm)	19"(483mm)	7" (178mm) - 12" (300mm)	53 lbs (24kg)
VARIES	10.75"(273mm)	21.5"(546mm)	7" (178mm) - 12" (300mm)	68 lbs (31 kg)
VARIES	13.0"(330mm)	26"(660mm)	7" (178mm) - 12" (300mm)	81 lbs (37 kg)
VARIES	18.5"(470mm)	37"(940mm)	7" (178mm) - 12" (300mm)	126 lbs (57 kg)

#### **SHROUD**

- . DIMENSION "A" IS EQUAL TO THE DIAMETER OF THE MAST ARM POLE AT THE TOP OF THE SHROUD. THE SHROUD SHALL BE TIGHT TO THE MAST ARM POLE.
- 2. THE SUPPLIER SHALL VERIFIED THE ABOVE DIMENSIONS BASED ON MAST ARM REQUIREMENTS.
- 3. THE HEIGHT OF THE SHROUD SHALL COVER THE ANCHOR BOLTS, NUTS AND MAST ARM POLE BASE.

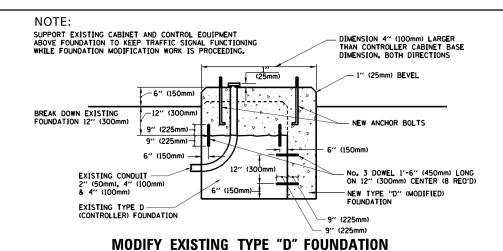


## EXISTING CONDUIT PLAN ELEVATION


SCALE: NONE

- 1. HANDHOLE CONSTRUCTED PER STATE STANDARD 814001.
- 2. REMOVAL OF THE EXISTING CONDUIT FROM THE HANDHOLE AND THE INSTALLATION OF THE CONDUIT BUSHINGS SHALL BE INCLUDED WITH THE COST OF THE HANDHOLE.

#### HANDHOLE TO INTERCEPT EXISTING CONDUIT

		DIST	RICT O	NE		F.A.U. RTE	SECTION	COUNTY	TOTAL SHEETS	SHEE NO.
STANDARD TRAFFIC SIGNAL DESIGN DETAILS		298	18-00517-00-TL	WILL	72	71				
	IANDAND	INALLIC	SIGIVA	L DESIGN	V DETAILS		TS-05	CONTRACT	NO. 6	1G36
	SHEET 6	OF 7	SHEETS	STA.	TO STA.		ILLINOIS FED A	ID PROJECT		

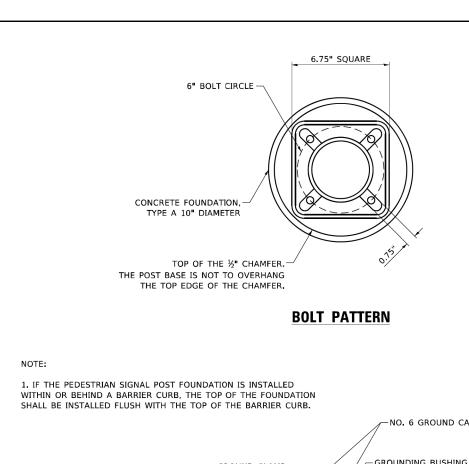

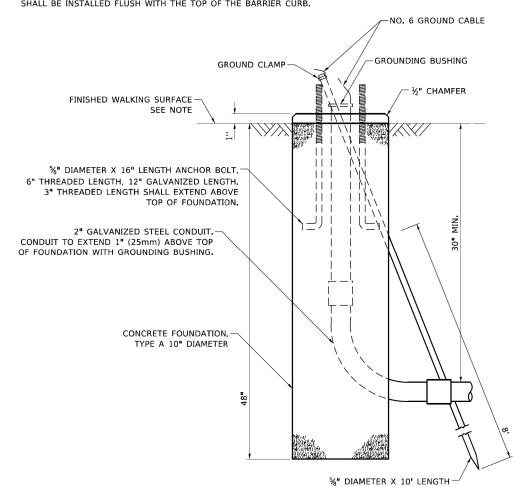

#### CONCRETE FOUNDATION, TYPE A 10-INCH DIAMETER

GROUND ROD

IP 1/8/2020

#### PEDESTRIAN SIGNAL POST, 10 FT.

#### PEDESTRIAN SIGNAL POST, 5 FT.







R10-3e

R10-3b


R10-3d

#### SIGN TABLE

SIGN	DIMENSIONS
R10-3b (RAILROAD ONLY)	9" X 12"
R10-3d (RAILROAD ONLY)	9" X 12"
R10-3e	9" X 15"

#### NOTES:

- 1. THE SIGN PANELS SHALL BE TYPE AP SHEETING.
- 2. THE ARROW ON SIGNS FOR PUSH-BUTTONS SERVING TWO DIRECTIONS ON THE SAME PHASE SHALL BE BI-DIRECTIONAL.
- 3. THE SIGN FOR DUAL-CALL PUSH-BUTTONS SHALL HAVE NO ARROW.

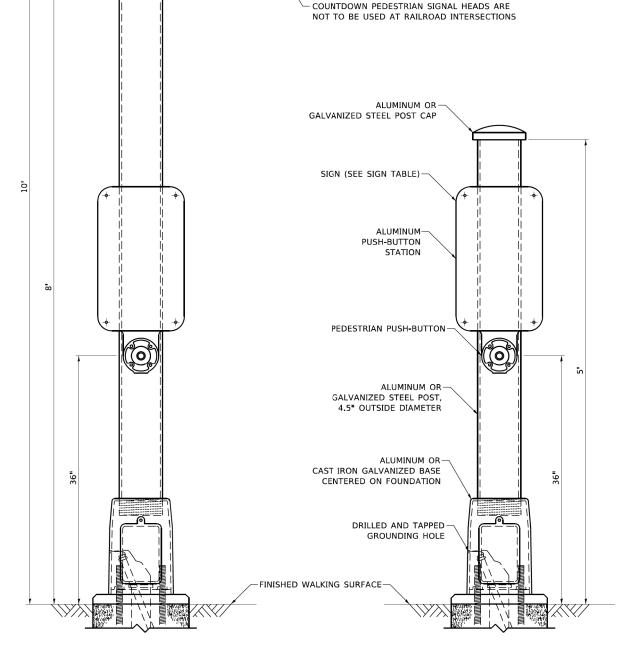

- PEDESTRIAN SIGNAL HEAD

TS SHT NO 72

GEWALT HAMILTON ASSOCIATES, INC. 

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JSER NAME = zwallsten DESIGNED - IP REVISED OOT-StdDetails.dgr DRAWN REVISED 388.800 LOT SCALE = 1:2 REVISED OOT D1 STANDARD TS05g PLOT DATE = 8/20/2020

STATE OF ILLINOIS **DEPARTMENT OF TRANSPORTATION** 

SECTION DISTRICT ONE 18-00517-00-TL WILL STANDARD TRAFFIC SIGNAL DESIGN DETAILS SHEET 7 OF 7 SHEETS STA.

72 72 CONTRACT NO. 61G36