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11-06-2020 LETTING ITEM 119

STATE OF ILLINOIS DEPARTMENT OF TRANSPORTATION DIVISION OF HIGHWAYS

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STATE STANDARDS

825101-02 LUMINARE WIRING IN POLE 825001-04 LIGHTING CONTROLLER POLE MOUNTED, 240V 836001-04 LIGHT POLE FOUNDATION

424016-05 MID-BLOCK CURB RAMPS FOR SIDEWALKS 606001-07 CONCRETE CURB TYPE B AND COMBINATION CONCRETE CURB AND CUTTER 701006-05 OFF-RD OPERATIONS, 2L, 2W, 15" (4.5 m) TO 24" (600 mm) FROM

701006-05 OFF-RD OPERATIONS, 2L, 2W, 15' (4.5 m) TO 24" (600 mm) PAVEMENT EDGE
701201-05 LANE CLOSURE, 2L, 2W, DAY ONLY, FOR SPEEDS ≥ 45 MPH
701301-04 LANE CLOSURE, 2L, 2W, SHORT TIME OPERATIONS
701311-03 LANE CLOSURE, 2L, 2W MOYING OPERATIONS
701301-05 URBAN LANE CLOSURE, 2L, 2W, UNDIVIDED
701701-10 URBAN LANE CLOSURE, MULTILANE INTERSECTION
701801-06 SIDEWALK, CORNER OR CROSSWALK CLOSURE
701901-08 TRAFFIC CONTROL DEVICES
720001-01 SIGN PANEL MOUTHING DETAILS
720006-04 SIGN PANEL RECETION DETAILS
72001-01 METAL POSTS FOR SIGN MARKERS AND DELINEATORS
728001-01 TELESCOPING STEEL SIGN SUPPORT
729001-01 APPLICATION OF TYPE A AND TYPE B POSTS
780010-05 TYPICAL PAVEMENT MARKINGS
805001-01 LECTRICAL SERVICE INSTALLATION DETAILS
821101-02 LUMINARE WIRING IN POLE

SAFE ROUTES TO SCHOOL

VILLAGE OF FORRESTON FORRESTON, ILLINOIS

PROPOSED ADA CROSSINGS PLANS

FAP ROUTE 316 ILLINOIS ROUTE 26 & FAP ROUTE 549 ILLINOIS ROUTE 72 SECTION: 19-00018-00-SW OGLE COUNTY PROJECT NO. MBH9(524) JOB NO. C-92-085-20 SRTS NO. CRTS-019-2003 CONTRACT No. 85702

WHITACE OF ECOPERTON

FORRESTON JR HIGH SCHOOL ADA SITE

VILLAGE OF	FORRESTON
MARK METZGER	VILLAGE PRESIDENT
MICHELLE DRAYTON	VILLAGE CLERK
FRED SCHNEIDERMAN	VILLAGE TREASURER

VILLAGE TRUSTEES

ILLINOIS DEPARTMENT of TRANSPORTATION REGION NO. 2, DISTRICT NO. 2

STEPHENSON

FORRESTON-

CARROLL

WHITESIDE

HENRY

ROCK ISLAND

JO DAVIESS

KEN VINNEDGE	VILLAGE TRUSTEE
MONTY COTTER	VILLAGE TRUSTEE
JEFF FREEZE	VILLAGE TRUSTEE
VICKYE NORRIS	VILLAGE TRUSTEE
KEN TOMS	VILLAGE TRUSTEE
GARY BUSS	VILLAGE TRUSTEE



2040 IL 26 ADT = 3700; 4.47% TRUCKS 2040 IL 72 ADT = 2430; 6.36% TRUCKS DESIGN SPEED LIMIT = 30 MPH

IL 72 FUNCTIONAL CLASS = MINOR ARTERIAL

J.U.L.I.E.

Know what's below. Call before you dig.


OR CALL (800) 892-0123

KEN VINNEDGE	VILLAGE TRUSTEE
MONTY COTTER	VILLAGE TRUSTEE
JEFF FREEZE	VILLAGE TRUSTEE
VICKYE NORRIS	VILLAGE TRUSTEE
KEN TOMS	VILLAGE TRUSTEE
GARY BUSS	VILLAGE TRUSTEE


UTILITIES

UTILITY TYPE	COMMON NAME
WATER & SEWER	VILLAGE OF FORRESTON
ELECTRIC	COMED
TELEPHONE	FRONTIER COMMUNICATIONS
GAS	NICOR GAS COMPANY
CABLE	COMCAST

(CONTRACTOR TO BE RESPONSIBLE FOR ANY ADJUSTMENTS TO BE MADE.)

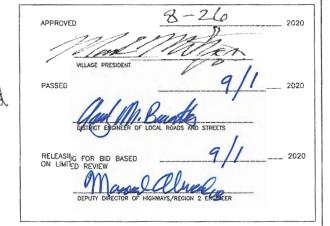

FOR BIDDING

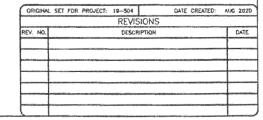

LOCATION MAP

LENGTH OF PROJECT = 200 FEET/0.04 MILES IL 26 FUNCTIONAL CLASS = PRINCÍPAL ARTERIAL

ENGINEERING & ENVIRONMENTAL

ILLINOIS

AWOI

WISCONSIN

ILLINOIS PROFESSIONAL DESIGN FIRM NUMBER: 184003525

sistere/Drowings/C3D/18/19-504/Phons/19-504 Piloms.chig. Tible

GENERAL NOTES

- 1. THIS PROJECT SHALL BE CONSTRUCTED IN ACCORDANCE WITH THE MUNICIPAL CODE, VILLAGE OF FORRESTON, ILLINOIS, CURRENT EDITION, THE ILLINOIS DEPARTMENT OF TRANSPORTATION'S "STANDARD SPECIFICATIONS FOR ROAD AND BRIDGE CONSTRUCTION IN ILLINOIS", CURRENT EDITION, "SUPPLEMENTAL SPECIFICATIONS AND RECURRING SPECIAL PROVISIONS," CURRENT EDITION, SPECIAL PROVISIONS AND THE "STANDARD SPECIFICATIONS FOR WATER AND SEWER MAIN CONSTRUCTION IN ILLINOIS", CURRENT EDITION. SIGN CONSTRUCTION AND PAVEMENT MARKINGS SHALL CONFORM TO THE REQUIREMENTS OF THE "MANUAL ON UNIFORM TRAFFIC CONTROL DEVICES", CURRENT EDITION.
- 2. IN THESE CONTRACT DOCUMENTS MENTION IS MADE OF THE "ENGINEER", WHICH SHALL MEAN THE VILLAGE'S DULY AUTHORIZED AGENT. IN THESE CONTRACT DOCUMENTS MENTION IS MADE OF THE "OWNER", WHICH SHALL MEAN VILLAGE OF FORRESTON, OR THEIR DULY AWARDED AGENT.
- 3. AS PART OF THE BIDDING PROCEDURE, THE CONTRACTOR SHALL VERIFY THAT THE QUANTITIES FOR PAY ITEMS, AS PRESENTED IN THESE PLAN DOCUMENTS, ARE SUBSTANTIALLY CORRECT. IF DISCREPANCIES ARE DETECTED, THE CONTRACTOR SHALL NOTIFY THE ENGINEER OF THE DISCREPANCY PRIOR TO THE BID DATE.
- 4. QUANTITIES SHOWN ARE ESTIMATES FOR INFORMATION ONLY. PAYMENT WILL BE BASED ON ACTUAL QUANTITIES MEASURED IN THE FIELD OR ON PAYMENT LIMIT DETAILS.
- 5. THE CONTRACTOR SHALL BE PAID FOR MATERIALS AND EQUIPMENT SUCCESSFULLY INSTALLED IN ACCORDANCE WITH THE PLANS AND SPECIFICATIONS AS MEASURED OR VERIFIED IN PLACE BY THE ENGINEER OR HIS AGENT.
- 6. IN CASE OF CONFLICT BETWEEN THE ABOVE MENTIONED SPECIFICATIONS, THE ENGINEER SHALL DETERMINE WHICH OF THE SPECIFICATIONS SHALL GOVERN. THE ENGINEER'S DECISION SHALL BE FINAL AND NO ADDITIONAL COMPENSATION SHALL BE AWARDED UNLESS APPROVED BY THE ENGINEER.
- 7. THE PROPOSED IMPROVEMENTS MUST BE CONSTRUCTED IN ACCORDANCE WITH THE ENGINEERING PLANS AS APPROVED BY THE OWNER. IMPROVEMENT REPRESENTATIONS AS SHOWN ON THESE PLANS, ARE AS ACCURATE AS POSSIBLE FROM THE INFORMATION AVAILABLE. HOWEVER SOME FIELD REVISIONS MAY BE REQUIRED TO ACCOMMODATE UNFORESEEN CIRCUMSTANCES — THE ENGINEER SHALL BE ADVISED OF ANY NECESSARY REVISIONS WITH SUFFICIENT LEAD TIME ALLOWED TO PROPERLY CONSIDER AND ACT UPON SAID REQUESTS. PROPER CONSTRUCTION TECHNIQUES MUST BE FOLLOWED IN CONSTRUCTING THOSE IMPROVEMENTS AS DETAILED IN THIS ENGINEERING PLAN.
- 8. THE ENGINEER SHALL HAVE THE AUTHORITY TO INSPECT, APPROVE OR REJECT THE WORKMANSHIP AND/OR MATERIALS WHICH GO TO MAKE UP IMPROVEMENTS AS DETAILED IN THESE PLANS AND SPECIFICATIONS.
- 9. GENERAL SAFETY PROVISION: TO PROVIDE DRIVERS WITH SAFE TRAVEL CONDITIONS DURING THE CONSTRUCTION PROJECT, AND TO PROVIDE SAFE WORKING CONDITIONS FOR ALL EMPLOYEES, THE RULES, REGULATIONS, AND CONDITIONS STATED BELOW WILL PREVAIL FOR THE DURATION OF THIS CONTRACT. ANY EMPLOYEE OF THE CONTRACTOR OR HIS SUBCONTRACTORS WHO REFUSES TO COMPLY WITH THESE GENERAL SAFETY PROVISIONS SHALL BE REMOVED FROM THE JOB SITE IN ACCORDANCE WITH STATE AND LOCAL REQUIREMENTS. THE CONTRACTOR AND ANY SUBCONTRACTORS RETAINED BY HIM SHALL COMPLY WITH THE STATE AND FEDERAL REQUIREMENTS OF THE OCCUPATIONAL SAFETY AND HEALTH ACT OF 1970 (OSHA), JULY 1, 1987 AS IT RELATES TO CONTRACTOR'S OPERATIONS.
- 10. THE CONTRACTOR SHALL COMPLY WITH ALL STATE REGULATIONS REGARDING AIR, WATER, AND NOISE POLLUTION. THE CONTRACTOR WILL NOT BE ALLOWED TO BUILD FIRES ON THE SITE.
- 11. THE SCALE SHOWN ON THE DRAWINGS APPLIES ONLY TO THE FULL SIZE PLANS NOT THE REDUCED SIZE PLANS.
- 12. IT SHALL BE THE CONTRACTOR'S RESPONSIBILITY TO MAINTAIN DRAINAGE FLOWS AT ALL TIMES DURING THE PERFORMANCE OF THE WORK. METHODS USED BY THE CONTRACTOR SHALL BE SUBJECT TO THE APPROVAL OF THE ENGINEER. COST OF MAINTAINING DRAINAGE FLOWS SHALL BE INCIDENTAL TO THE CONTRACT.
- 13. WHERE SECTION OR SUBSECTION MONUMENTS ARE ENCOUNTERED, THE ENGINEER SHALL BE NOTIFIED BEFORE SUCH MONUMENTS ARE REMOVED OR DISTURBED. THE CONTRACTOR SHALL PROTECT AND CAREFULLY PRESERVE ALL PROPERTY MARKERS, MONUMENTS AND RIGHT-OF-WAY PINS UNTIL THE OWNER, AND AUTHORIZED SURVEYOR, OR AGENT HAS WITNESSED OR OTHERWISE REFERENCED THEIR LOCATION. THE CONTRACTOR SHALL BE RESPONSIBLE FOR HAVING AN AUTHORIZED SURVEYOR RE-ESTABLISH ANY SECTION OR SUBSECTION MONUMENTS DESTROYED BY HIS OPERATIONS. REPLACEMENT OF MONUMENTS WILL BE DETERMINED BY THE ENGINEER.
- 14. THE CONTRACTOR SHALL REMOVE, STORE, AND RELOCATE TO THE SATISFACTION OF THE ENGINEER ALL EXISTING SIGNAGE IN ACCORDANCE WITH STATE AND LOCAL REQUIREMENTS, AND CONSIDER THIS AS INCIDENTAL TO THE CONTRACT.
- 15. OUTSIDE THE EXISTING RIGHT-OF-WAY, THE CONTRACTOR SHALL USE CARE IN GRADING OR EXCAVATION NEAR ANY AND ALL EXISTING SIGNS OUTSIDE THE RIGHT-OF-WAY. ANY SIGNS REMOVED FOR CONSTRUCTION PURPOSES SHALL BE CAREFULLY REMOVED AND RE-ERECTED BY THE CONTRACTOR AT A LOCATION NEAREST TO THE ORIGINAL LOCATION, OR AT A LOCATION DETERMINED BY THE ENGINEER IN THE FIELD. REMOVAL AND RE-ERECTED SIGNS AND ANY DAMAGE DONE TO EXISTING SIGNS BY THE CONTRACTOR'S OPERATIONS SHALL BE REPAIRED OR REPLACED AT NO ADDITIONAL EXPENSE TO THE OWNER.
- 16. ALL ITEMS SHALL INCLUDE ALL THE NECESSARY MATERIALS AND LABOR TO COMPLETE THE ITEM IN PLACE. MATERIALS AND LABOR NOT SPECIFICALLY IDENTIFIED SHALL BE CONSIDERED INCIDENTAL TO THE PROJECT.
- 17. AT THE END OF EACH DAY, THE CONTRACTOR SHALL SECURE THE CONSTRUCTION WORK ZONE FROM POTENTIAL INTRUDERS.
- 18. THE CONTRACTOR SHALL FIELD VERIFY THE ELEVATIONS OF THE BENCHMARKS PRIOR TO COMMENCING WORK. THE CONTRACTOR SHALL ALSO FIELD VERIFY LOCATION. ELEVATION AND SIZE OF EXISTING UTILITIES. AND VERIFY PAVEMENT ELEVATIONS WHERE MATCHING INTO EXISTING WORK. THE CONTRACTOR SHALL FIELD VERIFY HORIZONTAL CONTROL BY REFERENCING SHOWN COORDINATES TO KNOWN PROPERTY LINES. NOTIFY ENGINEER OF DISCREPANCIES IN EITHER VERTICAL OR HORIZONTAL CONTROL PRIOR TO PROCEEDING WITH WORK.
- 19. THE CONTRACTOR SHALL CONTACT THE ENGINEER OF ANY ERRORS OR DISCREPANCIES WHICH MAY BE SUSPECTED IN LINES AND GRADES, AND SHALL NOT PROCEED WITH THE WORK UNTIL ALL LINES AND GRADES WHICH ARE BELIEVED TO BE IN ERROR HAVE BEEN VERIFIED OR CORRECTED BY THE ENGINEER OR HIS REPRESENTATIVE.
- 20. THE ENGINEER AND OWNER ARE NOT RESPONSIBLE FOR THE CONSTRUCTION MEANS, METHODS, TECHNIQUES, SEQUENCE OR PROCEDURES, TIME OF PERFORMANCE, PROGRAMS OR ANY SAFETY PRECAUTIONS USED BY THE CONTRACTOR. THE CONTRACTOR IS SOLELY RESPONSIBLE FOR EXECUTION OF THEIR WORK IN ACCORDANCE WITH THE CONTRACT DOCUMENTS AND SPECIFICATIONS.
- 21. ALL ITEMS TO BE REMOVED AND NOT DEFINED AS A PAY ITEM SHALL BE CONSIDERED INCIDENTAL TO THE PROJECT.
- 22. ALL EXCESS EARTH EXCAVATION, EXCESS MATERIALS, OR OTHER REMOVED ITEMS SHALL BE HAULED OFF-SITE AT THE CONTRACTOR'S EXPENSE, UNLESS OTHERWISE APPROVED BY THE OWNER.
- 23. THIS WORK SHALL BE IN ACCORDANCE WITH SECTION 201 OF THE ILLINOIS DEPARTMENT OF TRANSPORTATION'S "STANDARD SPECIFICATIONS FOR ROAD AND BRIDGE CONSTRUCTION IN ILLINOIS", CURRENT EDITION. THE CONTRACTOR SHALL REMOVE AND DISPOSE OF ALL OBSTRUCTIONS, TREES, DEBRIS AND BRUSH AS DESIGNATED BY THE OWNER AND AS INDICATED ON THE PLANS. ALL MATERIALS SHALL BE DISPOSED OF AT THE CONTRACTOR'S EXPENSE. DURING CONSTRUCTION, CARE SHALL BE TAKEN TO MINIMIZE DAMAGE TO THE EXISTING TREES AND LANDSCAPING. ONLY THOSE ITEMS DESIGNATED BY THE OWNER SHALL BE REMOVED.
- 24. ALL ROADWAY REMOVAL ITEMS SHALL CONFORM TO THE ILLINOIS DEPARTMENT OF TRANSPORTATION'S "STANDARD SPECIFICATIONS FOR ROAD AND BRIDGE CONSTRUCTION IN ILLINOIS", CURRENT EDITION. ALL JOINTS BETWEEN THE PORTION REMOVED AND THAT LEFT IN PLACE SHALL BE SAWED TO SUCH A DEPTH THAT A CLEAN, NEAT EDGE WILL RESULT WITH NO SPALLING TO THE REMAINING PORTION. THE COST OF SAWING SHALL BE CONSIDERED INCIDENTAL TO THE CONTRACT. ADDITIONAL SAWING OR RE-SAWING MAY BE REQUIRED AS DIRECTED BY THE ENGINEER WITH NO ADDITIONAL COMPENSATION BEING ALLOWED. THE COST OF SAWCUTTING THE EXISTING PAVEMENT SHALL NOT BE PAID FOR SEPARATELY, BUT SHALL BE CONSIDERED INCIDENTAL TO THE CONTRACT.

GENERAL NOTES

- 25. WHEN ARTIFICIAL LIGHTING IS UTILIZED DURING NIGHT OPERATIONS, THE CONTRACTOR SHALL EXERCISE UTMOST PRECAUTIONS IN PREVENTING ADVERSE VISIBILITY TO THE MOTORING PUBLIC, AS WELL AS ADJOINING RESIDENTIAL AREAS.
- 26. THE CONTRACTOR IS REQUIRED TO STAY WITHIN THE NOTED PROPERTY BOUNDARIES RIGHT-OF-WAY AND EASEMENTS AS SHOWN IN THE PLANS. ANY ADDITIONAL EASEMENTS SHALL BE SECURED BY THE CONTRACTOR AT NO EXTRA COST.
- 27. ANY AREAS DAMAGED OR DISTURBED DURING THE PROJECT AS A DIRECT OR INDIRECT RESULT OF CONTRACTOR OPERATIONS, SHALL BE RESTORED TO A CONDITION EQUAL TO OR BETTER THAN THE ORIGINAL CONDITION. THE COST OF SAID RESTORATION OR REPAIR SHALL BE BORNE TOTALLY BY THE CONTRACTOR, WITH NO EXTRA COMPENSATION BEING AWARDED UNDER THIS CONTRACT. THE RESPONSIBILITY FOR THE REPAIR OR REPLACEMENT OF ANY UTILITY, STRUCTURE LANDSCAPING, ETC., DAMAGED OR DESTROYED BY THE CONTRACTOR DURING MOBILIZATION OR CONSTRUCTION SHALL BE BORNE SOLELY BY THE CONTRACTOR, WITH NO EXPENSE BEING CHARGED TO THE ENGINEER OR OWNER. PRIOR TO ACCEPTANCE OF THIS REPAIR OR REPLACEMENT, THE CONTRACTOR SHALL PRESENT THE OWNER WITH A "SIGNOFF LETTER" SIGNED BY A RESPONSIBLE OFFICIAL OF THE OWNER OF THE DAMAGED UTILITY STATING THAT THE REPAIR OR REPLACEMENT IS ACCEPTABLE.
- 28. REVIEW OF COMPLETE PEDESTRIAN SIGNAL SHALL BE COMPLETED BY THE ENGINEER AND IDOT PRIOR TO CONTRACTOR ORDERING MATERIALS.

CONSTRUCTION STAKING

1. THE OWNER SHALL BE RESPONSIBLE FOR CONSTRUCTION LAYOUT STAKING THE PROPOSED IMPROVEMENTS AS INDICATED IN THE SPECIAL PROVISIONS. CONTROL POINTS ARE INDICATED ON THE PLANS.

EROSION CONTROL NOTES

- 1. UNLESS OTHERWISE SPECIFIED, ALL EROSION AND SEDIMENT CONTROL MEASURES AND THEIR MAINTENANCE, CLEARING AND REMOVAL SHALL BE CONSIDERED INCIDENTAL TO CONSTRUCTION.
- 2. THIS WORK SHALL CONFORM TO THE APPLICABLE STANDARDS FROM THE ILLINOIS URBAN MANUAL. THE ILLINOIS DEPARTMENT OF TRANSPORTATION STANDARD SPECIFICATION, CURRENT EDITION, THE PROJECT SPECIFICATIONS, AND THE APPROPRIATE
- 3. THE CONTRACTOR SHALL IMPLEMENT THE EROSION AND SEDIMENT CONTROL MEASURES AS INDICATED ON THESE EROSION CONTROL PLANS BEFORE CONSTRUCTION BEGINS.
- 4. THE CONTROLS SHALL BE INSTALLED AS DETAILED AND WHERE INDICATED ON THE EROSION CONTROL PLAN SHEETS AND AS DIRECTED BY THE INSPECTOR.
- 5. SITE ACTIVITIES SHOULD ENSURE THAT EXISTING VEGETATION IS PRESERVED WHERE PRACTICABLE.
- 6. DISTURBED PORTIONS OF THE SITE SHALL BE STABILIZED (TEMPORARILY OR PERMANENTLY SEEDED, MULCHED, SODDED OR PAVED) AS SOON AS PRACTICABLE, BUT IN NO CASE MORE THAN 7 CALENDAR DAYS AFTER THE CONSTRUCTION ACTIVITY IN THAT PORTION OF THE SITE HAS TEMPORARILY OR PERMANENTLY CEASED.
- 7. UNTIL SUCH TIME AS THE PROJECT SITE REACHES FINAL STABILIZATION AND FINAL INSPECTION IS APPROVED BY THE OWNER AND IDOT, THE CONTRACTOR SHALL BE RESPONSIBLE TO ADJUST, REPAIR, OR REPLACE, ALL VEGETATION, EROSION CONTROLS, SEDIMENT CONTROLS, AND ANY OTHER PROTECTIVE MEASURES AS REQUIRED IN ORDER TO MAINTAIN THEIR INTENDED FUNCTION IN A GOOD AND EFFECTIVE OPERATING CONDITION.
- 8. EXCEPT FOR FLOWS FROM FIRE FIGHTING ACTIVITIES, SOURCES OF NON-STORM WATER EXPECTED DURING THE CONSTRUCTION PROCESS THAT MAY BE COMBINED WITH STORM WATER DISCHARGES SHALL BE DIRECTED AWAY FROM UNPROTECTED, BARE, OR OTHERWISE UNSTABILIZED SOIL, AND APPROPRIATE POLLUTION PREVENTION MEASURES SHALL BE IMPLEMENTED SO THAT THESE DISCHARGES DO NOT CAUSE EROSION OR DEGRADE THE QUALITY OF RUNOFF FROM THE CONSTRUCTION SITE.
- 9. REGULAR INSPECTIONS WILL BE MADE AS REQUIRED. A QUALIFIED INSPECTOR WILL BE PROVIDED BY THE OWNER. BASED ON THE RESULTS OF THE INSPECTIONS, POLLUTION PREVENTION MEASURES SHALL BE REVISED AS APPROPRIATE AS SOON AS PRACTICABLE AFTER EACH INSPECTION. SUCH REVISIONS SHALL BE IMPLEMENTED WITHIN 7 CALENDAR DAYS FOLLOWING EACH INSPECTION.
- 10. THE INSPECTOR SHALL HAVE AUTHORIZATION TO DETERMINE THE ADEQUACY OF THE CONTRACTOR'S EROSION CONTROL EFFORTS. THE OWNER OR THE INSPECTOR SHALL HAVE FULL AUTHORITY OVER THE GENERAL CONTRACTOR AND ANY SUBCONTRACTOR TO CAUSE POLLUTANT CONTROL MEASURES TO BE REPAIRED, MODIFIED, MAINTAINED, SUPPLEMENTED, OR WHATEVER ELSE IS NECESSARY IN ORDER TO ACHIEVE EFFECTIVE POLLUTANT CONTROL OR TO SUSPEND OR LIMIT THE CONTRACTORS OPERATIONS PENDING ADEQUATE PERFORMANCE.
- 11. PERIMETER EROSION BARRIER TO BE CONSTRUCTED OF SILT FENCE UNLESS NOTED OTHERWISE.
- 12. A TEMPORARY CONCRETE WASHOUT FACILITY SHALL BE CONSTRUCTED AT A LOCATION APPROVED BY THE ENGINEER. WASHOUT FACILITY SHALL BE UTILIZED FOR ALL APPLICABLE OPERATIONS.
- 13. TEMPORARY EROSION CONTROL MEASURES INCLUDE TEMPORARY DITCH CHECKS, PERIMETER EROSION BARRIER, INLET AND PIPE PROTECTION, TEMPORARY SEEDING, AND ANY OTHER TEMPORARY EROSION CONTROL MEASURE NEEDED TO LIMIT THE AMOUNT OF SOIL EROSION AND SEDIMENTATION DURING CONSTRUCTION.
- 14. AT THE COMPLETION OF THE PROJECT, ALL TEMPORARY EROSION CONTROL ITEMS SHALL BE REMOVED FROM THE SITE, AND BECOME THE PROPERTY OF THE CONTRACTOR. CONTRACTOR MUST STABILIZE ANY AREA DISTURBED BY THE REMOVAL OF EROSION CONTROL ITEMS.
- 15. CONTRACTOR SHALL CLEAN ANY DEBRIS TRACKED OFFSITE DAILY.

SEEDING OF DISTURBED AREAS

- 1. THE FINAL TOP 4" INCHES OF SOIL IN ANY DISTURBANCE AREA MUST BE A COHESIVE SOIL CAPABLE OF SUPPORTING VEGETATION.
- 2. FERTILIZER HAVING AN ANALYSIS OF 10-10-10 SHALL BE APPLIED AT A RATE OF 90 LBS/ACRE TO ALL DISTURBED AREAS AND INCORPORATED INTO THE SEEDBED PRIOR TO SOWING THE SEED.
- 3. THE CONTRACTOR SHALL SEED AND STABILIZE ALL DISTURBED AREAS ADJACENT TO IMPROVEMENTS WITH SEEDING, IDOT CLASS 1A AND EROSION CONTROL BLANKET IN ACCORDANCE WITH IDOT STANDARD SPECIFICATION OR AS APPROVED BY THE ENGINEER. ACCORDANCE WITH IDOT STANDARD SPECIFICATION OR AS APPROVED BY THE ENGINEER.
- 4. <u>GUARANTEE</u>: ALL SEEDED AREAS SHALL BE MAINTAINED AND MOWED FOR AT LEAST 30 DAYS AFTER GERMINATION. SCATTERED BARE SPOTS NO LARGER THAN TWO SQUARE FOOT WILL BE ALLOWED UP TO A MAXIMUM OF 5% OF ANY SEEDED AREA INCLUDING 30-DAY MAINTENANCE. MOWING AND WATERING AS NECESSARY.
- 5. THIS WORK SHALL CONFORM TO THE APPLICABLE STANDARDS FROM THE ILLINOIS URBAN MANUAL, THE ILLINOIS DEPARTMENT OF TRANSPORTATION STANDARD SPECIFICATION SECTIONS, CURRENT EDITION, THE PROJECT SPECIFICATIONS, AND THE
- 6. RESTORATION THE CONTRACTOR SHALL RESTORE ALL AREAS DISTURBED DURING CONSTRUCTION OF THE IMPROVEMENTS AND RELATED APPURTENANCES OR AS PART OF ANY OF THEIR ACTIVITIES TO A CONDITION EQUAL TO OR BETTER THAN THE

UTILITIES

- 1. UTILITIES SHOWN ON THE PLANS ARE FOR ILLUSTRATIVE PURPOSES ONLY AND NO GUARANTEE OF THEIR ACCURACY IS MADE OR INFERRED. THE LOCATION OF EXISTING UTILITIES AS SHOWN ON THE DRAWINGS REPRESENT DATA RECEIVED FROM VARIOUS SOURCES. IT IS NOT GUARANTEED TO BE CORRECT OR ALL-INCLUSIVE. THE CONTRACTOR SHALL CONDUCT HIS OWN INVESTIGATION INTO THE LOCATION, SIZE, DEPTH AND NATURE OF ANY AND ALL EXISTING UTILITIES THAT MAY INTERFERE WITH THE WORK UNDER THIS CONTRACT. ANY EXISTING UTILITIES THAT ARE TO REMAIN IN SERVICE SHALL BE FULLY PROTECTED BY THE CONTRACTOR AND ANY DAMAGE CAUSED BY THE CONSTRUCTION OPERATIONS SHALL BE IMMEDIATELY REPAIRED OR REPLACED TO THE SATISFACTION OF THE ENGINEER OR THE OWNER. THE CONTRACTOR SHALL BE RESPONSIBLE FOR CONTACTING ANY AND ALL UTILITY COMPANIES REGARDING ADJUSTMENTS NECESSARY. THIS WORK SHALL BE AT THE CONTRACTOR'S EXPENSE AND CONSIDERED INCIDENTAL TO THE PROJECT COST. THE CONTRACTOR SHALL BE RESPONSIBLE FOR THE PROTECTION OF ALL UNDERGROUND, OVERHEAD, OR SURFACE UTILITIES EVEN THOUGH THEY MAY NOT BE SHOWN ON THE PLANS. ANY UTILITY THAT IS DAMAGED DURING CONSTRUCTION SHALL BE REPAIRED TO THE SATISFACTION OF THE ENGINEER OR THE OWNER OR REPLACED. THIS WORK SHALL BE AT THE CONTRACTOR'S EXPENSE.
- 2. THE CONTRACTOR MUST VERIFY AND LOCATE ALL EXISTING UTILITIES ON OR ADJACENT TO THE SITE. PRIOR TO BEGINNING CONSTRUCTION ACTIVITIES, CONTACT J.U.L.I.E. AT 1-800-892-0123 (OR 811) FOR EXACT FIELD LOCATION OF UTILITIES. DAMAGE, AND THE COST THEREOF, TO ANY AND ALL UTILITIES SHALL BE THE SOLE RESPONSIBILITY OF THE CONTRACTOR. ANY AND ALL EXISTING UTILITIES SHOWN HEREON ARE APPROXIMATE. THE ENGINEER AND SURVEYOR ASSUMES NO RESPONSIBILITY FOR THE LOCATION OF THE EXISTING UTILITIES SHOWN HEREON.
- 3. IF THERE ARE ANY UTILITIES WHICH ARE NOT MEMBERS OF THE J.U.L.I.E. SYSTEM. THE CONTRACTOR SHALL BE SOLELY RESPONSIBLE FOR DETERMINING THIS AND REQUESTING SAID UTILITIES TO FIELD VERIFY AND MARK PERTINENT UTILITY
- 4. THE UTILITY LOCATIONS, DEPTHS, ETC. SHOWN ON THESE PLANS ARE APPROXIMATE ONLY, AND SHALL BE VERIFIED BY THE CONTRACTOR WITH ALL AFFECTED UTILITY COMPANIES PRIOR TO INITIATING CONSTRUCTION OPERATIONS; THE ENGINEER AND OWNER ASSUME NO RESPONSIBILITY FOR THE ADEQUACY, SUFFICIENCY OR EXACTNESS OF THESE UTILITY REPRESENTATIONS.
- 5. THE CONTRACTOR SHALL CONTACT THE NECESSARY UTILITY COMPANIES FOR ANY UTILITY RELOCATIONS. THE OWNER SHALL PAY FOR ALL COSTS ASSOCIATED WITH RELOCATION OF UTILITIES ON OR ADJACENT TO THE SUBJECT PROPERTY OR WITHIN THE ROAD RIGHT-OF-WAY.
- 6. TRENCH BACKFILL SHALL BE FILL MATERIAL TYPE A (GRAVEL OR CA6 CRUSHED STONE.) OR TYPE C (SAND FA-1 OR SAND FA-2) IN ACCORDANCE WITH AASHTO T27 GUIDELINES AND THE ILLINOIS DEPARTMENT OF TRANSPORTATION'S "STANDARD SPECIFICATIONS FOR WATER & SEWER CONSTRUCTION IN ILLINOIS", CURRENT EDITION. COST SHALL BE INCLUDED IN UNIT PRICE OF PIPE.
- 7. TRENCH BACKFILL SHALL BE USED IN LOCATIONS WHERE THERE IS AN EXISTING OR PROPOSED PERMANENT SURFACE.
- 8. ABANDONED UNDERGROUND UTILITIES THAT CONFLICT WITH CONSTRUCTION OR HAVE THE POTENTIAL FOR CREATING FUTURE PROBLEMS SHALL BE DISPOSED OF OUTSIDE THE LIMITS OF THE PROJECT AT AN APPROVED LOCATION OBTAINED BY THE CONTRACTOR, ACCORDING TO THE "STANDARD SPECIFICATIONS FOR WATER & SEWER CONSTRUCTION IN ILLINOIS", CURRENT EDITION, AND AS DIRECTED BY THE ENGINEER. THIS WORK WILL NOT BE PAID FOR SEPARATELY, BUT SHALL BE CONSIDERED INCIDENTAL TO THE CONTRACT AND NO ADDITIONAL COMPENSATION WILL BE ALLOWED.
- 9. ANY AND ALL FIELD TILES AND OR STORM SEWERS DAMAGED OR ENCOUNTERED DURING THE CONSTRUCTION ACTIVITIES SHALL BE REPAIRED, REPLACED AND/OR CONNECTED IMMEDIATELY BY THE CONTRACTOR. COST FOR SAID REPAIRS, REPLACEMENT. AND/OR CONNECTION SHALL BE THE SOLE RESPONSIBILITY OF THE CONTRACTOR.

CONTRACT 85702

DRAWING:

GENERAL NOTES 1

DATE

SET TYPE: FOR BIDDING \rockford\Drawings\C3D\19\19-504\Plans\19-504 Plans.dwg, Gen Notes 1 JOB NUMBER: 19-504

> SHEET NUMBER: 2 of 15

ENGINEERING & ENVIRONMENTAL

ILLINOIS DESIGN FIRM NO. 184-003525

ILLINOIS

IOWA WISCONSIN OWNER/DEVELOPER: VILLAGE OF FORRESTON 102 SOUTH WALNUT STREET P.O. BOX 206

SAFE ROUTES TO SCHOOL FORRESTON, ILLINOIS

PROJECT AND LOCATION:

DRAWN BY: MS APPROVED BY: SWG DATE: AUG 2020 SCALE: AS NOTED

REV. NO. DESCRIPTION

REVISIONS

TRAFFIC CONTROL

- 1. THE CONTRACTOR SHALL PROVIDE, INSTALL AND MAINTAIN ALL TRAFFIC CONTROL ITEMS NECESSARY FOR THE CONSTRUCTION OF ITEMS WITH IN THE ROAD RIGHT-OF-WAY. ALL WORK PERFORMED SHALL HAVE TRAFFIC CONTROL IN ACCORDANCE WITH THE "MANUAL ON UNIFORM TRAFFIC CONTROL DEVICES" AND OF THE ILLINOIS DEPARTMENT OF TRANSPORTATION'S "STANDARD SPECIFICATIONS FOR ROAD AND BRIDGE CONSTRUCTION IN ILLINOIS", CURRENT EDITION.
- ALL TRAFFIC CONTROL DEVICES USED FOR THE MAINTENANCE OF TRAFFIC SHALL BE REFLECTORIZED PRIOR TO INSTALLATION
 AND CLEANED AS NECESSARY THROUGHOUT THE DURATION OF THE CONTRACT. ALL SIGNS SHALL BE FURNISHED,
 INSTALLED AND MAINTAINED BY THE CONTRACTOR. PAYMENT SHALL BE CONSIDERED INCIDENTAL TO THE PROJECT.
- 3. TRAFFIC CONDITIONS, ACCIDENTS, AND OTHER UNFORESEEN CONDITIONS MAY REQUIRE THE ENGINEER TO MODIFY THE LOCATION OF THE TRAFFIC CONTROL DEVICES. THE CONTRACTOR SHALL MAKE THE NECESSARY ADJUSTMENTS AS DIRECTED BY THE ENGINEER WITHOUT DELAY. THE CONTRACTOR SHALL RESPOND WITHIN 30 MINUTES FROM THE TIME OF NOTIFICATION BY THE ENGINEER TO ANY REQUEST MADE BY THE ENGINEER FOR CORRECTION, IMPROVEMENT OR MODIFICATION OF THE MAINTENANCE OF TRAFFIC CONTROL DEVICES. DURING CONSTRUCTION OPERATIONS, THE CONTRACTOR SHALL TAKE NECESSARY PRECAUTIONS TO PROTECT ADJACENT TRAFFIC LANES OPEN TO TRAFFIC FROM DEBRIS BEING BLOWN OR OTHERWISE REMOVED FROM THE CONSTRUCTION AREAS. THE CONTRACTOR SHALL ALSO BE RESPONSIBLE FOR KEEPING DEBRIS OFF THE ADJACENT TRAVELED LANE SURFACE. COST INCIDENTAL TO THE PROJECT.
- 4. THE CONTRACTOR SHALL SUBMIT MAINTENANCE OF TRAFFIC AND STAGING OF CONSTRUCTION PLANS FOR APPROVAL BY THE ENGINEER PRIOR TO COMMENCING WORK.
- THE CONTRACTOR SHALL PERFORM THE WORK UNDER STAGE CONSTRUCTION IN THE EVENT THAT THE CONTRACTOR WILL NEED TO CLOSE PUBLIC ROADS, CONTRACTOR SHALL SUBMIT PROPOSED DETOUR ROUTE AND ASSOCIATED SIGNAGE TO THE ENGINEER PRIOR TO COMMENCING WORK.
- 6. TRAFFIC CONTROL DEVICES, STREET NAME SIGNS, AND PAVEMENT MARKINGS SHALL BE INSTALLED IN ACCORDANCE WITH VILLAGE OF FORRESTON ORDINANCES AND THE "MANUAL ON UNIFORM TRAFFIC CONTROL DEVICES". LOCATIONS OF SIGNS AND MARKINGS SHALL BE SPECIFIED BY THE PLANS, AND/OR AS DIRECTED BY THE ENGINEER.
- 7. PROVIDE TO THE ENGINEER AND THE OWNER THE NAME AND PHONE NUMBER OF INDIVIDUALS RESPONSIBLE FOR MAINTAINING TRAFFIC CONTROL MEASURES DURING CONSTRUCTION. THIS INDIVIDUAL SHALL BE AVAILABLE TO CORRECT TRAFFIC CONTROL PROBLEMS 24 HOURS PER DAY.
- THE CONTRACTOR SHALL NOTIFY THE POST OFFICE, POLICE DEPARTMENT, FIRE DEPARTMENT, 911 DISPATCH CENTER, ILLINOIS DEPARTMENT OF TRANSPORTATION, STATE POLICE, APPROPRIATE SCHOOL DISTRICT AND THE LOCAL AGENCY A MINIMUM OF 5 DAYS PRIOR TO CLOSING ANY PORTION OF THE STREET OR ALLEY.

SUBGRADES, SUBBASES, AND BASE COURSES

1. THE CONTRACTOR WILL BE REQUIRED TO SUBSTANTIATE BASE COURSE THICKNESSES AND FINISH PAVEMENT THICKNESSES. THE ENGINEER SHALL INSPECT BASE COURSE CORECUT PRIOR TO PLACING BASE COURSE TO ENSURE REQUIRED BASE COURSE DEPTH IS PRESENT. IN ADDITION, THE ENGINEER AND/OR THE CITY ENGINEER SHALL WITNESS THE PLACEMENT OF BITUMINOUS BINDER AND SURFACE COURSE. CORE DRILLING MAY BE REQUIRED TO DEMONSTRATE THAT BASE COURSE AND PAVEMENT THICKNESSES CONFORM TO THE SPECIFICATIONS. PRIOR TO PLACING BASE COURSE MATERIAL, THE CONTRACTOR SHALL TEST ROLL THE SUBGRADE, IN THE PRESENCE OF THE ENGINEER OR HIS AGENT TO DEMONSTRATE THAT SAID SUBGRADE IS READY FOR BASE. PRIOR TO PLACEMENT OF THE BITUMINOUS SUFFACE, THE SAME VERIFICATION PROCEDURE SHALL BE PERFORMED ON THE BASE COURSE MATERIAL. THE CONTRACTOR SHALL NOTIFY THE ENGINEER AT LEAST 48 HOURS PRIOR TO PERFORMING ANY OF THE REQUIRED TESTS SO THAT A REPRESENTATIVE MAY BE PRESENT.

EXCAVATION/EARTHWORK

- THE CONTRACTOR SHALL USE CARE IN GRADING OR EXCAVATION NEAR ANY AND ALL EXISTING ITEMS WHICH ARE NOT INDICATED TO BE REMOVED. ANY DAMAGE DONE TO EXISTING ITEMS BY THE CONTRACTOR'S OPERATIONS SHALL BE REPAIRED AT NO ADDITIONAL EXPENSE TO THE OWNER.
- 2. PRIOR TO STARTING EARTHWORK OR UTILITY TRENCHING, THE CONTRACTOR SHALL STRIP THE SITE OF TOPSOIL TO A DEPTH OF 4" AND TO THE LIMITS APPROVED BY THE ENGINEER. THIS MATERIAL SHALL BE STOCKPILED IN A REMOTE LOCATION OFF THE SITE (APPROVED BY THE ENGINEER) UNTIL THE PLAN IMPROVEMENTS ARE COMPLETED AND THE EXCESS MATERIAL SPREAD AS DIRECTED. IT SHALL THEN BE THE RESPONSIBILITY OF THE CONTRACTOR TO SPREAD THIS TOPSOIL MATERIAL IN AREAS OF THE SITE, OVER AREAS WHERE EXCESS EXCAVATED MATERIAL, SAND, GRAVEL HAS BEEN SPREAD OR IN OTHER AREAS AS DESIGNATED BY THE ENGINEER. THE MATERIAL SHALL THEN BE COMPACTED TO A MINIMAL DEPTH OF 4" AND FINE GRADED IN A MANNER ACCEPTABLE TO THE ENGINEER. THIS WORK SHALL BE IN ACCORDANCE WITH THE ILLINOIS DEPARTMENT OF TRANSPORTATION'S "STANDARD SPECIFICATIONS FOR ROAD AND BRIDGE CONSTRUCTION IN ILLINOIS", CURRENT EDITION.
- 3. CLEAN CONSTRUCTION OR DEMOLITION DEBRIS (CCDD) REQUIREMENTS—"THE CONTRACTOR IS RESPONSIBLE FOR THE ASSESSMENT AND PROPER DISPOSAL OF ALL EXCESS SOIL AND SUBSURFACE MATERIALS THAT ARE NOT ABLE TO BE RE—USED ON THE PROJECT SITE AS SUITABLE CLEAN FILL. CONTRACTOR RESPONSIBILITY'S SHALL INCLUDE ALL REQUIRED SOIL SAMPLING, LABORATORY ANALYSIS, DISPOSAL PROFILING FEES, TRANSPORTATION, AND DISPOSAL TIPPING FEES AND SURCHARGES."
- 4. ROCK IS NOT ANTICIPATED TO BE ENCOUNTERED.
- ALL EXCAVATIONS FOR STRUCTURES AND PIPE SHALL BE KEPT DEWATERED DURING CONSTRUCTION UNTIL BACKFILL IS IN PLACE. DURING DEWATERING OPERATIONS, WATER SHALL BE PUMPED INTO SEDIMENT BASINS OR SILT TRAPS. (COST INCIDENTAL)
- 6. EARTH EXCAVATION SHALL CONFORM TO SECTION 202 OF THE ILLINOIS DEPARTMENT OF TRANSPORTATION'S "STANDARD SPECIFICATIONS FOR ROAD AND BRIDGE CONSTRUCTION IN ILLINOIS", CURRENT EDITION. THIS WORK SHALL INCLUDE THE EXCAVATION OF ALL MATERIALS TO DESIGN SUBGRADE ELEVATIONS INDICATED IN THE PLANS.
- 7. A SOIL REPORT CAN BE PROVIDED IN AN ELECTRONIC FORMAT TO THE CONTRACTOR UPON REQUEST FROM THE OWNER.
- 8. SHEETING AND SHORING SHALL BE CONSIDERED INCIDENTAL TO CONTRACT IF REQUIRED.
- 9. WHENEVER THE CONTRACTOR WORKS NEAR EXISTING FACILITIES WITHIN THE LIMITS OF THE IMPROVEMENTS DURING TRENCHING OPERATIONS, HE WILL BE REQUIRED TO HAND TRENCH IN THAT AREA IN ORDER NOT TO DAMAGE THESE FACILITIES. PUSH HOLES AND SEARCH HOLES THAT ARE DUG BY THE CONTRACTOR SHALL BE BACKFILLED BY TAMPING THE EXCAVATED MATERIAL BACK IN PLACE TO KEEP SETTLEMENT TO A MINIMUM. NO ADDITIONAL COMPENSATION WILL BE ALLOWED.
- 10. EMBANKMENT WORK SHALL CONSIST OF THE CONSTRUCTION OF EMBANKMENTS BY DEPOSITING, PLACING AND COMPACTING EARTH, STONE, GRAVEL OR OTHER MATERIALS OF ACCEPTABLE QUALITY ABOVE THE NATURAL GROUND OR OTHER SURFACE IN ACCORDANCE WITH THE ILLINOIS DEPARTMENT OF TRANSPORTATION'S "STANDARD SPECIFICATIONS FOR ROAD AND BRIDGE CONSTRUCTION IN ILLINOIS", CURRENT EDITION.
- 11. IF SUFFICIENT TOPSOIL IS NOT PRESENT, THE CONTRACTOR SHALL SPREAD FURNISHED TOPSOIL SO AS TO MEET THE REQUIREMENTS OF THE CONTRACT. FURNISHED TOPSOIL SHALL ONLY BE USED WITH APPROVAL BY THE ENGINEER. THIS FURNISHED TOPSOIL SHALL BE PAID FOR AS FURNISHED TOPSOIL IN PLACE, DEPTH SPECIFIED.
- 12. IN PROPOSED FILL AREAS FOR PAVEMENT AND EMBANKMENT, TOPSOIL AND TURF SHALL BE SCARIFIED AND REMOVED PRIOR TO CONSTRUCTING THE EMBANKMENT.

CONSTRUCTION TYPE CODE: 0021

	Summary of Quantities				
Pay Item Number	Pay Item Description	Unit of Measure	IL Route 26	IL Route 72	Total
28000510	INLET FILTERS	EACH	0	2	2
28000400	PERIMETER EROSION BARRIER	FOOT	195	110	305
35101600	AGGREGATE BASE COURSE, TYPE B 4"	SQ YD	64	37	101
35102400	AGGREGATE BASE COURSE, TYPE B 12"	SQ YD	4	4	8
35300100	PCC BASE COURSE, 6"	SQ YD	4	4	8
40600275	BITUMINOUS MATERIALS (PRIME COAT)	POUND	2	2	4
40604060	HOT-MIX ASPHALT SURFACE COURSE, IL-9.5, MIX "D", N50	тон	1.5	1.5	3
42400300	PORTLAND CEMENT CONCRETE SIDEWALK 6 INCH	SQ FT	570	332	902
42400800	DETECTABLE WARNINGS	SQ FT	40	40	80
44000100	PAVEMENT REMOVAL	SY YD	4	4	8
44000500	COMBINATION CURB AND GUTTER REMOVAL	FOOT	30	30	60
44000600	SIDEWALK REMOVAL	SQ FT	589	342	931
60605300	COMBINATION CONCRETE CURB AND GUTTER, TYPE B-6.24 (MODIFIED)	FOOT	30	30	60
67100100	MOBILIZATION ·	L SUM ·	0.5	0.5	1
△ 78000200	THERMOPLASTIC PAVEMENT MARKING - LINE 4"	FOOT	3	24	27
△ 78000400	THERMOPLASTIC PAVEMENT MARKING - LINE 6"	FOOT	60	107	167
△ 78000500	THERMOPLASTIC PAVEMENT MARKING - LINE 8"	FOOT	0	9	9
△ 78000650	THERMOPLASTIC PAVEMENT MARKING - LINE 24"	FOOT	84	156	240
X0326806	WASHOUT BASIN	L SUM	0.5	0.5	1
X0327979	PAVEMENT MARKING REMOVAL - GRINDING	SQ FT	54	103	157
△ X8950301	REMOVE EXISTING TRAFFIC SIGNAL POST	EACH	2	0	2
XX000970	PARKWAY RESTORATION	L SUM	0.5	0.5	1
XX001848	CURB BOXES TO BE ADJUSTED	EACH	1	0	1
X7010216	TRAFFIC CONTROL AND PROTECTION, SPECIAL	L SUM	0.5	0.5	1
△ XX008872	SOLAR POWERED PEDESTRIAN CROSSING SIGNAL SYSTEM COMPLETE	EACH	1	1	2

A SPECIALTY ITEMS

CONTRACT 85702

HRGRALIAM

ILLINOIS

IOWA

ENGINEERING & ENVIRONMENTAL

VILLAGE

102 SO

P.O. BO

VILLAGE OF FORRESTON
102 SOUTH WALNUT STREET
P.O. BOX 206

SAFE ROUTES TO SCHOOL FORRESTON, ILLINOIS


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DATE: AUG 2020
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REV. NO.	DESCRIPTION	DATE
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GENERAL NOTES 2 AND SUMMARY OF QUANTITIES

SET TYPE: FOR BIDDING

19-504



ENGINEERING & ENVIRONMENTAL

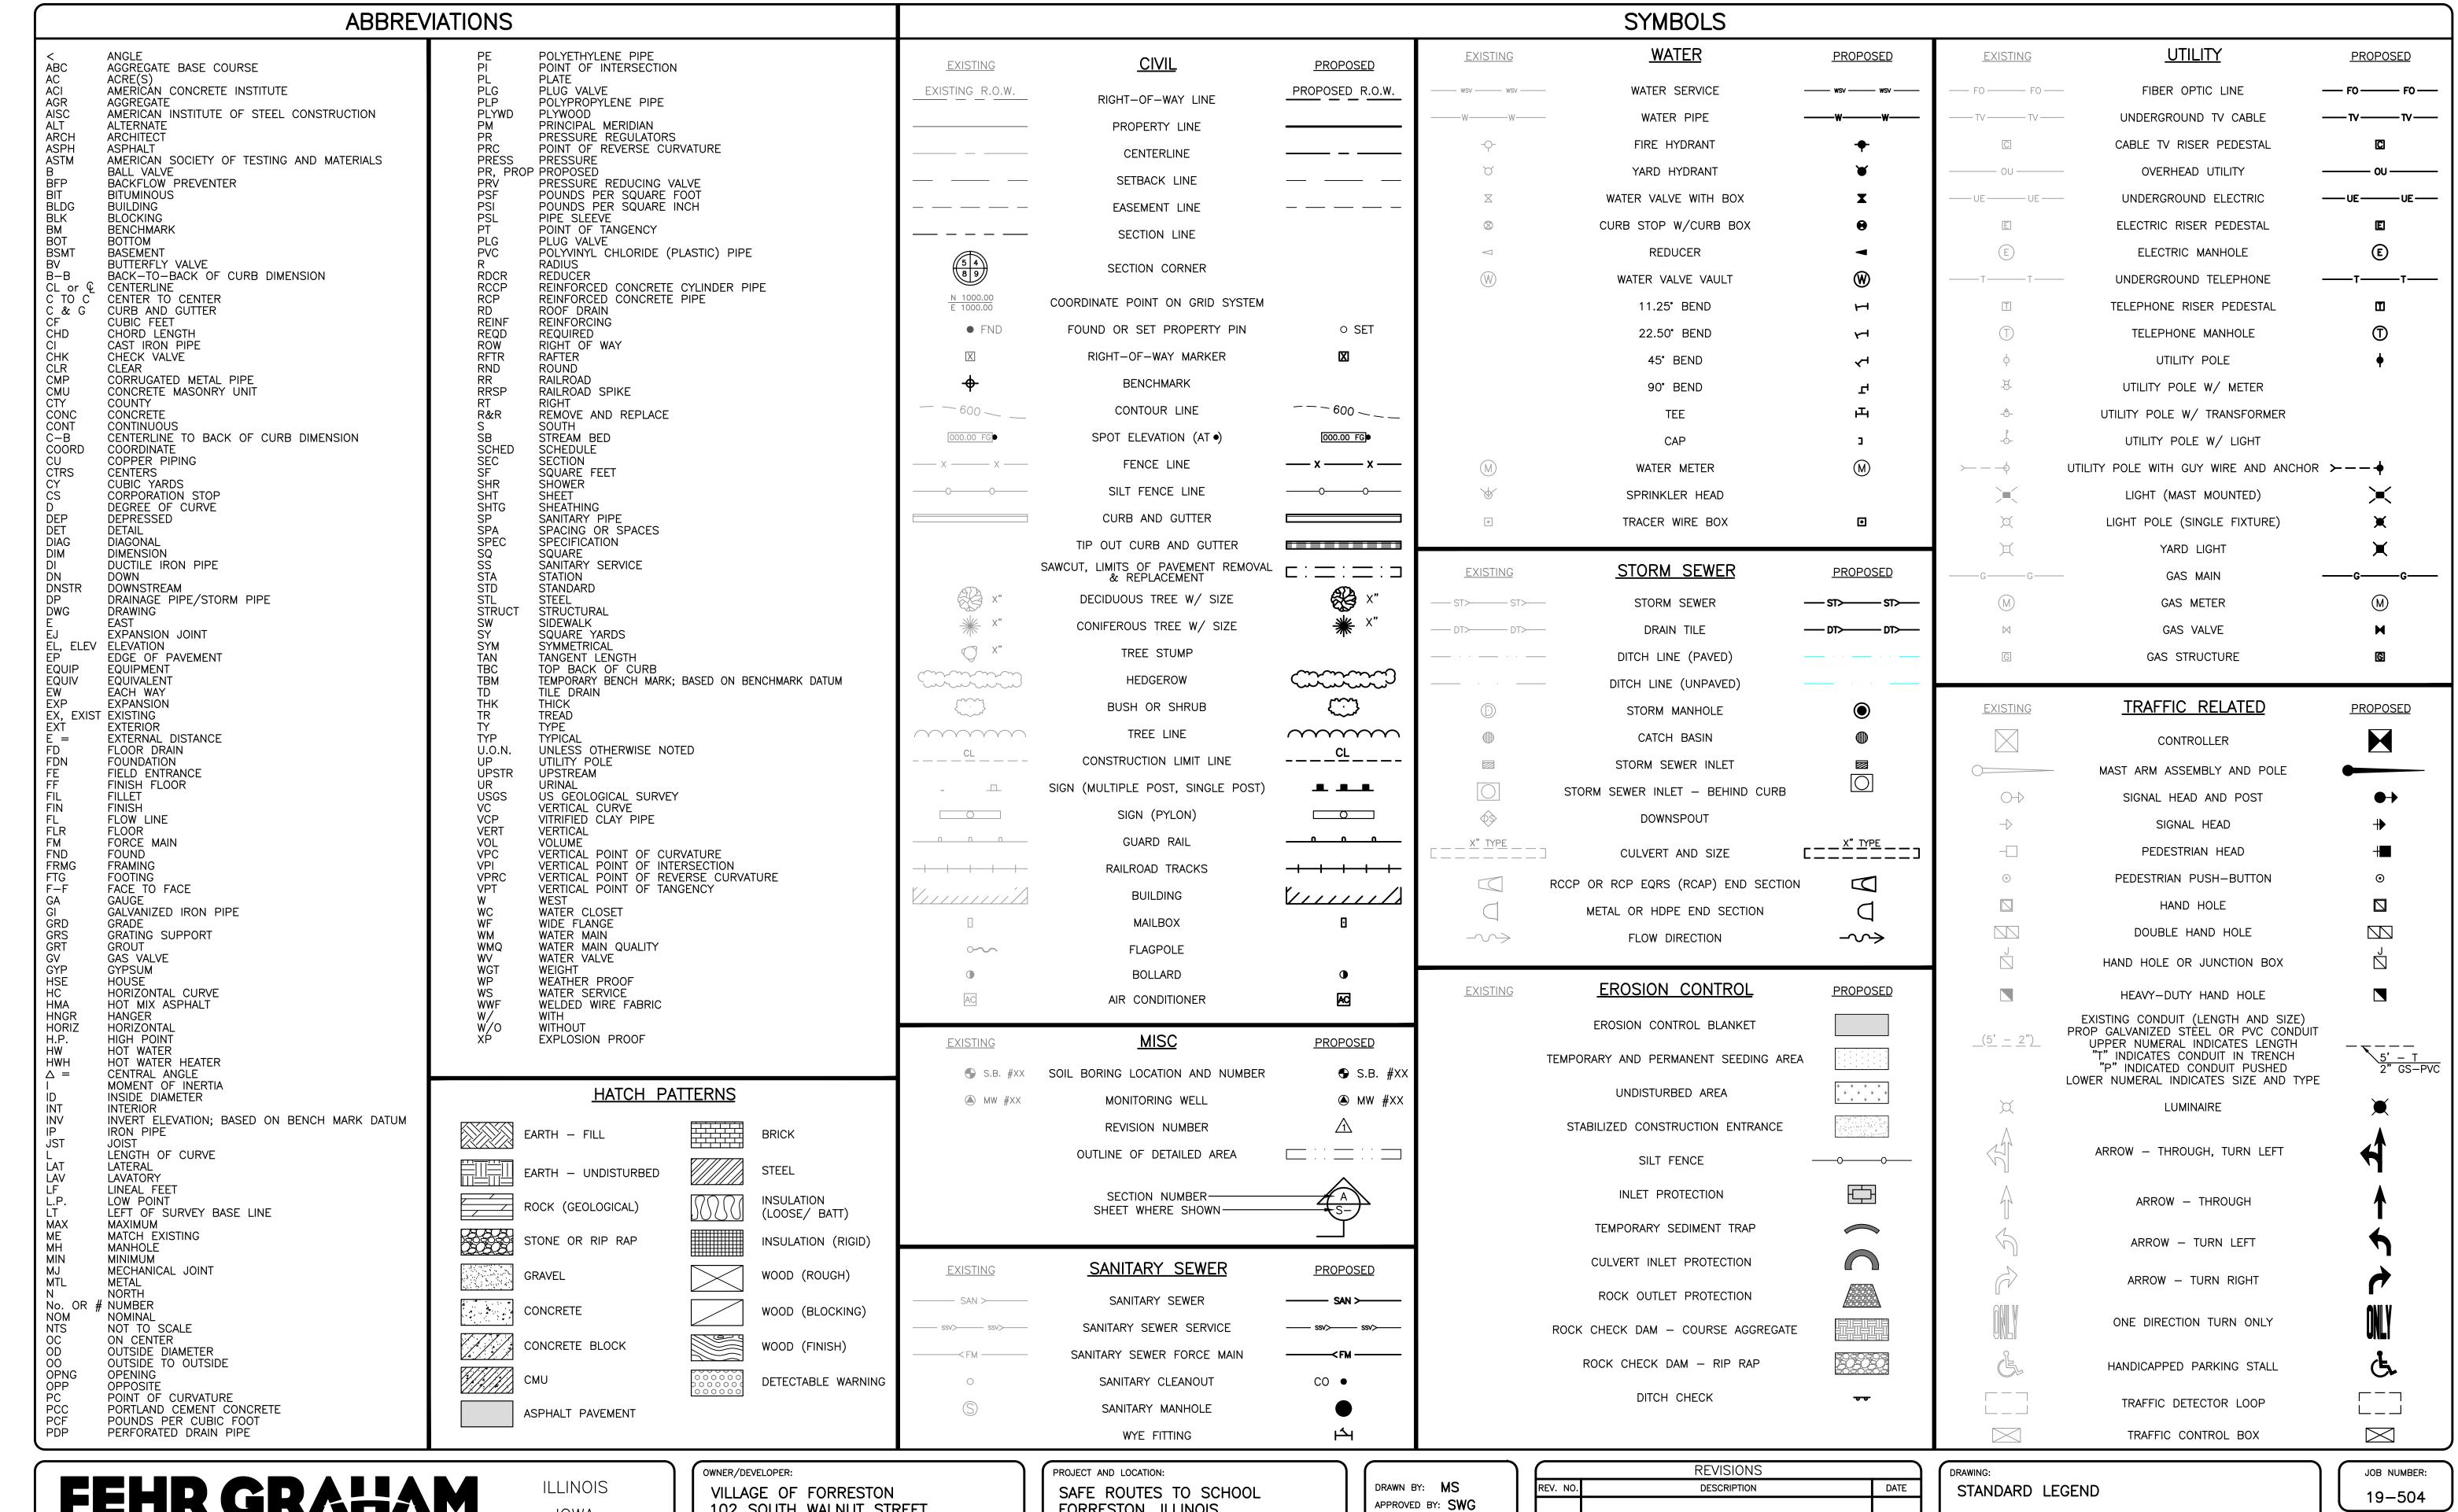ILLINOIS DESIGN FIRM NO. 184-003525

IOWA

WISCONSIN

102 SOUTH WALNUT STREET P.O. BOX 206


FORRESTON, ILLINOIS

DATE: AUG 2020 SCALE: AS NOTED

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CONTRACT 85702 SET TYPE: FOR BIDDING rockford\Drawings\C3D\19\19-504\Plans\19-504 Plans.dwg, Legend

SHEET NUMBER: **4** of **15**

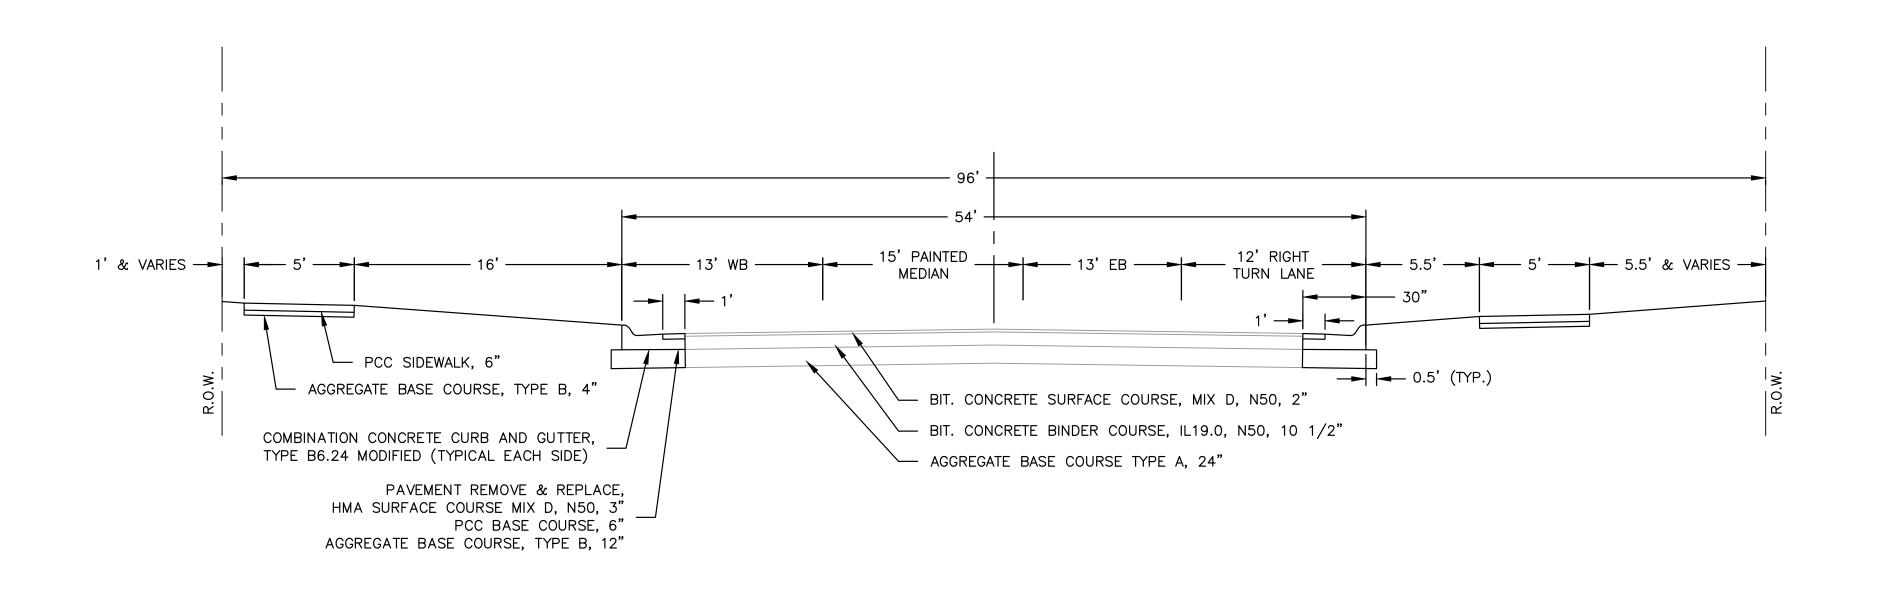

IL ROUTE 72

TYPICAL URBAN STREET CROSS-SECTION DETAIL

PCC COMBINATION CURB
& GUTTER B-6.24
MODIFIED (TYP.)

AGGREGATE BASE
COURSE, TYPE B, 12"


HMA SURFACING

PCC BASE COURSE

BASE COURSE IN PLACE PER STD. 606001

* 9" IS THE MINIMUM REQUIRED WHEN PCC

PCC COMBINATION CURB & GUTTER DETAIL

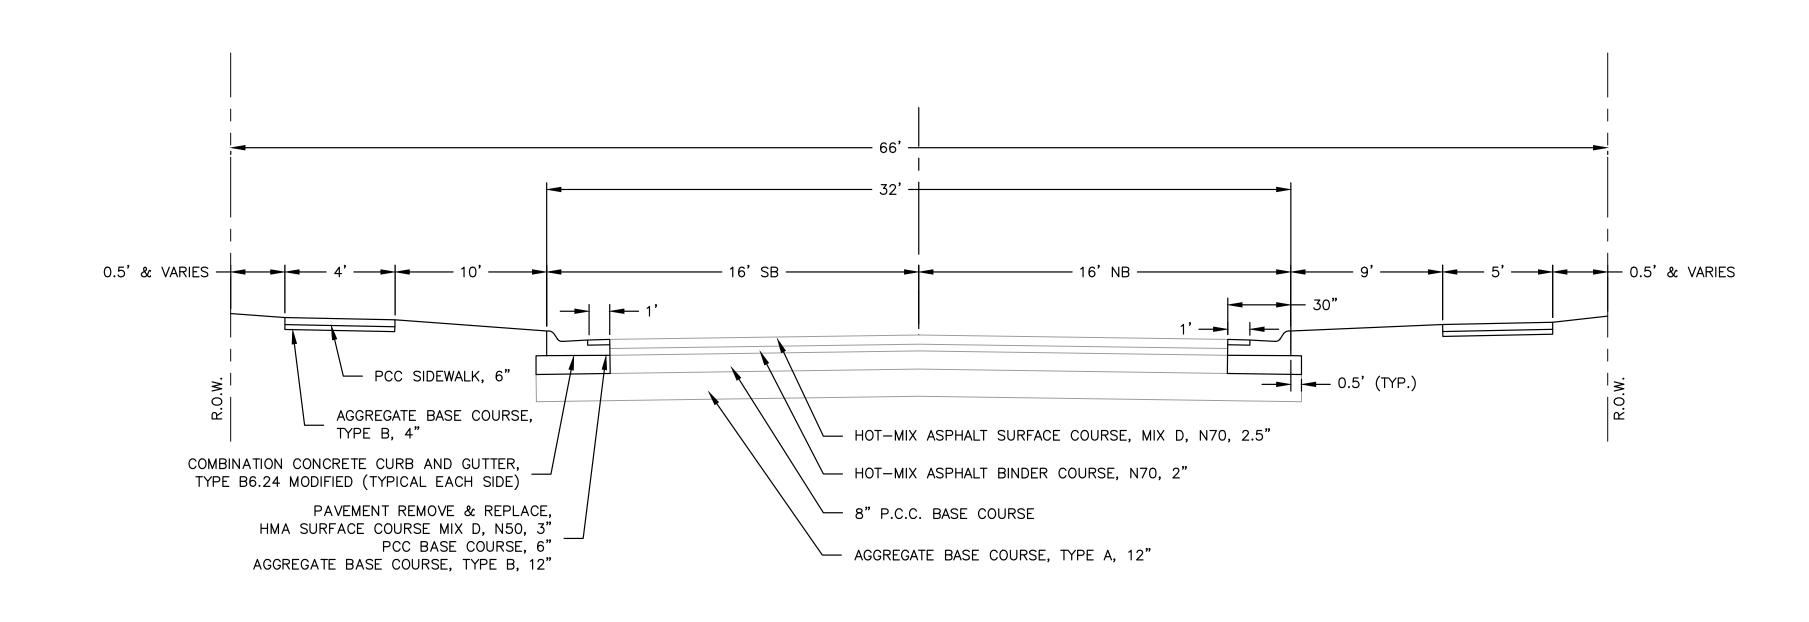

LOCATION AND MIXTURE	RESURFACING
USE(S):	SURFACE
PG:	PG 64-22
DESIGN AIR VOIDS	4.0 @ N50
MIXTURE COMPOSITION (GRADATION MIXTURE)	IL 9.5FG
FRICTION AGGREGATE	D
20 YEAR ESAL	0.0
MIX UNIT WEIGHT	112 LBS/SY/IN
QUALITY MANAGEMENT PROGRAM TO BE USED	QC/QA
SUBLOT TONNAGE	N/A
NUMBER OF ROLLER PASSESS	N/A

IL ROUTE 26 TYPICAL URBAN STREET CROSS—SECTION DETAIL N.T.S.

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ENGINEERING & ENVIRONMENTAL

ILLINOIS DESIGN FIRM NO. 184-003525

ILLINOIS IOWA WISCONSIN OWNER/DEVELOPER:

VILLAGE OF FORRESTON

102 SOUTH WALNUT STREET

P.O. BOX 206

PROJECT AND LOCATION:

SAFE ROUTES TO SCHOOL
FORRESTON, ILLINOIS

DRAWN BY: MS
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DATE: AUG 2020
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REV. NO.	DESCRIPTION	DATE

DRAWING:

TYPICAL CROSS SECTIONS


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JOB NUMBER:

19-504

SHEET NUMBER:



IOWA

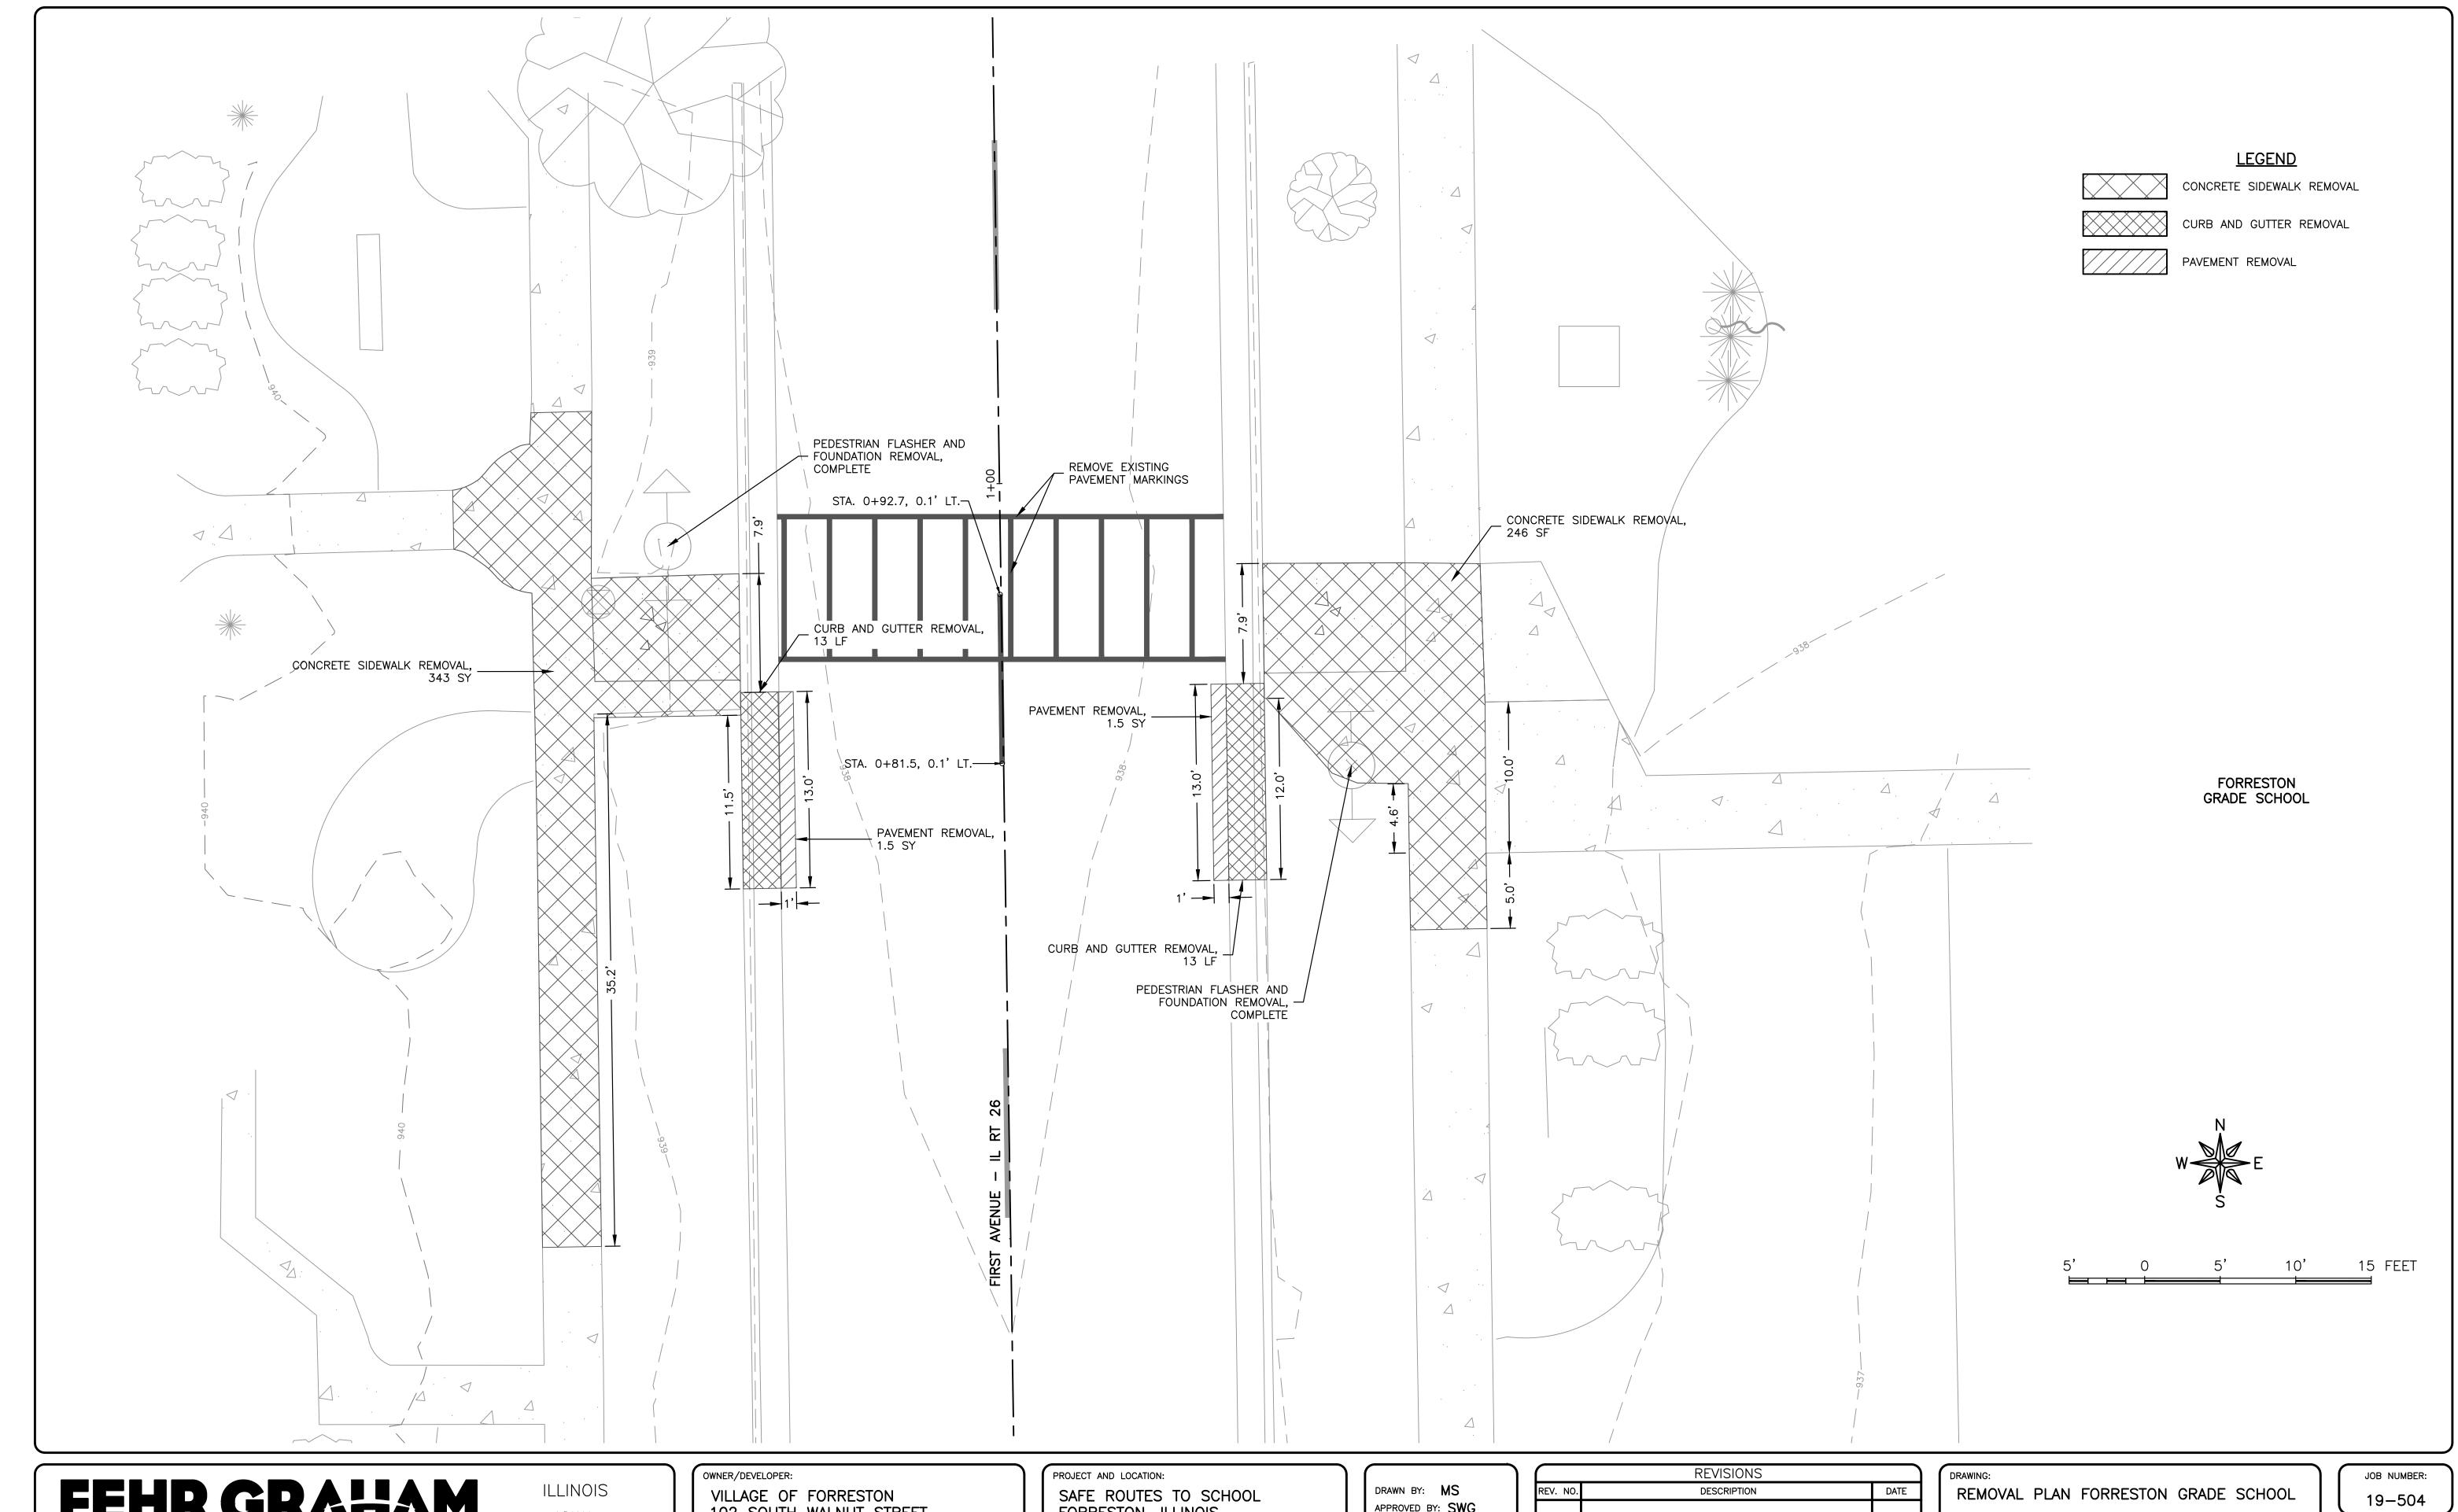WISCONSIN

VILLAGE OF FORRESTON 102 SOUTH WALNUT STREET P.O. BOX 206

FORRESTON, ILLINOIS

APPROVED BY: SWG DATE: AUG 2020 SCALE: AS NOTED


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WISCONSIN

VILLAGE OF FORRESTON 102 SOUTH WALNUT STREET P.O. BOX 206


FORRESTON, ILLINOIS

APPROVED BY: SWG DATE: AUG 2020 SCALE: AS NOTED

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REMOVAL PLAN FORRESTON JR HIGH CONTRACT 85702 SET TYPE: FOR BIDDING
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19-504 SHEET NUMBER:

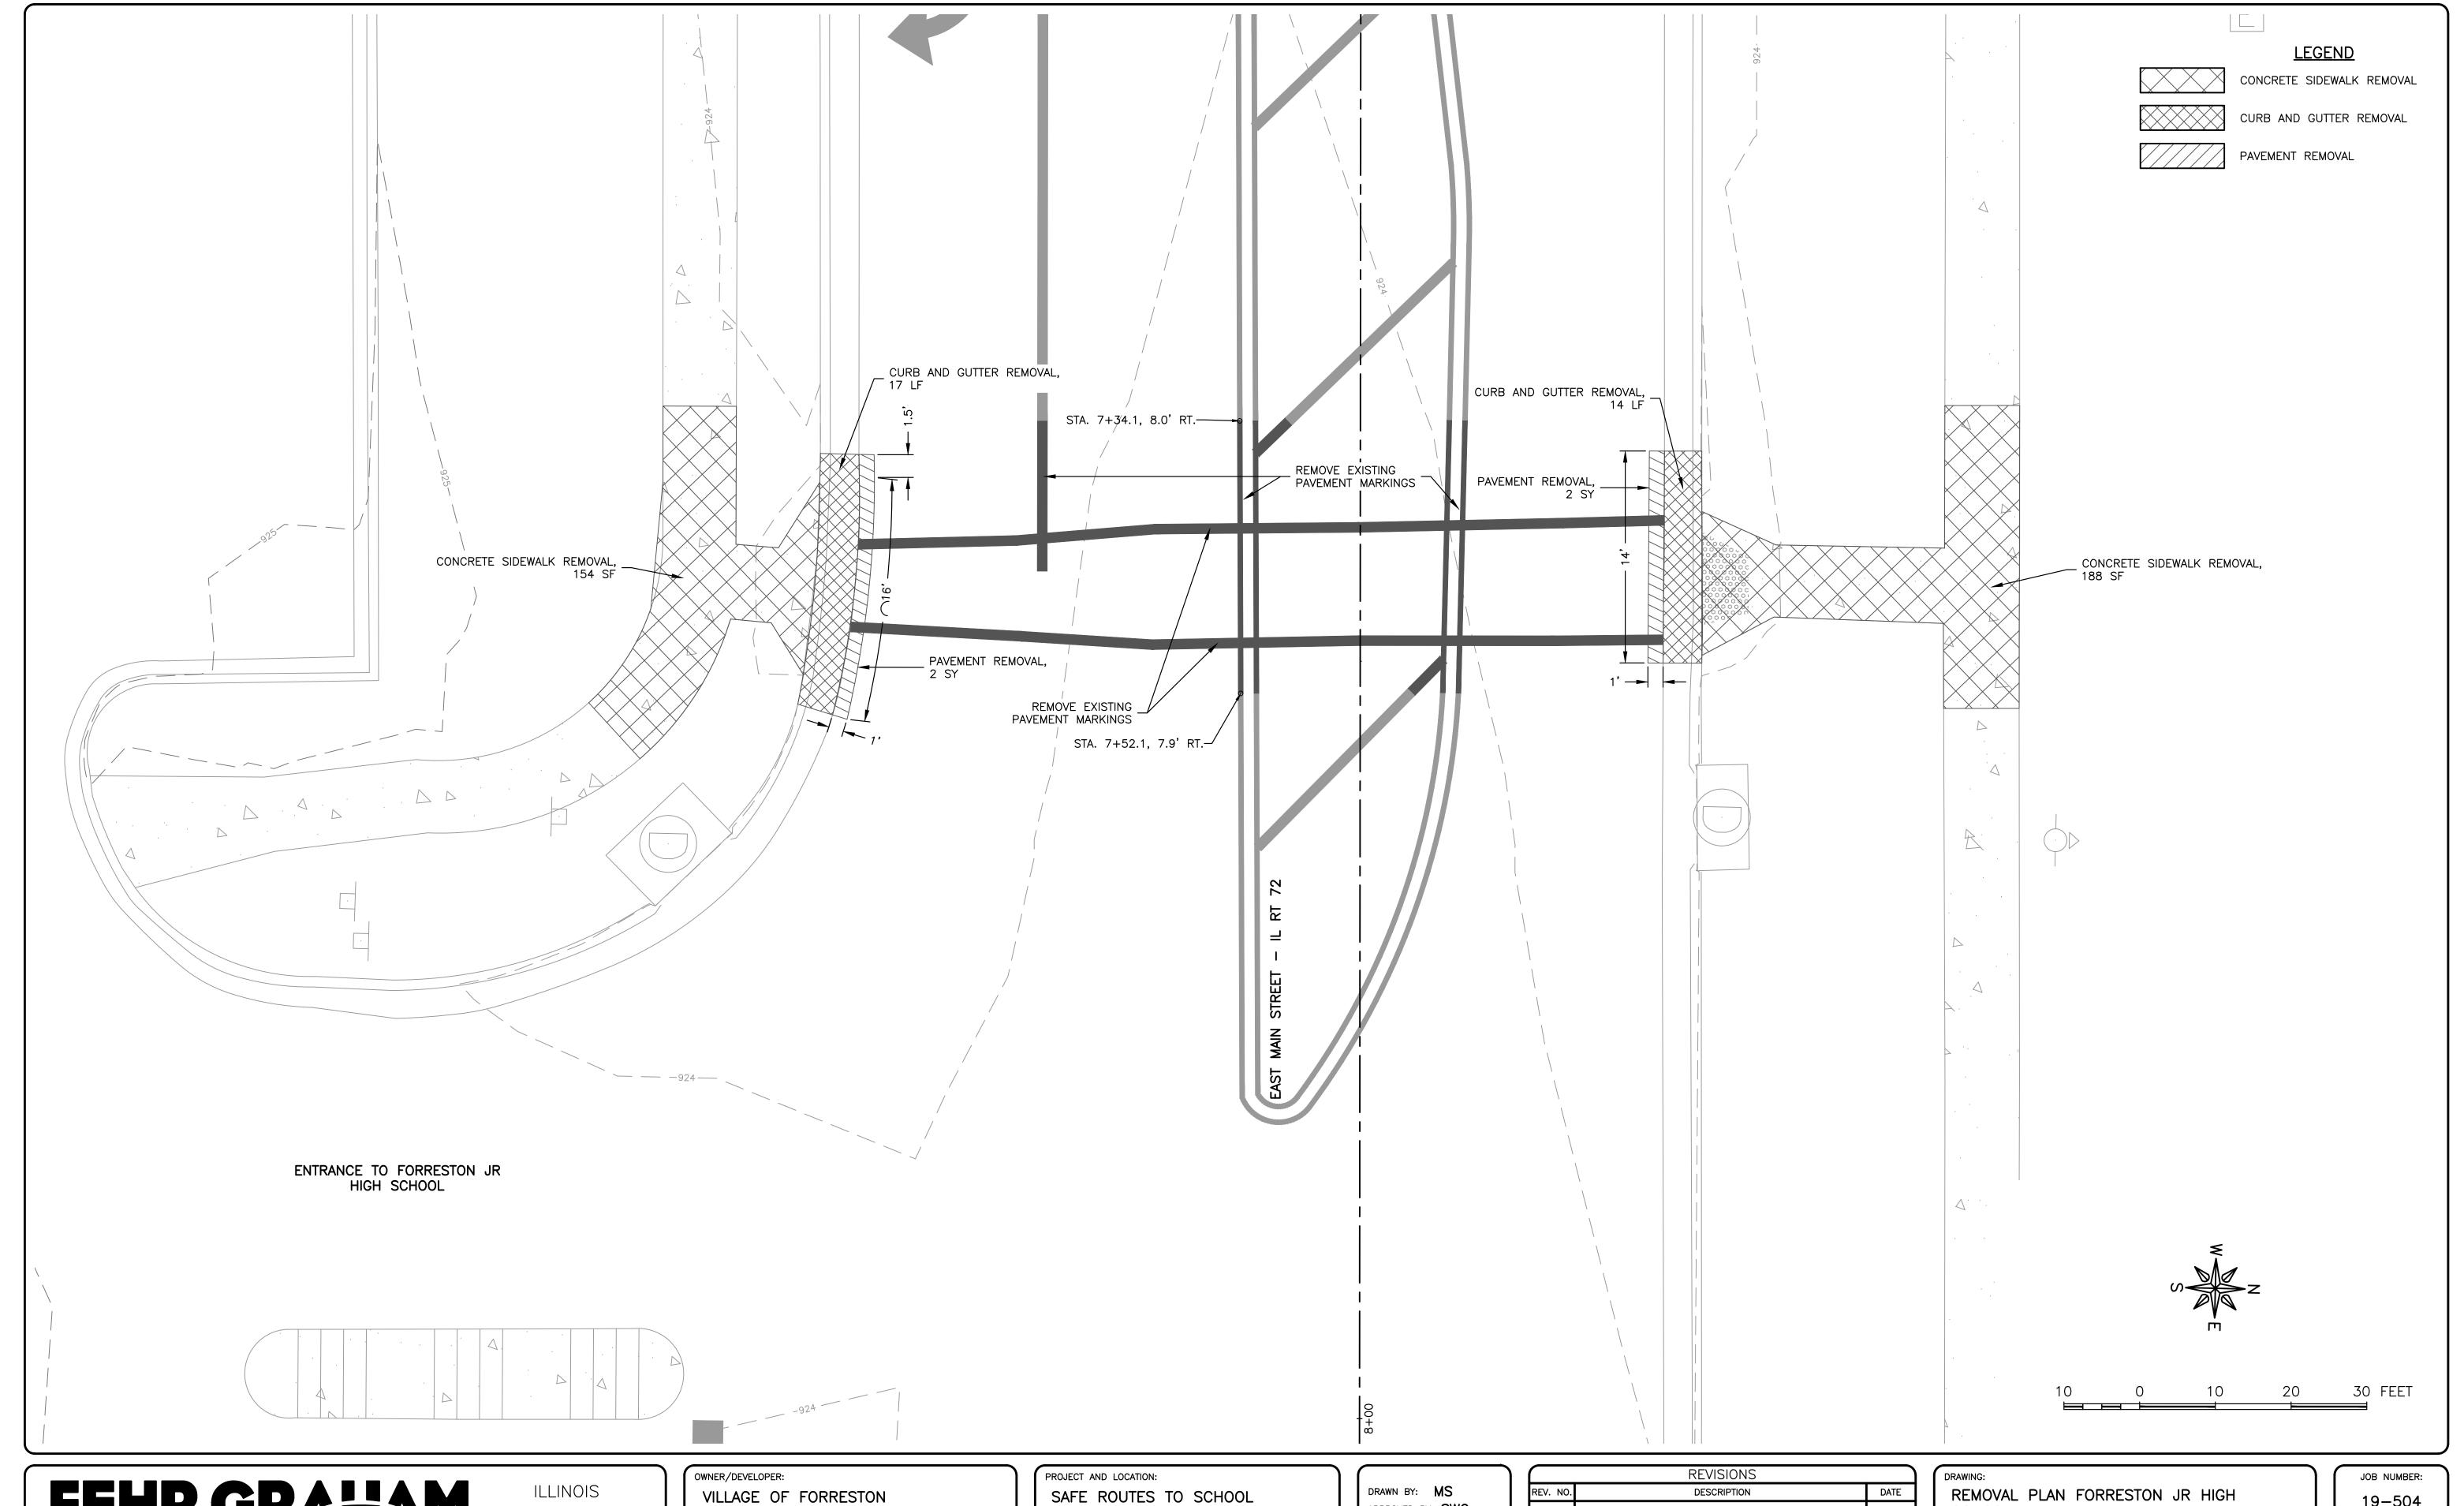

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WISCONSIN

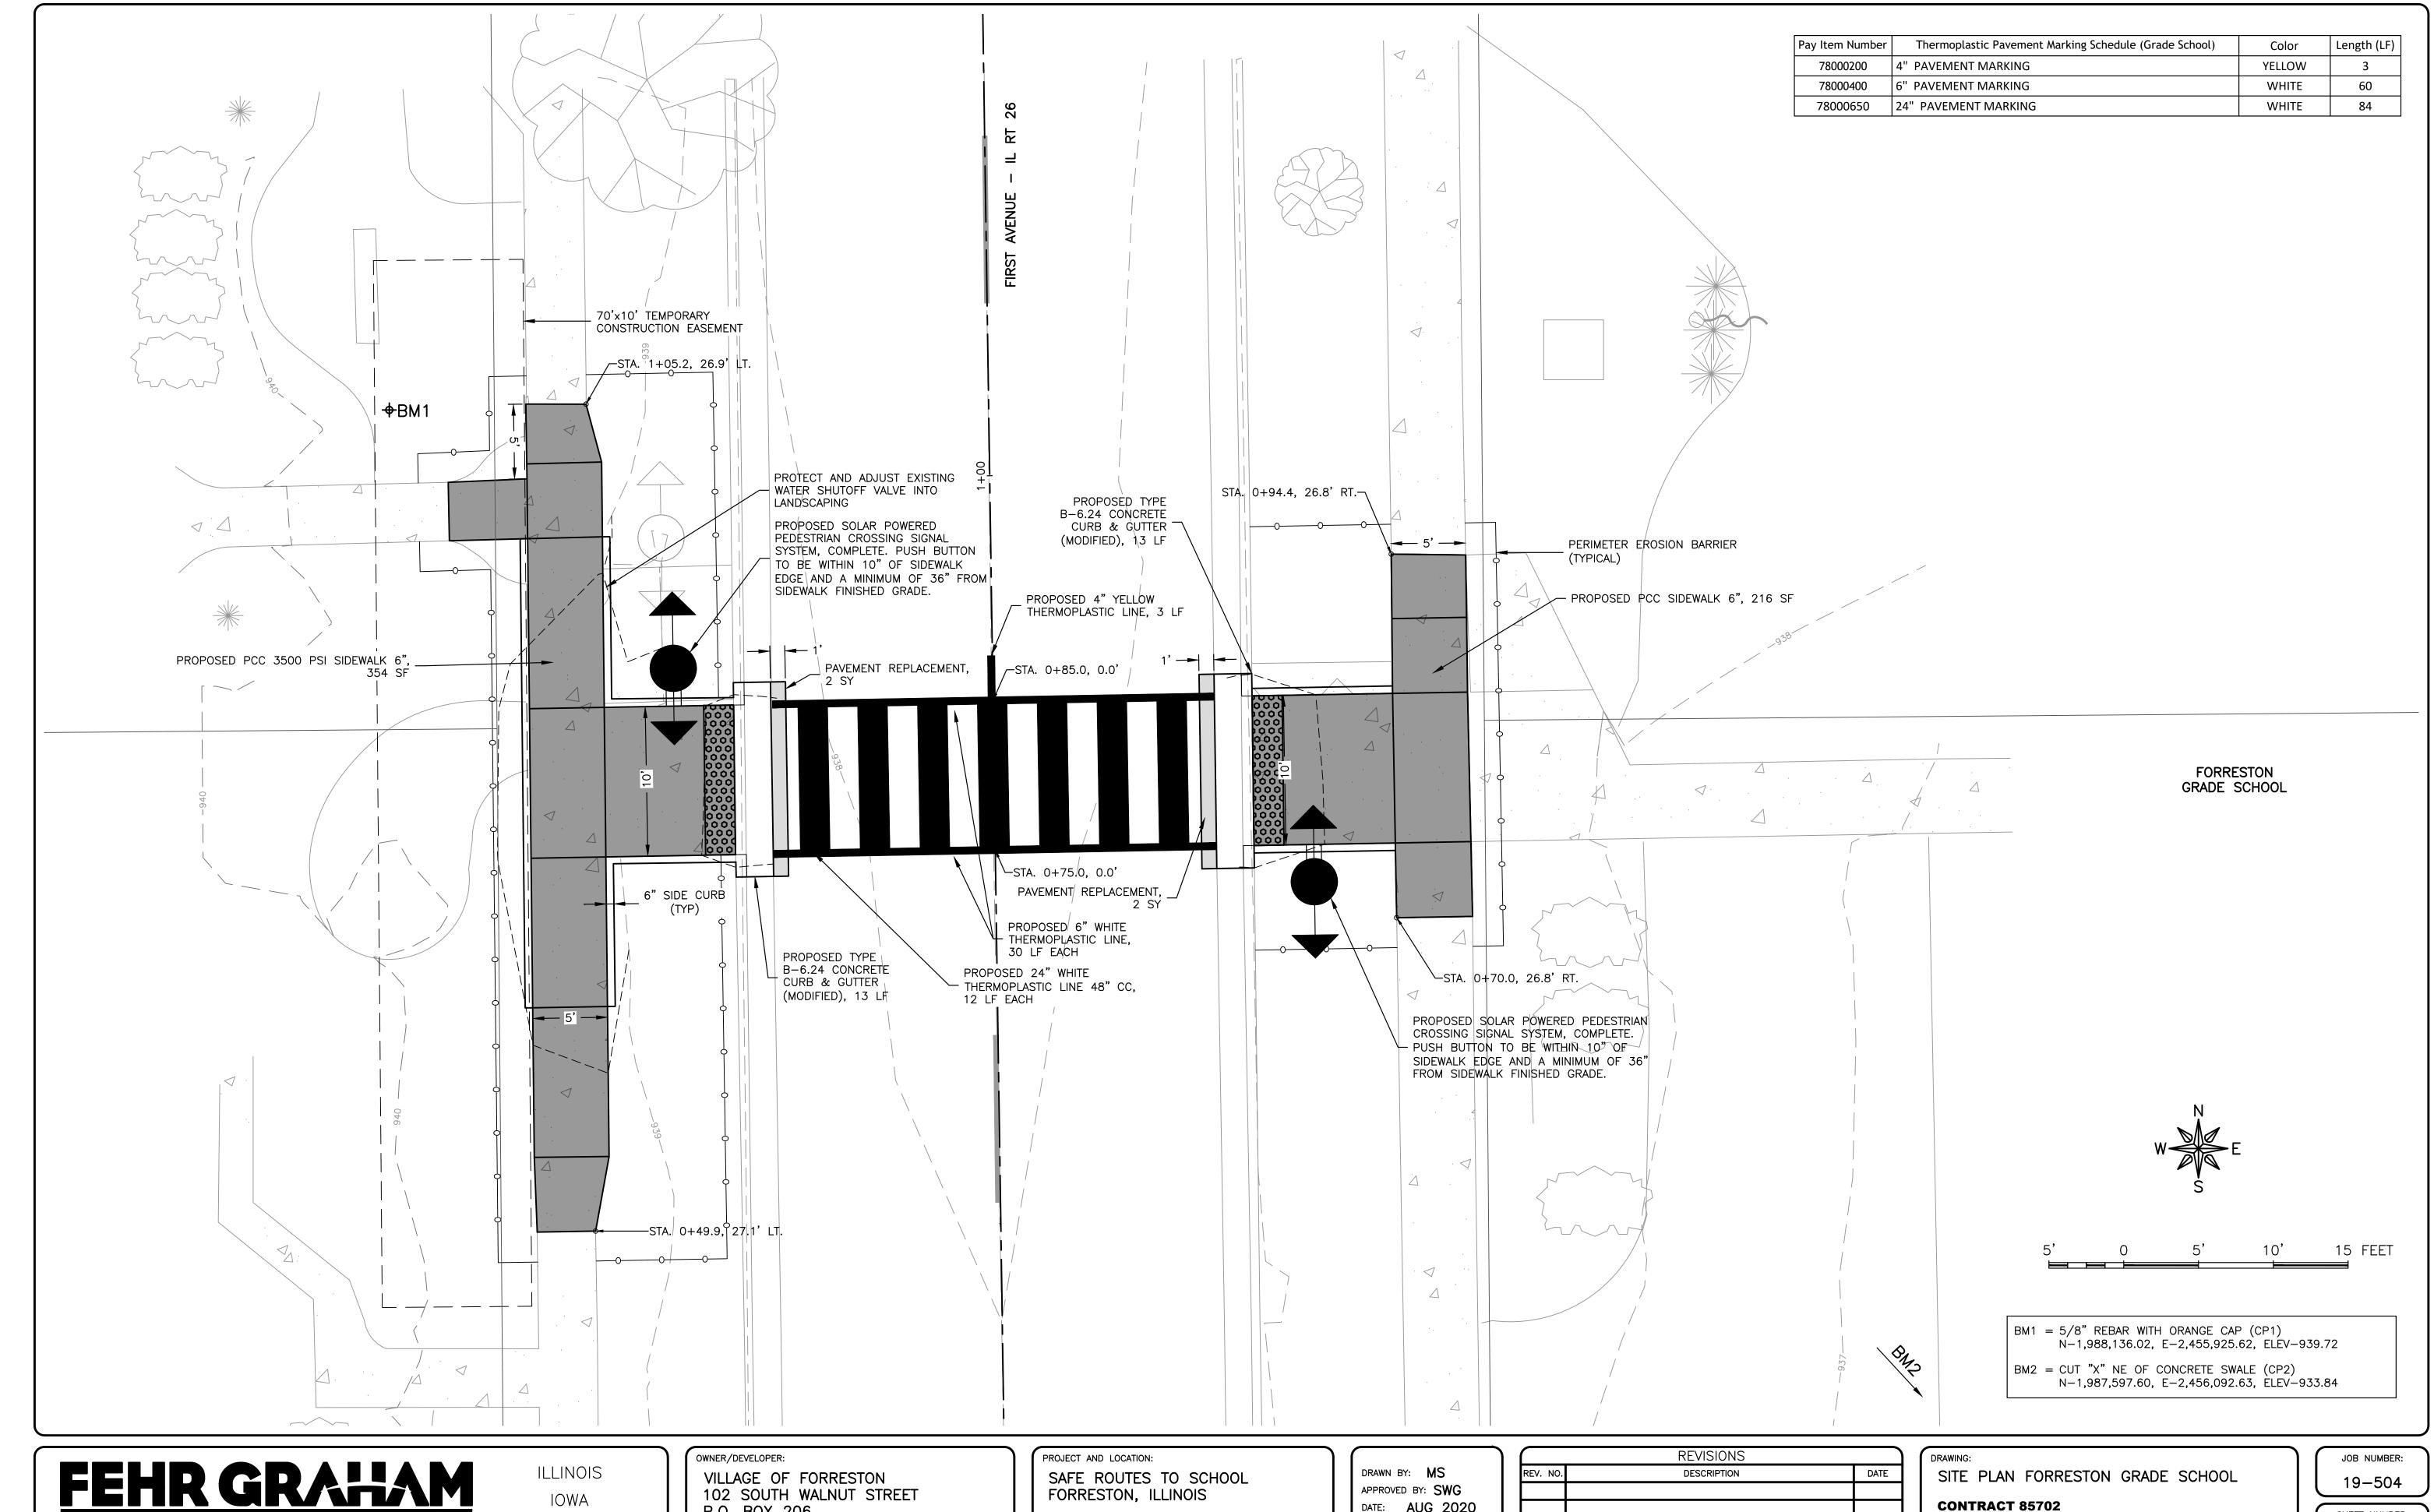P.O. BOX 206


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P.O. BOX 206

DATE: AUG 2020 SCALE: AS NOTED


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SHEET NUMBER: 9 of 15

PLOT DATE: 8/28/20 © 2020 FEHR GRAHAM

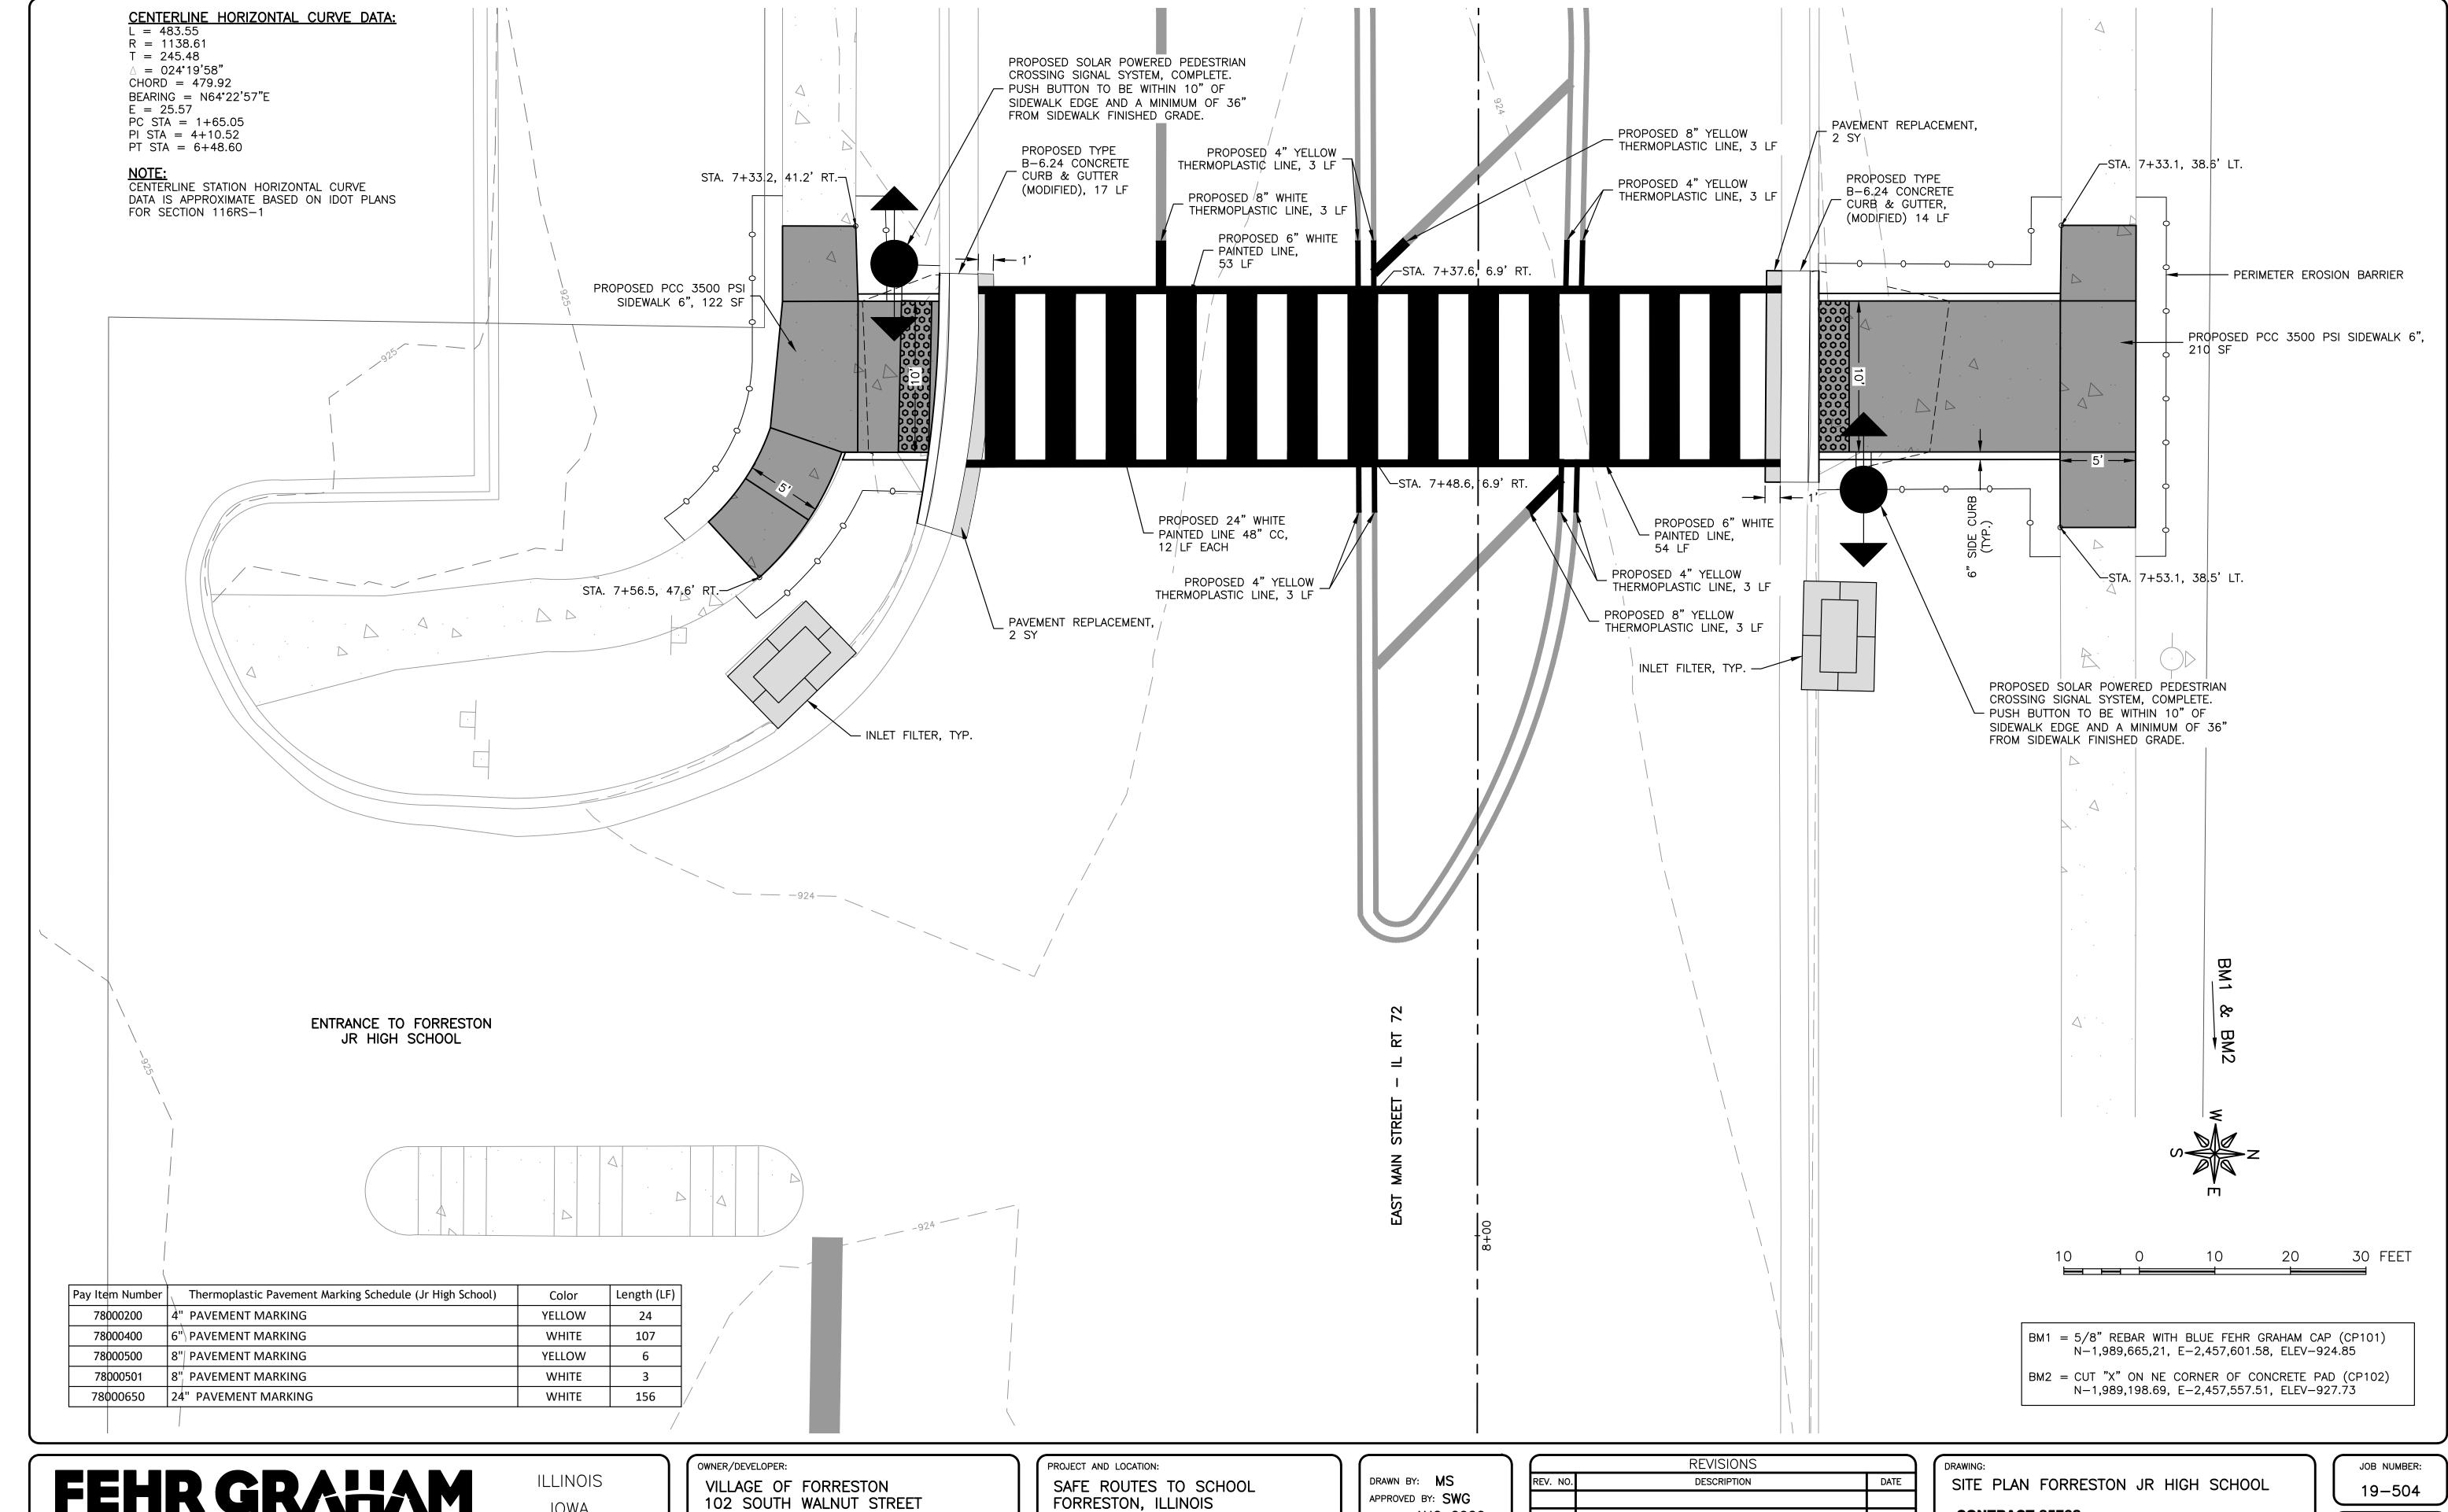

_ A	DA POI	NT TAB	LE
POINT	STATION	OFFSET	ELEV
200	0+84.93	-13.86	937.93
201	0+84.93	-14.86	937.90
202	0+84.92	-17.34	937.86
203	0+84.90	-25.99	938.52
204	0+96.30	-25.94	939.13
205	1+01.30	-25.92	939.11
206	1+05.19	-26.91	939.04
207	1+05.25	-30.93	939.16
209	1+00.25	-30.93	939.18
210	1+00.10	-36.20	939.40
211	0+96.19	-36.18	939.43
212	0+96.25	-30.95	939.20
213	0+84.88	-30.99	938.59
214	0+74.88	-31.03	938.55
215	0+64.88	-31.08	938.91
216	0+54.88	-31.12	939.27
217	0+49.89	-31.00	939.45
218	0+49.89	-27.09	939.25
219	0+54.87	-26.12	939.20
220	0+64.90	-26.08	938.84
221	0+74.90	-26.04	938.48
222	0+74.92	-17.36	937.83
223	0+74.93	-14.84	937.87
224	0+74.93	-13.84	937.88

ADA POINT TABLE				
POINT	STATION	OFFSET	ELEV	
250	0+85.01	13.80	937.80	
251	0+85.01	14.80	937.75	
252	0+85.02	17.32	937.71	
253	0+85.05	26.71	938.35	
254	0+90.05	26.74	938.40	
255	0+94.36	26.76	938.27	
256	0+94.22	31.73	938.50	
257	0+90.06	31.73	938.47	
258	0+85.06	31.72	938.42	
259	0+75.06	31.79	938.36	
260	0+70.06	31.83	938.37	
261	0+70.05	26.77	938.20	
262	0+75.05	26.75	938.30	
263	0+75.06	17.31	937.70	
264	0+75.01	14.80	937.74	
265	0+75.01	13.80	937.75	

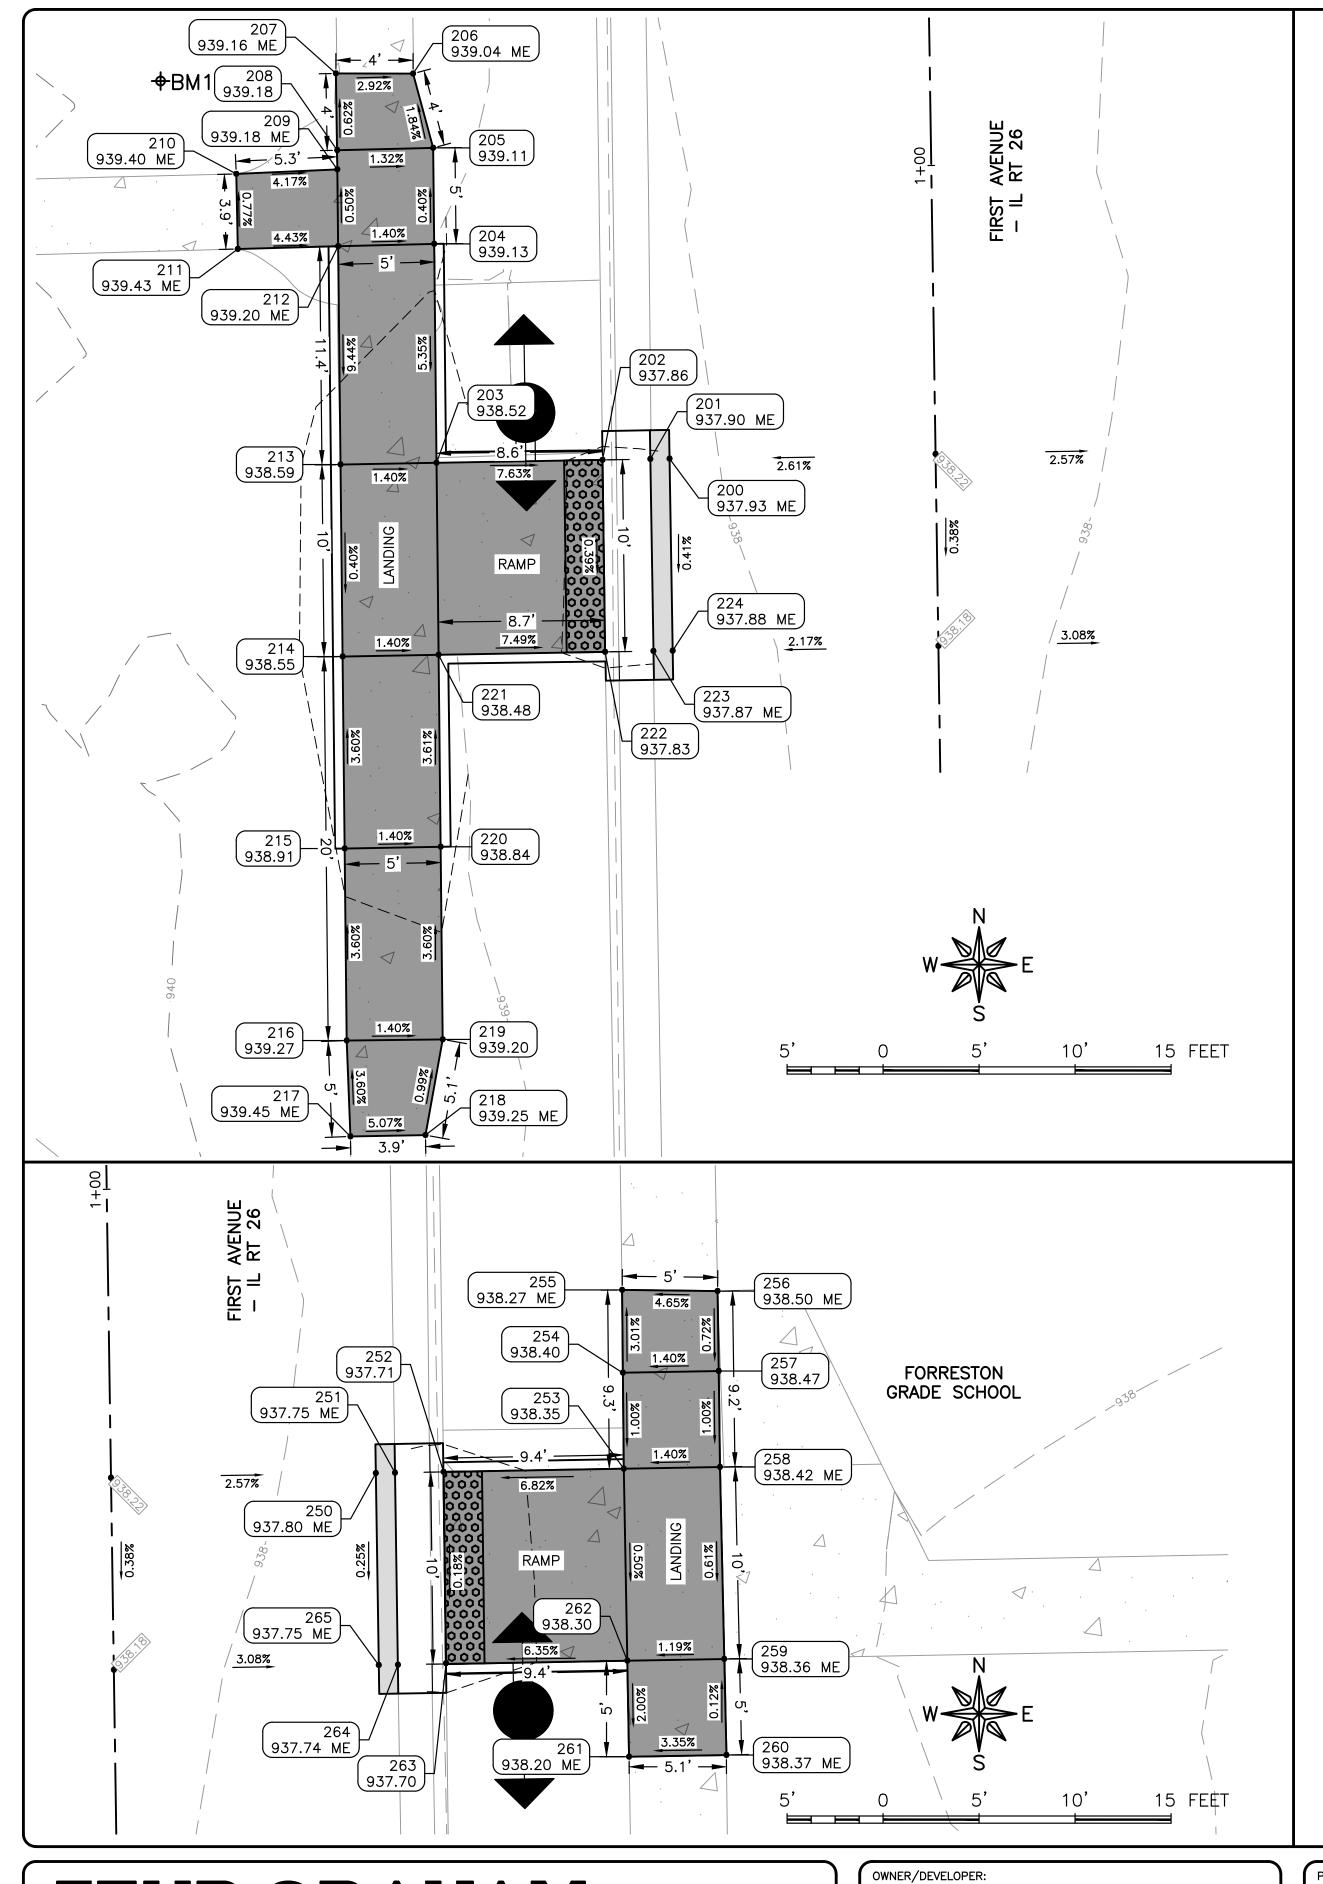BM1 = 5/8" REBAR WITH ORANGE CAP (CP1) N-1,988,136.02, E-2,455,925.62, ELEV-939.72

BM2 = CUT "X" NE OF CONCRETE SWALE (CP2) N-1,987,597.60, E-2,456,092.63, ELEV-933.84

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ENGINEERING & ENVIRONMENTAL ILLINOIS DESIGN FIRM NO. 184-003525

PLOT DATE: 8/28/20 © 2020 FEHR GRAHAM

ILLINOIS IOWA

WISCONSIN

VILLAGE OF FORRESTON 102 SOUTH WALNUT STREET P.O. BOX 206 PROJECT AND LOCATION:

SAFE ROUTES TO SCHOOL FORRESTON, ILLINOIS

DRAWN BY: MS
APPROVED BY: SWG
DATE: AUG 2020
SCALE: AS NOTED

REVISIONS		
REV. NO.	DESCRIPTION	DATE

ADA PLAN FORRESTON GRADE SCHOOL


CONTRACT 85702

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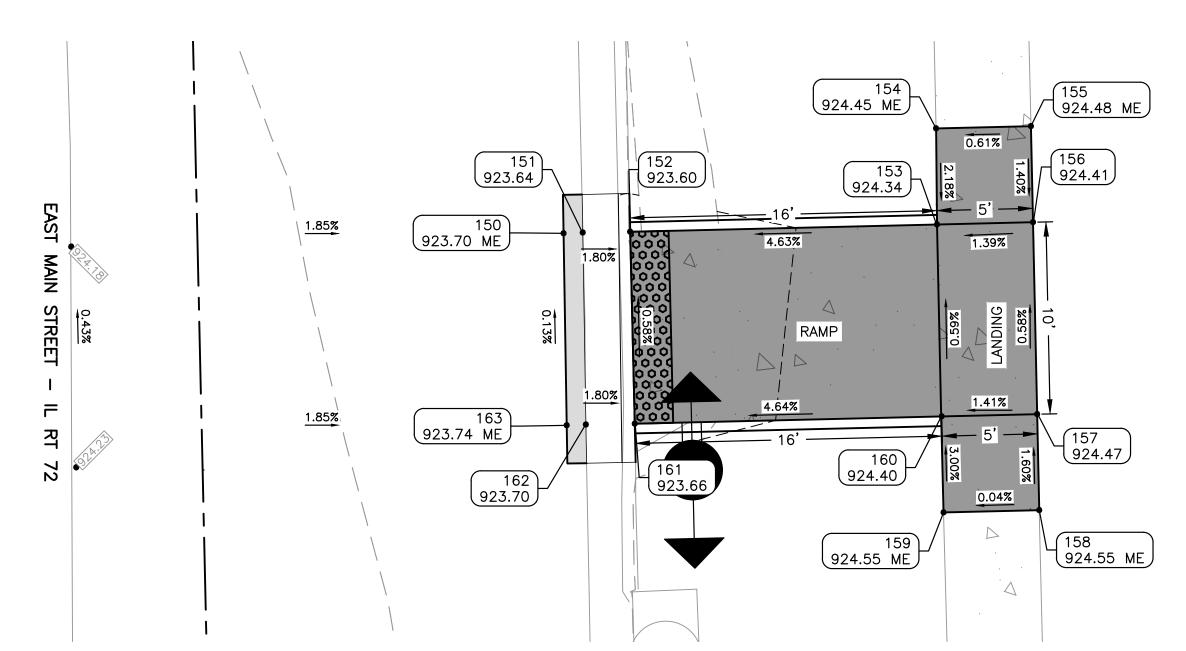
JOB NUMBER:

19-504


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ADA POINT TABLE				
POINT	POINT STATION		ELEV	
100	7+38.18	32.09	923.72	
101	7+38.18	33.08	923.69	
102	7+38.17	35.69	923.65	
103	7+38.17	36.17	923.65	
104	7+38.19	41.05	924.02	
105	7+33.20	41.21	924.04	
106	7+33.19	46.05	924.16	
107	7+38.19	46.05	924.09	
108	7+46.55	46.84	924.15	
109	7+49.91	48.49	924.25	
110	7+52.78	50.94	924.35	
111	7+56.46	47.55	924.31	
112	7+52.66	44.31	924.20	
113	7+48.17	42.11	924.07	
114	7+48.17	41.07	924.05	
115	7+48.17	36.37	923.72	
116	7+48.18	33.76	923.76	
117	7+48.18	32.81	923.78	

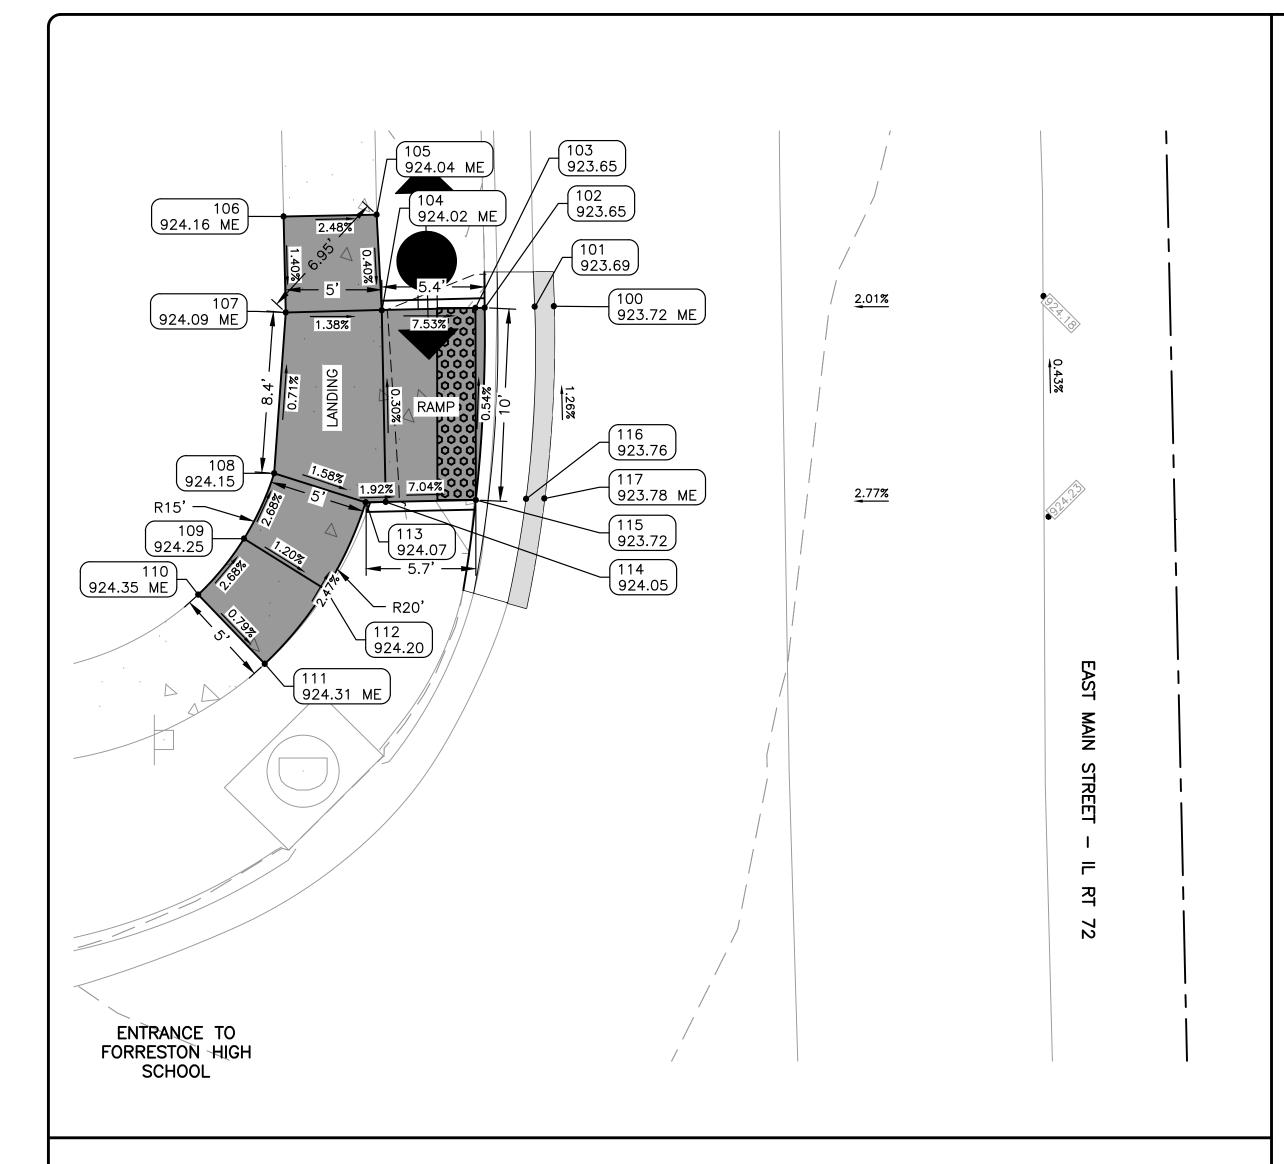

ADA POINT TABLE				
POINT	STATION	OFFSET	ELEV	
150	7+38.10	-19.07	923.70	
151	7+38.08	-20.07	923.64	
152	7+38.10	-22.54	923.60	
153	7+38.08	-38.53	924.34	
154	7+33.08	-38.59	924.45	
155	7+33.07	-43.53	924.48	
156	7+38.07	-43.53	924.41	
157	7+48.07	-43.52	924.47	
158	7+53.07	-43.51	924.55	
159	7+53.08	-38.53	924.55	
160	7+48.08	-38.55	924.40	
161	7+48.10	-22.56	923.66	
162	7+48.08	-20.01	923.70	
163	7+48.10	-19.01	923.74	



ENGINEERING & ENVIRONMENTAL ILLINOIS DESIGN FIRM NO. 184-003525

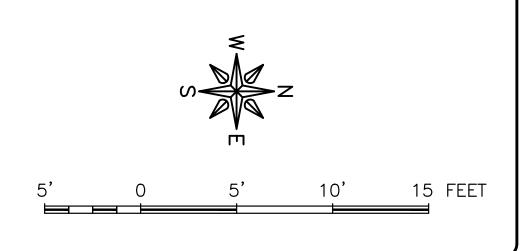ILLINOIS IOWA WISCONSIN OWNER/DEVELOPER:

VILLAGE OF FORRESTON

102 SOUTH WALNUT STREET

P.O. BOX 206

PROJECT AND LOCATION:

SAFE ROUTES TO SCHOOL FORRESTON, ILLINOIS

DRAWN BY: MS
APPROVED BY: SWG
DATE: AUG 2020
SCALE: AS NOTED

REVISIONS		
REV. NO.	DESCRIPTION	DATE

DRAWING:

ADA PLAN FORRESTON JR HIGH SCHOOL

CONTRACT 85702


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JOB NUMBER:

19-504

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11 of 15



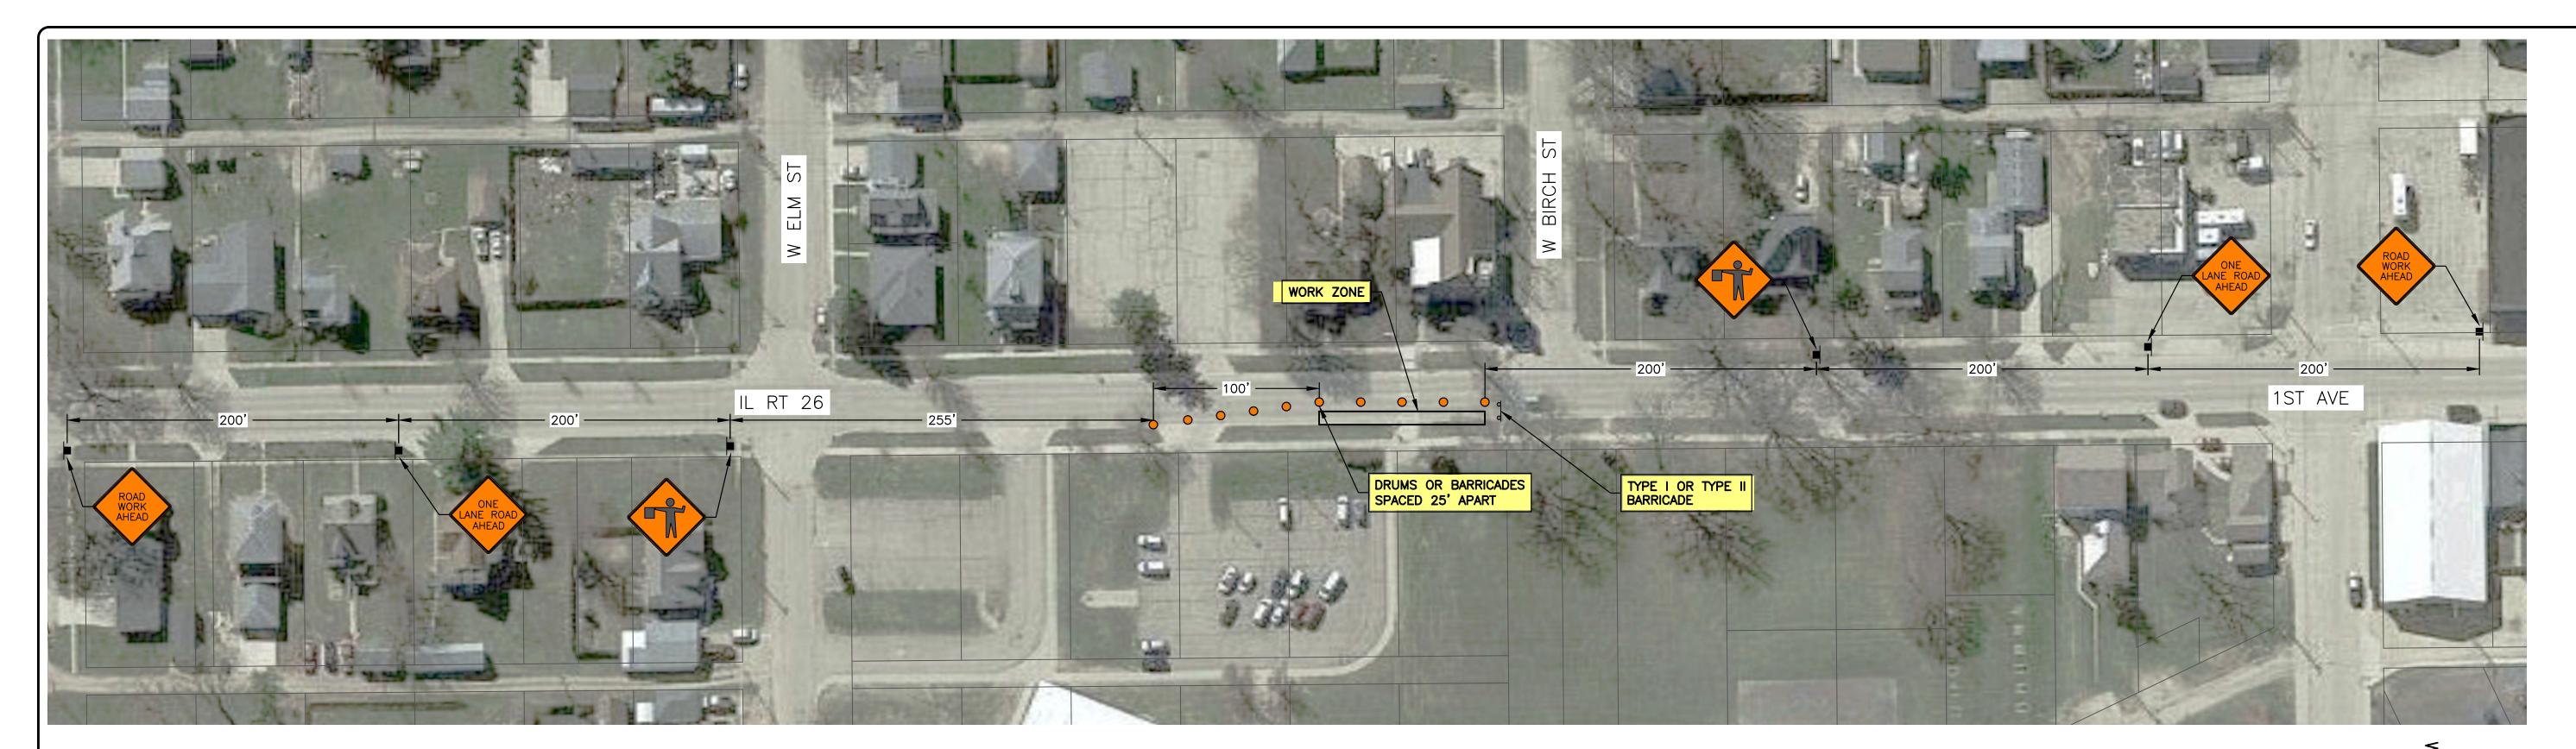

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ENGINEERING & ENVIRONMENTAL

ILLINOIS DESIGN FIRM NO. 184-003525

ILLINOIS IOWA WISCONSIN OWNER/DEVELOPER:

VILLAGE OF FORRESTON

102 SOUTH WALNUT STREET

P.O. BOX 206

PROJECT AND LOCATION:

SAFE ROUTES TO SCHOOL
FORRESTON, ILLINOIS

DRAWN BY: MS
APPROVED BY: SWG
DATE: AUG 2020
SCALE: AS NOTED

REVISIONS		
V. NO.	DESCRIPTION	DATE


TRAFFIC CONTROL PLAN — GRADE SCHOOL


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ENGINEERING & ENVIRONMENTAL ILLINOIS DESIGN FIRM NO. 184-003525

ILLINOIS IOWA

WISCONSIN

OWNER/DEVELOPER:

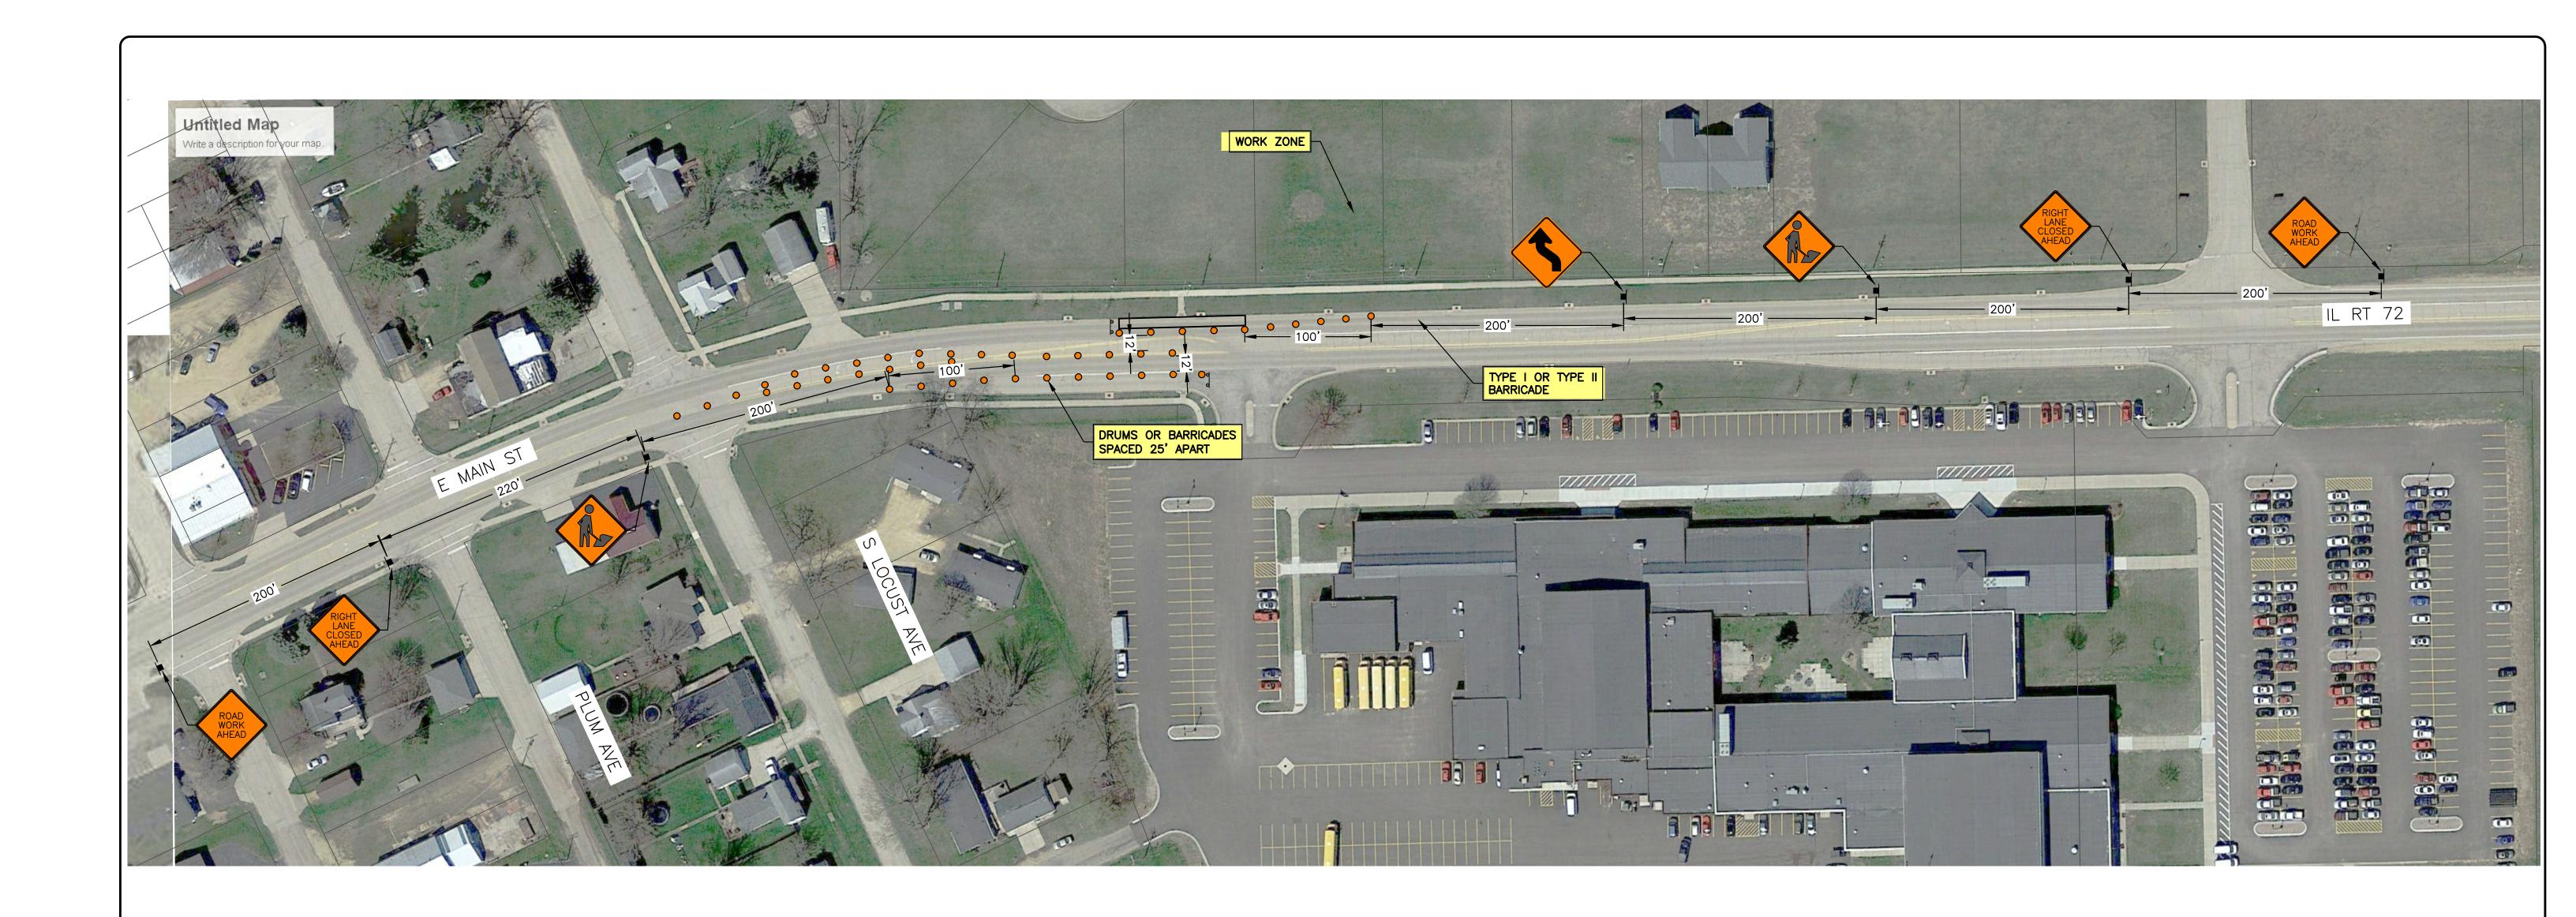VILLAGE OF FORRESTON

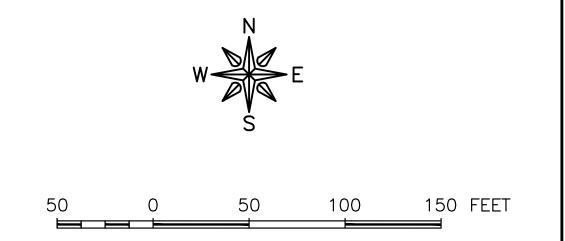102 SOUTH WALNUT STREET

P.O. BOX 206

PROJECT AND LOCATION:

SAFE ROUTES TO SCHOOL

FORRESTON, ILLINOIS

DRAWN BY: MS
APPROVED BY: SWG
DATE: AUG 2020
SCALE: AS NOTED


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SET TYPE: FOR BIDDING \\rockford\Drawings\C3D\19\19-504\19-504 Design.dwg, High School MOT

JOB NUMBER:


19-504

SHEET NUMBER:

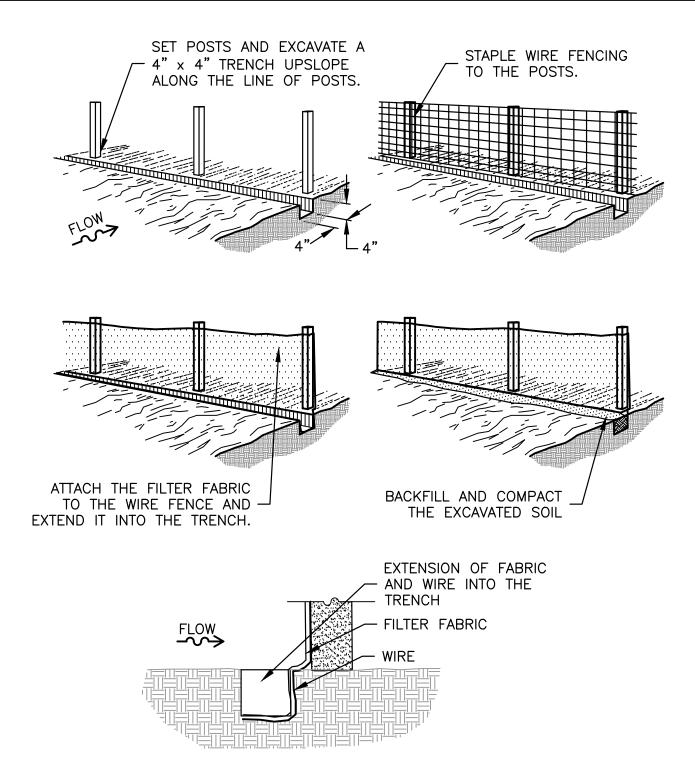

CROSS SECTION OF A SILT FENCE ANCHOR FENCE

SILT FENCE INSTALLATION DETAIL

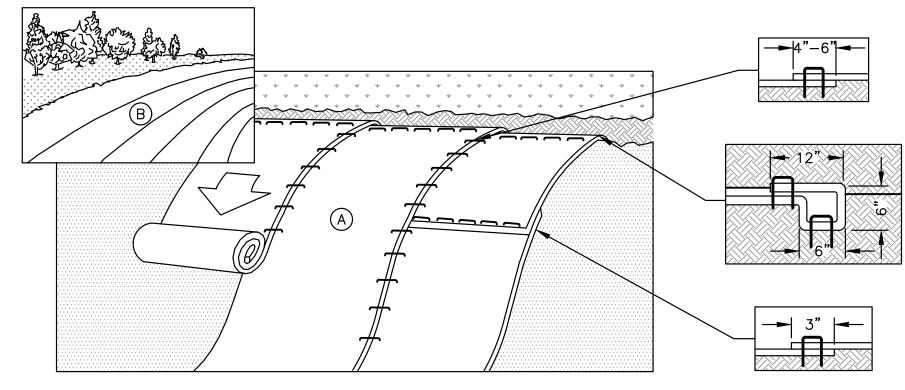

NOTE: PREPARE SOIL BEFORE INSTALLING BLANKETS, INCLUDING ANY NECESSARY APPLICATION OF LIME, FERTILIZER, AND SEED.

BEGIN AT THE TOP OF THE SLOPE BY ANCHORING THE BLANKET IN A 6" DEEP x 6" WIDE TRENCH WITH APPROXIMATELY 12" OF BLANKET EXTENDED BEYOND THE UP-SLOPE PORTION OF THE TRENCH. ANCHOR THE BLANKET WITH A ROW OF STAPLES/STAKES APPROXIMATELY 12" APART IN THE BOTTOM OF THE TRENCH. BACKFILL AND COMPACT THE TRENCH AFTER STAPLING. APPLY SEED TO COMPACTED SOIL AND FOLD REMAINING 12" PORTION OF BLANKET BACK OVER SEED AND COMPACTED SOIL. SECURE BLANKET OVER COMPACTED SOIL WITH A ROW OF STAPLES/STAKES SPACED APPROXIMATELY 12" APART ACROSS THE WIDTH OF THE BLANKET.

ROLL THE BLANKETS (A) DOWN OR (B) HORIZONTALLY ACROSS THE SLOPE. BLANKETS WILL UNROLL WITH APPROPRIATE SIDE AGAINST THE SOIL SURFACE. ALL BLANKETS MUST BE SECURELY FASTENED TO SOIL SURFACE BY PLACING STAPLES/STAKES IN APPROPRIATE LOCATIONS AS PER MANUFACTURES RECOMMENDATION.

THE EDGES OF PARALLEL BLANKETS MUST BE STAPLED WITH MINIMUM 6" OVERLAP. TO ENSURE PROPER SEAM ALIGNMENT, PLACE THE EDGE OF THE OVERLAPPING BLANKET (BLANKET BEING INSTALLED ON TOP) EVEN WITH THE SEAM STITCH ON THE PREVIOUSLY INSTALLED BLANKET.

CONSECUTIVE BLANKETS SPLICED DOWN THE SLOPE MUST BE PLACED END OVER END (SHINGLE STYLE) WITH AN APPROXIMATE 3" OVERLAP. STAPLE THROUGH OVERLAPPED AREA, APPROXIMATELY 12" APART ACROSS ENTIRE BLANKET WIDTH.

PLACE STAPLES/STAKES PER MANUFACTURE RECOMMENDATION FOR THE APPROPRIATE SLOPE BEING APPLIED.

IN LOOSE SOIL CONDITIONS, THE USE OF STAPLE OR STAKE LENGTHS GREATER THAN 6" MAY BE NECESSARY TO PROPERLY SECURE THE BLANKETS.


FOLLOW EROSION CONTROL TECHNOLOGY COUNCIL SPECIFICATION FOR PRODUCT SELECTION.

EROSION CONTROL BLANKET INSTALLATION DETAIL

OWNER/DEVELOPER: VILLAGE OF FORRESTON 102 SOUTH WALNUT STREET


PROJECT AND LOCATION: SAFE ROUTES TO SCHOOL FORRESTON, ILLINOIS

DRAWN BY: MS APPROVED BY: SWG DATE: AUG 2020 SCALE: AS NOTED

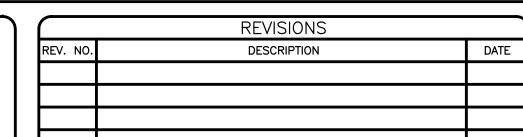

DRAWING: DETAILS 1 **CONTRACT 85702** SET TYPE: FOR BIDDING $\\C3D\19\19-504\Plans\19-504\ Plans.dwg,\ Details\ 1$

JOB NUMBER: 19-504 SHEET NUMBER: **14** of **15**

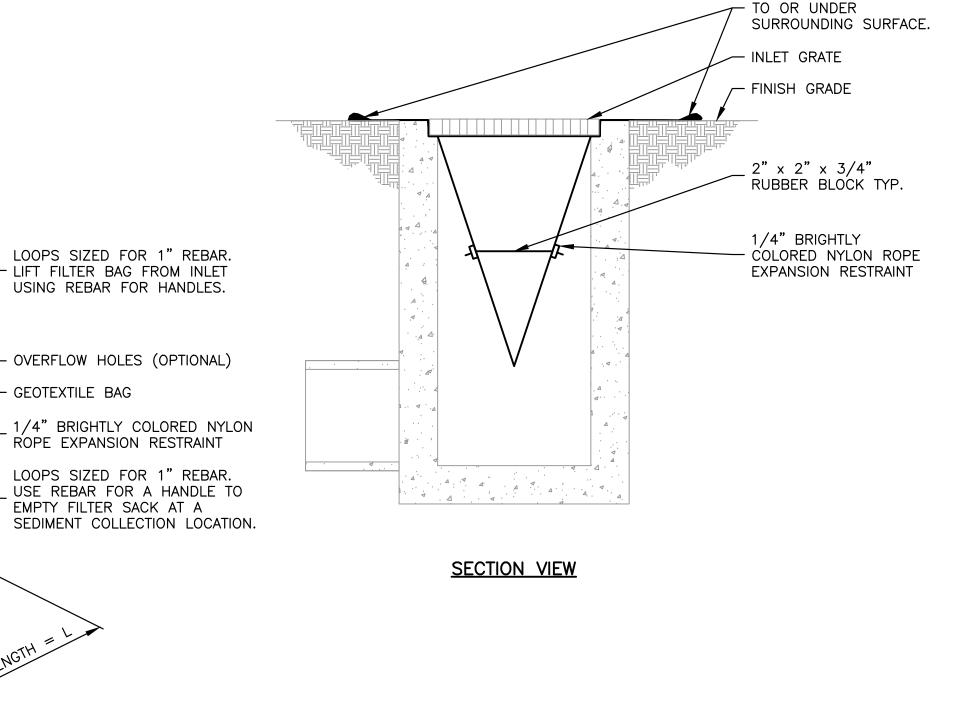

SECURE LIFTING LOOPS

ISOMETRIC VIEW

- GEOTEXTILE BAG

LOW TO MODERATE FLOW GEOTEXTILE **PROPERTIES** TEST METHOD UNITS 300 LBS GRAB TENSILE STRENGTH ASTM D-4632ASTM D-4632 GRAB TENSILE ELONGATION 20 % ASTM D-4833 120 LBS PUNCTURE MULLEN BURST ASTM D-3786 800 PSI ASTM D-4533 120 LBS TRAPEZOID TEAR ASTM D-4355 80 % UV RESISTANCE APPARENT OPENING SIZE ASTM D-4751 40 US SIEVE ASTM D-4491 | 40 GAL/MIN/SQ FT FLOW RATE **PERMITTIVITY** ASTM D-4491 | 0.55 SEĆ -1 MODERATE TO HIGH FLOW GEOTEXTILE TEST METHOD PROPERTIES UNITS GRAB TENSILE STRENGTH ASTM D-4632 265 LBS GRAB TENSILE ELONGATION ASTM D-4632 20 % 135 LBS ASTM D-4833 PUNCTURE MULLEN BURST ASTM D-3786 420 PSI TRAPEZOID TEAR ASTM D-4533 45 LBS UV RESISTANCE ASTM D-4355 90 % APPARENT OPENING SIZE ASTM D-4751 20 US SIEVE FLOW RATE ASTM D-4491 200 GAL/MIN/SQ FT PERMITTIVITY ASTM D-4491 1.5 SEC -1

FABRIC SPECIFICATION TABLE

NOTE: REMOVE TRAPPED SEDIMENT WHEN BRIGHTLY COLORED EXPANSION RESTRAINT CAN NO LONGER BE SEEN.

GEOTEXTILE SHALL BE A WOVEN POLYPROPYLENE FABRIC THAT MEETS OR EXCEEDS REQUIREMENTS IN THE SPECIFICATIONS TABLE.

PLACE AN OIL ADSORBENT PAD OR PILLOW OVER INLET GRATE WHEN OIL SPILLS ARE A CONCERN.

THE WIDTH, "W", OF THE FILTER SACK SHALL MATCH THE INSIDE WIDTH OF THE GRATED INLET BOX.

THE DEPTH, "D", OF THE FILTER SACK SHALL BE BETWEEN 18 INCHES AND 36 INCHES.

INSPECT PER REGULATORY REQUIREMENTS.

THE LENGTH, "L", OF THE FILTER SACK SHALL MATCH THE INSIDE LENGTH OF THE GRATED INLET BOX.

FILTER SACK FOR GRATED INLET DETAIL


FEHR GRAHAM

ILLINOIS IOWA


WISCONSIN

ENGINEERING & ENVIRONMENTAL

ILLINOIS DESIGN FIRM NO. 184-003525

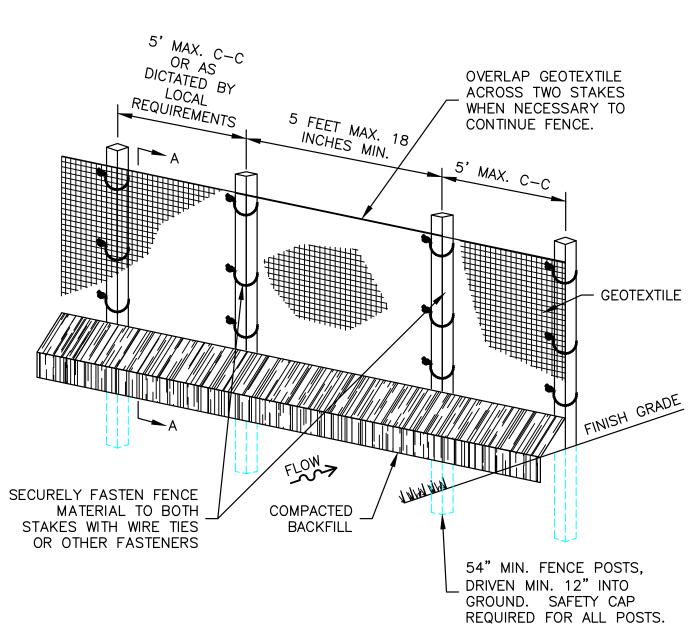

ELEVATION

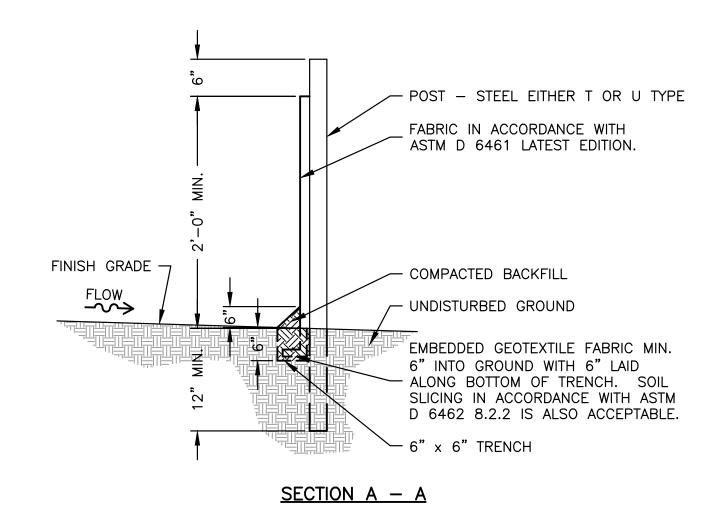


NOTE: INSTALLATION SHALL COMPLY WITH ASTM D 6462 LATEST EDITION. GEOTEXTILE TO BE FASTENED SECURELY TO STAKES.

> WHEN TWO SECTIONS OF GEOTEXTILE ADJOIN EACH OTHER THEY SHALL BE OVERLAPPED BY 18 to 60 INCHES AS SHOWN.

COLLECTED MATERIAL SHALL BE REMOVED WHEN "BULGES" DEVELOP IN THE SILT FENCE.

SILT FENCE WITHOUT WIRE SUPPORT DETAIL N.T.S.

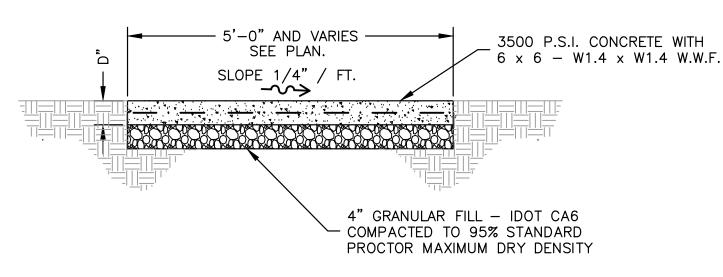

NOTE: WALK CONSTRUCTED OF 3500 PSI CONCRETE WITH 5 - 8% AIR ENTERTAINMENT, 3/4" MAX. AGGREGATE SIZE TO A MINIMUM THICKNESS OF 6" WITH $6 \times 6 - 10/10$ W.W.M. CONTINUOUS. WALK TO BE FINISHED WITH A FLOAT, STEEL TROWEL AND BARN BROOM FINISH WITH 6" TOOLED JOINTS AND EDGES. FORMED JOINTS TO BE FINISHED WITH A TOOL HAVING A 1/4" RADIUS.

INSTALL 1/2" WIDE EXPANSION JOINTS WITH BITUMINOUS JOINT FILLER AT 30'-0" O.C. (EXTEND FULL DEPTH OF WALK).


SCORE TOOLED JOINTS (1/2 D DEEP) AT 5'-0" O.C. UNLESS OTHERWISE NOTED.

INSTALL 1/2" WIDE BITUMINOUS ISOLATION JOINT WHERE SIDEWALK ABUTS A CURB, CONCRETE DRIVEWAY, STRUCTURE OR AT AN ADJACENT CURB JOINT (EXTEND FULL DEPTH OF WALK).

DEPTH D = 6" EXCEPT AT DRIVEWAYS WHERE D = 7".

SIDEWALK RAMPS AT DRIVES TO BE CONSTRUCTED ACCORDING TO IDOT STANDARD No. 424001.

SIDEWALK DETAIL N.T.S.

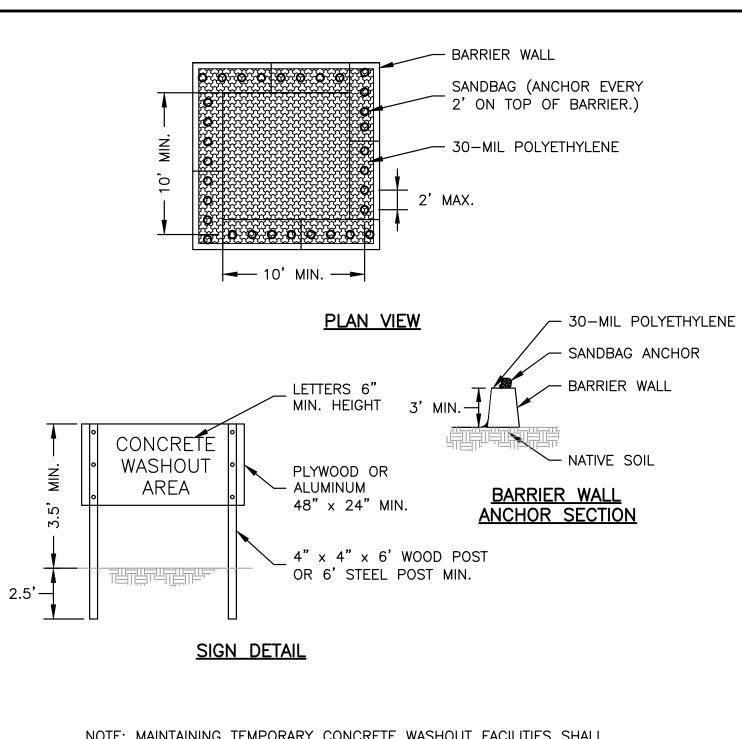

NOTE: MAINTAINING TEMPORARY CONCRETE WASHOUT FACILITIES SHALL INCLUDE REMOVING AND DISPOSING OF HARDENED CONCRETE AND/OR SLURRY AND RETURNING THE FACILITIES TO A FUNCTIONAL CONDITION. FACILITY SHALL BE CLEANED OR RECONSTRUCTED IN A

NEW AREA ONCE WASHOUT BECOMES TWO-THIRDS FULL.

CONCRETE WASH OUT PIT DETAIL

FEHR GRAHAM

ENGINEERING & ENVIRONMENTAL

ILLINOIS IOWA

WISCONSIN

OWNER/DEVELOPER: VILLAGE OF FORRESTON 102 SOUTH WALNUT STREET P.O. BOX 206

PROJECT AND LOCATION:

SAFE ROUTES TO SCHOOL FORRESTON, ILLINOIS

REVIS DRAWN BY: MS DESCF REV. NO. APPROVED BY: SWG DATE: AUG 2020 SCALE: AS NOTED

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		CONTRACT 85702
		SET TYPE: FOR BIDDING \\rockford\Drawings\C3D\19\19-504\Plans\19-504 Plans.dwg, Details 2

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