


F.A.P. RTE.	SECTION	COUNTY	TOTAL SHEETS	SHEET NO.
607	129 BR	KENDALL	61	12
STA.		TO STA.		
FED. ROAD DIST. NO.		ILLINOIS FED. AID PROJECT		

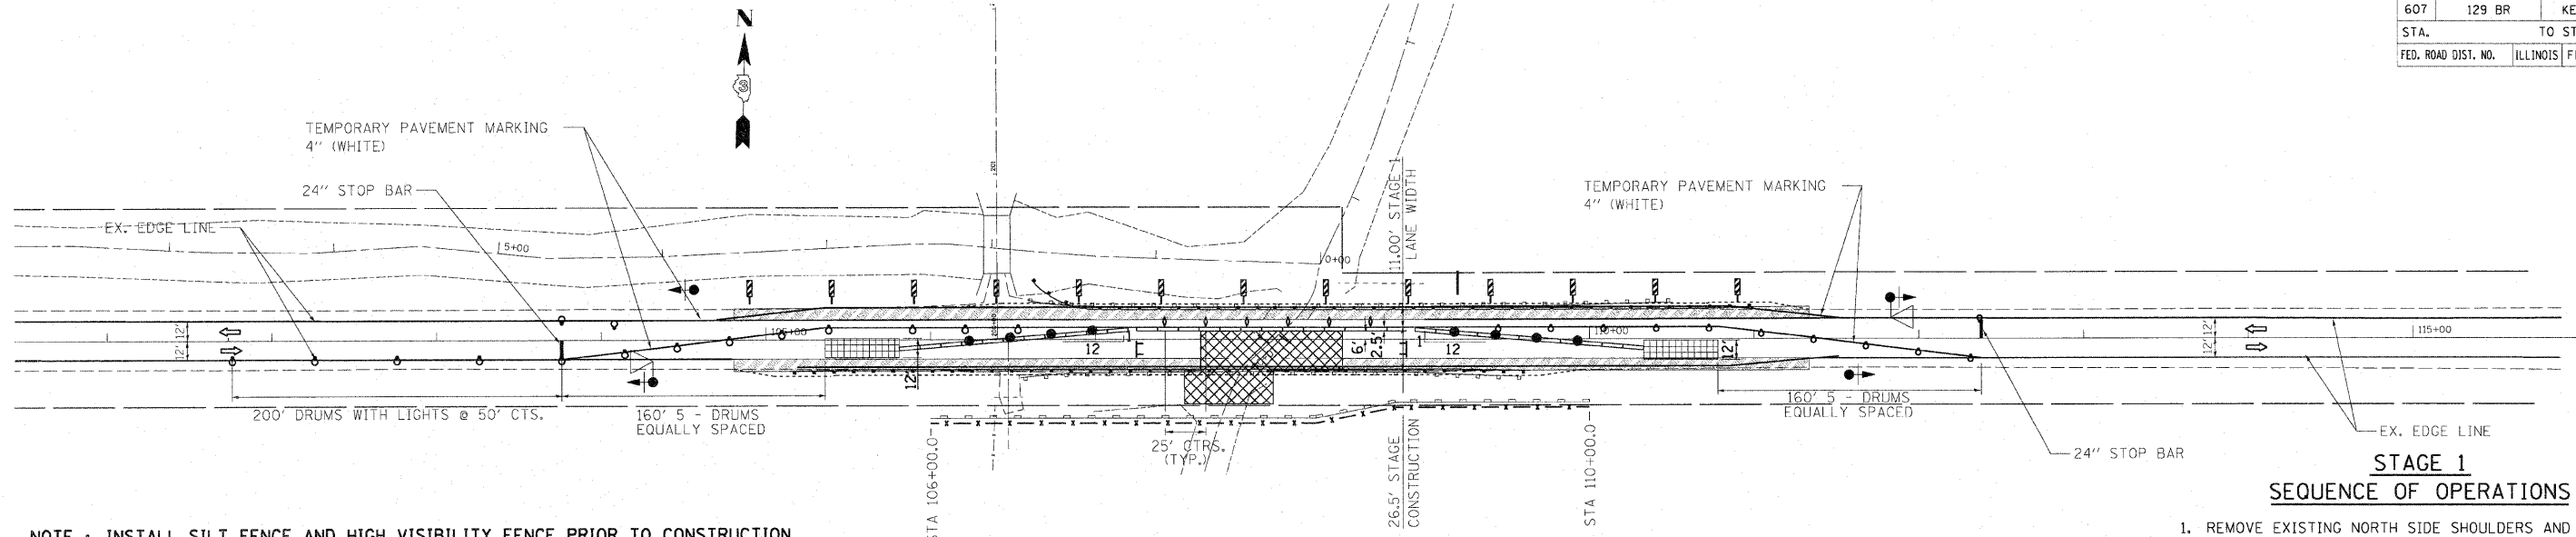


NOTE : INSTALL SILT FENCE AND HIGH VISIBILITY FENCE PRIOR TO CONSTRUCTION

**TRAFFIC CONTROL SCHEMATIC**


NOTE : TEMPORARY RUMBLE STRIPS AND SIGNS AS SHOWN IN TRAFFIC CONTROL AND PROTECTION STANDARD 701321 AND 702001 SHALL BE INSTALLED.

**STAGE 1 SEQUENCE OF OPERATIONS**

1. REMOVE EXISTING NORTH SIDE SHOULDERS AND CONSTRUCT NORTH SIDE HMA BASE COURSE WIDENING WITH THE AID OF TRAFFIC CONTROL AND PROTECTION STANDARD 701326.
2. INSTALL TEMPORARY TRAFFIC SIGNALS, ATTENUATOR BASES, ATTENUATORS, TEMPORARY CONCRETE BARRIERS AND DRUMS WITH THE AID OF TRAFFIC CONTROL AND PROTECTION STANDARDS 701201 AND 701006. ALL OTHER ITEMS AS PER THESE DETAILS AND AS PER LANE CLOSURE 2L, 2W, BRIDGE REPAIR WITH BARRIER STANDARD 701321. BEGIN OPERATING UNDER STAGE 1 TRAFFIC CONDITIONS WITH THE AID OF TRAFFIC CONTROL AND PROTECTION STANDARD 701201 AND 701006.
3. REMOVE EXISTING SOUTH SIDE SHOULDERS, GUARDRAIL & TRAFFIC BARRIER TERMINALS, EXCAVATE, AND REMOVE PORTION OF HWY 52 EXISTING STRUCTURE. REMOVE ENTRANCE STRUCTURE AT STA. 106+40.2 LT. REMOVE ENTRANCE AND 15" RCP AT STA. 106+47.23 RT.
4. CONSTRUCT NEW PORTIONS OF PROPOSED HWY 52 STRUCTURE (SN 047-0016), BACKFILL, COMPACT. INSTALL SOUTH SIDE HMA BASE COURSE WIDENING AND SOUTH LANE ROADWAY HMA BASE COURSE, INSTALL GUARDRAIL AND TRAFFIC BARRIER TERMINALS. CONSTRUCT NEW ENTRANCE STRUCTURE (SN 047-0046). GRADE AND SHAPE DITCHES.

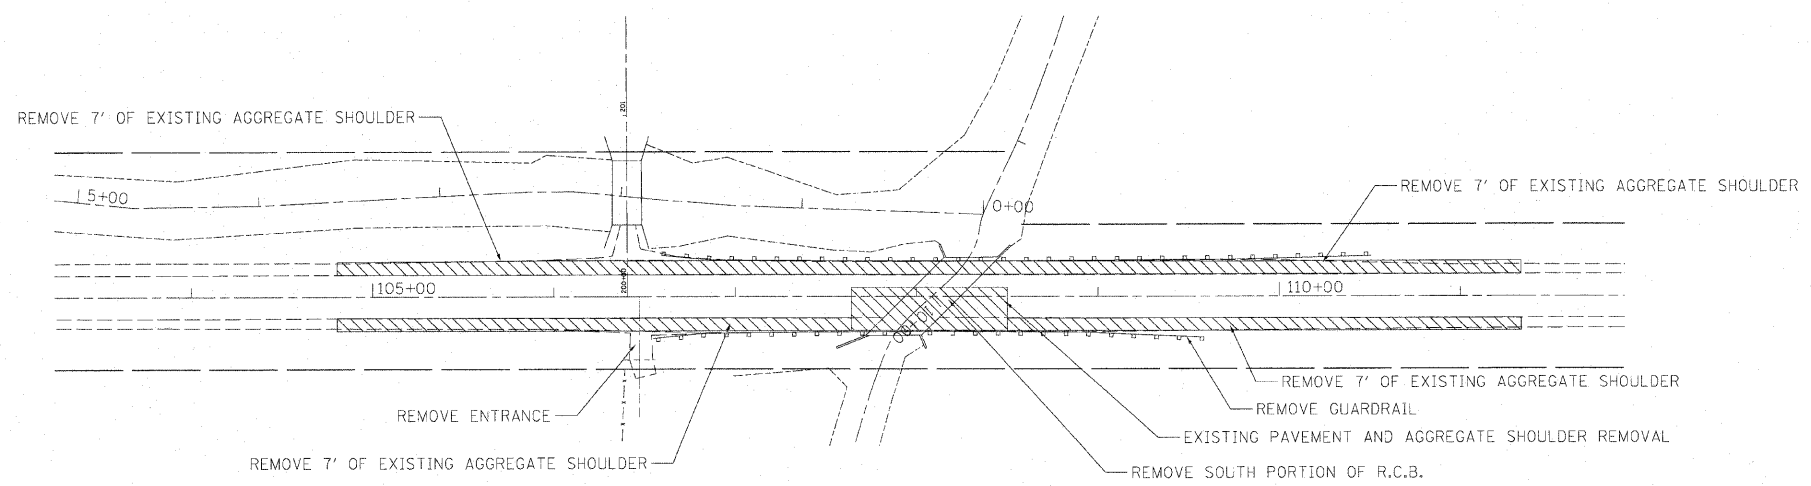

**REMOVAL SCHEMATIC**

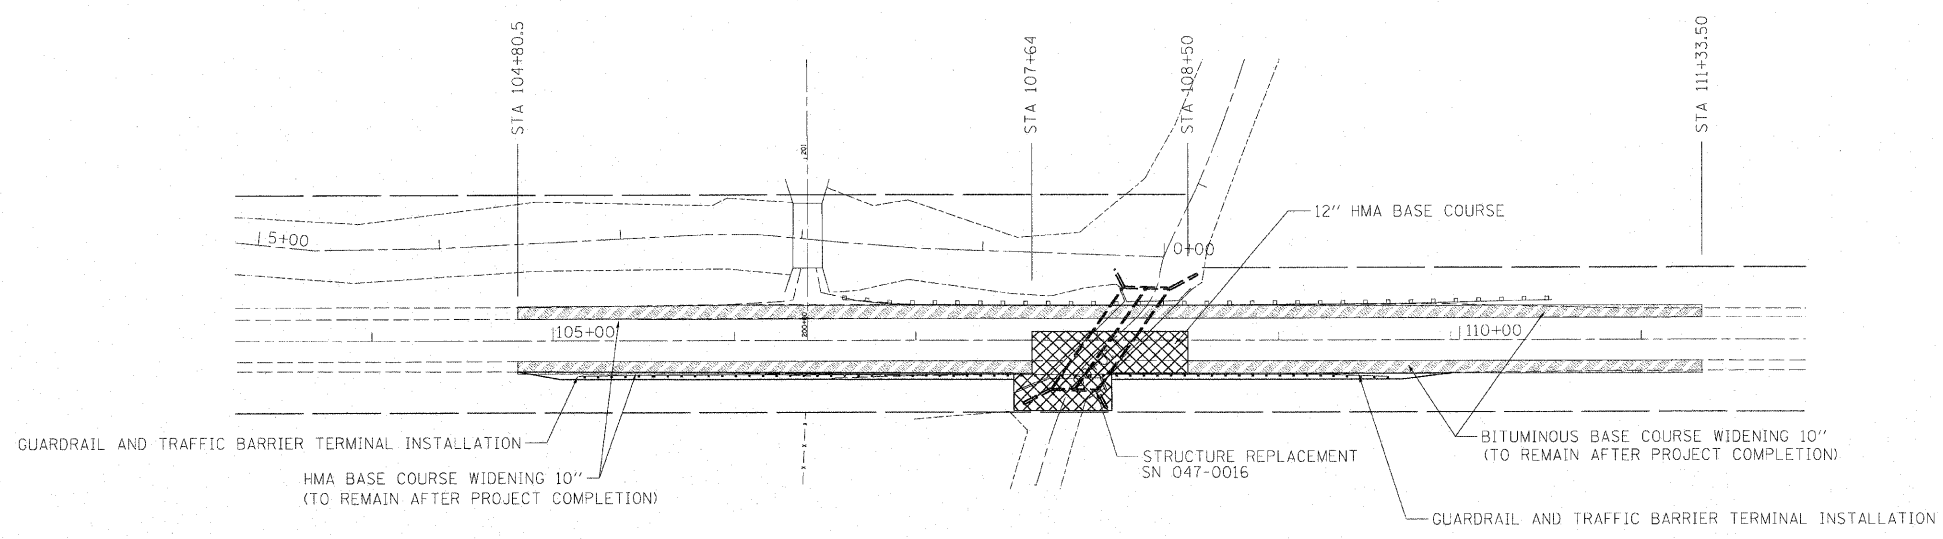

**CONSTRUCTION SCHEMATIC**

**LEGEND**

- WORK AREA
- REMOVAL AREA (SEE NOTES)
- HMA BASE COURSE WIDENING 10"
- TYPE III BARRICADE
- MICROWAVE DETECTOR
- TRAFFIC SIGNALS WITH BACKPLATE
- DRUM WITH STEADY BURNING LIGHT
- STOP LINE 24"
- TEMPORARY IMPACT ATTENUATOR (NON-REDIRECTIVE) RESERVE AREA
- DOUBLE VERTICAL PANEL
- TYPE C BIDIRECTIONAL REFLECTOR
- STEADY BURNING LIGHTS AND DOUBLE VERTICAL PANEL

REVISIONS	
NAME	DATE

ILLINOIS DEPARTMENT OF TRANSPORTATION

**STAGING PLANS**  
STAGE 1 CONSTRUCTION

SCALE: VERT. NOT TO SCALE  
HORIZ. NOT TO SCALE  
DATE 10/17/2007

DRAWN BY C. SUNTKEN  
CHECKED BY M. ZELINSKAS

PLOT DATE = 10/17/2007  
 FILE NAME = K:\DRAFT\66667\1\From Dbb 12-29-06\1000.dgn  
 PLOT SCALE = 1/8"=1'-0"  
 USER NAME = JUSER