11-07-2025 LETTING ITEM 008

PROJECT IS LOCATED IN THE

FOR INDEX OF SHEETS, SEE SHEET NO. 2

STATE OF ILLINOIS


DEPARTMENT OF TRANSPORTATION

PROPOSED HIGHWAY PLANS

FAI 55 (I-55) AT CATON FARM ROAD (3 MILES N. OF US 52) **SECTION FAI 55 22 BRIDGE REHAB** PROJECT NO: NHPP-JM31(164) **BRIDGE DECK OVERLAY AND JOINT REPAIR**

WILL COUNTY

C-91-232-22

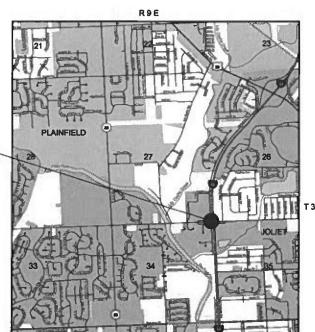

3RD PM

D-91-186-22

55 FAI 55 22 BRIDGE REMAB WILL 31

SECTION

COUNTY TOTAL SHEET

ILLINOIS CONTRACT NO. 62R76



STATE OF ILLINOIS DEPARTMENT OF TRANSPORTATION

> PRINTED BY THE AUTHORITY OF THE STATE OF ILLINOIS

TRAFFIC DATA

CITY OF JOLIET

CATON FARM ROAD: FUNCTION CLASS = MINOR ARTERIAL ADT (2023) = 18,100POSTED SPEED LIMIT = 35 MPH

FUNCTION CLASS = INTERSTATE ADT (2023) = 78,800POSTED SPEED LIMIT = 55 MPH

HOWARD J. HAMILTON, PE, CFM, CPESC SHEETS 1-13 ILUNOIS LICENSE NO. 062-047406 EXPIRES 11/30/2025

MAJLINDA AGOJCI P.E., S.E. SHEETS 14-22 ILLINOIS LICENSE NO. 081-006911

EXPIRES 11/30/2026

RUCTURAL MAJLINDA AGOJCI 081-006911

FULL SIZE PLANS HAVE REEN PREPARED USING STANDARD ENGINEERING SCALES. REDUCED SIZED PLANS WILL NOT CONFORM TO STANDARD SCALES, IN MAKING MEASUREMENTS ON REDUCED PLANS, THE ABOVE SCALES MAY BE USED.

JOINT UTILITY LOCATION INFORMATION FOR EXCAVATORS 1-800-892-0123 OR 811


PROJECT MANAGER, PRAVEEN KAINI, PE (847) 705-4237

GROSS LENGTH = 290.00 FT. = 0.055 MILE NET LENGTH = 290.00 FT. = 0.055 MILE

CONTRACT NO. 62R76

0



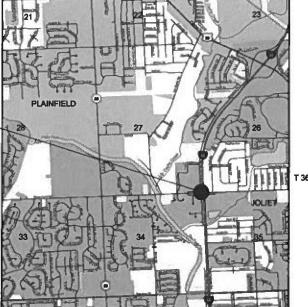



SHEET INDEX

COVER

GENERAL NOTES/SHEET INDEX 2.

SUMMARY OF QUANTITIES 3-5.

MOT GENERAL NOTES/CONSTRUCTION SEQUENCING

MAINTENANCE OF TRAFFIC TYPICAL SECTION

MAINTENANCE OF TRAFFIC PLAN STAGE 1 8-9 MAINTENANCE OF TRAFFIC PLAN STAGE 2

10-11.

ROADWAY PLAN 12.

PAVEMENT MARKING PLAN 13.

STRUCTURE PLANS 14-22.

23. DISTRICT 1 STANDARD DETAIL BD-24 DISTRICT 1 STANDARD DETAIL BD-32 24. DISTRICT 1 STANDARD DETAIL TC-8 25. 26. DISTRICT 1 STANDARD DETAIL TC-9 27. DISTRICT 1 STANDARD DETAIL TC-10 DISTRICT 1 STANDARD DETAIL TC-11 28. 29. DISTRICT 1 STANDARD DETAIL TC-13 DISTRICT 1 STANDARD DETAIL TC-17 30. 31. DISTRICT 1 STANDARD DETAIL TC-22

HIGHWAY STANDARDS

630001-13 STEEL PLATE BEAM GUARDRAIL OFF-RD OPERATIONS, 2L, 2W, 15' TO 24" FROM PAVEMENT EDGE 701006-05 701101-05 OFF-RD OPERATIONS, 15' (4.5 m) TO 24" (600 mm) FROM PAVEMENT EDGE 701106-02 OFF ROAD OPERATIONS, MULTILANE, MORE THAN 15' AWAY 701301-04 LANE CLOSURE, 2L, 2W, SHORT TIME OPERATIONS LANE CLOSURE, 2L, 2W, MOVING OPERATIONS-DAY ONLY 701311-03 701331-05 LANE CLOSURE, 2L, 2W, WITH RUNAROUND FOR SPEEDS ≥ 45 701400-12 APPROACH TO LANE CLOSURE FREEWAY/EXPRESSWAY 701401-13 LANE CLOSURE, FREEWAY/EXPRESSWAY 701411-09 LANE CLOSURE, MULTILANE, AT ENTRANCE OR EXIT RAMP. FOR SPEEDS ≥ 45 701427-05 LANE CLOSURE, MULTILANE, INTERMITTENT OR MOVING OPER., FOR SPEEDS ≤ 40 701428-01 TRAFFIC CONTROL SETUP AND REMOVAL FREEWAY/EXPRESSWAY TWO LANE CLOSURE, FREEWAY/EXPRESSWAY 701446-11

606001-08 CONCRETE CURB TYPE B AND COMBINATION CONCRETE CURB AND GUTTER

000001-08 STANDARD SYMBOLS, ABBREVIATIONS AND PATTERNS

701606-10 URBAN SINGLE LANE CLOSURE, MULTILANE, 2W WITH MOUNTABLE MEDIAN

701611-01 URBAN HALF ROAD CLOSURE, MULTILANE, 2W WITH MOUNTABLE MEDIAN

701901-10 TRAFFIC CONTROL DEVICES

704001-08 TEMPORARY CONCRETE BARRIER

780001-05 TYPICAL PAVEMENT MARKINGS

782006-01 GUARDRAIL AND BARRIER WALL REFLECTOR MOUNTING DETAILS

HMA MIXTURE REQUIREMENTS

MIXTURE TYPE	AIR VOIDS @ NDES	QUALITY MANAGEMENT PROGRAM (QMP)							
HMA OVERLAY AND BUTT JOINT									
HOT MIX ASPHALT SURFACE COURSE, IL-9.5, MIX "D", N70, 1 1/2"	4% AT 70 GYR.	QC/QA							
QMP DESIGNATION: QUALITY CONTROL/ QUALITY ASSURANCE (QC/QAPAY FOR PERFORMANCE (PFP)	A), QUALITY CONTROL FOR PEF	RFORMANCE (QCP),							

- 1. THE UNIT WEIGHT USED TO CALCULATE ALL HOT-MIX ASPHALT SURFACE MIXTURE QUANTITIES IS 112 LBS/SQ.YD/IN.
- 2. THE "AC TYPE" FOR POLYMERIZED HMA MIXES SHALL BE "SBS/SBR PG 76-22" AND FOR NON-POLTMERIZED HMA THE "AC TYPE" SHALL BE "PG 64-22" UNLESS MODIFIED BY RECLAIMED MATERIALS SPECIFICATIONS.

GENERAL NOTES

- THE CONTRACTOR WILL NOT BE ALLOWED TO SET UP A YARD OR FIELD OFFICE ON STATE OR CITY PROPERTY WITHOUT WRITTEN PERMISSION FROM THE DEPARTMENT.
- IT SHALL BE THE CONTRACTOR'S RESPONSIBILITY TO VERIFY ALL DIMENSIONS AND CONDITIONS EXISTING IN THE FIELD PRIOR TO CONSTRUCTION AND ORDERING OF MATERIALS.
- THE CONTRACTOR SHALL TAKE EXTREME CARE WHEN PERFORMING DEMOLITION AND REMOVAL AROUND THE EXISTING FACILITIES TO REMAIN IN PLACE. IF EXISTING ELEMENTS ARE DAMAGED, THE CONTRACTOR SHALL REPAIR/RESTORE TO MATCH THE EXISTING CONDITIONS OR BETTER.
- BEFORE BEGINNING ANY WORK, THE CONTRACTOR SHALL RETAIN AND RECORD FOR FUTURE REFERENCES, ALL EXISTING PAVEMENT MARKING LINES (AND RAISED REFLECTIVE PAVEMENT MARKERS) IN ORDER THAT THESE LOCATIONS CAN BE RE-ESTABLISHED FOR STRIPING.
- THE CONTRACTOR SHALL CONTACT KALPANA KANNAN-HOSADURGA, THE DISTRICT ONE TRAFFIC CONTROL SUPERVISOR, AT KALPANA.KANNAN-HOSADURGA@ILLINOIS.GOV A MINIMUM OF 72 HOURS IN ADVANCE OF BEGINNING
- THE CONTRACTOR SHALL CONTACT CARLOS MUNOZ. THE DISTRICT ONE EXPRESSWAY TRAFFIC CONTROL SUPERVISOR, AT CARLOS MUNOZ@ILLINOIS.GOV A MINIMUM OF 72 HOURS IN ADVANCE OF BEGINNING WORK.
- TWO WEEKS PRIOR TO THE PLACEMENT OF PERMANENT PAVEMENT MARKINGS. THE ENGINEER SHALL CONTACT MR. ERIC CAMPOS, AREA TRAFFIC FIELD ENGINEER, AT ERIC.CAMPOS@ILLINOIS.GOV.
- THE CONTRACTOR SHALL REQUEST AND GAIN APPROVAL FROM THE ILLINOIS DEPARTMENT OF TRANSPORTATION'S EXPRESSWAY TRAFFIC OPERATIONS ENGINEER AT WWW.IDOTLCS.COM TWENTY FOUR (24) HOURS IN ADVANCE OF ALL DAILY LANE, RAMP, AND SHOULDER CLOSURES AND SEVEN DAYS IN ADVANCE OF ALL PERMANENT AND WEEKEND CLOSURES ON ALL FREEWAYS AND/OR EXPRESSWAYS IN DISTRICT ONE. THIS ADVANCE NOTIFICATION IS CALCULATED BASED ON THE WORKWEEK OF MONDAY THROUGH FRIDAY AND SHALL NOT INCLUDE WEEKENDS OR HOLIDAYS.
- NO WORK SHALL COMMENCE UNTIL TRAFFIC CONTROL REQUIREMENTS ARE MET.
- DURING CONSTRUCTION OPERATIONS, WHENEVER LOOSE MATERIAL IS DEPOSIT IN THE FLOW LINE OF GUTTER, DRAINAGE STRUCTURES, DITCHES, ETC. SUCH THAT THE NATURAL FLOW LINE OF WATER IS OBSTRUCTED, THE LOOSE MATERIAL SHALL BE REMOVED AT THE CLOSE OF EACH WORKING DAY. AT THE CONCLUSION OF THE CONSTRUCTION OPERATIONS, ALL DRAINAGE STRUCTURES AND FLOW LINES SHALL BE FREE FROM DIRT AND DEBRIS.
- WHEN ARTIFICIAL LIGHTS ARE USED THE CONTRACTOR SHALL EXERCISE THE UTMOST PRECAUTIONS IN PREVENTING ADVERSE VISIBILITY TO THE MOTORING PUBLIC AND ADJOINING RESIDENTIAL AREAS.
- SAW CUTS (FULL DEPTH) SHALL BE REQUIRED WITHIN THE PAVEMENT, SIDEWALK, AND CURB & GUTTER AND THAT TO BE LEFT IN PLACE OR DIRECTED BY THE ENGINEER. THE WORK WILL NOT BE PAID FOR SEPARATELY BUT SHALL BE INCLUDED IN THE COST OF REMOVAL ITEMS.
- TEN (10) FOOT TRANSITIONS SHALL BE USED TO MATCH PROPOSED CURB AND GUTTER AND MEDIAN ITEMS OF WORK TO EXISTING CURB AND GUTTER AND MEDIAN IN THE FIELD, UNLESS OTHERWISE SHOWN.
- THE CONTRACTOR SHALL BE RESPONSIBLE FOR THE PROTECTION OF ALL UNDERGROUND OR SURFACE UTILITIES EVEN THOUGH THEY MAY NOT BE SHOWN ON THE PLANS. ANY UTILITY THAT IS DAMAGED DURING CONSTRUCTION SHALL BE REPAIRED OR REPLACED TO THE SATISFACTION OF THE ENGINEER. THIS WORK SHALL BE AT THE CONTRACTOR'S EXPENSE.
- THE CONTRACTOR SHALL TAKE WHATEVER PRECAUTIONS WHICH MAY BE NECESSARY TO PROTECT THE PROPERTY OF THE VARIOUS PUBLIC UTILITIES WHICH MAY BE LOCATED UNDERGROUND OR ABOVE GROUND, AT OR ADJACENT TO THE SITE OF THIS IMPROVEMENT, HE WILL BE REQUIRED TO REPAIR OR REPLACE AT HIS OWN EXPENSE, OR BEAR THE COST, TO REPAIR OR REPLACE, ANY PUBLIC UTILITY PROPERTY WHICH HAS BEEN DAMAGED BY HIS EFFORTS.

SCALE:

SHEET 1

I-55 AT CATON FARM ROAD					AD	F.A.I. RTE	SECTION		COUNTY	TOTAL SHEETS	SHEET NO.
					NEX	55	FAI 55 22 BRIDGE REH	IAB	WILL	31	2
GENERAL NOTES/SHEET INDEX								CONTRAC	Γ NO. 62F	₹76	
1	OF	1	SHEETS	STA	TO STA		III INOIS	EED AII	DROJECT		

SI	JMMARY OF QUANTITIES			CONSTR. CODE
	DIMINIARY OF GOARTHEO			90% FEDERAL 10% STATE
CODE	ITEM	UNIT	UNIT TOTAL	
NO.			QUANTITY	SN 099-0210
40600290	BITUMINOUS MATERIALS (TACK COAT)	POUND	212	212
40600982	HOT-MIX ASPHALT REMOVAL-BUTT JOINT	SQ YD	306	306
40604062	HOT-MIX ASPHALT SURFACE COURSE, IL-9.5, MIX "D", N70	TON	54	54
50102400	CONCRETE REMOVAL	CU YD	15	15
50157300	PROTECTIVE SHIELD	SQ YD	162	162
50300255	CONCRETE SUPERSTRUCTURE	CU YD	17	17
50300300	PROTECTIVE COAT	SQ YD	1115	1115
50800205	REINFORCEMENT BARS, EPOXY COATED	POUND	2580	2580
50800515	BAR SPLICERS	EACH	24	24
52000110	PREFORMED JOINT STRIP SEAL	FOOT	102	102
60260100	INLETS TO BE ADJUSTED	EACH	4	4
63100085	TRAFFIC BARRIER TERMINAL, TYPE 6	EACH	1	1
63200310	GUARDRAIL REMOVAL	FOOT	37.5	37.5
67100100	MOBILIZATION	L SUM	1	1
70107025	CHANGEABLE MESSAGE SIGN	CAL DA	120	120

USER NAME = mbuiting

Environmental Design International inc.

Civ., Survey, Environmente and Construction Inspection Services
SW, MoNROE STREET, SIDE 1825, CHICAGO, 16, 6903

STATE OF ILLINOIS
DEPARTMENT OF TRANSPORTATION

I-55 AT CATON FARM ROAD SUMMARY OF QUANTITIES

SCALE: N.A. SHEET 1 OF 3 SHEETS STA.

TO STA.

					CONSTR. CODE		
			T		90% FEDERAL		
					10% STATE BRIDGE		
	CODE	ITEM UNIT TOTAL UNIT CHARTER					
	NO.			QUANTITY	SN 099-0210		
	70300150	SHORT TERM PAVEMENT MARKING REMOVAL	SQ FT	3263	3263		
	70307120	TEMPORARY PAVEMENT MARKING - LINE 4" - TYPE IV TAPE	FOOT	9790	9790		
	70400100	TEMPORARY CONCRETE BARRIER	FOOT	614	614		
	70400200	RELOCATE TEMPORARY CONCRETE BARRIER	FOOT	614	614		
	70600241	IMPACT ATTENUATORS, TEMPORARY (NON- REDIRECTIVE, NARROW), TEST LEVEL 2	EACH	2	2		
	70600341	IMPACT ATTENUATORS, RELOCATE (NON- REDIRECTIVE, NARROW), TEST LEVEL 2	EACH	2	2		
*	78000200	THERMOPLASTIC PAVEMENT MARKING - LINE 4"	FOOT	3163	3163		
* 7	78000600	THERMOPLASTIC PAVEMENT MARKING - LINE 12"	FOOT	35	35		
* 7	8004635	PREFORMED PLASTIC PAVEMENT MARKING, TYPE D - STANDARD LINE 7"	FOOT	48	48		
*	78009004	MODIFIED URETHANE PAVEMENT MARKING, TYPE D - LINE 4"	FOOT	380	380		
*	78009012	MODIFIED URETHANE PAVEMENT MARKING, TYPE D - LINE 12"	FOOT	35	35		
* 7	'8011040	GROOVING FOR RECESSED PAVEMENT MARKING 8"	FOOT	48	48		
*	78200005	GUARDRAIL REFLECTORS, TYPE A	EACH	84	84		
*	78200011	BARRIER WALL REFLECTORS, TYPE C	EACH	32	32		
			I	l	I.		

* SPECIALTY ITEM

STATE OF ILLINOIS
DEPARTMENT OF TRANSPORTATION

I-55 AT CATON FARM ROAD SUMMARY OF QUANTITIES

SCALE: N.A. SHEET 2 OF 3 SHEETS STA.

TO STA.

 F.A.I. RTE.
 SECTION
 COUNTY SHEETS
 TOTAL SHEETS
 SHEET NO.

 55
 FAI 55 22 BRIDGE REHAB
 WILL
 31
 4

 CONTRACT NO. 62R76

 ILLINOIS
 FED. AID PROJECT

				CONSTR. COD
				90% FEDERAL
				10% STATE
				BRIDGE
CODE	ITEM	UNIT	TOTAL	0059
NO.		Olvill	QUANTITY	SN 099-0210
78300200	RAISED REFLECTIVE PAVEMENT MARKER REMOVAL	EACH	12	12
78300202	PAVEMENT MARKING REMOVAL-WATER BLASTING	SQ FT	558	558
K4400503	COMBINATION CURB AND GUTTER REMOVAL AND REPLACEMENT GREATER THAN 10 FEET	FOOT	160	160
X5030250	BRIDGE DECK GROOVING (LONGITUDINAL)	SQ YD	914	914
VC700407	ENGINEEDIC FIELD OFFICE TYPE A (D4)		40	40
X6700407	ENGINEER'S FIELD OFFICE TYPE A (D1)	CAL MO	12	12
X7010216	TRAFFIC CONTROL AND PROTECTION (SPECIAL)	L SUM	1	1
X7011015	TRAFFIC CONTROL AND PROTECTION (EXPRESSWAYS)	L SUM	1	1
Z0001800	APPROACH SLAB REPAIR (PARTIAL DEPTH)	SQ YD	14	14
Z0006014	BRIDGE DECK LATEX CONCRETE OVERLAY, 2½ INCHES	SQ YD	997	997
Z0012130	BRIDGE DECK SCARIFICATION 3/4"	SQ YD	997	997
Z0012754	STRUCTURAL REPAIR OF CONCRETE (DEPTH EQUAL TO OR LESS THAN 5 INCHES)	SQ FT	166	166
Z0012755	STRUCTURAL REPAIR OF CONCRETE (DEPTH GREATER THAN 5 INCHES)	SQ FT	8	8
Z0029090	DIAMOND GRINDING (BRIDGE SECTION)	SQ YD	914	914
X72 00061	TEMPORARY INFORMATION SIGNING	SQ FT	102.8	102.8

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District Survey, Environmental and Construction Inspection Services is aw Monitor Street; Survey 1250, CHICAGO, 160003

Ph. (312) 346-1400 Fax (312)345-0529 www.ndesigni.com

PLOT DATE = 5/20/2024

STATE OF ILLINOIS
DEPARTMENT OF TRANSPORTATION

I-55 AT CATON FARM ROAD
SUMMARY OF QUANTITIES

SCALE: N.A. | SHEET 3 OF 3 SHEETS | STATE TO STATE

MAINTENANCE OF TRAFFIC GENERAL NOTES

- 1. THE MAINTENANCE OF TRAFFIC CONTROL (MOT) PLANS SHALL SERVE AS A GUIDE FOR SAFE DIVERSION OF TRAFFIC DURING EXECUTION OF THIS CONTRACT. HOWEVER, THE CONTRACTOR MAY MODIFY THE MOT PLANS TO MEET CONSTRUCTION NEEDS. BUT NOT AT THE EXPENSE OF PUBLIC SAFETY OR CONVENIENCE. ANY CHANGES TO THE MOT PLANS SHALL BE SUBMITTED TO THE ENGINEER FOR APPROVAL.
- 2. THE ENGINEER SHALL BE INFORMED 48 HOURS IN ADVANCE OF ANY PROPOSED CHANGE TO THE MOT PLANS.
- 3. CHANGEABLE MESSAGE SIGNS SHALL BE INSTALLED TWO WEEKS PRIOR TO ALL TRAFFIC STAGE CHANGES ON EACH APPROACH OF THE EFFECTED ROADWAY TO WARN MOTORISTS OF THE UPCOMING EVENT. THE SIGNS SHALL BE REMOVED TWO WEEKS THEREAFTER UNLESS THEY ARE NEEDED IN A SUBSEQUENT FUTURE EVENT THAT WILL OCCUR WITHIN TWO WEEKS ON THE SAME APPROACH OF THE AFFECTED ROADWAY. CHANGEABLE MESSAGE SIGN LOCATION SHALL BE AS DIRECTED BY THE ENGINEER.
- 4. TYPE C BI-DIRECTIONAL CRYSTAL REFLECTORS INSTALLED ON EXISTING BRIDGE PARAPET SHALL BE REMOVED AT THE CONCLUSION OF MOT OPERATIONS AT NO ADDITIONAL COST TO THE DEPARTMENT.
- 5. ALL EXISTING LANE LINE PAVEMENT MARKINGS AND RAISED REFLECTIVE PAVEMENT MARKER REFLECTORS LOCATED WITHIN THE TEMPORARY PAVEMENT MARKING TAPE USED FOR STAGING SHALL BE REMOVED VIA WATER BLASTING WITH VACUUM RECOVERY IF THE STAGING WILL REMAIN IN PLACE FOR MORE THAN 14 DAYS. THE EXISTING PAVEMENT MARKINGS AND RAISED REFLECTORS THAT WERE REMOVED SHALL BE RESTORED IN KIND AFTER THE COMPLETION OF STAGING.
- 6. TEMPORARY CONCRETE BARRIER SHALL BE INSTALLED IN ACCORDANCE WITH SECTION 704 OF THE IDOT STANDARD SPECIFICATIONS. ALL TEMPORARY CONCRETE BARRIER APPROACH AND DEPARTING END UNITS SHALL BE ANCHORED TO THE PAVEMENT USING SIX ANCHOR PINS AS SHOWN IN IDOT STANDARD 704001. PINNING OF ADDITIONAL BARRIER UNITS WITH THREE ANCHOR PINS ON THE TRAFFIC SIDE HOLES WITHIN THE INSTALLATION SHALL BE REQUIRED WHEN EQUIPMENT, VEHICLES, FIXED OBJECTS, OR DROP-OFFS ARE LOCATED WITHIN 24" BEHIND THE BARRIER. THE 24" OF CLEAR PAVEMENT MEASUREMENT SHALL BE FROM THE BASE OF THE NON-TRAFFIC SIDE OF THE BARRIER. TRAFFIC SIDE PINNED BARRIER SHALL HAVE A MINIMUM OF 6" OF CLEAR PAVEMENT BEHIND THE BARRIER. WHERE BOTH PINNED AND UNPINNED BARRIER UNITS ARE USED IN A CONTINUOUS INSTALLATION, A TRANSITION SHALL BE PROVIDED BETWEEN THEM, THE TRANSITION FROM PINNED TO UNPINNED SHALL CONSIST OF TWO ANCHOR PINS INSTALLED IN THE END HOLES ON THE TRAFFIC SIDE OF THE FIRST BARRIER REYOND THE PINNED SECTION AND ONE ANCHOR PIN INSTALLED IN THE MIDDLE HOLE OF THE TRAFFIC SIDE OF THE SECOND BARRIER BEYOND THE PINNED SECTION. THE THIRD BARRIER BEYOND THE PINNED SECTION SHALL BE UNPINNED.

DESIGNED - MGB JSER NAME = mbuiting REVISED DRAWN -MGB REVISED HECKED -REVISED nvironmental and Construction Inspection Serv E STREET, SUITE 1825, CHICAGO, IL 60603 PLOT DATE = 12/16/2024 REVISED DATE

STATE OF ILLINOIS **DEPARTMENT OF TRANSPORTATION**

SECTION COUNTY I-55 AT CATON FARM ROAD 55 FAI 55 22 BRIDGE REHAB WILL MAINTENANCE OF TRAFFIC NOTES AND CONSTRUCTION SEQUENCING CONTRACT NO. 62R76 SHEET 1 OF 1 SHEETS STA.

31

SUGGESTED MAINTENANCE OF TRAFFIC SEQUENCING - CATON FARM RD

- REMOVE PERMANENT PAVEMENT MARKINGS TO THE LIMITS SHOWN IN THE PLANS AND THE SCHEDULE OF PAVEMENT MARKING REMOVAL.
- INSTALL ALL STAGE 1 CONSTRUCTION TRAFFIC CONTROL SIGNS, DRUMS, BARRICADES, TEMPORARY CONCRETE BARRIER, TEMPORARY IMPACT ATTENUATORS, AND TEMPORARY PAVEMENT MARKINGS AS DETAILED IN STAGE 1 PLANS AND APPROPRIATE STANDARD DRAWINGS.
- SHIFT ALL TRAFFIC TO THE NORTH OF THE CENTERLINE OF SN 099-0210.
- COORDINATE WORK TO BE COMPLETED IN THIS STAGE WITH DETAILS IN THE BRIDGE PLANS.

STAGE 2


- REMOVE STAGE 1 TEMPORARY PAVEMENT MARKINGS THAT WOULD CONFLICT WITH STAGE 2 TRAFFIC MOVEMENT.
- INSTALL ALL STAGE 2 CONSTRUCTION TRAFFIC CONTROL SIGNS, DRUMS, BARRICADES, TEMPORARY CONCRETE BARRIER, TEMPORARY IMPACT ATTENUATORS, AND TEMPORARY PAVEMENT MARKINGS AS DETAILED IN STAGE 1 PLANS AND APPROPRIATE STANDARD DRAWINGS.
- SHIFT ALL TRAFFIC TO THE SOUTH OF THE CENTERLINE OF SN 099-0210.
- COORDINATE WORK TO BE COMPLETED IN THIS STAGE WITH DETAILS IN THE BRIDGE PLANS.

POST STAGE


- REMOVE ALL CONSTRUCTION TRAFFIC CONTROL AND TEMPORARY CONSTRUCTION ITEMS.
- REMOVE ANY REMAINING EXISTING TEMPORARY PAVEMENT MARKINGS WITHIN THE PERMANENT PAVEMENT MARKING LIMITS.
- INSTALL PERMANENT PAVEMENT MARKINGS

SUGGESTED MAINTENANCE OF TRAFFIC SEQUENCING - I-55

TEMPORARY SHOULDER/ LANE CLOSURES ARE REQUIRED TO PERFORM SUBSTRUCTURE REPAIRS. LANE CLOSURES ALONG I-55 SHALL BE IN ACCORDANCE WITH SPECIAL PROVISION "TRAFFIC CONTROL AND PROTECTION (EXPRESSWAYS)". LANE CLOSURES SHALL OCCUR ONLY DURING NIGHTTIME HOURS IN ACCORDANCE WITH SPECIAL PROVISION "KEEPING THE EXPRESSWAYS OPEN TO TRAFFIC".

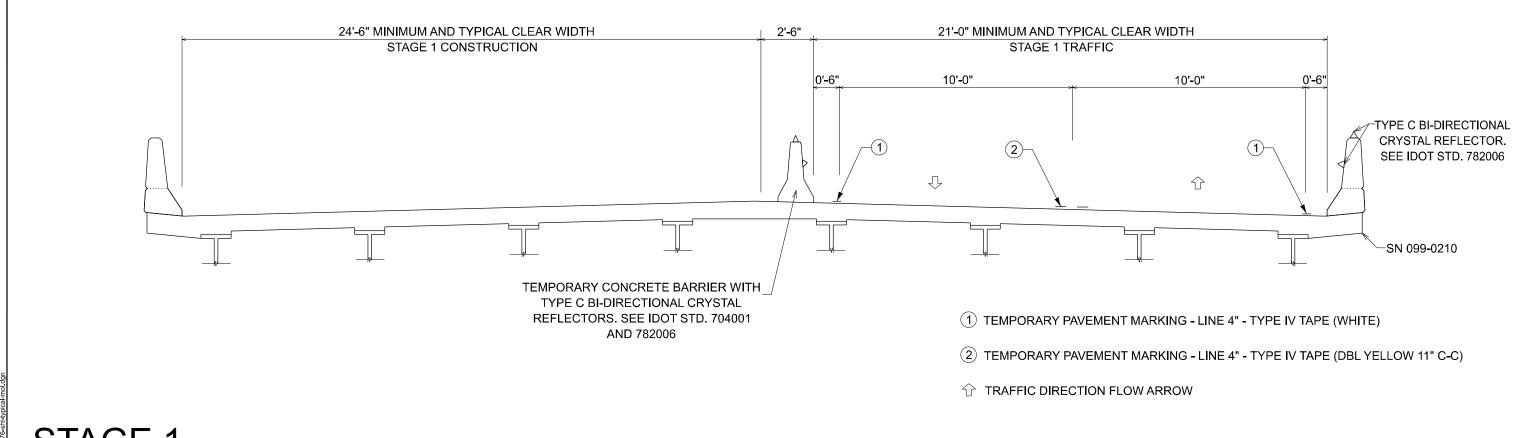

STAGE 1

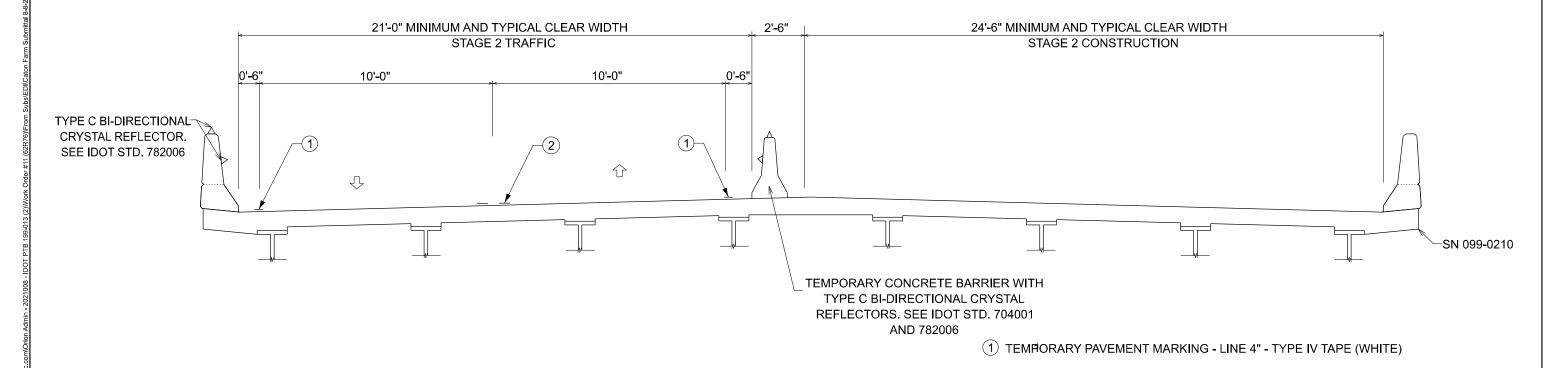

STAGE 2


D16	Excellence, Dedication, Innovation	L
EL:	Environmental Design International inc.	L
吕늬	Civil. Survey. Environmental and Construction Inspection Services	L
ΣΕ	33 W. MONROE STREET, SUITE 1825, CHICAGO, IL 60603 Ph. (312) 345-1400 Fax (312)345-0529 www.envdesigni.com	L

USER NAME = aseiber	DESIGNED - MGB	REVISED -
	DRAWN - MGB	REVISED -
	CHECKED -	REVISED -
PLOT DATE = 12/17/2024	DATE -	REVISED -

STATE OF ILLINOIS	
DEPARTMENT OF TRANSPORTATION	

ŀŝ	55 AT	CA	TON FA	RM ROA	D	F.A.I. RTE	SECT	ION		COUNTY	TOTAI SHEET
AINTENANCE OF TRAFFIC TYPICAL SECTION					55	FAI 55 22 BRIDGE REHAB			WILL	31	
	.OL 0		IVAI I IO	111102	L SECTION					CONTRACT	NO. 6
SHEET 1	OF	1	SHEETS	STA.	TO STA.			ILLINOIS	FED. AII	PROJECT	

2 TEMPORARY PAVEMENT MARKING - LINE 4" - TYPE IV TAPE (DBL YELLOW 11" C-C)

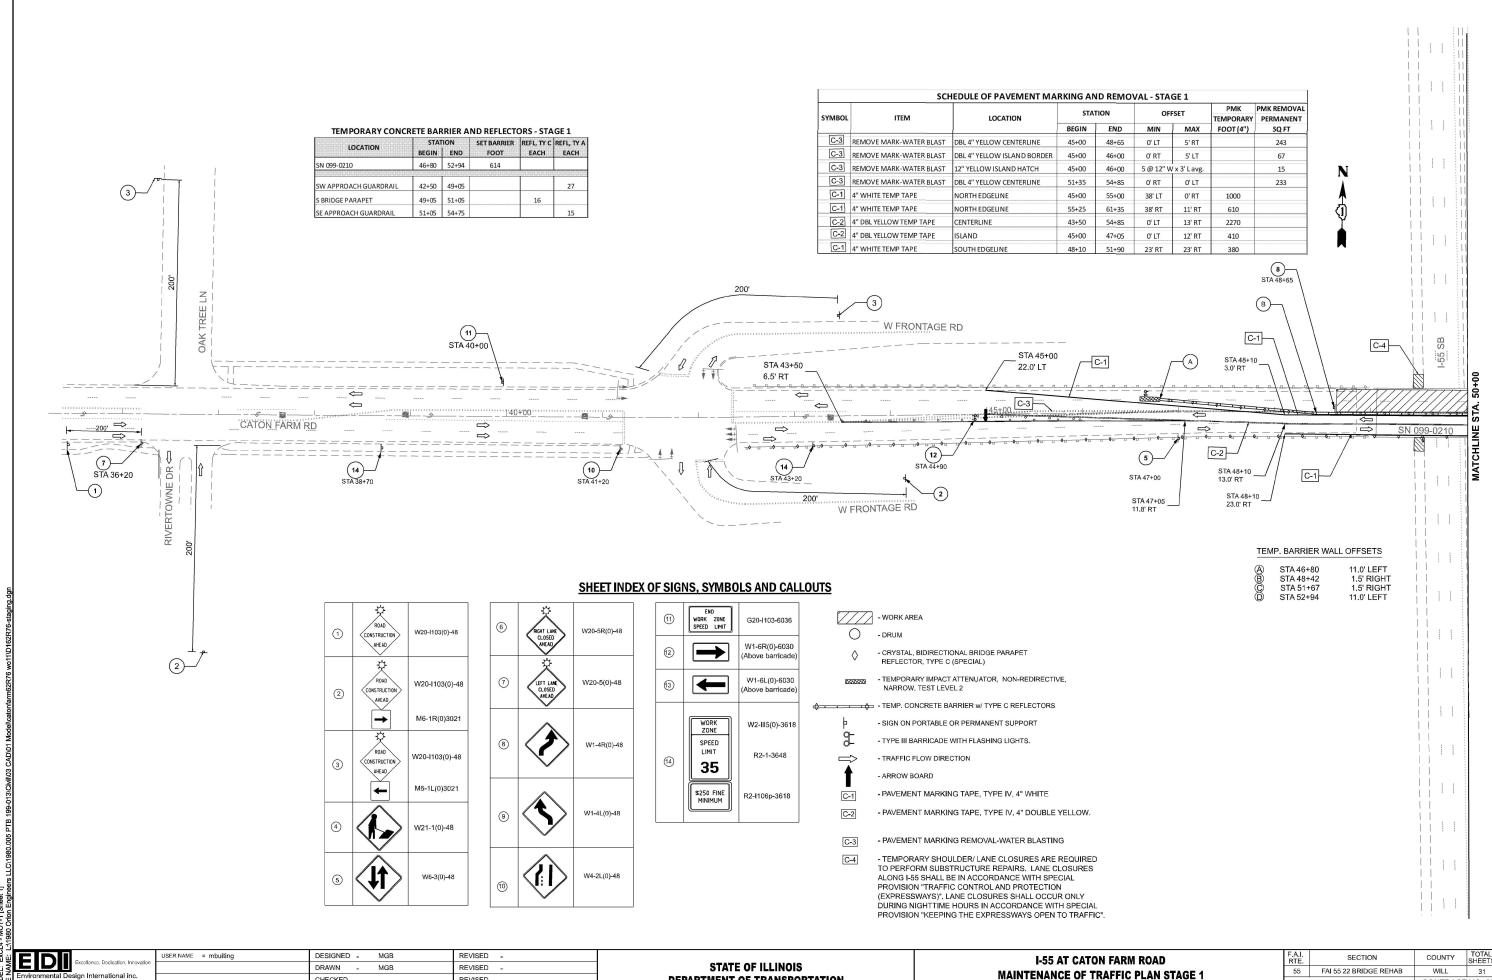


CHECKED REVISED PLOT DATE = 12/16/2024 DATE REVISED

DEPARTMENT OF TRANSPORTATION

SHEET

SCALE: 1"=50"

I-55 AT CATON FARM ROAD					F.A.I. RTE.	SECTION			COUNTY	TOTAL SHEETS	SHEET NO.		
ren/	NCF	: OF	TRAFFI	C PLAN STAG	F 1		55	FAI 55 22 BRI	DGE REI	HAB	WILL	31	8
L 147	TITOL	. 0.	IIVALLI	O I LAN OIAO	- 1						CONTRACT	NO. 62F	₹76
1	OF	2	SHEETS	STA. 31+20.00	TO STA.	50+00.00			ILLINOIS	FED. AII	PROJECT		

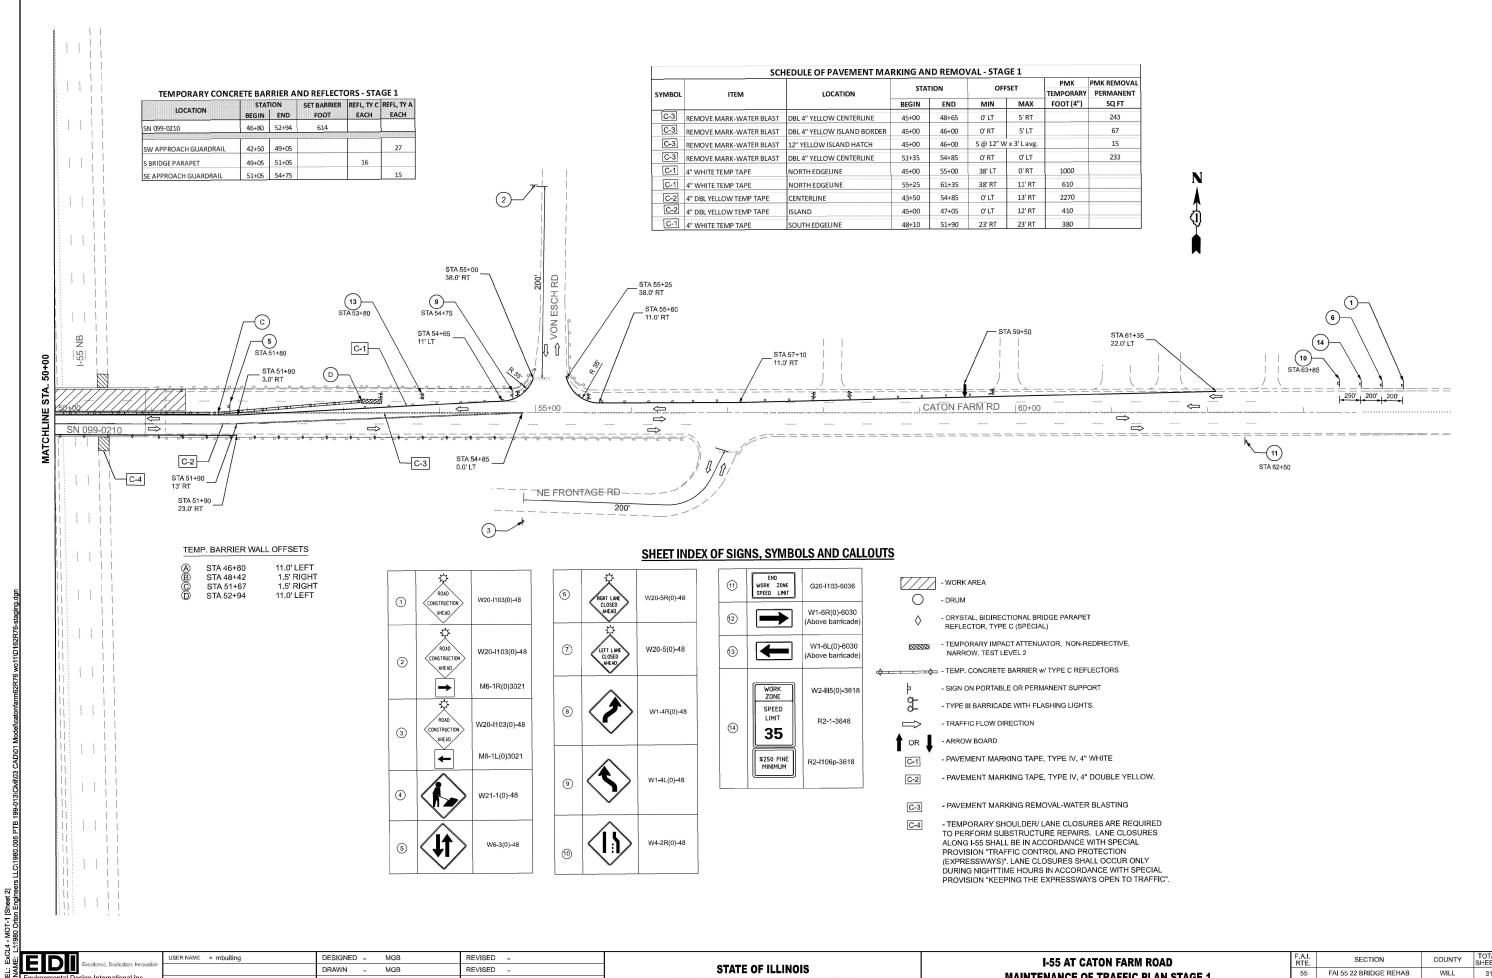


CHECKED REVISED PLOT DATE = 12/16/2024 DATE REVISED

DEPARTMENT OF TRANSPORTATION

SCALE: 1"=50"


FAI 55 22 BRIDGE REHAB WILL **MAINTENANCE OF TRAFFIC PLAN STAGE 1** CONTRACT NO. 62R76 SHEET 2 OF 2 SHEETS STA. 50+00.00 TO STA. 67+35.00

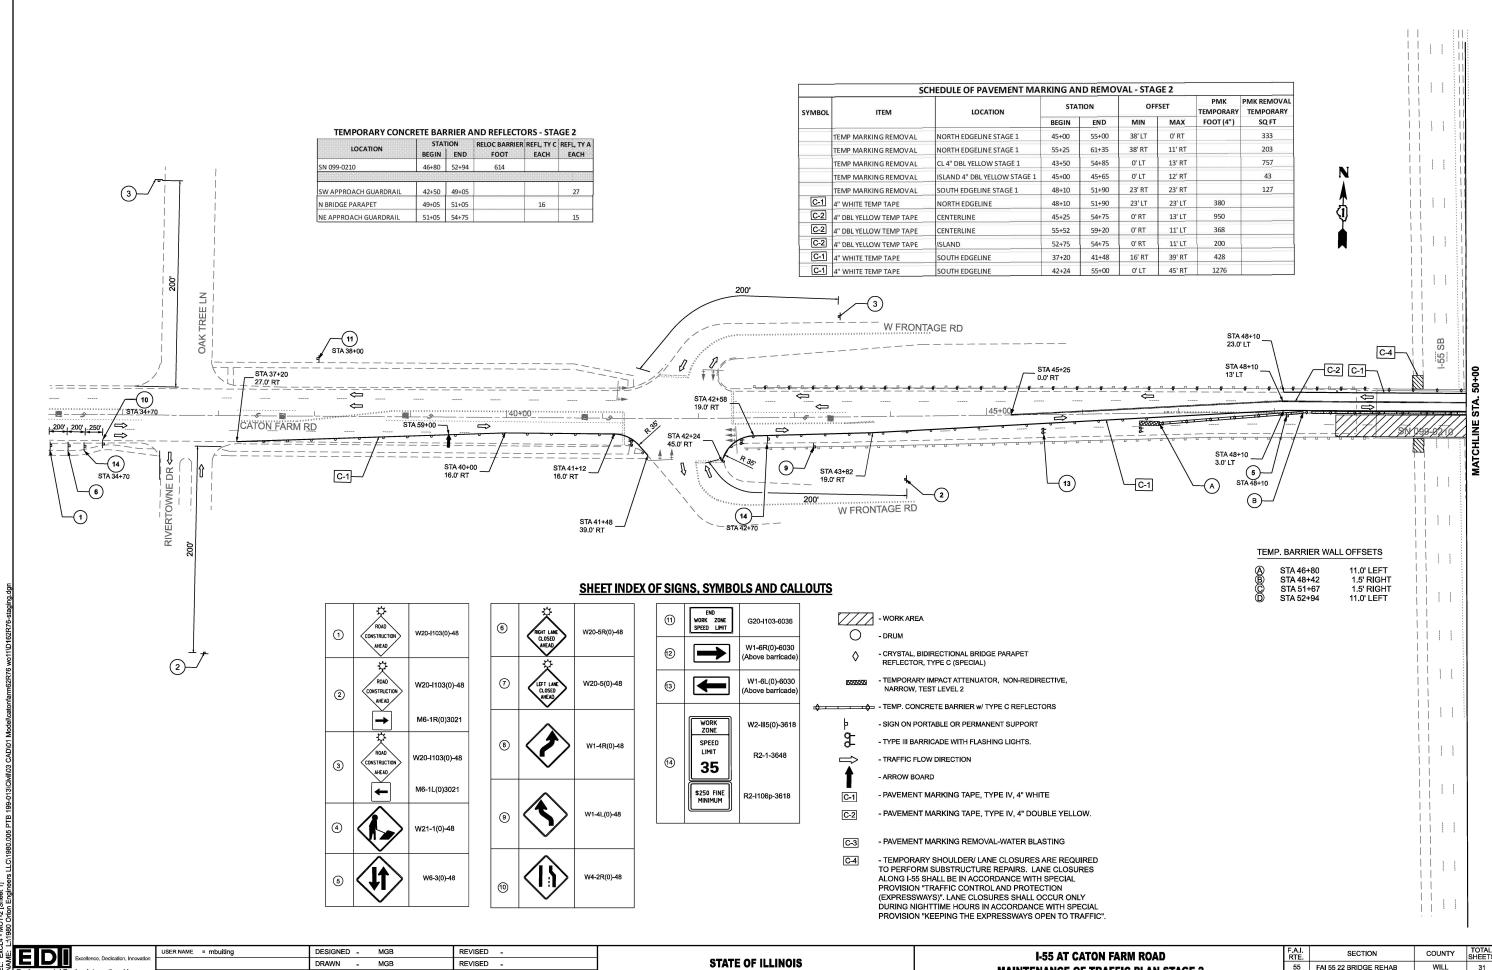

REVISED CHECKED ronmental and Construction Inspection Servi STREET, SUITE 1825, CHICAGO, IL 60603 PLOT DATE = 12/16/2024 DATE REVISED

DEPARTMENT OF TRANSPORTATION

55 FAI 55 22 BRIDGE REHAB WILL **MAINTENANCE OF TRAFFIC PLAN STAGE 2** CONTRACT NO. 62R76 SHEET 1 OF 2 SHEETS STA. 31+20.00 TO STA. 50+00.00

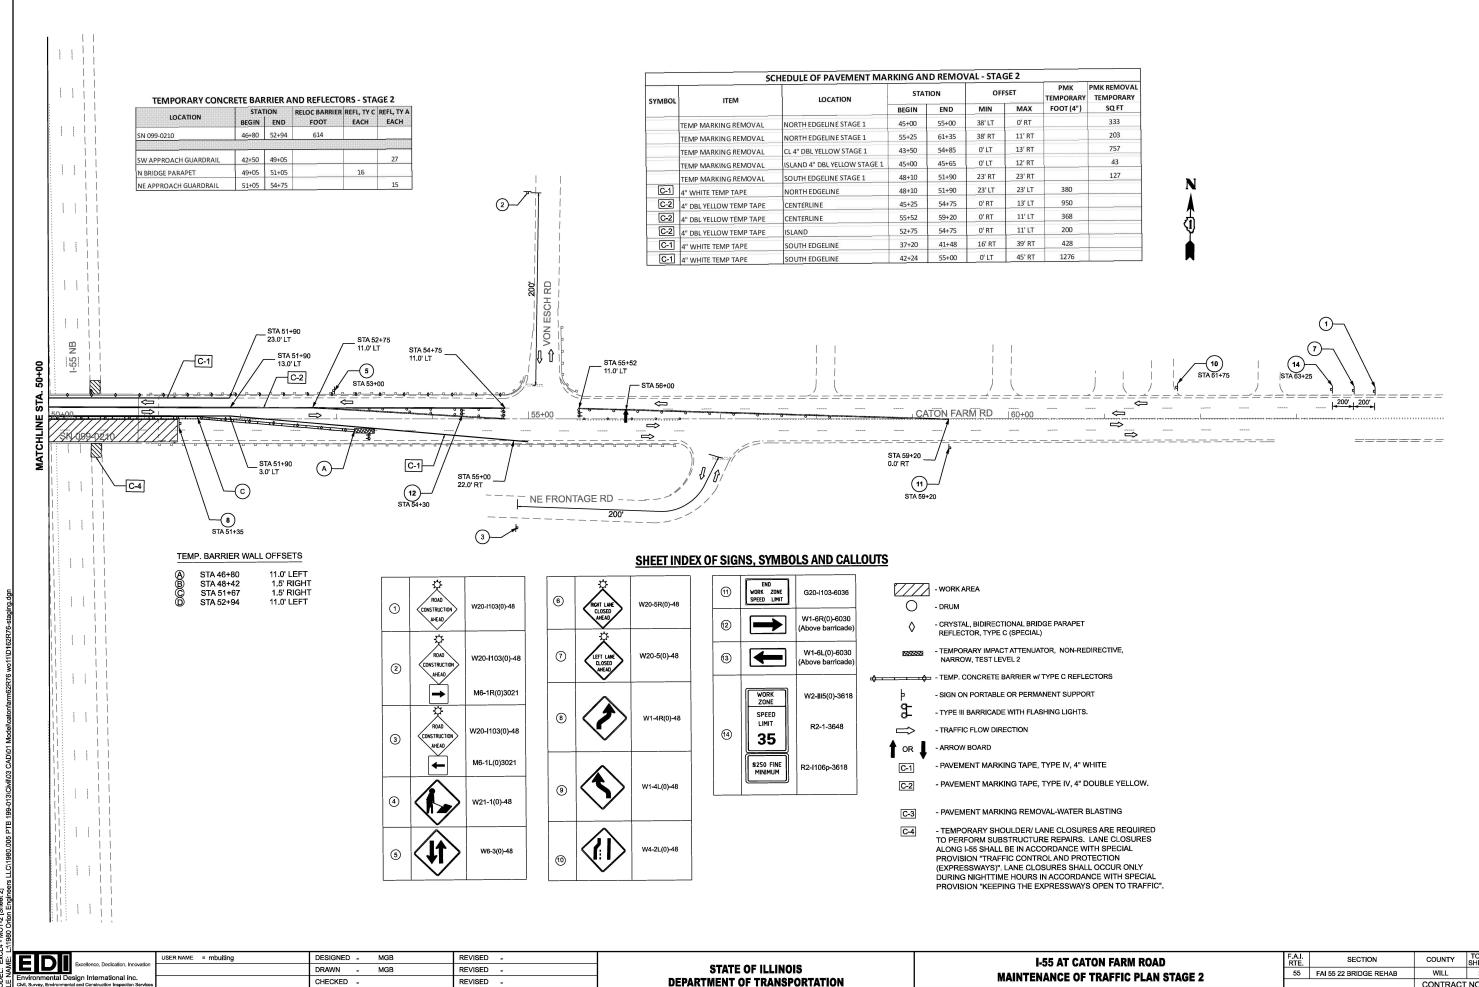

fronmental and Construction Inspection Servi STREET, SUITE 1825, CHICAGO, IL 60603

PLOT DATE = 12/16/2024


DATE


REVISED

SCALE: 1"=50"

MAINTENANCE OF TRAFFIC PLAN STAGE 2 OF SHEETS STA. 50+00.00 TO STA. 67+35.00 SHEET

55 FAI 55 22 BRIDGE REHAB WILL CONTRACT NO. 62R76

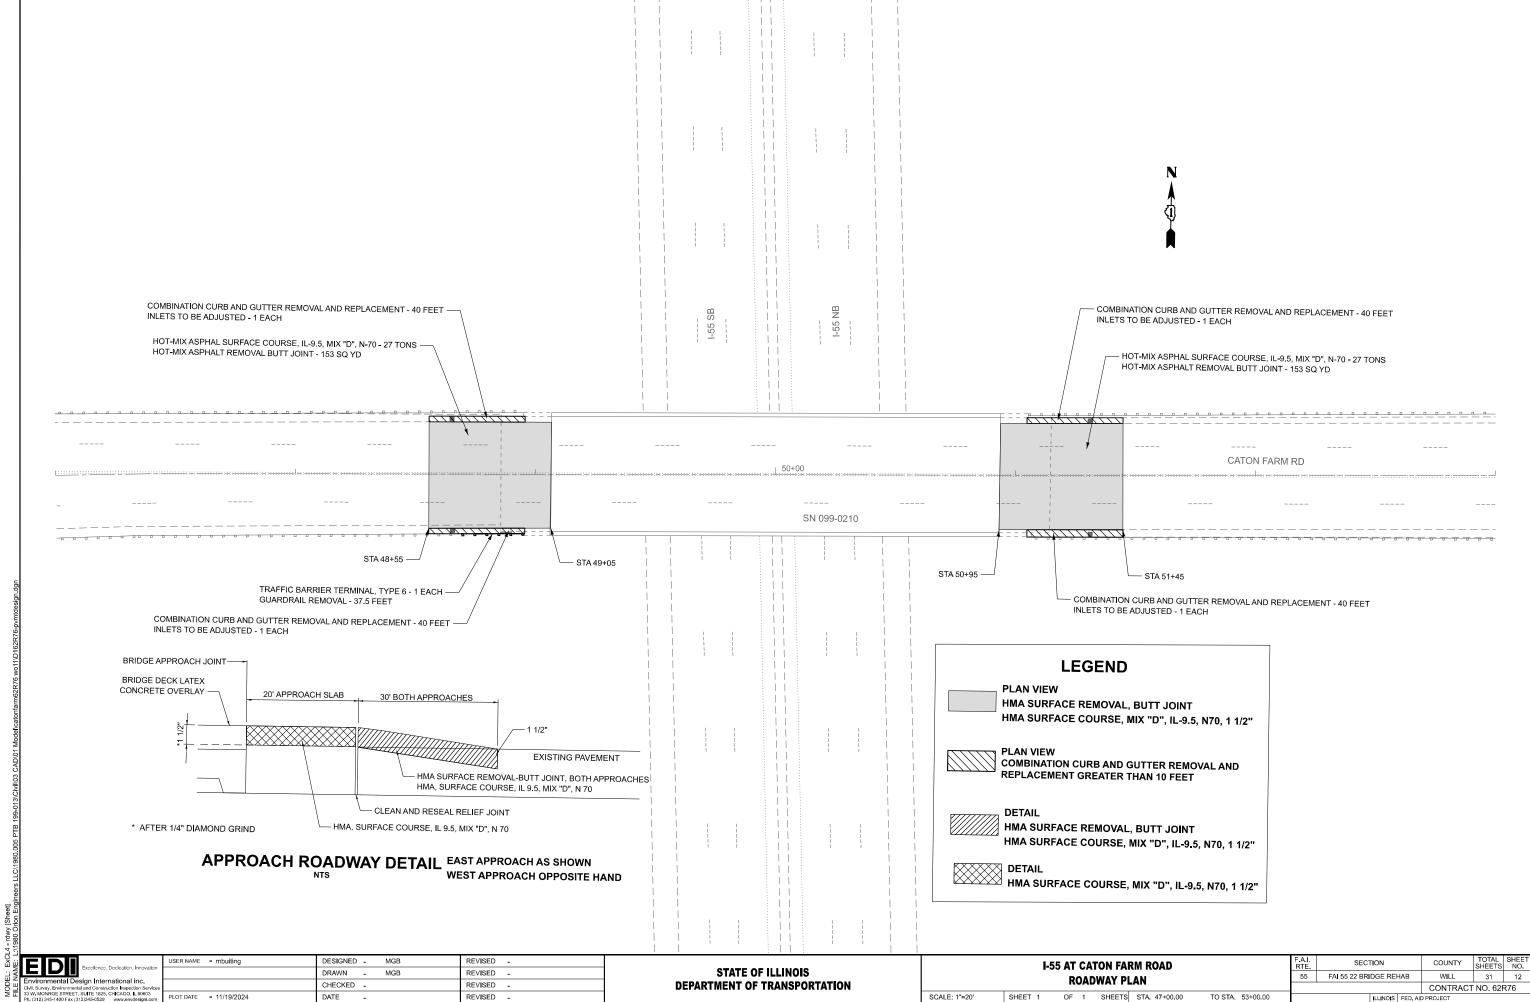

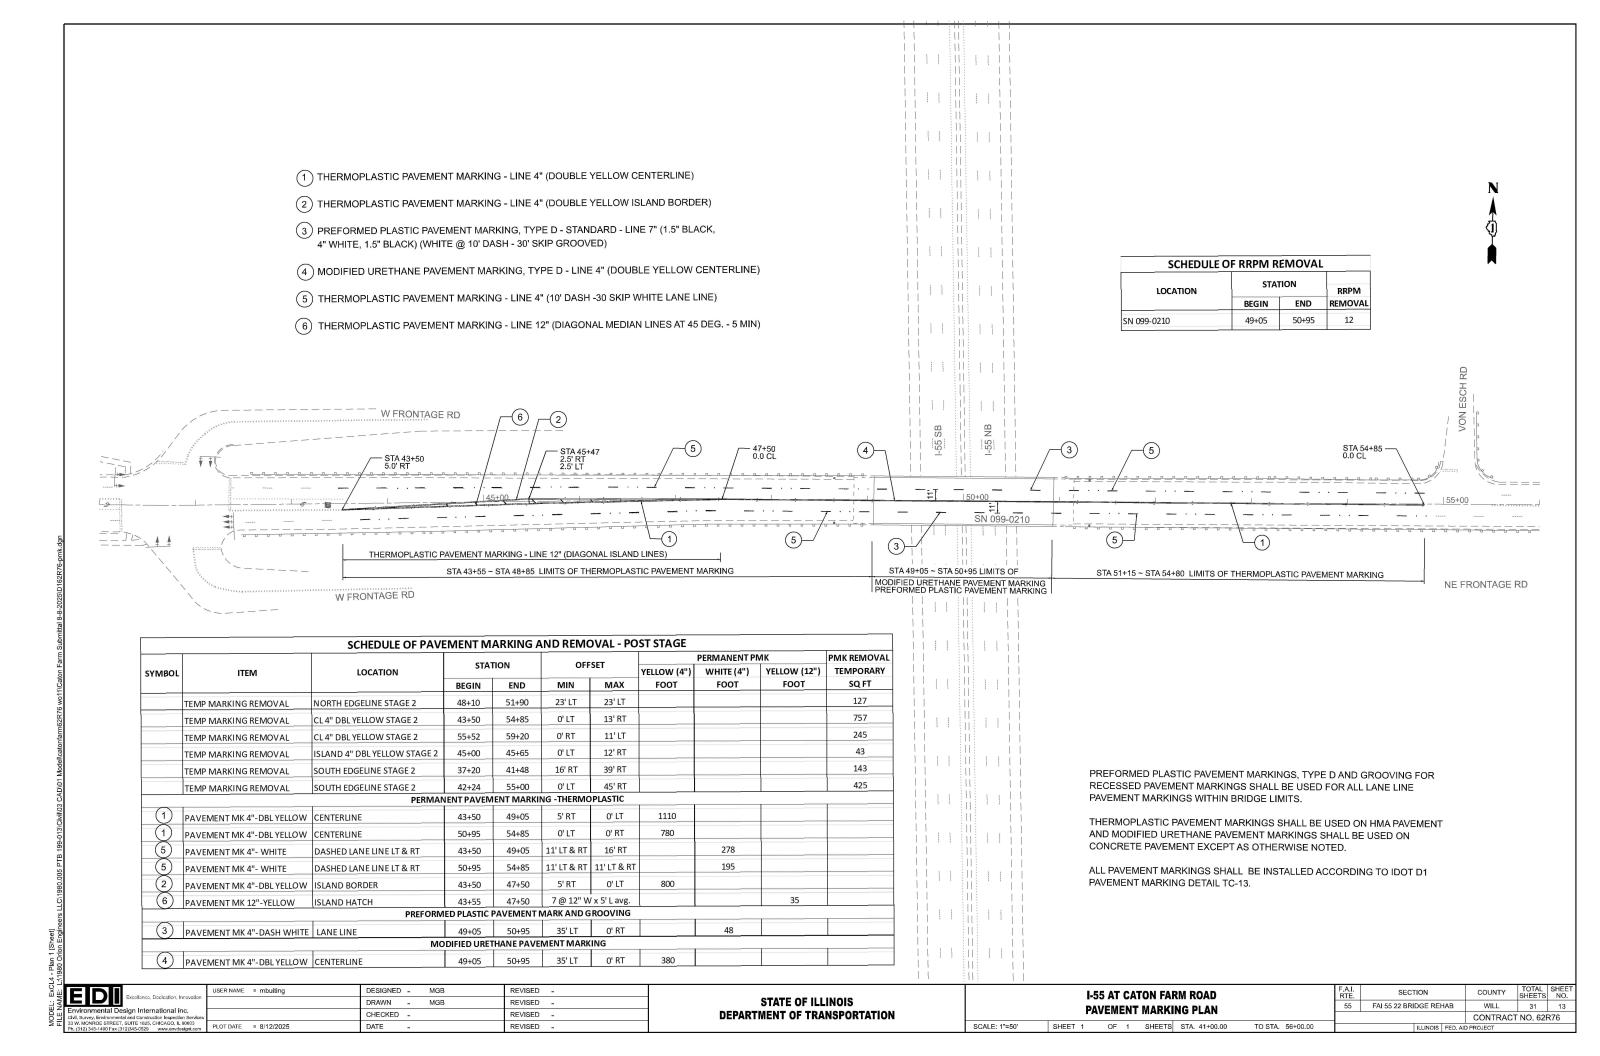

Existing Structure:

SN 099-0210 was originally constructed in 1988. The bridge consists of 4-span reinforced concrete deck on steel rolled sections. The substructure consists of reinforced concrete piers and abutments.

Traffic Control:

Stage Construction will be utilized. Two lanes of traffic shall be maintained on the north side of Canton Farm Road for Stage I construction. Two lanes of traffic shall be maintained on the south side of Caton Farm Road for Stage II construction.

No Salvage.



EXISTING CAST IN PLACE CONCRETE

f'c = 3,500 PSI (Concrete) fy = 50,000 PSI (Reinforcement)

PROPOSED CAST IN PLACE CONCRETE

f'c=4,000 psi (Superstructure) f'c=3,500 psi (Substructure) fy=60,000 psi (Reinforcement)


DESIGN SPECIFICATIONS


AASHTO LRFD Bridge Design Specifications, 17th Edition.

Illinois Department Of Transportation Bridge Manual Dated January 2025.

LOADING HS20-44

No future wearing surface allowed

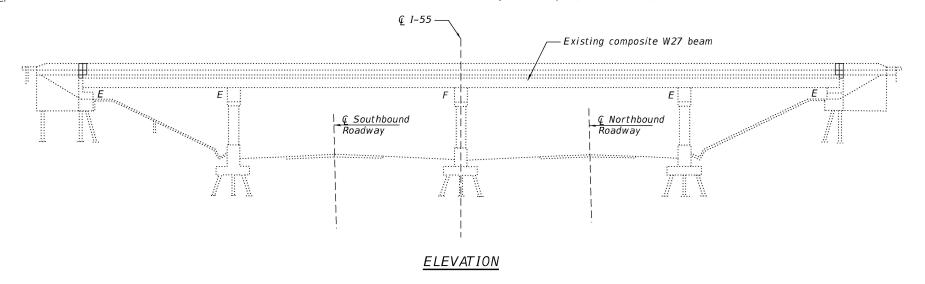

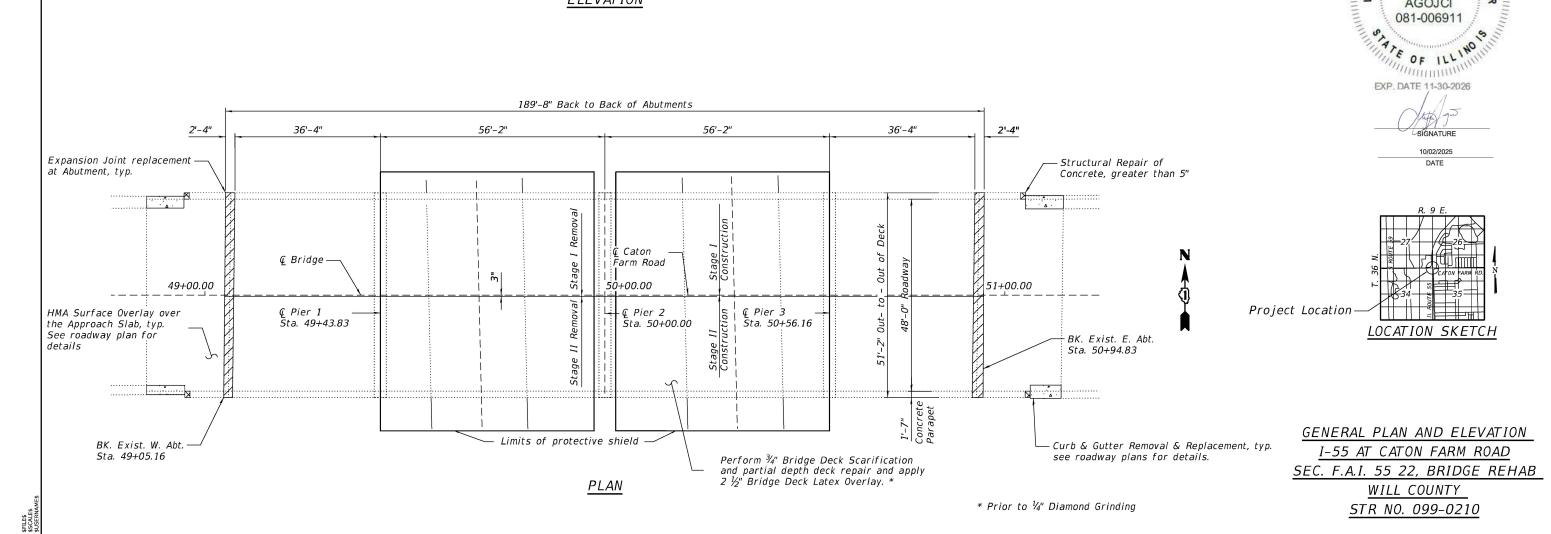

GSG CONSULTANTS, INC.
735 E. REMINISTON RD, SCHAUMBURG, IL 80773
TEL: 1630.994.2600 | WWW.GSG-CONSULTANTS.COM

 USER NAME
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 PLOT DATE
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 -11/22/2024
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STATE OF ILLINOIS
DEPARTMENT OF TRANSPORTATION

GENERAL PLAN AND ELEVATION
STRUCTURE NO. 099-0210

SCALE: 1"=24' SHEET NO. 51 OF S9 SHEETS STA. TO STA.

 F.A.I. RTE.
 SECTION
 COUNTY
 TOTAL SHEET
 SHEET NO.

 55
 F.A.I. 55 22 BRIDGE REHAB
 WILL
 31
 14

 CONTRACT NO. 62R76

 FED. ROAD DIST. NO. 1 ILLINOIS FED. AID PROJECT

TICENSTITUTE OF THE PROPERTY O

INDEX OF SHEETS

SHEET NO.	<u>DESCRIPTION</u>
51	GENERAL PLAN AND ELEVATION
52	GENERAL NOTES, INDEX OF SHEETS, BILL OF MATERIALS
<i>S3</i>	STAGE CONSTRUCTION DETAILS
54	DECK OVERLAY AND SLAB REPAIR PLANS
<i>S</i> 5	EXPANSION JOINT DETAILS
56	PREFORMED JOINT STRIP SEAL (BASE SHEET)
<i>S7</i>	ABUTMENT REPAIR DETAILS
<i>S8</i>	PIER REPAIR DETAILS
59	BAR SPLICER ASSEMBLY AND MECHANICAL SPLICER

TOTAL BILL OF MATERIAL

ITEM	UNIT	TOTAL
Concrete Removal	Cu Yd	15.0
Protective Shield	Sq Yd	162
Concrete Superstructure	Cu Yd	17.0
Protective Coat	Sq Yd	1115
Reinforcement Bars, Epoxy Coated	Pound	2580
Bar Splicers	Each	24
Preformed Joint Seal	Foot	102
Bridge Deck Grooving (Longitudinal)	Sq Yd	914
Approach Slab Repair (Partial Depth)	Sq Yd	14
Bridge Deck Latex Concrete Overlay, 2 ½ Inches	Sq Yd	997
Bridge Deck Scarification 3/4"	Sq Yd	997
Structural Repair Of Concrete (Depth Equal to or Less Than 5 Inches)	Sq Ft	166
Structural Repair Of Concrete (Depth Greater than 5")	Sq Ft	8
Diamond Grinding (Bridge Section)	Sq Yd	914

GENERAL NOTES

- 1. Plan dimensions and details relative to existing plans are subject to routine variations. The Contractor shall field verify existing dimensions and details affecting new construction and make necessary approved adjustments prior to construction or ordering of materials. Such variations shall not be cause for additional compensation for a change in scope of the work, however, the Contractor will be paid for the quantity actually furnished based upon the unit price bid for the work.
- 2. Existing reinforcement bars extending into the removal area shall be cleaned, straightened and incorporated into the new construction. Any reinforcement bars that are damaged during concrete removal shall be replaced with an approved bar splicer or anchorage system. Cost included with Concrete Removal.
- 3. Reinforcement bars designated "(E)" shall be epoxy coated.
- 4. Reinforcement bar bending details shall be in accordance with the latest "Manual of Standard Practice for Detailing Reinforced Concrete Structures, ACI 315".
- 5. Reinforcement bar bending dimensions are out to out.
- 6. Contractor shall not scale dimensions from the Contract Plans for construction purposes. Scales shown are for information only.
- 7. No construction joints except those shown on the plans shall be allowed unless approved by the Engineer.
- 8. No concrete cutting shall be permitted until the cutting limits have been outlined by the Contractor and approved by the Engineer.
- 9. Joint openings shall be adjusted according with Article 520.04 of the Standard Specs, when the deck is poured at an ambient temperature other than 50°F.


SCOPE OF WORK

- To be completed under stage construction:
- 1. Install Protective Shield over lane and shoulders of I-55.
- 2. Perform 3/4" Bridge Deck Scarification.
- 3. Reconstruct bridge deck expansion joints at the Abutments with preformed joint strip seal.
- 4. Perform Structural Repair on approach concrete barriers.
- 5. Perform partial depth deck patching as required and, apply $2\frac{1}{2}$ Bridge Deck Latex Overlay and perform Bridge Deck Grooving, and diamond grinding.
- 6. Apply Protective Coat to the existing parapet concrete and to new concrete overlay.
- 7. Perform Structural Repair on Abutments and Piers 1 & 3.


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	DRAWN - AAA	REVISED -
PLOT SCALE =	CHECKED - KZ	REVISED -
PLOT DATE =	DATE - ·11/22/2024	REVISED -

SCALE: ·


GENERAL NOTES, INDEX OF SHEETS AND BILL OF MATERIALS					F.A.I. RTE	SECT	10N	COUNTY	TOTAL SHEETS	
					5-5	F.A.I. 55 22 BF	RIDGE REHAB	WILL	31	1.5
STRUCTURE NO. 099-0210							CONTRACT	NO. 6	2R76	
	SHEET NO. S2 OF S9 SHEETS	STA ·	TO STA		EED D	OAD DIST NO. 1	ILLIMOIS FED AL	D DROIECT		

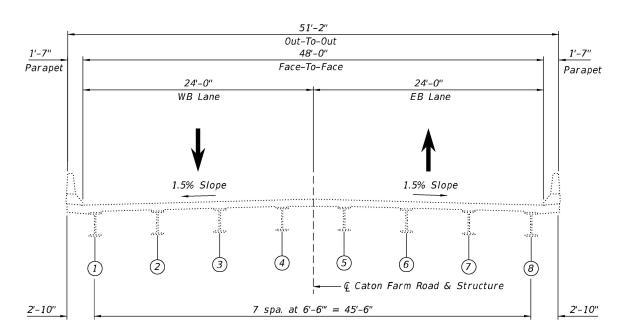

EXISTING (Looking East)

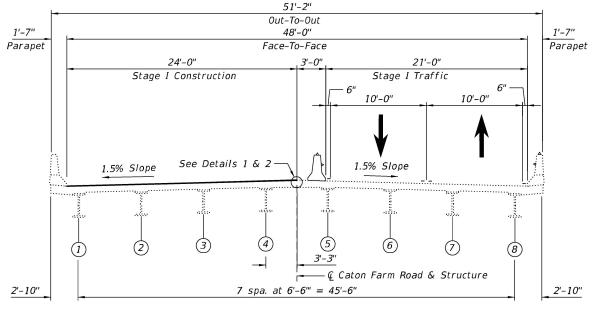

STAGE I
(Looking East)

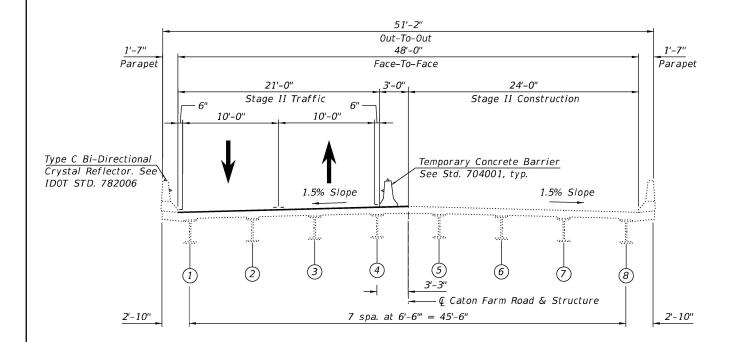

DETAIL 2 (SHOWING PROPOSED)


* Prior to 1/4" Diamond Grinding

ℚ Roadway —

- Stage Construction Line

Bridge Deck Latex

Overlay 2½" */

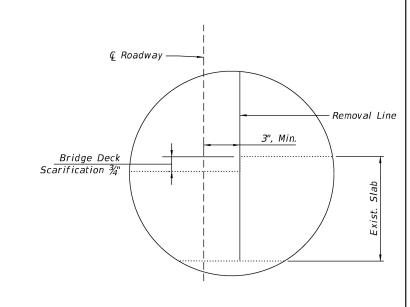

DETAIL 1 (SHOWING REMOVAL)




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PLOT DATE =	DATE - 11/22/2024	REVISED -

STAGE II (Looking East)

STATE OF ILLINOIS DEPARTMENT OF TRANSPORTATION

STAGE CONSTRUCTION DETAILS	F.A.I. RTE.	SECTION	COUNTY	TOTAL SHEETS	SHEET NO.
STRUCTURE NO. 099-0210	55	F.A.I. 55 22 BRIDGE REHAB	WILL	30	16
31NOCIONE NO. 033-0210			CONTRACT	NO. 6	2R76
SCALE: 1"■10" SHEET NO. S3 OF S9 SHEETS STA. TO STA.	FED. R	OAD DIST, NO. 1 ILLINOIS FED, A	D PROJECT		

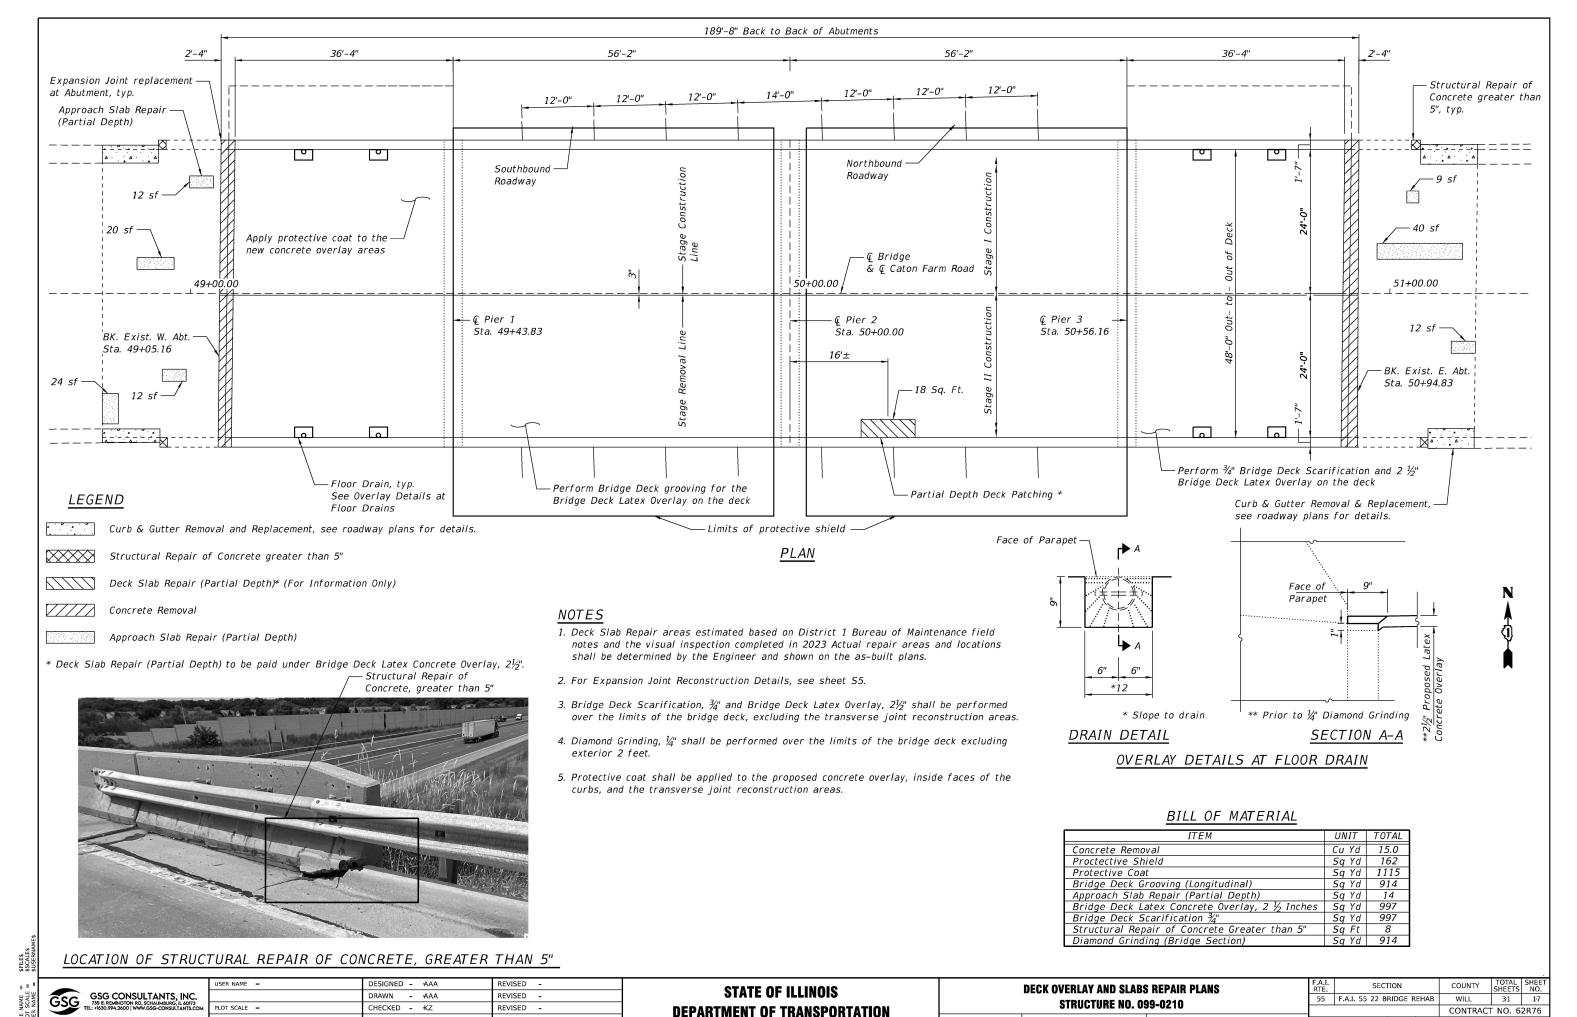



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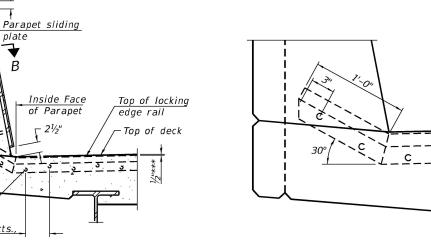
STATE OF ILLINOIS DEPARTMENT OF TRANSPORTATION


SCALE: 1"=16'

	DECK OVERLAY AND SLABS REPAIR PLANS STRUCTURE NO. 099-0210						SEC	TION		COUNTY	TOTAL SHEETS	SI
							F.A.I. 55 22 B	RIDGE R	EHAB	WILL	31	Г
	31KUC1UKE NU. U33-UZ1U									CONTRAC	T NO. 6	2F
	SHEET NO. S4 OF S9 SHEETS	STA.		TO STA.		FED. R	OAD DIST, NO. 1	ILLINOIS	FED. AI	ID PROJECT		




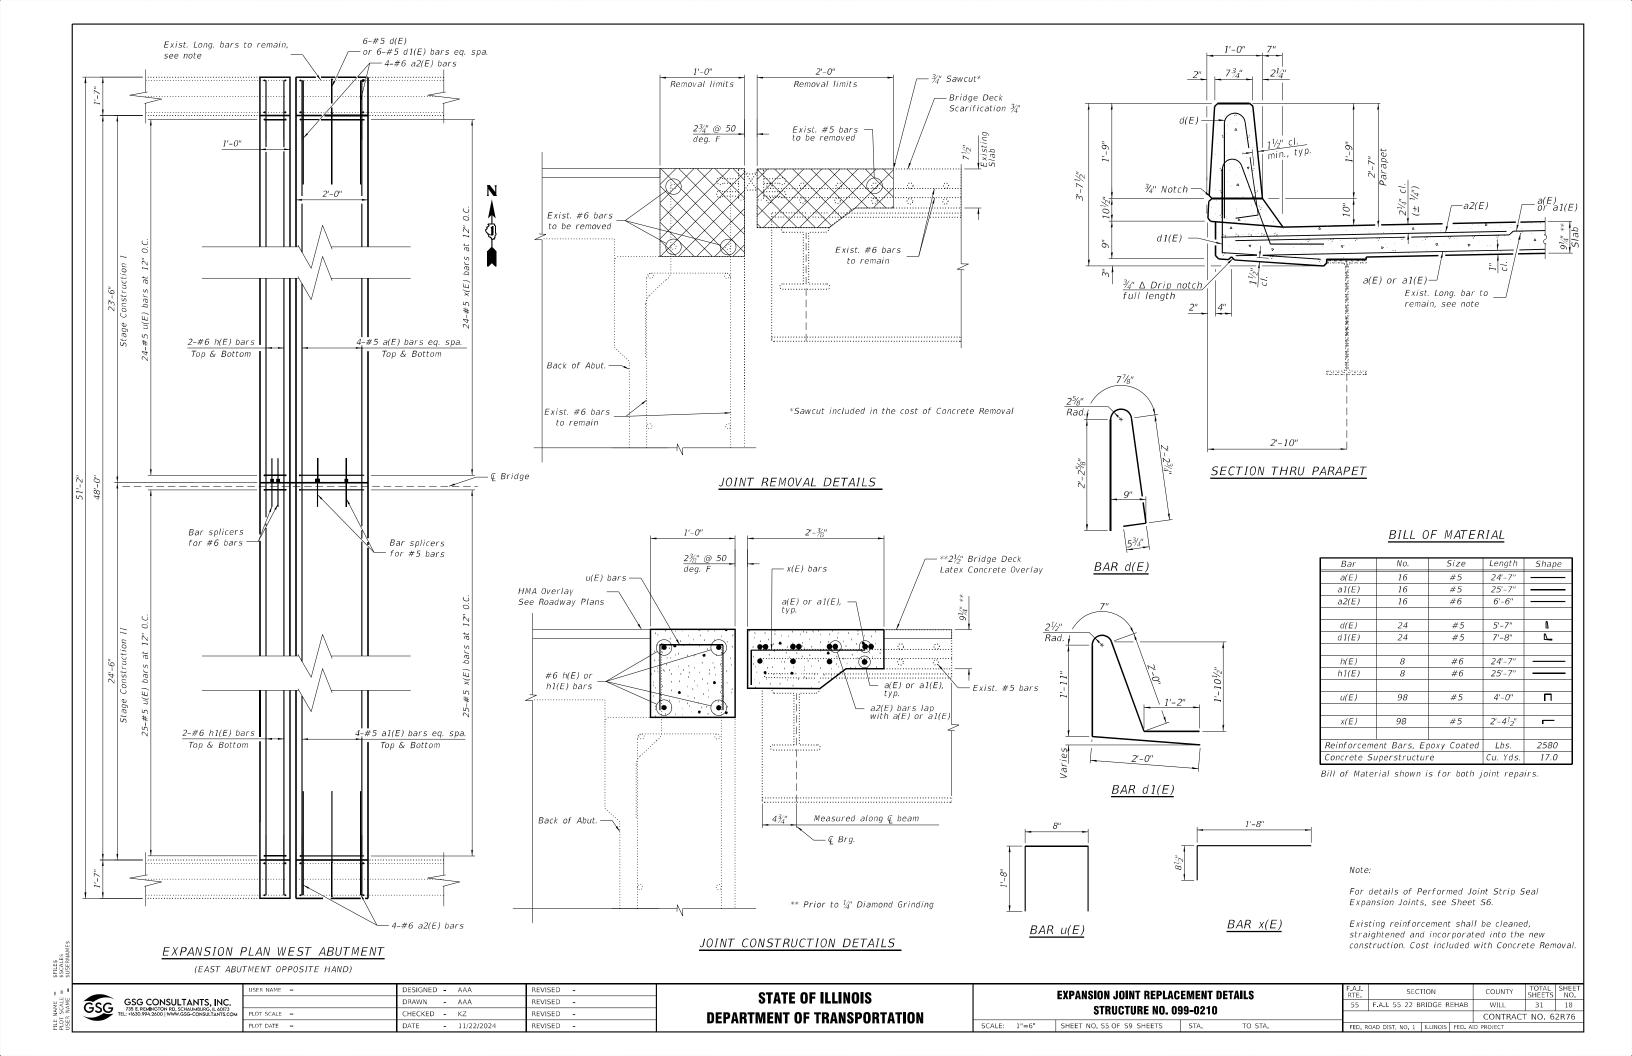

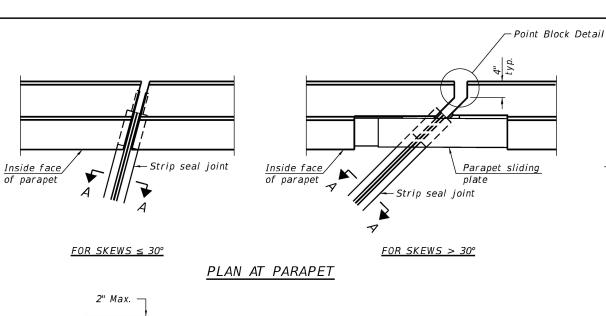

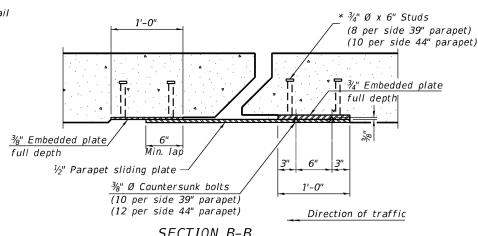

SECTION B-B

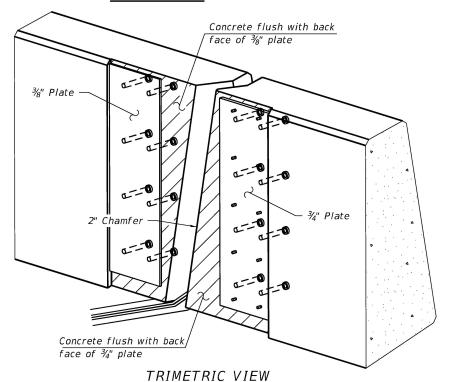

Notes:

The strip seal shall be made continuous and shall have a minimum thickness of $\frac{1}{4}$ ". The configuration of the strip seal shall match the configuration of the locking edge rails. Open or "webbed" strip seal gland configurations are not permitted. The gland shall be sized for a maximum rated movement of 4 inches.

The locking edge rails depicted are configured for typical applications and are conceptual only. The actual configuration of the locking edge rails and matching strip seal may vary from manufacturer to manufacturer provided they fit the application and meet the minimum anchorage shown. Flanged edge rails, however, will not be allowed. Locking edge rails may exceed the 4½" maximum depth provided the anchorage system is revised according to the manufacturer's recommendation.

The manufacturer's recommended installation methods shall be followed.

All steel components shall be galvanized after fabrication according to Article 520.03 of the Standard Specifications.


The Maximum space between locking edge rail segments shall be $\frac{3}{16}$ and sealed with a suitable sealant; however, any rail joint within 10' measured perpendicular to the face of the curb or parapet shall be welded as shown in the locking edge rail splice detail.

Cost of parapet sliding plates, embedded plates, and anchorage studs included with Preformed Joint Strip Seal. 39" constant slope barrier shown, 44" constant slope barrier similar as noted.

The concrete opening below the strip seal will vary based on the locking edge rail chosen by the Contractor. Deck and parapet lengths shown elsewhere in the plans are dimensioned to the concrete opening, not the joint opening, and are based on the rolled locking edge rail. If the Contractor elects to use a different locking edge rail, dimensional adjustments may be required. One exception to this would be the strip seal joint at the end of the precast bridge approach slab. For these cases the pavement connector length shall be adjusted, not the length of the bridge approach slab.


SECTION AT PARAPET

(Skews > 30° shown. Skews ≤ 30° similar except as shown in plan view.)

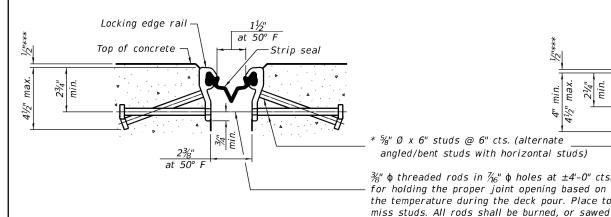


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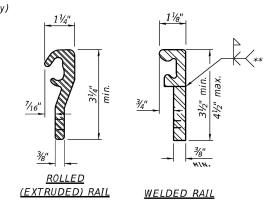
SHOWING ROLLED RAIL JOINT

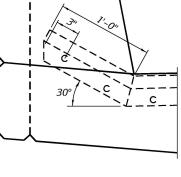

DETAIL A

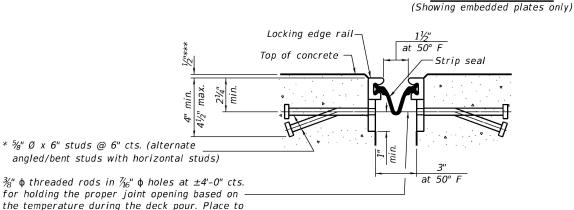


SHOWING WELDED RAIL JOINT



LOCKING EDGE RAILS

** Back gouge not required if complete joint penetration is verified by mock-up.

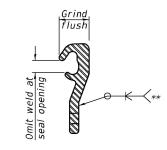

LOCKING EDGE RAIL SPLICE

The inside of the locking edge rail groove shall be free of weld residue. Rolled rail shown, welded rail similar.

BILL OF MATERIAL

Item	Unit	Total
Preformed Joint Strip Seal	Foot	102

SECTION A-A

* Granular or solid flux filled headed studs conforming to Article 1006.32 of the Std. Specs., automatically end welded.

off flush with the plates after concrete is set.

*** Prior to 1/4" Diamond Grinding

GSG CONSULTANTS, INC. GSG

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STATE OF ILLINOIS DEPARTMENT OF TRANSPORTATION

PI	PREFORMED JOINT STRIP SEAL (BASE SHEET) Structure no. 099-0210								
	SHEET NO. S6 OF S9 SHEETS	STA.	TO STA.						


SCALE:

F.A.I. RTE.	SEC	ΓΙΟΝ		COUNTY	TOTAL SHEETS	SHEET NO.
55	F.A.I. 55 22 B	RIDGE R	EHAB	WILL	30	19
			CONTRACT	NO. 6	2R76	
FED, R	OAD DIST, NO. 1	ILLINOIS	FED. A	D PROJECT		


EJ-SS

Detail A

%" Ø x 6" Studs

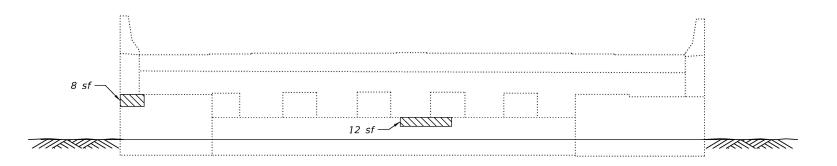

WEST ABUTMENT Looking East

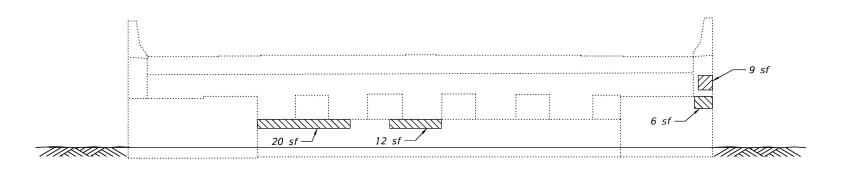

EAST ABUTMENT Looking West

LEGEND


Structural Repair of Concrete less than 5 Inches


TOTAL BILL OF MATERIAL

ITEM	UNIT	TOTAL
Structural Repair of Concrete (Depth Equal to or Less than 5 Inches)	Sq Ft	67

USER NAME =	DESIGNED - AAA	REVISED -
	DRAWN - AAA	REVISED -
PLOT SCALE	CHECKED - KZ	REVISED -
PLOT DATE =	DATE - 11/22/2024	REVISED -

	F.A.I. RTE.	SEC	CTION			
	55	F.A.I. 55 22 B	RIDGE RI			
SCALE: 1"=16"	SHEET NO. S7 OF S9 SHEETS	STA.	TO STA.	FED. F	OAD DIST, NO. 1	ILLINOIS

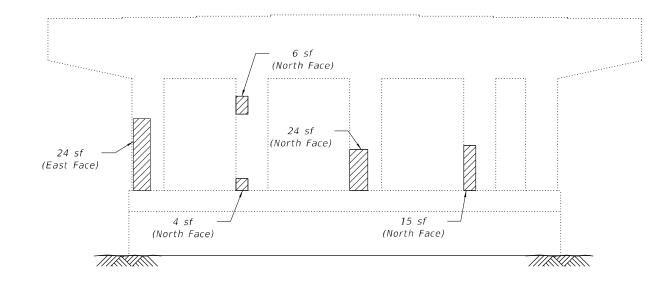

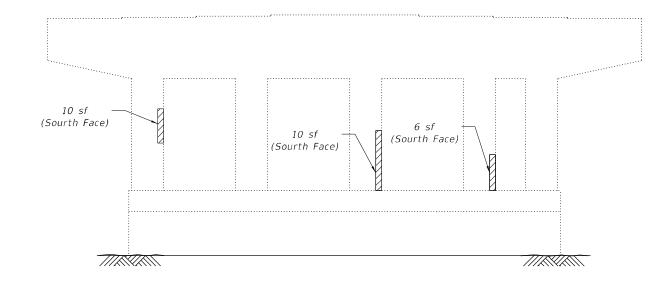

<u>PIER 1</u> West Elevation <u>PIER 3</u> West Elevation

<u>LEGEND</u>

Structural Repair of Concrete less than 5 Inches


TOTAL BILL OF MATERIAL

ITEM	UNIT	TOTAL	
Structural Repair of Concrete (Depth Equal to or Less than	5 Inches	Sq Ft	99



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PLOT DATE	DATE - 11/22/2024	REVISED -

		PIER REPAIR DE	F.A.I. RTE	SECTION	COUNTY	TOTAL SHEETS	SHEET NO.		
		STRUCTURE NO. 09	55	F.A.I. 55 22 BRIDGE REHAB	WILL	28	21		
		SINUCIUNE NO. US)3-UZ IU				CONTRAC	T NO. 6	2R76
SCALE:	SCALE: N/A SHEET NO. S8 OF S9 SHEETS STA. TO STA.					ROAD DIST. NO. 1 ILLINOIS FED. A	ID PROJECT		

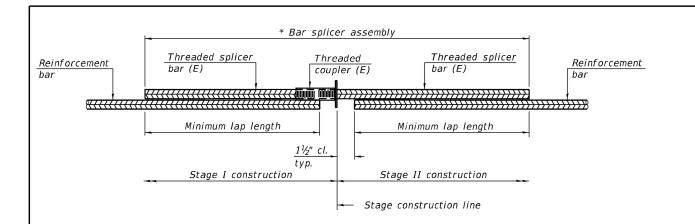


STANDARD BAR SPLICER ASSEMBLY PLAN (All components shall be provided from one supplier)

Threaded splicer bar length = min. lap length + $1\frac{1}{2}$ " + thread length

* Epoxy not required on Bar Splicer Assembly components used in conjunction with black bars.


Location	Bar size	No. assemblies required	Minimum Iap length
Deck	#5	16	3'-4"
Abutment	#6	8	4'-0"

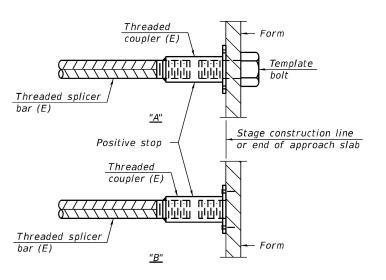

INSTALLATION AND SETTING METHODS

"A": Set bar splicer assembly by means of a template bolt.
"B": Set bar splicer assembly by nailing to wood forms or cementing to steel forms.

(E): Indicates epoxy coating.

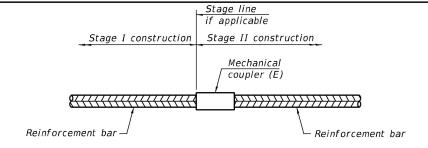

STANDARD MECHANICAL SPLICER

Location	Bar size	No. assemblies required

Notes:

Splicer bars shall be deformed with threaded ends and have a minimum 60 ksi yield strength.

All reinforcement shall be lapped and tied to the splicer bars.

Bar splicer assemblies shall be epoxy coated according to the requirements for reinforcement bars. See Section 508 of the Standard Specifications.

See approved list of bar splicer assemblies and mechanical splicers for alternatives.


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I	BAR SPLICER ASSEMBLY AND MEC	HANICAL SPLICER DETAILS	F.A.I. RTE.	SECTION	COUNTY	TOTAL SHEETS	SHEET NO.
I	STRUCTURE NO.	55	F.A.I. 55 22 BRIDGE REHAB	WILL	30	22	
ļ	JINUGIUNE NU.			CONTRAC	T NO. 6	2R76	
ı	SCALE: 1"=2" SHEET NO. S9 OF S9 SHEETS STA. TO STA.			OAD DIST, NO. 1 ILLINOIS FED. A	D PROJECT		




- 💥 3" (75) MINIMUM FROM TOP AND BOTTOM OF THE CONCRETE PAVEMENT OR BASE COURSE.

CURB OR CURB AND GUTTER REMOVAL AND REPLACEMENT

ALL DIMENSIONS ARE IN INCHES (MILLIMETERS) UNLESS OTHERWISE SHOWN.

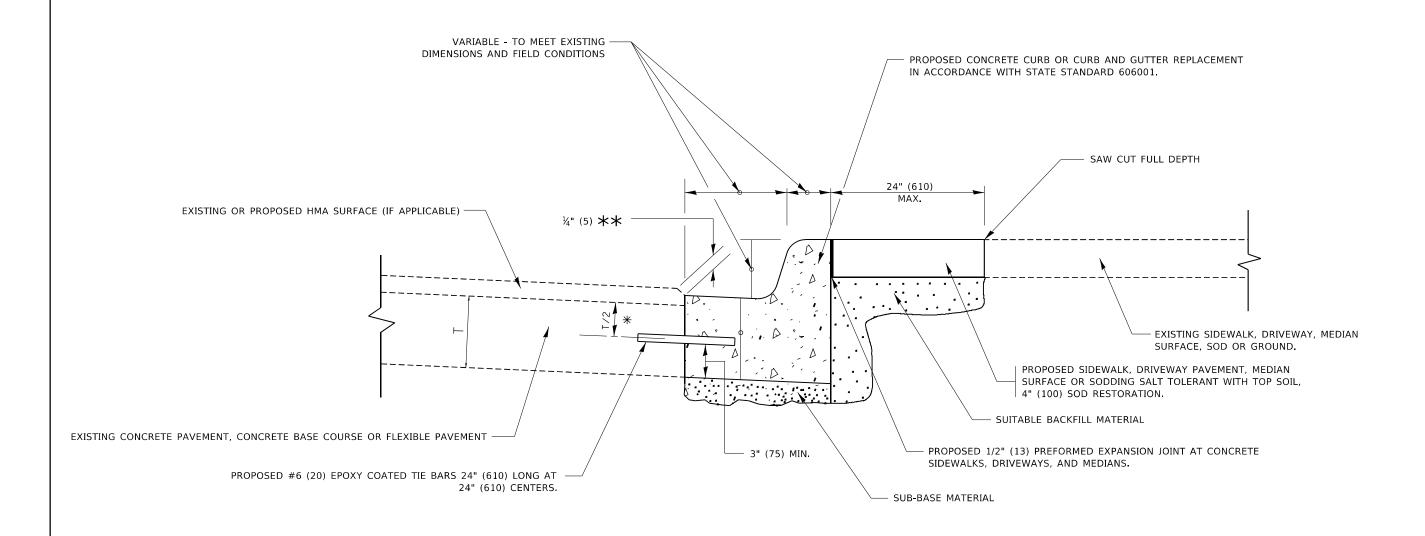
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	DRAWN -	REVISED - M. GOMEZ 01-22-01	STATE OF ILLINOIS		REMOVAL AND REPLACEMENT	55	FAI 55 22 BRIDGE REHAB	WILL	31	23
PLOT SCALE = 50.0000 / in.	CHECKED -	REVISED - R. BORO 12-15-09	DEPARTMENT OF TRANSPORTATION		NEWOVAL AND NEPLACEMENT	к	3D600-06 (BD-24)	CONTRACT	T NO.	62R76
PLOT DATE = 7/11/2019	DATE - 03-11-94	REVISED - K. SMITH 07-11-19		SCALE: NONE	SHEET 1 OF 1 SHEETS STA. TO STA.		ILLINOIS FED AI	D PROJECT		

019 1:53:

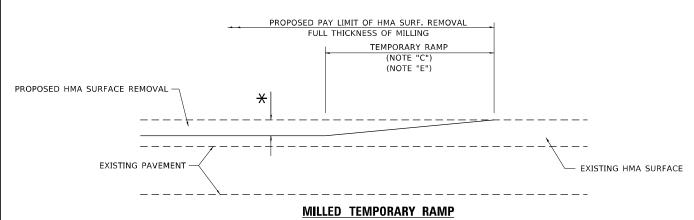

(FOR BUTT JOINT AND HMA TAPER SEE DETAIL BELOW)

OPTION 1

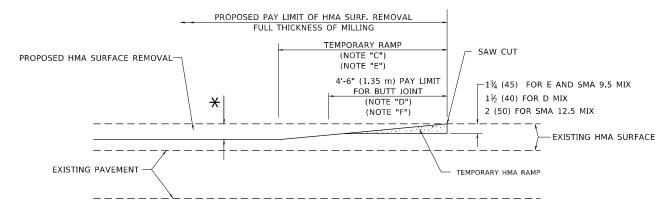


HMA CONSTRUCTED TEMPORARY RAMP

(FOR BUTT JOINT AND HMA TAPER SEE DETAIL BELOW)


OPTION 2


TYPICAL TEMPORARY RAMP

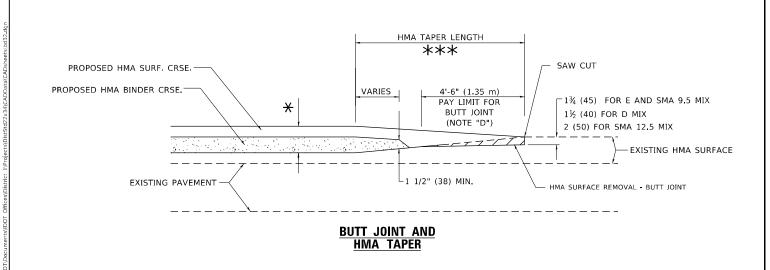

TYPICAL BUTT JOINT AND HMA TAPER FOR MILLING AND RESURFACING

STATE OF ILLINOIS DEPARTMENT OF TRANSPORTATION

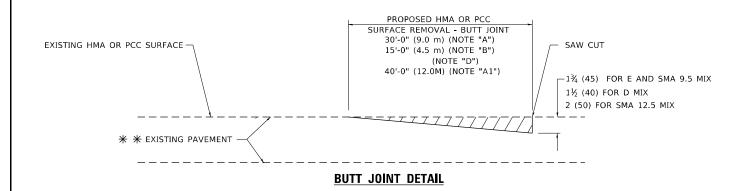

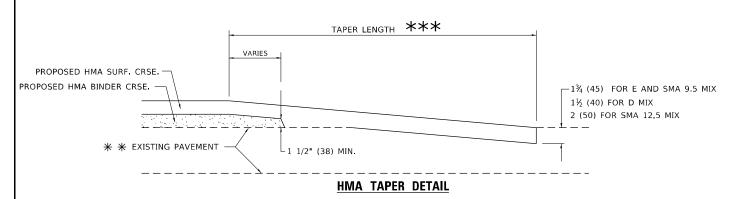

TYPICAL BUTT JOINT AND HMA TAPER FOR RESURFACING ONLY

** PC CONCRETE, HMA OR HMA RESURFACED PAVEMENT.

GENERAL NOTES


- A. MAINLINE ARTERIAL ROADWAYS AND MAJOR SIDE ROADS.
- A1. INTERSTATES
- B. MINOR SIDE ROADS.
- C. THE TEMP. RAMP SHALL BE CONSTRUCTED IMMEDIATELY UPON REMOVAL OF THE EXISTING HMA SURFACE.
- D. THE BUTT JOINT SHALL BE CONSTRUCTED IMMEDIATELY PRIOR TO PLACING THE PROPOSED HMA COURSES.
- E. TAPER THE TEMP. RAMP AT A RATE OF 3' 4" (1.02m) PER 1 INCH (25 mm) OF MILLING THICKNESS.
 - igstar SEE TYPICAL SECTIONS FOR MILLING THICKNESS.
- F. SEE ARTICLE 406.08 AND 406.14 OF THE STANDARD SPECIFICATIONS FOR "HMA AND/OR PCC SURFACE REMOVAL, BUTT JOINT".
- *** 20'-0" (6.1 m) PER 1 (25) RESURFACING (NOTE "A") 10'-0" (3.0 m) PER 1 (25) RESURFACING (NOTE "B")


BASIS OF PAYMENT

- THE BUTT JOINT WILL BE PAID FOR AT THE CONTRACT UNIT PRICE PER SQUARE YARD (SQUARE METER) FOR "HOT-MIX ASPHALT SURFACE REMOVAL - BUTT JOINT" OR FOR "PORTLAND CEMENT CONCRETE SURFACE REMOVAL- BUTT JOINT"
- 2. THE TEMPORARY RAMP AND SAW CUT SHALL BE INCLUDED IN THE UNIT COST FOR HMA OR PCC SURFACE REMOVAL-BUTT JOINT.

SCALE: NONE

ALL DIMENSIONS ARE IN INCHES (MILLIMETERS) UNLESS OTHERWISE SHOWN.

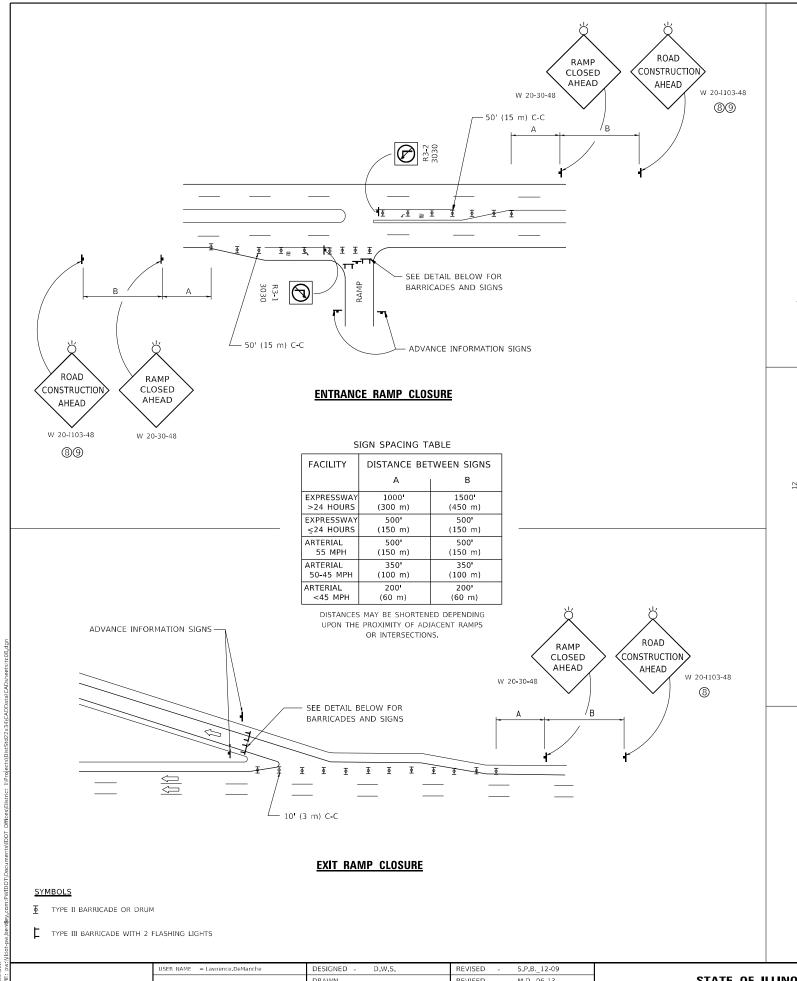

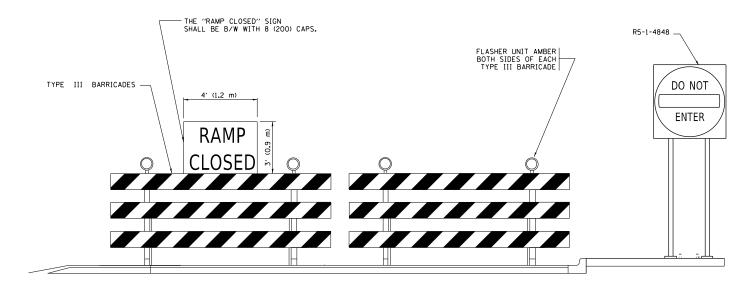

DETAIL FOR REQUIRED BARRICADES & SIGNS


RAMP CLOSURE ADVANCE WARNING SIGN

RAMP CLOSED 10' (3 m)

BLACK LEGEND ON ORANGE

BACKGROUND MOUNTED DIAGONALLY E MOD FONT 1 (25) BORDER

THESE SIGNS ARE REQUIRED ON ALL THE EXIT GUIDE SIGNS FOR EXIT RAMPS THAT WILL BE CLOSED FOR MORE THAN FOUR (4) CONSECUTIVE DAYS.

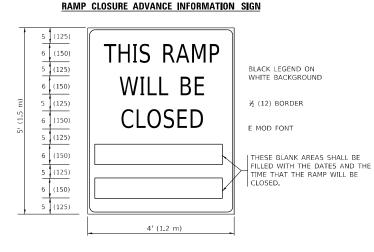

THESE SIGNS ARE REQUIRED ON BOTH SIDES OF THE RAMP, MINIMUM OF 1 WEEK IN ADVANCE OF THE CLOSURE.

THESE SIGNS SHALL BE FABRICATED AND PAID FOR ACCORDING TO THE TEMPORARY INFORMATION SIGNING SPECIAL PROVISION

GENERAL NOTES:


- CONES MAY BE SUBSTITUTED FOR DRUMS OR TYPE II BARRICADES DURING DAY OPERATIONS. CONES SHALL BE A MINIMUM OF 28 (700) HIGH.
- (2) VERTICAL BARRICADES SHALL NOT BE USED FOR RAMP CLOSURES.
- 3 A FLAGGER SHALL BE POSITIONED AT EACH CLOSED RAMP THAT IS OPEN TO CONSTRUCTION VEHICLES, PRECEEDED BY A W20-7 FLAGGER WARNING SIGN.
- 4 ALL ROUTE MARKERS AND TRAILBLAZER ASSEMBLIES WHICH DIRECT MOTORISTS TO A CLOSED ENTRANCE RAMP SHALL BE COVERED WHEN THE RAMP IS CLOSED FOR MORE THAN FOUR (4) DAYS.
- 5 THE SIGNING AND BARRICADING WHICH IS REQUIRED BY THIS DETAIL SHALL BE INCLUDED IN THE COST OF TRAFFIC CONTROL AND PROTECTION (EXPRESSWAYS).


- (6) AUTHORIZATION FROM THE DISTRICT'S BUREAU OF TRAFFIC IS REQUIRED FOR ALL RAMP CLOSURES.
- THE RAMP CLOSURE ADVANCE INFORMATION SIGNS SHALL BE ERECTED IF THE CLOSURE TIME EXCEEDS TWENTY-FOUR (24) HOURS. ADDITIONAL ADVANCE WARNING SIGNS ON EXIT GUIDE SIGNING WILL BE REQUIRED FOR EXIT RAMP CLOSURES THAT EXCEED FOUR (4) DAYS IN LENGTH
- (8) ROAD CONSTRUCTION AHEAD SIGNS MAY BE OMITTED WHEN THIS DETAIL IS USED IN CONJUNCTION WITH OTHER TRAFFIC CONTROL THAT ALREADY INCLUDES A ROAD CONSTRUCTION AHEAD SIGN.
- ARTERIAL ROAD CONSTRUCTION AHEAD SIGNS SHALL BE INSTALLED ON THE LEFT SIDE OF TRAFFIC IF THE MEDIAN IS MORE THAN 10 FT WIDE.

ALL DIMENSIONS ARE IN INCHES (MILLIMETERS) UNLESS OTHERWISE SHOWN.

COET TWITE CONTENCED CONTINUE	DESIGNED - D.M.S.	NEVISED S.I.D12 05	•		
	DRAWN -	REVISED - M.D06-13	STATE OF ILLINOIS		
PLOT SCALE = 100.0000 / in.	CHECKED -	REVISED - M.D01-18	DEPARTMENT OF TRANSPORTATION		
PLOT DATE = 5/3/2024	DATE - 02-83	REVISED - D.S05-24	· ·	SCALE: NONE	SHEET

SECTION ENTRANCE_AND_EXIT_RAMP 55 FAI 55 22 BRIDGE REHAB WILL 31 25 **CLOSURE DETAILS** CONTRACT NO. 62R76 OF 1 SHEETS STA TO STA.

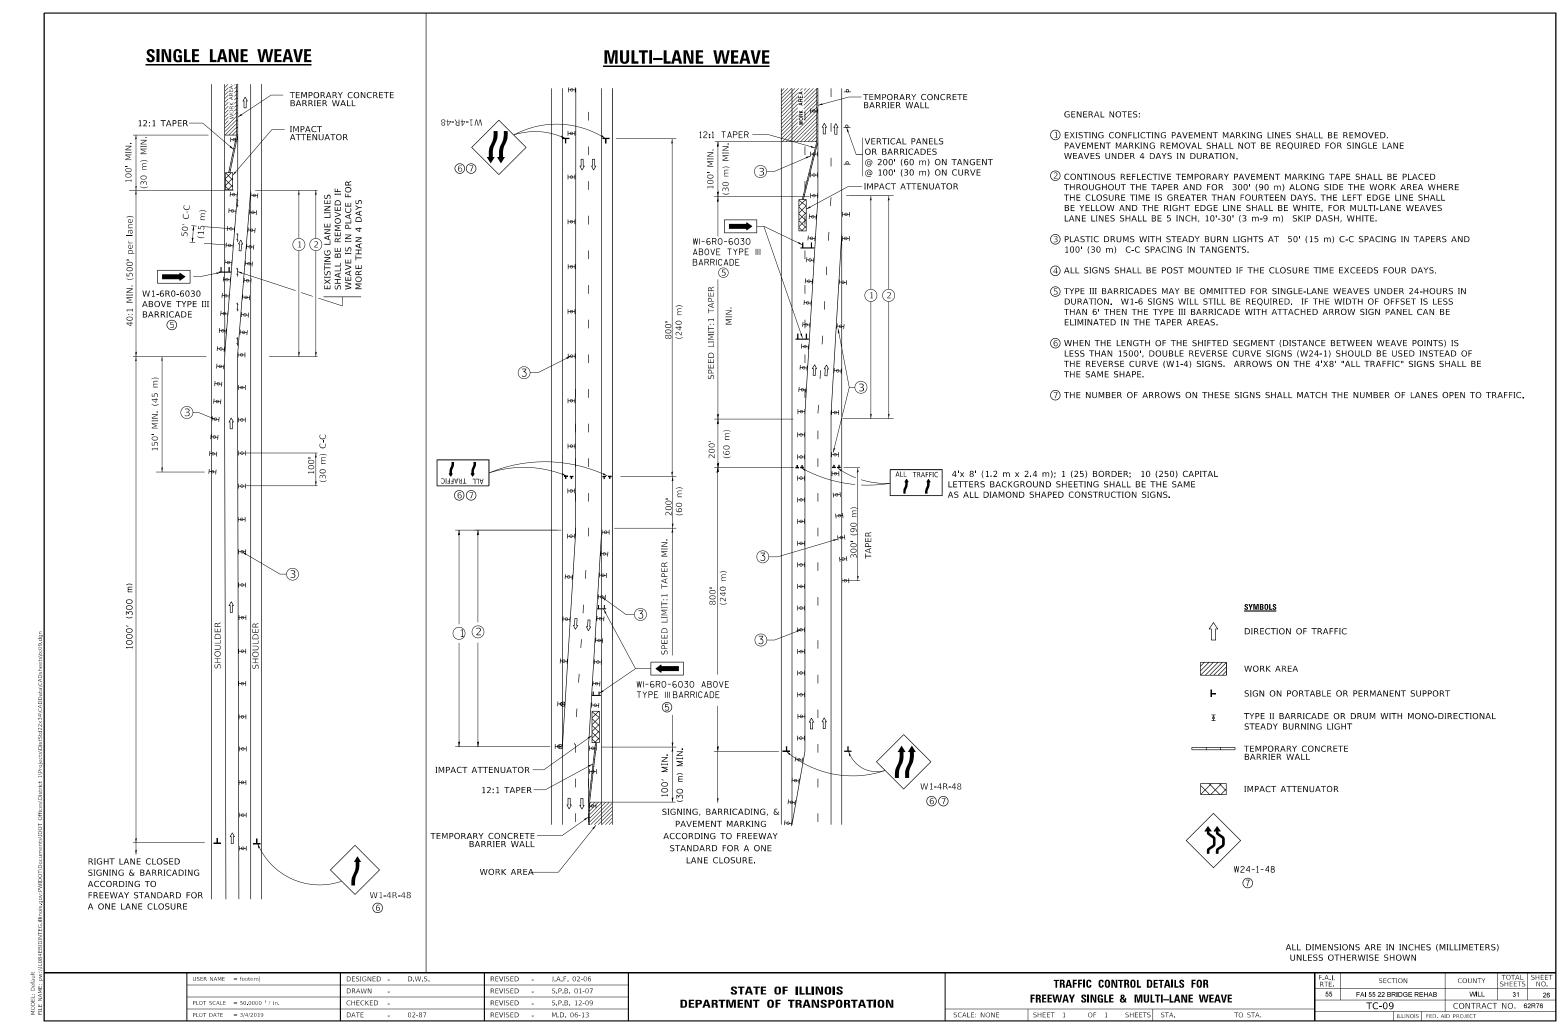

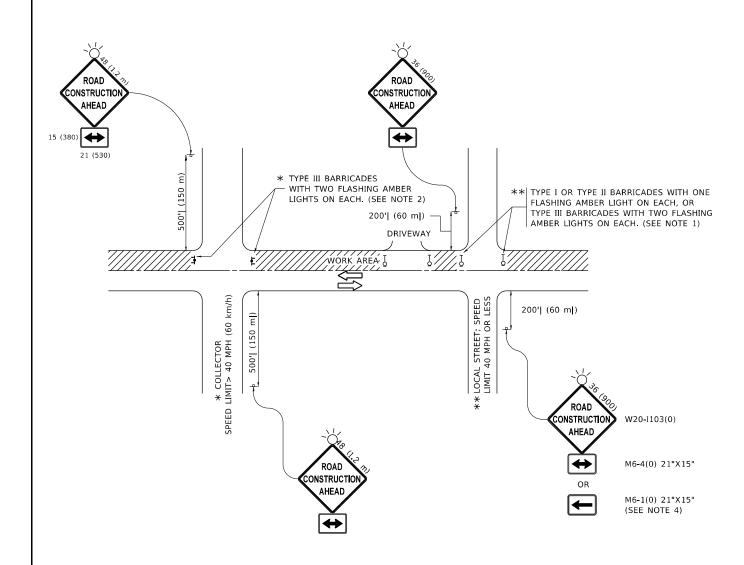

NOTES:

- 1. SIDE ROAD WITH A SPEED LIMIT OF 40 MPH (60 km/h) OR LESS AS SHOWN ON THE DRAWING AND AS DIRECTED BY THE ENGINEER:
- a) ONE "ROAD CONSTRUCTION AHEAD" SIGN 36 x 36 (900x900) WITH A FLASHER MOUNTED ON IT APPROXIMATELY 200' (60 m) IN ADVANCE OF THE MAIN ROUTE.
- b) THE CLOSED PORTION OF THE MAIN ROUTE SHALL BE PROTECTED BY BLOCKING WITH TYPE I, TYPE II OR TYPE III BARRICADES, 1/3 OF THE CROSS SECTION OF THE CLOSED PORTION.
- 2. SIDE ROAD WITH A SPEED LIMIT GREATER THAN 40 MPH (60 km/h) AS SHOWN ON THE DRAWING AND AS DIRECTED BY THE ENGINEER:
- a) ONE "ROAD CONSTRUCTION AHEAD" SIGN 48 x 48 (1.2 m x 1.2 m) WITH A FLASHER MOUNTED ON IT APPROXIMATELY 500' (150 m) IN ADVANCE OF THE MAIN ROUTE,
- THE CLOSED PORTION OF THE MAIN ROUTE SHALL BE PROTECTED BY
 b) BLOCKING WITH TYPE III BARRICADES, 1/2 OF THE CROSS SECTION
 OF THE CLOSED PORTION.
- 3. CONES MAY BE SUBSTITUTED FOR BARRICADES OR DRUMS AT HALF THE SPACING DURING DAY OPERATIONS. CONES SHALL BE A MINIMUM OF 28 (710) IN HEIGHT
- WHEN THE SIDE ROAD LIES BETWEEN THE BEGINNING OF THE MAINLINE
 4. SIGNING AND THE WORK ZONE, A SINGLE HEADED ARROW (M6-1) SHALL
 BE USED IN LIEU OF THE DOUBLE HEADED ARROW (M6-4).

- 5. WHEN WORK IS BEING PERFORMED ON A SIDE ROAD OR DRIVEWAY, FOLLOW THE APPLICABLE STANDARD(S). THE DIRECTIONAL ARROW (M6-1 OR M6-4) SHALL BE COVERED OR REMOVED WHEN NO LONGER CONSISTENT WITH THE TRAFFIC CONTROL SET-UP.
- 6. ADVANCE WARNING SIGNS ARE TO BE OMITTED ON DRIVEWAYS UNLESS OTHERWISE SPECIFIED IN THE PLANS OR BY THE ENGINEER
- 7. THE TRAFFIC CONTROL AND PROTECTION FOR SIDE ROADS, INTERSECTIONS, AND DRIVEWAYS SHALL BE INCLUDED IN THE COST OF SPECIFIED TRAFFIC CONTROL STANDARDS OR ITEMS.


All dimensions are in inches (millimeters) unless otherwise shown.


USER NAME = Lawrence.DeManche	DESIGNED - L.H.A.	REVISED - T. RAMMACHER 01-06-00
	DRAWN -	REVISED - A. SCHUETZE 07-01-13
PLOT SCALE = 100.0000 / in	CHECKED -	REVISED - A. SCHUETZE 09-15-16
PLOT DATE = 5/3/2024	DATE - 06-89	REVISED - D. SENDERAK 05-03-24

STATE OF ILLINOIS
DEPARTMENT OF TRANSPORTATION


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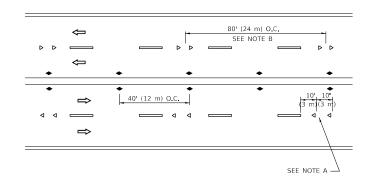


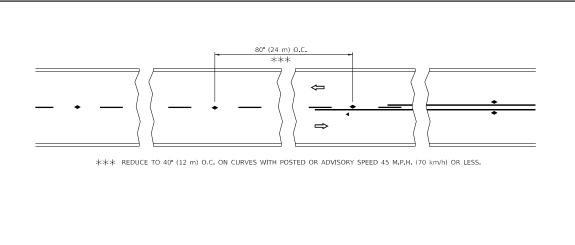


SEE FIGURE 3B-14 MUTCD

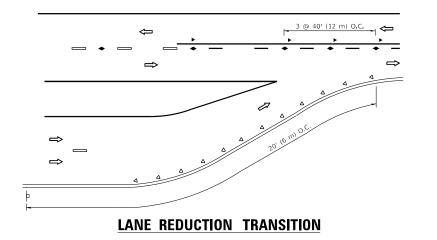


TWO-LANE/TWO-WAY

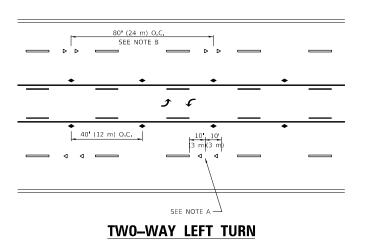


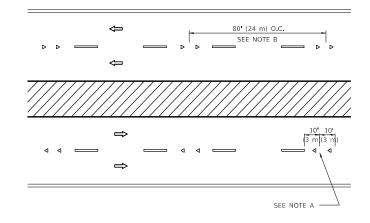

MULTI-LANE/UNDIVIDED



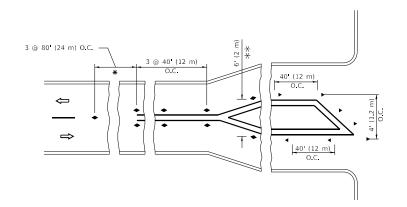

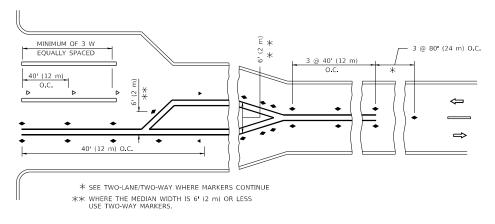

TURN LANES

GENERAL NOTES

- MARKERS USED WITH DASHED LINES SHALL BE CENTERED IN THE GAP BETWEEN SEGMENTS.
- MARKERS USED ADJACENT TO SOLID LINES SHALL BE OFFSET 2 TO 3 (50 TO 75) TOWARD TRAFFIC AS SHOWN.
- MARKERS THROUGH TANGENTS LESS THAN 500' (150 m) IN LENGTH BETWEEN CURVES SHALL BE INSTALLED AT THE LESSER OF THE TWO CURVE SPACINGS.
- 4. MARKERS ARE TO BE USED ADJACENT TO BOTH SOLID WHITE LINES IN DUAL LEFT TURN LANES

NICED ADJACENT TO DOTAL COUR

LANE MARKER NOTES

- A. USE DOUBLE LANE LINE MARKERS SPACED AS SHOWN.
- B. REDUCE TO 40' (12 m) O.C. ON CURVES WHERE ADVISORY SPEEDS ARE 10 M.P.H (20 km/h) LOWER THAN POSTED SPEEDS.

DESIGN NOTES

- 1. DOUBLE LANE LINE MARKERS SHALL BE USED UNLESS SPECIFIED OTHERWISE.
- EXCEPT AS SHOWN ON THE LANE REDUCTION TRANSITION AND FREEWAY EXIT RAMP DETAIL, MARKERS ARE NOT TO BE SPECIFIED ON RIGHT EDGE LINES.
- 3. THE EXACT MARKER LIMITS, SPACING, AND COLOR SHALL BE INCLUDED IN THE PLANS WHEN STANDARD SPECIFICATIONS ARE NOT BEING USED.
- MARKERS SHOULD NOT BE USED ALONGSIDE CURBS EXCEPT FOR EXTREMELY SHORT SECTIONS OF CURBS WHERE NOT MORE THAN TWO MARKERS WOULD BE INVOLVED.

All dimensions are in inches (millimeters) unless otherwise shown.

STATE OF ILLINOIS
DEPARTMENT OF TRANSPORTATION

TYPICAL APPLICATIONS

RAISED REFLECTIVE PAVEMENT MARKERS (SNOW-PLOW RESISTANT)

SCALE: NONE SHEET 1 OF 1 SHEETS STA. TO STA.

SYMBOLS

ONE-WAY AMBER MARKER

TWO-WAY AMBER MARKER


ONE-WAY CRYSTAL MARKER (W/O)


YELLOW STRIPE

WHITE STRIPE

MODEL: Default

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TYPE OF MARKING WIDTH OF LINE PATTERN SPACING / REMARKS COLOR CENTERLINE ON 2 LANE PAVEMENT SKIP-DASH YELLOW 10' (3 m) LINE WITH 30' (9 m) SPACE SOLID YELLOW 11 (280) C-C NO PASSING ZONE LINES: FOR ONE DIRECTION FOR BOTH DIRECTIONS **4 (100)** 2 @ 4 (100) YELLOW YELLOW OMIT SKIP-DASH CENTERLINE BETWEEN LANE LINES SKIP-DASH SKIP-DASH 10' (3 m) LINE WITH 30' (9 m) SPACE 4 (100) 5 (125) ON FREEWAYS DOTTED LINES (EXTENSIONS OF CENTER, LANE OR TURN LANE MARKINGS) SAME AS LINE BEING EXTENDED SKIP-DASH SAME AS LINE BEING EXTENDED 2 (600) LINE WITH 6 (1.8 m) SPACE EDGE LINES SOLID OUTLINE MEDIANS IN YELLOW 4 (100) YELLOW-LEFT WHITE-RIGHT 6 (150) LINE, FULL SIZE LETTERS & SYMBOLS (8' (2.4m) TURN LANE MARKINGS SOLID SEE TYPICAL TURN LANE MARKING DETAIL 10' (3 m) LINE WITH 30' (9 m) SPACE FOR SKIP-DASH; 5½ (140) C-C BETWEEN SOLID LINE AND SKIP-DASH LINE SEE TYPICAL TWO-WAY LEFT TURN MARKING DETAIL TWO WAY LEFT TURN MARKING 2 @ 4 (100) EACH DIRECTION 8 (2.4m) LEFT ARROW 2 @ 6 (150) 12 (300) @ 45° 12 (300) @ 90° CROSSWALK LINES (PEDESTRIAN) A. DIAGONALS (BIKE & EOUESTRIAN) NOT LESS THAN 6' (1.8 m) APART . LONGITUDINAL BARS (SCHOOL) SOLID WHITE ' (600) APART SEE TYPICAL CROSSWALK MARKING DETAILS. PLACE 4' (1.2 m) IN ADVANCE OF AND PARALLEL TO CROSSWALK, IF PRESENT. OTHERWISE, PLACE AT DESIRED STOPPING POINT. PARALLEL TO CROSSROAD CENTERLINE, WHERE POSSIN F. STOP LINES 24 (600) SOLID WHITE PAINTED MEDIANS SOLID 11 (280) C-C FOR THE DOUBLE LINE SEE TYPICAL PAINTED MEDIAN MARKING. 2 @ 4 (100) WITH 12 (300) DIAGONALS YELLOW: TWO WAY TRAFFIC WHITE: ONE WAY TRAFFIC @ 45° NO DIAGONALS USED FOR 4' (1.2 m) WIDE MEDIANS DIAGONALS: 15' (4.5 m) C-C (LESS THAN 30MPH (50 km/h)) 20' (6 m) C-C 30MPH (50 km/h) TO 45MPH (70 km/h)) 30' (9 m) C-C (OVER 45MPH (70 km/h)) 24 (600) TRANSVERSE LINES; "RR" IS 6' (1.8 m) LETTERS; 16 (400) LINE FOR "X" RAILROAD CROSSING SOLID WHITE SEE STATE STANDARD 780001 AREA OF: "R"=3.6 SQ. FT. (0.33 m PEACH "X"=54.0 SQ. FT. (5.0 m)2 50' (15 m) C-C (LESS THAN 30MPH (50 km/h)) 75' (25 m) C-C (30 MPH (50 km/h) TO 45MPH (70 km/h)) 150' (45 m) C-C (OVER 45MPH (70 km/h)) SHOULDER DIAGONALS (REQUIRED FOR 12 (300) @ 45° SOLID WHITE - RIGHT YELLOW - LEFT SHOULDERS > 8') U TURN ARROW SEE DETAIL SOLID WHITE 2 ARROW COMBINATION SOLID WHITE 30.4 SF

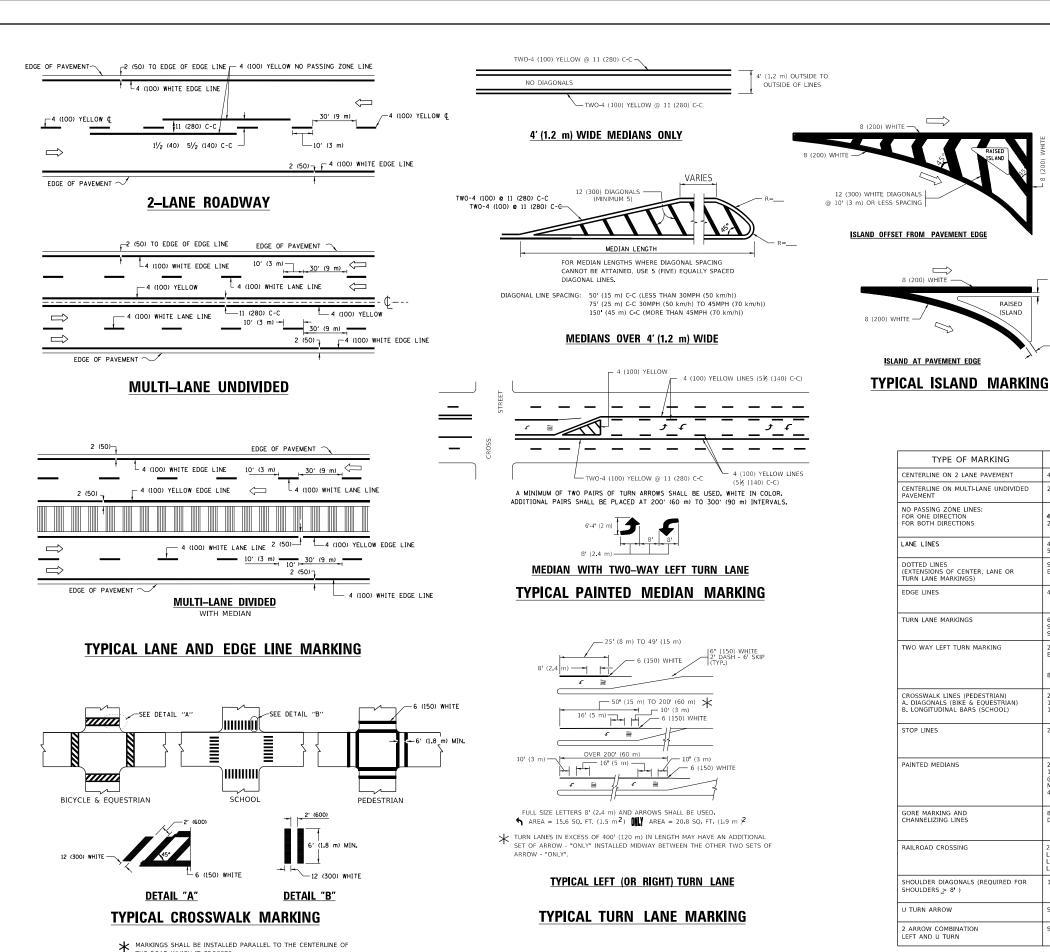FOR FURTHER DETAILS ON PAVEMENT MARKING REFER TO STANDARD SPECIFICATIONS FOR ROAD AND BRIDGE CONSTRUCTION AND STATE STANDARD 780001.

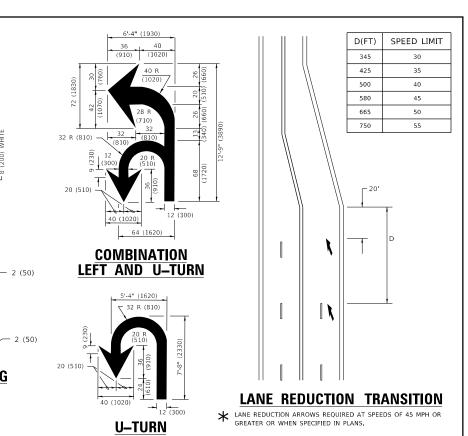SCALE: NONE


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SER NAME = footem EVERS DESIGNED -C. JUCIUS 09-09-09 DRAWN REVISED C. JUCIUS 07-01-13 HECKED REVISED DATE

THE ROAD WHICH IT CROSSES

STATE OF ILLINOIS **DEPARTMENT OF TRANSPORTATION**

SECTION DISTRICT ONE FAI 55 22 BRIDGE REHAB 55 WILL 31 29 TYPICAL PAVEMENT MARKINGS CONTRACT NO.62R76 OF 2 SHEETS STA TO STA.

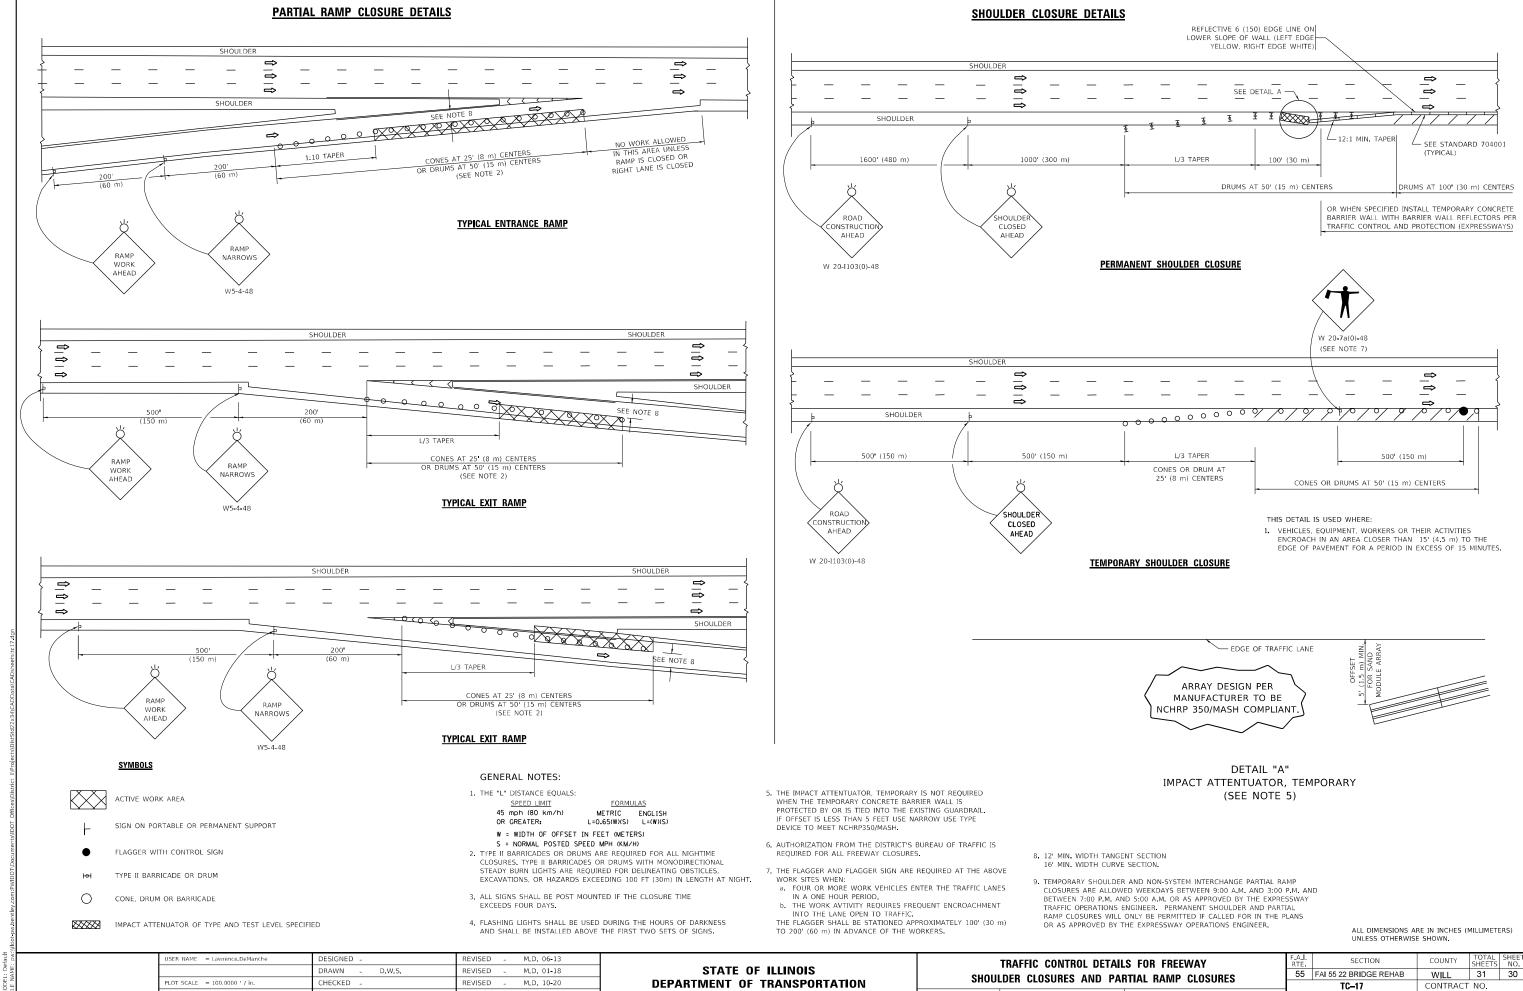


D.S. 05-24

REVISED

DATE

SHEET 1 OF 1 SHEETS STA.

Horbert - Dates

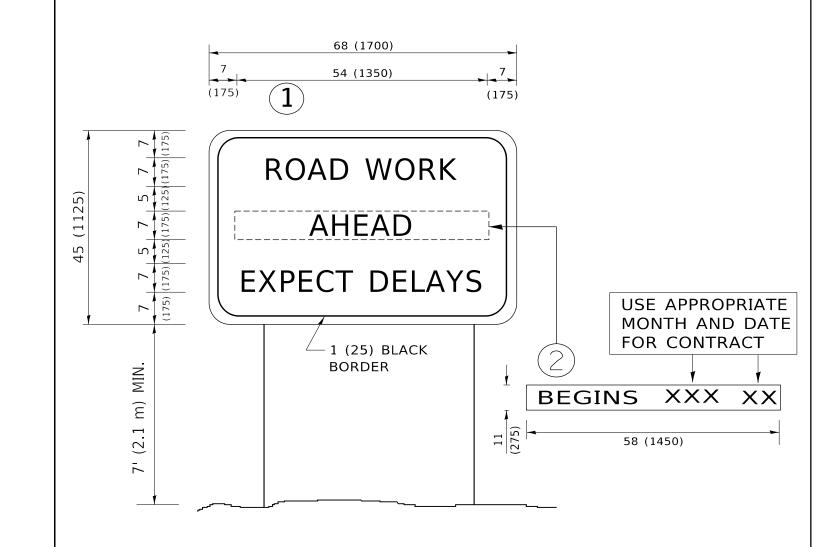

NOTES:

- 1. USE BLACK LETTERING ON ORANGE BACKGROUND.
- 2. ERECT SIGNS IN ADVANCE OF THE LOCATION FOR THE "ROAD CONSTRUCTION AHEAD" SIGN AT LOCATIONS AS DIRECTED BY THE ENGINEER.
- 3. ERECT SIGN 1 WITH INSTALLED PANEL 2 ONE WEEK PRIOR TO THE START OF CONSTRUCTION.
- 4. REMOVE PANEL(2)SOON AFTER THE START OF CONSTRUCTION.
- 5. SEE SPECIAL PROVISION FOR "TEMPORARY INFORMATION SIGNING" FOR ADDITIONAL INFORMATION.
- 6. ONE SIGN ASSEMBLY EQUALS 25.70 SQ. FT. (2.3 SQ. M.)

SCALE: NONE

7. SHALL BE PAID FOR AS TEMPORARY INFORMATION SIGNING.

ALL DIMENSIONS ARE IN INCHES (MILLIMETERS) UNLESS OTHERWISE SHOWN.

	USER NAME = footemj	DESIGNED -	REVISED	-	R. MIRS 09-15-97
		DRAWN -	REVISED	-	R. MIRS 12-11-97
	PLOT SCALE = 50.0000 ' / in.	CHECKED -	REVISED	- T.	RAMMACHER 02-02-9
	PLOT DATE = 3/4/2019	DATE -	REVISED	-	C. JUCIUS 01-31-07

STATE OF ILLINOIS							
DEPARTMENT OF	TRANSPORTATION						

ARTERIAL ROAD					F.A.I. RTE	SECTION	
	INFORM	IATION	SIGN		55	FAI 55 22 BRIDGE REF	
IN OUNT TOU SIGN					TC-22		
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