
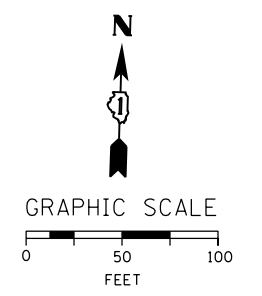


**NOTES:**

1. SEE DRAWING E-01 FOR IDOT ELECTRICAL SYMBOLS.
2. PROVIDE AN EMPTY CONDUIT RUN FOR FUTURE USE.
3. ROUTE THE CONDUIT RUN DOWN THE BRIDGE PIER AND TERMINATE BELOW GRADE WITH PVC ELBOW ENCASED IN NON-REINFORCED CONCRETE AS SHOWN ON IDOT STANDARD DRAWING BE-902. THE CONDUIT SHALL BE STUBBED OUT OF THE ENCASEMENT AND CAPPED FOR FUTURE USE. THE CONCRETE ENCASED CONDUIT TRANSITION SHALL BE INCLUDED IN THE COST OF THE GALVANIZED RIGID STEEL CONDUIT PAY ITEMS.
4. ALL VERTICAL CONDUIT RUNS ROUTED DOWN THE PIERS SHALL BE INSTALLED ON THE INSIDE OF THE PIER FACING AWAY FROM TRAFFIC.
5. DEMARCATION POINT FOR TRANSITION FROM RIGID STEEL CONDUIT INSTALLED UNDERGROUND TO PVC COATED RIGID STEEL CONDUIT ATTACHED TO STRUCTURE SHALL BE AT THE BRIDGE ABUTMENT. SEE STRUCTURAL PLANS FOR LOCATION OF CONDUIT SLEEVES IN ABUTMENT WALL.
6. ALL WORK SHALL BE COORDINATED AND COMPLY WITH THE ELECTRIC UTILITY (COMED) STANDARDS.

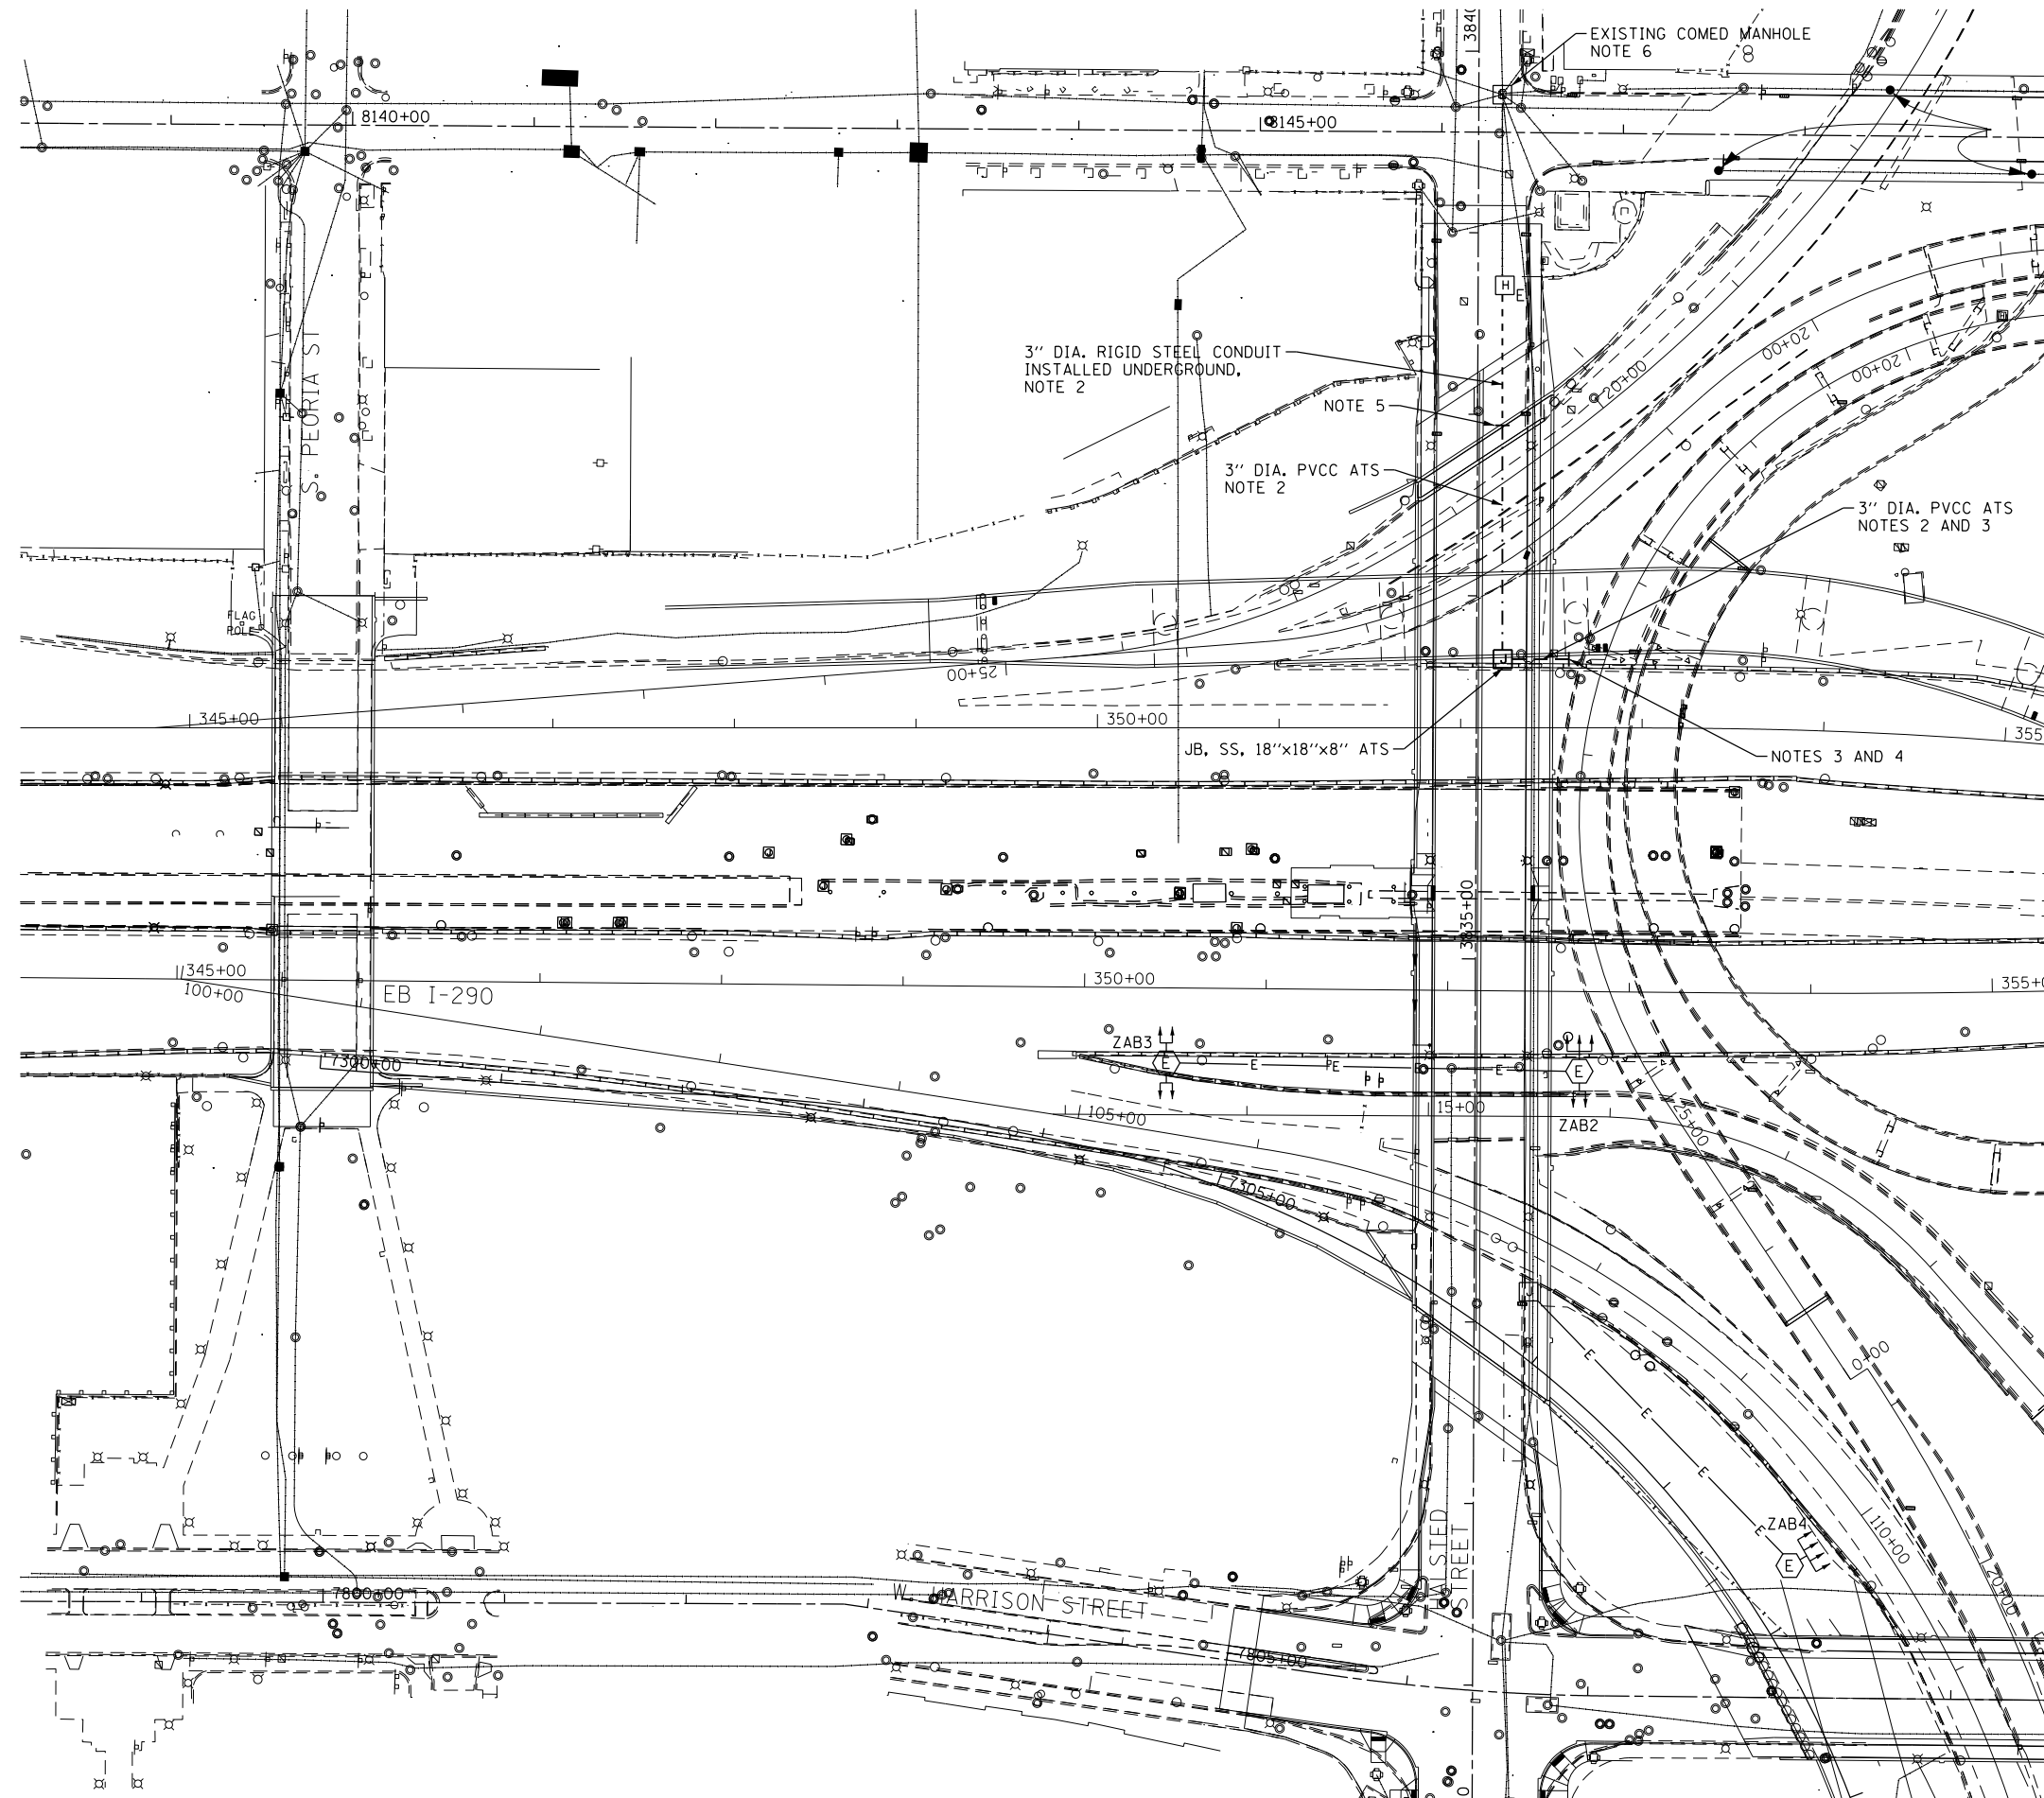

E-04

FILE PATH = p:\388035\pmt\escom\lme\local\AECOM\Documents\01\_Americas\Transportation\60269938\_Circle\Phase\1\000\_CAD\01E\_Electrical\Sheets\60W26-sht-Light-04



D160W26-sht-Light-04  
 USER NAME = myersc  
 PLOT SCALE = 50.0000' / in.  
 PLOT DATE = 8/15/2013

DESIGNED - WDS	REVISED -
DRAWN - CAM	REVISED -
CHECKED - WDS	REVISED -
DATE - 8/20/13	REVISED -

**STATE OF ILLINOIS  
 DEPARTMENT OF TRANSPORTATION**

**I-290 PROPOSED LIGHTING PLAN**  
 SCALE: 1"=50' SHEET 4 OF 22 SHEETS STA. TO STA.

F.A.I. RTE. 90/94/290	SECTION 2013-008R	COUNTY COOK	TOTAL SHEETS 559	SHEET NO. 227
CONTRACT NO. 60W26				
ILLINOIS FED. AID PROJECT				