
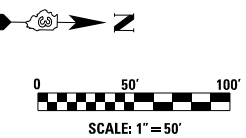
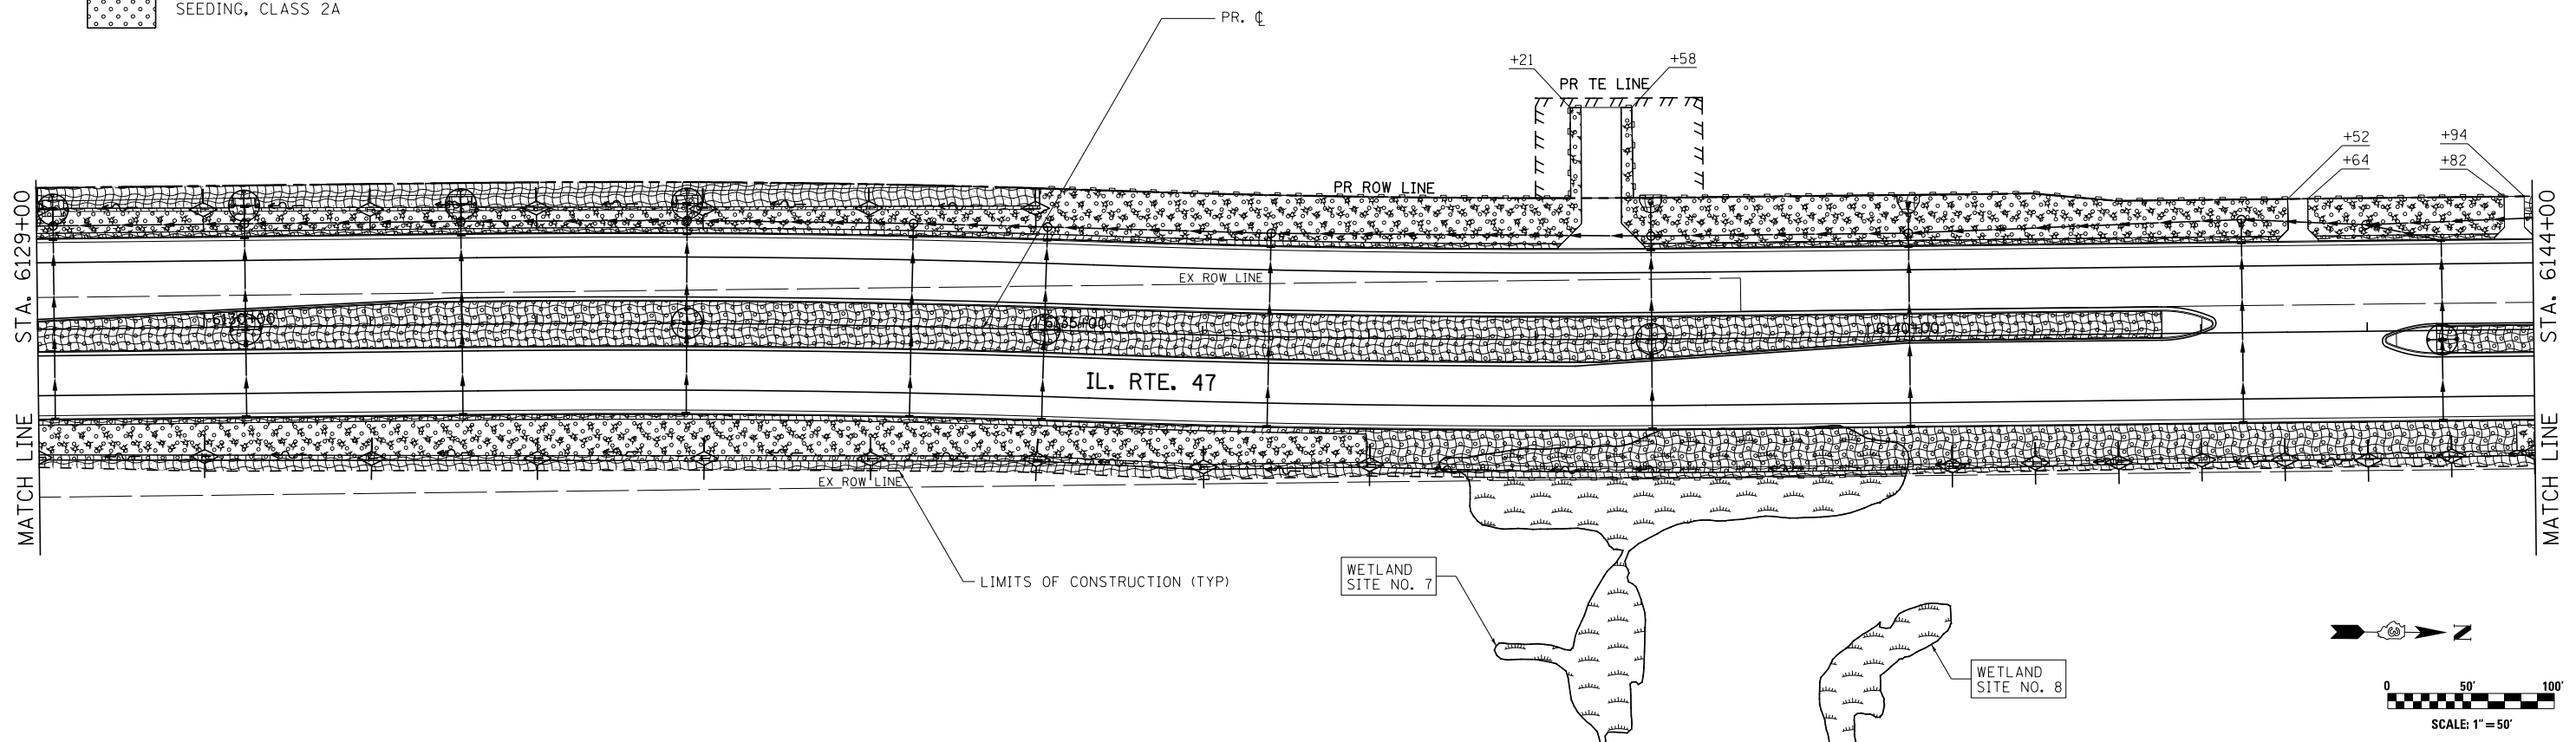


NOTES
 1. SEE TYPICAL LANDSCAPING DETAILS FOR LOCATIONS OF SEEDING, MULCH, EROSION CONTROL BLANKET, AND SODDING

- LEGEND**
- TEMPORARY DITCH CHECKS
 - PERIMETER EROSION BARRIER
 - INLET AND PIPE PROTECTION
 - SALT TOLERANT SODDING
 - SEEDING, CLASS 2A
 - EROSION CONTROL BLANKET
 - STONE RIPRAP
 - SEEDING, CLASS 4
 - MULCH, METHOD 2

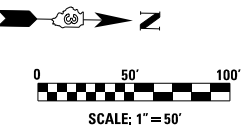

FILE NAME = V:\3195\66883 (South Section)\CADD Sheets\0366883-sht-eros-04.dgn	USER NAME = bdecreane	DESIGNED - BS	REVISED -
SHT_DOUBLE PLAN	PLOT SCALE = 100.0000' / in.	DRAWN - BS	REVISED -
	PLOT DATE = 8/6/2013	CHECKED - ST	REVISED -
		DATE - 7/15/2013	REVISED -

**STATE OF ILLINOIS
 DEPARTMENT OF TRANSPORTATION**

**IL. RTE. 47
 LANDSCAPING AND EROSION CONTROL PLANS**

SCALE: 1"=50' SHEET NO. 4 OF 13 SHEETS STA. 6114+00 TO STA. 6144+00

F.A.P. RTE.	SECTION	COUNTY	TOTAL SHEETS	SHEET NO.
326	(110)R, BR & BR-1	GRUNDY	644	189
				CONTRACT NO. 66B83
ILLINOIS FED. AID PROJECT				