


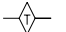




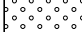
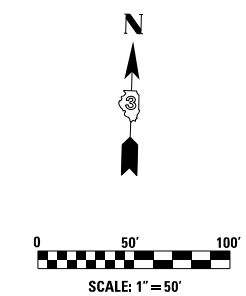
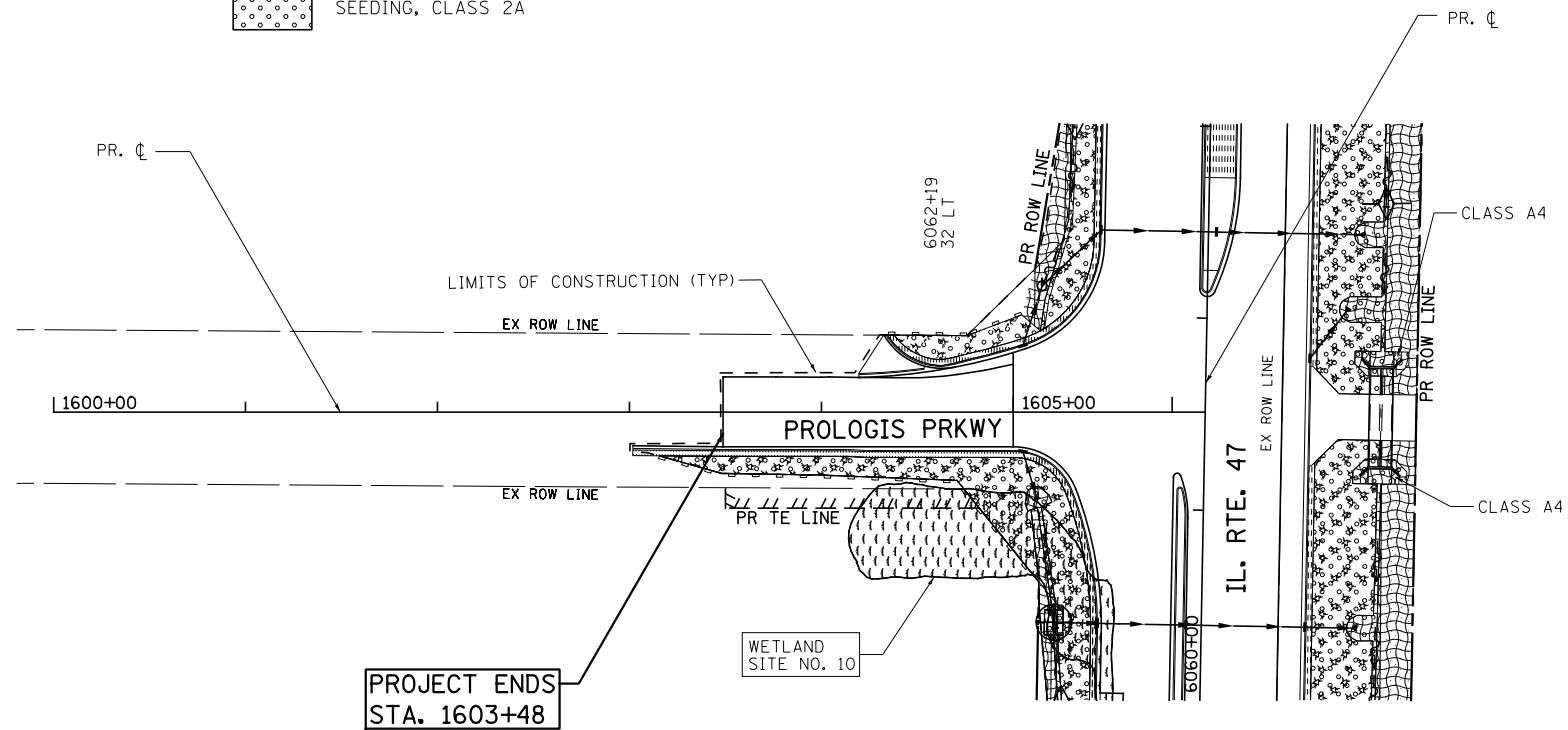
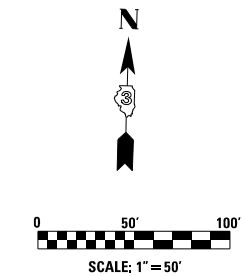


NOTES

- SEE TYPICAL LANDSCAPING DETAILS FOR LOCATIONS OF SEEDING, MULCH, EROSION CONTROL BLANKET, AND SODDING

LEGEND

-  TEMPORARY DITCH CHECKS
-  EROSION CONTROL BLANKET
-  PERIMETER EROSION BARRIER
-  STONE RIPRAP
-  INLET AND PIPE PROTECTION
-  SEEDING, CLASS 4
-  SALT TOLERANT SODDING
-  MULCH, METHOD 2
-  SEEDING, CLASS 2A



FILE NAME =	USER NAME = bdecreene	DESIGNED - BS	REVISED -
V:\3195\66883 (South Section)\CADD Sheets\0366883-sht-eros-10.dgn		DRAWN - BS	REVISED -
	PLOT SCALE = 100.0000' / in.	CHECKED - ST	REVISED -
SHT_DOUBLE PLAN	PLOT DATE = 8/6/2013	DATE - 7/15/2013	REVISED -

**STATE OF ILLINOIS
DEPARTMENT OF TRANSPORTATION**

**GRANVILLE RD. & PROLOGIS PRKWY.
LANDSCAPING AND EROSION CONTROL PLANS**

SCALE: 1"=50' SHEET NO. 10 OF 13 SHEETS STA. TO STA.

F.A.P. RTE.	SECTION	COUNTY	TOTAL SHEETS	SHEET NO.
326	(110)R, BR & BR-1	GRUNDY	644	195
			CONTRACT NO. 66B83	
ILLINOIS FED. AID PROJECT				