


SJ-OV SHEETS), 016-1700	TAILS
		90/94	F.A.I. RTE.
[ILLINOIS] FED. ALD PROJECT		2014-015R&B	SECTION
to PROJECT	CONTRACT	COOK	COUNTY
	. NO. 6	378	TOTAL
	30X95	201	SHEET NO.

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2'-10" 2'-10" 2'-8" 2'-8" 2'-10" 4'-0"	B	

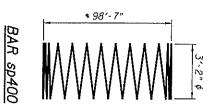

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Crosshole Testing	Crosshole Access L	Concrete	1			Reinforcement	Concrete	Structure		v403	v402	v401(E)	v400(E)		u402(E)	0401(E)	u400(E)	00100	55400	5404(E)	5403(E)	5402(E)	5401(E)	5400(E)	p404(E)	p403(E)	₽402(E)	p401(E)	p400(E)		h402(E)	h40](E)	h400(E)	Bar	
Sonic ,	le Sonic i Ducts	Sealer	Shaft in F	Shaft in S	Coated		Structures	Excovation		112	112	211	72		38	25	10	-	7	32	58	32	116	128	14	91	8	91	16		34	თ	12	No.	BILL
Logging	Logging		Rock	Soil	bars,	Bars	res	ition	1	6	#10	#JO	4 9		#7	#5	#5		<u></u> #л	#5	6#6	#5	#5	#5	#8	#8	#8	6 #	#10		#7	# 50	#5	Size	
Each	Foot	5q. Ft.		Cu. Yd.	Pound	Pound	Cu. Yd.	1 1	- 1	45'-0"	- 1	<u>18'-2"</u>	14'-4"		X	۰. I	10~2"	- ~	081-7"	9'-2"	26'-10"	8'-2"	12'-5"	8'-7"	57'-0"	13'-5"	55'-2"	39'-6"	40'- I"	0	57'-0"	23'-8"	36'-3"	Length	MATERIAL
⊳	691	2,733	7.5	312	32,390	65,170	136	82					լ	-				IAAAI	IVVVV															Shape	AL


*

Notes: Apply concrete sealer to all exposed concrete surfaces of the pier. * The quantities and reinforcement detailing are based on the top of shaft and the estimated top of rock elevations shown and may change based on the actual top of rock encountered at each shaft and the final top of shaft elevation. *

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Length is height of spiral. When splicing spiral reinforcement is necessary, the spirals shall be provided with 1½° extra turns at the ends to be spliced. These additional turns shall either be welded together according to AWS D1.4, or shall both terminate in 130° standard hook.




CHECKED - AH **BRINCKERHOFF** PLOT SCALE = N.T.S. DRAWN MR PLOT DATE = 6/29/2017 CHECKED - JIG REVISED

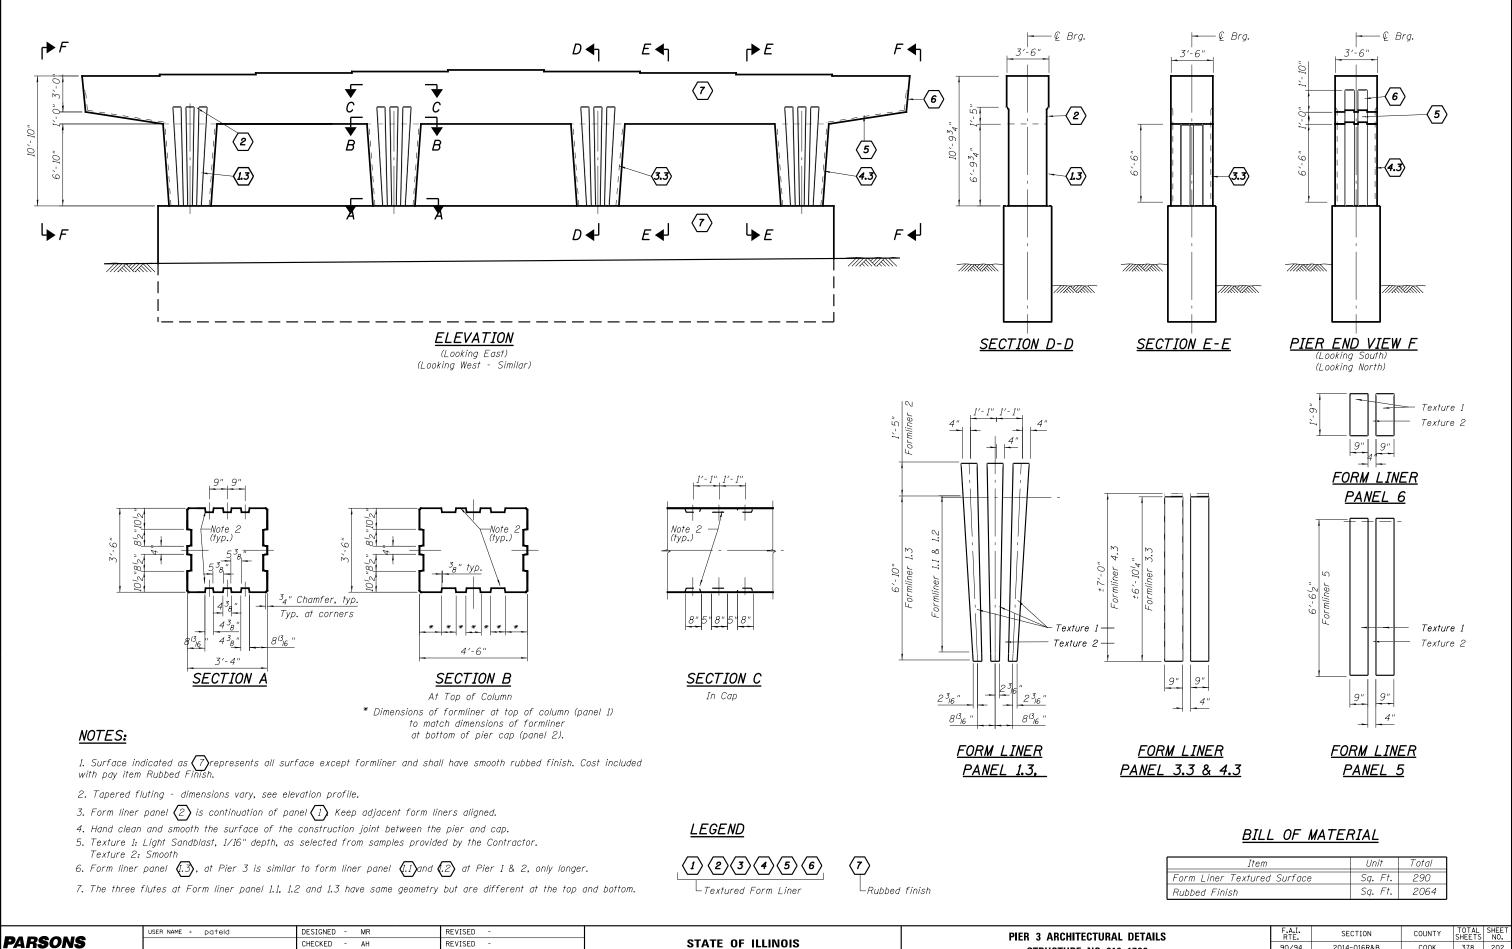REVISED

STATE OF ILLINOIS **DEPARTMENT OF TRANSPORTATION**

STRUCTURE NO. SHEET NO. S1-50 OF S

JRAL DETAILS	F.A.I. RTE.	SECTION	COUNTY	TOTAL SHEETS	SHEET NO.
. 016–1700	90/94	2014-016R&B	СООК	378	202
. 010-1700		CONTRACT	NO. 6	0X95	
S1-60 SHEETS		ILLINOIS FED. A	D PROJECT		

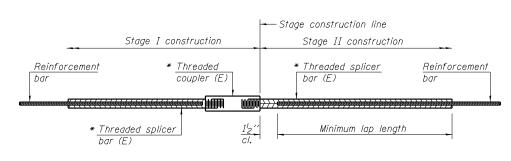


STANDARD BAR SPLICER ASSEMBLY

Threaded splicer bar length = min. lap length + l_2'' + thread length


* Epoxy not required on Bar Splicer Assembly components used in conjunction with black bars.

Location	Bar size	No. assemblies required	Minimum Iap length

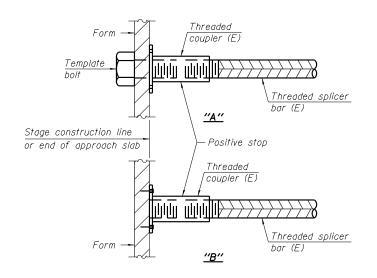

INSTALLATION AND SETTING METHODS

"A" : Set bar splicer assembly by means of a template bolt.
 "B" : Set bar splicer assembly by nailing to wood forms or cementing to steel forms.
 (E) : Indicates epoxy coating.

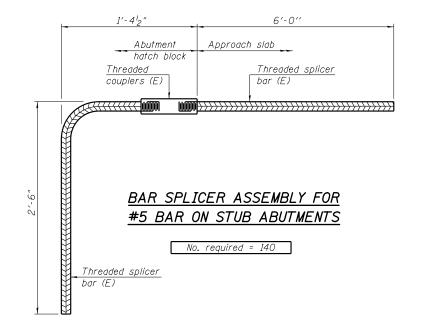


00-60X95-S051-BAR.

BSD-1

6-8-15

	USER NAME = pateld	DESIGNED - JZ	REVISED -		BAR SPLICER ASSEMBLY AND MECHANICAL SPLICER DETAILS	F.A.I. RTE,	SECTION	COUNTY	TOTAL SHEETS	HEET
PARSONS BRINCKERHOFF	PLOT SCALE = N.T.S.	CHECKED - AH DRAWN - DCP	REVISED - REVISED -	STATE OF ILLINOIS DEPARTMENT OF TRANSPORTATION	STRUCTURE NO. 016–1700	90/94	2014-016R&B	COOK	378	203
	PLOT DATE = 6/29/2017	CHECKED - JIG	REVISED -		SHEET NO. S1-51 OF S1-60 SHEETS		ILLINOIS FED.	AID PROJECT	1 110. 0	<u></u>

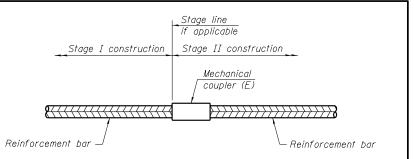


STANDARD MECHANICAL SPLICER


Location	Bar size	No. assemblies required

NOTES


Splicer bars shall be deformed with threaded ends and have a minimum 60 ksi yield strength.


All reinforcement shall be lapped and tied to the splicer bars. Bar splicer assemblies shall be epoxy coated according to the requirements for reinforcement bars. See Section 508 of the Standard Specifications. See approved list of bar splicer assemblies and mechanical splicers for alternatives.

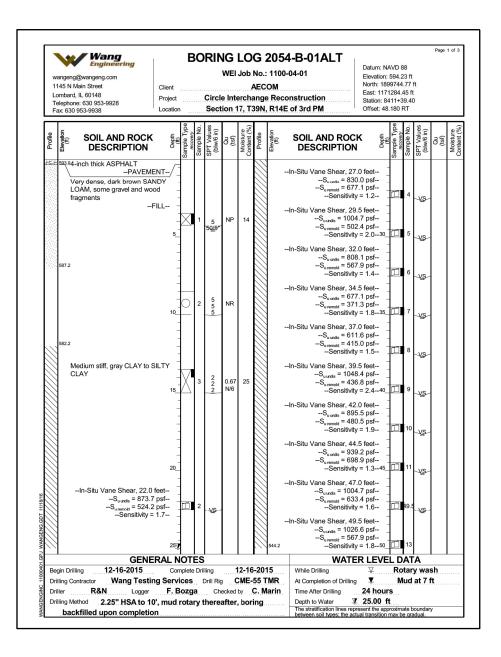


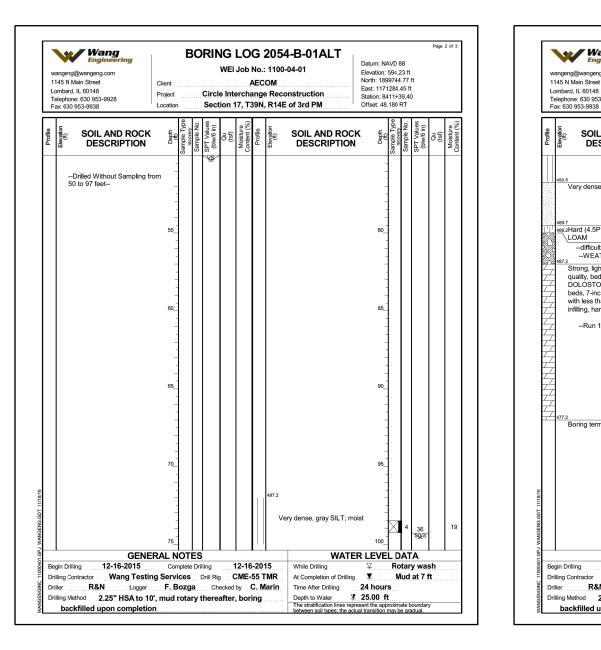

	USER NAME = pateld	DESIGNED - HA	REVISED -		BORING LOGS I	F.A.I. RTE.	SECTION	COUNTY	TOTAL SHEET SHEETS NO.
		CHECKED - AH	REVISED -	STATE OF ILLINOIS	STRUCTURE NO. 016–1700	90/94	2014-016R&B	COOK	378 204
BRINCKERHOFF	PLOT SCALE = N.T.S.	DRAWN - DCP	REVISED -	DEPARTMENT OF TRANSPORTATION	SINUCIUNE NU. UID-1/UU			CONTRACT	T NO. 60X95
016	PLOT DATE = 6/29/2017	CHECKED - JIG	REVISED -		SHEET NO. S1-52 OF S1-60 SHEETS		ILLINOIS FED, AI	D PROJECT	

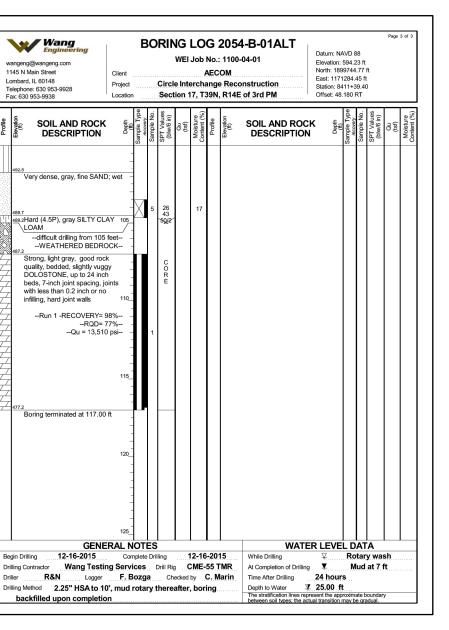


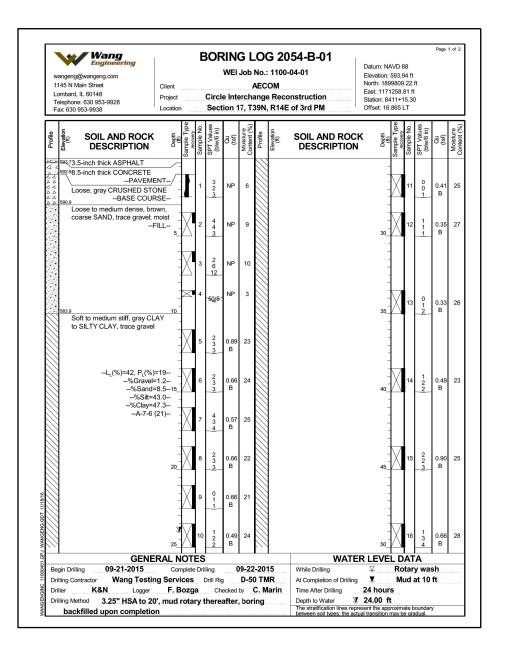


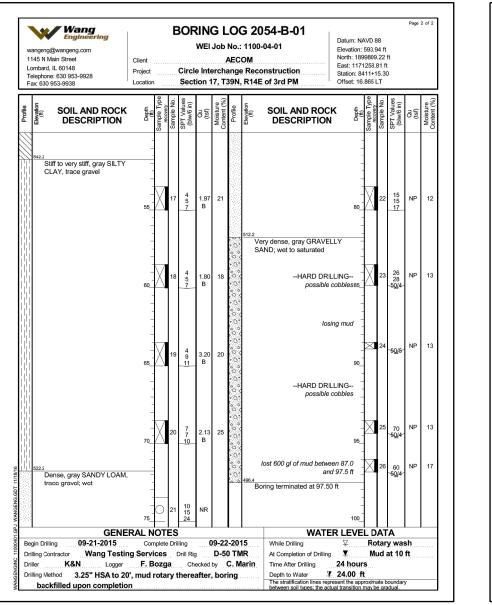


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BRINCKERHOFF	PLOT SCALE = N.T.S.	DRAWN - DCP	REVISED -	DEPARTMENT OF TRANSPORTATION	STRUCTURE NO. 016–1700				CT NO. 60X95
016	PLOT DATE = 6/29/2017	CHECKED - JIG	REVISED -		SHEET NO. S1-53 OF S1-60 SHEETS		ILLINOIS FED. 4	AID PROJECT	




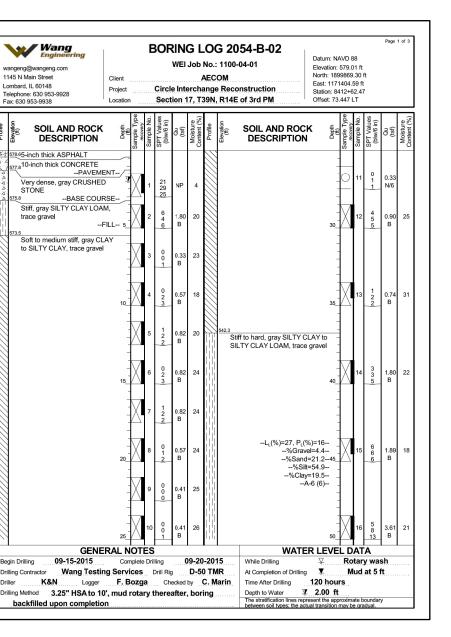

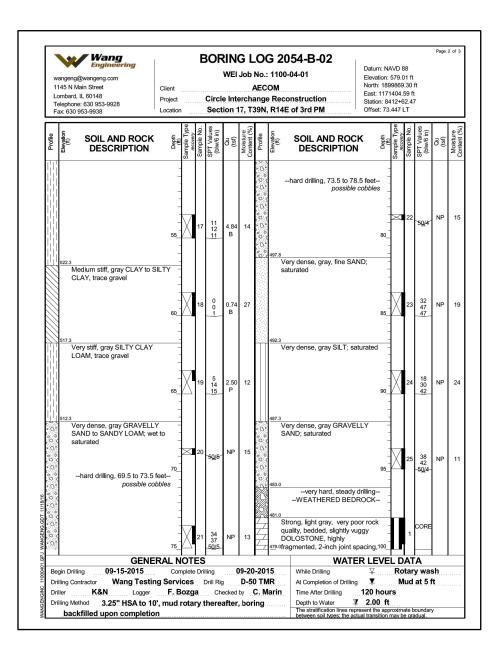


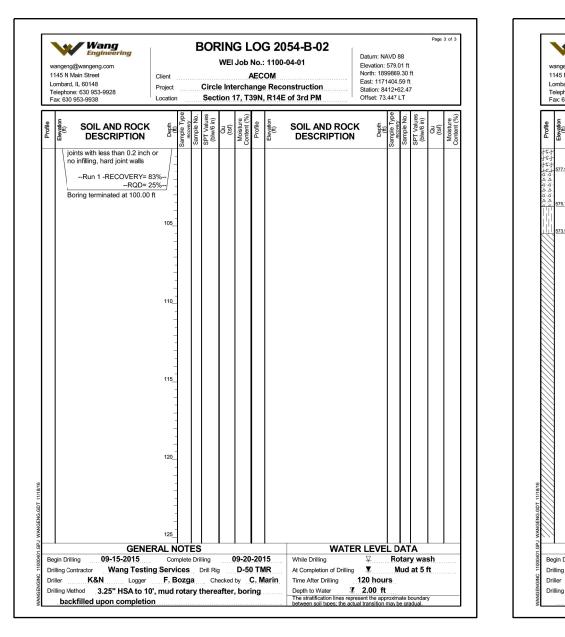
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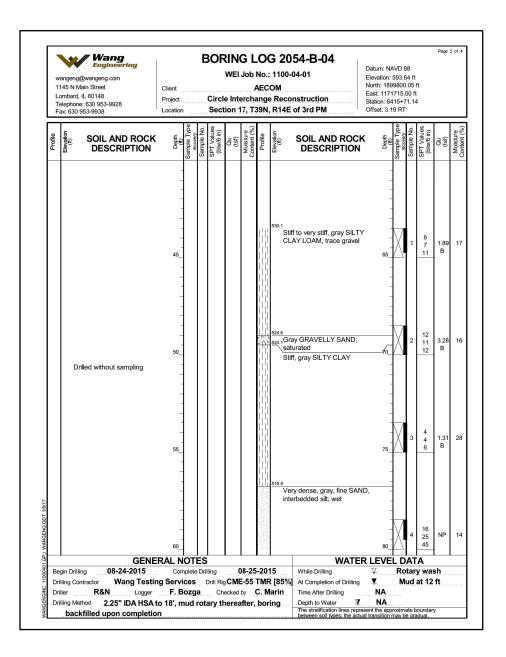
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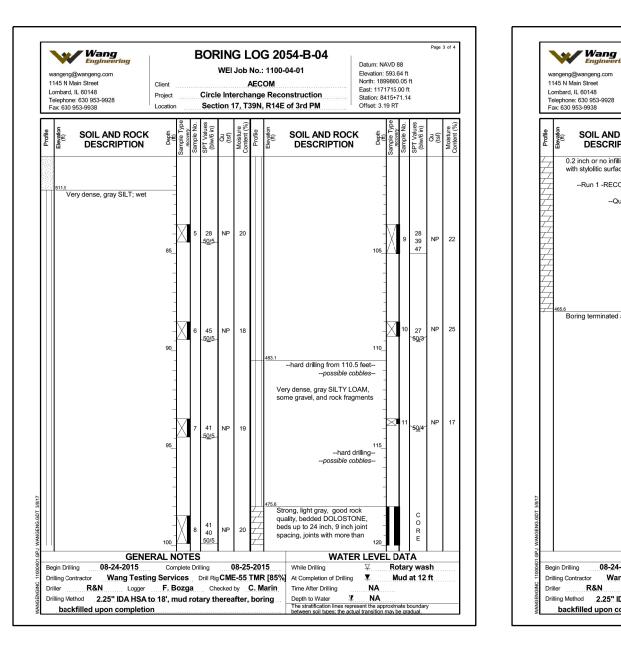


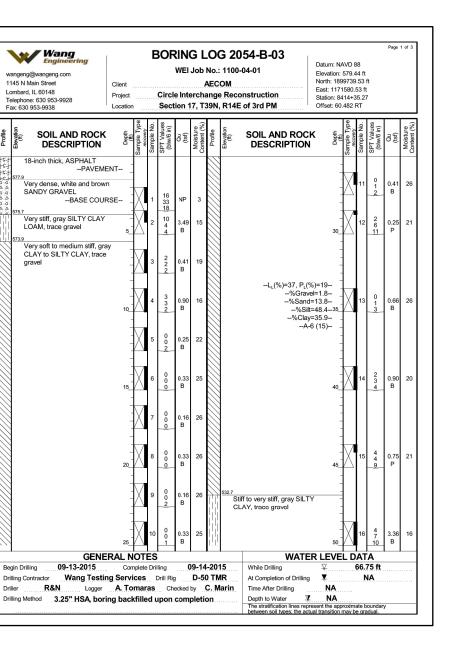


	USER NAME = pateld	DESIGNED - HA	REVISED -		BORING LOGS IV	F.A.I. SECT		COUNTY	TOTAL SHEET
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BRINCKERHOFF	PLOT SCALE = N.T.S.	DRAWN - DCP	REVISED - DEPARTMENT OF TRANSPORTATION			-			NO. 60X95
0	PLOT DATE = 6/29/2017	CHECKED - JIG	REVISED -		SHEET NO. S1-55 OF S1-60 SHEETS	ILL	INOIS FED, AID	PROJECT	


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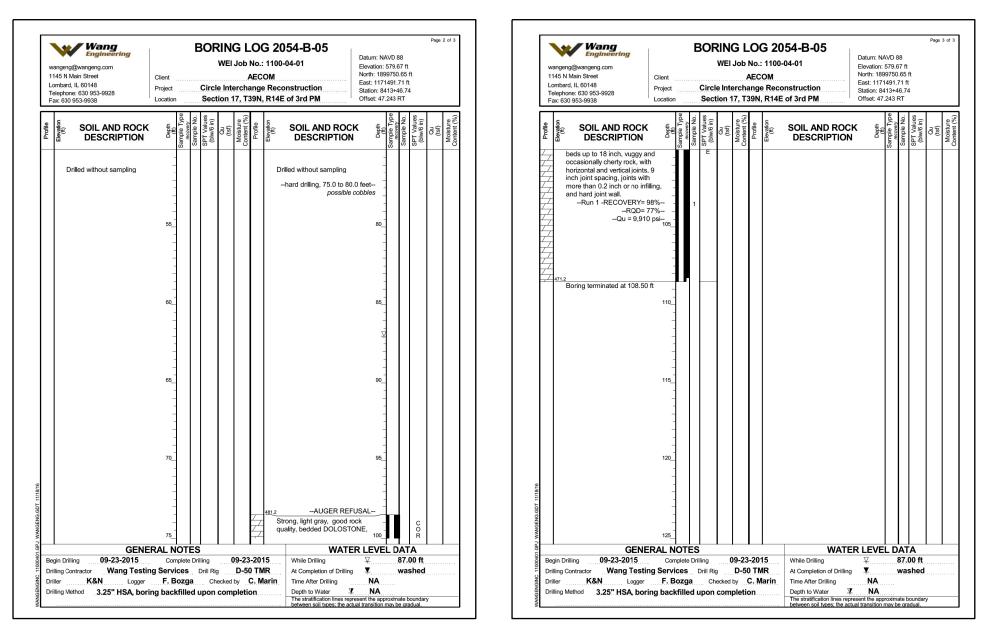


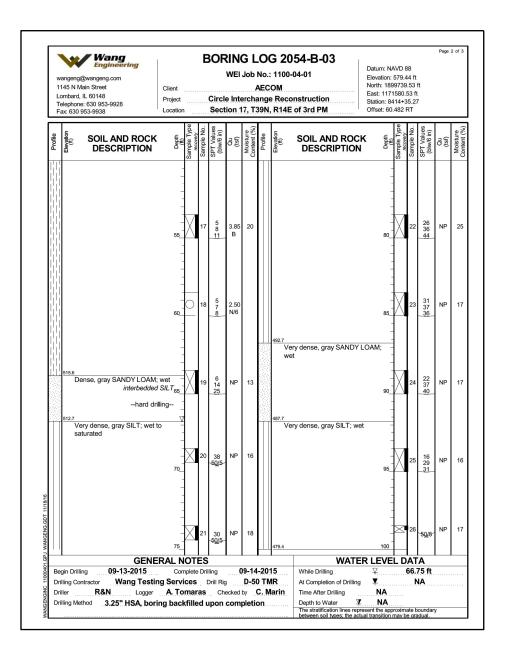

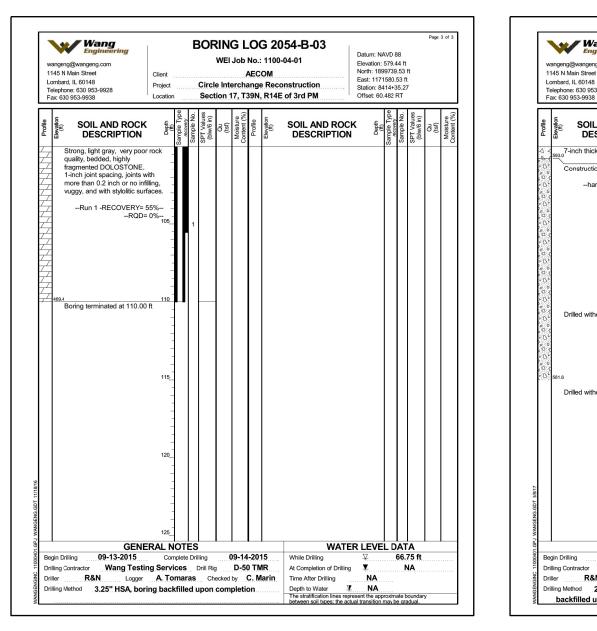
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	PARSONS		CHECKED - AH	REVISED -	STATE OF ILLINOIS	STRUCTURE NO. 016–1700	90/94	2014-016R&B	СООК	378 208
1170	BRINCK ER HOFF	PLOT SCALE = N.T.S.	DRAWN - DCP	REVISED -	DEPARTMENT OF TRANSPORTATION				CONTRAC	T NO. 60X95
016		PLOT DATE = 6/29/2017	CHECKED - JIG	REVISED -		SHEET NO. S1-56 OF S1-60 SHEETS		ILLINOIS FED. A	AID PROJECT	




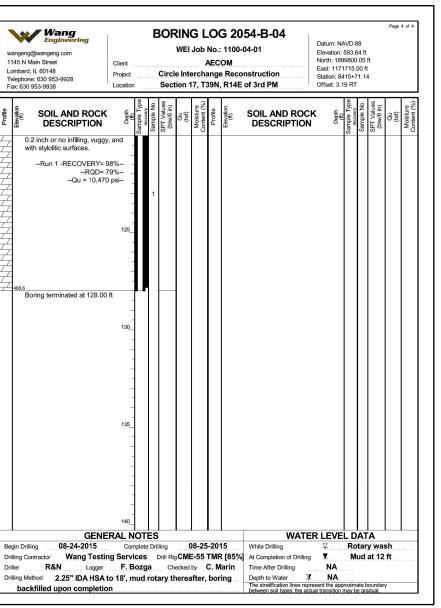

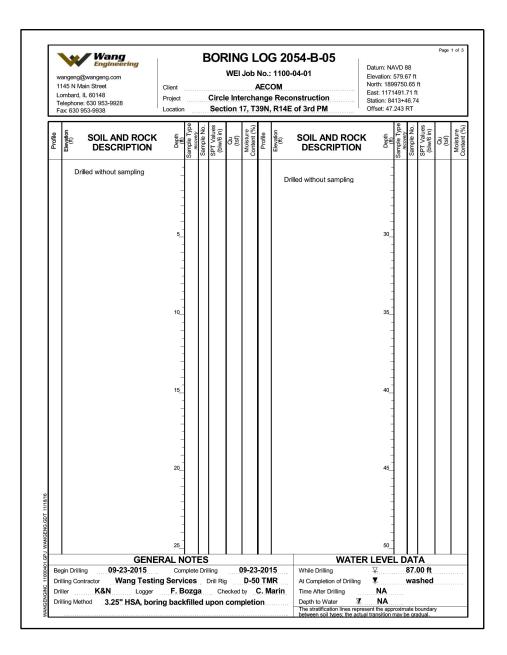



	USER NAME = pat	eld DESIGNED - H	HA REVISED -		BORING LOGS VI	F.A.I. RTF.	SECTION	COUNTY TOTAL	SHEET NO.
PARSONS		CHECKED - 4	AH REVISED -	STATE OF ILLINOIS	STRUCTURE NO. 016–1700	90/94	2014-016R&B	COOK 378	209
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016	PLOT DATE = 6/2	9/2017 CHECKED	JIG REVISED -		SHEET NO. S1-57 OF S1-60 SHEETS		ILLINOIS FED. /	AID PROJECT	

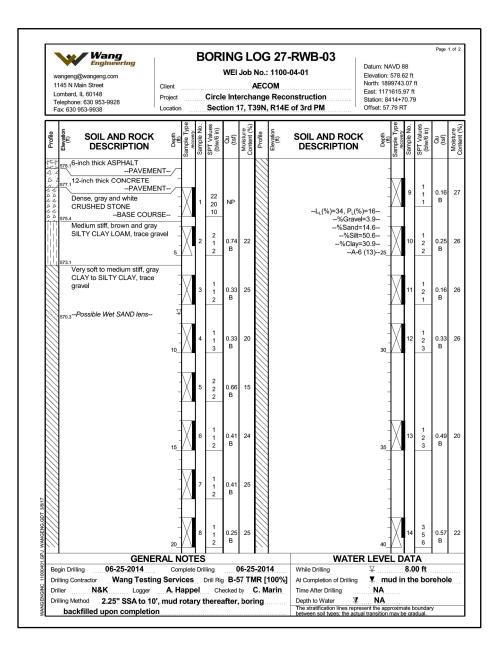


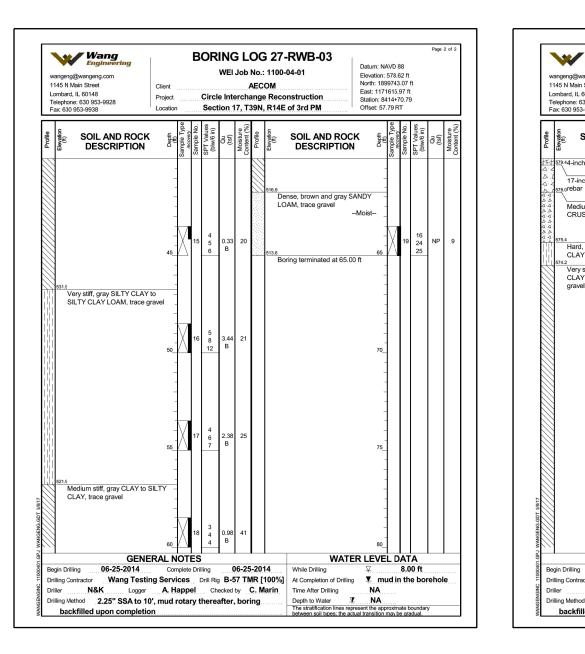


	USER NAME = pateld	DESIGNED - HA REVISED -			BORING LOGS VII	F.A.I. SECT		TOTAL SHEET		
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BRINCKERHOFF	PLOT SCALE = N.T.S.	DRAWN - DCP	REVISED -	DEPARTMENT OF TRANSPORTATION			CONTRAC	CT NO. 60X95		
016	PLOT DATE = 6/29/2017				SHEET NO. S1-58 OF S1-60 SHEETS	ILLINOIS FED. AID PROJECT				

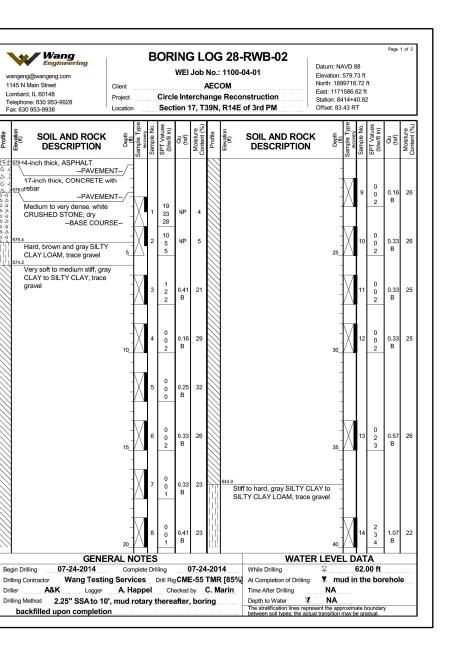


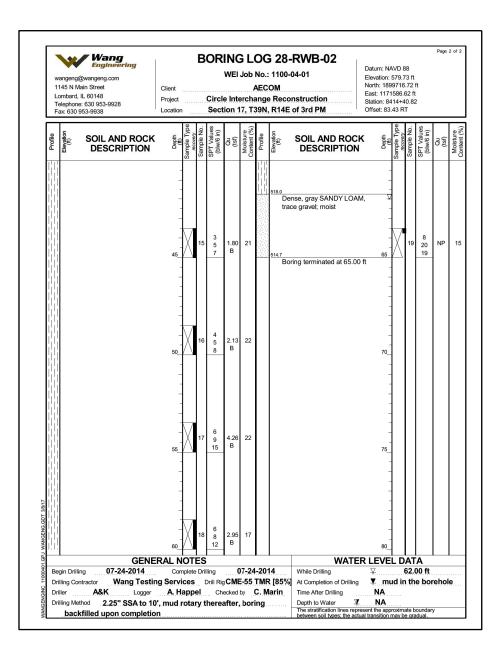


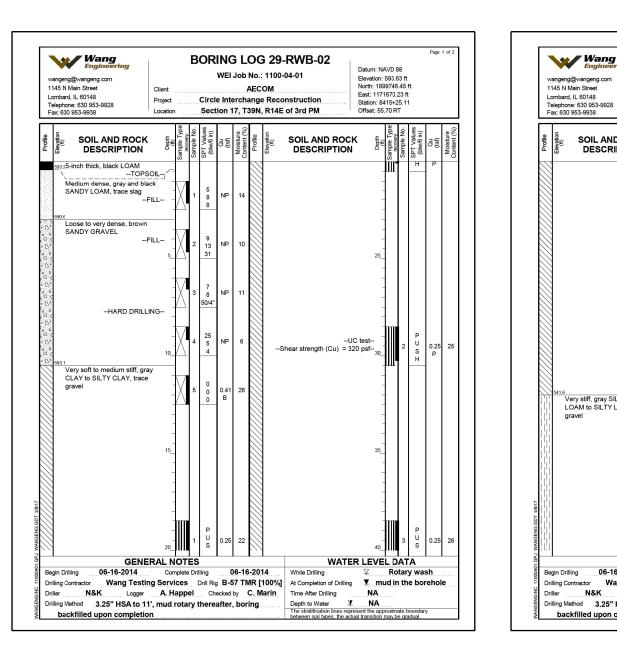


	USER NAME = pateld	DESIGNED - HA	REVISED -		BORING LOGS VIII	F.A.I.	SECTION	COUNTY TOT	FAL SHEET
Image: Second state Image: Second state		CHECKED - AH	REVISED -	STATE OF ILLINOIS	STRUCTURE NO. 016–1700	90/94	2014-016R&B	C00K 378	78 211
BRINCKERHOFI		DRAWN - DCP	REVISED -	DEPARTMENT OF TRANSPORTATION	SINUCIUNE NU. 010-1700			CONTRACT NO.	0. 60X95
016	PLOT DATE = 6/29/2017	CHECKED - JIG	REVISED -		SHEET NO. S1-59 OF S1-60 SHEETS		ILLINOIS FED. A	AID PROJECT	

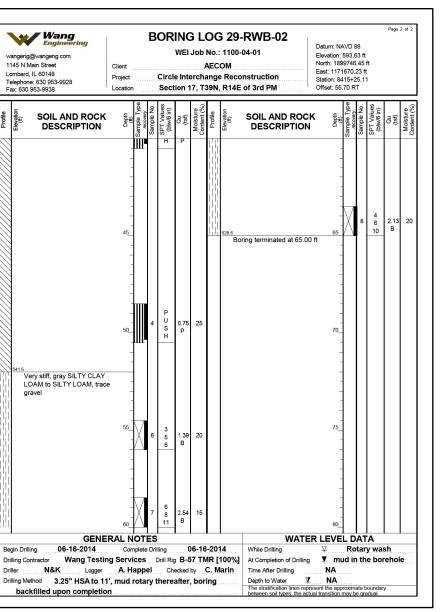

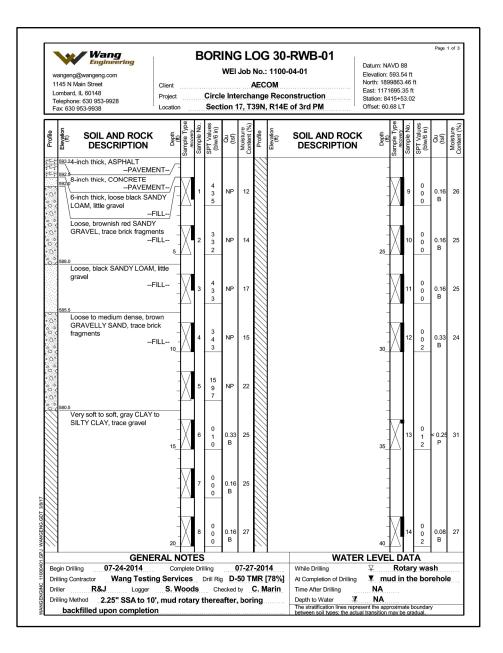

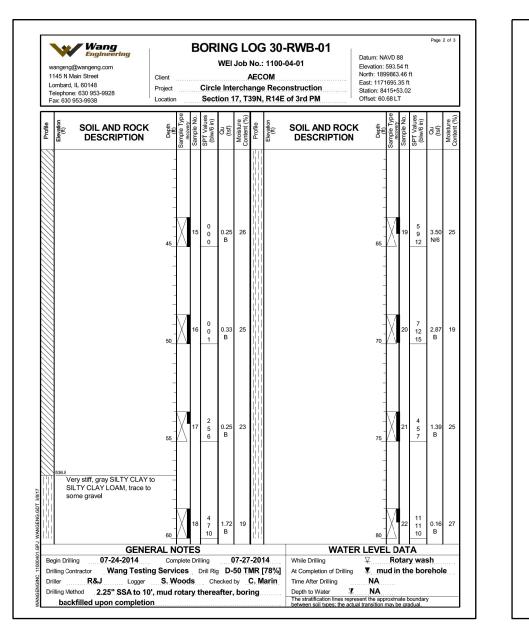



	USER NAME = pateld	DESIGNED - HA	REVISED -		BORING LOGS IX	F.A.I. SECTION	COUNTY TOTAL SHEET
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BRINCKERHOFF	PLOT SCALE = N.T.S.	DRAWN - DCP	REVISED -	DEPARTMENT OF TRANSPORTATION			CONTRACT NO. 60X95
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levation (ft)

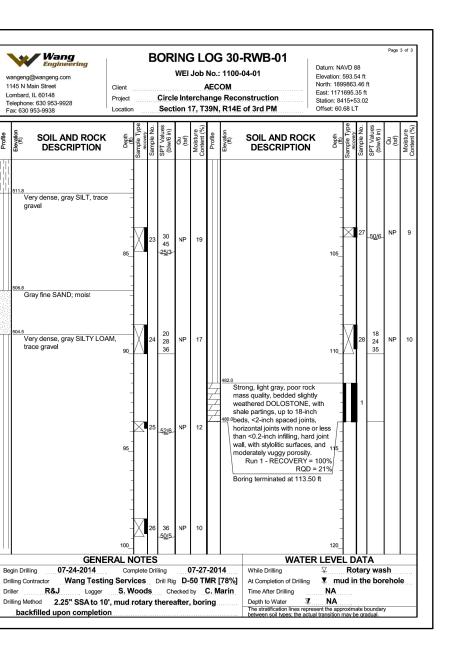
Driller



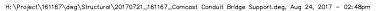

H:\Project\161167\dwg\Structural\20170721_161167_Comcast Conduit Bridge Support.dwg, Aug 24, 2017 - 02:49pm

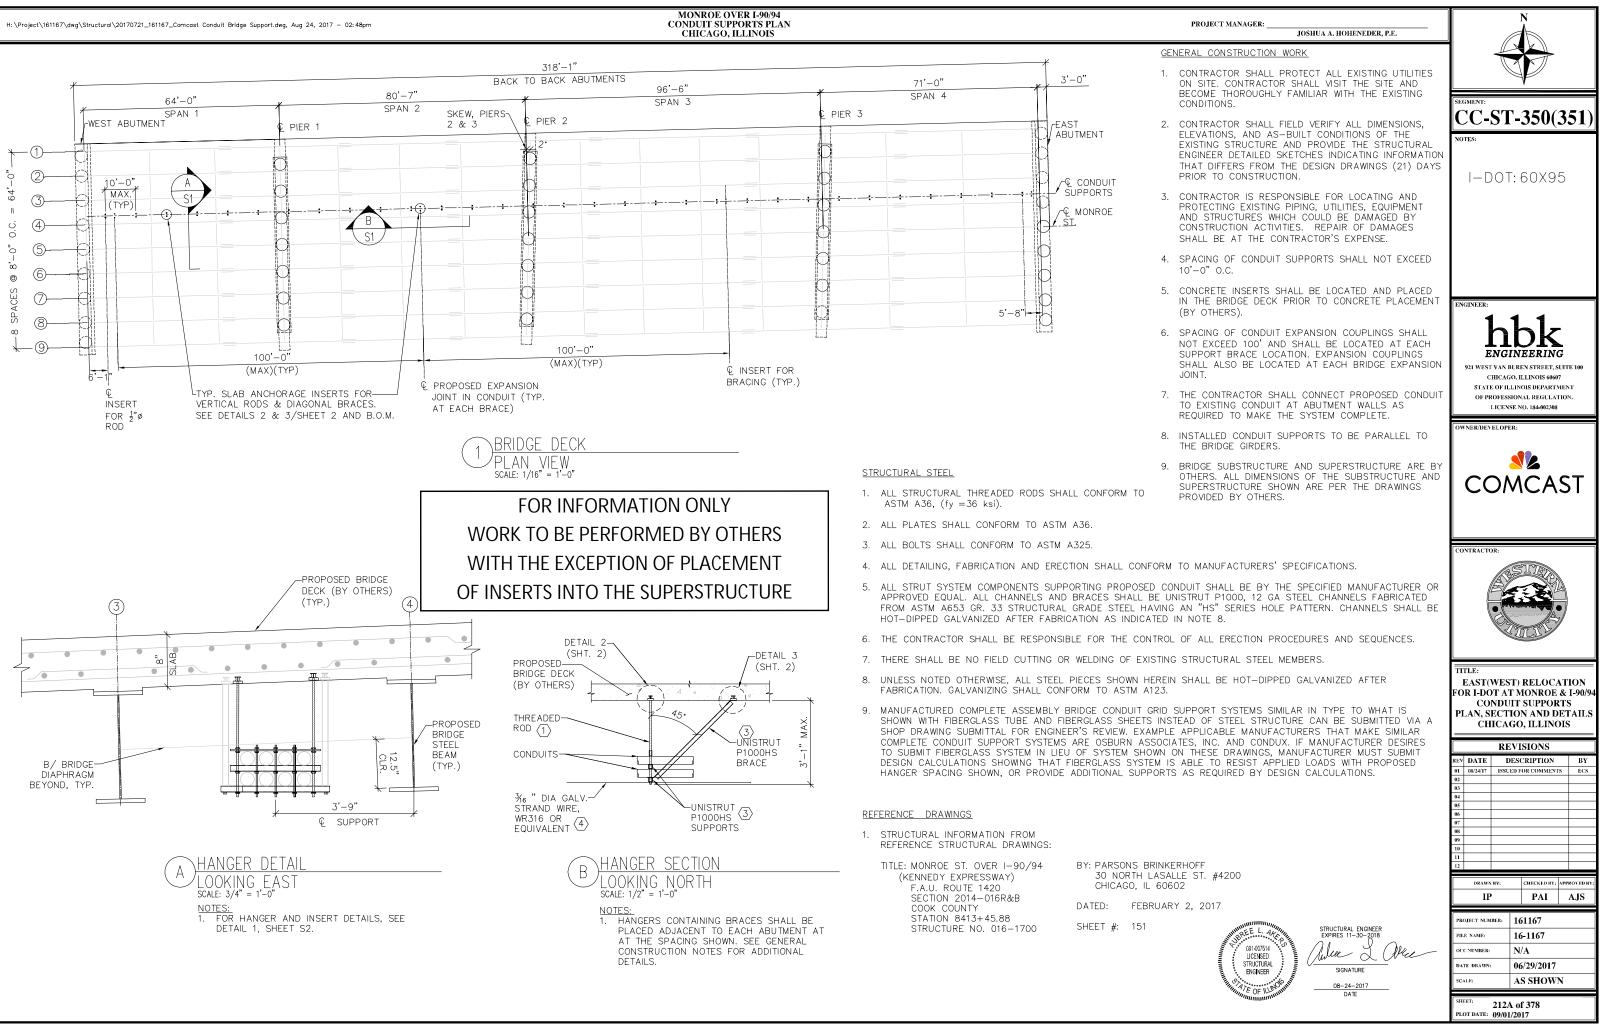MONROE OVER I-90/94 CONDUIT SUPPORT DETAILS CHICAGO, ILLINOIS

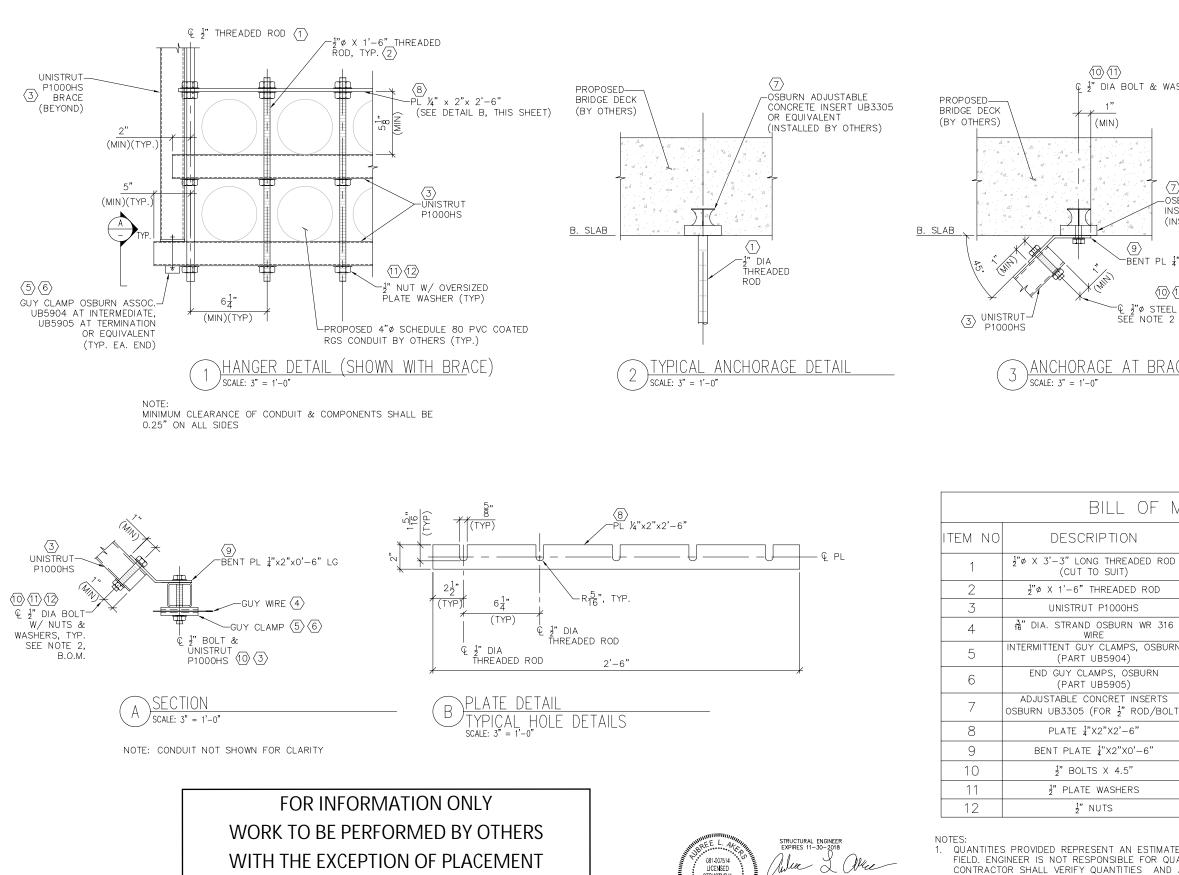

OF INSERTS INTO THE SUPERSTRUCTURE





FIELD. ENGINEER IS NOT RESPONSIBLE FOR QU CONTRACTOR SHALL VERIFY QUANTITIES AND TO COMPLETE THE SYSTEM INSTALLATION PRIC

STANDARD STEEL BOLTED CONNECTIONS ARE REQUIRE THAT NUTS AND HARDWARE ARE ALI 2. CONTRACTOR TO VERIFY THAT FASTENING SYSTEM SHOWN CONFORMS TO STRUT MANUFACTURER'S SPECIFICATIONS OR PROVIDE ASSEMBLY DRAWING FOR REVIEW BY ENGINEER OF RECORD.

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	QTY	UNIT	MATERIAL			•			•	
D	202	LINEAR FEET	ASTM A36			R		LIL	7/	
	139.5	LINEAR FEET	ASTM A36							
	170.5	LINEAR FEET	ASTM A653 GR. 33	1				RELOC		
6	640	LINEAR FEET	SEE CATALOG	FO.		NDU	IT	IONROH SUPPOI AILS		
IRN	62	EACH	SEE CATALOG	_	CE			, ILLIN	015	
	4	EACH	SEE CATALOG	REV	DATE			SIONS		BV
;)LT)	70	EACH	SEE CATALOG	01 02	DATE 08/24/17			DR COMMEN	18	BY ECS
	31	EACH	ASTM A36	03 04 05						
	16	EACH	ASTM A36	96 97						
	32	EACH	ASTM A325	08 09 10						
	676	EACH	ASTM F436	10						
	644	EACH	ASTM A563		DRAW	N BY:		CHECKED BY:	APP	ROVED BY:
					II			PAI		AJS
ATE ()F THE FX	KACT QUANTITIE	S REQUIRED IN THE	PR	OJECT NUN	IBER:	16	1167	-	
)UAN	TITY TO E	BE ORDERED FOR	R CONSTRUCTION. URPLUS AS REQUIRED		E NAME:			-1167		
IOR ⁻	to final	PURCHASE.		ou	C NUMBER		N/	A	_	_
		EVER, STRUT MA OF THE SAME N	ANUFACTURER MAY Manufacturer.	DA	TE DRAWN	:	06	/29/2017		
′STE№	1 SHOWN	CONFORMS TO		sc	ALR:		A	5 SHOW	N	

212B of 378 PLOT DATE: 09/01/2017

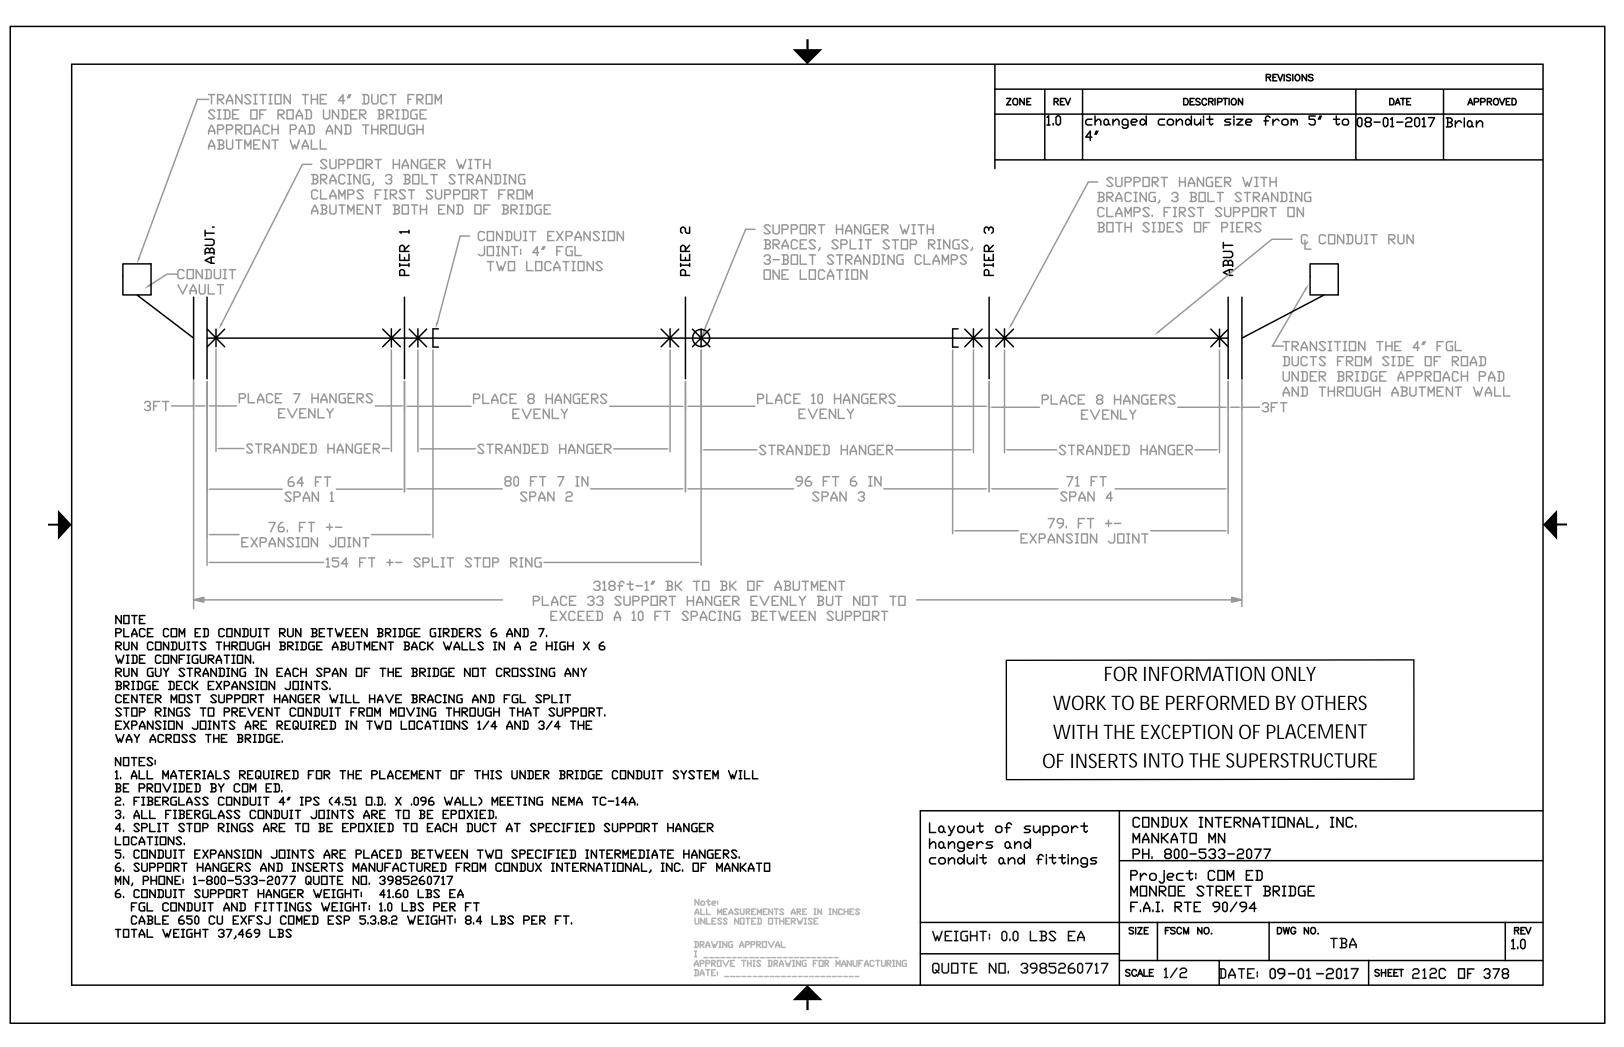

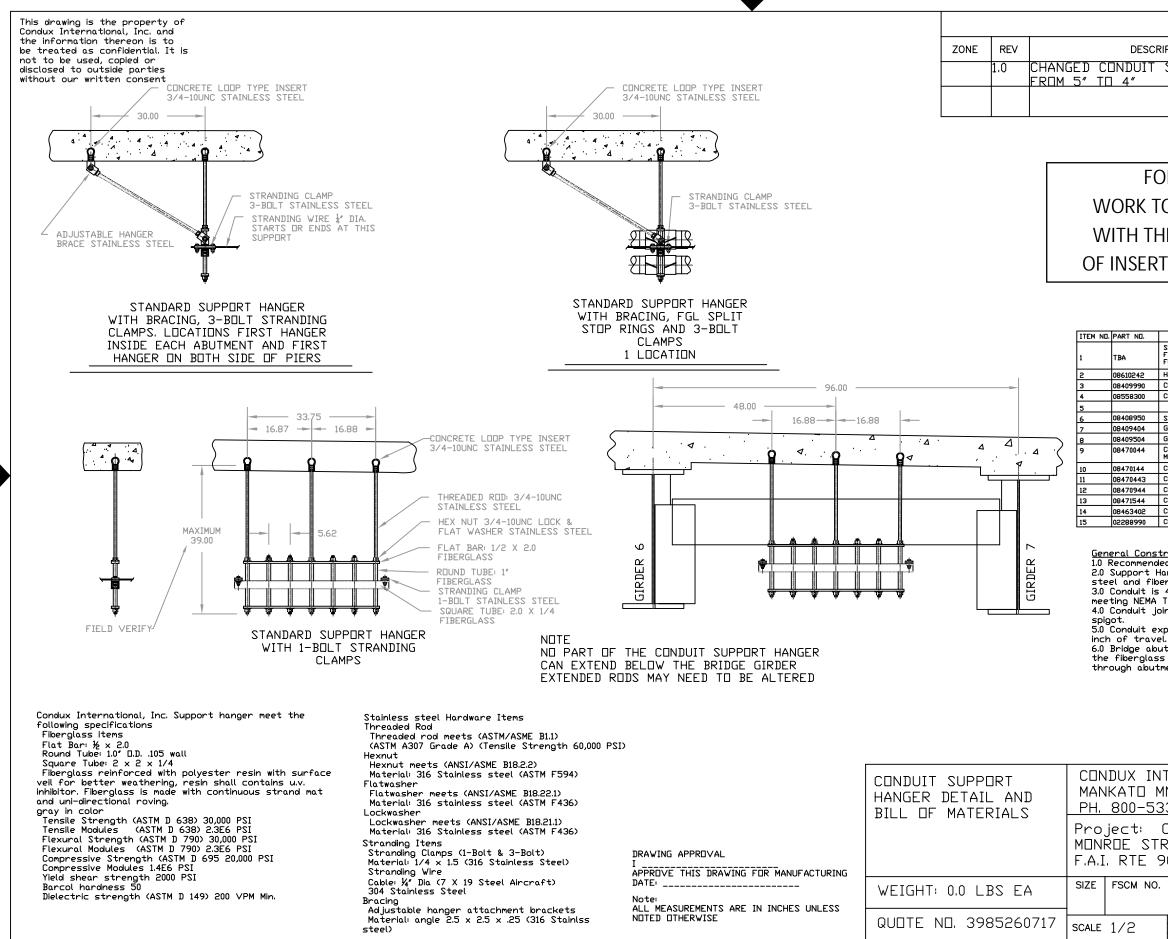

REVISIONS		
DESCRIPTION	DATE	APPROVED
UIT SIZE	08-01-2017	BRIAN

FOR INFORMATION ONLY WORK TO BE PERFORMED BY OTHERS WITH THE EXCEPTION OF PLACEMENT OF INSERTS INTO THE SUPERSTRUCTURE

BILL OF MATERIAL


ND.	DESCRIPTION	QTY	UNIT
	STANDARD CONDUIT SUPPORT HANGER: 2 HIGH X 6 WIDE FIBERGLASS AND STAINLESS STELL, UPENING FOR TVELVE 4* FGL DUCTS THREADED RDDS THREE @ 3/4-10UNC X 39.00 LONG	33	EA.
242	HANGER BRACE ADJUSTABLE: 42 INCH STAINLESS STEEL	16	EA.
9990	CONCRETE INSERT: 3/4-10 LOOP TYPE, STAINLESS STEEL	115	EA.
8300	CONCRETE INSERT SETTING PLUG: 3/4-10	115	EA.
3950	STRANDING WIRE 1/4 X 500 FT., STAINLESS STEEL	2	EA.
9404	GUY STRAND CLAMP: 3-BOLT, STAINLESS STEEL	16	EA.
9504	GUY STRAND CLAMP: 1-BOLT, STAINLESS STEEL	50	EA.
0044	CONDUIT FIBERGLASS: 4" IPS, MW (4.51 D.D. X .096 WALL) MEETING NEMA TC-14A	4800	FT.
0144	CONDUIT STOP COUPLING: 4" IPS MW	24	EA.
0443	CONDUIT EXPANSION JOINT O-RING TYPE: 4" IPS MW	24	EA.
0944	CONDUIT SPLIT STOP RING: 4" IPS MW	24	EA.
1544	CONDUIT ADAPTER: 4" IPS MW TO 4" GRC	24	EA.
3402	CONDUIT EPDXY ADHESIVE CARTRIDGE:	30	EA.
8990	CONDUIT EPOXY ADHESIVE GUN	1	EA.

<u>General Construction, Hanger and Conduit Notes</u> 1.0 Recommended spacing between Support is 10 foot. 2.0 Support Hanger Material shall be manufactured using 316 stainless steel and fiberglass components. 3.0 Conduit is 4 inch Fiberglass with minimum wall thickness of .096 inch meeting NEMA TC-14A Specs. 4.0 Conduit joints shall be positive locking adhesive bonded bell and

5.0 Conduit expansion joints shall be sliding sleeve with provision for 8

6.0 Bridge abutments must have a block out or be sleeved to allow the fiberglass conduit to pass through. After conduit is placed through abutment seal up opening with state approved sealant.

	IONAL, INC.								
0 MN 0-533-2077	7								
Com Ed STREET BRIDGE E 90/94									
/ NO.	dwg no. TBA					rev 1.0			
2 DATE:	09-01-2017	SHEET	212D	OF	378	3			

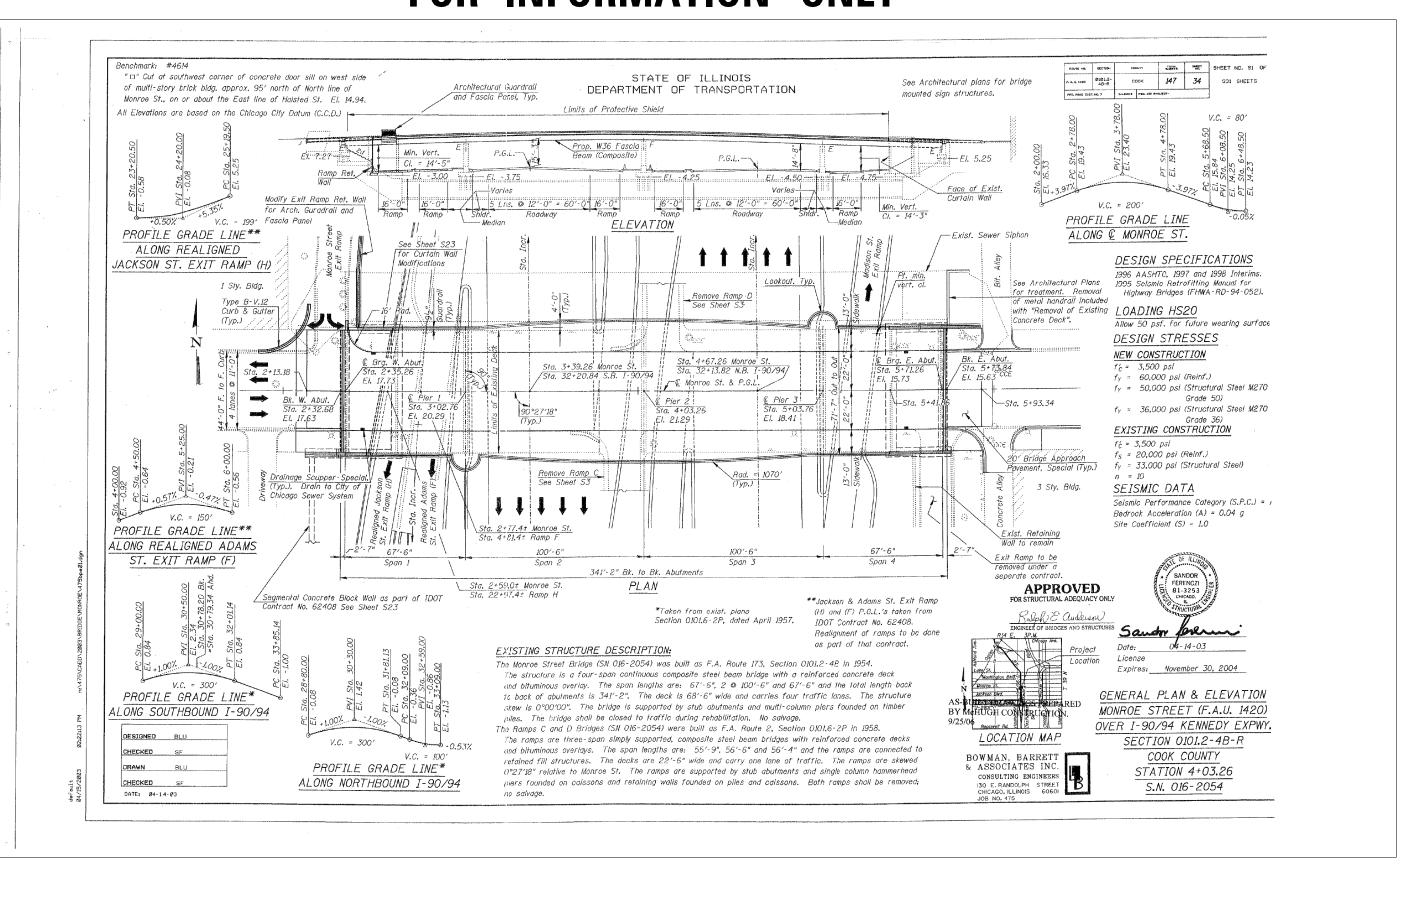

	USER NAME = pateld	DESIGNED -	REVISED -		EXISTING PLANS	F.A.I. SECTION COUNTY SHEETS NO.	
PARSONS		CHECKED -	REVISED -	STATE OF ILLINOIS	STRUCTURE NO. 016–2054	90/94 2014-016R&B COOK 378 213	
BRINCKERHOFF	PLOT SCALE = N.T.S.	DRAWN - DCP	REVISED -	DEPARTMENT OF TRANSPORTATION	31NUCTURE NO. 010-2034	CONTRACT NO. 60X95	
	PLOT DATE = 5/15/2017	CHECKED - JIG	REVISED -		SHEET NO. 1 OF 87 SHEETS	ILLINOIS FED. AID PROJECT	

GENERAL NOTES

Fasteners shall be high strength bolts. Bolts 7_8 " ϕ , open holes ${}^{15}_{16}$ " ϕ . unless otherwise noted

Calculated weight of Structural Steel: M270 Grade 50 = 252,570 lbs M270 Grade 36 = 7660 lbs.

Field welding of construction accessories will not be permitted to beams or airders.

Anchor bolts shall be set before bolting diaphragms over supports.

The main load carrying member components subject to tensile stress shall conform to the Supplemental Requirements for Notch Toughness Zone 2. These components are the wide flange beams and all splice plate material except fill plates.

Reinforcement bars shall conform to the requirements of AASHTO M31, M42 or M53 Grade 60.

Plan dimensions and details relative to existing structure have been taken from existing plans and are subject to nominal construction variations. It shall be the Contractor's responsibility to verify such dimensions and details in the field and make necessary approved adjustments prior to construction or ordering of materials. Such variations shall not be cause for additional compensation for a change in the scope of the work, however, the Contractor will be paid for the quantity actually furnished at the unit price bid for the

Bridge Seat Sealer shall be applied to the seat area of the abutments.

The existing structural steel coating contains lead. The Contractor should take appropriate precautions to deal with the presence of lead on this project.

Cleaning and painting of the existing structural steel shall be as specified in the Special Provision for "Cleaning and Painting Existing Steel Structures". All beams, bearings and other structural steel within 5 feet (measured along the beams) of either side of deck joints shall be cleaned per Near White Blast Cleaning -- SSPC-SPIO. All remaining structural steel shall be cleaned per Power Tool Cleaning -- Modified SSPC-SP3.


The designated areas cleaned per Near White Blast Cleaning -- SSPC-SP10 shall be painted according to the requirements of Paint System 1 - 0Z/E/U. The designated areas cleaned per Power Tool Cleaning -- Modified SSPC-SP3 shall be painted according to the requirements of Paint System 2 - PS/EM/U. The color of the final finish coat for all steel surfaces shall be Gray, Munsell No 58 7/1

The Inorganic zinc rich primer/Acrylic/Acrylic Paint System shall be used for shop and field painting of new structural steel except where otherwise noted. The color of the final finish coat for all steel surfaces shall be Gray Munsell No. 5B 7/1. See Special Provision for "Cleaning and Painting New Metal Structures".

Bearing seat surfaces shall be constructed or adjusted to the designated elevations within a tolerance of l_{θ} inch. Adjustment shall be made either by grinding the surface or by shimming the bearing. Two l_g adjusting shims, of the dimensions of the bottom bearing plate, shall be provided for each bearing in addition to all other plates or shims. For Type I Elastomeric Bearings, two ${}^{\prime}_{8}$ " adjusting shims shall be provided for each bearing and placed as detailed.

Slope wall shall be reinforced with welded wire fabric, 6" x 6" - W4.0 x W4.0, weighing 58 lbs. per 100 sq. ft.

All construction joints shall be bonded.

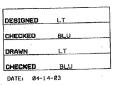

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STATE OF ILLINDIS DEPARTMENT OF TRANSPORTATION


TOTAL BILL OF MATERIAL


	UNIT	SUPER	SUB	TOTAL
ITEN	Cu. Yd.	-	188	188
Structure Excavation	Each	2	-	2
Removal of Existing Structures	Each	1	-	1
Removal of Existing Concrete Deck	Pound	201,230	·	201,230
Structural Steel Removal	Sa. Yd.	2,950	-	2,950
Protective Shield	Each		40	40
Jack and Remove Existing Bearings	Cu. Yd.		170.1	170.1
Concrete Removal				
Cleaning and Painting Steel	L. Sum	1	-	1
Bridge No. 1				
Containment and Disposal of	L. Sum	1	1 e	1
Lead Paint Cleaning Residues No. 1				
Furnishing and Erecting Structural	L. Sum	0.5	-	0.5
Steel	E al	9.080		9,080
Stud Shear Connectors	Each	9,080	24	24
Elastomeric Bearing Assembly Type I	Each		24	24
Electomeric Rearing Assembly Type 11	Each	140	- 24	140
Neoprene Expansion Joint 2'2"	Foot	973.4		973.4
Concrete Superstruciure	Cu. Yd.	973.4	122.5	122.5
Concrete Structures	Cu. Yd.	174,130	15,240	189,370
Reinforcement Bars, Epoxy Coated	Pound	114,150	277	277
Bridge Seat Sealer	Sq. Ft.	0.070	- 211	2,872
Protective Coat	Sq. Yd.			1,583
Bridge Deck Grooving	Sq. Yd.	1,583	0.5	0.5
Drainage System	L. Sum		0.5	4
Drainage Scuppers (Special)	Each	4	777	373
High Performance-Enhanced Shotcrete	Sq. Ft		373	15
Fooxy Crack Sealing	1001		15	0.5
Temporary Shoring and Cribbing	L. Sun		0.5	161
Slope Wall 4 Inch	Sq. Yd		161	97
Earth Excavation	Cu. Yd		97	
Bar Solicers	Each		99	99
Temporary Soll Retention System	Sq. Ft	<u> </u>	470	470


Prior to pouring the new concrete deck, all loose rust, loose mill scale, and other loose potentially detrimental foreign material shall be removed from the surfaces of the beams or girders in contact with concrete. The cost of this work will be included in the pay item covering removal of the existing concrete. All heavy rust and other tightly adhered potentially detrimental foreign matter All neavy rust and other tightly danered potentially detrimental roteign matter shall also be removed from the surfaces of the beams or girders in contact with concrete. Tightly adhered paint may remain unless otherwise noted. This removal shall be accomplished by methods that will not damage the steel. The cost of this work will be paid for according to Article 109.04.


All existing construction accessories welded to the top flange over the pler between the quarter points of the beams or girders shall be removed. The remaining weld shall be ground smooth and inspected for cracks using magnetic particle testing. Any cracks that can not be removed by grinding approximately Place nosing material only 4 inch deep shall be identified and reported to the Bureau of Bridges and Structures for further disposition. The cost of this work will be paid for according to Article 109.04.

A minimum of 2 air monitors will be required to monitor obrasive blasting operations at this slie, see special provision for "Containment and Disposal of Lead Paint Cleaning Residues".

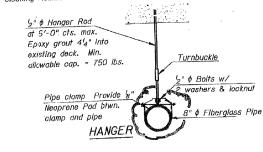

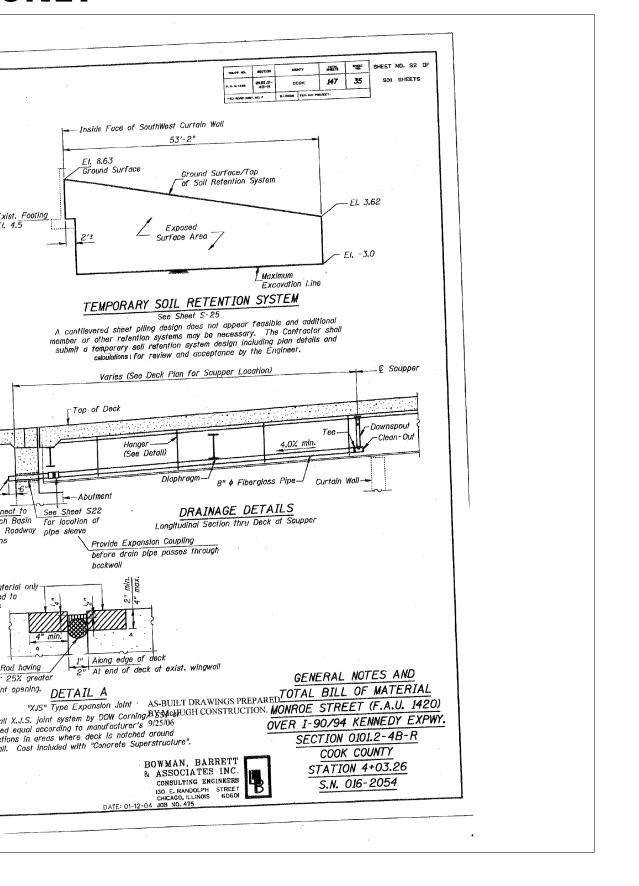

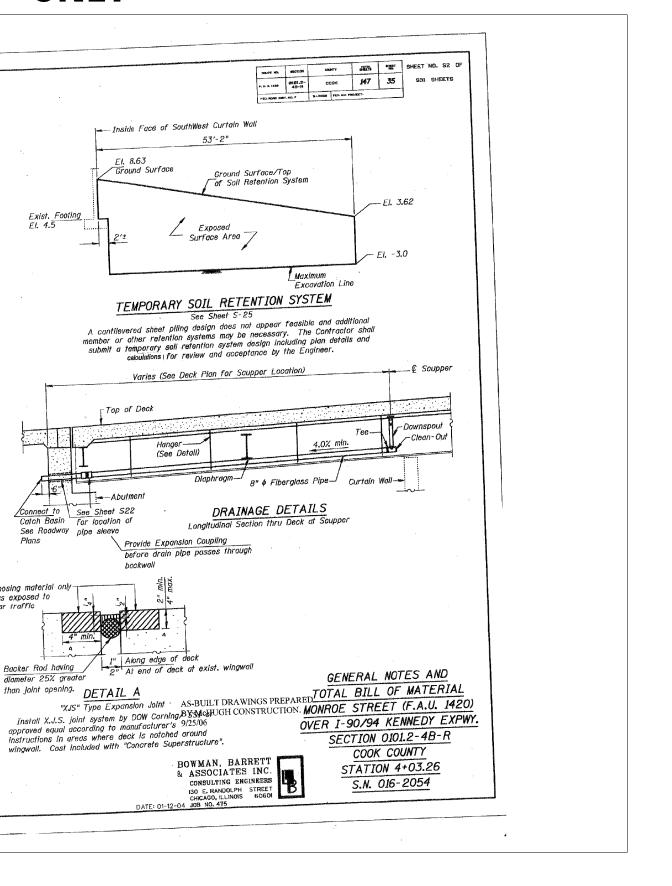


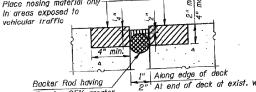

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& ASSOCIATES	INC
CONSULTING ENG	
130 E. RANDOLPH CHICAGO, ILLINOIS	STREE 6060


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016		PLOT DATE = 5/15/2017	CHECKED - JIG	REVISED -		SHEET NO. 2 OF 87 SHEET

LANS RTE. SECTION COUNTY SHEETS NO.						
	LANS	F.A.I. RTE.	SECTION	COUNTY		SHEET NO.
016–2054 90/94 2014–016R&B COOK 378 214	016_205/	90/94	2014-016R&B	СООК	378	214
CONTRACT NO. 60X95	010-2034			CONTRACT	' NO. 6	0X95
7 SHEETS ILLINOIS FED. AID PROJECT	7 SHEETS		ILLINOIS FED. AI	D PROJECT		

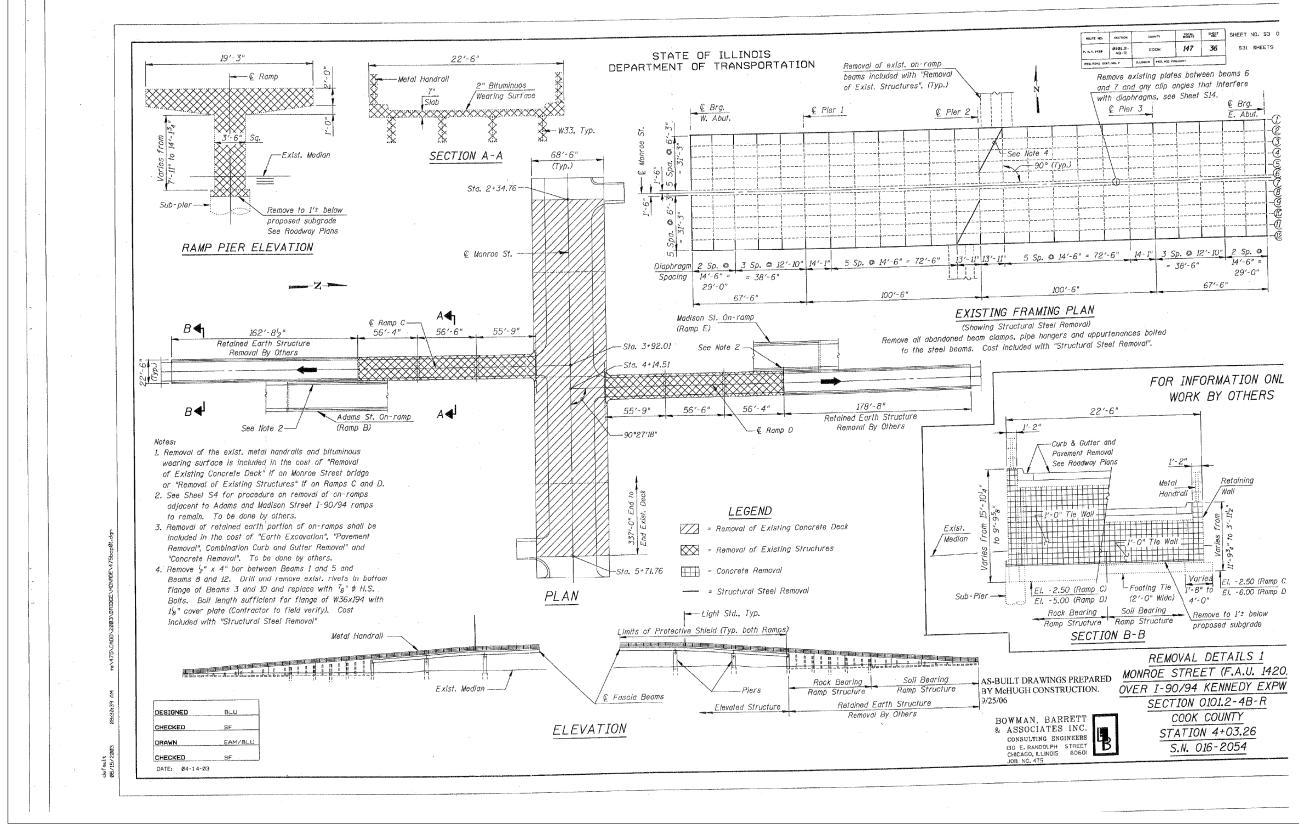


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21 E	BRINCKERHOFF	PLOT SCALE =	N.T.S.	DRAWN - DCP	REVISED -	DEPARTMENT OF TRANSPORTATION	STRUCTURE NO. 016–2054	CONTRACT NO. 60			
016		PLOT DATE =	5/15/2017	CHECKED - JIG	REVISED -		SHEET NO. 3 OF 87 SHEETS		ILLINOIS FED. AID PROJECT		

	ROUTE NO.	SECTION	Ceu	NTY	HILETS	SHEET HD.	SHEET NO.	S3
	P. A. U. 1428	Ø101.2- 48-R			147	36	S31 SHE	ETS
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14'-6"	= 72'-	6"	14 - 1 ⁰	35	p. @ 1	2'-10"	2 Sp. @	
					38'-6"			
00′-6"				1		67'-6		

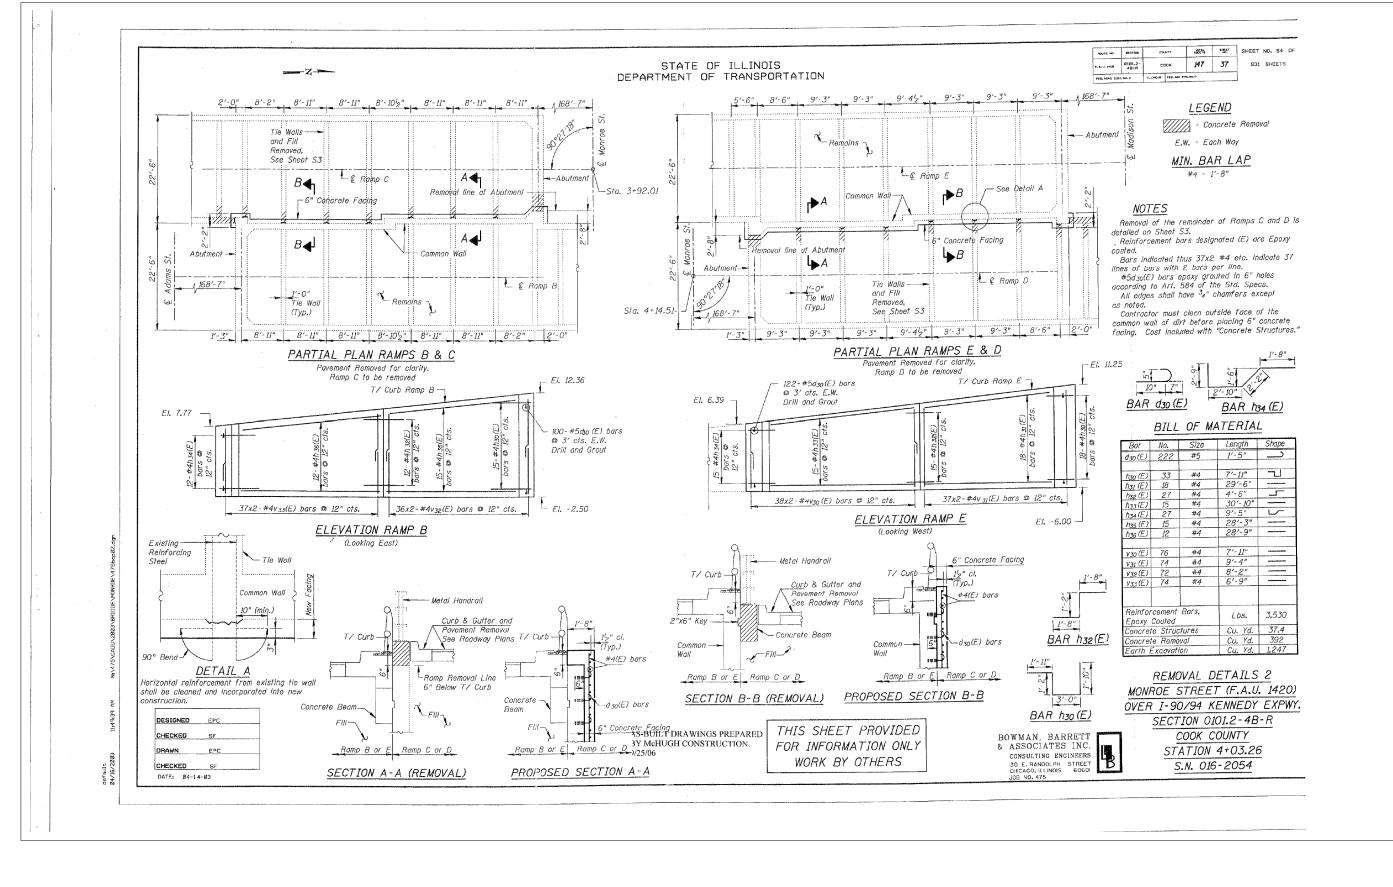

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BRINCKERHOFF	PLOT SCALE = N.T.S.	DRAWN - DCP	REVISED -	DEPARTMENT OF TRANSPORTATION			CONTRACT NO. 60X95
016	PLOT DATE = 5/15/2017	CHECKED - JIG	REVISED -		SHEET NO. 4 OF 87 SHEETS	ILLINOIS	ED. AID PROJECT

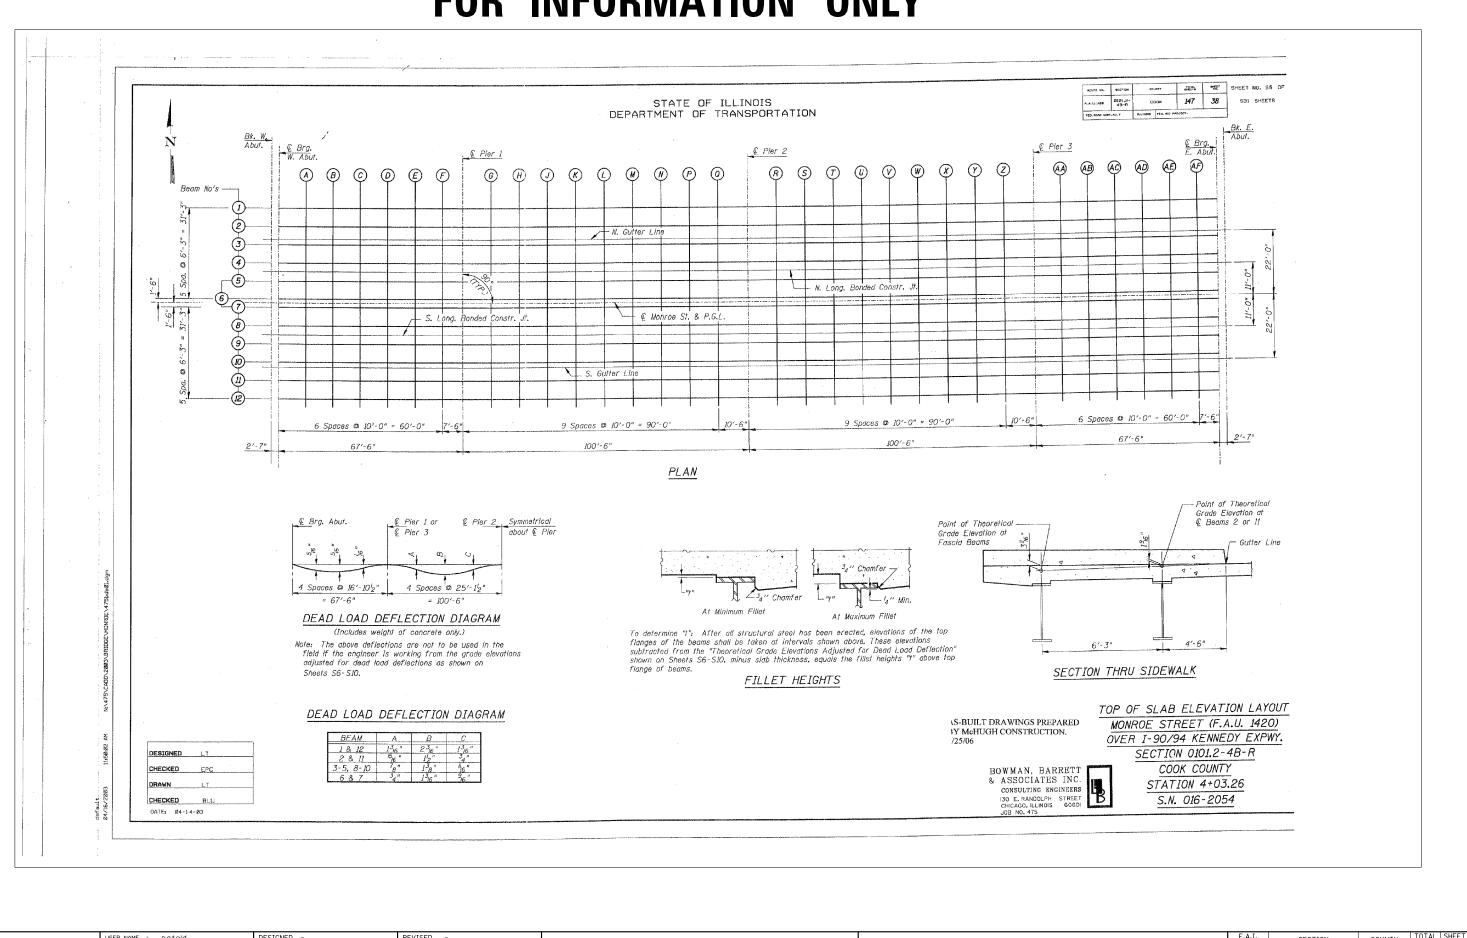

LANS	RTE.	SE	CTION			COUNTY	SHEETS	NO.
016-2054	90/94	2014	-016R&E	3		COOK	378	217
						CONTRACT	NO. (60X95
7 SHEETS			ILLINOIS	FED.	AID	PROJECT		

STATE OF ILLINOIS DEPARTMENT OF TRANSPORTATION

	!	BEAM	<u>1</u>		
Location	Station	Offset	Theoretical Grade Elevations	Theoretical Grade Elevations Adjusted For Dead Load Deflection	Locatio
Bk. West Abut.	2+32, 68	-32,750	17.006	17.006	Bk. West
¢ Brg. West Abut.	2+35, 26	-32.750	17.108	17.108	€ Brg. We
A B C D E F	2+45.26 2+55.26 2+65.26 2+75.26 2+85.26 2+95.26	-32.750 -32.750 -32.750 -32.750 -32.750 -32.750 -32.750	17.505 17.902 18.299 18.696 19.083 19.431	17.529 17.940 18.337 18.720 19.087 19.424	A B C D E F
¢ Pler 1	3+02.76	-32.750	19.666	19.666	¢ Pier
G H J K L M N P O	3+12.76 3+22.76 3+32.76 3+52.76 3+52.76 3+62.76 3+62.76 3+72.76 3+82.76 3+82.76	- 32, 750 - 32, 750	19. 945 20. 184 20. 384 20. 543 20. 664 20. 744 20. 785 20. 786 20. 747	19. 984 20. 278 20. 527 20. 720 20. 848 20. 911 20. 911 20. 660 20. 672	G H J K L M N Q
© Pler 2	4+03.26	-32.750	20.663	20. 663	€ Plen
R S T U V W X Y Z	4+13, 26 4+23, 26 4+33, 26 4+43, 26 4+53, 26 4+63, 26 4+63, 26 4+73, 26 4+83, 26 4+93, 26	-32.750 -32.750 -32.750 -32.750 -32.750 -32.750 -32.750 -32.750 -32.750	20, 543 20, 383 20, 184 19, 945 19, 666 19, 347 18, 989 18, 596 18, 199	20.566 20.455 20.308 20.110 19.851 19.525 19.135 18.693 18.241	R S T W X Z
⊈ Pler 3	5+03.76	~32.750	17, 782	17. 782	€ Pier
AA AB AC AD AE AF	5+13, 76 5+23, 76 5+33, 76 5+43, 76 5+53, 76 5+63, 76	-32, 750 -32, 750 -32, 750 -32, 750 -32, 750 -32, 750	17.385 16.988 16.591 16.194 15.797 15.400	17.379 16.997 16.619 16.233 15.833 15.419	AA AB AC AD AE AF
© Brg. Eost Abut.	5+71.26	-32.750	15, 107	15.107	€ Brg. Ed
Bk. East Abut.	5+73.84	-32,750	15.010	15.010	Bk. Eas

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DATE: 04-14-03

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Location	Station	Offset	Theoretical Grade Flevations	Theoretical Grade Elevations Adjusted For Dead Load
				Deflection
k, West Abut.	2+32.68	-26.500	17.136	17.136
Brg. West Abut.	2+35.26	-26,500	17.238	17.238
A	2+45.26	-26.500	17.635	17.656
8	2+55.26	-26.500	18.032	18, 462
с	2+65.26	-26.500	18.429	18.849
D	2+75.26	-26.500	18,826	19, 220
E	2+85.26	-26.500	19.213	19.558
F	2+95.26	~26.500	19.561	
¢ Pler 1	3+02.76	-26, 500	19.796	19.796
G	3+12.76	-26.500	20.075	20,098
н	3+22.76	-26.500	20.314	20.374
J	3+32,76	-26, 500	20.514	20,608
	3+42.76	-26, 500	20.674	20.792
ĸ		-26, 500	20.794	20.917
L	3+52,76		20.874	20, 984
M	3+62.76	-26.500	20. 915	20.995
N	3+72,76	-26.500		20.959
Р	3+82.76	~26.500	20.916	20. 890
۵	3+92.76	-26,500	20. B77	
⊈ Pier 2	4+03.26	-26.500	20.794	20.794
R	4+13.26	-26,500	20.673	20.685
S	4+23,26	-26.500	20.514	20.555
T	4+33,26	-26,500	20, 314	20, 393
L L	4+43.26	-26.500	20.075	20, 183
v	4+53.26	-26.500	19,796	19.919
w	4+63.26	-26.500	19,477	19.596
	4+73.26	-26.500	19,119	19.215
×		~26, 500	18.726	18.788
YZ	4+83.26	-26.500	18.329	18.354
	5+03.76	-26.500	17.913	17.913
€ Pier 3	5403.76	-20, 500		
AA	5+13,76	-26.500	17.516	17.513
AB	5+23,76	-26, 500	17.119	17.129
AC	5+33.76	-26, 500	16.722	16.748
AD	5+43.76	-26.500	16.325	16.359
AE	5+53.76	-26,500	15.928	15, 958
AF	5+63,76	-26.500	15,531	15.546
Brg, East Abut.	5+71.26	-26.500	15.238	15.238
3k. East Abut.	5+73.84	-26.500	15.140	15.140

Location	Station	Offset	Theoretical Grade Elevations	Theoretical Grade Elevations Adjusted For Dead Load Deflection	Location
Bk. West Abut.	2+32.68	-22.000	17.230	17, 230	Bk. West Abu
Brg. West Abut.	2+35.26	~22.000	17.332	17.332	⊈ Brg. West /
	2+45, 26	-22,000	17,729	17.748	A
A	2+15.26	-22,000	18.126	18.156	8
В	2+55.26	-22,000	18.523	18.553	С
с.	2+65.26	-22,000	18.920	18,941	0
D		-22,000	19.307	19.313	E
E	2+85.26	-22,000	19.655	19,652	F F
F	2+95.26	-22,000	15.055		
¢Pler 1	3+02.76	-22.000	19.890	19.890	¢ Pler 1
			20, 169	20, 190	G
G	3+12.76	-22.000		20.463	н
н	3+22,76	-22.000	20.408	20, 694	J
J	3+32.76	-22.000	20.608	20, 875	К
к	3+42.76	-22.000	20.767	21,000	
L	3+52.76	-22.000	20,888	21.000	м
M	3+62.76	-22.000	20.968		N
N	3+72.76	-22,000	21.009	21.082	P
Р	3+82.76	-22.000	21.009	21.049	Q
۵	3+92.76	-22,000	20, 971	20. 983	_
¢ Pier 2	4+03.26	-22.000	20.887	20.887	¢ Pier 2
	4+13,26	-22.000	20, 767	20.778	R
R	4+23, 26	-22.000	20, 607	20.645	S.
S T	4+33.26	-22.000	20, 408	20, 480	T
	4+43.26	-22.000	20, 169	20, 268	U
U		-22,000	19,890	20,002	V V
V	4+53.26	-22.000	19,571	19.679	w w
W	4+63.26			19.301	×
х	4+73.26	-22.000	1	18.876	Y
Y Z	4+83.26 4+93.26	-22,000		18.446	Z
¢ Pier 3	5+03.76	-22.000	18.006	18.006	¢ Pler 3
- AA	5+13.76	-22,000	17,609	17,607	AA
AA	5+23.76	-22,000		17.222	AB
AC	5+33.76	-22.000		16.839	AC
	5+33.16	-22.000		16.449	AD
AD	5453.76	-22,000		16.049	AE
AE	5+53, 76	-22,000		15.639	AF
¢ Brg, East Abut.		-22.000		15.331	¢ Brg. Eas†
A or de l'age wordte	1			15, 234	Bk. East A

NORTH GUTTER LINE

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	PARSONS		CHECKED -	REVISED -	STATE OF ILLINOIS	STRUCTURE NO. 016–2054	90/94	2014-016R&B	соок	378	218
:	Brinck er hoff	PLOT SCALE = N.T.S.	DRAWN - DCP	REVISED -	DEPARTMENT OF TRANSPORTATION				CONTRAC	JT NO. 60	DX95
ΞL		PLOT DATE = 5/15/2017	CHECKED - JIG	REVISED -		SHEET NO. 6 OF 87 SHEETS		ILLINOIS FED.	AID PROJECT		
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BONTE NO.	RETION	001	INTY	HITAL BUELTD	BHEET NO.	SHEET	ND. 56 OF
						1	
n. A. D. 1429	Ø101.2- 48-R	C	рок	147	39	531	SHEETS

BEAM 3

Location	Station	Offset	Theoretical Grade Elevations	Theoretical Grade Elevations Adjusted For Dead Load Deflection
Bk. West Abut.	2+32.68	-20.250	17.266	17.266
🖞 Brg. West Abut.	2+35.26	-20.250	17.369	17.369
A	2+45,26	-20.250	17.766	17.784
8	2+55.26	-20.250	18,163	
c	2+65.26	-20.250	18.560	18.590
0	2+75.26	-20.250	18.957	18,977
	2+85.26	-20,250	19.343	19.349
E		-20, 250	19,692	19,689
F	2+95.26	-20.250	13.052	
¢ Pler 1	3+02.76	-20.250	19.927	19.927
	3.40.70	-20,250	20, 206	20, 227
G	3+12.76		20. 445	20, 499
н	3+22.76	-20.250		20.731
J	3+32.76	-20.250	20.644	20.912
К	3+42.76	-20.250	20,804	
1	3+52,76	-20.250	20, 924	21.037
м	3+62.76	-20,250	21,004	21, 104
Ň	3+72.76	-20,250	21.045	21.118
	3+82.76	-20, 250	21,046	21,086
P	3+92.76	-20, 250	21,007	21.019
a	3+92.76	-20,250	21,000	
¢ Pier 2	4+03.26	-20.250	20.924	20.924
R	4+13.26	~20, 250	20.804	20.814
S	4+23.26	-20,250	20.644	20.682
	4+33.26	-20, 250	20.444	20.516
T	4+33,26	-20, 250	20, 205	20.304
U		-20.250	19,926	20.039
v	4+53.26		19,607	19, 716
, w	4+63.26	-20.250		19, 337
X	4+73.26	-20.250	19.249	18, 913
l y	4+83.26	-20,250	18.857	
Z	4+93.26	-20, 250	18.460	18, 482
¢ Pier 3	5+03.76	- 20. 250	18.043	18.043
	5+13.76	-20, 250	17.646	17.644
AA		-20, 250		17.259
AB	5+23.76			16, 875
AC	5+33.76	-20.250		16, 486
AD	5+43.76			16.086
AE	5+53, 76	-20. 250		
AF	5+63,76	-20.250	15.661	15.675
¢ Brg. East Abu1	. 5+71.26	-20, 250	15, 368	15.368
Bk. East Abut.	5+73.84	-20, 250	15.270	15.270

TOP OF SLAB ELEVATIONS 1 MONROE STREET (F.A.U. 1420) AS-BUILT DRAWINGS PREPARED OVER I-90/94 KENNEDY EXPWY. BY MCHUGH CONSTRUCTION. SECTION 0101.2-4B-R COOK COUNTY BOWMAN, BARRETT & ASSOCIATES INC. CONSULTING ENGINEERS IGO E. RANDOLPH STREET CHICAGO, LLLING'S GOGOI STATION 4+03.26 S.N. 016-2054

STATE OF ILLINOIS DEPARTMENT OF TRANSPORTATION

N. LONGITUDINAL BONDED CONSTR. JOINT

BEAM 5

Offset

-7,750

7.750

-7. 750 -7. 750 -7. 750 -7. 750 -7. 750 -7. 750 -7. 750

-7.750

-7.750 -7.750 -7.750 -7.750 -7.750 -7.750 -7.750 -7.750 -7.750

-7.750

-7. 750 -7. 750 -7. 750 -7. 750 -7. 750 -7. 750 -7. 750 -7. 750 -7. 750 -7. 750

-7.750

7.750 7.750 7.750 7.750 7.750 7.750 7.750

-7.750

Station

2+32.68 2+35.26

2+45.26 2+55.26 2+65.26 2+75.26 2+85.26 2+85.26 2+95.26

3+02.76

3+12.76 3+22.76 3+32.76 3+42.76 3+52.76 3+52.76 3+62.76 3+72.76

3+82, 76 3+92, 76

4+03.26

4+13.26 4+23.26 4+33.26 4+43.26 4+53.26 4+63.26 4+63.26 4+73.26 4+83.26 4+93.26

5+03.76

5+13.76 5+23.76 5+33.76 5+43.76 5+53.76 5+63.76

5+71.26

5+73.84 -7.750

Location

Bk. West Abut.

Brg. West Abu

¢ Pier 1

L M P Q

© Pier 2

z

¢ Pier 3

AA AB AC AD AE AF

¢ Brg. East Abut

8k. East Abut.

						Transferrate statements	
		Theoretical Grade				Theoretical	Theoretical Grade
	Theoretical						Elevations Adjuste
•	Grade	Elevations Adjusted	Location	Station	Offset	Grade	For Dead Load
		For Dead Load				Elevations	
	Elevations	Deflection					Deflection
-			Bk. West Abut.	2+32.68	-1.500	17.608	17.608
	17,510	17.510	BK. West ADUL.	2732,00	1. 500	111000	i
	17.612	17.612	🤅 Brg. West Abut.	2+35.26	-1.500	17.710	17.710
	18.009	18.028	A	2+45,26	-1.500	18, 107	18, 123
	18,406	18, 436	8	2+55.26	-1.500	18,504	18.529
	18, 803	18,833	c	2+65.26	-1.500	18.901	18.927
	19,200	19.221	D	2+75.26	-1.500	19.298	19.315
1	19,587	19.593	E	2+85.26	-1.500	19.684	19.690
		19,932	F	2+95.26	-1.500	20.033	20.030
	19.935	19, 552					
	20.170	20.170	¢ Pier 1	3+02.76	-1.500	20, 268	20. 268
		00.470	G	3+12, 76	-1.500	20. 547	20.565
	20.449	20.470	н	3+22.76	-1.500	20. 786	20.833
	20.688		J	3+32.76	-1.500	20. 985	21.060
	20.888	20.974	· K	3+42.76	-1.500	21, 145	21.238
	21.047	21.155	Ĺ	3+52.76	-1.500	21.265	21.363
	21.167	21.280	M	3+62, 76	-1.500	21.345	21, 432
	21.248	21, 348	N N	3+72, 76	-1,500	21.386	21.450
	21.288	21.362	p	3+82,76	-1.500	21.387	21.422
	21.289	21.329		3+92.76	-1.500	21.348	21.359
	21.251	21.262	Q	3+92.10			
	21.167	21.167	¢ Pler 2	4+03.26	-1.500	21. 265	21, 265
	21,047	21.058	R	4+13.26	-1.500	21.145	21.154
	20.887	20.925	S	4+23.26	-1.500	20.985	21.018
	20.688	20.760	Т	4+33.26	-1.500	20.785	20.848
	20. 449	20.548	U	4+43.26	-1.500	20.546	20.632
	20.170	20, 282	v	4+53,26	-1.500	20.267	20.365
	19.851	19,959	W	4+63.26	-1.500	19.949	20.042
	19.493	19.580	x	4+73, 26	-1.500	19.590	19.666
		19, 156	Ŷ	4+83, 26	-1.500	19.198	19,246
	19.100 18.703	18.726	Z	4+93, 26	-1.500	18.801	18.821
	18.286	18.286	©_Pler 3	5+03.76	-1.500	18.384	18. 384
	17.889	17.887	AA	5+13.76	-1.500	17.987	17.985
	17.889	17.502	AB	5+23.76	-1.500	17.590	17.598
		17, 119	AC	5+33.76	-1,500	17.193	17, 213
	17.095	16.729	AD	5+43.76	-1.500	16.796	16.822
	16.698	16. 329	AE	5+53.76	-1.500	16.399	16. 423
	16.301 15.904	15,919	AF	5+63.76	-1.500	16.002	16.014
					-1.500	15.709	15.709
	15.611	15.611	¢ Brg. East Abut.				
	15.514	15.514	Bk, East Abut.	5+73.84	-1.500	15.612	15,612

Location	Station	Offset	Theoretical Grade Elevations	Theoretical Grade Elevations Adjusted For Dead Load Deflection
Bk. West Abut.	2+32.68	-14.000	17.397	17. 397
¢ Brg. West Abut	2+35. 26	~14.000	17. 199	17.499
A	2+45.26	-14.000	17.896	17.914
8	2+55.26	-14.000	18, 293	18, 323
с	2+65.26	-14,000	18,690	18.720
D	2+75.26	-14,000	19.087	19.107
E	2+85,26	-14,000	19,473	19,480
F	2+95, 26	-14.000	19.822	19.819
¢ Pier 1	3+02.76	-14.000	20.057	20.057
G, 1	3+12.76	-14.000	20, 336	20, 357
н	3+22.76	-14.000	20.575	20.629
J	3+32.76	-14.000	20.774	20.861
К	3+42.76	-14.000	20, 934	21.042
L	3+52.76	-14.000	21.054	21, 167
м	3+62,76	-14.000	21.135	21, 235
N	3+72,76	-14,000	21.175	21, 249
р	3+82,76	-14,000	21, 176	21.216
Q	3+92.76	-14,000	21.137	21.149
ÇPler 2	4+03.26	-14.000	21.054	21.054
R	4+13, 26	~14.000	20.934	20, 945
S	4+23, 26	-14,000	20.774	20, 812
Ţ	4+33.26	-14.000	20, 574	20, 646
U	4+43.26	~14,000	20.335	20. 434
v	4+53,26	-14,000	20.056	20, 169
W	4+63.26	-14,000	19,738	19,846
х	4+73.26	~14,000	19.379	19.467
Y	4+83.26	-14,000	18.987	19.043
Z	4+93.26	-14.000	18.590	18.613
€ Pi⊖r 3	5+03.76	-14.000	18.173	18.173
AA	5+13.76	-14.000	17.776	17.774
AB	5+23.76	-14,000	17.379	17.389
AC	5+33.76	~14.000	16.982	17.006
AD	5+43.76	-14.000	16.585	16.616
AE	5+53.76	-14.000	16.188	16.216
AF	5+63.76	-14.000	15.791	15.805
© Brg. East Abut.	5+71.26	~14.000	15.498	15,498
BK, East Abut,	5+73.84	-14.000	15.401	15.401

BEAM 4

Location	Station	Offset	Theoretical Grade Elevations	Theoretical Grade Elevations Adjusted For Dead Load Deflection
Bk. West Abut.	2+32.68	-11.000	17.459	17.459
🖞 Brg. West Abut.	2+35-26	-11.000	17.561	17.561
A B C. D E F	2+45.26 2+55.26 2+65.26 2+75.26 2+85.26 2+85.26	-11.000 -11.000 -11.000 -11.000 -11.000 -11.000	17.958 18.355 18.752 19.149 19.536 19.884	17.977 18.385 18.782 19.170 19.542 19.681
¢ Pier 1	3+02.76	-11.000	20.119	20.119
C H J K L M N P Q	3+12.76 3+22.76 3+32.76 3+42.76 3+52.76 3+52.76 3+62.76 3+72.76 3+82.76 3+92.76	-11.000 -11.000 -11.000 -11.000 -11.000 -11.000 -11.000 -11.000 -11.000	20, 398 20, 637 20, 837 20, 997 21, 117 21, 197 21, 238 21, 239 21, 200	20. 419 20. 692 20. 923 21. 104 21. 229 21. 297 21. 311 21. 276 21. 212
¢ Pier 2	4+03.26	-11.000	21.116	21.116
R S T V W X Y Z	4+13, 26 4+23, 26 4+33, 26 4+43, 26 4+53, 26 4+63, 26 4+83, 26 4+93, 26 4+93, 26	-11.000 -11.000 -11.000 -11.000 -11.000 -11.000 -11.000 -11.000 -11.000	20. 996 20. 837 20. 637 20. 398 20. 119 19. 800 19. 442 19. 049 18. 652	21.007 20.875 20.705 20.497 20.231 19.909 19.530 19.105 18.675
ÇPler 3	5+03,76	-11.000	18.235	18, 235
AA AB AC AD AE AF	5+13.76 5+23.76 5+33.76 5+43.76 5+53.76 5+63.76	-11.000 -11.000 -11.000 -11.000 -11.000 -11.000	17.838 17.441 17.044 16.647 16.250 15.853	17.837 17.451 17.068 16.678 16.278 15.868
⊈ Brg, East Abjt,	5+71.26	-11.000	15, 560	15.560
Bk. East Abut.	5+73.84	~11.000	15.463	15.463

 DESIGNED
 LT

 CHECKED
 EPC

 DRAWN
 LT

 CHECKED
 BLJ

 DATE:
 94-14-83

default 04/16/20 AS-BUILT DRAWINGS PREPARED BY MCHUGH CONSTRUCTION. 9/25/06


> BOWMAN, BARRETT & ASSOCIATES INC. CONSULTING ENGINEERS IGO E. TANDOLPH STREET CHICACO, BLLINOIS GOGOI JOB NO. 475

	USER NAME = pateld	DESIGNED -	REVISED -		EXISTING PLANS	F.A.I. RTF.	SECTION	COUNTY TO	JTAL SHEET
PARSONS		CHECKED -	REVISED -	STATE OF ILLINOIS	STRUCTURE NO. 016–2054	90/94	2014-016R&B	C00K 37	378 219
BRINCKERHOFF	PLOT SCALE = N.T.S.	DRAWN - DCP	REVISED -	DEPARTMENT OF TRANSPORTATION		-		CONTRACT NO	10. 60X95
010	PLOT DATE = 5/15/2017	CHECKED - JIG	REVISED -		SHEET NO. 7 OF 87 SHEETS		ILLINOIS FED. A	ID PROJECT	

HOUTE HO.	a121.2-		NTY	BOTM. SHERTS	SNEET	SHEET	ND.	57	OF
F, A, U. 1428			181.2- 46-R COOK 147		40	\$31	SHE		
FED. HDAD OID	1.50.7	10.11015	FED. AID P	NOJECT-		1			

BEAM 6

TOP OF SLAB ELEVATIONS 2 MONROE ST. (F.A.U. 1420) OVER I-90/94 KENNEDY EXPWY. SECTION 0101.2-4B-R COOK COUNTY STATION 4+03.26 S.N. 016-2054

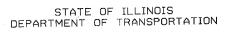

	<u>©</u> M	IONROE	STRE	ET & P.			T	BEAM	7	Theoretical Grade	[BEA	<u>M 8</u> Theoretical	Theoretical Grade	S. LONGITU				Theoretical Gra Elevations Adjus
	Location	Station	Offset	Theorefical Grade Elevations	Theoretical Grade Elevations Adjusted For Dead Load Deflection	Location	Station	Offset	Theoretical Grade Elevations	Elevations Adjusted For Dead Load Deflection	Location	Station	Offset	Grade Elevations	Elevations Adjusted For Dead Load Deflection	Location	Station		Elevations	For Dead Loc Deflection 17.459
	Bk. West Abut.	2+32,68	0, 000	17.631	17.631	Bk. West Abut.	2+32.68	1.500	17.608	17.608	Bk. West Abut.	2+32.68	7.750	17.510	17.510	8k. West Abut.	2+32.68	1	17.561	17.561
	¢ Brg. West Abut.			17.733	17.733	© Brg. West Abut	. 2+35.26	1.500	17.710	17.710	¢ Brg. West Abut.	2+35.26	7,750	17.612	17.612	¢ Brg. West Abut.	2+35, 26		17.958	17.977
	A B	2+45, 26	0.000 0.000	18.130 18.527	18, 146 18, 553	AB	2+45, 26	1.500	18.107 18.504	18.123 18.529	A B C	2+45.26 2+55.26 2+65.26		18.009 18.406 18.803	18.028 18.436 18.833	A B C	2+65.26 2+65.26 2+75.26	11.000 11,000	18.355 18.752 19.149	18. 385 18. 782 19. 170
	. C D	2+65.26 2+75.26	0.000 0.000	18,924 19,321	18.950 19.334	CD	2+65.26	1.500 1.500 1.500	18, 901 19, 298 19, 684	18,927 19,315 19,690	DE	2+75.26 2+85.26	7.750 7.750	19.200 19.587	19.221 19.593	D E	2+95.26	11.000	19.536 19.884	19.542 19.881
	E F	2+85.26 2+95.26	0.000	19, 708 20, 056	19. 713 20. 054	E. F	2+85.26		20.033	20.030	F	2+95.26		19.935 20.170	19.932 20.170	¢ Pier 1	3+02.76	11.000	20.119	20.119
	¢ Pier 1	3+02.76	0.000	20.291	20. 291	¢ Pier 1	3+02.70		20. 268	20. 268	¢ Pler 1 G	3+02, 76		20, 449	20.470	СН	3+12.76 3+22.76		20.398 20.637	20. 419 20. 692
	G H	3+12.76	0.000	20.570	20, 589 20, 856	G	3+12.70 3+22.70 3+32.70	6 1.500	20.547 20.786 20.985	20, 565 20, 833 21, 060	H H	3+22, 76 3+32, 76	7.750	20.688 20.888	20.743 20.974 21.155	JK	3+32.76 3+42.76	11.000 11.000	20.837 20.997	20. 923 21. 104 21. 229
	ĸ	3+32,76 3+42,76 3+52,76	0.000	21.009 21.168 21.289	21.084 21.262 21.386	J K L	3+42.76	6 1.500	21.145	21.238 21.363	K L	3+42.76	7.750 7.750 7.750	21.047 21.167 21.248	21. 135 21. 280 21. 348	L M	3+52.76 3+62.76	11.000	21.117 21.197 21.238	21. 225
	M	3+62,76	0.000	21. 369 21. 410	21. 388 21. 456 21. 473	M	3+62.76	6 1.500 6 1.500	21.345 21.386	21.432 21.450	M N P	3+62.76 3+72.76 3+82.76	7.750	21. 288	21.362 21.329	N	3+72.76 3+82.76 3+92.76	41.000	21, 238	21, 278
	P	3+82.76 3+92.76	0.000	21.411 21.372	21.445 21.382	P Q	3+82.74	6 1.500	21. 387 21. 348	21. 422 21. 359	, a	3+92. 76	7.750	21.251	21.262	¢ Plar 2	4+03.26		21.116	21.116
	¢ Pler 2	4+03.26	0.000	21.288	21. 288	€ Pier 2	4+03.2	6 1.500	21. 265	21.265	¢ Pier 2	4+03.26		21.167	21.167	R	4+13.26	11.000	20, 996	21.007 20.875
	R	4+13.26 4+23.26		21.168 21.008	21.177 21.041	R	4+13.2 4+23.2	6 1.500	21,145 20,985	21.154 21.018	RS	4+13.26 4+23.26 4+33.26	7.750	21.047 20.887 20.688	20. 925	s T	4+23, 26	11.000	20.837 20.637 20.398	20. 875
	τ τ	4+33.26 4+43.26	0, 000	20. 809 20. 570	20. 871 20. 655	T	4+33.2	6 1.500 6 1.500	20.785 20.546	20. 848 20. 632	U V	4+43.26 4+53.26	7.750	20.449	20.548 20.282	U V	4+43.20 4+53.20 4+63.20	11,000	20.119	20.231 19.909
	V W	4+53.26 4+63.26		20. 291 19, 972	20. 388 20. 066	w W	4+53, 2	6 1.500		20, 365 20, 042 19, 666	W X	4+63.26	7.750 7.750	19.851 19.493	19.959 19.580	W X Y	4+73.20	5 11.000 5 11.000		19.530 19.105
	X Y Z	4+73, 26 4+83, 26 4+93, 26	0.000	19.614 19.221 18.824	19.690 19.270 18.844	X Y Z	4+73.2 4+83.2 4+93.2	6 1.500		19.246 18.821	Y Z	4+83.26 4+93.26		19.100 18.703	19.156 18.726	z	4+93.2			18.675 18.235
	¢ Pier 3	5+03. 76		18.407	18.407	¢ Pier 3	5+03.7			18. 384	¢ Pier 3	5+03.76	7.750	18.286	18.286	¢ Pier 3 AA	5+03.7		1	17.837
ŝ	AA	5+13.76	0.000	18.010	18.009	AA	5+13. 7 5+23. 7	5 1.500		17.985 17.598	AA A8	5+13.76 5+23.76	7.750		17.887 17.502 17.119	AB	5+23. 7 5+33. 7	6 11.000 6 11.000	17.441	17.451
c	AB AC AD	5+23.76 5+33.76 5+43.76		17.613 17.216 16.819	17.622 17.237 16.846	AB AC AD	5+33.7	8 1.500	17.193	17.213 16.822	AC AD	5+33.76 5+43.76 5+53.76	7.750	16,698	16. 729 16. 329	AD AE	5+43.7 5+53.7	6 11.000	16.250	16.678 16.278 15.868
pb.4%	AE	5+53.76 5+63.76	0.000	16.422 16.025	16. 446 16. 038	AE AF	5+53.7 5+63.7	6 1.500		16. 423 16. 014	AE AF	5+63.76		15.904	15.919	AF ¢ Brg, East Abu	5+63, 7 nt. 5+71, 2		1	15.560
475bde	¢ Brg. East Abut	5+71.26	0.000	15.732	15, 732	¢ Brg. East Abu	+. 5+71.2	6 1.500	15.709	15.709	¢ Brg. East Abu				15.611 15.514	BK. East Abut,				15.463
NRDEV	Bk. Eost Abut.	5+73.84	0. 000	15,635	15.635	Bk. East Abut.	5+73.8	4 1.500	15.612	15.612	Bk, East Abut,	5+73,84	7.750	15,514	15, 514					
LIEGGES AM NAVA75/CADD/2883/BRIDGE	DESIGNED LT														AS-BL BY M 9/25/0	BOWMAN, BARRI	on. Ett f	M	ONROE R I-90/S SECTIO	AB ELEVA ST. (F.A.U. 94 KENNEL N 0101.2- 0K COUNTY
default 84.76.2003	CHECKED EP DRAWN T CHECKED BL DATE: 04-14-03	r					Name of the state									& ASSOCIATES I CONSULTING ENGINI 130 E. RANDOLPH ST CHICAGO, ILLINOIS E JOB NO. 475	NC. EERS REET	3	STAT	ION 4+03. . 016-2054

	USER NAME = pateld	DESIGNED -	REVISED -		EXISTING PLANS	F.A.I. BTE	SECTION	COUNTY TOTAL	SHEET
PARSONS		CHECKED -	REVISED -	STATE OF ILLINOIS	STRUCTURE NO. 016–2054	90/94	2014-016R&B	COOK 378	220
BRINCKERHOFF	PLOT SCALE = N.T.S.	DRAWN - DCP	REVISED -	DEPARTMENT OF TRANSPORTATION	STRUCTURE NO. 010-2034			CONTRACT NO. 6	50X95
010	PLOT DATE = 5/15/2017	CHECKED - JIG	REVISED -		SHEET NO. 8 OF 87 SHEETS		ILLINOIS FED. AID	PROJECT	

NOUTE NO.	ACCTION	COLN	TY	E EXTO	SHEAT NO.	SHEET	NO. 58 (ρF
F. A. U. 3428	20 8101.2- 4B-R	COC	соок 147			531	SHEETS	
FEO. READ DIS	IT, NO. 7	BLUNCIS .	ED. AID FAC.	edt-]		

STATE OF ILLINOIS DEPARTMENT OF TRANSPORTATION

BEAM 9

· · · /

DESIGNED

CHECKED

CHECKED BLU DATE: 04-14-03

RAWN

default 84/16/2003

· · · · · · · · · · · · · · · · · · ·			p	
Location	Station	Offset	Théoretical Grade Elevations	Theoretical Grade Elevations Adjusted For Dead Load Deflection
Bk. West Abut.	2+32.68	14.000	17.397	17.397
¢ Brg. West Abut.	2+35.26	14.000	17.499	17.499
A	2+45.26	14.000	17.896	17.914
в	2+55.26	14.000	18,293	18, 323
с	2+65.26	14,000	18,690	18,720
D	2+75, 26	14,000	19,087	19, 107
Ē	2+85.26	14.000	19,473	19,480
Ē	2+95. 26	14.000	19.822	19.819
¢ Plor 1	3+02.76	14.000	20.057	20.057
G	3+12.76	14.000	20, 336	20. 357
н	3+22.76	14.000	20.575	20, 629
J	3+32.76	14.000	20.774	20.861
к	3+42,76	14.000	20.934	21.042
L	3+52.76	14.000	21.054	21, 167
м	3+62.76	14.000	21.135	21, 235
N	3+72.76	14.000	21.175	21, 249
p	3+82,76	14,000	21, 176	21.216
۵	3+92.76	14.000	21.137	21.149
¢ Pler 2	4+03, 26	14.000	21.054	21.054
R	4+13.26	14.000	20.934	20.945
s	4+23.26	14.000	20.774	20.812
Т	4+33.26	14.000	20.574	20.646
U	4+43.26	14.000	20.335	20.434
v	4+53.26	14.000	20.056	20.169
W	4+63.26	14.000	19.738	19.846
х	4+73.26	14.000	19.379	19.467
Y	4+83.26	14.000	18.987	19.043
z	4+93.26	14.000	18.590	18,613
¢ Pier 3	5+03.76	14,000	18.173	18.173
AA	5+13.76	14.000	17.776	17.774
AB	5+23.76	14.000	17.379	17.389
AC	5+33.76	14.000	16, 982	17.006
AD	5+43.76	14.000	16.585	16.616
AE.	5+53.76	14.000	16,188	16.216
AF	5+63,76	14.000	15.791	15.805
€ Brg. Eost Abut.	5+71.26	14.000	15.498	15.498
Bk. East Abut.	5+73.84	14.000	15.401	15,401

Location	Station	Offset	Theoretical Grade Elevations	Theoretical Grade Elevations Adjusted For Dead Load Deflection
Bk. West Abut,	2+32.68	20, 250	17.266	17.266
EBrg. West Abut.	2+35.26	20, 250	17.369	17, 369
A B C D E F	2+45,26 2+55,26 2+65,26 2+75,26 2+85,26 2+85,26 2+95,26	20, 250 20, 250 20, 250 20, 250 20, 250 20, 250	17.766 18.163 18.560 18.957 19.343 19.692	17.784 18.192 18.590 18.977 19.349 19.689
(Pler 1	3+02.76	20,250	19.927	19.927
G J J K L N P Q Pler 2 R S T U V W X Y Z	3+12, 76 3+32, 76 3+32, 76 3+42, 76 3+52, 76 3+52, 76 3+62, 76 3+72, 76 3+72, 76 3+72, 76 4+23, 26 4+23, 26 4+23, 26 4+23, 26 4+43, 26 4+53, 264+54, 26 4+54, 26 4+54, 264+54, 264+54, 264+54, 264+54, 264+5	20, 250 20, 20, 250 20, 20, 20, 20, 20, 20, 20, 20, 20, 20,	20, 206 20, 445 20, 644 20, 604 21, 004 21, 045 21, 004 21, 045 21, 007 20, 924 20, 804 20, 644 20, 644 20, 644 20, 644 20, 644 19, 607 19, 249 18, 857 18, 460	20, 227 20, 499 20, 731 20, 912 21, 037 21, 104 21, 118 21, 086 21, 019 20, 924 20, 814 20, 682 20, 516 20, 304 20, 039 19, 716 19, 337 18, 913 18, 482
¢ Pier 3	5+03.76	20, 250	18.043	18.043
AA AB AC AD AE AF ¢ Brg. East Abut.	5+13.76 5+23.76 5+33.76 5+43.76 5+53.76 5+63.76 5+63.76 5+71.26	20. 250 20. 250 20. 250 20. 250 20. 250 20. 250 20. 250	17.646 17.249 16.852 16.455 16.058 15.661	17.644 17.259 16.875 16.486 16.086 15.675 15.368
Bk, East Abut,	5+73, 84	20.250	15.270	15.270

		1	Theoretical	Theoretical Grade Elevations Adjusted	Location
Location	Station	Offset	Grade	For Dead Load	Locarion
	-		Elevations	Deflection	
				Derrection	
Bk. West Abut.	2+32,68	22,000	17.230	17.230	BK. West Ab
BK. West Abur.	2152.00	201000			
🕻 Brg. West Abut.	2+35.26	22.000	17.332	17.332	¢ Brg. West
2				13 740	A
A	2+45.26	22.000	17.729	17.748	8
8	2+55.26	22.000	18.126	18.553	c c
с	2+65.26	22.000	18.523	18, 941	D
D	2+75.26	22,000	18,920		3
E	2+85.26	22,000	19.307	19, 313	
F	2+95.26	22.000	19.655	19.652	
				19.890	¢ Pier 1
C Pier 1	3+02.76	22.000	19,890	13,830	
		00.000	20, 169	20, 190	G
G	3+12.76	22.000	20.408	20, 463	н
н	3+22.76	22.000		20, 694	J
J	3+32.76	22.000	20.608	20.875	K
к	3+42.76	22.000	20, 767	21.000	Ι I ι
L	3+52,76	22.000	20,888	21.000	м
м	3+62.76	22.000	20.968		N
N	3+72.76	22.000	21,009	21.082	P P
P	3+82.76	22.000	21.009	21.049	0
۵	3+92.76	22.000	20.971	20.983	l l ř
¢ Pler 2	4+03.26	22.000	20, 867	20.887	¢ Pter 2
Q (10) 2	1100125				R
R	4+13.26	22.000	20.767	20.778	S
s	4+23.26	22.000	20.607	20.645	T
T	4+33, 26	22,000	20.408	20, 480	
ů.	4+43.26	22.000	20, 169	20, 268	U
v	4+53.26	22,000	19.890	20.002	V
Ŵ	4+63, 26	22.000	19.571	19.679	W
×	4+73.26	22.000	19.213	19.301	X
Y	4+83.26	22,000	18.820	18.876	Y
z	4+93.26	22.000	18, 423	18.446	Z
-					¢ Pier 3
¢ Pier 3	5+03.76	22.000	18.006	18.006	<u> </u>
-			1 1 1 1 1 1 1 1 1 1 1 1 1 1 1 1 1 1 1 1	17.607	AA
AA	5+13.76	22.000	17.609	17.222	AB
AB	5+23.76	22.000	17.212	16,839	AC AC
AC	5+33.76	22.000	16.815		DA
AD	5+43.76	22.000	16.418	16.449	AE
AE	5+53.76	22.000		16.049	AF
AF	5+63,76	22.000	15.624	15,639	, iii
¢ Brg. East Abut	. 5+71,26	22,000	15.331	15. 331	Ç_Brg. Eos
Bk. East Abut,	5+73.84	22.000	15.234	15.234	Bk, East

SOUTH GUTTER LINE

6X03		USER NAME = pateld	DESIGNED -	REVISED -		EXISTING PLANS	F.A.I. RTF.	SECTION	COUNTY	TOTAL SHEET
	RSONS		CHECKED -	REVISED -	STATE OF ILLINOIS	STRUCTURE NO. 016–2054	90/94	2014-016R&B	СООК	378 221
2 B F	RINCK ER HOFF	PLOT SCALE = N.T.S.	DRAWN - DCP	REVISED -	DEPARTMENT OF TRANSPORTATION	STRUCTURE NU. 016-2054			CONTRACT	T NO. 60X95
016		PLOT DATE = 5/15/2017	DATE = 5/15/2017 CHECKED - JIG REVISED -		SHEET NO. 9 OF 87 SHEETS	ILLINOIS FED. AID		AID PROJECT		


			CONTRACTOR OF STREET, S					
ROLITE NO.	BECTION	COUNTY	s'2246	SHRET MO-	SHEET	NO.	59	OF
F. A. U. 1420	6101.2- 48-R	COCK	147	42	\$31	SHE	ETS	
FED. 4040 DIST	r. NO. 7	ILLINGID FED	ALO PROJECT.]			

BEAM 11

				······
			Theoretical	Theoretical Grade Elevations Adjusted
Location	Station	Offset	Grade	
Location	Signon	0.7007	Elevations	For Dead Load
	ĺ			Deflection
				17.176
3k. West Abut.	2+32.68	26,500	17.136	17, 136
				17,238
Brg, West Abut,	2+35.26	26.500	17.238	11,230
	1		17 636	17.656
A	2+45, 26	26.500	17.635	18.065
8	2+55.26	26.500	18, 429	18, 462
С	2+65.26	26.500	18.826	18.849
D	2+75.26	26,500		19,220
3	2+85.26	26.500	19.213	19.558
F	2+95.26	26.500	19,561	13.000
	1 1	00 500	19.796	19,796
⊈ Pier 1	3+02.76	26.500	12.126	13.100
		26, 500	20.075	20,098
G	3+12.76		20.314	20.374
н	3+22.76	26.500	20.514	20, 608
J	3+32.76	26.500	20.514	20, 792
ĸ	3+42.76	26.500		20. 917
L	3+52, 76	26.500	20.794	20, 984
м	3+62.76	26.500	20.874	20, 995
N	3+72.76	26.500	20.915	20. 959
P	3+82.76	26.500	20.916	
0	3+92.76	26.500	20.877	20.890
¢ Pier 2	4+03.26	26, 500	20. 794	20.794
ୟୁ Ften ∠	1.001.00			
R	4+13.26	26.500	20, 673	20.685
S	4+23,26	26,500	20.514	20.555
s T	4+33.26	26.500	20.314	20, 393
U	4+43, 26	26,500	20.075	20. 183
v	4+53, 26	26.500	19.795	19.919
	4+63, 26	26.500	19.477	19.596
W	4+73,26	26.500	19.119	19, 215
X	4+83.26	26.500	18, 726	18.788
Y	4+93.26	26.500	18.329	18, 354
Ζ.	1733.20	20.000	1	
¢ Pier 3	5+03.76	26.500	17.913	17.913
	5+13.76	26,500	17.516	17.513
AA	5+13, 76	26, 500		17.129
AB		26.500		16, 748
AC	5+33.76	26,500		16. 359
AD	5+43.76			15, 958
AE	5+53.76	26.500		15, 546
AF	5+63, 76	26.500	10.001	1 101010
¢ Brg. East Abut	5+71.26	26.500	15.238	15.238
		1		15. 140
Bk, East Abut,	5+73.84	26.500	15.140	15.140

AS-BUILT DRAWINGS PREPARED BY MCHUGH CONSTRUCTION. 9/25/06

TOP OF SLAB ELEVATIONS 4 MONROE ST. (F.A.U. 1420) OVER 1-90/94 KENNEDY EXPWY. SECTION 0101.2-4B-R BOWMAN, BARRETT & ASSOCIATES INC. CONSULTING ENGINEERS ISO E. RANDOLPH STREET CHICACO, ILLINOS 60601 COOK COUNTY STATION 4+03.26 S.N. 016-2054

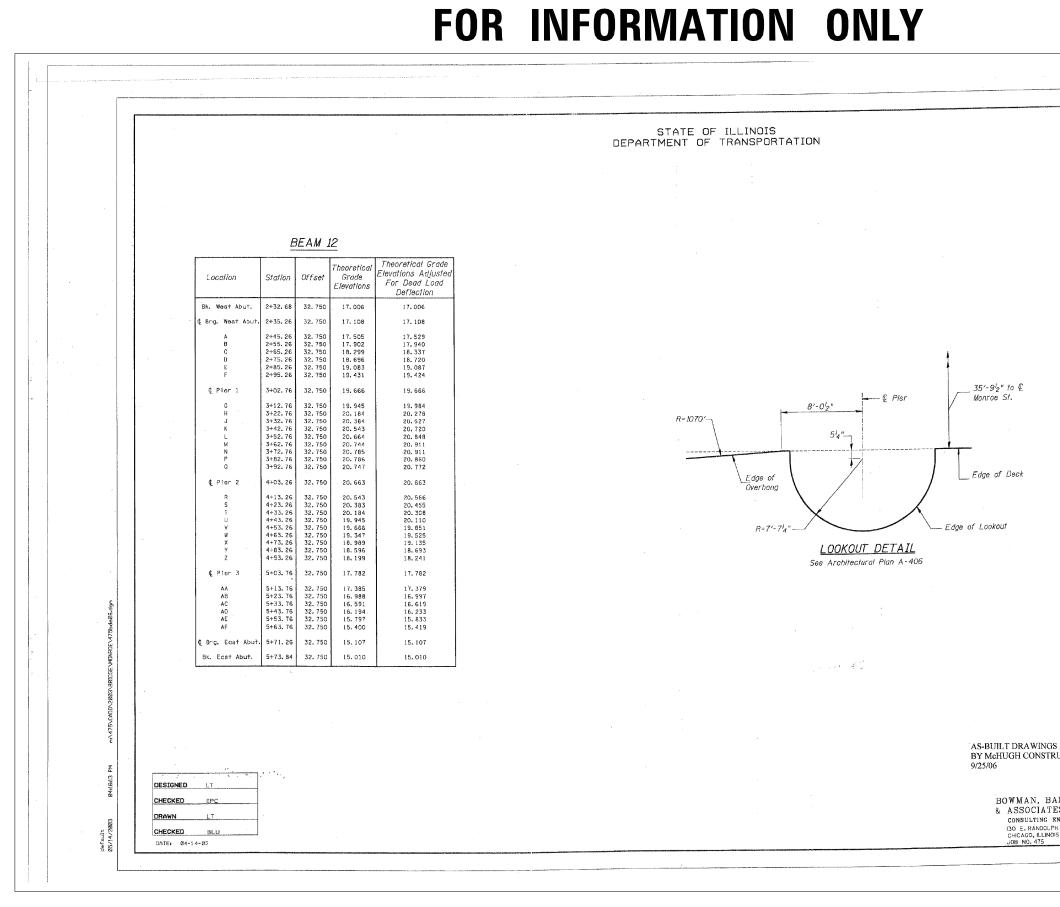


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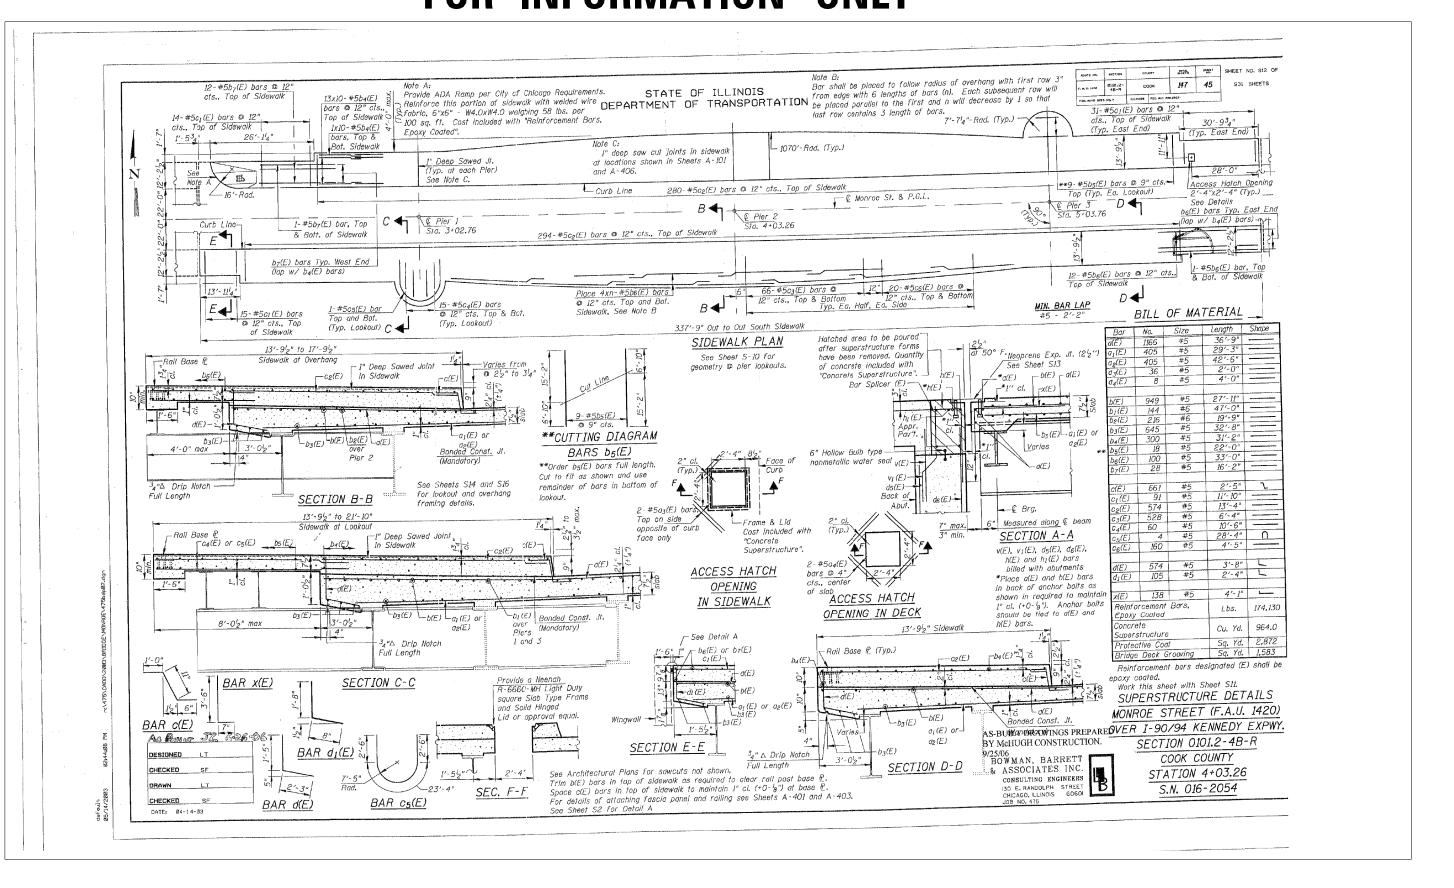
	USER NAME = pateld	DESIGNED -	REVISED -		EXISTING PLANS	F.A.I. RTE.	SECTION	COUNTY TO	JTAL SHEET IEETS NO.
PARSONS		CHECKED -	REVISED -	STATE OF ILLINOIS	STRUCTURE NO. 016–2054	90/94	2014-016R&B	C00K 3	378 222
BRINCKERHOFF		DRAWN - DCP	REVISED -	DEPARTMENT OF TRANSPORTATION				CONTRACT NO	10. 60X95
0	PLOT DATE = 5/15/2017	CHECKED - JIG	REVISED -		SHEET NO. 10 OF 87 SHEETS		ILLINOIS FED. A	AID PROJECT	

							and the second design of the
BOUTE NO.	NOIT DIS	C0.817		1914a	SHEET HD.	SHEET	NO. 510 OF
F. A.U. 1928	9101.2- 48-8	co	сож		43	S31	SHEETS
FED. 8040 DEB	г. ня. ¥	ILLINGS	FEO. AND PRO	o.#¢1+			

PREPARED UCTION.	TOP OF SLAB ELEVATIONS 5 MONROE ST. (F.A.U. 1420)	
	OVER I-90/94 KENNEDY EXPWY. SECTION 0101.2-4B-R	
RRETT	COOK COUNTY	
ES INC.	STATION 4+03.26	
S 6060	S.N. 016-2054	

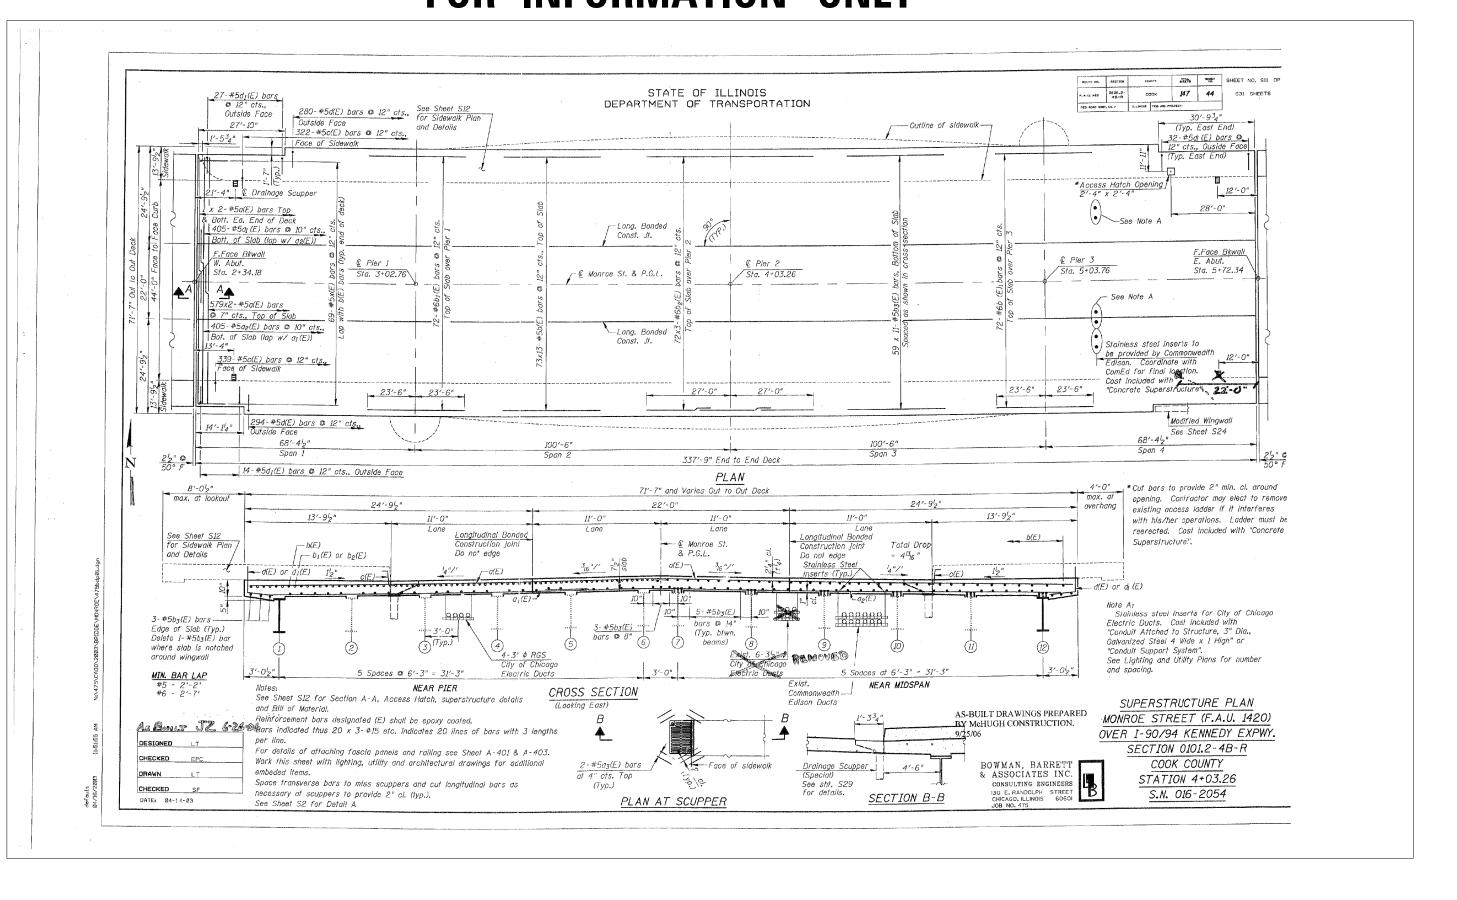


	USER NAME = pateld	DESIGNED -	REVISED -		EXISTING PLANS					
PARSONS		CHECKED -	REVISED -	STATE OF ILLINOIS	STRUCTURE NO. 016–2054	90/94 2	2014-016R&B	COOK 378	223	
BRINCKERHOFF		DIVANIN DOI	REVISED -	DEPARTMENT OF TRANSPORTATION				CONTRACT NO. 6	60X95	
010	PLOT DATE = 5/15/2017	CHECKED - JIG	REVISED -		SHEET NO. 11 OF 87 SHEETS		ILLINOIS FED. AI) PROJECT		



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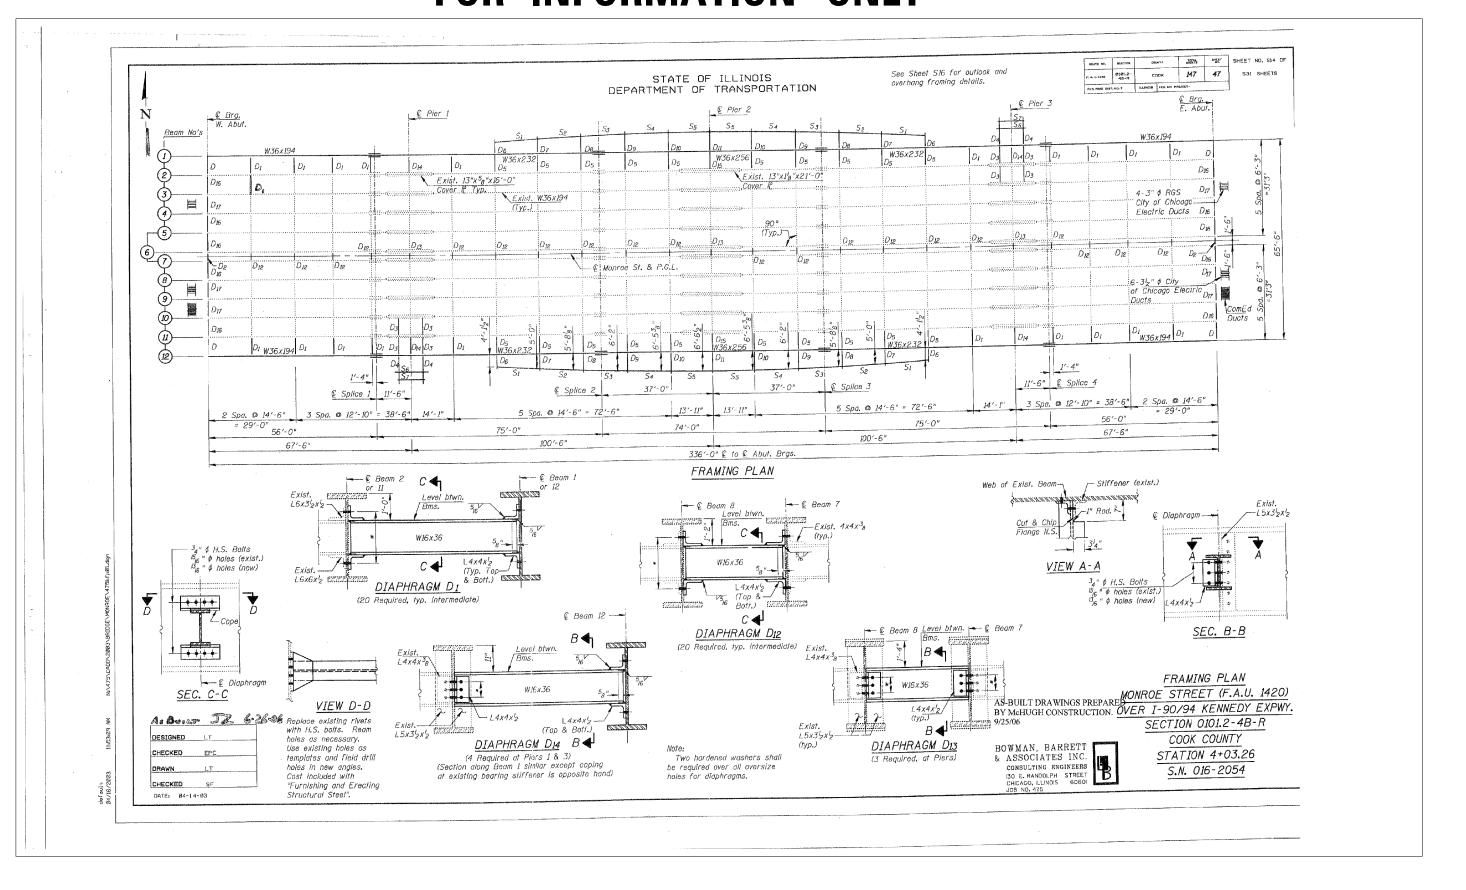
6	PARSONS	USER NAME = pateld PLOT SCALE = N.T.S.	DESIGNED - CHECKED - DRAWN - DCP	REVISED - REVISED - REVISED -	STATE OF ILLINOIS	EXISTING PLANS Structure No. 016–
01617	BRINCKERHOFF	PLOT DATE = 5/15/2017	CHECKED - JIG	REVISED -	DEPARTMENT OF TRANSPORTATION	SHEET NO. 12 OF 87 SHEE

LANS	F.A.I. RTE.	SECTION	COUNTY	TOTAL SHEETS	SHEET NO.
016-2054	90/94	2014-016R&B	СООК	378	224
010-2034			CONTRACT	NO. 6	0X95
7 SHEETS		ILLINOIS FED. AI	D PROJECT		

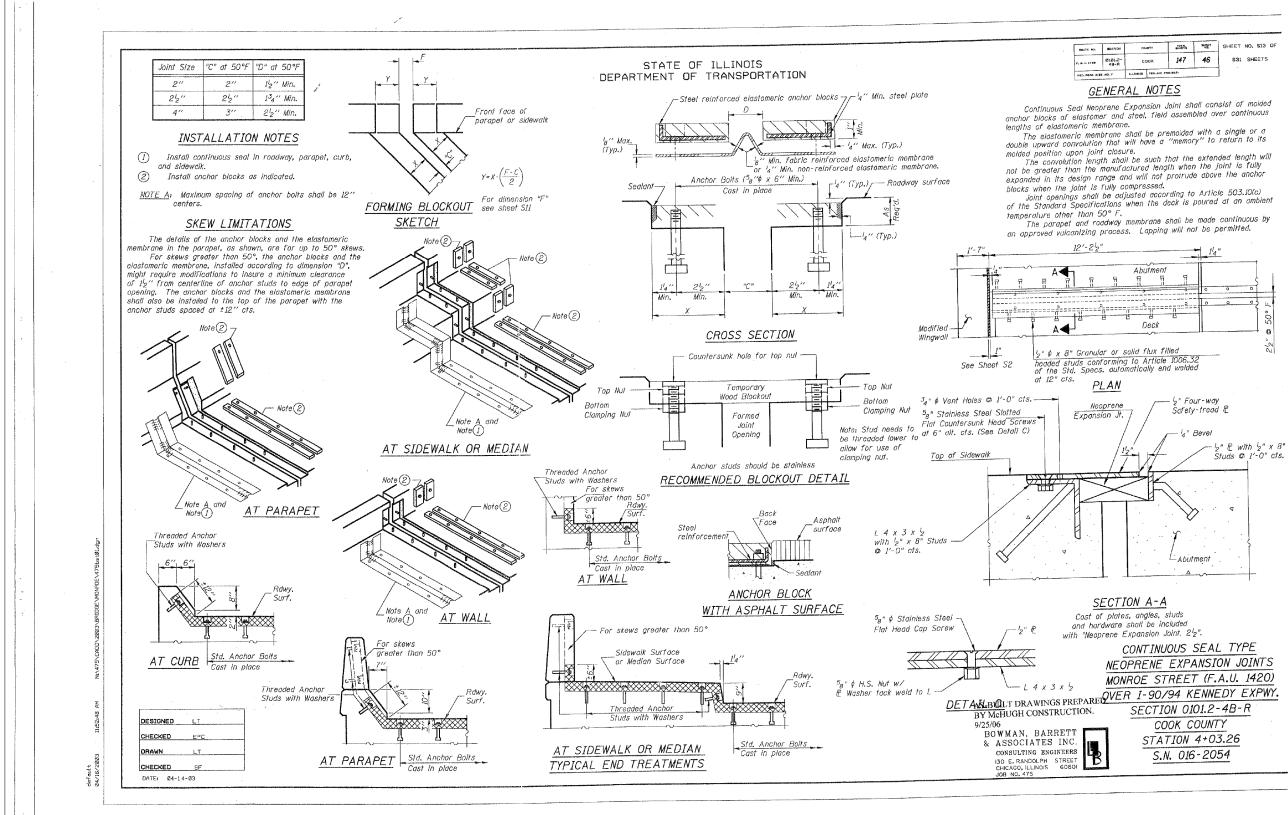


S.											
Ň		USER NAME = pateld	DESIGNED -	REVISED -		EXISTING PLANS	F.A.I.	SECTION	COUNTY	TOTAL SH	EET
	RSONS		CHECKED -	REVISED -	STATE OF ILLINOIS		90/94	2014-016R&B	соок	378 2	25
≗ B F	RINCKERHOFF	PLOT SCALE = N.T.S.	DRAWN - DCP	REVISED -	DEPARTMENT OF TRANSPORTATION	STRUCTURE NO. 016–2054			CONTRAC	T NO. 60X	.95
016		PLOT DATE = 5/15/2017	CHECKED - JIG	REVISED -		SHEET NO. 13 OF 87 SHEETS		ILLINOIS FED. A	AID PROJECT		

_					Contraction of the local division of the loc				
	NOUTE NO.	BECTION	005	нти	TELAS	BUCCT ND.	SHEET	NO. \$13 DF	
	F. A. U. 1428	Ø101.2- 48-R	GC	DCIK.	147	46	S31	SHEETS	
	PED. AGAD DIST	ND. 7	ILLINDIS	PED. AID PR	-1310				




6X0		USER NAME = pateld	DESIGNED -	REVISED -		EXISTING PLANS	F.A.I. SECTION	COUNTY TOTAL SHEET
όľ	PARSONS		CHECKED -	REVISED -	STATE OF ILLINOIS		90/94 2014-016R&B	СООК 378 226
120	BRINCKERHOFF	PLOT SCALE = N.T.S.	DRAWN - DCP	REVISED -	DEPARTMENT OF TRANSPORTATION	STRUCTURE NO. 016–2054		CONTRACT NO. 60X95
016		PLOT DATE = 5/15/2017	CHECKED - JIG	REVISED -		SHEET NO. 14 OF 87 SHEETS	ILLINOIS FED. A	ID PROJECT

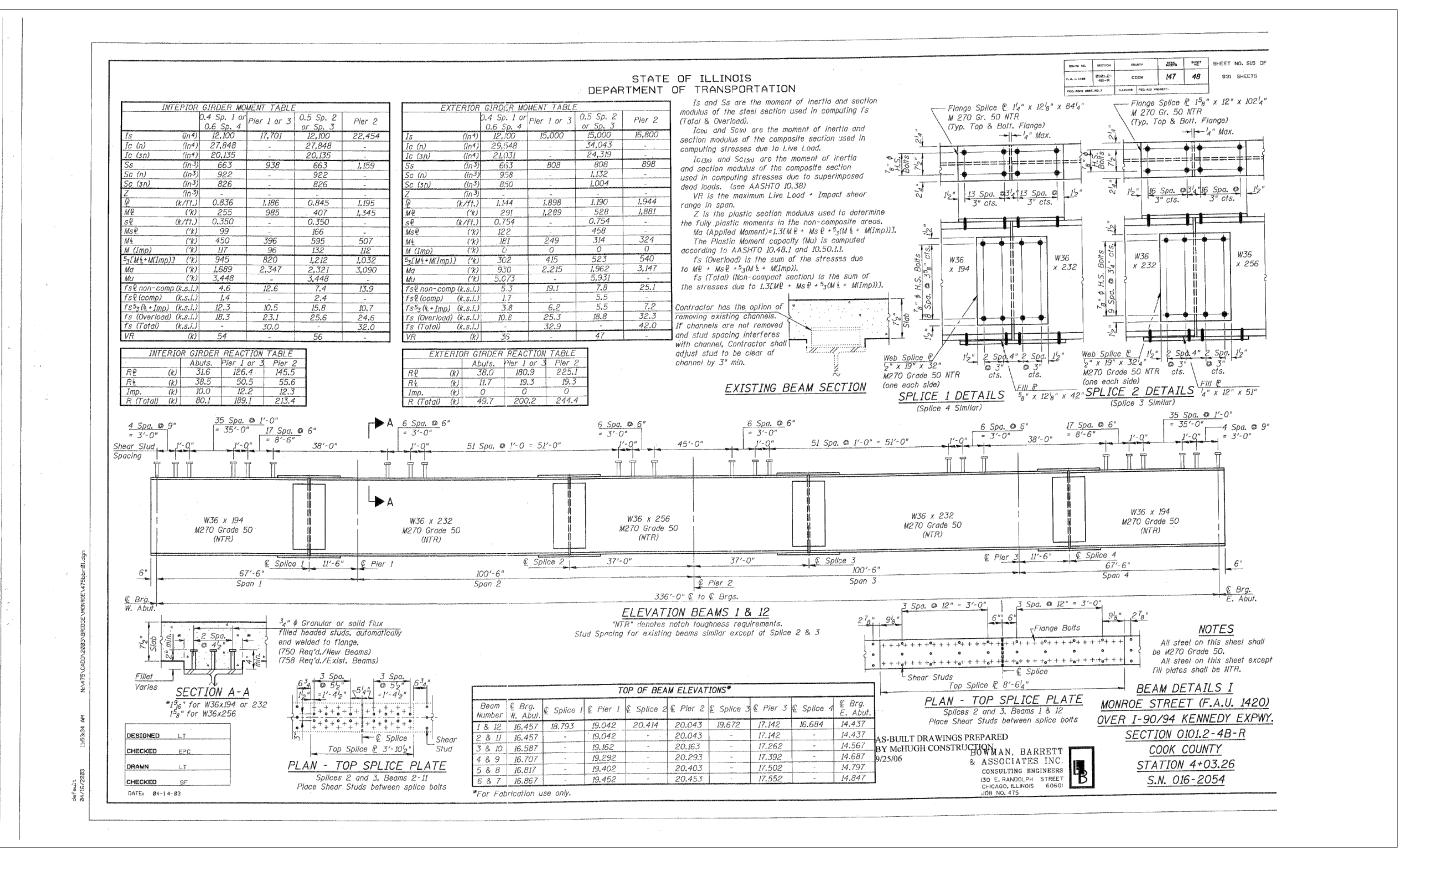


00-60X95-S075-EXT.dgn

6X0	USER NAME = pateld	DESIGNED -	REVISED -		EXISTING PLANS	F.A.I.	SECTION	COUNTY TOT	TAL SHEET
PARSONS		CHECKED -	REVISED -	STATE OF ILLINOIS		90/94	2014-016R&B	COOK 37	.ETS NU. 78 227
BRINCKERHO	PLOT SCALE = N.T.S.	DRAWN - DCP	REVISED -	DEPARTMENT OF TRANSPORTATION	STRUCTURE NO. 016–2054			CONTRACT NO	0. 60X95
016	PLOT DATE = 5/15/2017	CHECKED - JIG	REVISED -		SHEET NO. 15 OF 87 SHEETS		ILLINOIS FED. A	AID PROJECT	

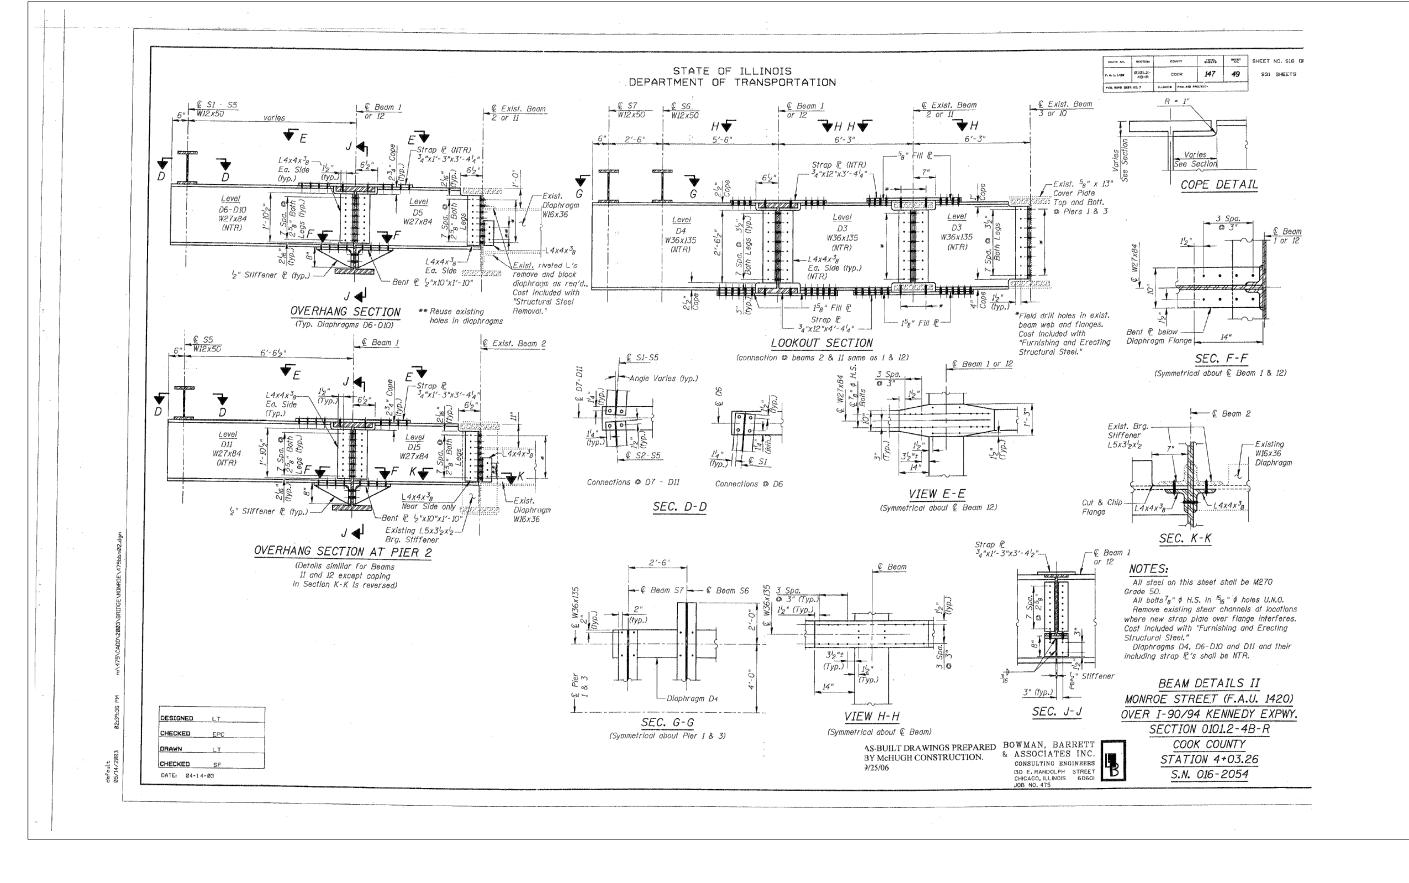

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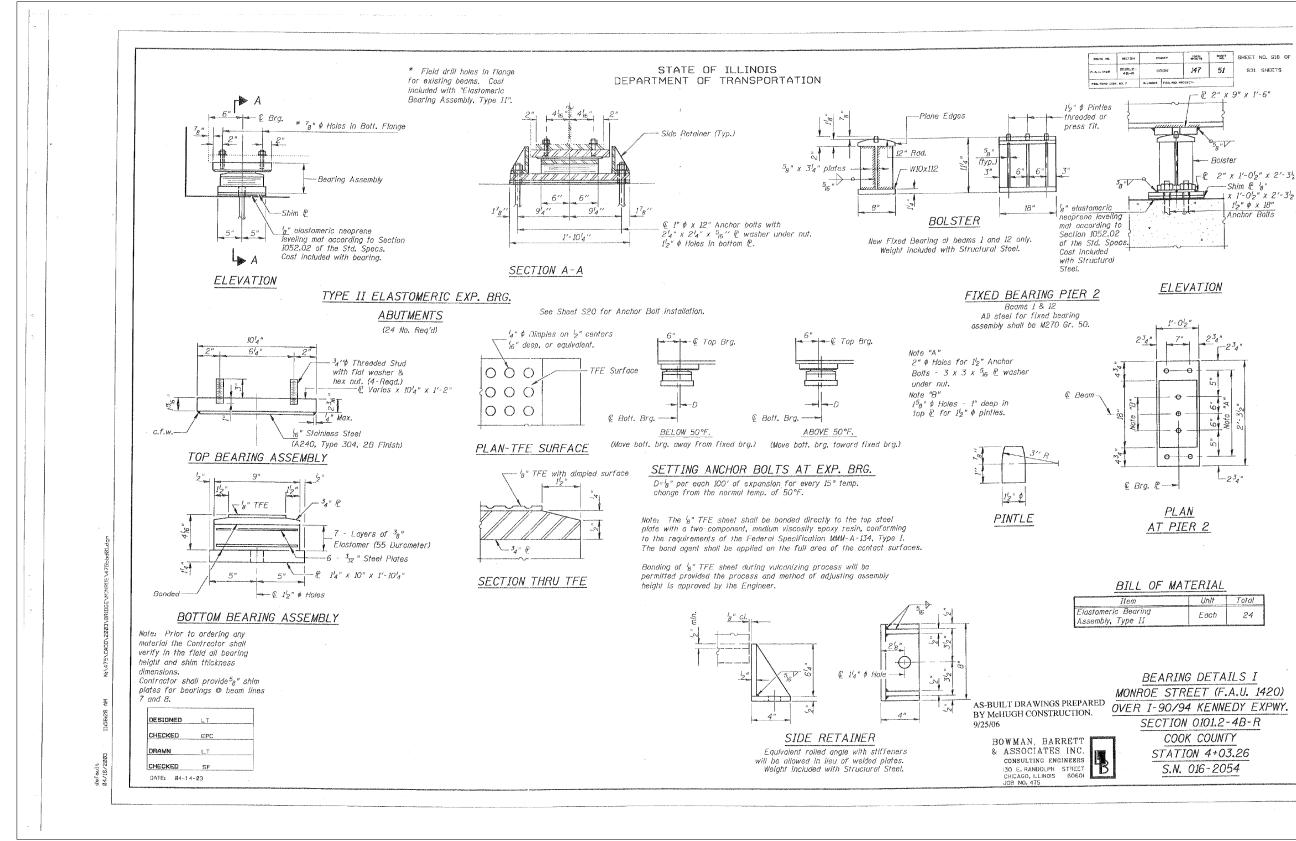
	USER NAME = pateld	DESIGNED -	REVISED -		EXISTING PLANS	F.A.I. RTE,	SECTION	COUNTY	TOTAL SHEET SHEETS NO.
PARSONS		CHECKED -	REVISED -	STATE OF ILLINOIS	STRUCTURE NO. 016–2054	90/94	2014-016R&B	СООК	378 228
BRINCKERHOFI	PLOT SCALE = N.T.S.	DRAWN - DCP	REVISED -	DEPARTMENT OF TRANSPORTATION		_			F NO. 60X95
01	PLOT DATE = 5/15/2017	CHECKED - JIG	REVISED -		SHEET NO. 16 OF 87 SHEETS		ILLINOIS FED. A	D PROJECT	

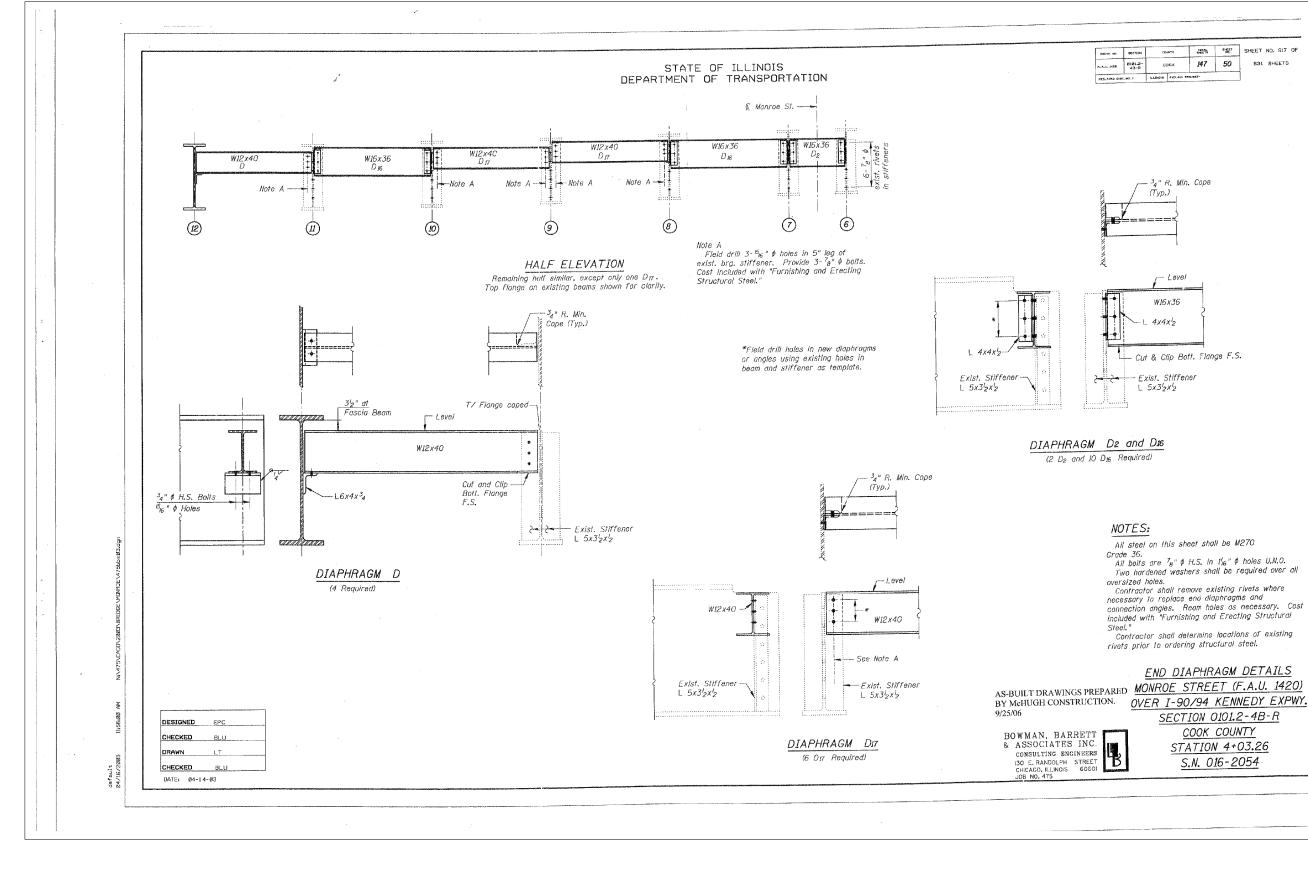

	USER NAME = pateld	DESIGNED -	REVISED -		EXISTING PLANS	F.A.I. BTE	SECTION	COUNTY TOTA	AL SHEET
J PARSONS		CHECKED -	REVISED -	STATE OF ILLINOIS	STRUCTURE NO. 016–2054	90/94	2014-016R&B	COOK 378	78 229
BRINCKERHOFF	PLOT SCALE = N.T.S.	DRAWN - DCP	REVISED -	DEPARTMENT OF TRANSPORTATION				CONTRACT NO.	60X95
ā	PLOT DATE = 5/15/2017	CHECKED - JIG	REVISED -		SHEET NO. 17 OF 87 SHEETS		ILLINOIS FED, AI	D PROJECT	


						And the second
	*CERTIFIC COLUMN					
ROUTE NO.	BECTION	COUNTY	TOTAL SPECTS	alvert Net	SHEET	NO, S17 OF
P. A. U. 1120	8181.2- 43-R	савк	147	50	S31	SHEETS
PED. Adva DIS	т. но. 7	ILLINDIA FRO. ALS P	NDJECT-			

All steel on this sheet shall be M270 Grade 36. Grade 36. All bolts are 7₈" ¢ H.S. in 11₆" ¢ holes U.N.O. Two hardened washers shall be required over all oversized holes. Contractor shall remove existing rivets where necessary to replace end diaphragms and connection angles. Ream holes as necessary. Cost included with "Furnishing and Erecting Structural Steel." Contractor shall determine locations of existing rivets prior to ordering structural steel. END DIAPHRAGM DETAILS SECTION 0101.2-4B-R COOK COUNTY STATION 4+03.26 S.N. 016-2054




35									
××	USER NAME = pateld	DESIGNED -	REVISED -		EXISTING PLANS	F.A.I. RTE	SECTION	COUNTY TOTA	AL SHEET
PARSONS		CHECKED -	REVISED -	STATE OF ILLINOIS		90/94	2014-016R&B	C00K 378	8 230
BRINCKERHOFF	PLOT SCALE = N.T.S.	DRAWN - DCP	REVISED -	DEPARTMENT OF TRANSPORTATION	STRUCTURE NO. 016–2054			CONTRACT NO.	60X95
016	PLOT DATE = 5/15/2017	CHECKED - JIG	REVISED -		SHEET NO. 18 OF 87 SHEETS		ILLINOIS FED.	AID PROJECT	
=									

BILL OF	MATERIAL	
Item	Unit	Total
astomeric Bearing	Each	24

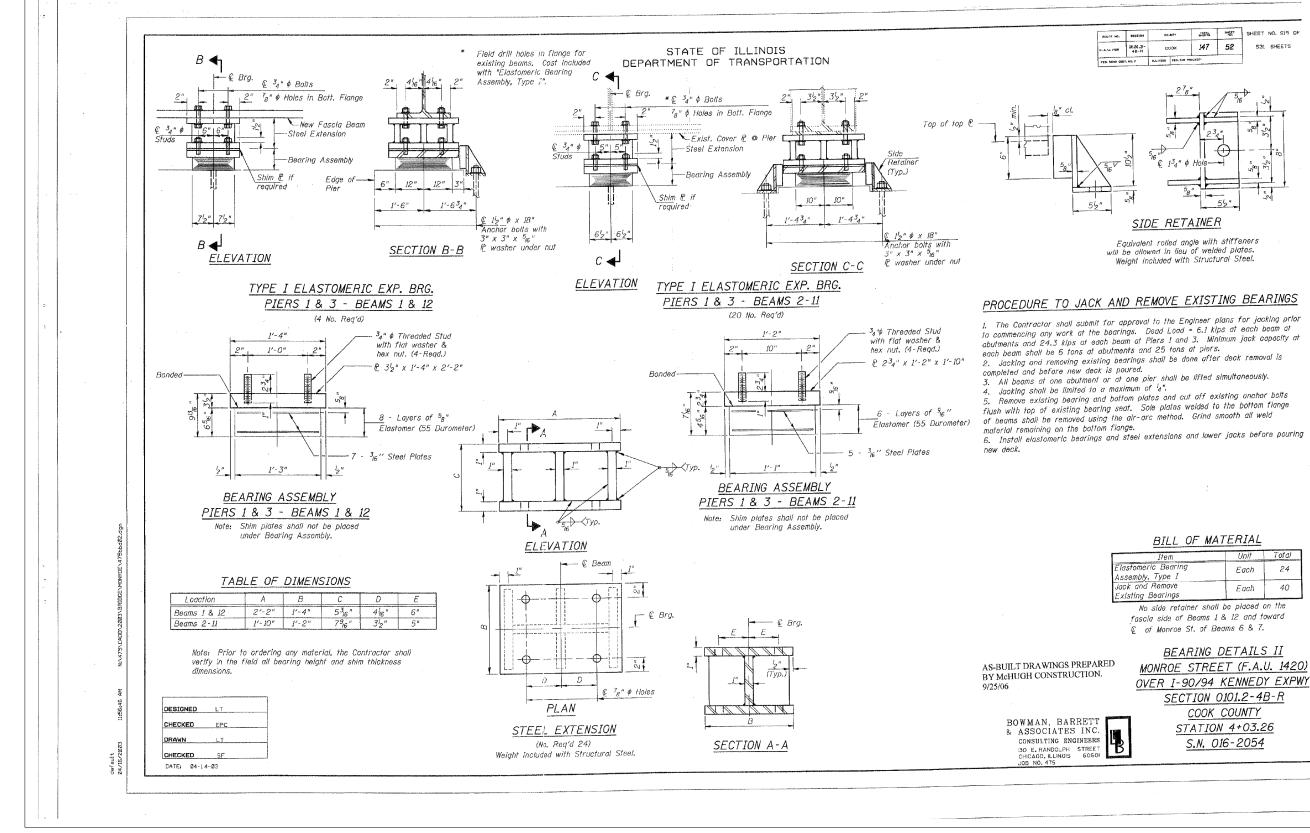

Item	Unit	Total
Elastomeric Bearing Assembly, Type I	Each	24
Jack and Remove Existing Bearings	Each	40
and the second		

PLANS	F.A.I. RTE.	SECTION	COUNTY	TOTAL SHEETS	SHEET NO.
. 016–2054	90/94	2014-016R&B	COOK	378	231
. 010-2034			CONTRACT	TRACT NO. 60	0X95
87 SHEETS	ILLINOIS FED. AID PROJECT				

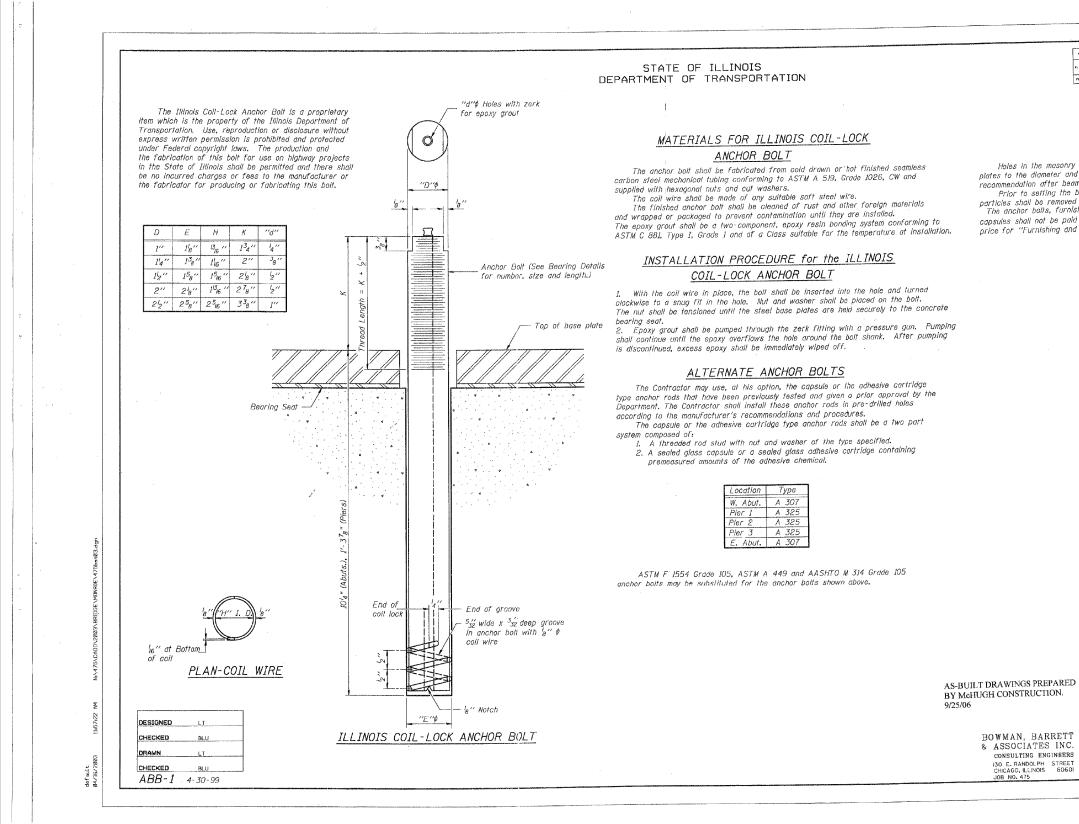

700-60X95-S080-EXT.dgn

	USER NAME = pateld	DESIGNED -	REVISED -		EXISTING PLANS	F.A.I. RTE.	SECTION	COUNTY TOT	TAL SHEET
PARSONS		CHECKED -	REVISED -	STATE OF ILLINOIS	STRUCTURE NO. 016–2054	90/94 20	014-016R&B	COOK 37	78 232
BRINCKERHOFF	11110	DRAWN - DCP	REVISED -	DEPARTMENT OF TRANSPORTATION				CONTRACT NO	0. 60X95
016	PLOT DATE = 5/15/2017	CHECKED - JIG	REVISED -		SHEET NO. 20 OF 87 SHEETS	ILLINOIS FED. AID PROJECT		D PROJECT	

		AUGUST BORN (1999) 1990				and the second second second second
			1			
BOUTE NO.	SECTION	COLNEY	NT ANG	NO.	SHEET	NO. S20 OF
F. A. U. 1120	0101.2- 68-8	COOK	147	53	\$31	SHEETS
	443-14					
PEO, FOND DIST	PEO, ROND DIST. HD. 7 JULDING PED. AND PA		Nouset-			

GENERAL NOTES

Holes in the masonry for anchor bolts shall be drilled through the base plates to the diameter and depth shown or according to the manufacturer's recommendation after beams or glrders have been erected and adjusted. Prior to setting the bolts, the holes shall be dry and all dust and loose particles shall be removed by the use of compressed air or vacuuming. The anchor bolts, furnished and installed and including the epoxy grout or capsules shall not be paid for separately but shall be included in the unit bid price for "Furnishing and Erecting Structural Steel".

LANS	F.A.I. RTE.	SECTION	COUNTY	TOT
016–2054	90/94	2014-016R&B	СООК	378
			CONTRACT	NO.

ANCHOR BOLT DETAILS

FOR BEARINGS

MONROE STREET (F.A.U. 1420)

OVER I-90/94 KENNEDY EXPWY.


SECTION 0101.2-4B-R

COOK COUNTY

STATION 4+03.26

S.N. 016-2054

В

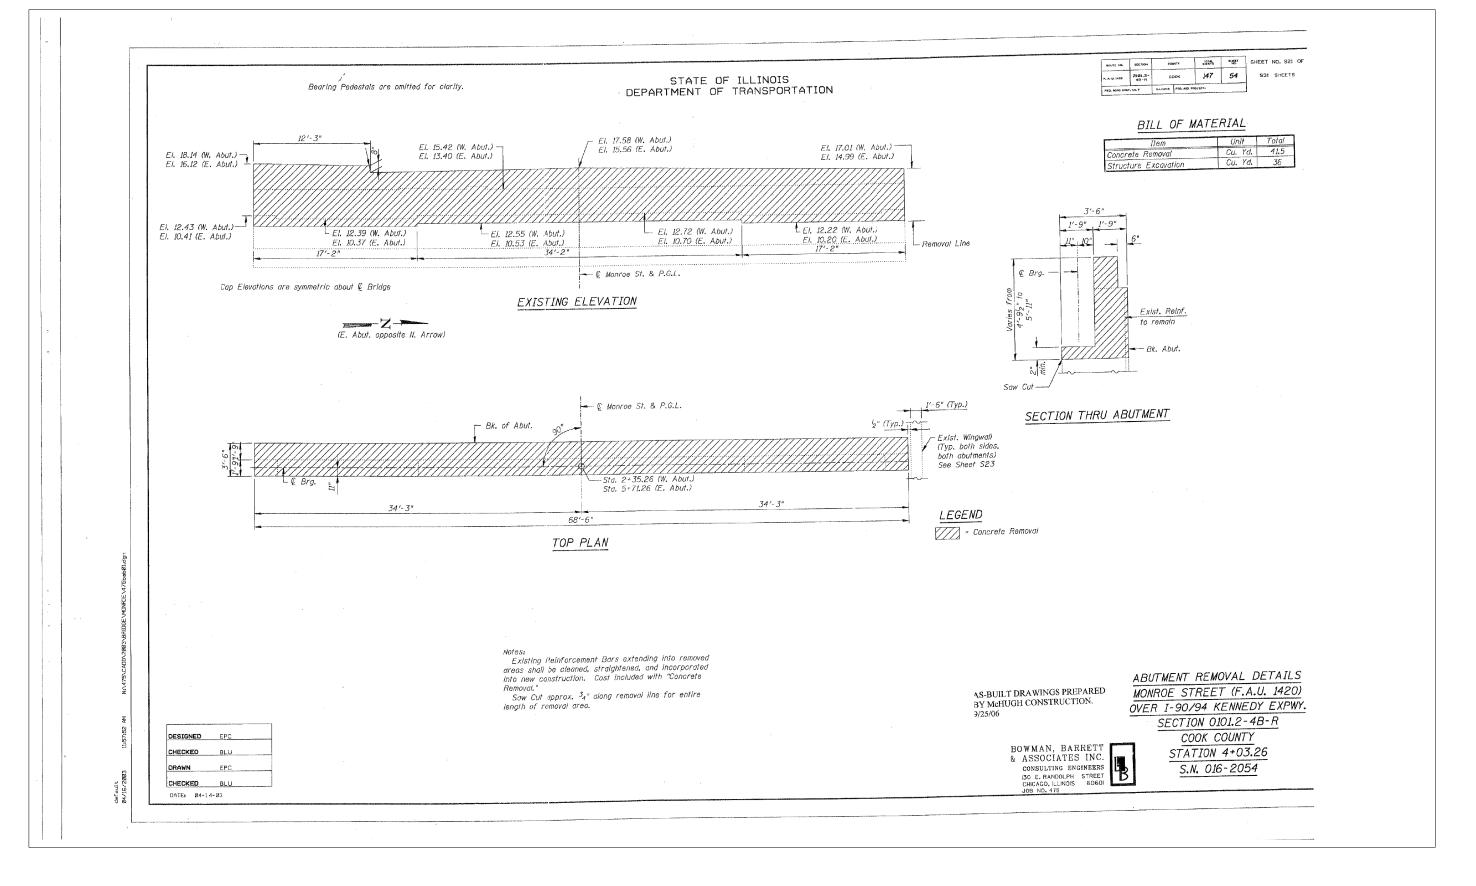


0-60X95-S081-EXT.dgn	
700-60X95	

	USER NAME = pateld	DESIGNED -	REVISED -		EXISTING PLANS	F.A.I. RTF.	SECTION	COUNTY	TOTAL SHEET SHEETS NO.
PARSONS		CHECKED -	REVISED -	STATE OF ILLINOIS	STRUCTURE NO. 016–2054	90/94	2014-016R&B	СООК	378 233
		DRAWN - DCP	REVISED -	DEPARTMENT OF TRANSPORTATION				CONTRACT	NO. 60X95
10	PLOT DATE = 5/15/2017	CHECKED - JIG	REVISED -		SHEET NO. 21 OF 87 SHEETS		ILLINOIS FED. A	AID PROJECT	


			and so that the second s					
NOUTE HO.	86071014	COUNTY		INTAL BEECT	SIGET NO.	SHEET	NO. S21	OF
P. A. U. 1428	0101.2- 48-8	соок		<i>j</i> 47	54	\$31	SHEETS	
FED. 8040 DIST	. NGL 7	BLUNDIS PEO	3. AND PH	origet-				

DILL OF MILL		
Item	Unit	Total
Concrete Removal	Cu. Yd.	41.5
Structure Excavation	Cu. Yd.	36

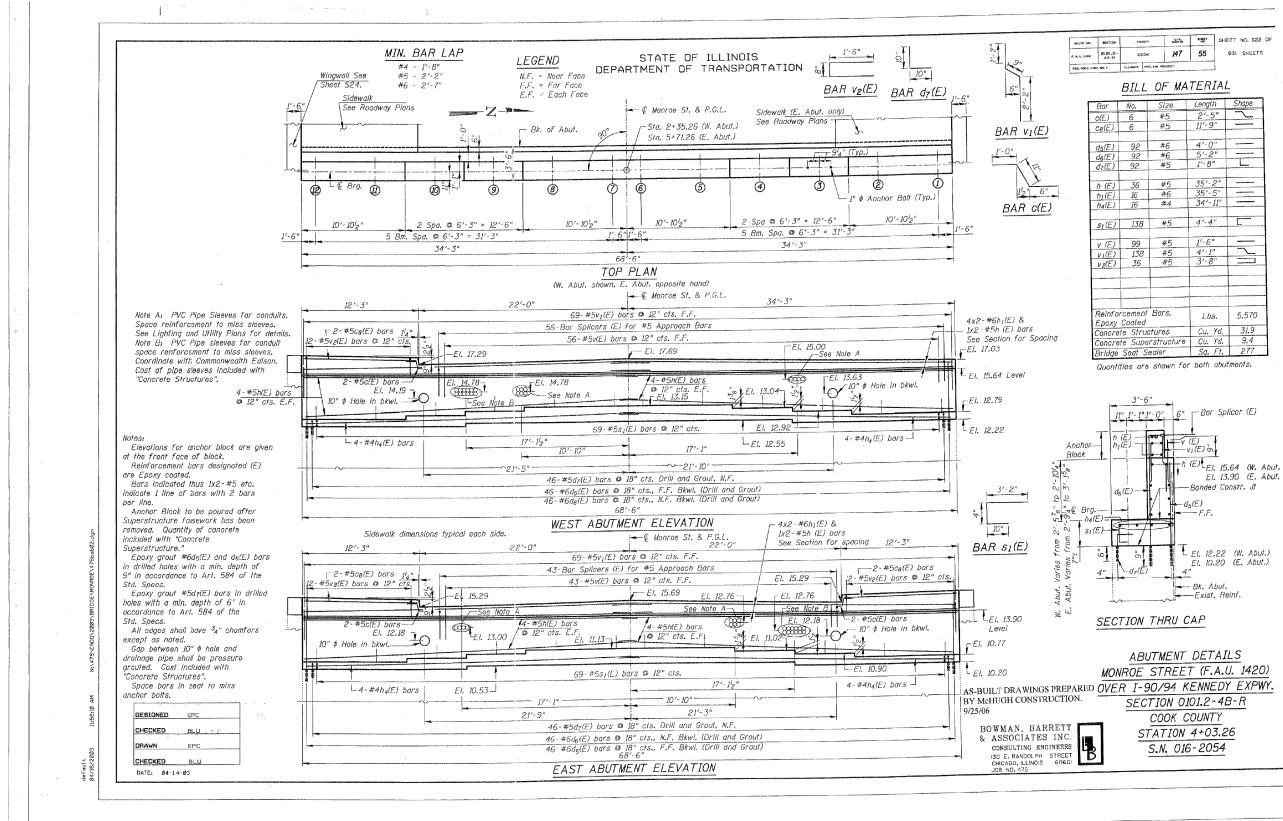


	USER NAME = pateld	DESIGNED -	REVISED -		EXISTING PLANS	F.A.I.	SECTION		FOTAL SH	.ET
PARSONS		CHECKED -	REVISED -	STATE OF ILLINOIS	STRUCTURE NO. 016–2054	90/94	2014-016R&B	СООК	378 2	4
BRINCKERHOFF	PLOT SCALE = N.T.S.	DRAWN - DCP	REVISED -	DEPARTMENT OF TRANSPORTATION	SINUCIUNE NU. 010-2004			CONTRACT N	NO. 60X	<i>i</i> 5
	PLOT DATE = 5/15/2017	CHECKED - JIG	REVISED -		SHEET NO. 22 OF 87 SHEETS		ILLINOIS FED. /	AID PROJECT		

NOUTE NO.	SECTION	COUNTY		BRETA	SINCET NO.	SHE	ET NO. 522
. A, U. 1422	8101.2- 48-R	CDDH	< 1	147	55	9	31 SHEETS
ED. 7040 133	NO. 7	ILLINDIA PE	CLAID PRO	UECT-		3	
		0111	~	- 114	TED	T A I	
		BILL	Ur	- MA	IERI	AL	
Г	Bar	No.	SI	ze	Lengtl	7	Shape
	c(E)	6	#	5	2'-5		~
	CB(E)	6	#	5	11'-9		
						. -	
	d5(E)	92	#		4'-0 5'-2		
	d6(E)	92		6	1'-8'		
-	d7(E)	92	#	· <u> </u>	10	-	
-	h (E)	36	#	5	35'-2	2"	
F	$h_1(E)$	16	#	6	35'-		
Γ	h4(E)	16	#	4	34'	11"	
Ľ			L		4'-4		<u> </u>
-	s1(E)	138	#	±5	4'-4		_ <u> </u>
-	v (E)	99	#	ŧ5	1'-6"		
	V1(E)	138		+5	4'-1'		
F	VE(E)	36		ŧ5	3'-8	n	
Ē						+	
		1					

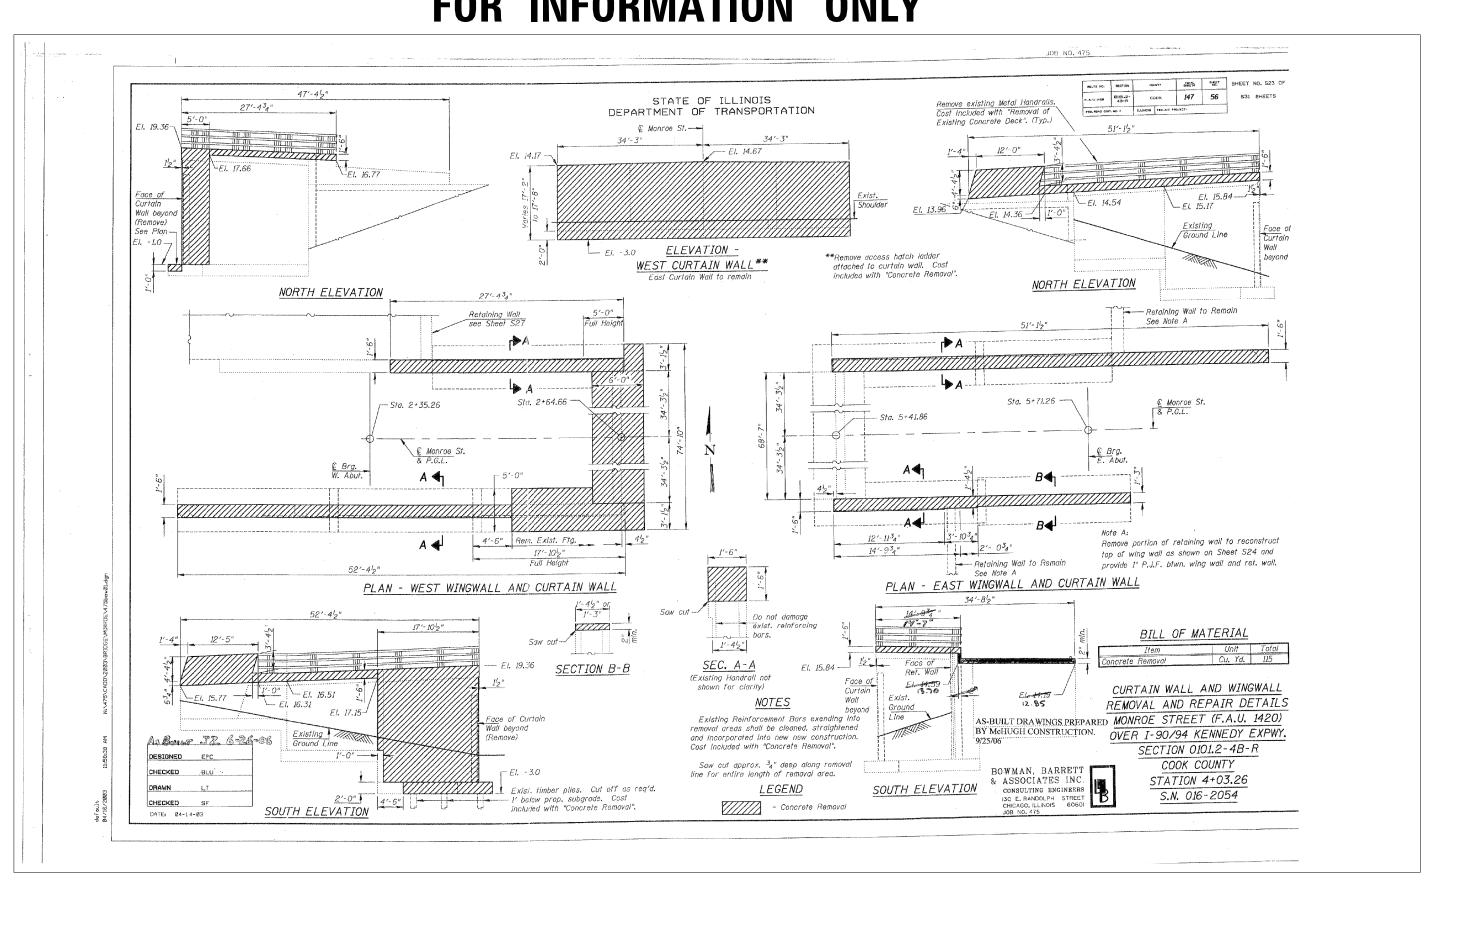


	PARSONS BRINCKERHOFF	· ·	DESIGNED - CHECKED - DRAWN - DCP	REVISED - REVISED - REVISED -	STATE OF ILLINOIS DEPARTMENT OF TRANSPORTATION	EXISTING PLANS Structure NO.016-
0161		PLOT DATE = 5/15/2017	CHECKED - JIG	REVISED -		SHEET NO. 23 OF 87 SHEE


LANS	F.A.I. RTE.	SECTION	COUNTY	TOTAL SHEETS	SHEET NO.
016–2054	90/94	2014-016R&B	СООК	378	235
010-2034	1		CONTRACT	NO. 6	0X95
37 SHEETS		ILLINOIS FED. AI	D PROJECT		

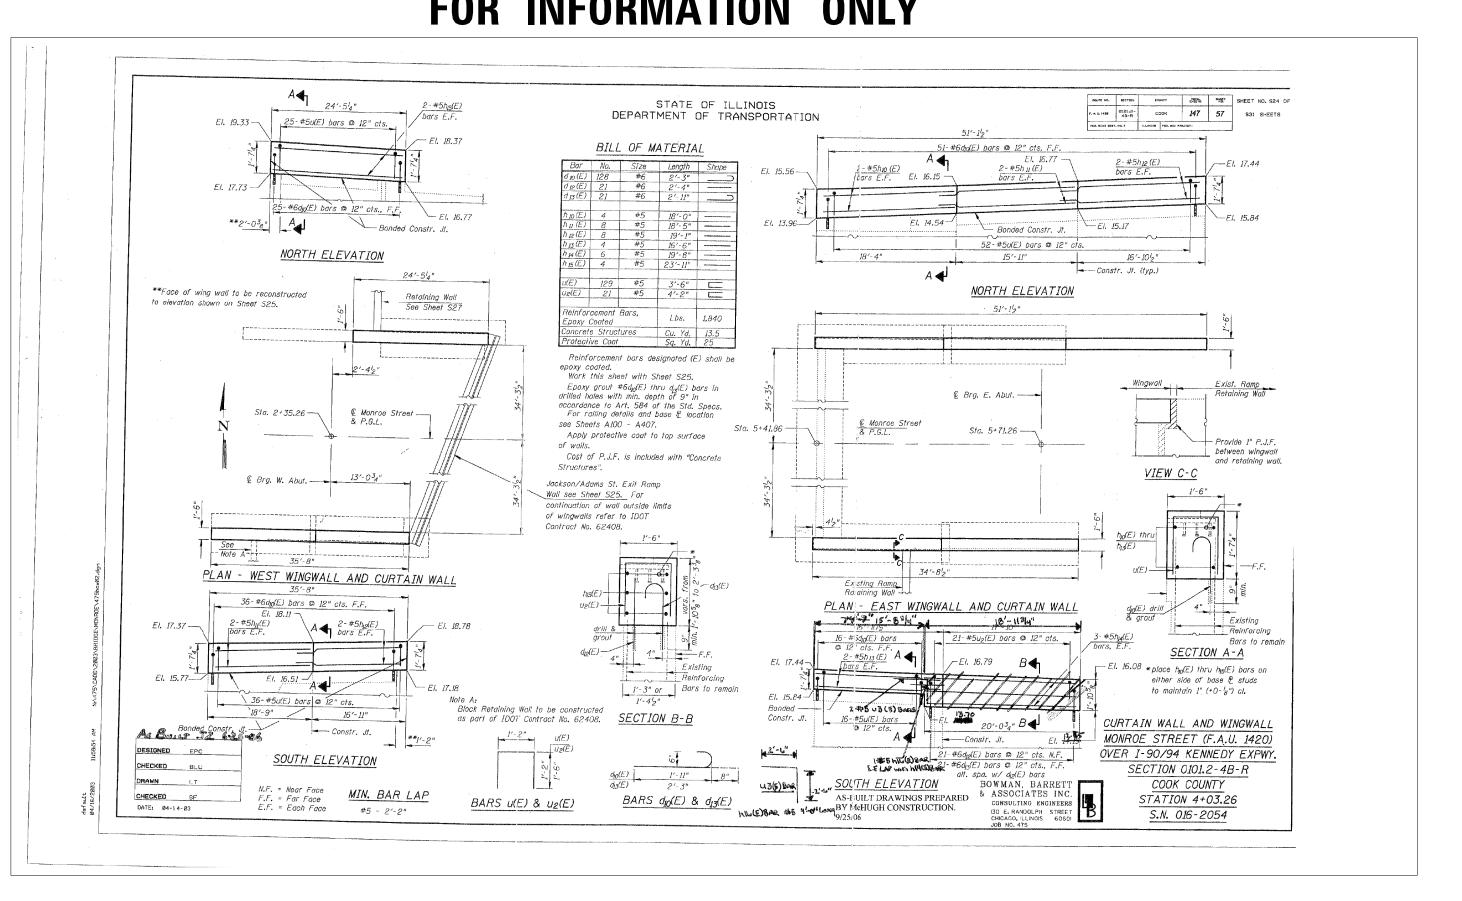

32											
XO		USER NAME = pateld	DESIGNED -	REVISED -		EXISTING PLANS	F.A.I.	SECTION	COUNTY	TOTAL	SHEET
Ó	PARSONS		CHECKED -	REVISED -	STATE OF ILLINOIS		90/94	2014-016R&B	соок	378	236
170	BRINCK ER HOFF	PLOT SCALE = N.T.S.	DRAWN - DCP	REVISED -	DEPARTMENT OF TRANSPORTATION	STRUCTURE NO. 016–2054			CONTRACT	[NO. 6/	X95
016		PLOT DATE = 5/15/2017	CHECKED - JIG	REVISED -		SHEET NO. 24 OF 87 SHEETS		ILLINOIS FED. AI	ID PROJECT		
0											

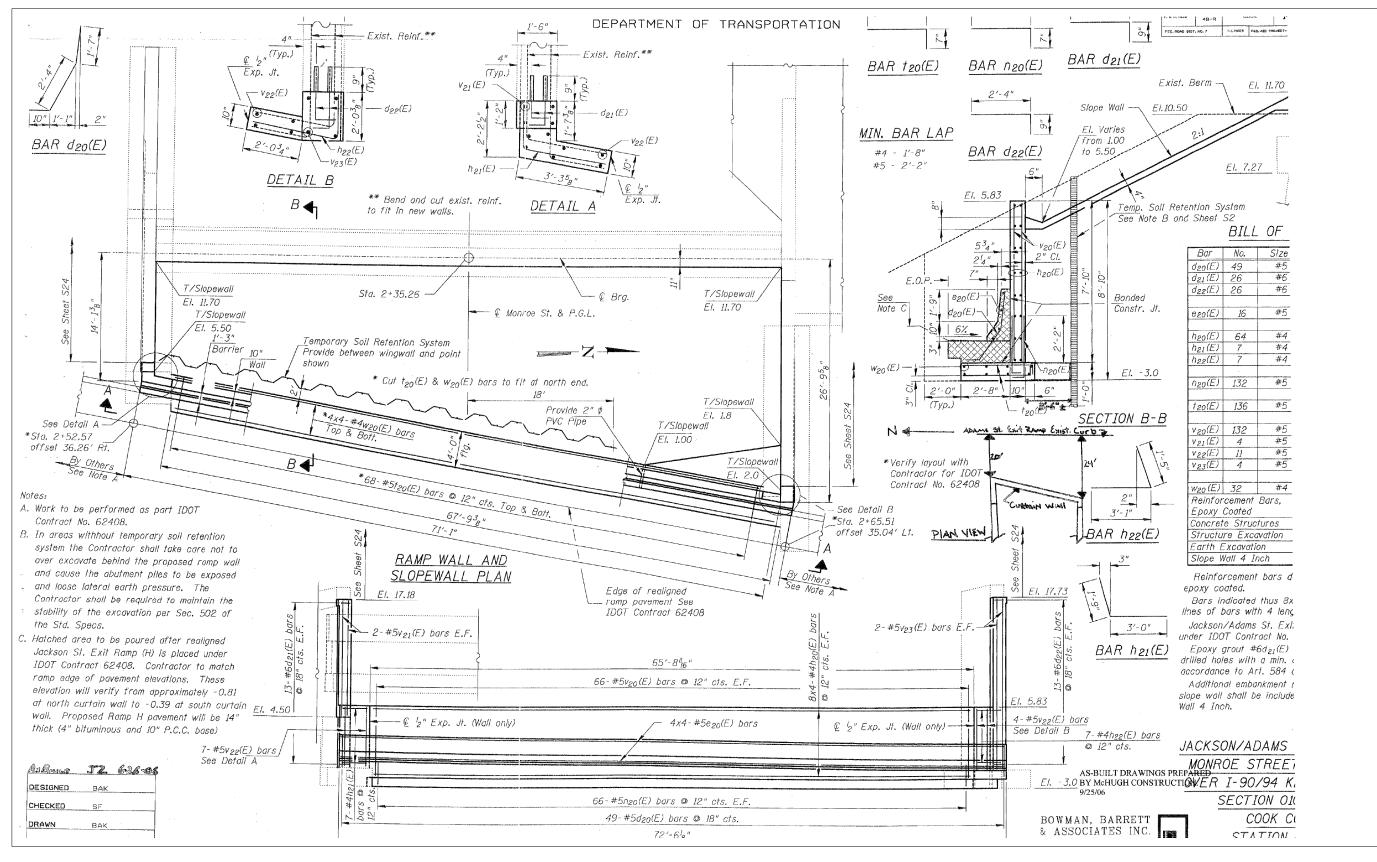


	USER NAME = pateld	DESIGNED -	REVISED -			F.A.I.	SECTION	COUNTY	TOTAL	EET
PARSONS	poroid	CHECKED -	REVISED -	STATE OF ILLINOIS	EXISTING PLANS	RTE.	2014-016R&B	COOK	SHEETS N	10. 137
BRINCKERHOFF	PLOT SCALE = N.T.S.	DRAWN - DCP	REVISED -	DEPARTMENT OF TRANSPORTATION	STRUCTURE NO. 016–2054	507 54	2014-0166&B	CONTRACT	[NO. 60)	95
	PLOT DATE = 5/15/2017	CHECKED - JIG	REVISED -		SHEET NO. 25 OF 87 SHEETS		ILLINOIS FED. AI	D PROJECT		

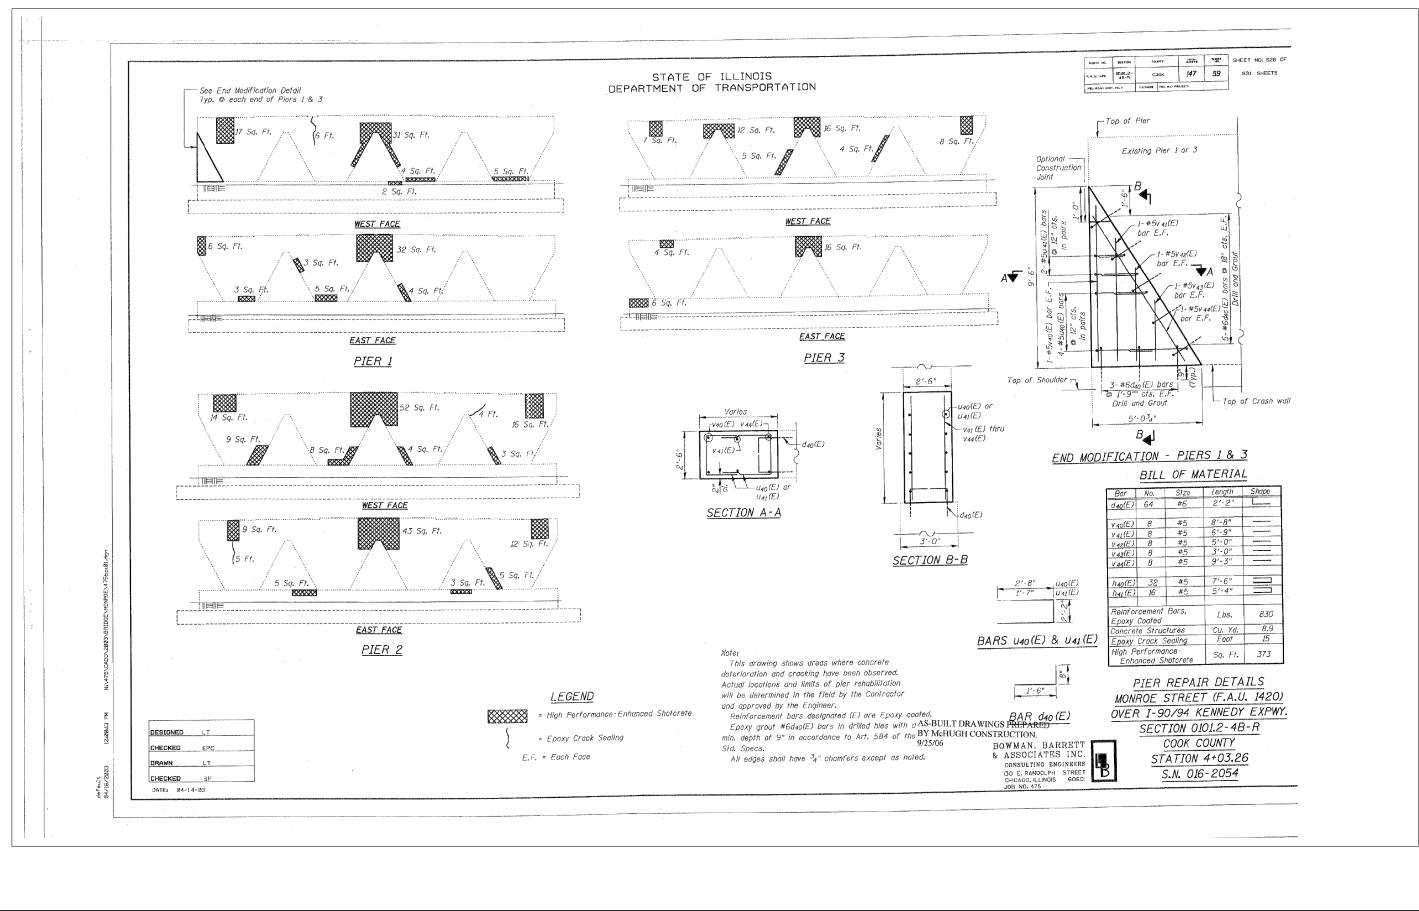

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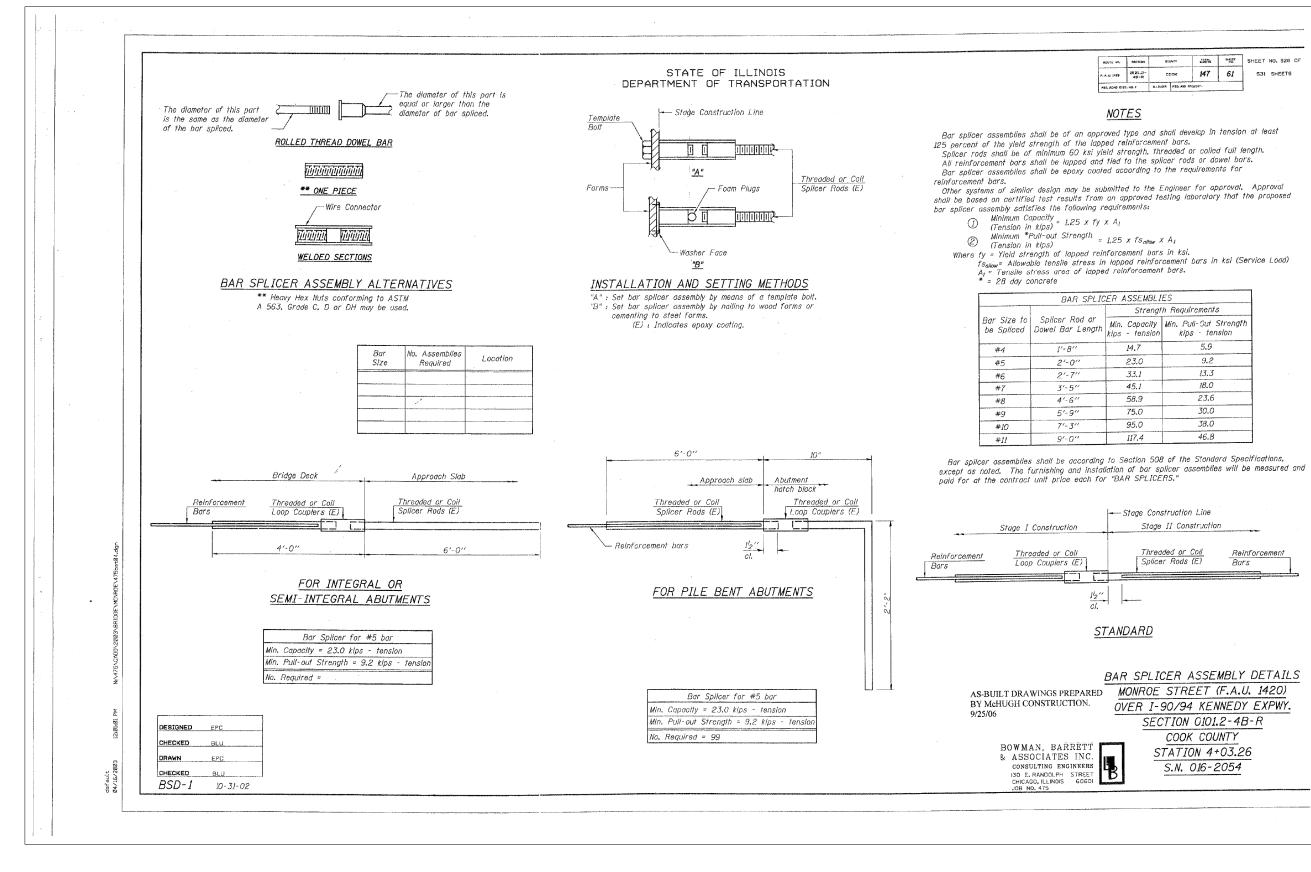
	USER NAME = pateld	DESIGNED -	REVISED -		EXISTING PLANS	F.A.I. RTF.	SECTION	COUNTY TOTAL SHEET
o Fangung		CHECKED -	REVISED -	STATE OF ILLINOIS	STRUCTURE NO. 016–2054	90/94	2014-016R&B	COOK 378 238
	PLUT SCALE = N.T.S. DRAWN - DC	511111	REVISED -	DEPARTMENT OF TRANSPORTATION				CONTRACT NO. 60X95
016	PLOT DATE = 5/15/2017	CHECKED - JIG	REVISED -		SHEET NO. 26 OF 87 SHEETS		ILLINOIS FED. A	AID PROJECT

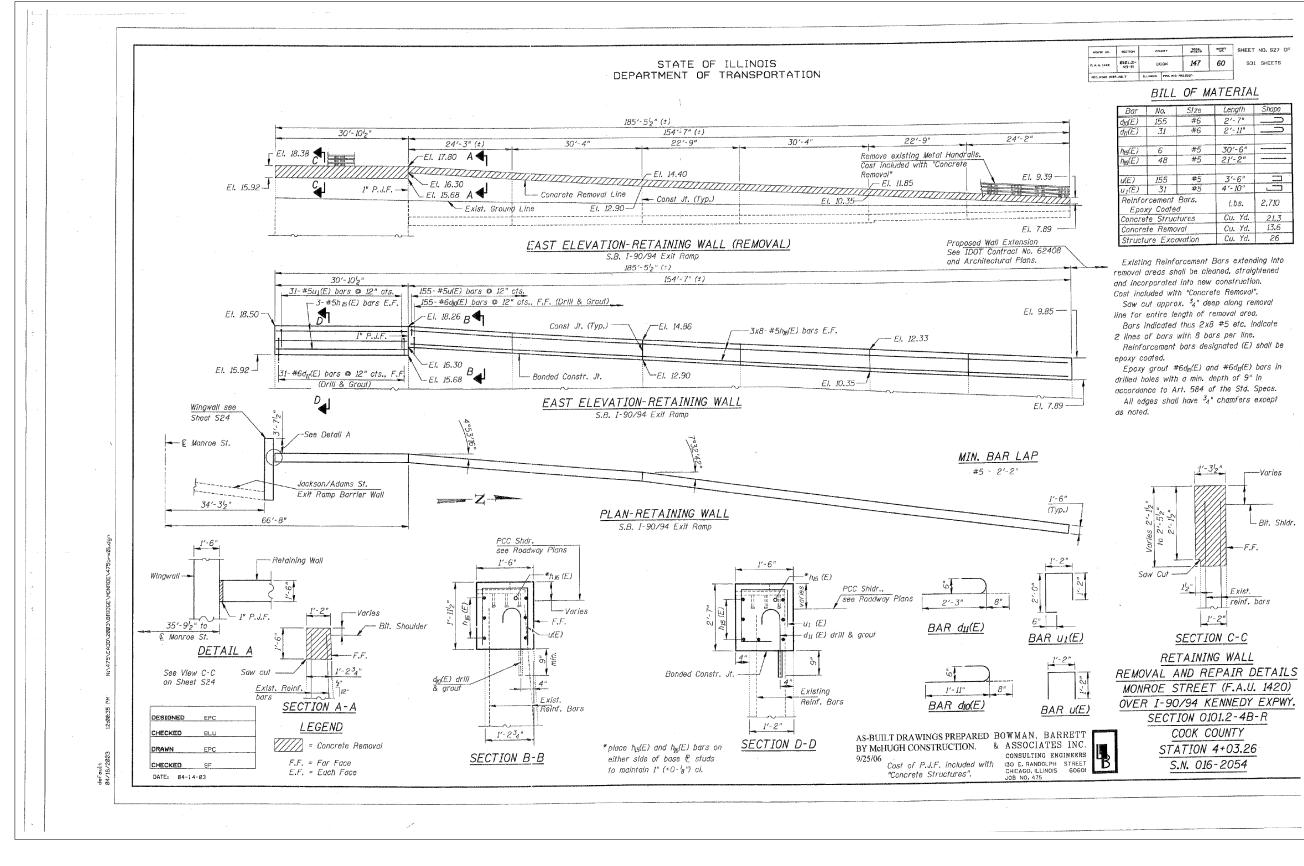

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XO		USER NAME = pateld	DESIGNED -	REVISED -		EXISTING PLANS	F.A.I. RTE	SECTION	COUNTY	TOTAL SHEET SHEETS NO.
	PARSONS		CHECKED -	REVISED -	STATE OF ILLINOIS	STRUCTURE NO. 016–2054	90/94	2014-016R&B	соок	378 239
170	BRINCKERHOFF	PLOT SCALE = N.T.S.	DRAWN - DCP	REVISED -	DEPARTMENT OF TRANSPORTATION	51KUCIUKE NU. 010-2054			CONTRAC	CT NO. 60X95
016		PLOT DATE = 5/15/2017	CHECKED - JIG	REVISED -		SHEET NO. 27 OF 87 SHEETS		ILLINOIS FED.	AID PROJECT	
.						•				

-														
Γ	HOUTE NO. BEDTION		COLINEY		AND PART		SHEET	ND. S27 DF						
	Fi A. U. 1420	Ø101.2- 48-R	50	ок	147	60	\$31	SHEETS						
ŀ			3.1.1MOIS PED. A10 PROJECT-											

Bar	No.	Size	Length	Shape
did(E)	155	#6	2'-7"	·
$d_{II}(E)$	31	#6	2'-11"	
$h_{15}(E)$	6	#5	30'-6"	
$h_{16}(E)$	48	#5	21'-2"	
u(E)	155	#5	3'-6"	
$u_1(E)$	31	#5	4'-10"	
	cement		Lbs.	2,710
	y Coate			
	te Struc	Cu. Yd.	21.3	
Concre	te Remo	Cu. Yd.	13.6	
Structu	Ire Exce	avation	Cu. Yd.	26




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0161700-60X95-S088-EXT.	


	USER NAME = pateld	DESIGNED -	REVISED -		EXISTING PLANS	F.A.I. SECTIO	N COUNTY TOTAL SHEET		
PARSONS		CHECKED -	REVISED -	STATE OF ILLINOIS	STRUCTURE NO. 016–2054	90/94 2014-016	R&B COOK 378 240		
	PLOT SCALE = N.T.S. PLOT DATE = 5/15/2017	DRAWN - DCP CHECKED - JIG	REVISED -	DEPARTMENT OF TRANSPORTATION	SHEET NO. 28 OF 87 SHEETS				
ō	1201 BATE - 371372011	CHECKED - JIG REVISED -			SHEET NO. 20 OF OF SHEETS	ILLINUIS FED. ALD PROJECT			

	ROUTE NO.	-	OLINEY		TOTAL SHIRE TO	SPECET VO.	SHEET	NO. 528 OF
	P. A. LI. 1428 8181.2- 48-R FED. ROAD DIST. NO. 7		соак		147	61	531	SHEETS
			ILLINDIS	FED. AND PN	anea			


AR SPLIC	ER ASSEMBLI	ES
	Strengt	h Requirements
Rod or r Length	Min. Capacity kips – tension	Min. Pull-Out Strength kips - tension
3''	14.7	5.9
0''	23.0	9.2
7''	33.1	13.3
5″	45.1	18.0
6''	58.9	23.6
9''	75.0	30.0
3''	95.0	38.0
0''	117.4	46.8

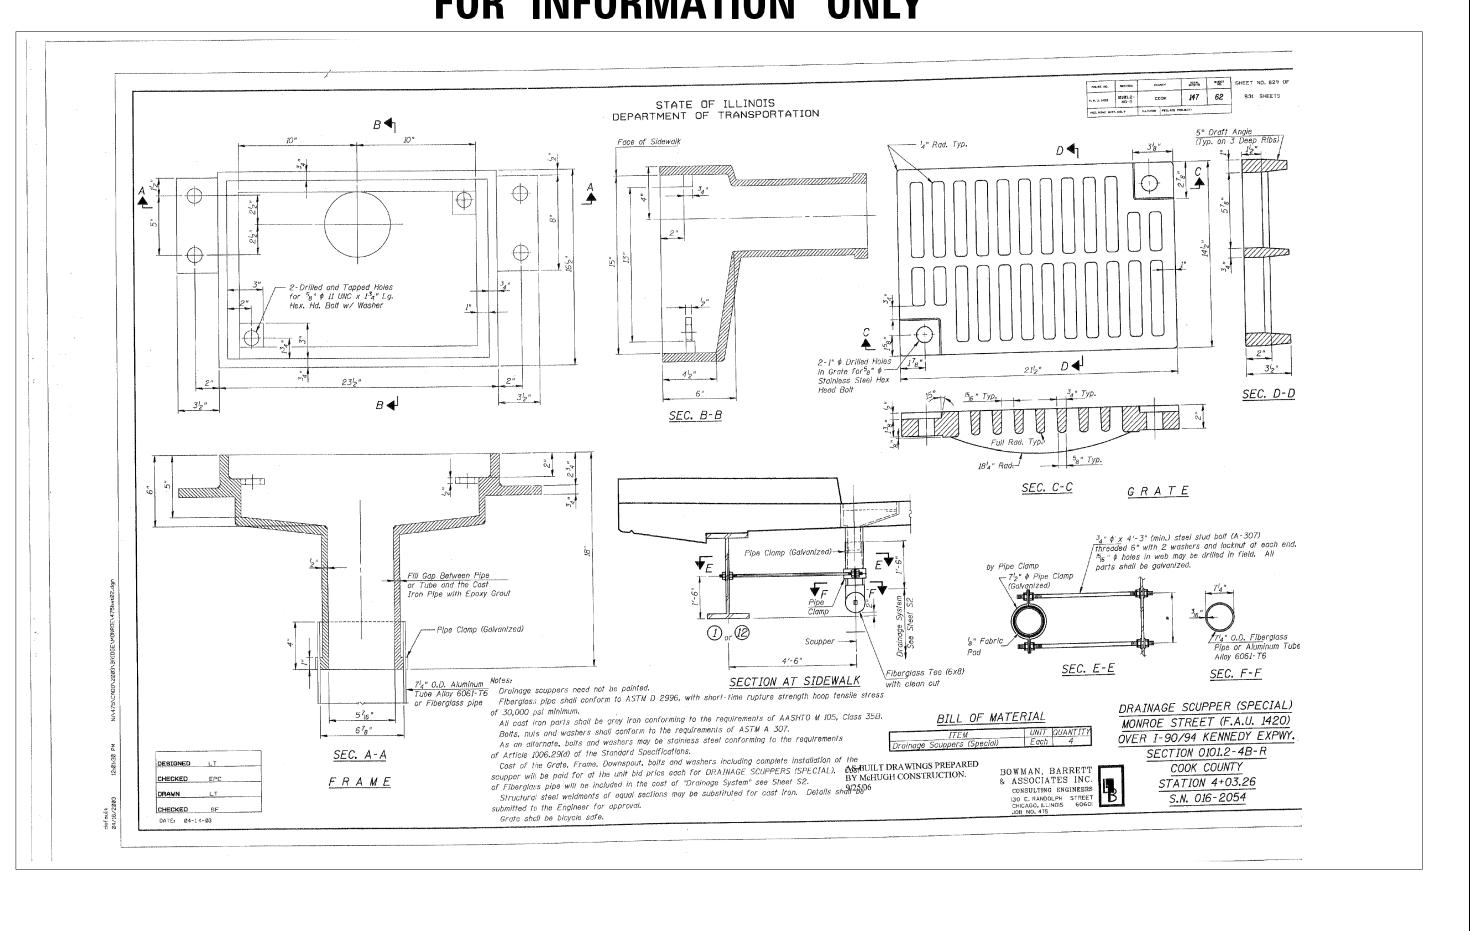

	USER NAME = pateld DESIGNED -		REVISED -		EXISTING PLANS	F.A.I. RTF.	SECTION	COUNTY	TOTAL SHEET	
PARSONS		CHECKED -	REVISED -	STATE OF ILLINOIS	STRUCTURE NO. 016–2054	90/94	2014-016R&B	СООК	378 241	
BRINCKERHOFF	PLOT SCALE = N.T.S.	DRAWN - DCP	REVISED -	DEPARTMENT OF TRANSPORTATION		CONTRACT NO. 60X95				
5	PLOT DATE = 5/15/2017 CHECKED - JIG REVISED -			SHEET NO. 29 OF 87 SHEETS		ILLINOIS FED. AID PROJECT				

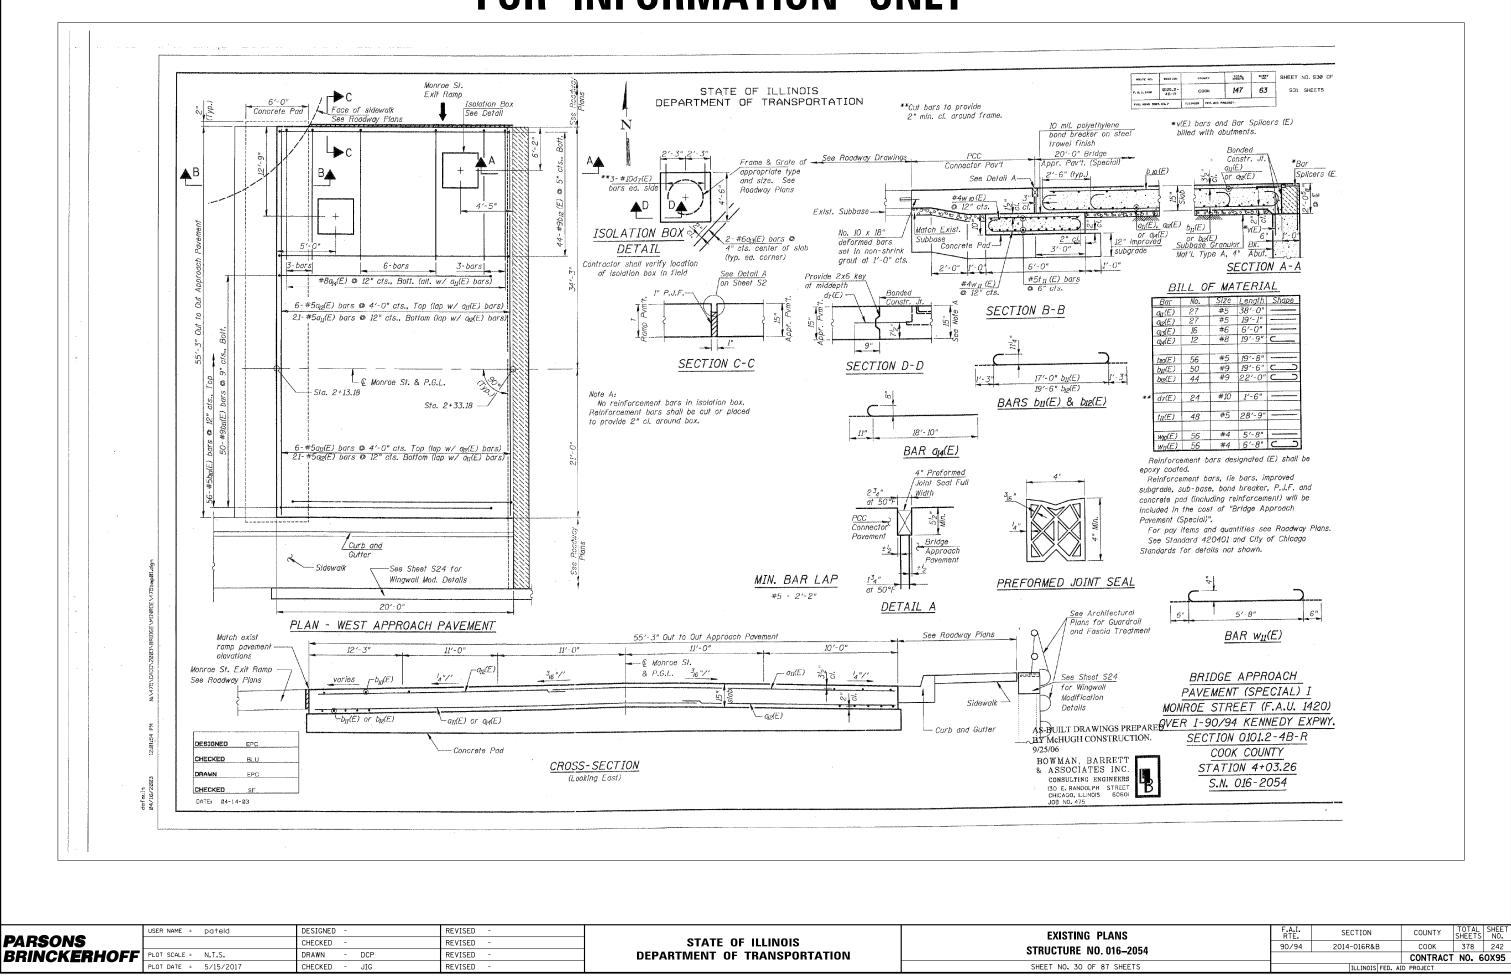

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LANS	F.A.I. RTE.	SECTION	COUNTY	TOTAL SHEETS	SHEET NO.
016-2054	90/94	2014-016R&B	СООК	378	242
010-2034	1		CONTRACT	NO. 6	0X95
37 SHEETS	1	ILLINOIS FED. AI	D PROJECT		

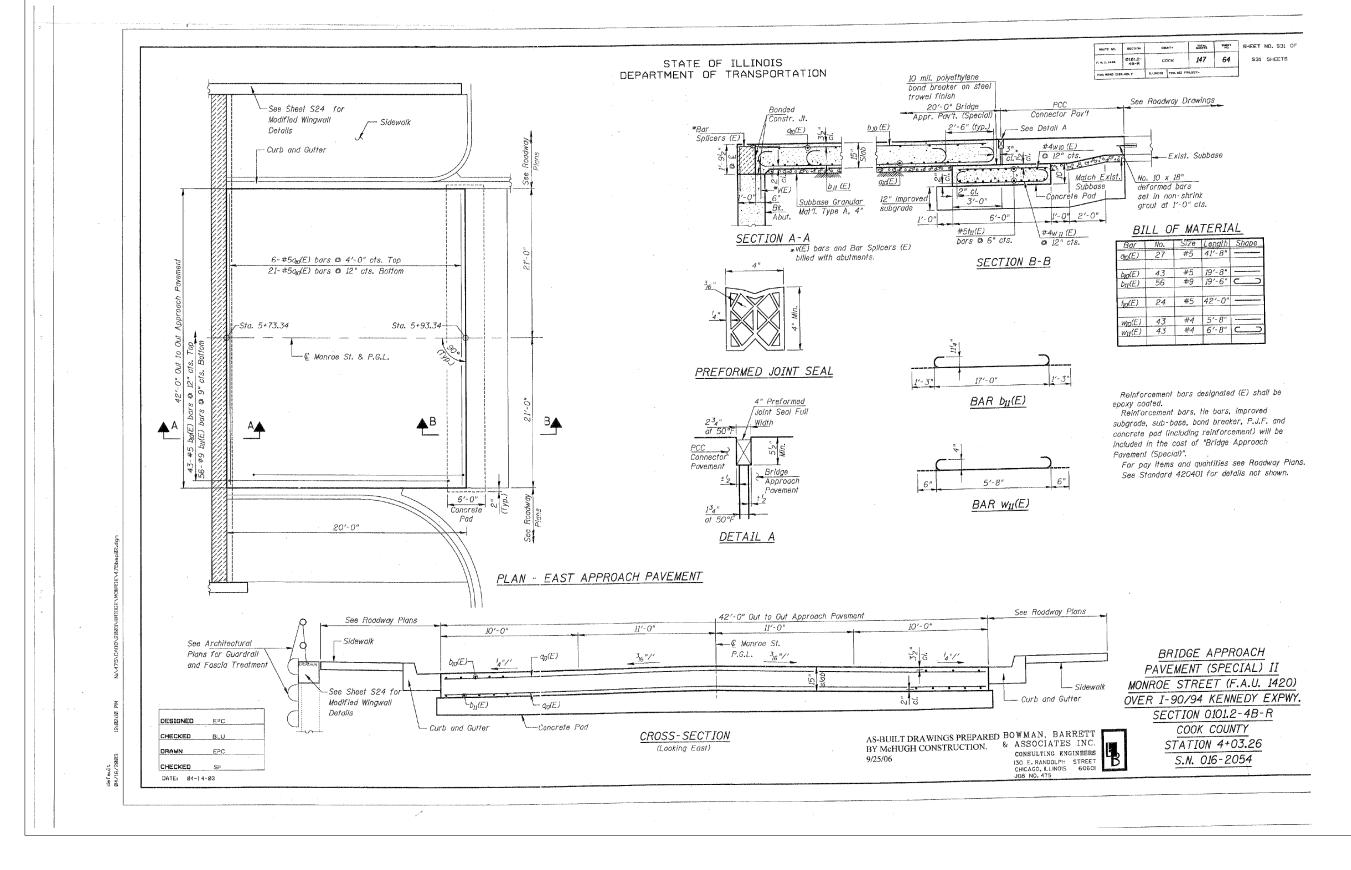


ò	PARSONS BRINCKERHOFF	USER NAME = pateld PLOT SCALE = N.T.S.	DESIGNED - CHECKED - DRAWN - DCP	REVISED - REVISED - REVISED -	STATE OF ILLINOIS DEPARTMENT OF TRANSPORTATION	EXISTING PLANS STRUCTURE NO. 016-
	PLOT DATE = 5/15/2017	CHECKED - JIG	REVISED -		SHEET NO. 31 OF 87 SHE	

INS	F.A.I. RTE,	SE	CTION		Τ	COUNTY	T	OTAL HEETS	SHEET
16–2054	90/94	2014	-016R&E	3		COOK	-	378	243
SHEETS			TI I THOTO	55D	410	CONTRAC	TI	10. 6	0X95
SHELTS			ILLINOIS	FED.	AID	PROJECT			

STATE OF ILLINOIS DEPARTMENT OF TRANSPORTATION

REHABILITATION OF THE MONROE STREET BRIDGE OVER INTERSTATE 90-94


MONROE STREET DRAWINGS

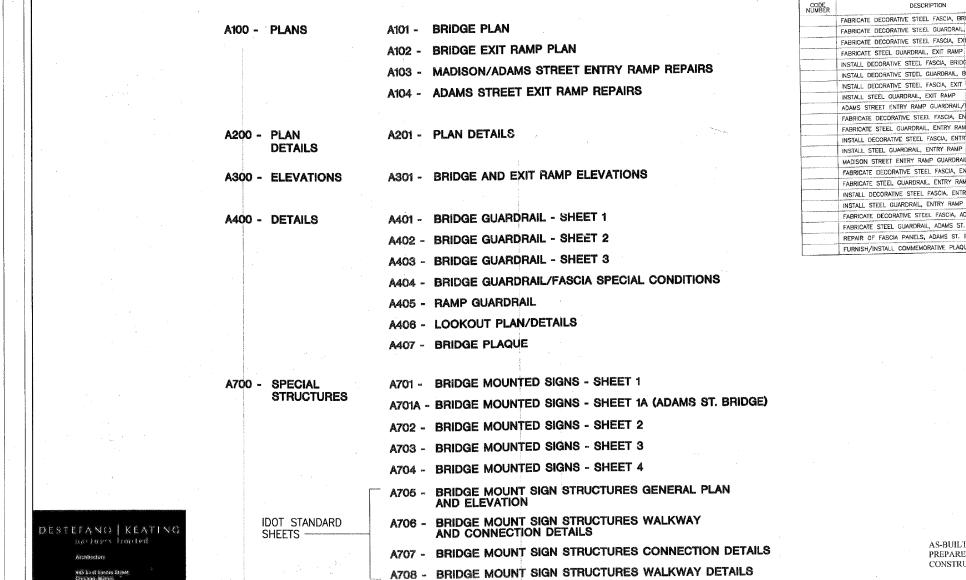

	USER NAME = pateld	DESIGNED -	REVISED -		EXISTING PLANS	F.A.I. SECTION	COUNTY TOTAL SHEET
J PARSONS		CHECKED -	REVISED -	STATE OF ILLINOIS	STRUCTURE NO. 016–2054	90/94 2014-016R&B	COOK 378 244
BRINCKERHOFF	PLOT SCALE = N.T.S.	DRAWN - DCP REVISED -	REVISED	DEPARTMENT OF TRANSPORTATION			CONTRACT NO. 60X95
016	PLOT DATE = 5/15/2017	CHECKED - JIG	REVISED -		SHEET NO. 32 OF 87 SHEETS	ILLINOIS FED	. AID PROJECT


R	DUTE	NO.	SECTIÓN	COUNTY	TOTAL SHEETS	SHEET NO.	SHEET	N
1	1420 0101.2-4B-R		COOK		94A	SH	EÉ	
F	FED. ROAD DIST.			ILLINOIS FED.	AID PRO	JECT		

BILL OF MATERIALS-ARCHITECTURAL ENHANCEMENTS		
DESCRIPTION	UNIT	TOTAL QUANTITY
FABRICATE DECORATIVE STEEL FASCIA, BRIDGE	FEET	700
FABRICATE DECORATIVE STEEL GUARDRAIL, BRIDGE	FEET	750
FABRICATE DECORATIVE STEEL FASCIA, EXIT RAMP	FEET	294
FABRICATE DECORATIVE STEEL FACINE, EAT TOTAL	FEET	294
	FEET	700
INSTALL DECORATIVE STEEL FASCIA, BRIDGE	FEET	750
INSTALL DECORATIVE STEEL GUARDRAIL, BRIDGE	FEET	294
INSTALL DECORATIVE STEEL FASCIA, EXIT RAMP	FEET	185
INSTALL STEEL GUARDRAIL, EXIT RAMP	FEET	34
ADAMS STREET ENTRY RAMP GUARDRAIL/FASCIA REMOVAL	FEET	182
FABRICATE DECORATIVE STEEL FASCIA, ENTRY RAMP (ADAMS)	FEET	34
FABRICATE STEEL GUARDRAIL, ENTRY RAMP (ADAMS)	FEET	182
INSTALL DECORATIVE STEEL FASCIA, ENTRY RAMP (ADAMS)	FEET	
INSTALL STEEL GUARDRAIL, ENTRY RAMP (ADAMS)	FEET	34
MADISON STREET ENTRY RAMP GUARDRAIL FASCIA REMOVAL	FEET	170
FABRICATE DECORATIVE STEEL FASCIA, ENTRY RAMP (MADISON)	FEET	34
FABRICATE STEEL GUARDRAIL, ENTRY RAMP (MADISON)	FEET	170
INSTALL DECORATIVE STEEL FASCIA, ENTRY RAMP (MADISON)		34
INSTALL STEEL GUARDRAIL, ENTRY RAMP (MADISON)	FEET	245
FABRICATE DECORATIVE STEEL FASCIA, ADAMS ST. EXIT RAMP	FEET	245
FABRICATE STEEL GUARDRAIL, ADAMS ST. EXIT RAMP	FEET	
REPAIR OF FASCIA PANELS, ADAMS ST. BRIDGE	EACH	3
FURNISH/INSTALL COMMEMORATIVE PLAQUE	EACH	2
		· · · · · · · · · · · · · · · · · · ·
	KE U. RTE.	STREET OVER 1-90 NNEDY EXPRESSWAY 1420, SEC. 0101. COOK COUNTY STA. 4+03.26 FR. NUM. 016-2054

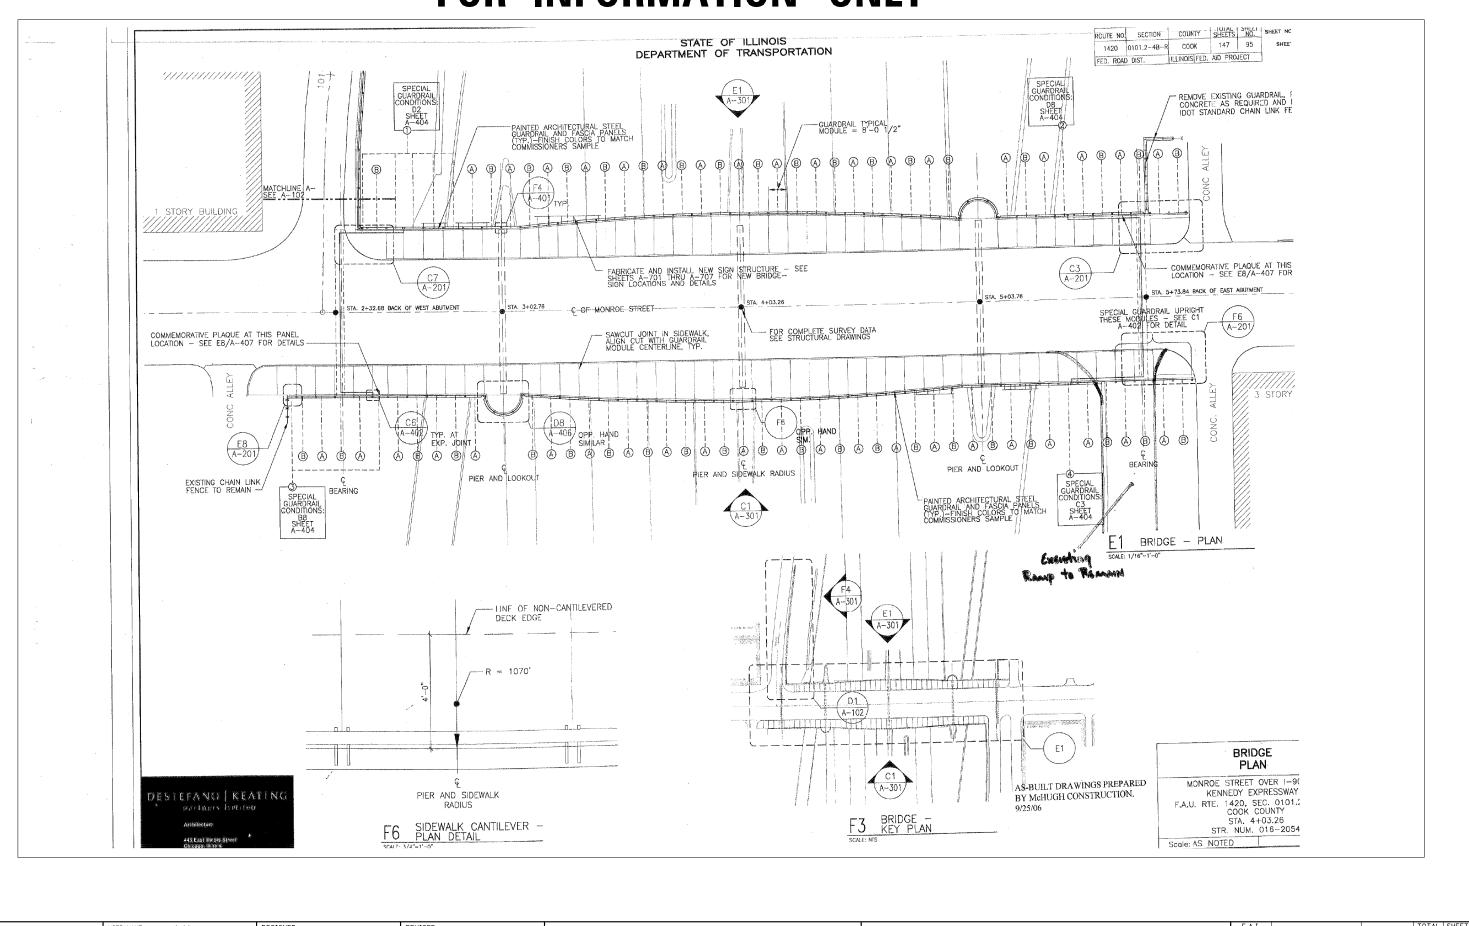

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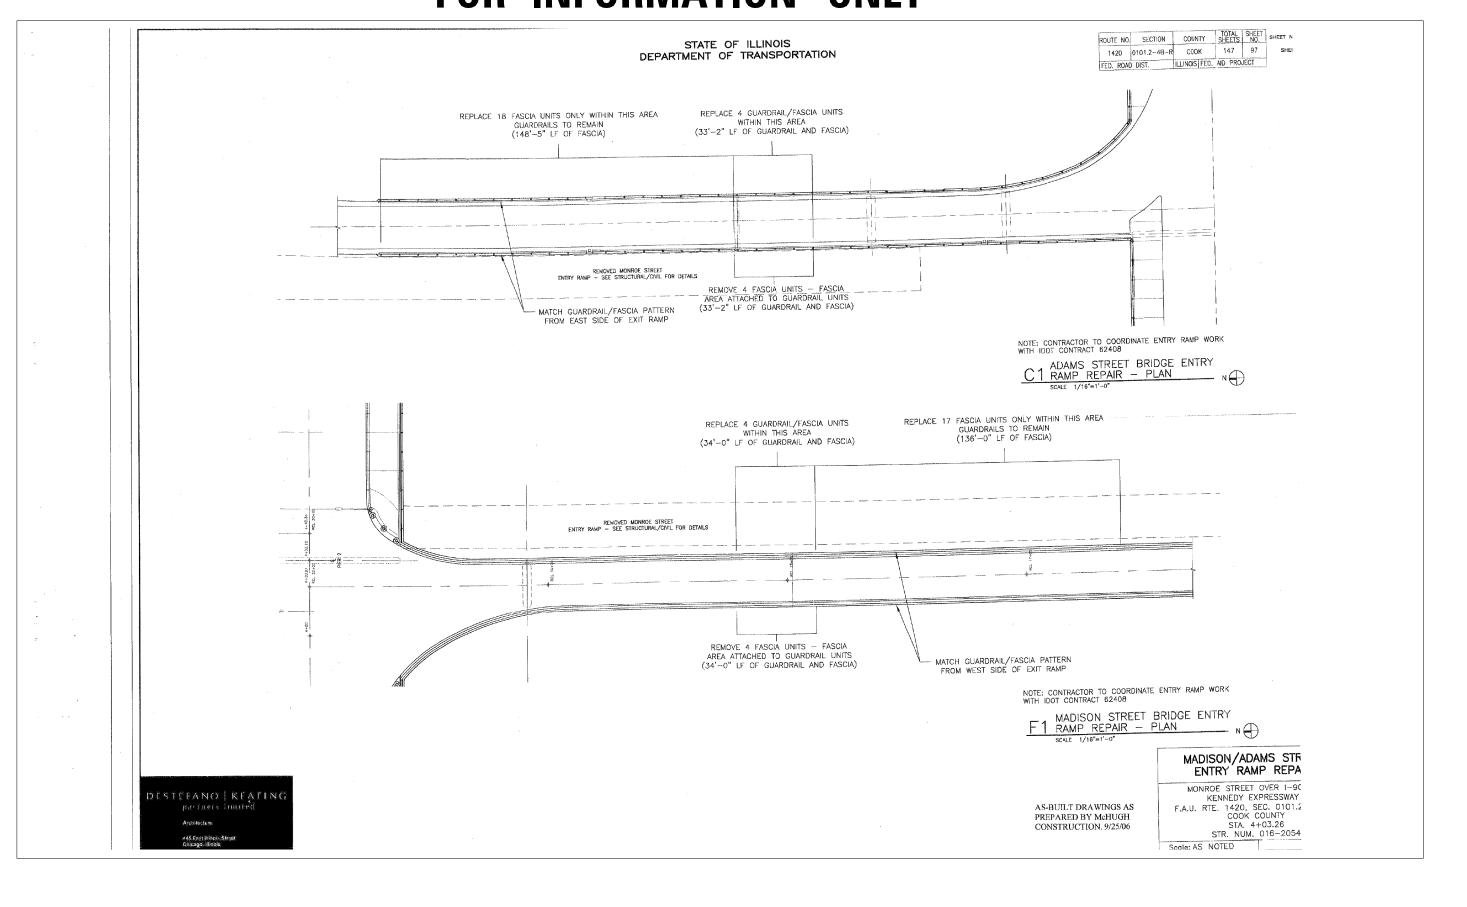
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PARSONS		CHECKED -	REVISED -	STATE OF ILLINOIS	STRUCTURE NO. 016–2054	90/94	2014-016R&B	COOK 378 245
	PLOT SCALE = N.T.S.	DRAWN - DCP	REVISED -	DEPARTMENT OF TRANSPORTATION				CONTRACT NO. 60X95
ō	PLOT DATE = 5/15/2017	CHECKED - JIG	REVISED -		SHEET NO. 33 OF 87 SHEETS		ILLINOIS FED. A	ID PROJECT

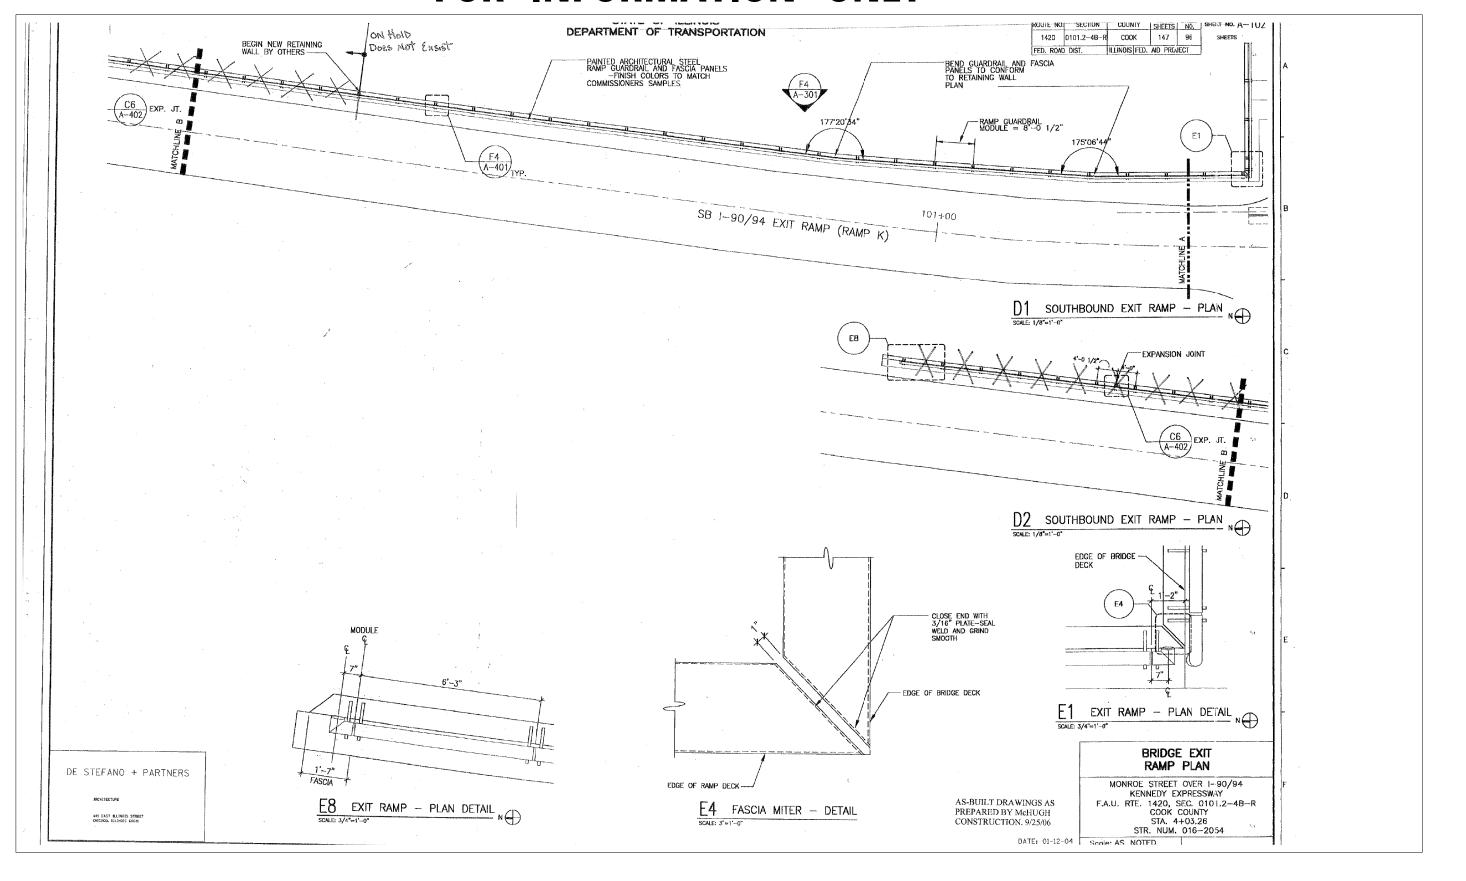


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6X09		USER NAME = pateld	DESIGNED -	REVISED -		EXISTING PLANS	F.A.I. RTE.	SECTION	COUNTY	TOTAL SHEETS	SHEET NO.
	PARSONS		CHECKED -	REVISED -	STATE OF ILLINOIS	STRUCTURE NO. 016–2054	90/94	2014-016R&B	СООК	378	246
6170	BRINCK ER HOFF	PLOT SCALE = N.T.S.	DRAWN - DCP	REVISED -	DEPARTMENT OF TRANSPORTATION				CONTRAC	T NO. 6	0X95
ΞL		PLUT DATE = 571572017	CHECKED - JIG	REVISED -		SHEET NU. 34 UF 87 SHEETS		ILLINOIS FED. A	ID PROJECT		






	USER NAME = pateld	DESIGNED -	REVISED -		EXISTING PLANS	F.A.I. BTF.	SECTION	COUNTY TOTAL SHEET
PARSONS	CHECKE	CHECKED - REVISED -		STATE OF ILLINOIS	STRUCTURE NO. 016–2054	90/94 2014-016R&B CO		COOK 378 247
BRINCKERHOFF	PLOT SCALE = N.T.S. PLOT DATE = 5/15/2017	DRAWN - DCP CHECKED - JIG	REVISED - REVISED -	DEPARTMENT OF TRANSPORTATION	SHEET NO. 35 OF 87 SHEETS			CONTRACT NO. 60X95
	PLOT DATE = 5/15/2017	CHECKED - JIG	REVISED -		SHEET NO. 35 OF 87 SHEETS		ILLINOIS FED. AI) PROJECT

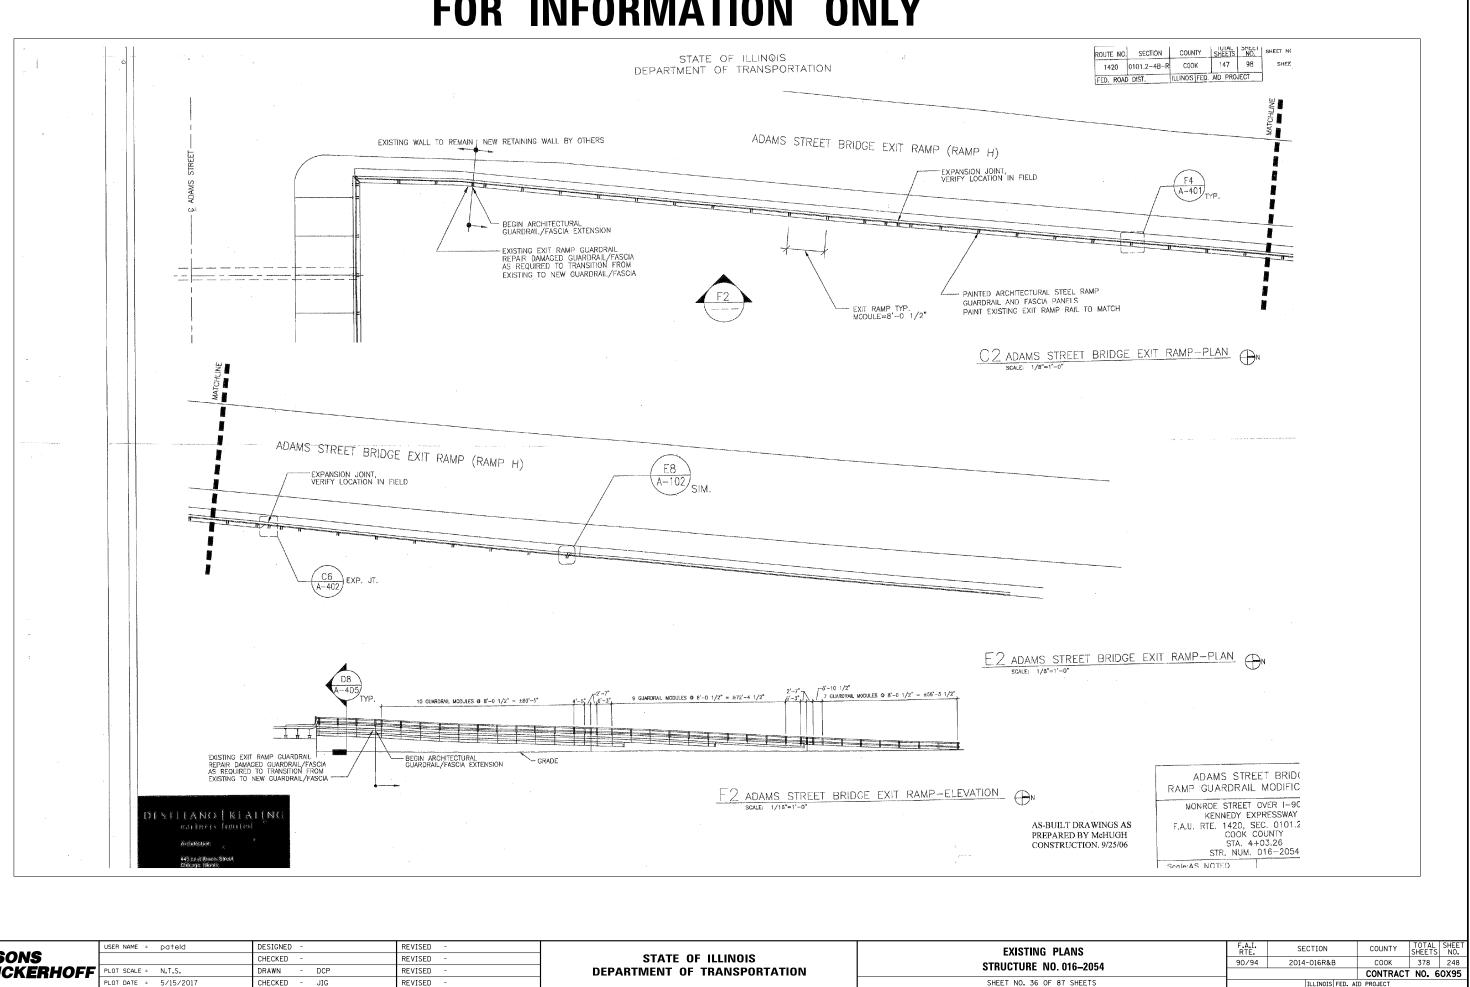


TULINOIS FED ATD PROJECT

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5		USER NAME = pateld	DESIGNED -	REVISED -		EXISTING PLANS
ŝ	PARSONS		CHECKED -	REVISED -	STATE OF ILLINOIS	
Ď	BRINCKERHOFF	PLOT SCALE = N.T.S.	DRAWN - DCP	REVISED -	DEPARTMENT OF TRANSPORTATION	STRUCTURE NO. 016-
e l	2	PLOT DATE = 5/15/2017	CHECKED - JIG	REVISED -		SHEET NO. 36 OF 87 SHE

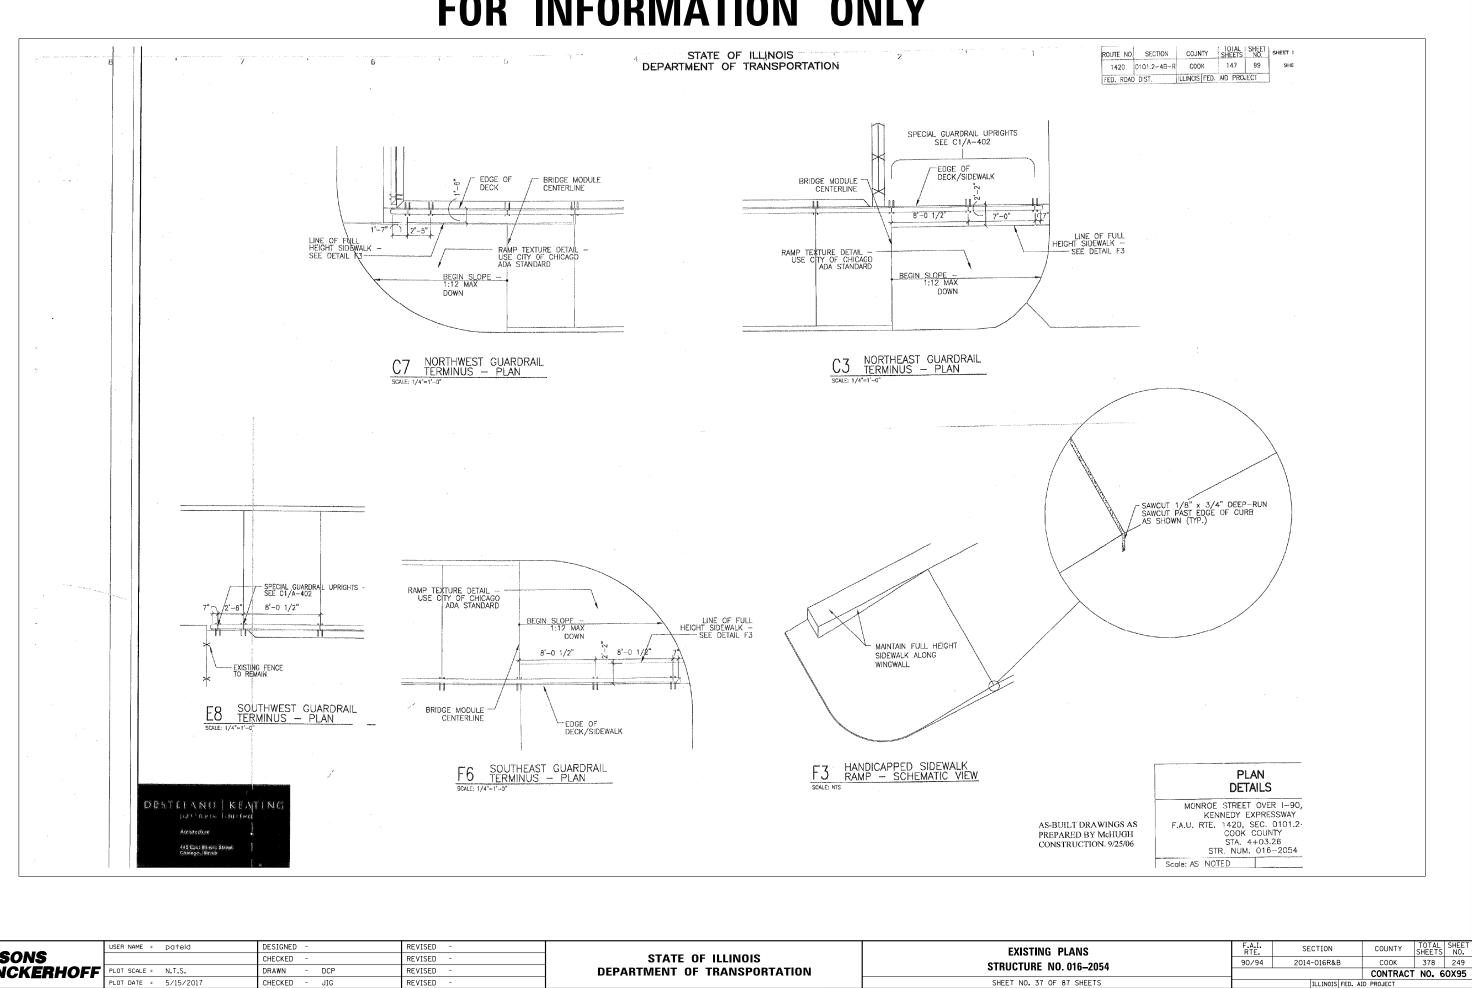


5						
š		USER NAME = pateld	DESIGNED -	REVISED -		EXISTING PLANS
ŝ	PARSONS		CHECKED -	REVISED -	STATE OF ILLINOIS	
ē	BRINCKERHOFF	PLOT SCALE = N.T.S.	DRAWN - DCP	REVISED -	DEPARTMENT OF TRANSPORTATION	STRUCTURE NO. 016-
		PLOT DATE = 5/15/2017	CHECKED - JIG	REVISED -		SHEET NO. 37 OF 87 SHE

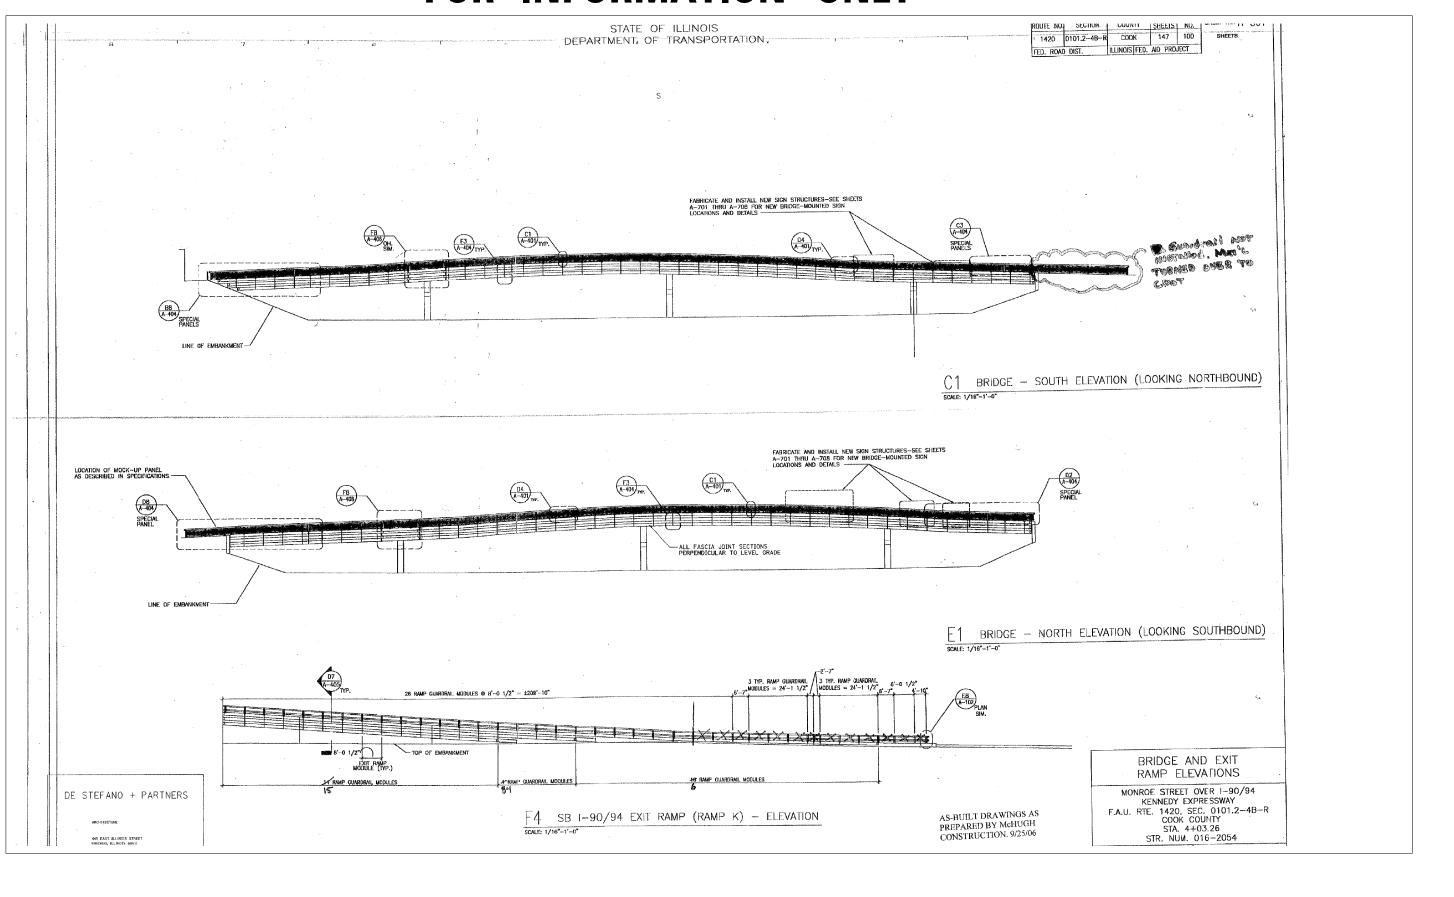

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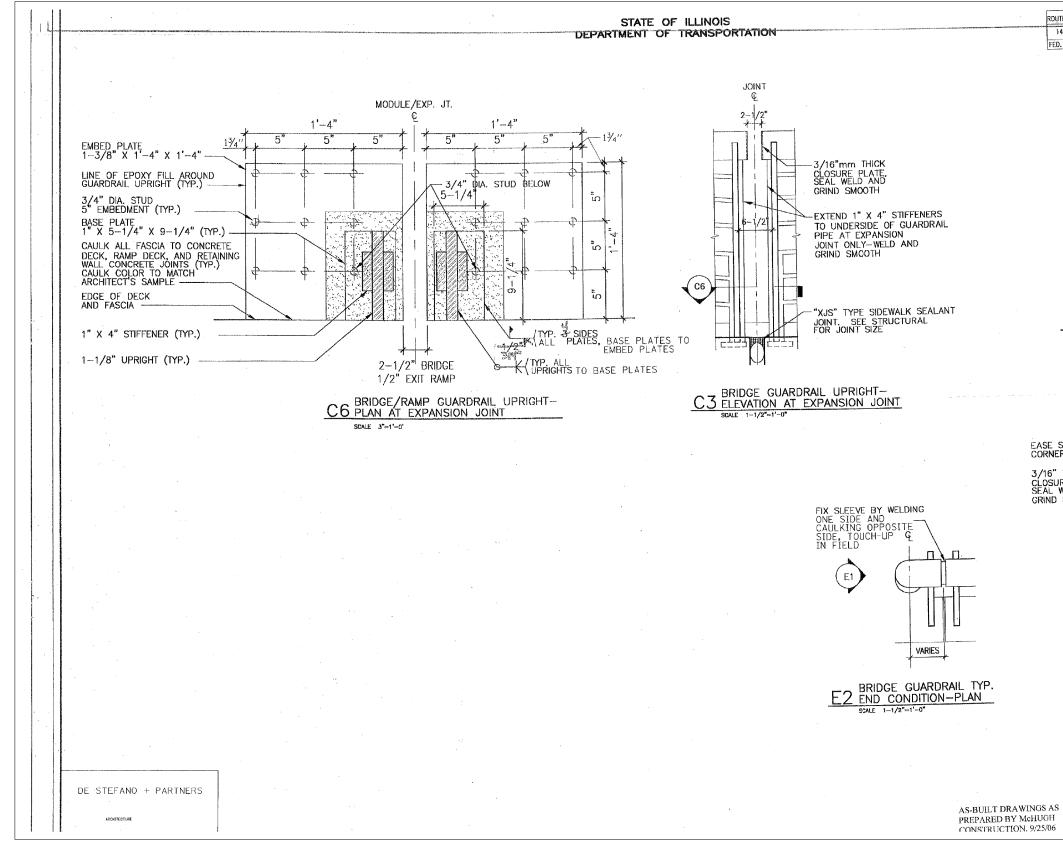
ō l						
Ň		USER NAME = pateld	DESIGNED -	REVISED -		EXISTING PLANS
	PARSONS		CHECKED -	REVISED -	STATE OF ILLINOIS	
170	BRINCKERHOFF	PLOT SCALE = N.T.S.	DRAWN - DCP	REVISED -	DEPARTMENT OF TRANSPORTATION	STRUCTURE NO. 016-
016		PLOT DATE = 5/15/2017	CHECKED - JIG	REVISED -		SHEET NO. 38 OF 87 SHE
_						

SECTION	COUNTY	TOTAL SHEETS	SHEET NO.
2014-016R&E	з соок	378	250
	CONTRAC	T NO. 6	0X95
ILLINOIS	FED. AID PROJECT		
-	2014-016R&E	2014-016R&B COOK	SECTION COUNTY SHEETS 2014-016R&B COOK 378 CONTRACT NO. 6

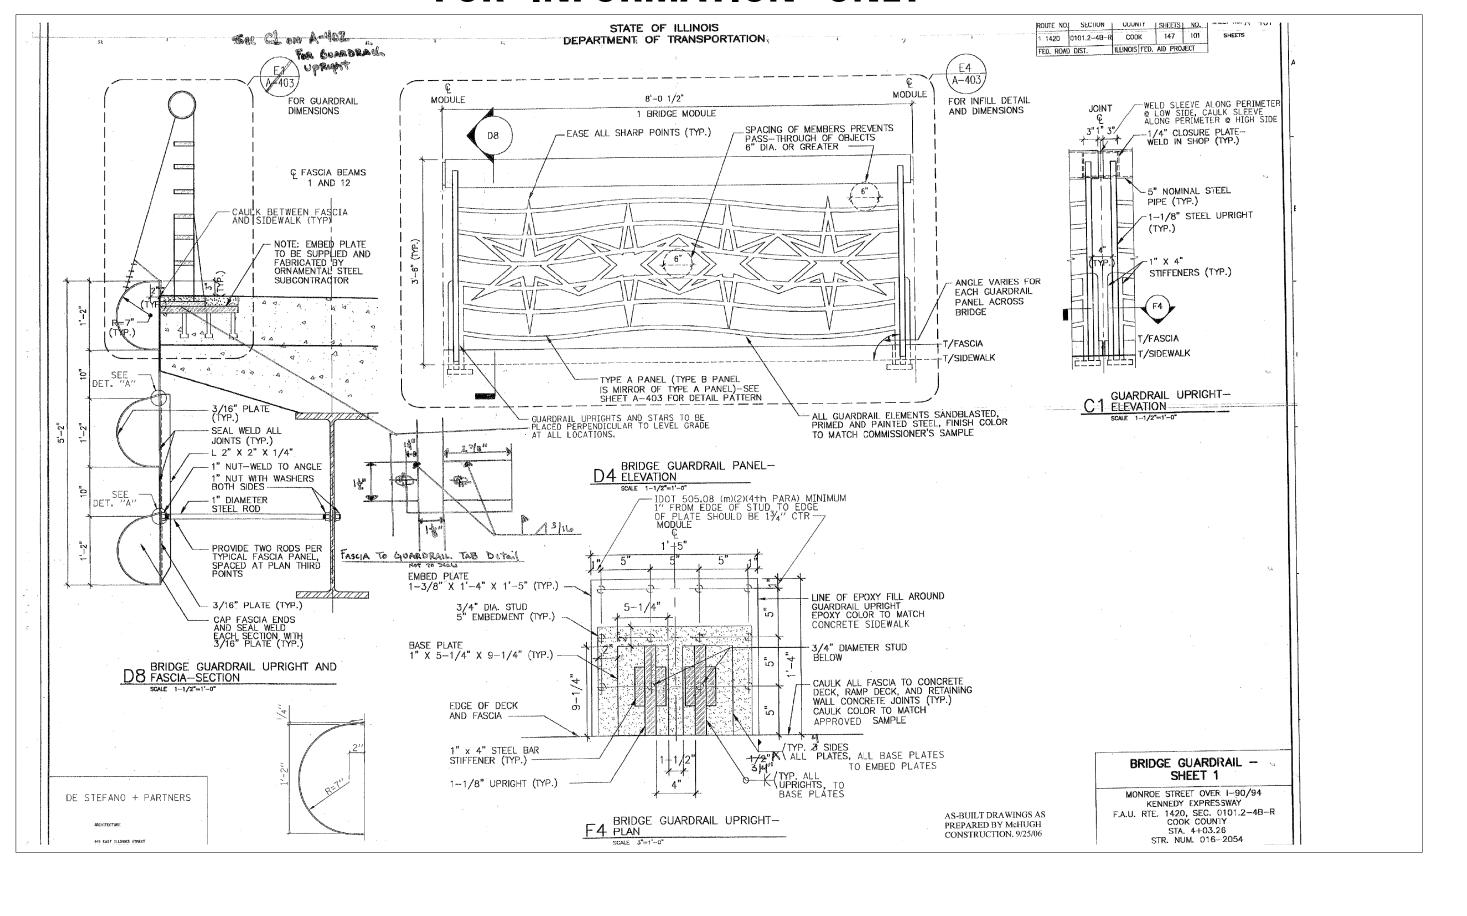


8						
Xo		USER NAME = pateld	DESIGNED -	REVISED -		EXISTING PLAN
ò	PARSONS		CHECKED -	REVISED -	STATE OF ILLINOIS	
170	BRINCKERHOFF	PLOT SCALE = N.T.S.	DRAWN - DCP	REVISED -	DEPARTMENT OF TRANSPORTATION	STRUCTURE NO. 016
016		PLOT DATE = 5/15/2017	CHECKED - JIG	REVISED -		SHEET NO. 39 OF 87 SH


LANS	F.A.I. RTE.	SECTION	COUNTY	TOTAL SHEETS	SHEET NO.
016–2054	90/94	2014-016R&B	СООК	378	251
. 010-2034			CONTRACT	NO. 6	0X95
87 SHEETS		ILLINOIS FED.	ID PROJECT		



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5		USER NAME = pateld	DESIGNED -	REVISED -		EXISTING PLANS
ŝ	P ARSONS		CHECKED -	REVISED -	STATE OF ILLINOIS	
Ď	BRINCKERHOFF	PLOT SCALE = N.T.S.	DRAWN - DCP	REVISED -	DEPARTMENT OF TRANSPORTATION	STRUCTURE NO. 016-2
e lo	2	PLOT DATE = 5/15/2017	CHECKED - JIG	REVISED -		SHEET NO. 40 OF 87 SHEE

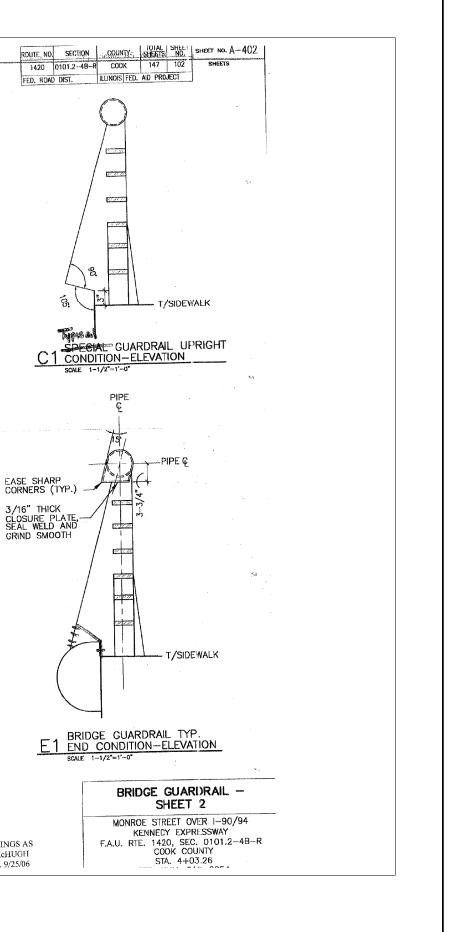


LANS	F.A.I. RTE.	F.A.I. SECTION C		TOTAL SHEETS	SHEET	
016–2054	90/94	2014-016R&B	СООК	378	252	
010-2034			CONTRACT	NO. 6	0X95	
37 SHEETS		ILLINOIS FED. AI	D PROJECT			

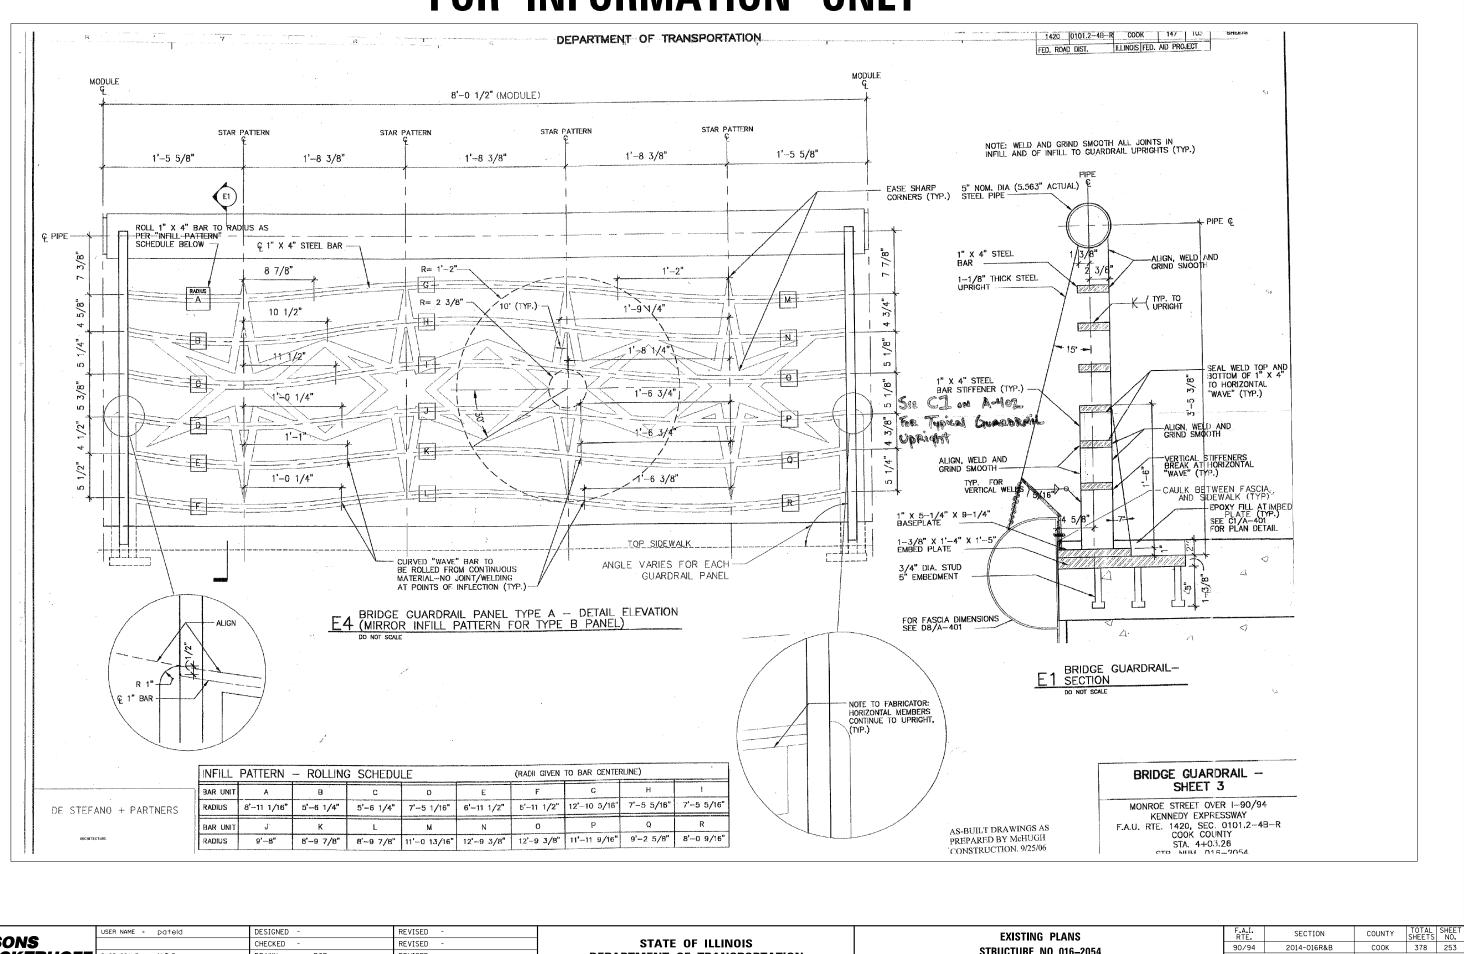

	PARSONS BRINCKERHOFF	USER NAME = pateld PLOT SCALE = N.T.S.	DESIGNED - CHECKED - DRAWN - DCP	REVISED - REVISED - REVISED -	STATE OF ILLINOIS DEPARTMENT OF TRANSPORTATION	EXISTING PLANS STRUCTURE NO. 016-
0161	DHINCKENNOFF	PLOT DATE = 5/15/2017	CHECKED - JIG	REVISED -		SHEET NO. 41 OF 87 SHE


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. 010-2054			CONTRACT	NO.	60X95
87 SHEETS	ILLINOIS	FED. AI	D PROJECT		

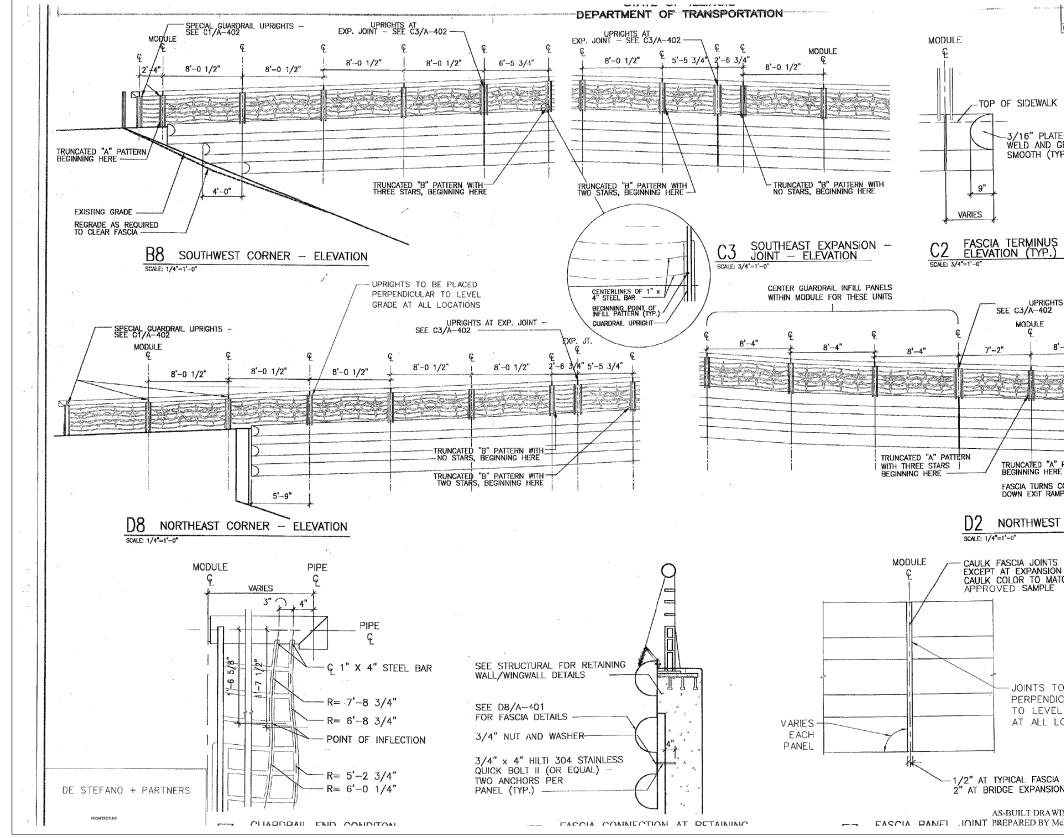

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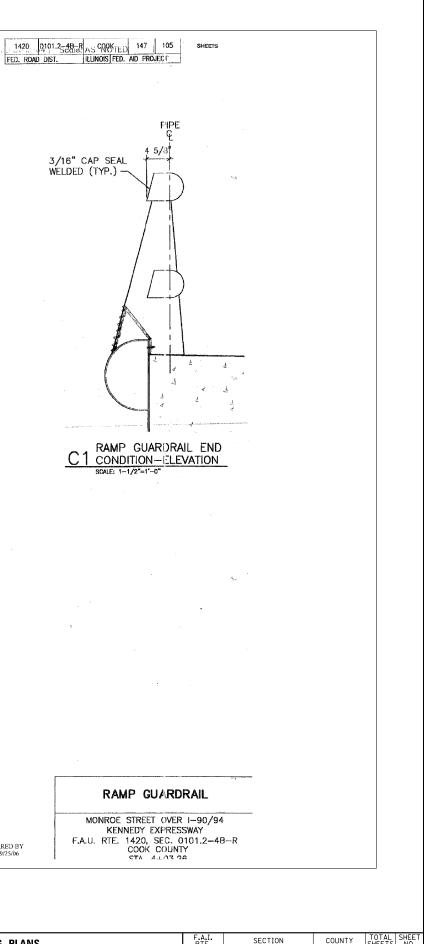
	USER NAME = pateld	DESIGNED -	REVISED -		EXISTING PLANS	F.A.I. SECTION	COUNTY TOTAL SHEET
PARSONS		CHECKED -	REVISED -	STATE OF ILLINOIS	STRUCTURE NO. 016–2054	90/94 2014-016R&B	COOK 378 254
BRINCKERHOFF	PLOT SCALE = N.T.S.	DRAWN - DCP	REVISED -	DEPARTMENT OF TRANSPORTATION		-	CONTRACT NO. 60X95
016	PLOT DATE = 5/15/2017	CHECKED - JIG	REVISED -		SHEET NO. 42 OF 87 SHEETS	ILLINOIS FED.	AID PROJECT

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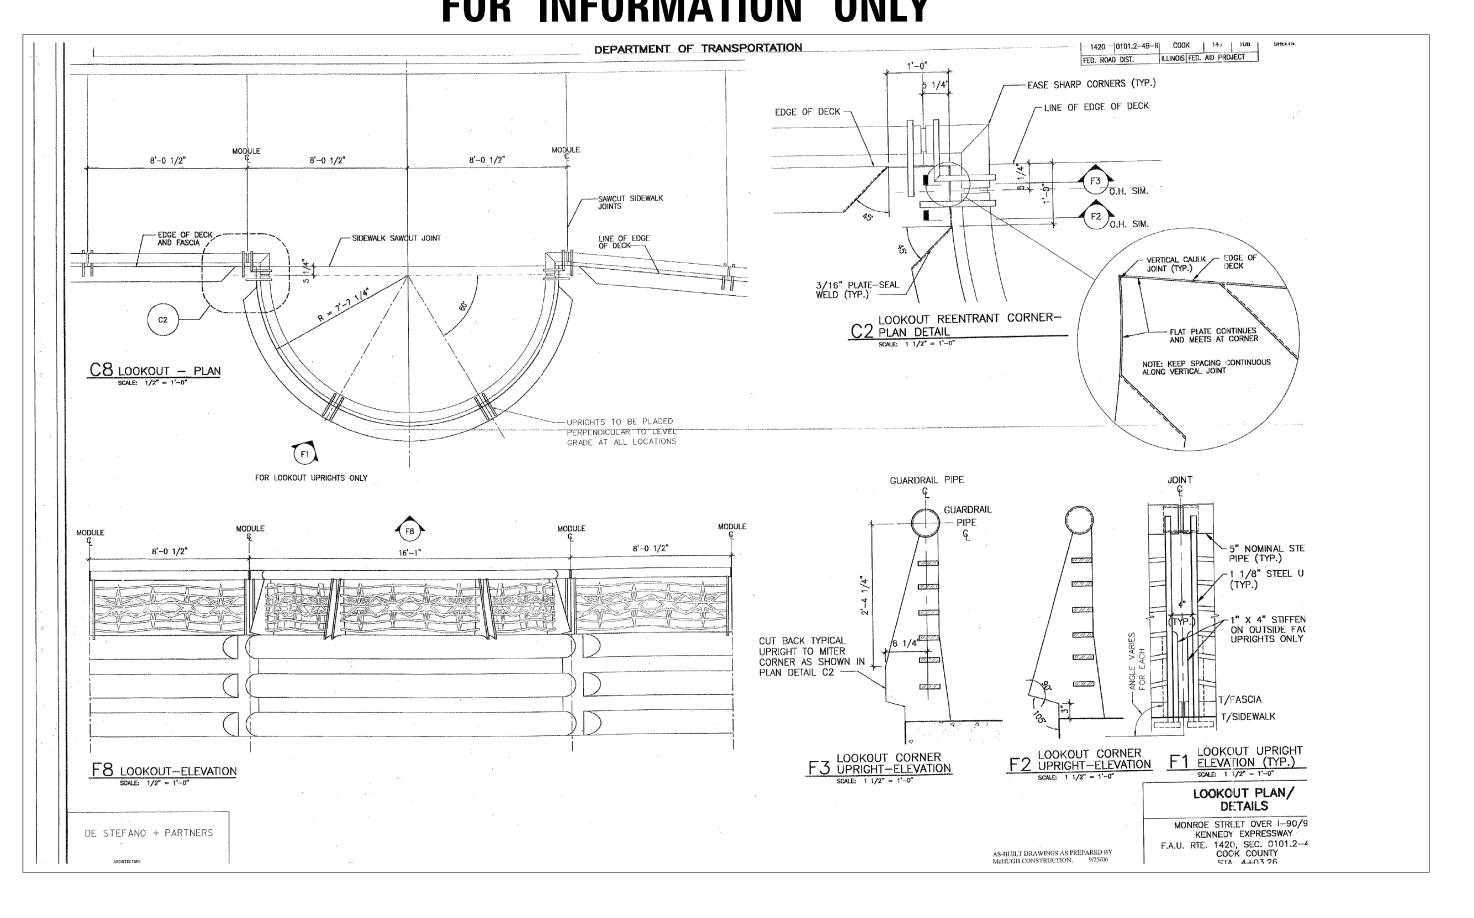


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016		PLOT DATE = 5/15/2017	CHECKED - JIG	REVISED -		SHEET NO. 43 OF 87 SHE

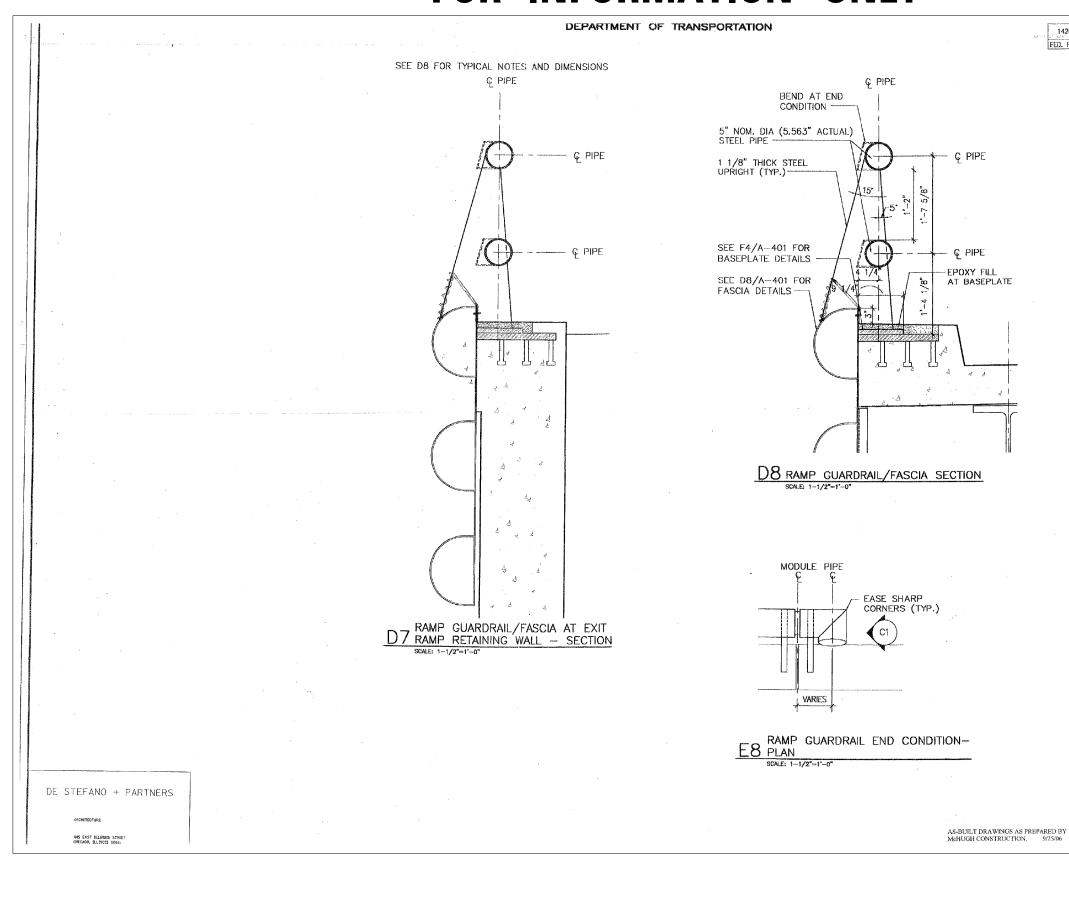



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), 016–2054	90/94	2014-016R&E	3	COOK	378	255
. 010-2034				CONTRACT	NO.	60X95
87 SHEETS		ILLINOIS	FED, AI	D PROJECT		
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USER NAME =	· · · · · · · · · · · · · · · · · · ·	DESIGNED -	REVISED -		EXISTING PLANS	F.A.I. RTE,	SECTION	COUNTY TOTAL SHEET SHEETS NO.
PARSONS	(CHECKED -	REVISED -	STATE OF ILLINOIS	STRUCTURE NO. 016–2054	90/94	2014-016R&B	COOK 378 256
	• N.T.S. [DRAWN - DCP	REVISED -	DEPARTMENT OF TRANSPORTATION				CONTRACT NO. 60X95
PLOT DATE =	5/15/2017	CHECKED - JIG	REVISED -		SHEET NO. 44 OF 87 SHEETS		ILLINOIS FED. AI	D PROJECT






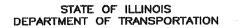


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šΓ		USER NAME = pateld	DESIGNED -	REVISED -		EXISTING PLANS	F.A.I. BTE	SECTION	COUNTY	TOTAL SHEET
5 I	PARSUNS		CHECKED -	REVISED -	STATE OF ILLINOIS		90/94	2014-016R&B	соок	378 257
2	BRINCKERHOFF	PLOT SCALE = N.T.S.	DRAWN - DCP	REVISED -	DEPARTMENT OF TRANSPORTATION	STRUCTURE NO. 016–2054			CONTRACT	NO. 60X95
f L		PLOT DATE = 5/15/2017	CHECKED - JIG	REVISED -		SHEET NO. 45 OF 87 SHEETS		ILLINOIS FED. AI	D PROJECT	

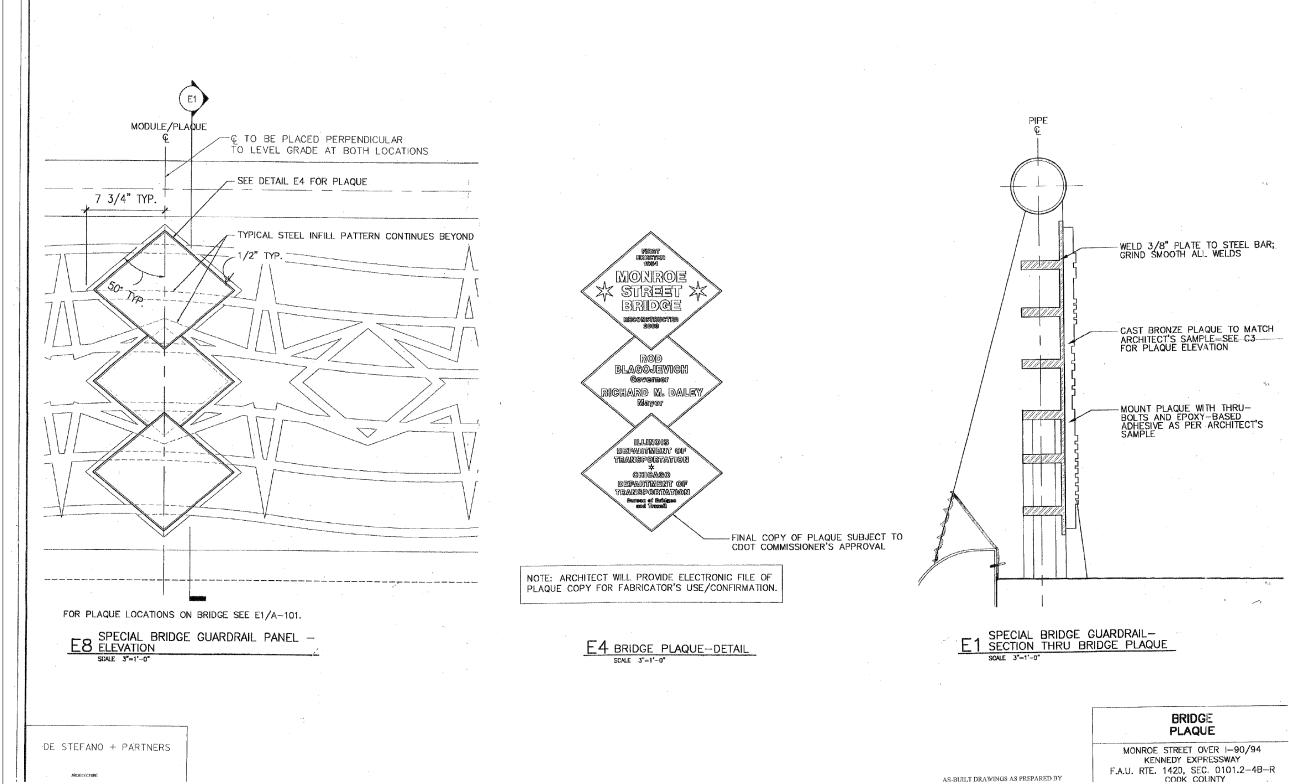ROUTE NO.	SECTION	COUNTY	SHEETS	NC.	SHEET NO. A-4U/
1420	0101.2-48-R	COOK	~147	107	SHEETS
FED. ROAD	DIST.	ILLINOIS FED.	AID PRO	JECT	

	BRIDGE PLAQUE
BY	MONROE STREET OVER I-90/94 KENNEDY EXPRESSWAY F.A.U. RTE. 1420, SEC. 0101.2-4B-R COOK COUNTY

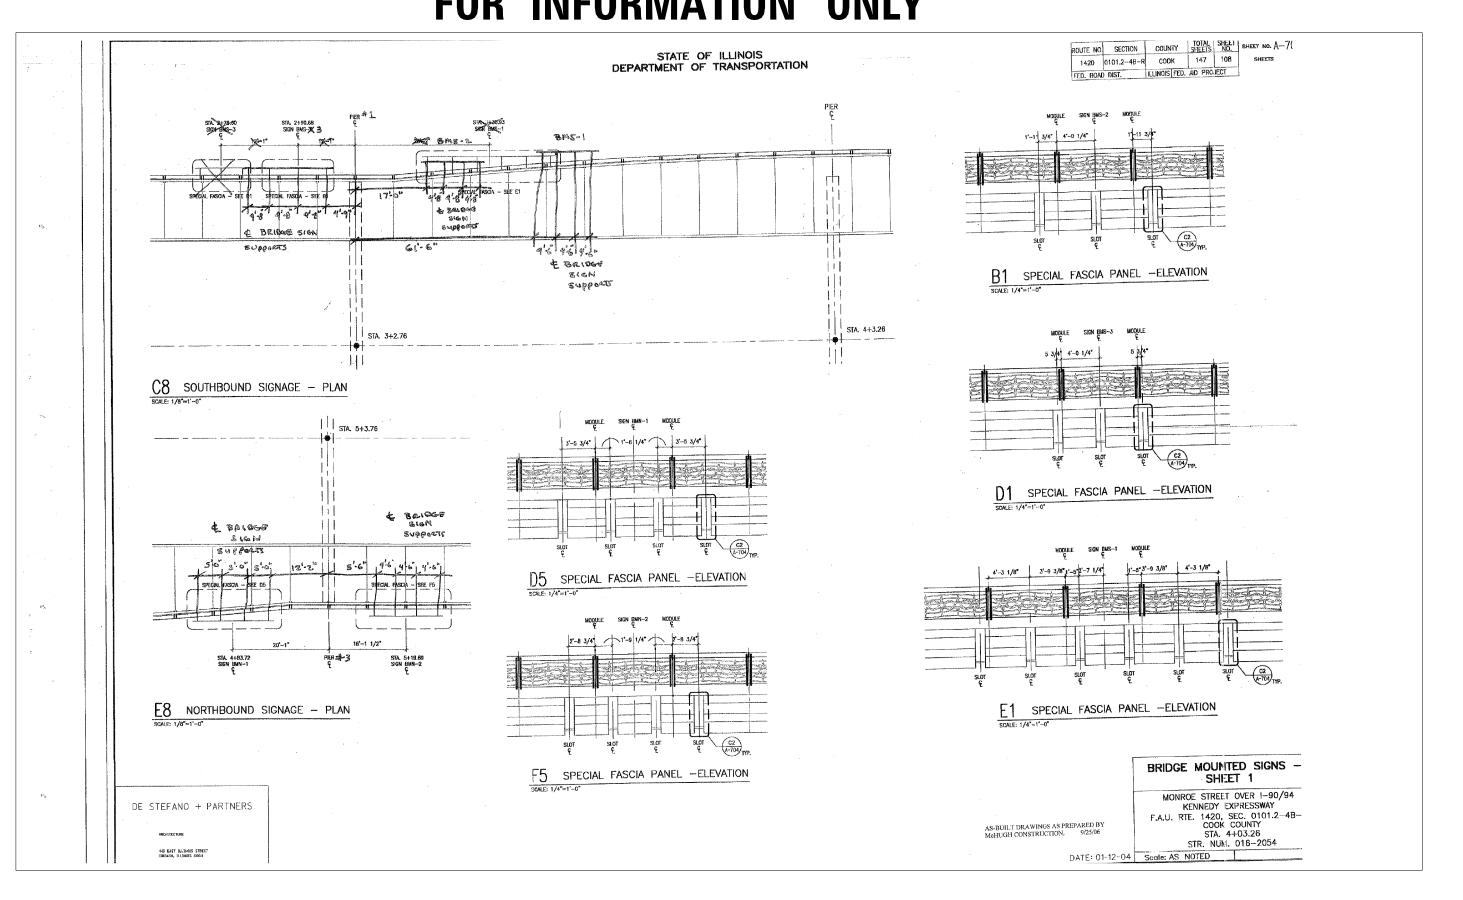


	USER NAME = pateld	DESIGNED -	REVISED -		EXISTING PLANS	F.A.I. SECTION	COUNTY TOTAL SHEET
PARSONS		CHECKED -	REVISED -	STATE OF ILLINOIS	STRUCTURE NO 016-2054	90/94 2014-016R&B	СООК 378 258
BRINCKERHOFF	PLOT SCALE = N.T.S.	DRAWN - DCP	REVISED -	DEPARTMENT OF TRANSPORTATION			CONTRACT NO. 60X95
010	PLOT DATE = 5/15/2017	CHECKED - JIG	REVISED -		SHEET NO. 46 OF 87 SHEETS	ILLINOIS FED.	AID PROJECT

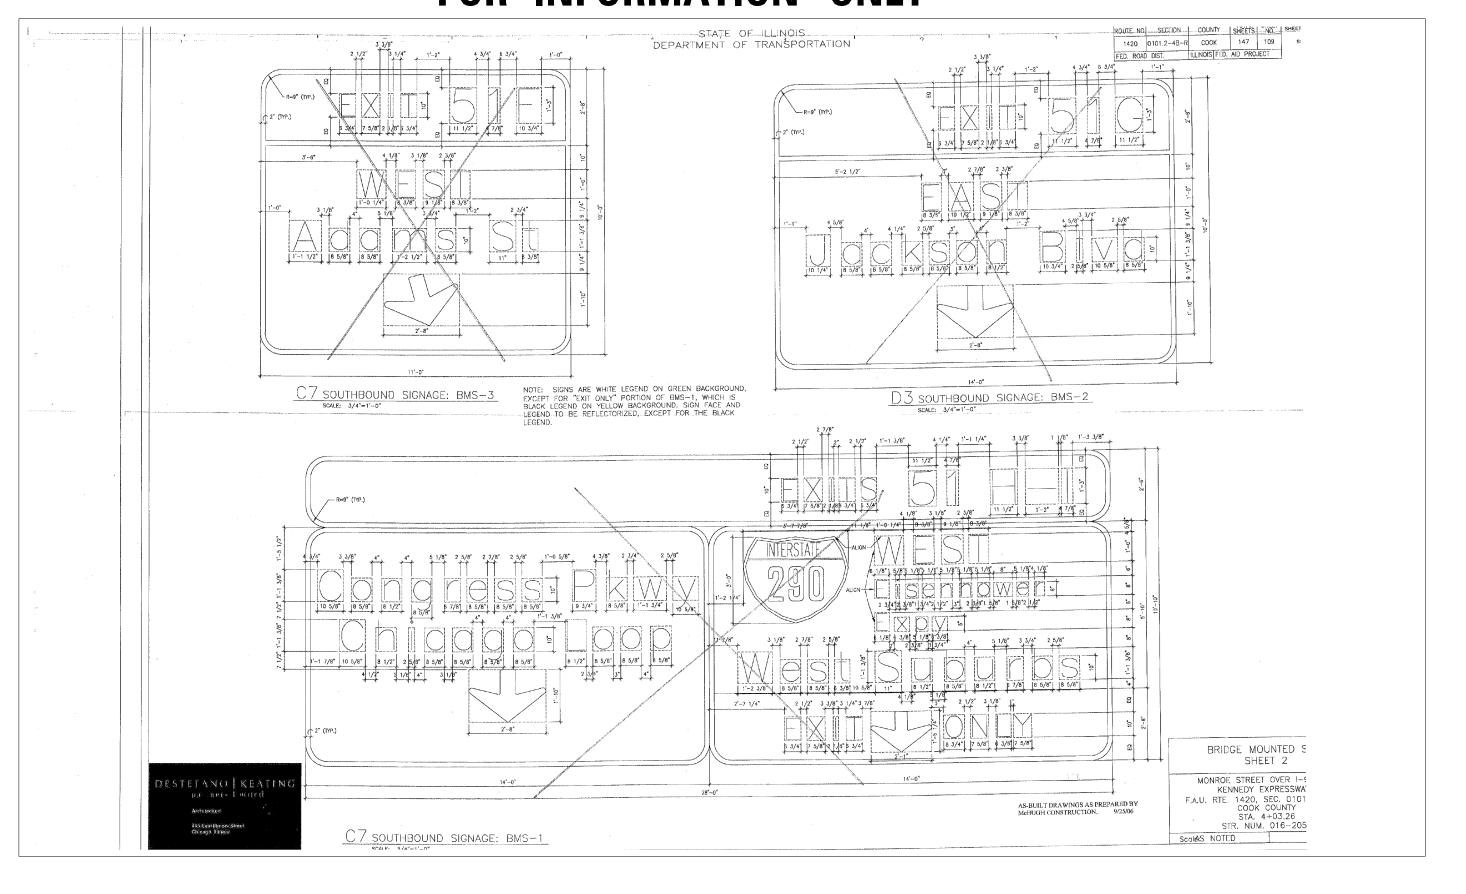

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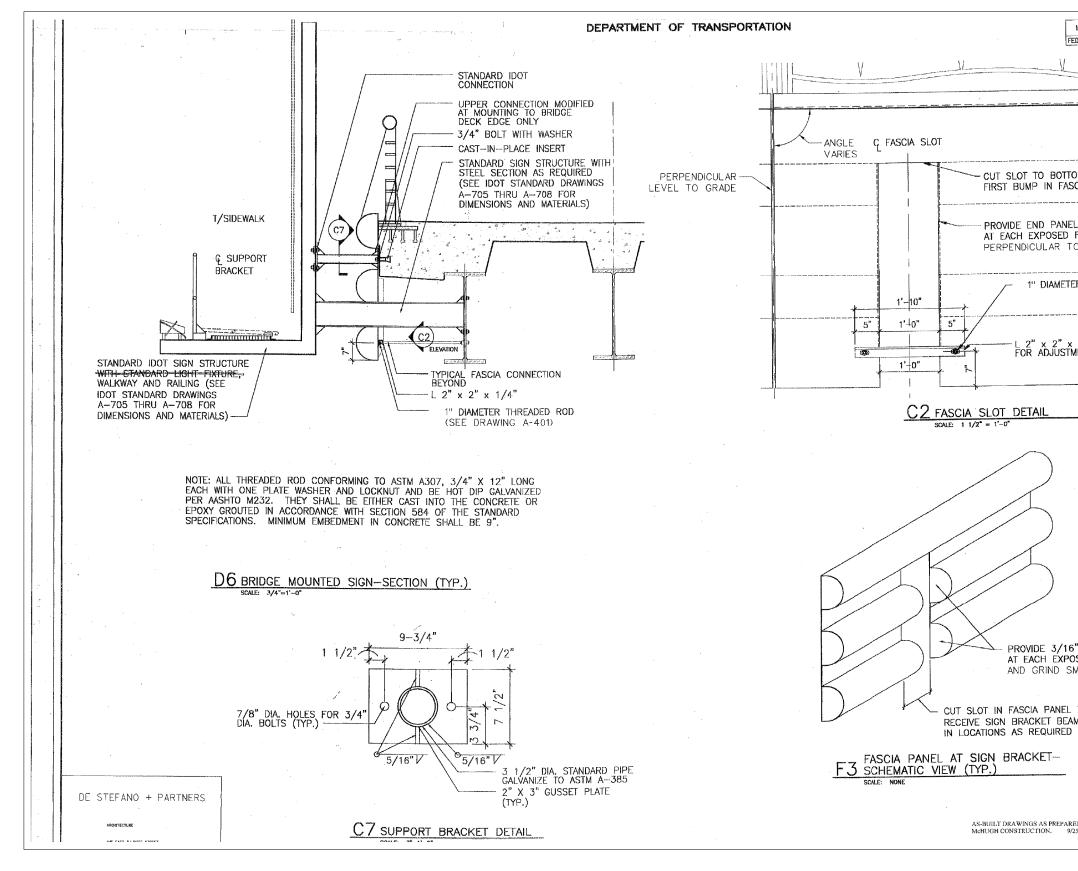
6X0S		USER NAME = pateld	DESIGNED -	REVISED -		EXISTING PLANS	F.A.I. RTE.	SECTION	COUNTY	TOTAL	SHEET
	ARSONS		CHECKED -	REVISED -	STATE OF ILLINOIS	STRUCTURE NO. 016–2054	90/94	2014-016R&B	COOK	378	259
191 BI	RINCK ER HOFF	PLOT SCALE = N.T.S. PLOT DATE = 5/15/2017	DRAWN - DCP CHECKED - JIG	REVISED - REVISED -	DEPARTMENT OF TRANSPORTATION	SHEET NO. 47 OF 87 SHEETS	_			T NO. 6	30X95
ö		1201 BATE - 571572011	CHECKED 810	REVISED -		SHEET NO. 41 OF OF SHEETS		ILLINOIS FED. 7	AID PROJECT		

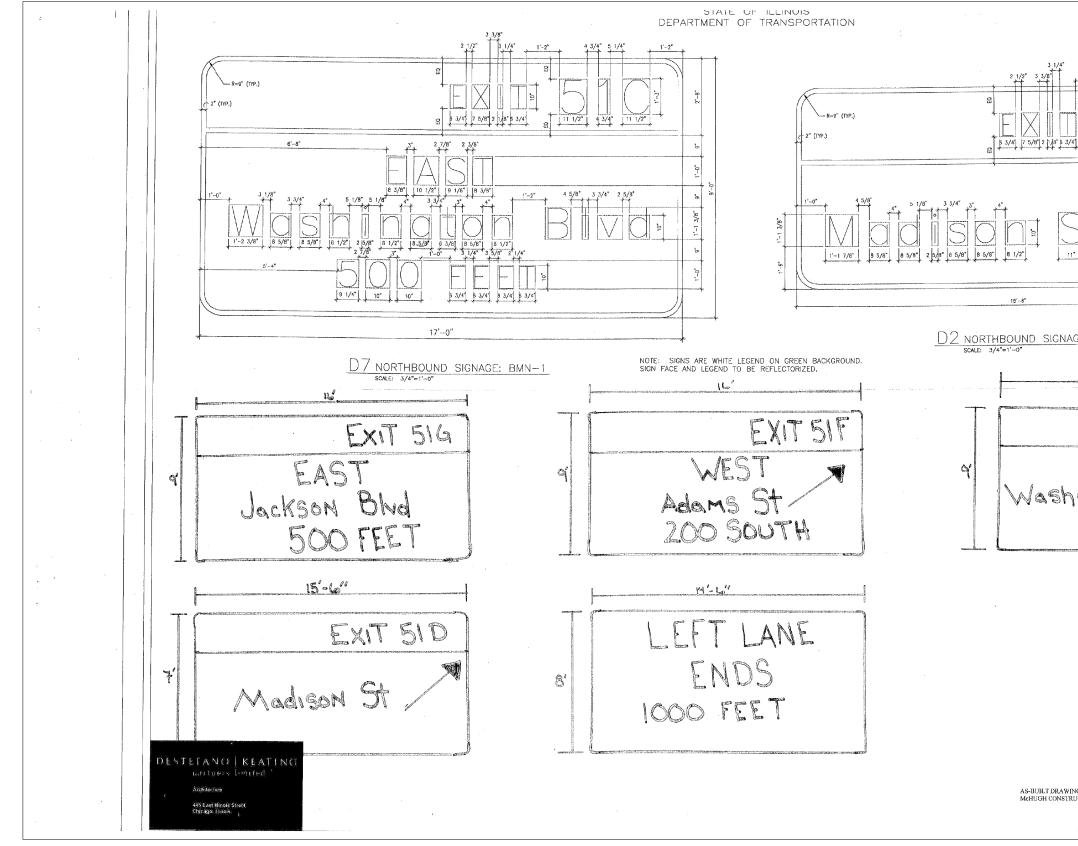

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	USER NAME = pateld	DESIGNED	REVISED -		EXISTING PLANS	F.A.I. RTF.	SECTION	COUNTY TOT	TAL SHEET
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	PLOT SCALE = N.T.S.	DRAWN - DCP	REVISED -	DEPARTMENT OF TRANSPORTATION				CONTRACT NO	0. 60X95
010	PLOT DATE = 5/15/2017	CHECKED - JIG	REVISED -		SHEET NO. 48 OF 87 SHEETS	ILLINOIS FED. AID PROJECT		D PROJECT	

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BRIDGE MOUNTED S SHEET 3 MONROE STREET OVER 1-9 KENNEDY EXPRESSWAY F.A.U. RTE. 1420, SEC. 0101. COOK COUNTY




Ò.	PARSONS BRINCKERHOFF	USER NAME = poteld PLOT SCALE = N.T.S.	DESIGNED - CHECKED - DRAWN - DCP	REVISED - REVISED - REVISED -	STATE OF ILLINOIS DEPARTMENT OF TRANSPORTATION	EXISTING PLANS Structure No. 016–2054
016		PLOT DATE = 5/15/2017	CHECKED - JIG	REVISED -		SHEET NO. 49 OF 87 SHEETS

1420 0101.2-48-R COOK 147 111 FED. ROAD DIST. ILLINOIS FED. AID PROJECT	SHEETS		
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BRIDGE MOUN SHEET MONROE STREET O KENNEDY EXP F.A.U. RTE. 1420, SEC COOK CO STA. 44-0	VER 1-90, RESSWAY C. 0101.2- DUNTY	/94	
2LANS . 016–2054	F.A.I. RTE. 90/94	SECTION 2014-016R&B	TAL SHEET EETS NO. 78 261
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ΧΓ		USER NAME = pateld	DESIGNED -	REVISED -		EXISTING PLANS	F.A.I. RTE	SECTION	COUNTY	TOTAL	SHEET
ċ ∎	PARSONS		CHECKED -	REVISED -	STATE OF ILLINOIS		90/94	2014-016R&B	соок	378	262
170	BRINCKERHOFF	PLOT SCALE = N.T.S.	DRAWN - DCP	REVISED -	DEPARTMENT OF TRANSPORTATION	STRUCTURE NO. 016–2054			CONTRACT	T NO. 6	0X95
016		PLOT DATE = 5/15/2017	CHECKED - JIG	REVISED -		SHEET NO. 50 OF 87 SHEETS	ILLINOIS FED. AID PROJECT				

ROUTE NO.	SECTION	COUNTY	TOTAL SHEETS	SHEET NO.	SHEET NO
1420	0101.2-4B-R	COOK	147	112	SHEET
FED. ROAD	DIST.	ILLINOIS FED.	AID PRO	JECT	

DESIGN: AASHTO Standard Specifications for Structural Supports for Highway Signs, Luminaires and Traffic Signals. ("AASHTO Specifications") ②

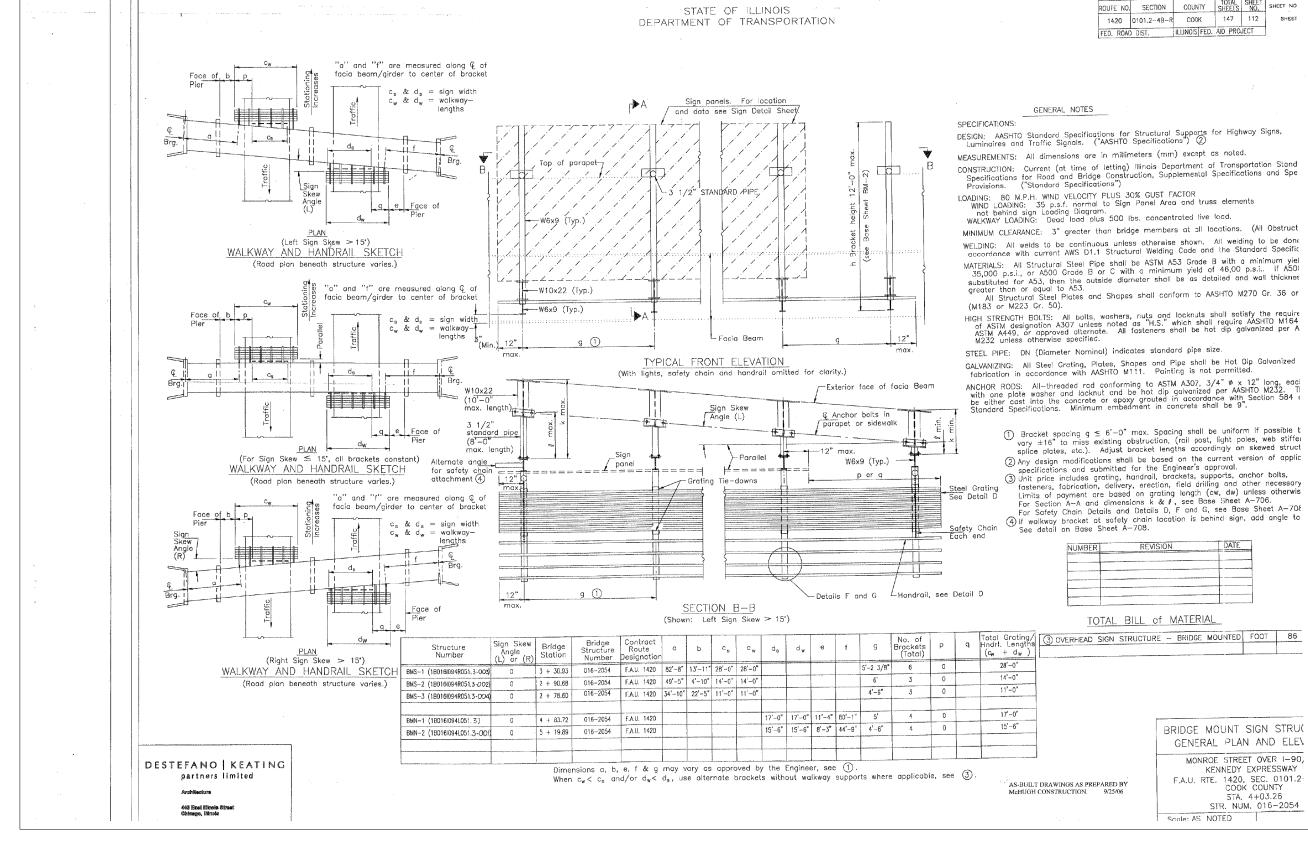CONSTRUCTION: Current (at time of letting) Illinois Department of Transportation Stand Specifications for Road and Bridge Construction, Supplemental Specifications and Spe Provisions. ("Standard Specifications")

MINIMUM CLEARANCE: 3" greater than bridge members at all locations. (All Obstruct WELDING: All welds to be continuous unless otherwise shown. All welding to be done accordance with current AWS D1.1 Structural Welding Code and the Standard Specific

HIGH STRENGTH BOLTS: All bolts, washers, nuts and locknuts shall satisfy the require of ASTM designation A307 unless noted as "H.S." which shall require AASHTO M164 ASTM A449, or approved alternate. All fasteners shall be hot dip galvanized per A M232 unless otherwise specified.

GALVANIZING: All Steel Grating, Plates, Shapes and Pipe shall be Hot Dip Galvanized fabrication in accordance with AASHTO M111. Painting is not permitted.

ANCHOR RODS: All-threaded rad conforming to ASTM A307, 3/4" & x 12" long, each with one plate washer and locknut and be hat dip galvanized per AASHTO M232. The be either cast into the concrete or epoxy grouted in accordance with Section 584 (Standard Specifications, Minimum embedment in concrete shall be 9".

 \bigoplus Bracket spacing $g \leq 6'-0"$ max. Spacing shall be uniform if possible t vary $\pm 16"$ to miss existing obstruction, (rail post, light poles, web stiffer splice plates, etc.). Adjust bracket lengths accordingly on skewed struct


splice plates, etc.). Adjust bracket lengths accordingly on skewed struct
(2) Any design modifications shall be based on the current version of applic specifications and submitted for the Engineer's approval.
(3) Unit price includes grating, handrail, brackets, supports, anchor bolts, fasteners, fabrication, delivery, erection, field drilling and other necessary Limits of payment are based on grating length (cw, dw) unless otherwis For Section A-A and dimensions k & l, see Base Sheet A-706.
For Safety Chain Details and Details D, F and G, see Base Sheet A-706.
(4) If wolkway bracket at safety chain location is behind sign, add angle to See detail on Base Sheet A-708.

NUMBER	REVISION	DATE
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TOTAL BILL of MATERIAL


VERHEAD SIGN STRUCTURE - BRIDGE MOUNTED FOOT 8	3
ERHEAD SIGN STRUCTURE - BRIDGE MOUTHED	

	BRIDGE MOUNT SIGN STRU(GENERAL PLAN AND ELE)
IGS AS PREPARED BY UCTION 9/25/06	MONROE STREET OVER I-90, KENNEDY EXPRESSWAY F.A.U. RTE. 1420, SEC. 0101.2- COOK COUNTY STA. 4+03.26 STR. NUM. 016-2054 Scale: AS NOTED

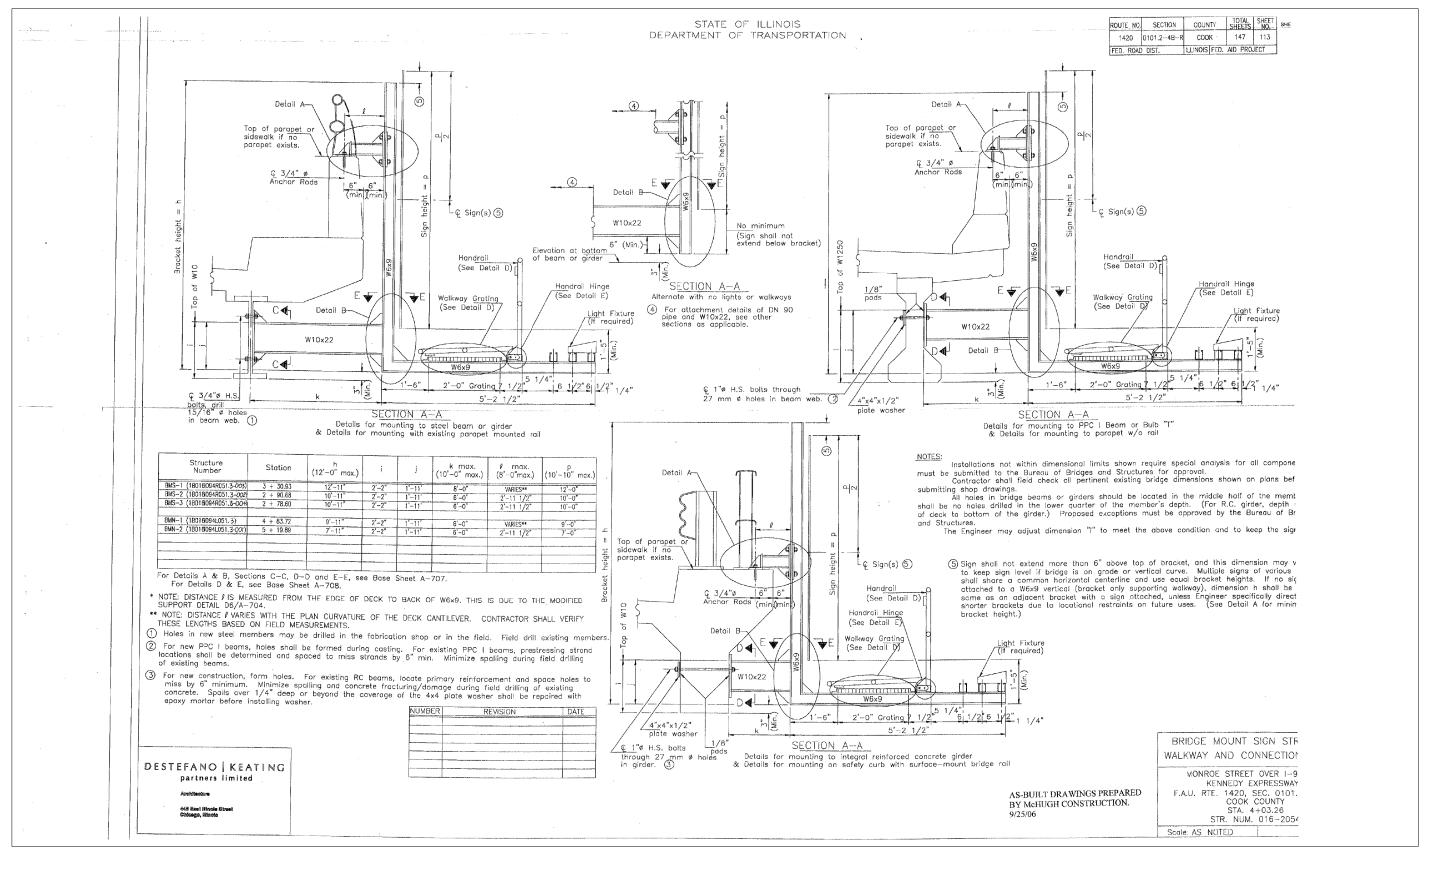


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	USER NAME = pateld	DESIGNED -	REVISED -		EXISTING PLANS		SECTION	COUNTY	TOTAL SHEETS	SHEET NO.
PARSONS		CHECKED - REVISED - STAT		STRUCTURE NO. 016–2054	90/94	2014-016R&B	соок	378	263	
	1201 00122 11110	DRAWN - DCP	REVISED -	DEPARTMENT OF TRANSPORTATION				CONTRACT	NO. 6	OX95
010	PLOT DATE = 5/15/2017	CHECKED - JIG	REVISED -		SHEET NO. 51 OF 87 SHEETS	ILLINOIS FED. AID PROJE		ID PROJECT		

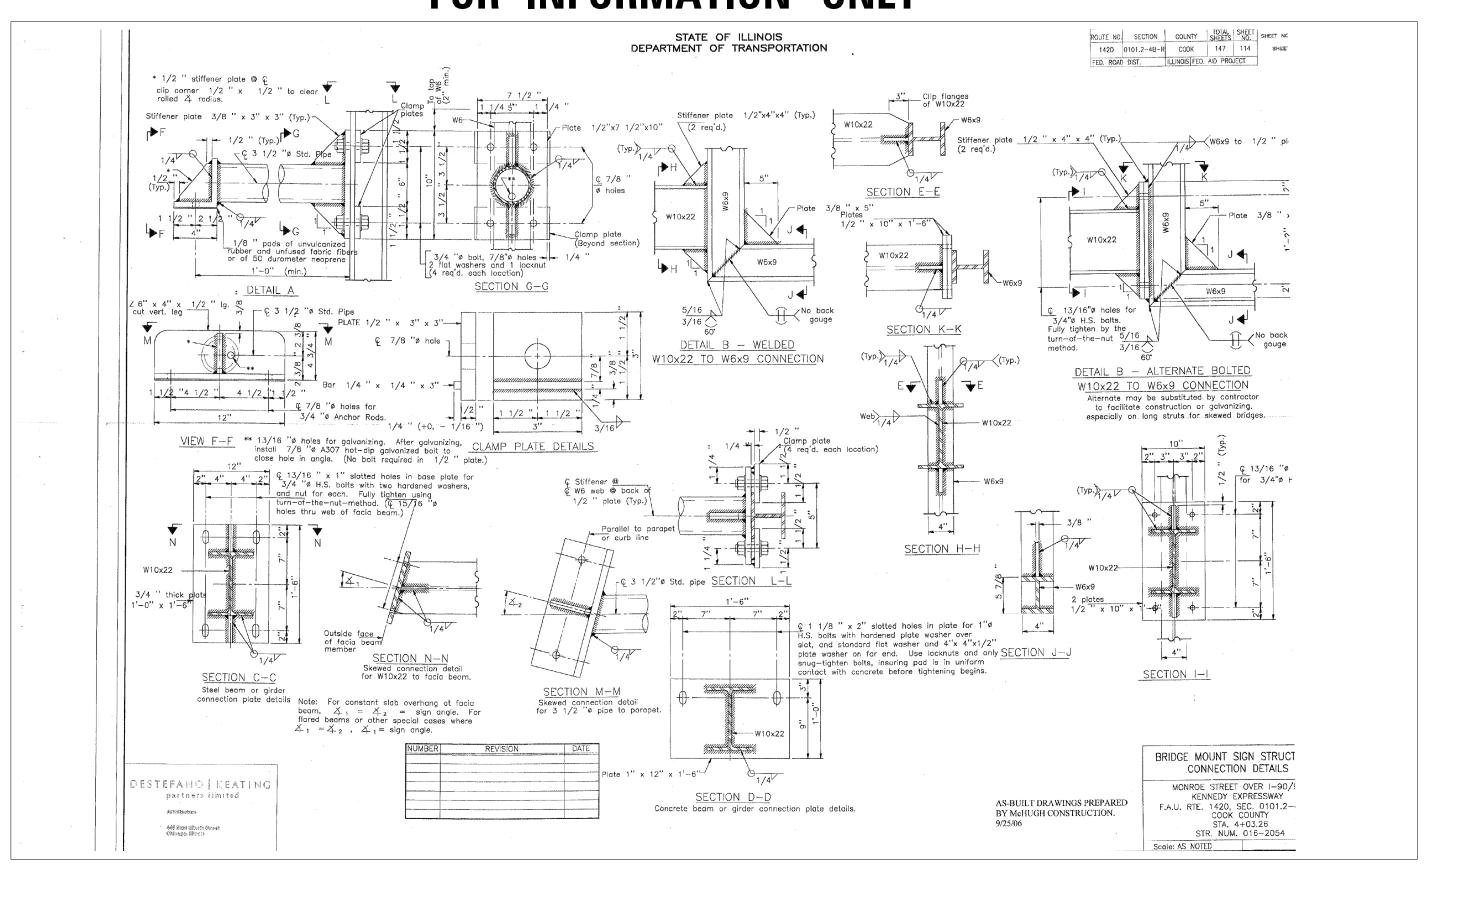


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	USER NAME = pateld	DESIGNED -	REVISED -		EXISTING PLANS	F.A.I. RTE.	SECTION	COUNTY	TOTAL	SHEET NO.
PARSONS		CHECKED -	REVISED -	STATE OF ILLINOIS	STRUCTURE NO. 016–2054	90/94	2014-016R&B	СООК	378	264
	PLOT SCALE = N.T.S. PLOT DATE = 5/15/2017	DRAWN - DCP CHECKED - JIG	REVISED -	DEPARTMENT OF TRANSPORTATION STRUCTURE NO. 010-2034				CONTRACT	NO. 6	JX95
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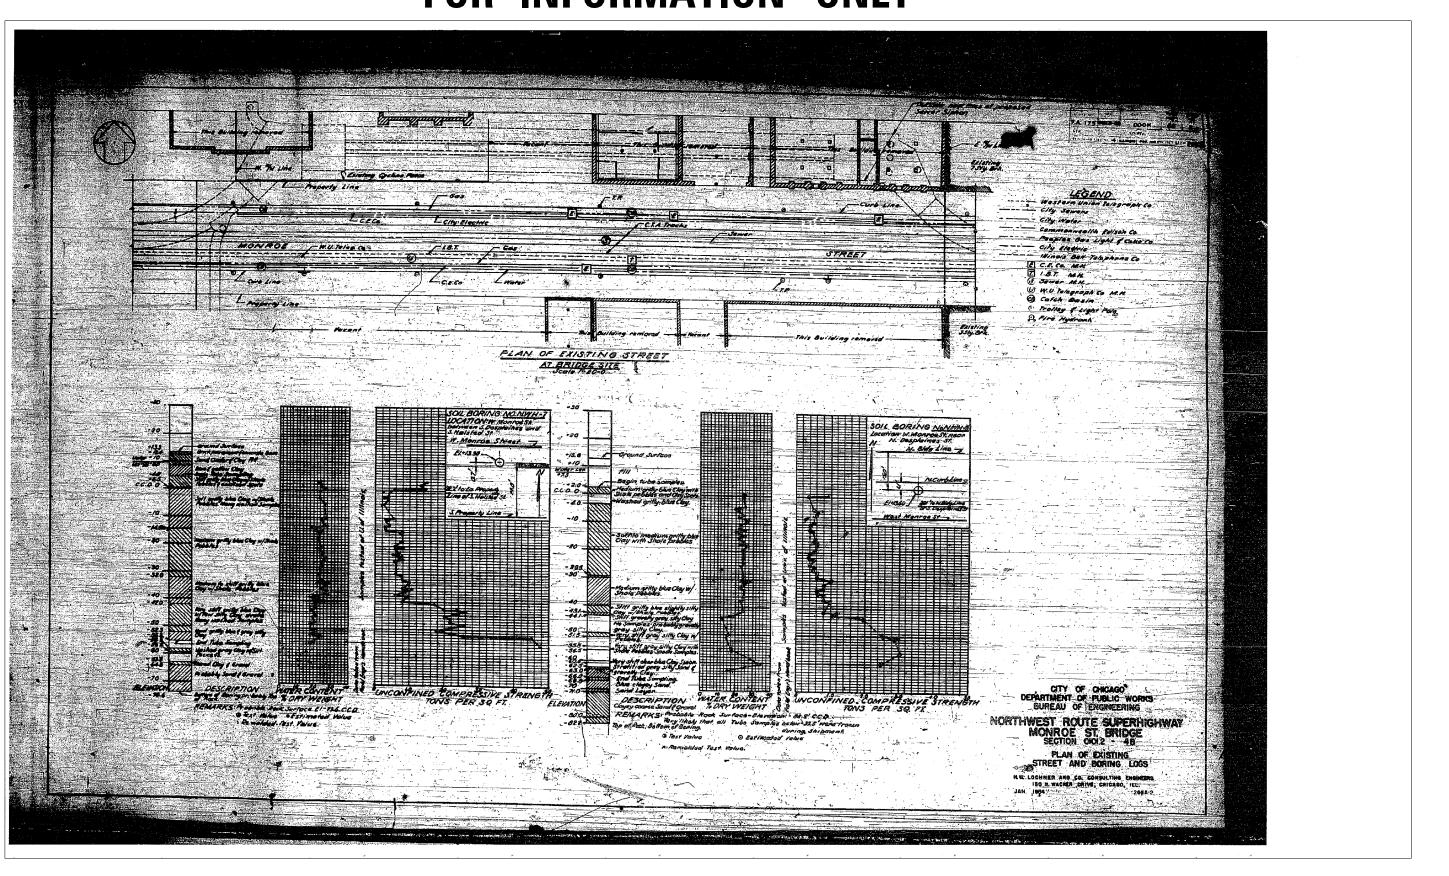
		USER NAME = pateld	DESIGNED -	REVISED -		EXISTING PLANS	F.A.I. SECTION	COUNTY TOTAL SHEET			
	PARSONS		CHECKED -	REVISED -	STATE OF ILLINOIS	STRUCTURE NO. 016–2054	90/94 2014-016R&B	СООК 378 265			
	BRINCK ER HOFF	PLOT SCALE = N.T.S.	DRAWN - DCP	REVISED -	DEPARTMENT OF TRANSPORTATION		CONTRACT NO. 60X				
ŝ L		PLOT DATE = 5/15/2017 CHECKED - JIG REVISED	REVISED -		SHEET NO. 53 OF 87 SHEETS	ILLINOIS FED. AID PROJECT					




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	PARSONS		CHECKED -	REVISED -	STATE OF ILLINOIS		90/94	2014-016R&B	СООК	378	266
6170	BRINCK ER HOFF	PLOT SCALE = N.T.S.	DRAWN - DCP	REVISED -	DEPARTMENT OF TRANSPORTATION	STRUCTURE NO. 016-2054			CONTRACT	NO. 6	JX95
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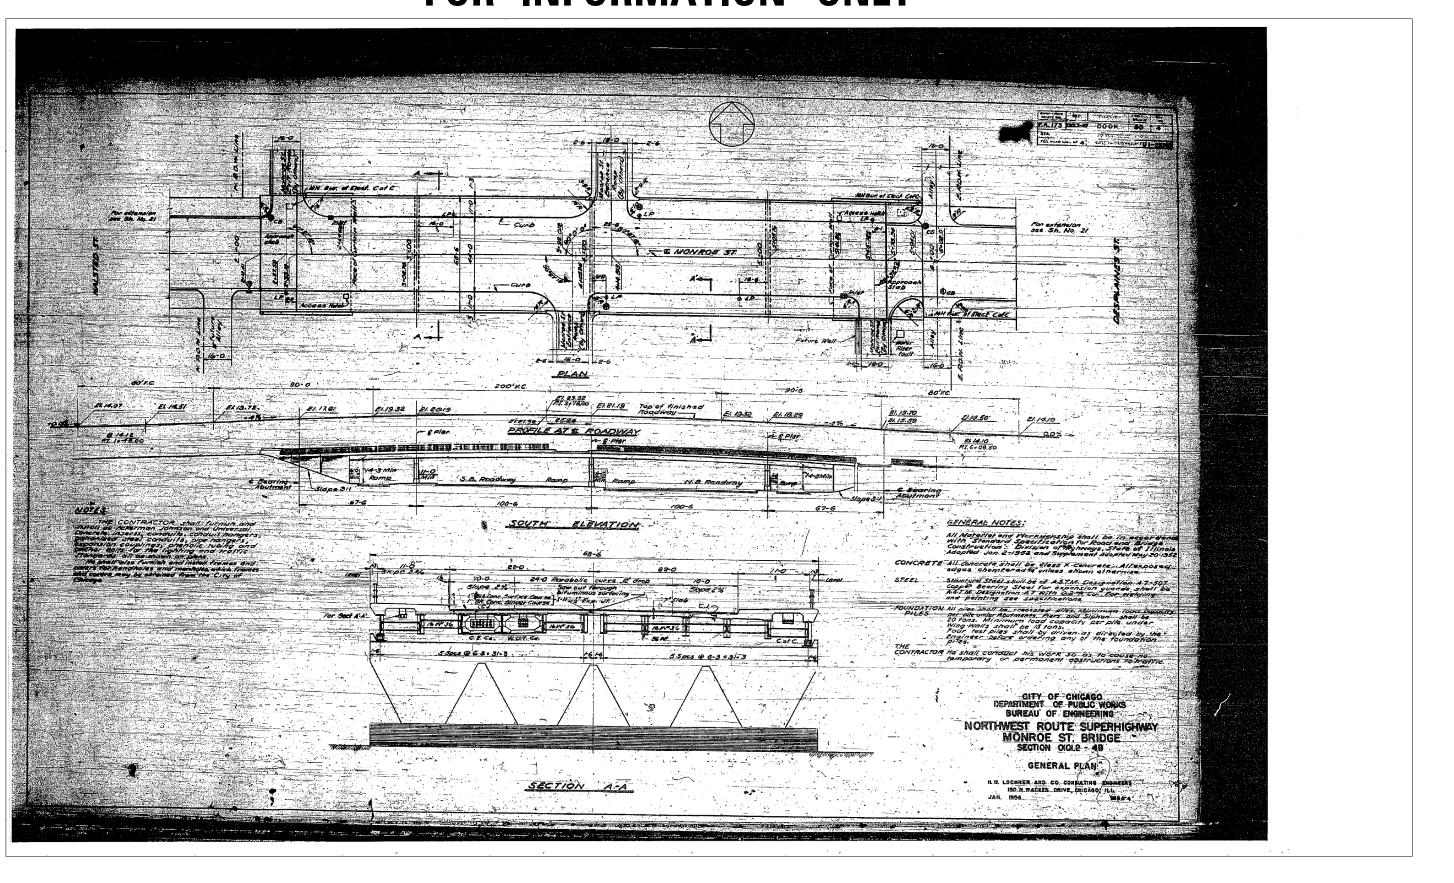
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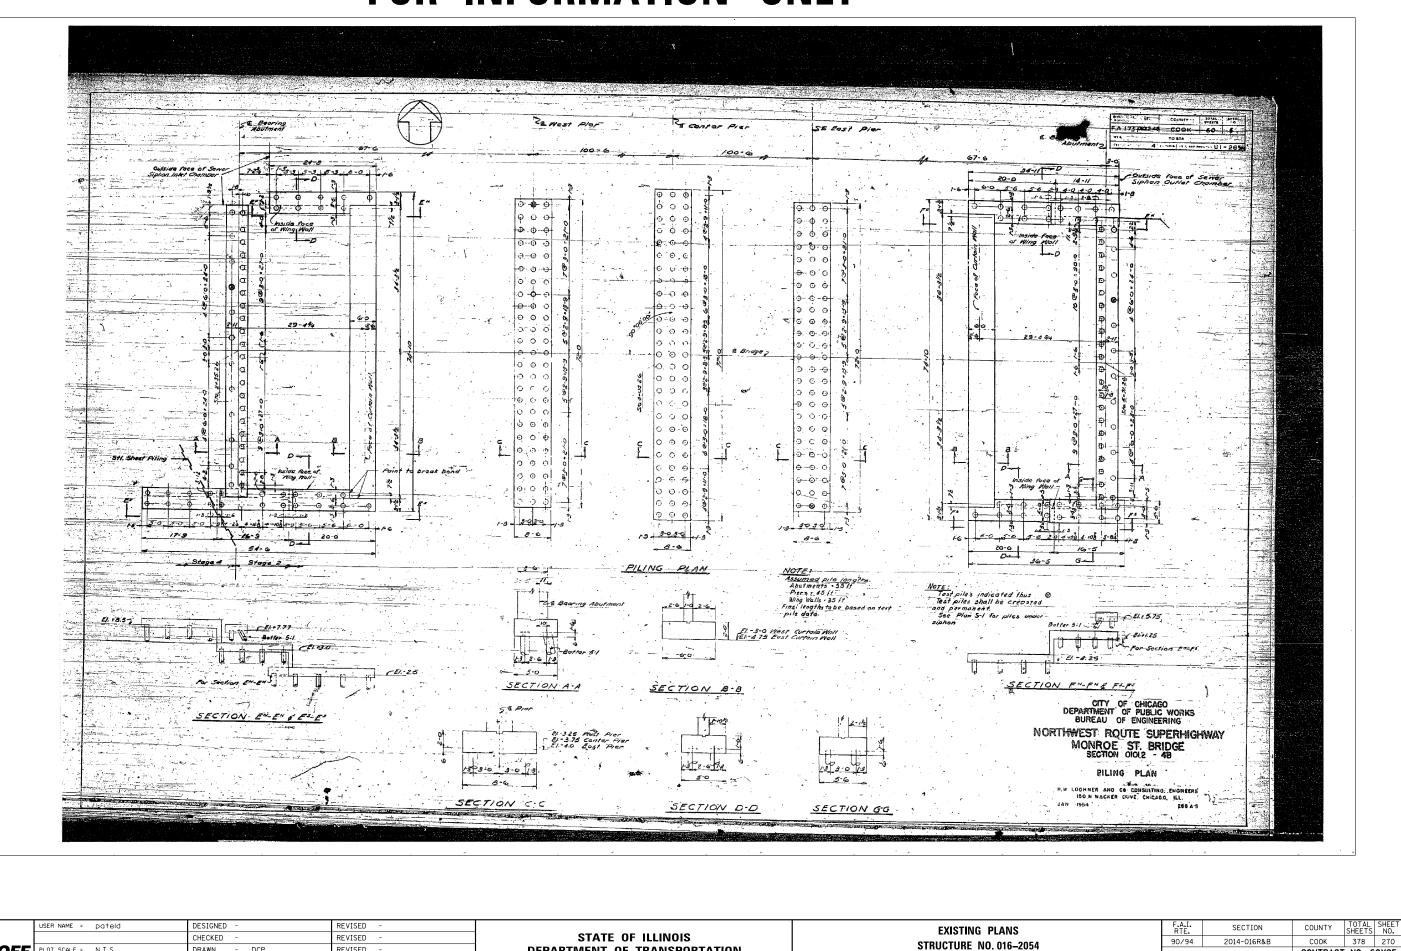
۲. ۲.		USER NAME = pateld	DESIGNED -	REVISED -		EXISTING PLANS	F.A.I.	SECTION	COUNTY	TOTAL	SHEET
	PARSONS		CHECKED -	REVISED -	STATE OF ILLINOIS		90/94	2014-016R&B	СООК	378	267
19	BRINCK ER HOFF	PLOT SCALE = N.T.S. PLOT DATE = 5/15/2017	DRAWN - DCP CHECKED - JIG	REVISED - REVISED -	DEPARTMENT OF TRANSPORTATION	SHEET NO. 55 OF 87 SHEETS			CONTRAC	T NO. 6	,0X95
5 L		101 DHTL - 371372011	CHECKED - JIG	NEVISED		SHEET NO. 33 UP OF SHEETS	ILLINOIS FED, AID PROJECT		ID PROJECT		

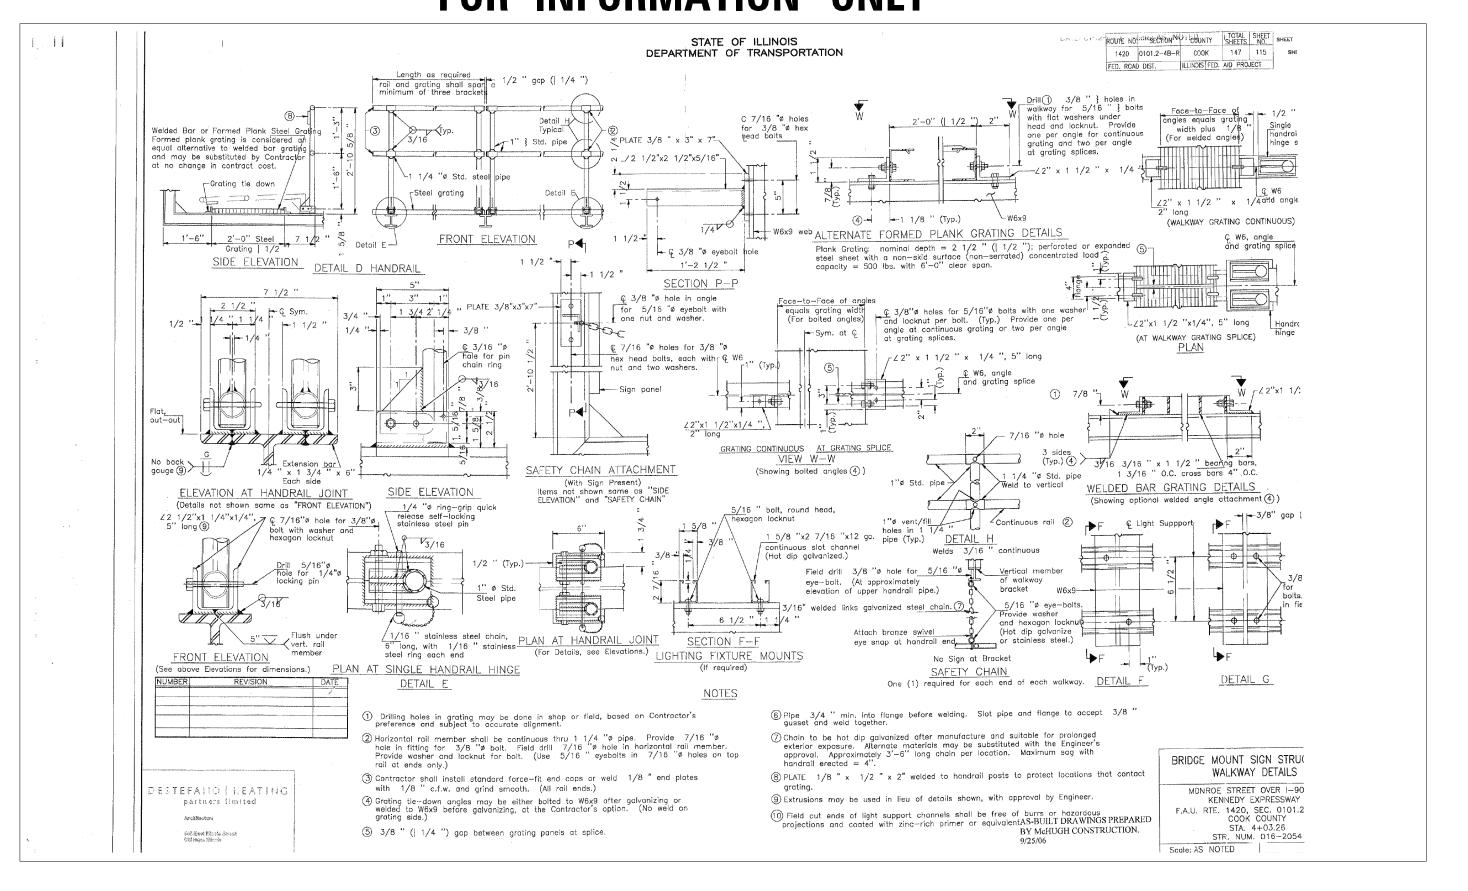

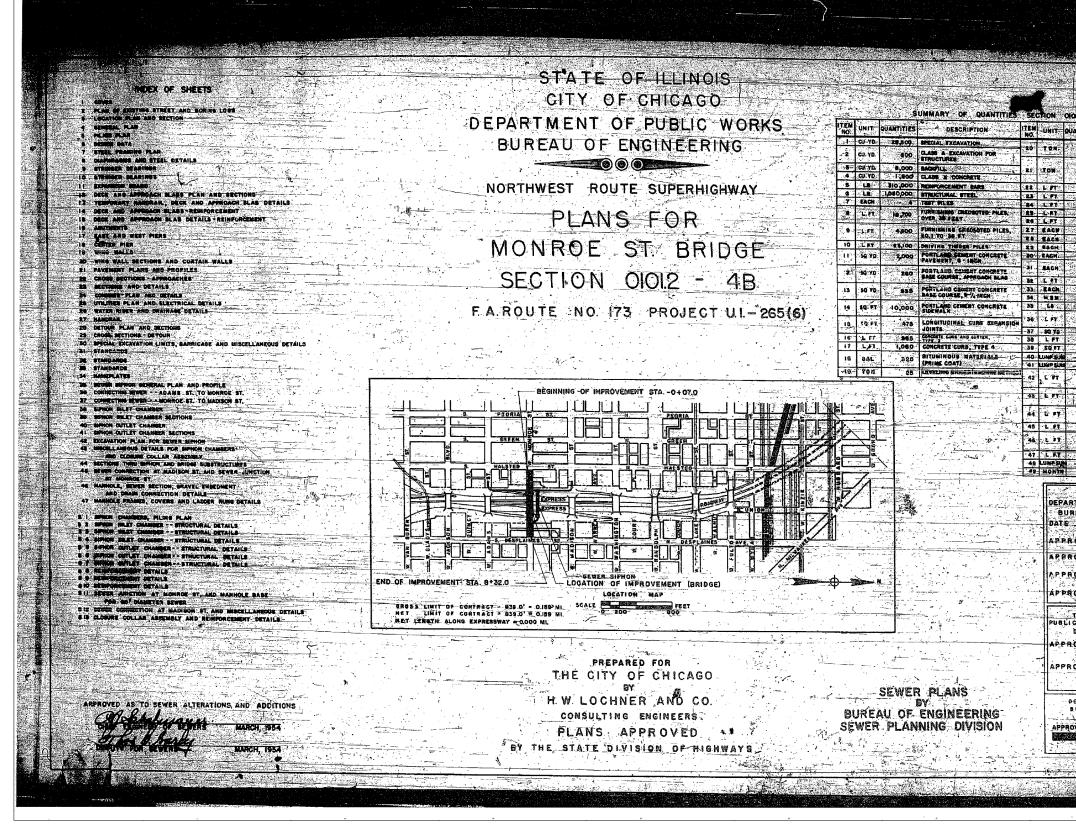	USER NAME = pateld	DESIGNED -	REVISED -			F.A.I.	SECTION	COUNTY	TOTAL	HEET
PARSONS		CHECKED -	REVISED -	STATE OF ILLINOIS	EXISTING PLANS	90/94	2014-0168&8	СООК	SHEETS 378	268
BRINCKER	OFF PLOT SCALE = N.T.S.	DRAWN - DCP	REVISED -	DEPARTMENT OF TRANSPORTATION	STRUCTURE NO. 016–2054		2014 010100	CONTRACT	[NO. 60	x95
	PLOT DATE = 5/15/2017	CHECKED - JIG	REVISED -		SHEET NO. 56 OF 87 SHEETS	ILLINOIS FED. AID PROJECT		ID PROJECT		




	USER NAME = pateld	DESIGNED -	REVISED -		EXISTING PLANS	F.A.I. RTE	SECTION	COUNTY	TOTAL SHEET
PARSONS		CHECKED -	REVISED -	STATE OF ILLINOIS	STRUCTURE NO. 016–2054	90/94	2014-016R&B	соок	378 269
BRINCKERHOFF	PLOT SCALE = N.T.S.	DRAWN - DCP	REVISED -	DEPARTMENT OF TRANSPORTATION				CONTRACT	NO. 60X95
;	PLOT DATE = 5/15/2017	CHECKED - JIG	REVISED -		SHEET NO. 57 OF 87 SHEETS		ILLINOIS FED. A	ID PROJECT	/

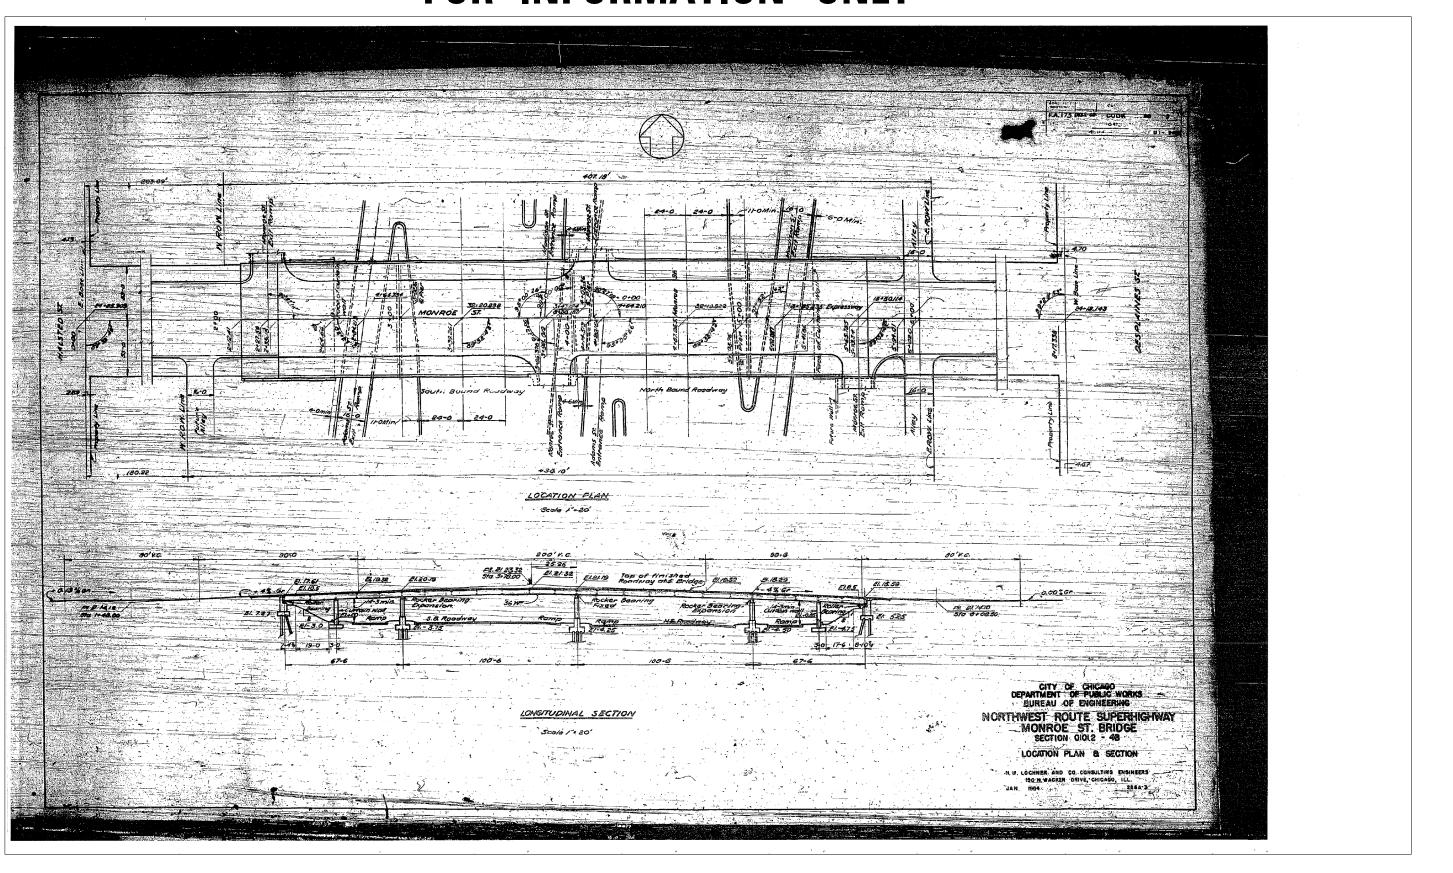

PARSONS BRINCKERHOFF	USER NAME = pateld PLOT SCALE = N.T.S.	DESIGNED - CHECKED - DRAWN - DCP	REVISED - REVISED - REVISED -	STATE OF ILLINOIS DEPARTMENT OF TRANSPORTATION	EXISTING PLANS STRUCTURE NO. 016-
	PLOT DATE = 5/15/2017	CHECKED - JIG	REVISED -		SHEET NO. 58 OF 87 SHE


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10.010-2054			CONTRACT	NO.	60X95
OF 87 SHEETS	ILLINOIS I	FED, AID	PROJECT		

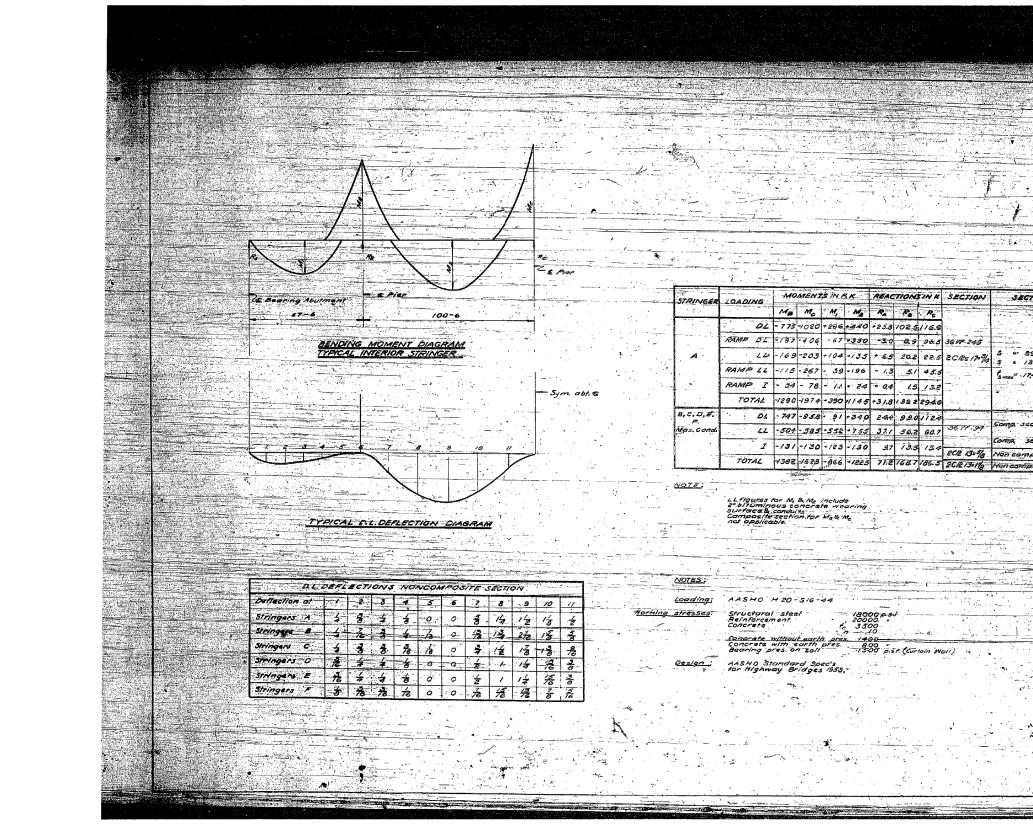

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	PLOT DATE = 5/15/2017	CHECKED - JIG	REVISED -		SHEET NO. 59 OF 87 SHE

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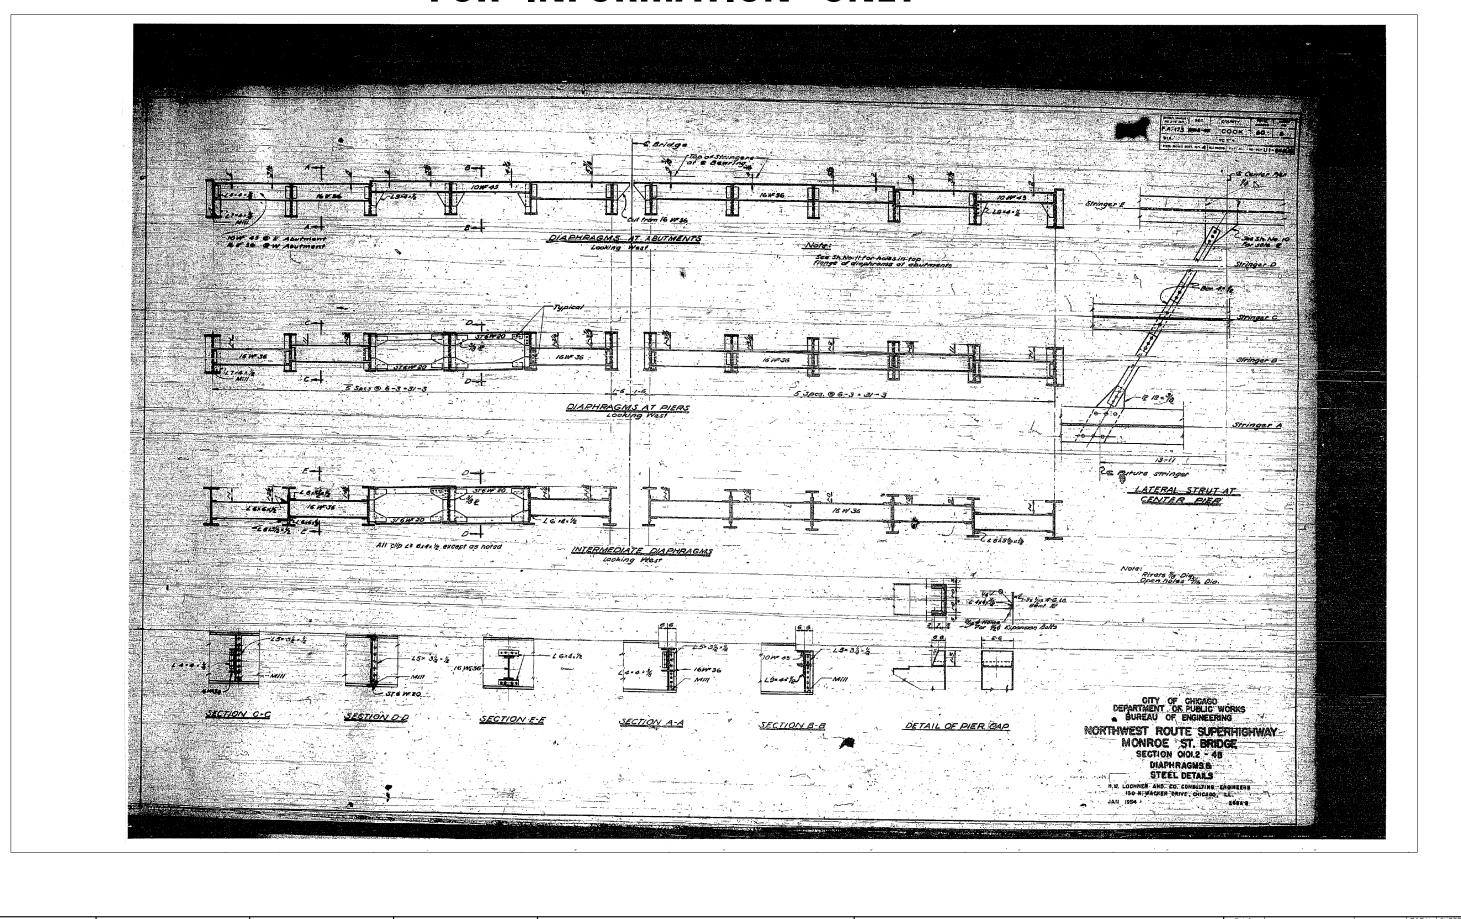
016–2054	30734	2014 010104	,	COOK	510	211
010-2034				CONTRACT	NO.	60X95
37 SHEETS		ILLINOIS	FED, AI	D PROJECT		

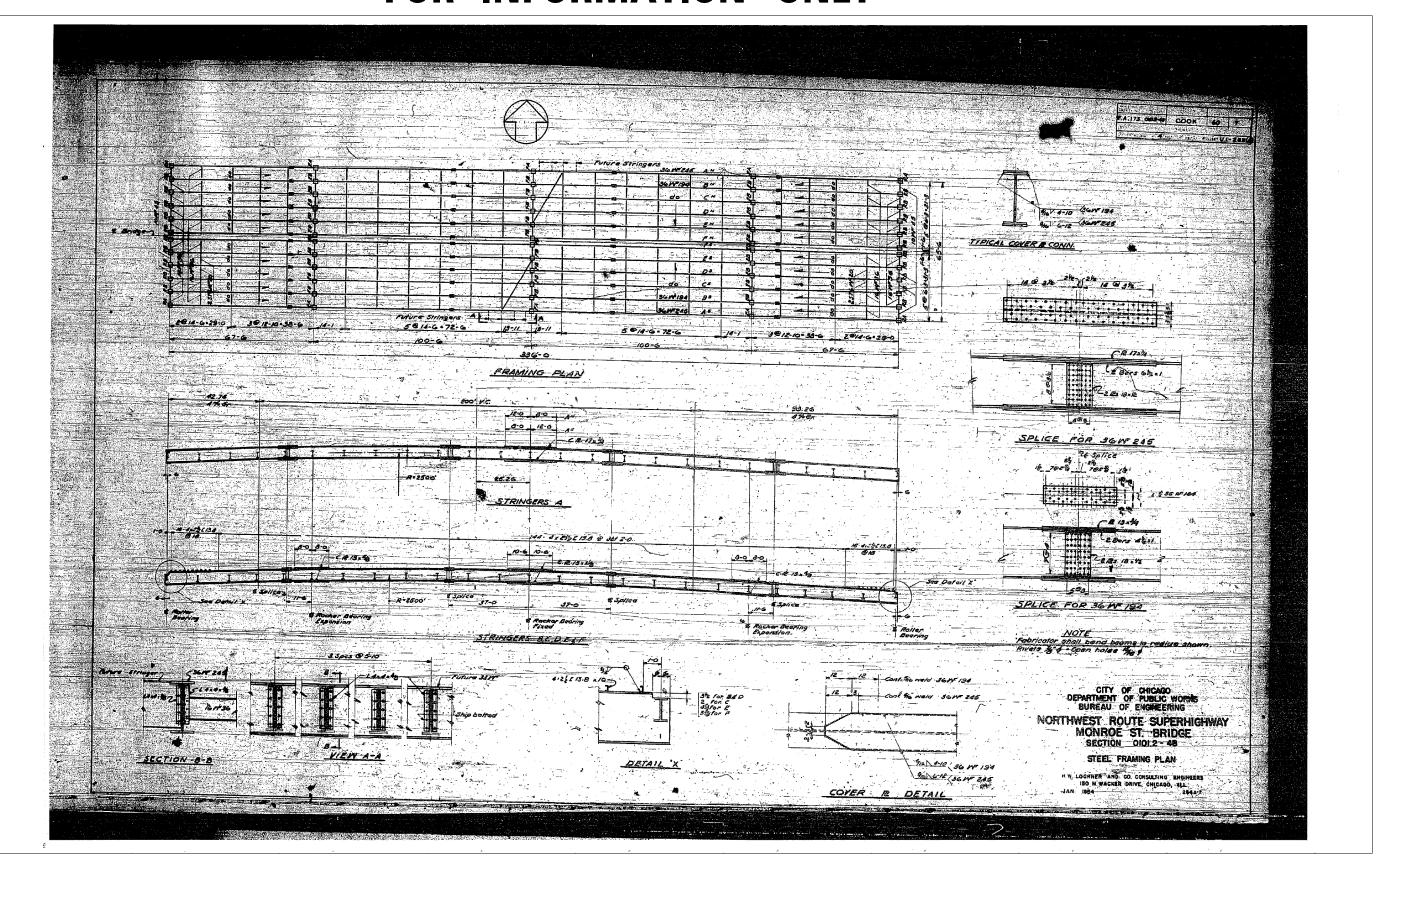

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ž,		USER NAME = pateld	DESIGNED -	REVISED -		
9-0	PARSONS		CHECKED -	REVISED -	STATE OF ILLINOIS	EXISTING PLANS
170	BRINCKERHOFF	PLOT SCALE = N.T.S.	DRAWN - DCP	REVISED -	DEPARTMENT OF TRANSPORTATION	STRUCTURE NO. 016–
016		PLOT DATE = 5/15/2017	CHECKED - JIG	REVISED -		SHEET NO. 60 OF 87 SHE


LANS	F.A.I. RTE.	SECTION	COUNTY	TOTAL SHEETS	SHEET NO.
016–2054	90/94	2014-016R&B	СООК	378	272
010-2034			CONTRACT	NO. 6	0X95
B7 SHEETS		ILLINOIS FED. A	D PROJECT		



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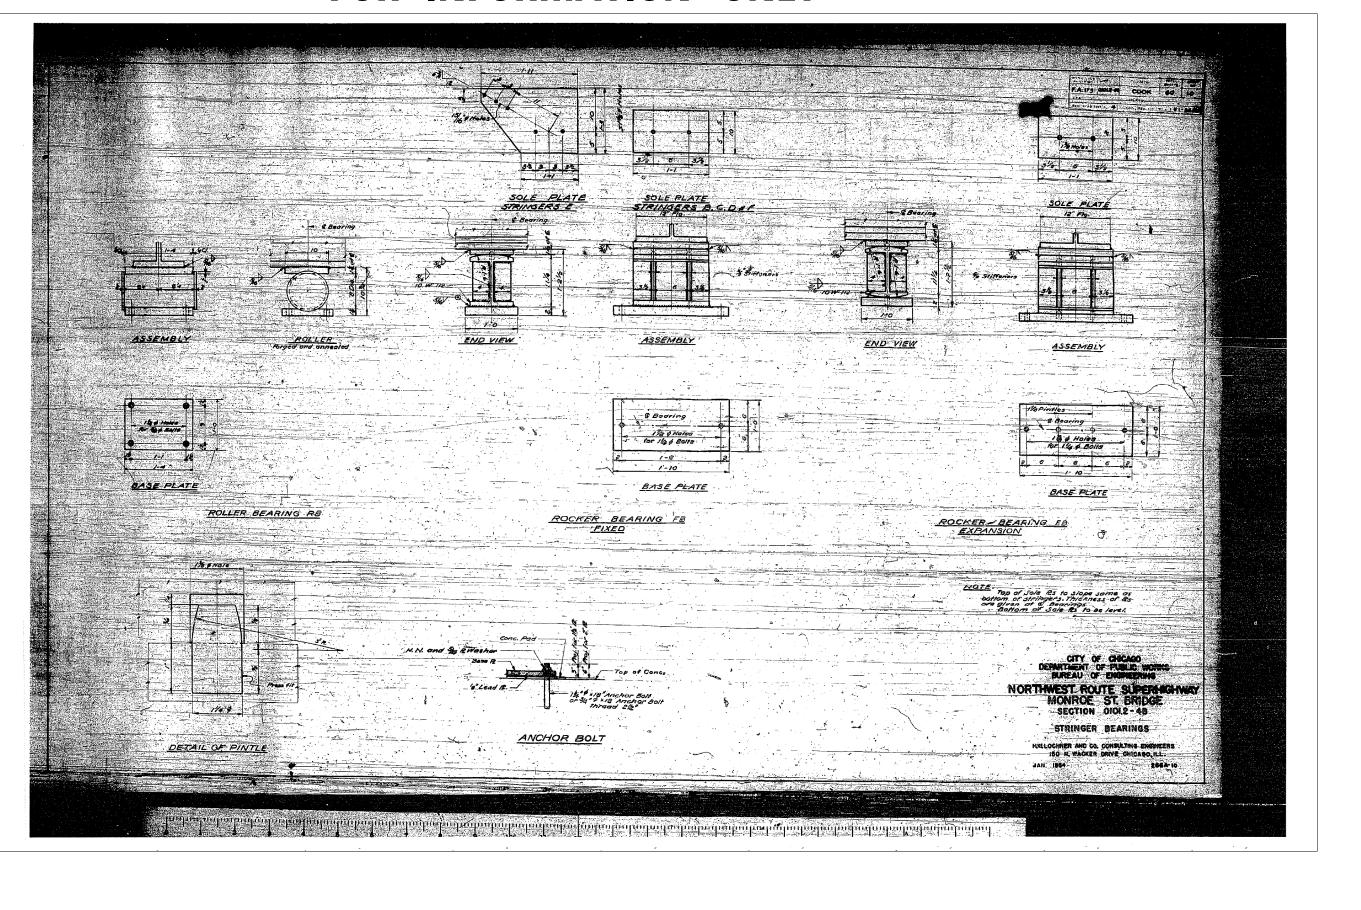
	PARSONS BRINCKERHOFF	USER NAME = pateld PLOT SCALE = N.T.S.	DESIGNED - CHECKED - DRAWN - DCP	REVISED - REVISED - REVISED -	STATE OF ILLINOIS DEPARTMENT OF TRANSPORTATION	EXISTING PLANS Structure No. 016–
0161		PLOT DATE = 5/15/2017	CHECKED - JIG	REVISED -	DEPARIMENT OF TRANSPORTATION	SHEET NO. 61 OF 87 SHE

LANS	F.A.I. RTE.	SECTION	COUNTY	TOTAL SHEETS	SHEET NO.
016–2054	90/94	2014-016R&B	COOK	378	273
010-2034			CONTRACT	NO. 6	0X95
37 SHEETS		ILLINOIS FED. AI	D PROJECT		

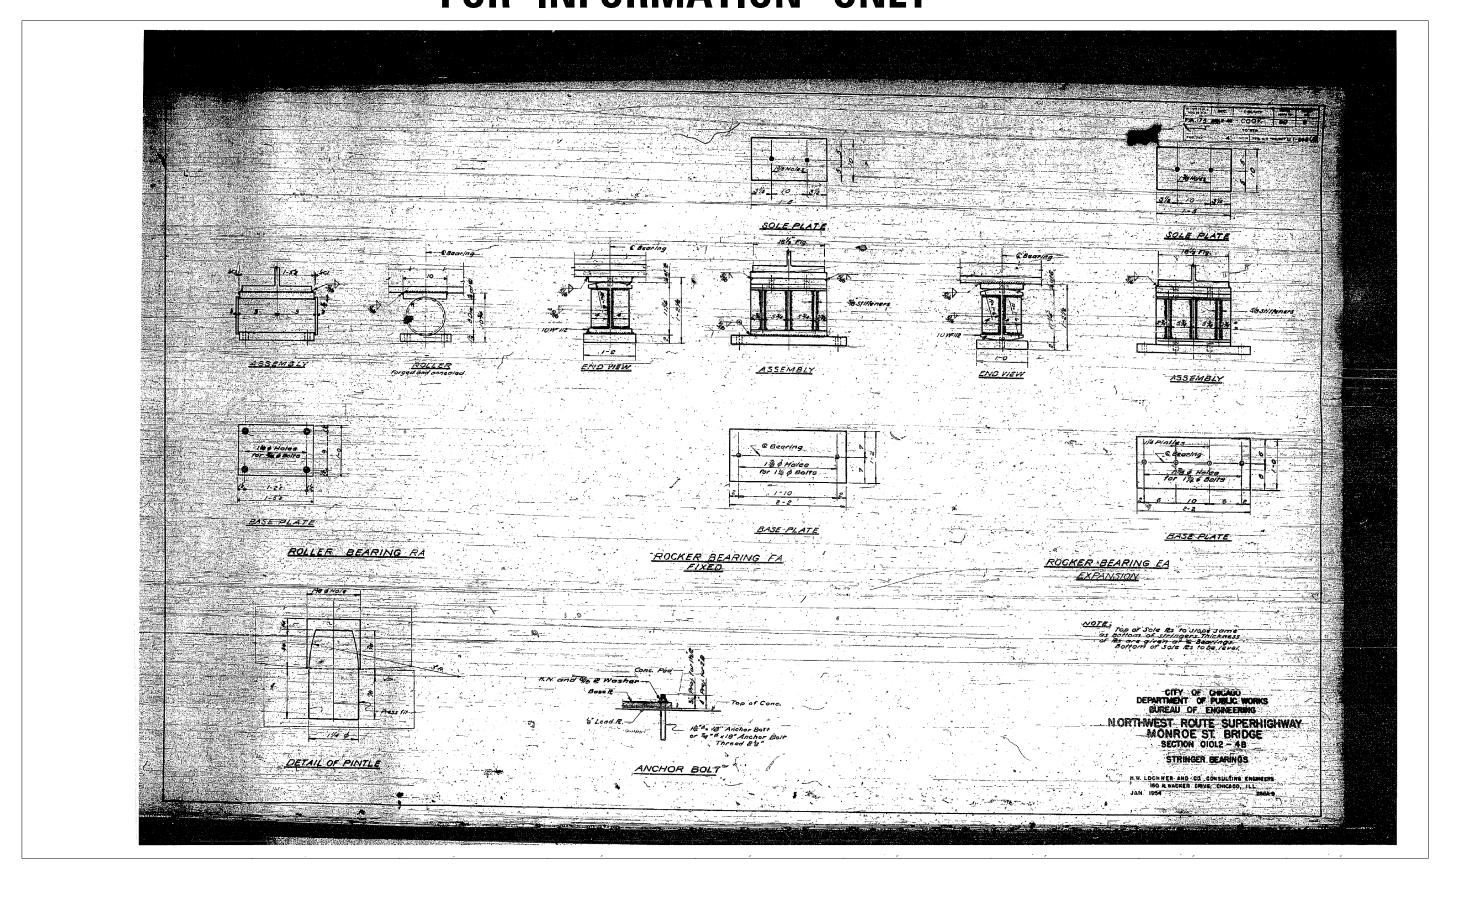


	PARSONS BRINCK ER HOFF	USER NAME = poteld PLOT SCALE = N.T.S.	DESIGNED - CHECKED - DRAWN - DCP	REVISED - REVISED - REVISED -	STATE OF ILLINOIS DEPARTMENT OF TRANSPORTATION	EXISTING PLANS STRUCTURE NO. 016-
5		PLOT DATE = 5/15/2017	CHECKED - JIG	REVISED -		SHEET NO. 62 OF 87 SHE

LANS	F.A.I. RTE.	SECTION	COUNTY	TOTAL SHEETS	SHEET NO.
016-2054	90/94	2014-016R&B	СООК	378	274
010-2034			CONTRACT	NO. 6	0X95
B7 SHEETS		ILLINOIS FED.	AID PROJECT		




PARSONS	USER NAME = pateld	DESIGNED - CHECKED -	REVISED - REVISED -	STATE OF ILLINOIS	EXISTING PLANS STRUCTURE NO. 016-
BRINCKERHOFF	PLOT SCALE = N.T.S. PLOT DATE = 5/15/2017	DRAWN - DCP CHECKED - JIG	REVISED - REVISED -	DEPARTMENT OF TRANSPORTATION	SHEET NO. 63 OF 87 SHE

LANS	F.A.I. RTE.	SECTION	COUNTY	TOTAL SHEETS	SHEET NO.			
016–2054	90/94	2014-016R&B	COOK	378	275			
	CONTRACT NO. 60X95							
37 SHEETS		ILLINOIS FED. AI	D PROJECT					

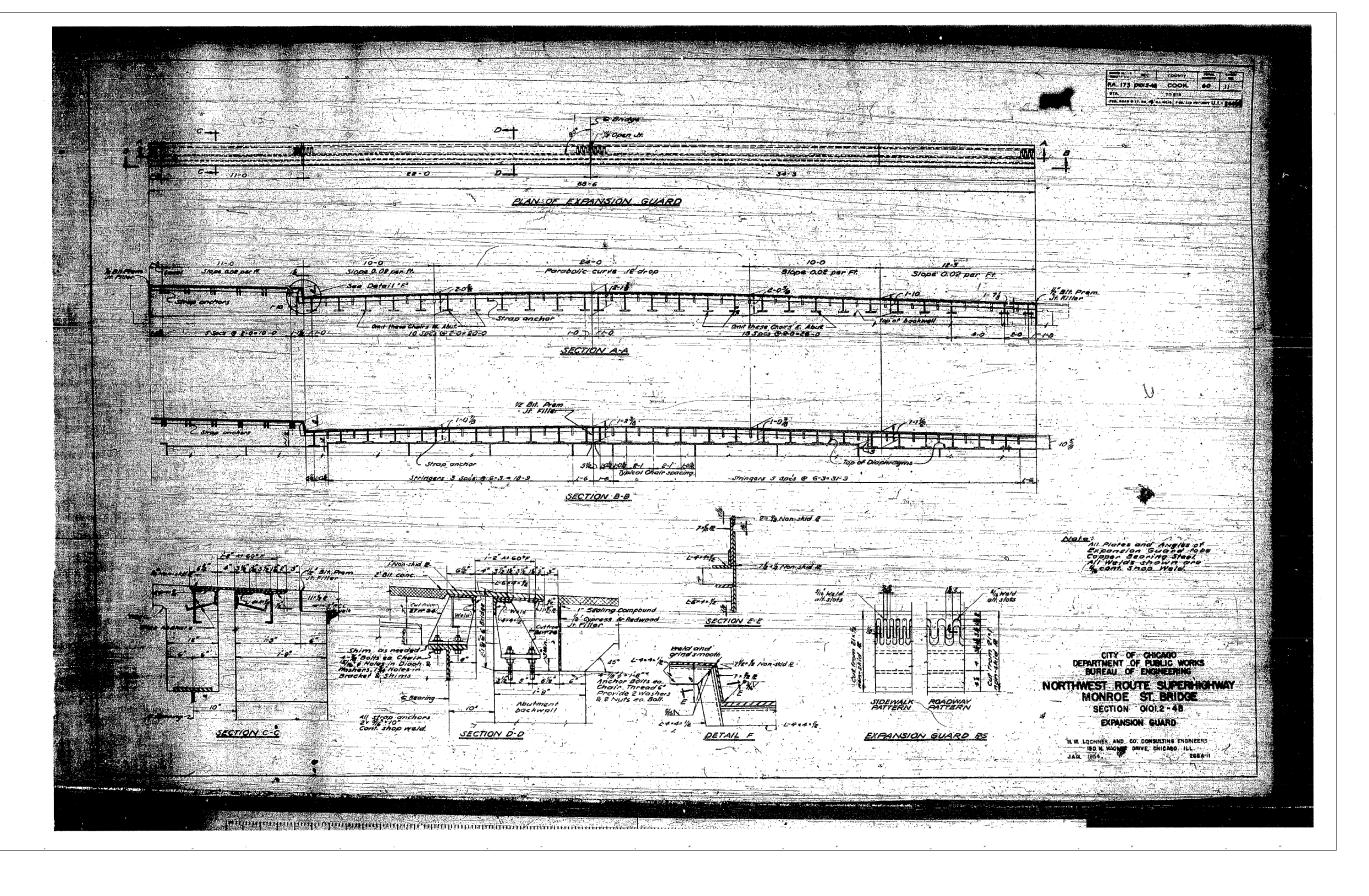


	RSONS NCKERHOFF	USER NAME = pateld PLOT SCALE = N.T.S.	DESIGNED - CHECKED - DRAWN - DCP	REVISED - REVISED - REVISED -	STATE OF ILLINOIS DEPARTMENT OF TRANSPORTATION	EXISTING PLANS STRUCTURE NO. 016-
BRINCKENNOFF	PLOT DATE = 5/15/2017	CHECKED - JIG	REVISED -		SHEET NO. 64 OF 87 SHE	

LANS	F.A.I. RTE.	SECTION	COUNTY	TOTAL SHEETS	SHEET NO.		
016-2054	90/94	2014-016R&B	СООК	378	276		
010-2034	CONTRACT NO. 60X95						
7 SHEETS	ILLINOIS FED. AID PROJECT						

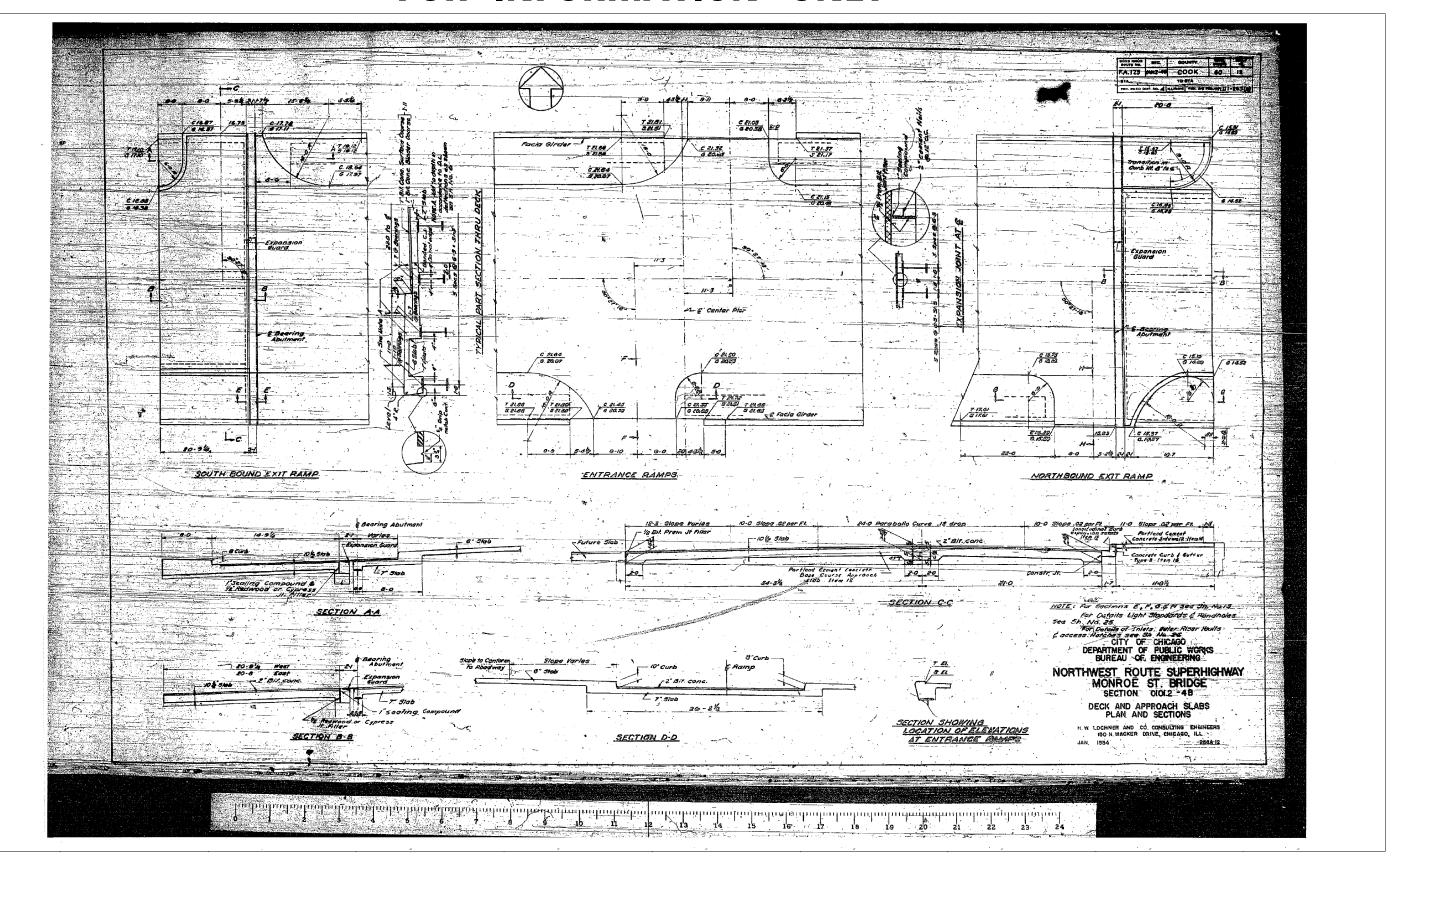

PARSONS BRINCKERHOFF	STATE OF ILLINOIS DEPARTMENT OF TRANSPORTATION	EXISTING PLANS STRUCTURE NO. 016
		SHEET NO. 65 OF 87 SHEE

LANS	F.A.I. RTE.	SECTION		COUNTY	TOTAL SHEETS	SHEET NO.
016–2054	90/94	2014-016R&B		СООК	378	277
	CONTRACT NO. 60X95					
37 SHEETS		ILLINOIS F	ED. AID	PROJECT		

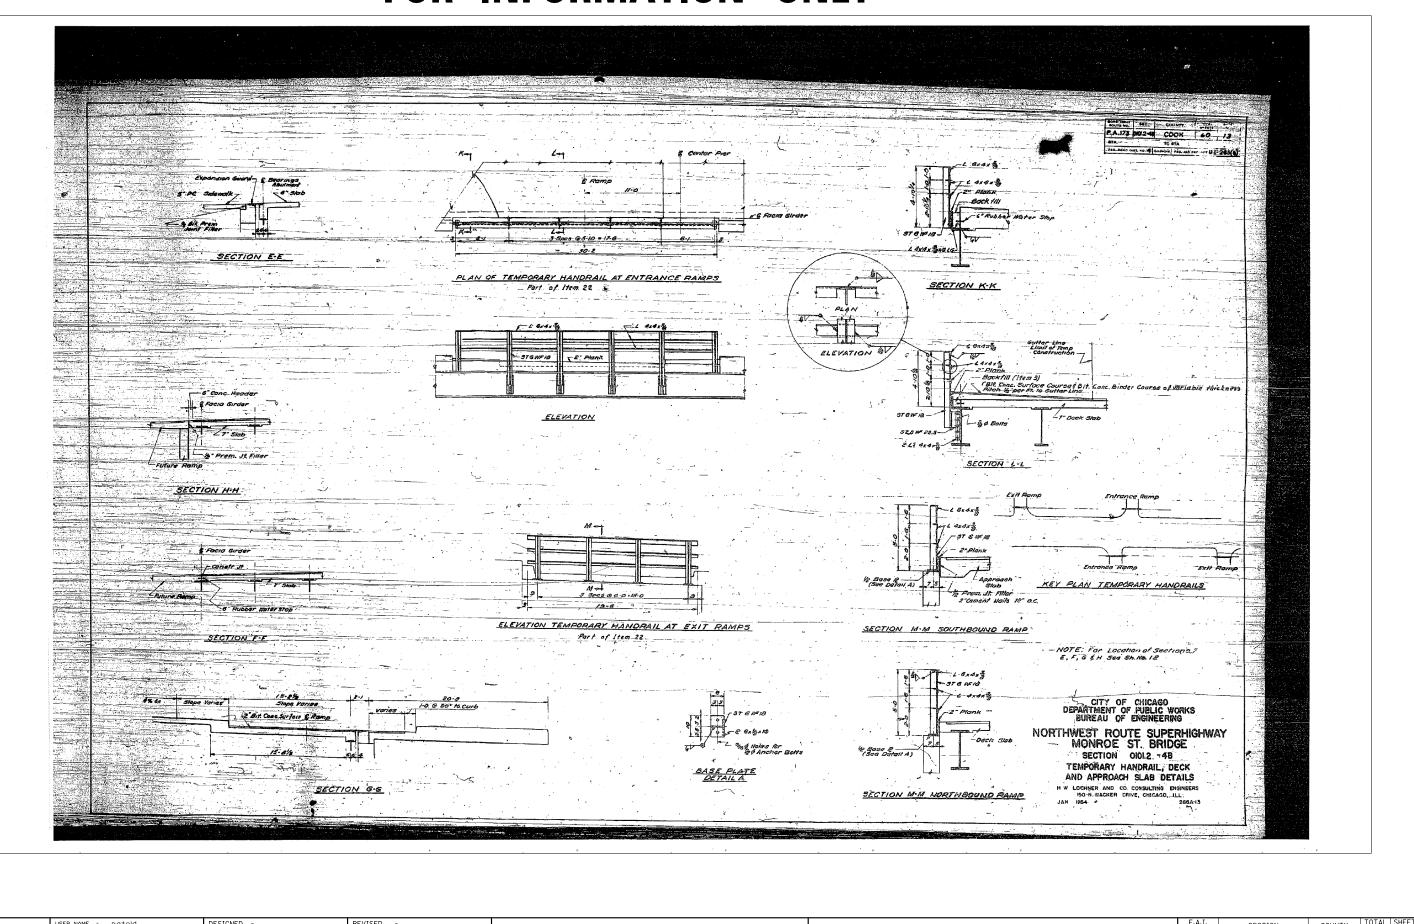


	P ARSONS BRINCK ER HOFF	USER NAME = pateld PLOT SCALE = N.T.S.	DESIGNED - CHECKED - DRAWN - DCP	REVISED - REVISED - REVISED -	STATE OF ILLINOIS DEPARTMENT OF TRANSPORTATION	EXISTING PLANS STRUCTURE NO.016-
1910	DRINCKERNUFF	PLOT DATE = 5/15/2017	CHECKED - JIG	REVISED -	DEFARIMENT OF TRANSFORTATION	SHEET NO. 66 OF 87 SHE

LANS	F.A.I. RTE.	SE	CTION	COUNTY	TOTAL SHEETS	SHEET NO.	
016-2054	90/94	2014	-016R&B	СООК	378	278	
010-2034	CONTRACT NO. 60X95						
B7 SHEETS			ILLINOIS FED. A	D PROJECT			


Reit Rom	8			
			Entrance Ramp	randard Support Acce
		63 Spc. @ 4-	NFORCEMENT	S & Anenor guardeo
C Aproaction		4 8 184 Cont Typicol	TOP REINFORCEMENT.	
2-3-12-3/4 	2 - 2 - 2 - 2 - 2 - 2 - 2 - 2 - 2 - 2 -	Bont	Materiale Sea Shine Shine Sea Shine Sh	C-Light Shandard Support
	1-0 	22-07 Act	DECK PLAN	10-0
	2-1/2 20 10 10 200	Cu -18 - 19 - 18 - 18 - 18 - 18 - 18 - 18	Typicer (/ / / / / / / / / / / / / / / / / / /	9 12 18 74 11 picot Cont. 12 12 12 12 12 12 12 12 12 12
		Pes C 6-3+3/-3	PICAL CROSS SECTION	dermegiate Beintersament
	Side well Item in Concrete Curb and	.€1-0 1-6@ 2-6	5° Roadway	34- <u>3</u>
			"B @ #	*a @ 13 Rsinforcement Gars Ird
			SECTION D'-D' Similar n	

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	PARSONS BRINCKERHOFF	USER NAME = poteld PLOT SCALE = N.T.S.	DESIGNED - CHECKED - DRAWN - DCP	REVISED - REVISED - REVISED -	STATE OF ILLINOIS DEPARTMENT OF TRANSPORTATION	EXISTING PLANS STRUCTURE NO. 016-
016.		PLOT DATE = 5/15/2017	CHECKED - JIG	REVISED -		SHEET NO. 67 OF 87 SH

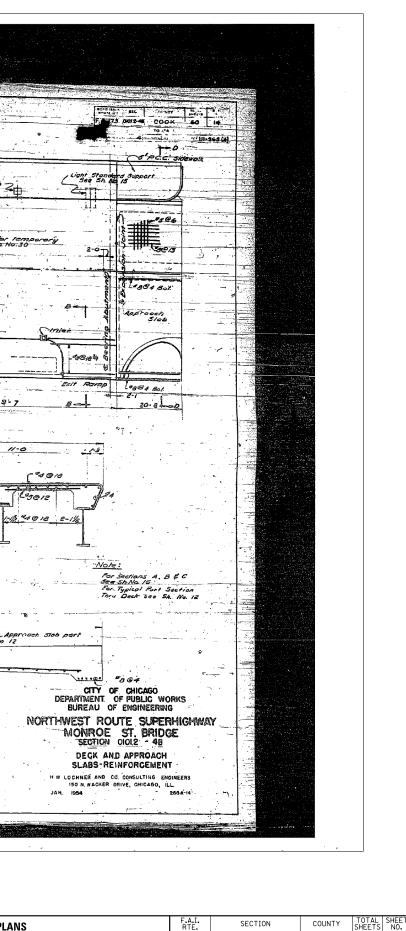


LANG	INTE.					140.
. 016–2054	90/94	2014-016F	&B	СООК	378	279
. 010-2054				CONTRACT	NO. 6	50X95
87 SHEETS		ILLING	IS FED. A	ID PROJECT		

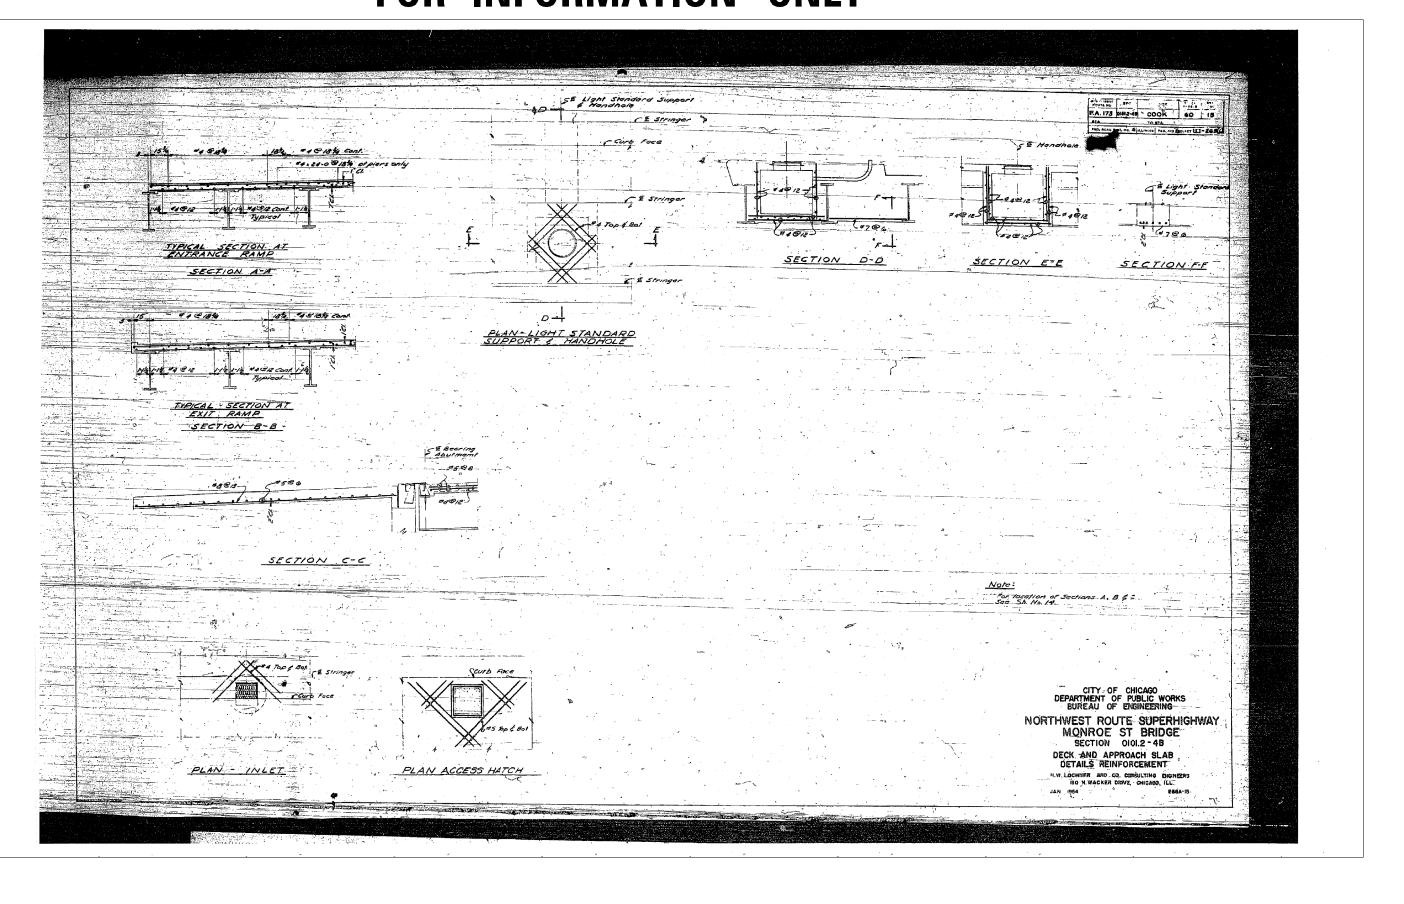


	PARSONS BRINCKERHOFF	USER NAME = pateld PLOT SCALE = N.T.S.	DESIGNED - CHECKED - DRAWN - DCP	REVISED - REVISED - REVISED -	STATE OF ILLINOIS DEPARTMENT OF TRANSPORTATION	EXISTING PLANS STRUCTURE NO. 016-
5		PLOT DATE = 5/15/2017	CHECKED - JIG	REVISED -		SHEET NO. 68 OF 87 SHE

LANS	F.A.I. RTE.	SECTION	COUNTY	TOTAL SHEETS	SHEET NO.	
. 016–2054	90/94	2014-016R&B	COOK	378	280	
. 010-2034	CONTRACT NO. 60X95					
B7 SHEETS		ILLINOIS FED. AI	D PROJECT			

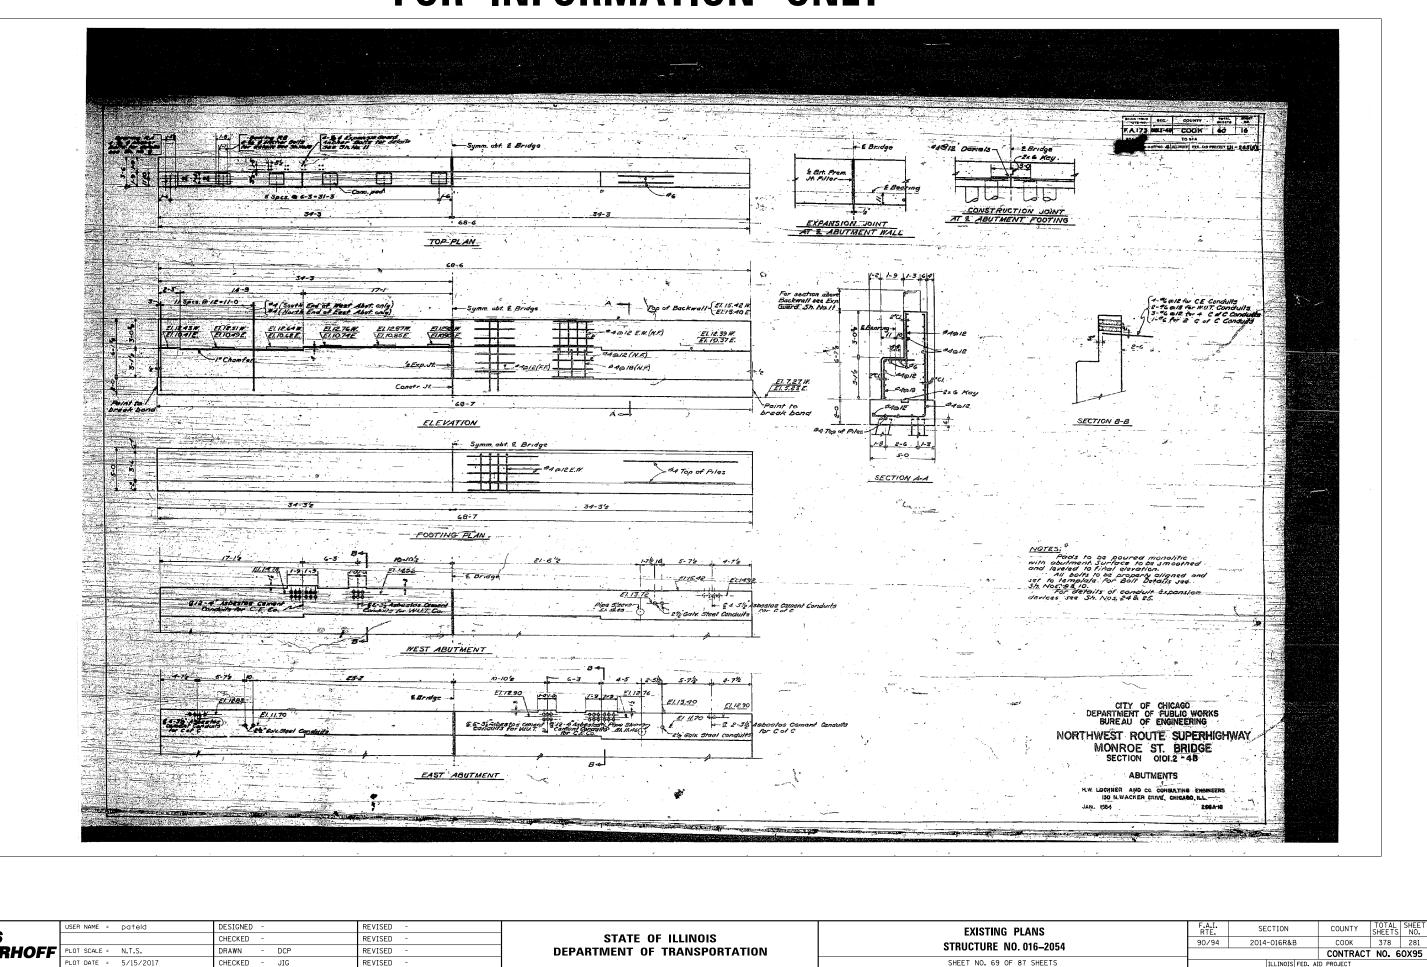


PARSONS BRINCKERHOFF		DESIGNED - CHECKED - DRAWN - DCP	REVISED - REVISED - REVISED -	STATE OF ILLINOIS DEPARTMENT OF TRANSPORTATION	EXISTING PLANS Structure NO. 016-
PL	PLOT DATE = 5/15/2017	CHECKED - JIG	REVISED -		SHEET NO. 69 OF 87 SHE

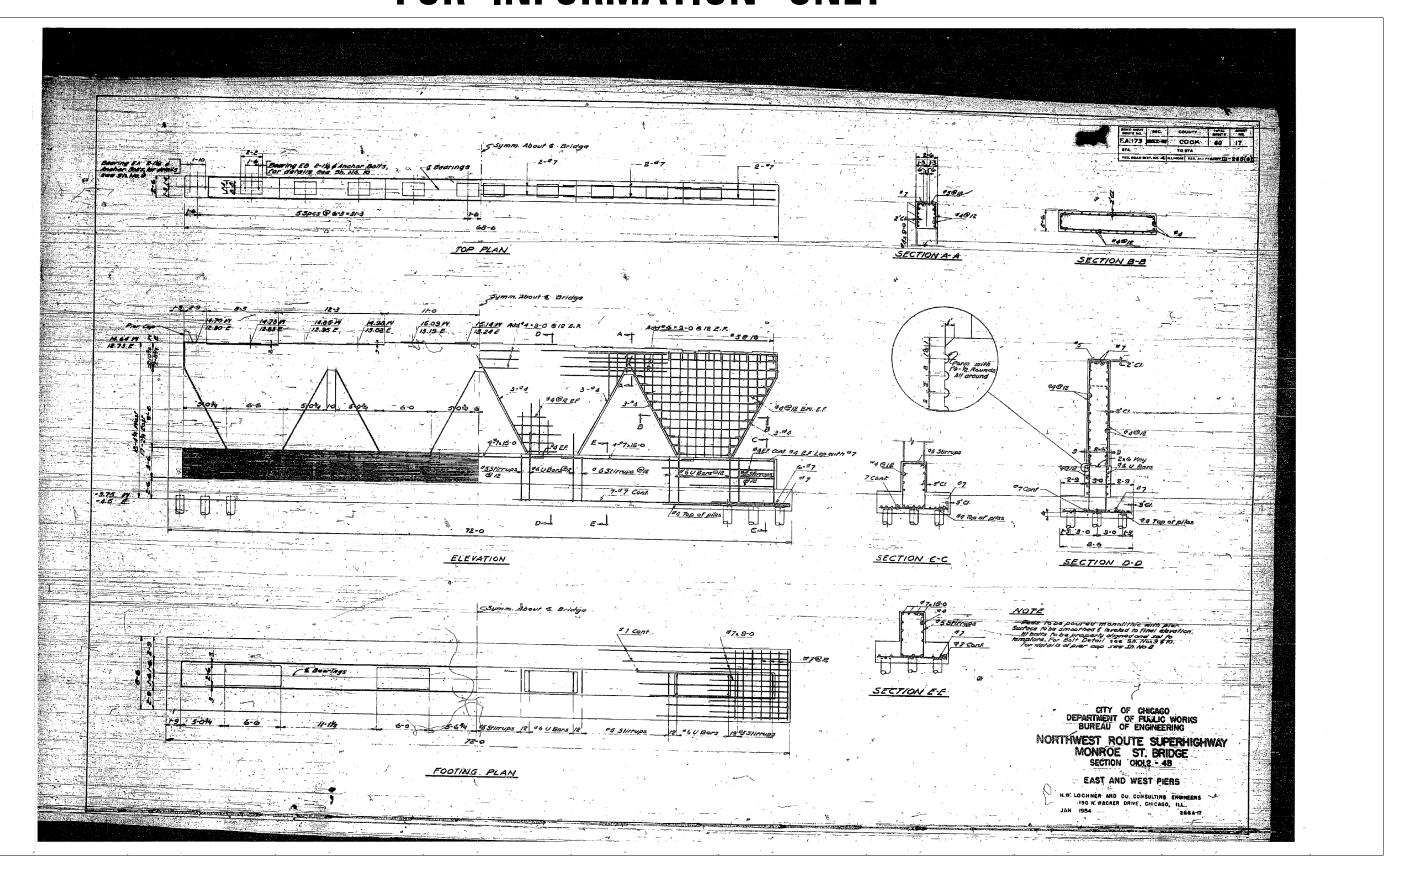

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ອ						
Ň		USER NAME = pateld	DESIGNED -	REVISED -		EXISTING PLAN
0-6	PARSONS		CHECKED -	REVISED -	STATE OF ILLINOIS	
170	BRINCKERHOFF	PLOT SCALE = N.T.S.	DRAWN - DCP	REVISED -	DEPARTMENT OF TRANSPORTATION	STRUCTURE NO. 016
016	2	PLOT DATE = 5/15/2017	CHECKED - JIG	REVISED -		SHEET NO. 70 OF 87 SH


LANS	F.A.I. RTE.	SECTION	COUNTY	TOTAL SHEETS	SHEET NO.
016–2054	90/94	2014-016R&B	COOK	378	282
010-2034			CONTRACT	NO. 6	0X95
B7 SHEETS		ILLINOIS FED. AI	D PROJECT		

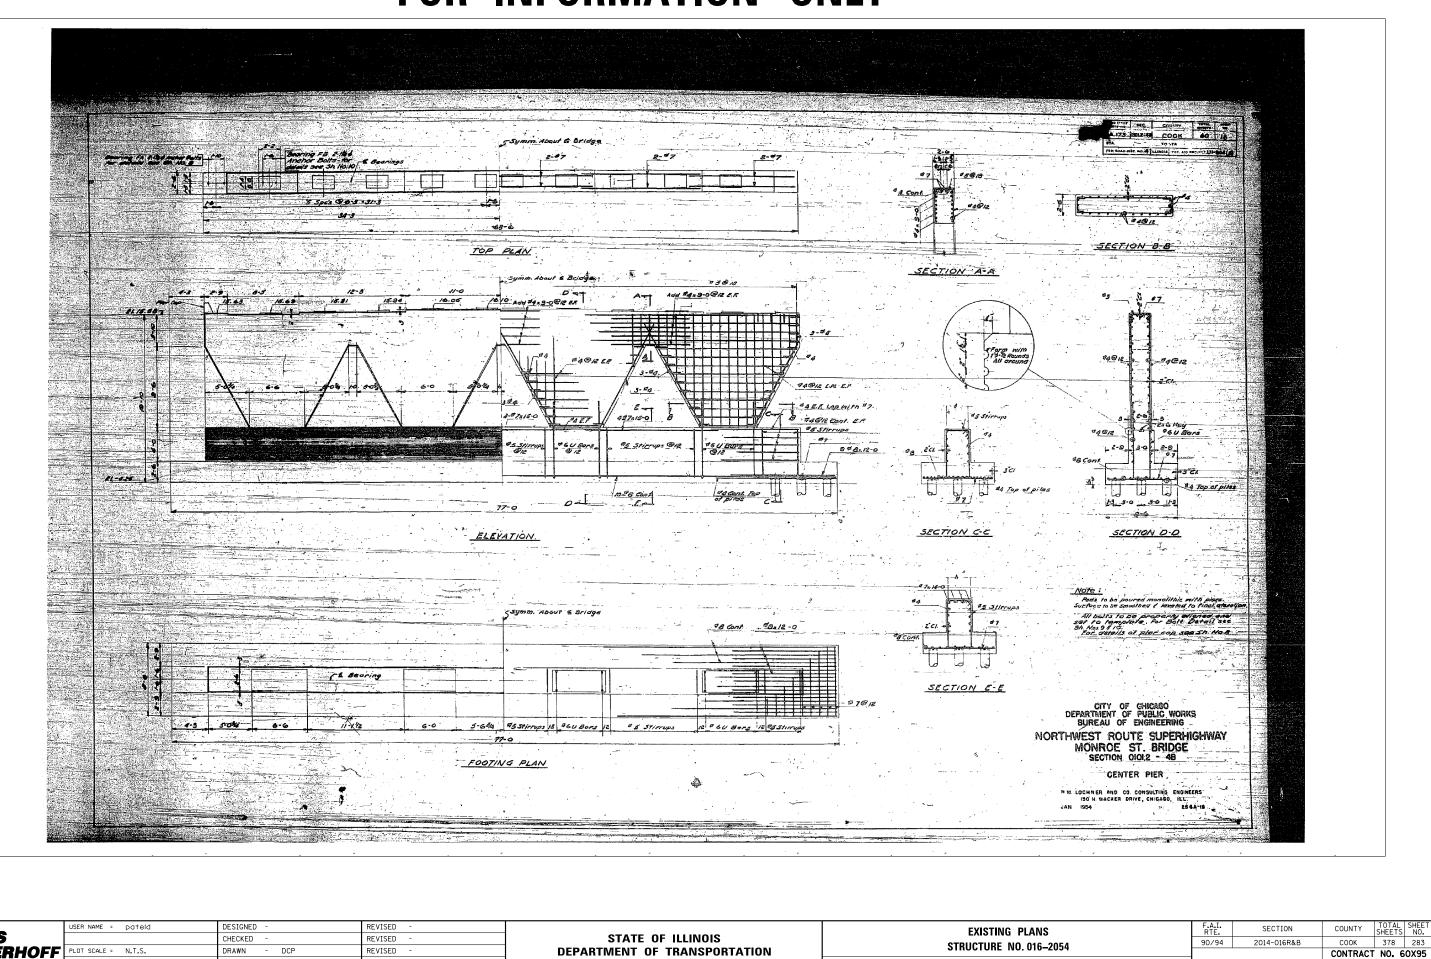

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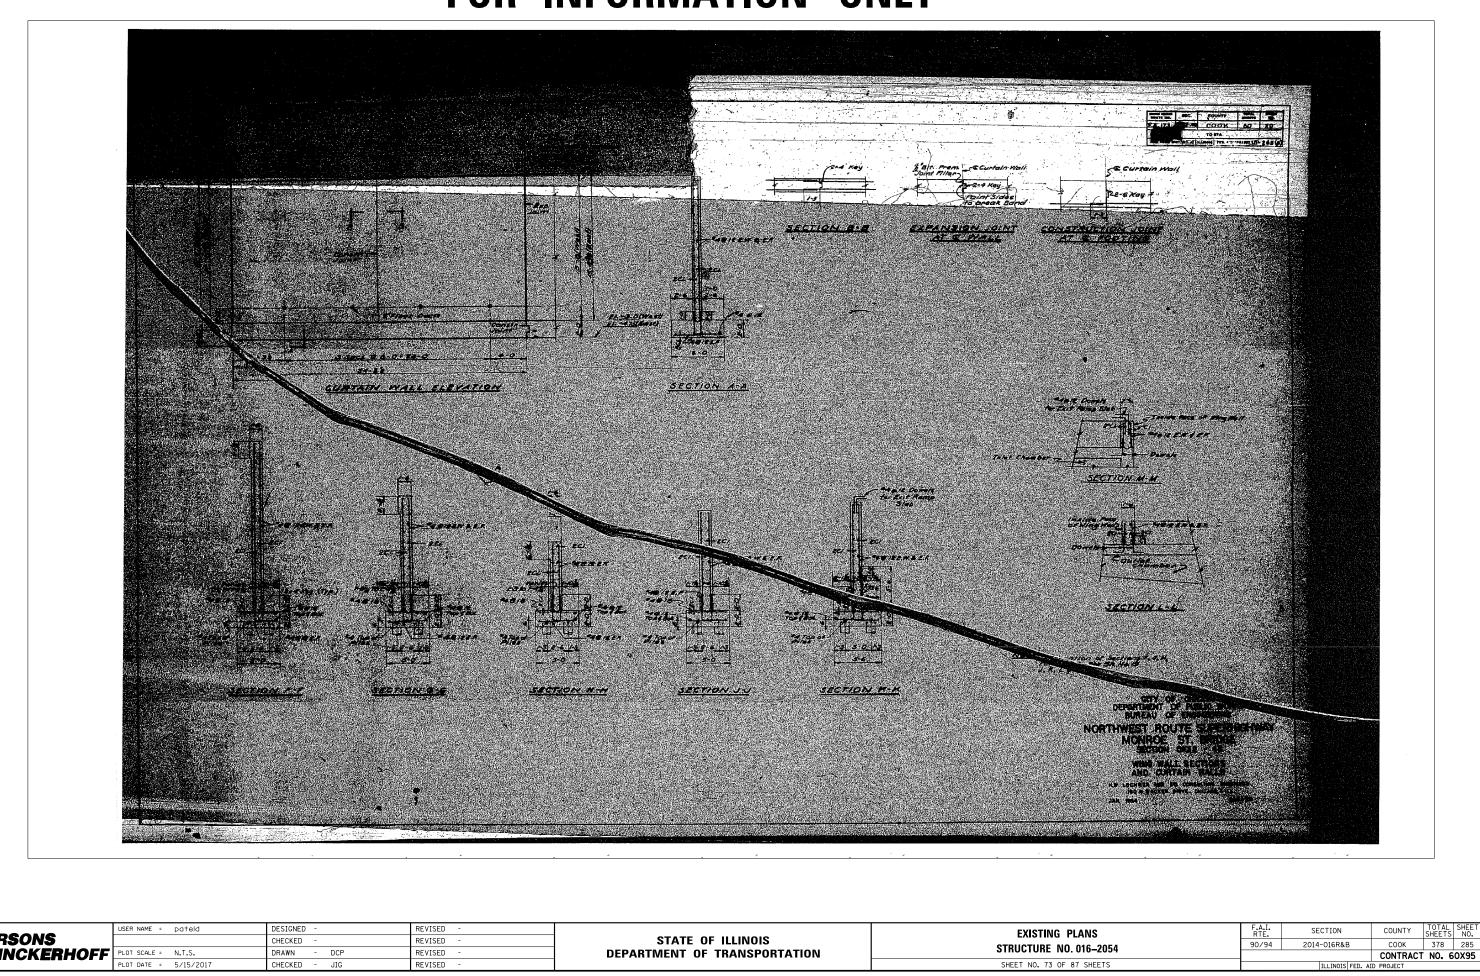
ATD PROJECT

60X5	P ARSONS	USER NAME = pateld	DESIGNED -	REVISED -	STATE OF ILLINOIS	EXISTING PLANS
	BRINCKERHOFF	PLOT SCALE = N.T.S.	CHECKED - DRAWN - DCP	REVISED - REVISED -	DEPARTMENT OF TRANSPORTATION	STRUCTURE NO. 016–2054
016		PLOT DATE = 5/15/2017	CHECKED - JIG	REVISED -		SHEET NO. 71 OF 87 SHEETS

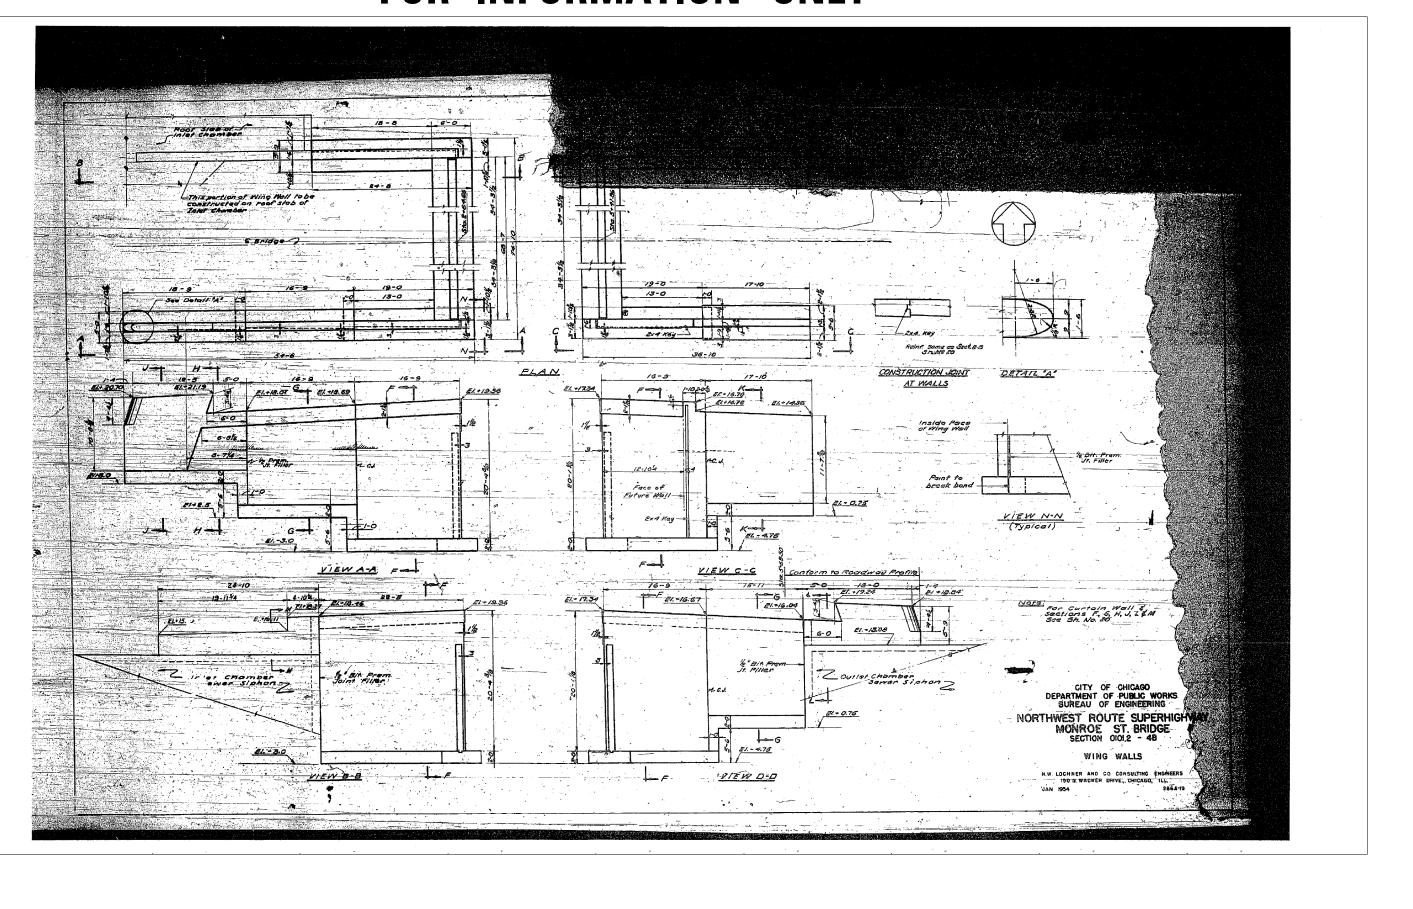


PARSONS BRINCKERHOFF	USER NAME = pateld PLOT SCALE = N.T.S.	DESIGNED - CHECKED - DRAWN - DCP	REVISED - REVISED - REVISED -	STATE OF ILLINOIS DEPARTMENT OF TRANSPORTATION	EXISTING PLANS STRUCTURE NO.016→
DNINCKENNUFF	PLOT DATE = 5/15/2017	CHECKED - JIG	REVISED -	DEFAILINENT OF THANSFORTATION	SHEET NO. 72 OF 87 SHE

LANS	F.A.I. RTE.	SECTION	COUNTY	TOTAL SHEETS	SHEET NO.
016-2054	90/94	2014-016R&B	СООК	378	284
010-2034			CONTRACT	NO. 6	0X95
37 SHEETS	1	ILLINOIS FED. AI	D PROJECT		




	USER NAME = pateld	DESIGNED -	REVISED -		EXISTING PLANS
PARSONS		CHECKED -	REVISED -	STATE OF ILLINOIS	
BRINCKERHOFF	PLOT SCALE = N.T.S.	DRAWN - DCP	REVISED -	DEPARTMENT OF TRANSPORTATION	STRUCTURE NO. 016-
	PLOT DATE = 5/15/2017	CHECKED - JIG	REVISED -		SHEET NO. 73 OF 87 SHE

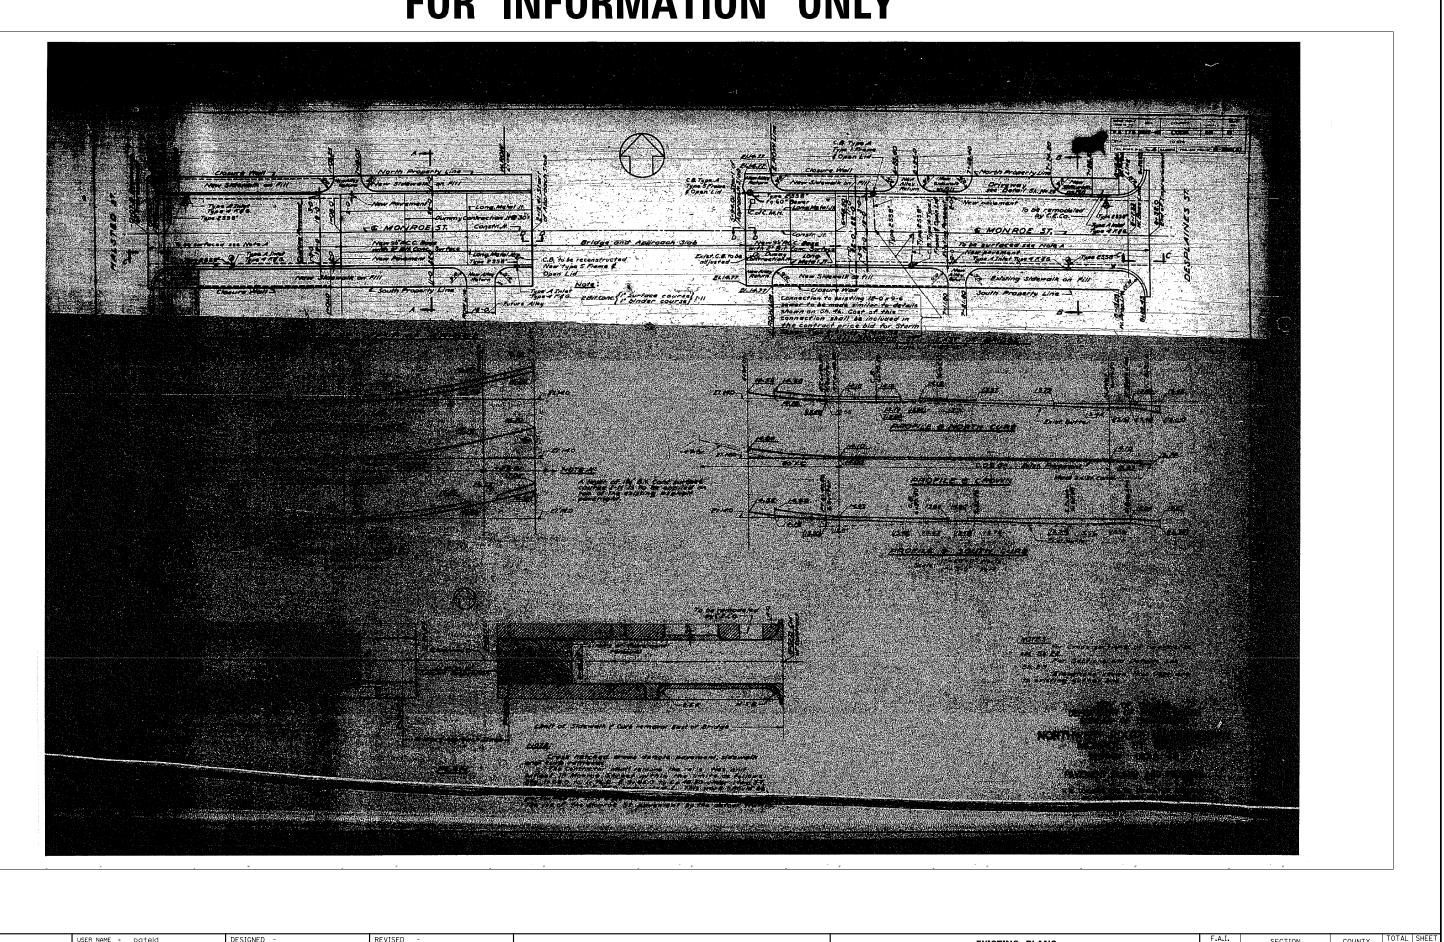


	PARSONS BRINCK ER HOFF	USER NAME = pateld PLOT SCALE = N.T.S.	DESIGNED - CHECKED - DRAWN - DCP	REVISED - REVISED - REVISED -	STATE OF ILLINOIS DEPARTMENT OF TRANSPORTATION	EXISTING PLANS STRUCTURE NO.016-
L		PLOT DATE = 5/15/2017	CHECKED - JIG	REVISED -		SHEET NO. 74 OF 87 SHE

LANS	F.A.I. RTE.	SE	CTION		COUNTY		SHEETS	SHEET
016–2054	90/94	2014	-016R&E	3	COOK		378	286
010-2034					CONTRA	сτ	NO. 6	50X95
37 SHEETS			ILLINOIS	FED, A	ID PROJECT			

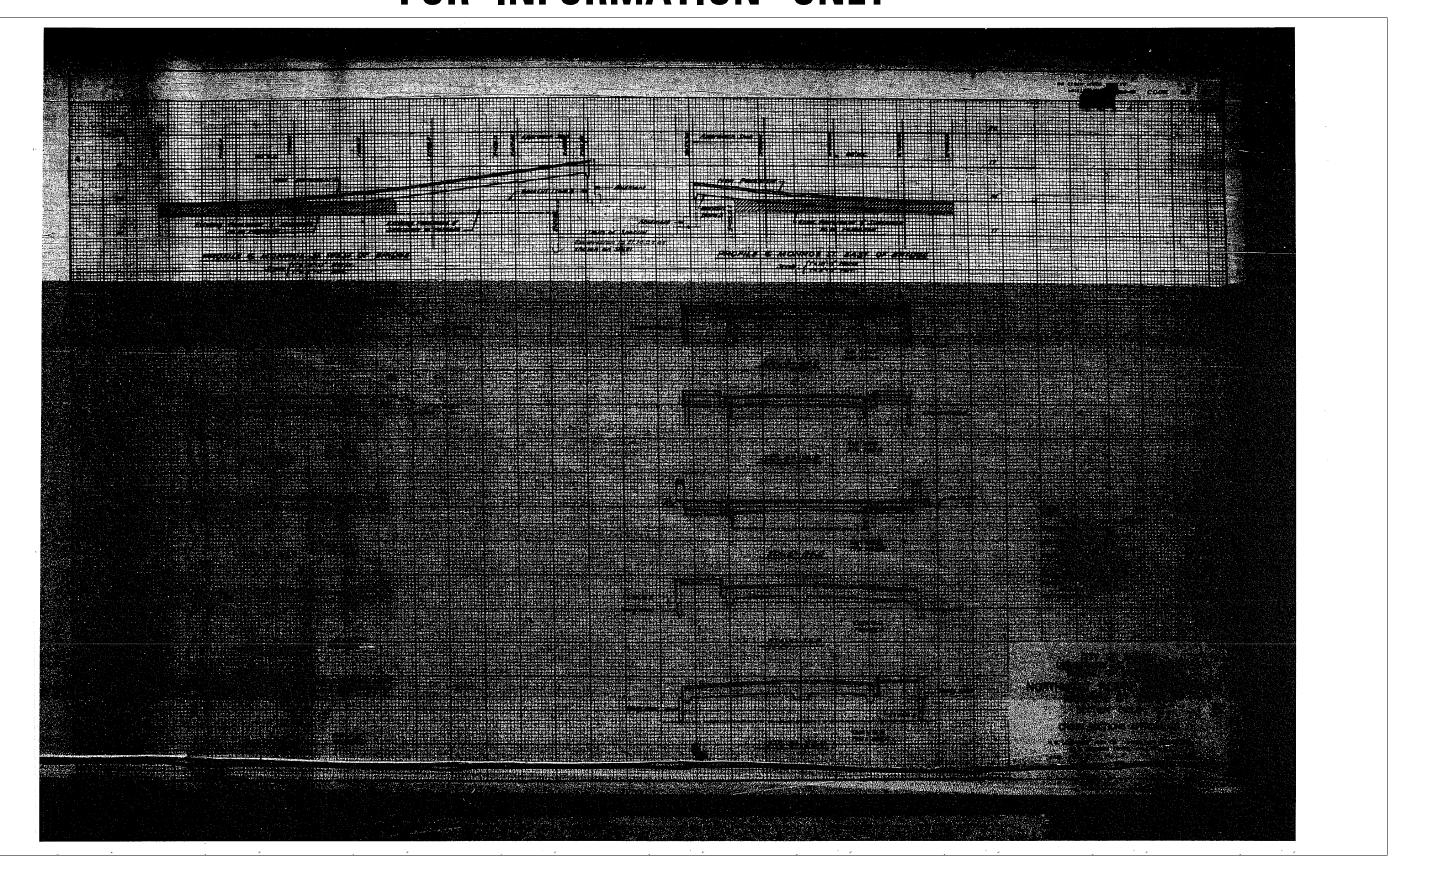


P ARSONS BRINCKERHOFF	USER NAME = pateld PLOT SCALE = N.T.S.	DESIGNED - CHECKED - DRAWN - DCP	REVISED - REVISED - REVISED -	STATE OF ILLINOIS DEPARTMENT OF TRANSPORTATION	EXISTING PLANS STRUCTURE NO. 016-
	PLOT DATE = 5/15/2017	CHECKED - JIG	REVISED -		SHEET NO. 75 OF 87 SHE

LANS	F.A.I. RTE	SECTION	COUNTY	TOTAL SHEETS	SHEET NO.	
016–2054	90/94	2014-016R&B	СООК	378	287	
010-2034	CONTRACT NO. 60X95					
B7 SHEETS		ILLINOIS FED. AI	D PROJECT			

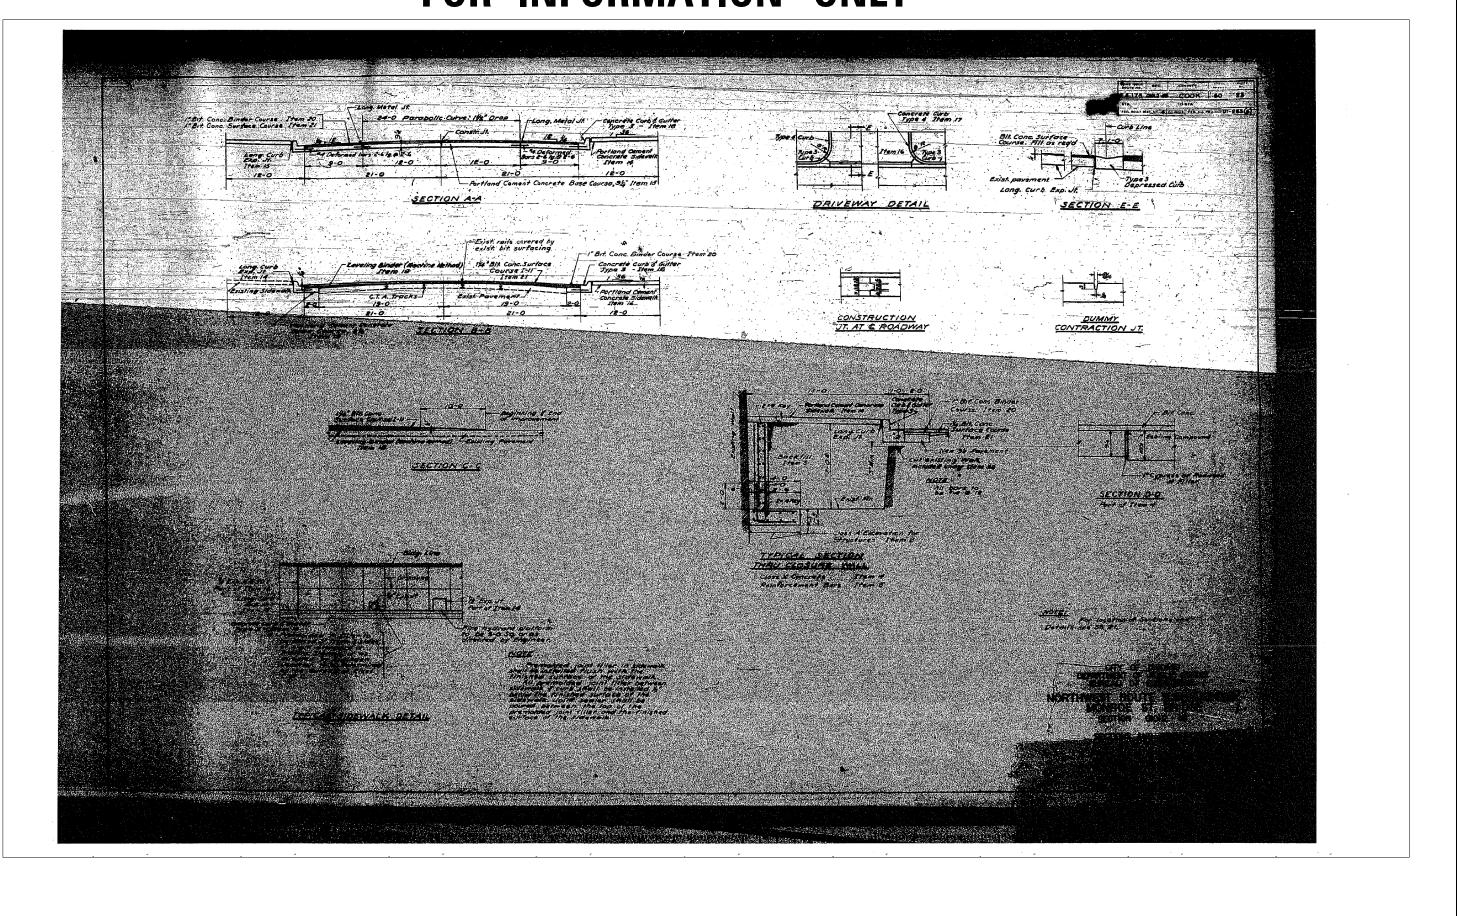

PARSONS BRINCK ER HOFF	USER NAME = pateld PLOT SCALE = N.T.S.	DESIGNED - CHECKED - DRAWN - DCP	REVISED - REVISED - REVISED -	STATE OF ILLINOIS DEPARTMENT OF TRANSPORTATION	EXISTING PLANS Structure no. 016–3
	PLOT DATE = 5/15/2017	CHECKED - JIG	REVISED -		SHEET NO. 76 OF 87 SHE


LANS	F.A.I. RTE.	SECTION	COUNTY	TOTAL SHEETS	SHEET NO.
016–2054	90/94	2014-016R&B	СООК	378	288
010-2034			CONTRACT	NO. 6	0X95
37 SHEETS		ILLINOIS FED. AI	D PROJECT		

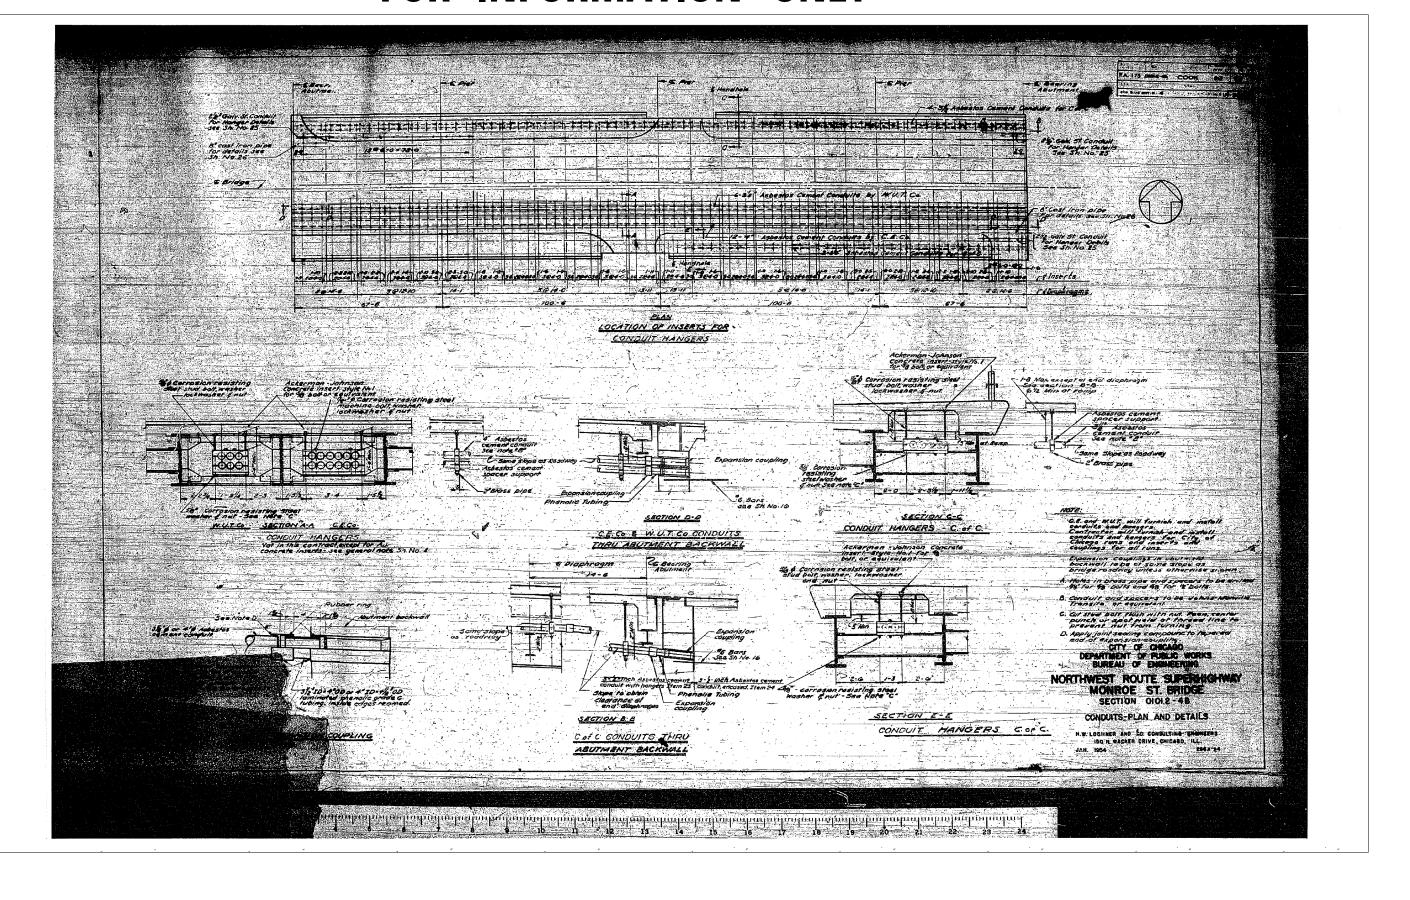

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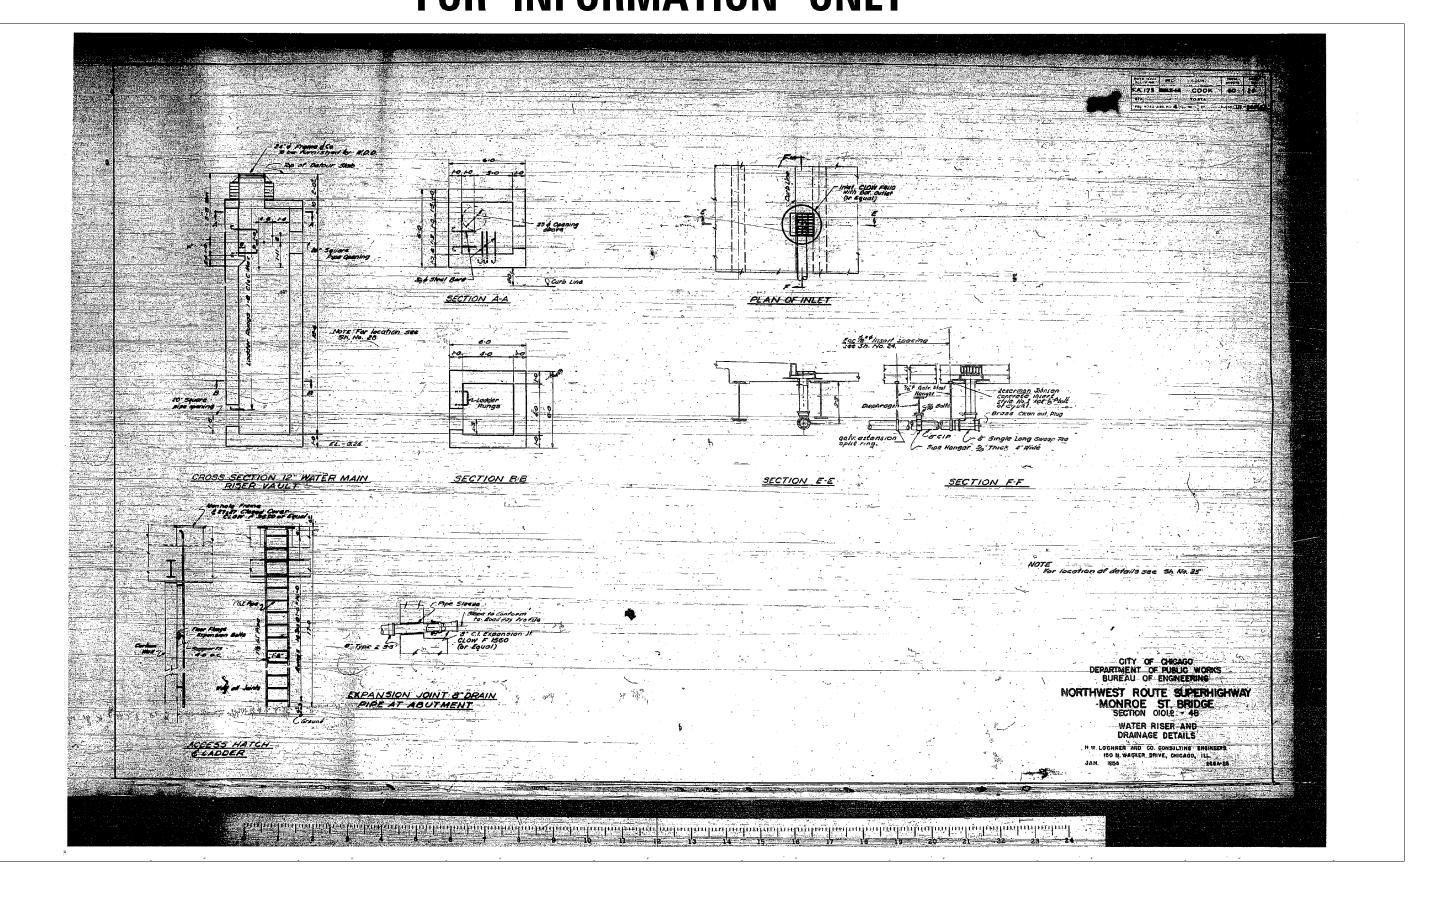
ж L						
Χ̈́		USER NAME = pateld	DESIGNED -	REVISED -		EXISTING PLAN
	PARSONS		CHECKED -	REVISED -	STATE OF ILLINOIS	
170	BRINCKERHOFF	PLOT SCALE = N.T.S.	DRAWN - DCP	REVISED -	DEPARTMENT OF TRANSPORTATION	STRUCTURE NO. 016
016		PLOT DATE = 5/15/2017	CHECKED - JIG	REVISED -		SHEET NO. 77 OF 87 SH
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LANS	F.A.I. RTE.	SECTION		COUNTY	TOTAL SHEETS	SHEET NO.
016-2054	90/94	2014-016R&B	3	СООК	378	289
				CONTRACT	NO. 6	0X95
37 SHEETS		ILLINOIS	FED. AI	ID PROJECT		




P ARSONS BRINCK ER HOFF	USER NAME = pateld PLOT SCALE = N.T.S.	DESIGNED - CHECKED - DRAWN - DCP	REVISED - REVISED - REVISED -	STATE OF ILLINOIS DEPARTMENT OF TRANSPORTATION	EXISTING PLANS STRUCTURE NO. 016–
BRINCKERNUFF	PLOT DATE = 5/15/2017	CHECKED - JIG	REVISED -	DEPARTMENT OF TRANSPORTATION	SHEET NO. 78 OF 87 SHE

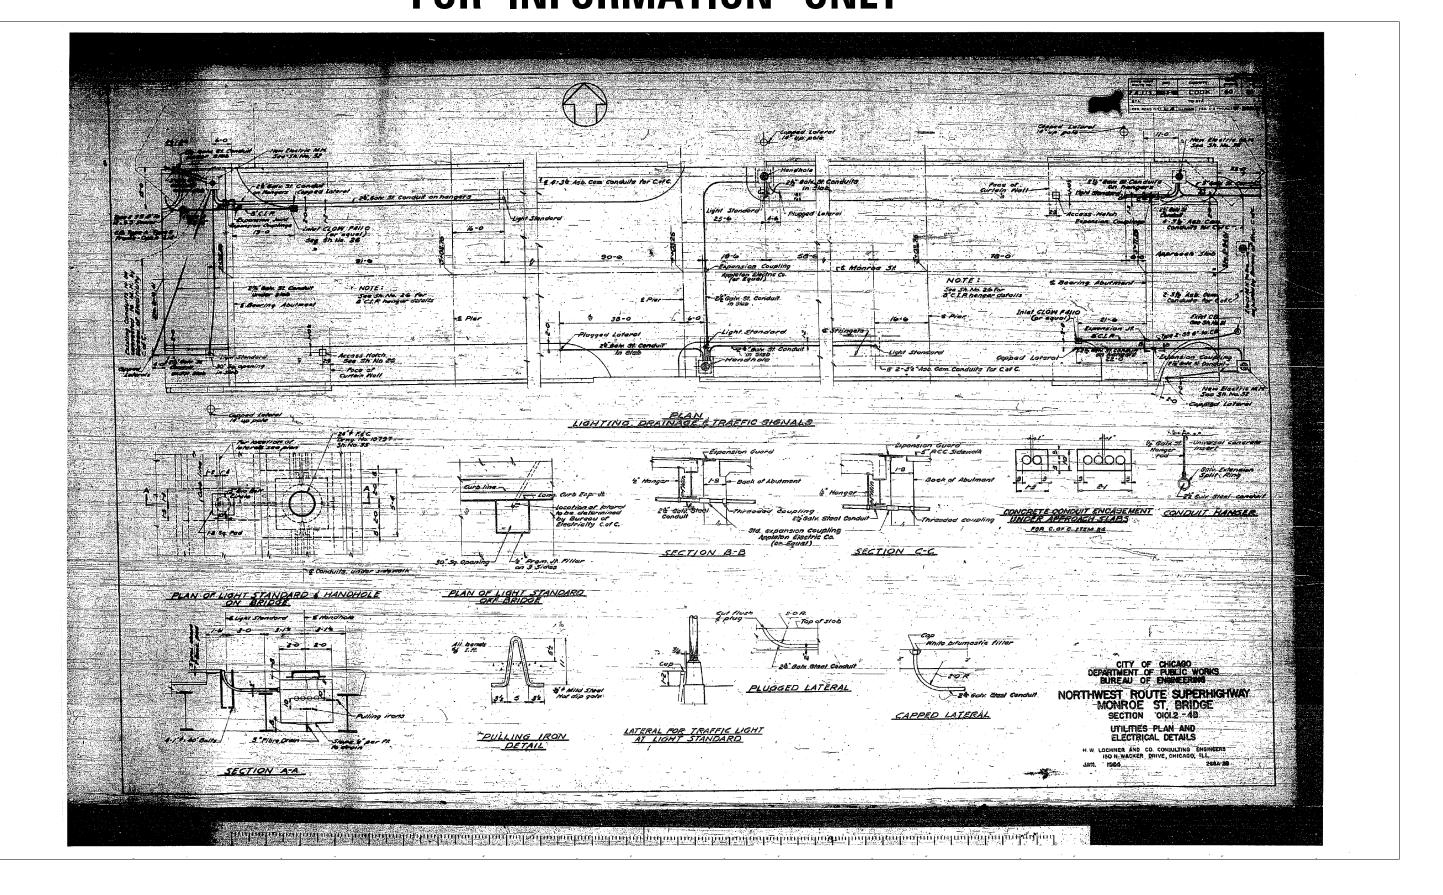LANS	F.A.I. RTE.	SECTION	COUNTY	TOTAL SHEETS	SHEET NO.	
016–2054	90/94	2014-016R&B	COOK	378	290	
010-2034	CONTRACT NO. 60X95					
37 SHEETS		ILLINOIS FED. AI	D PROJECT			




P ARSONS BRINCKERHOFF	USER NAME = pateld PLOT SCALE = N.T.S.	DESIGNED - CHECKED - DRAWN - DCP	REVISED - REVISED - REVISED -	STATE OF ILLINOIS DEPARTMENT OF TRANSPORTATION	EXISTING PLANS Structure NO. 016
	PLOT DATE = 5/15/2017	CHECKED - JIG	REVISED -		SHEET NO. 79 OF 87 SHE

ANS 016–2054	F.A.I. RTE.	SECTION	COUNTY	TOTAL SHEETS	SHEET NO.	
016_2054	90/94	2014-016R&B	COOK	378	291	
010-2037	CONTRACT NO. 60X95					
7 SHEETS		ILLINOIS FED. AI	D PROJECT			

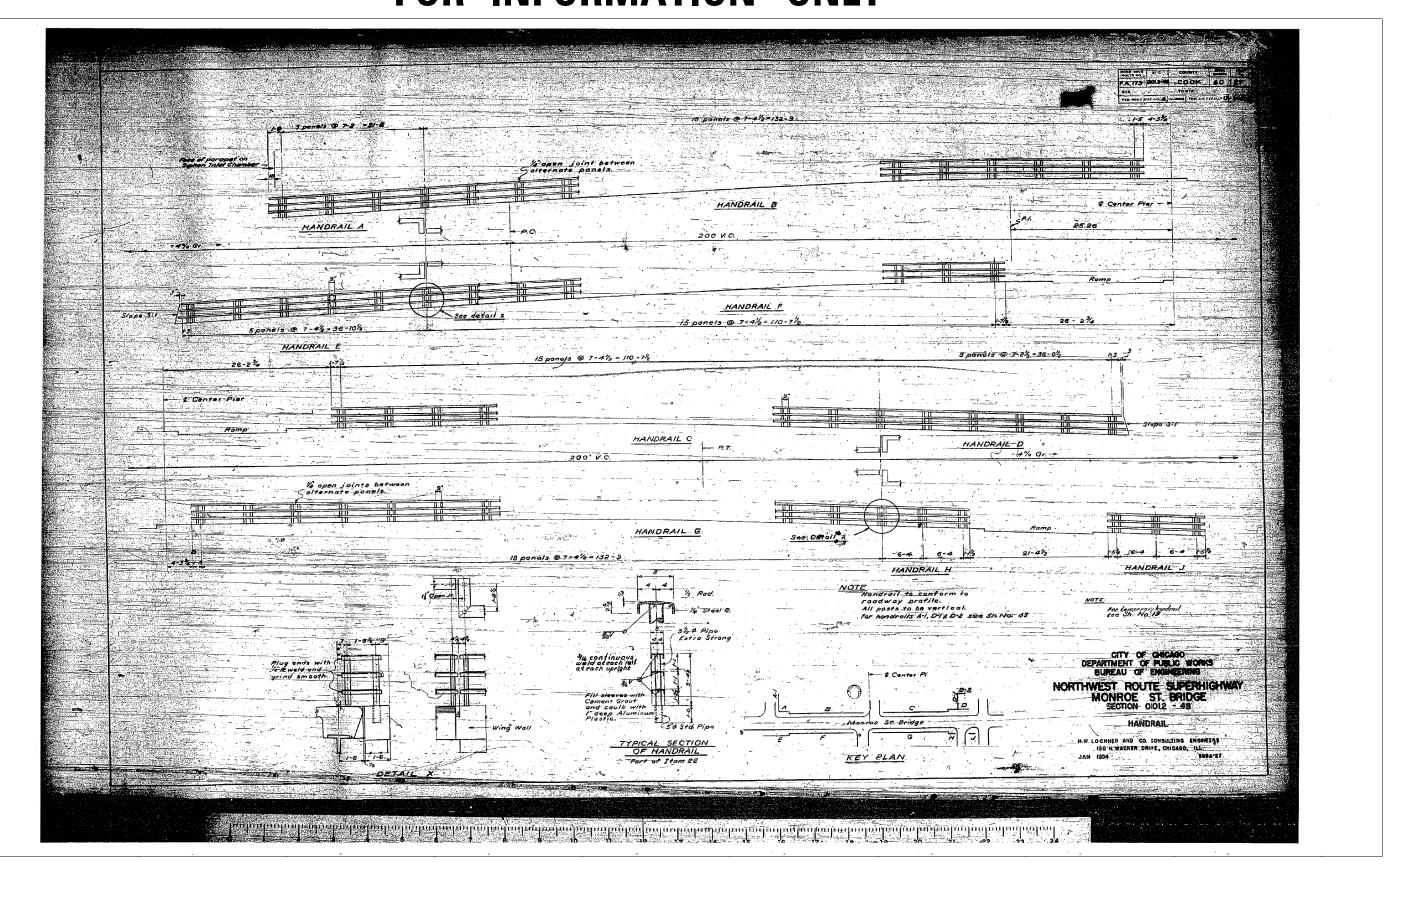


P ARSONS BRINCKERHOFF	USER NAME = poteld PLOT SCALE = N.T.S.	DESIGNED - CHECKED - DRAWN - DCP	REVISED - REVISED - REVISED -	STATE OF ILLINOIS DEPARTMENT OF TRANSPORTATION	EXISTING PLANS STRUCTURE NO. 016-
	PLOT DATE = 5/15/2017	CHECKED - JIG	REVISED -		SHEET NO. 80 OF 87 SHE

LANS	F.A.I. RTE.	SECTION	COUNTY	TOTAL SHEETS	SHEET NO.
016–2054	90/94	2014-016R&B	СООК	378	292
010-2037			CONTRACT	NO. 6	0X95
37 SHEETS		ILLINOIS FED. AI	D PROJECT		

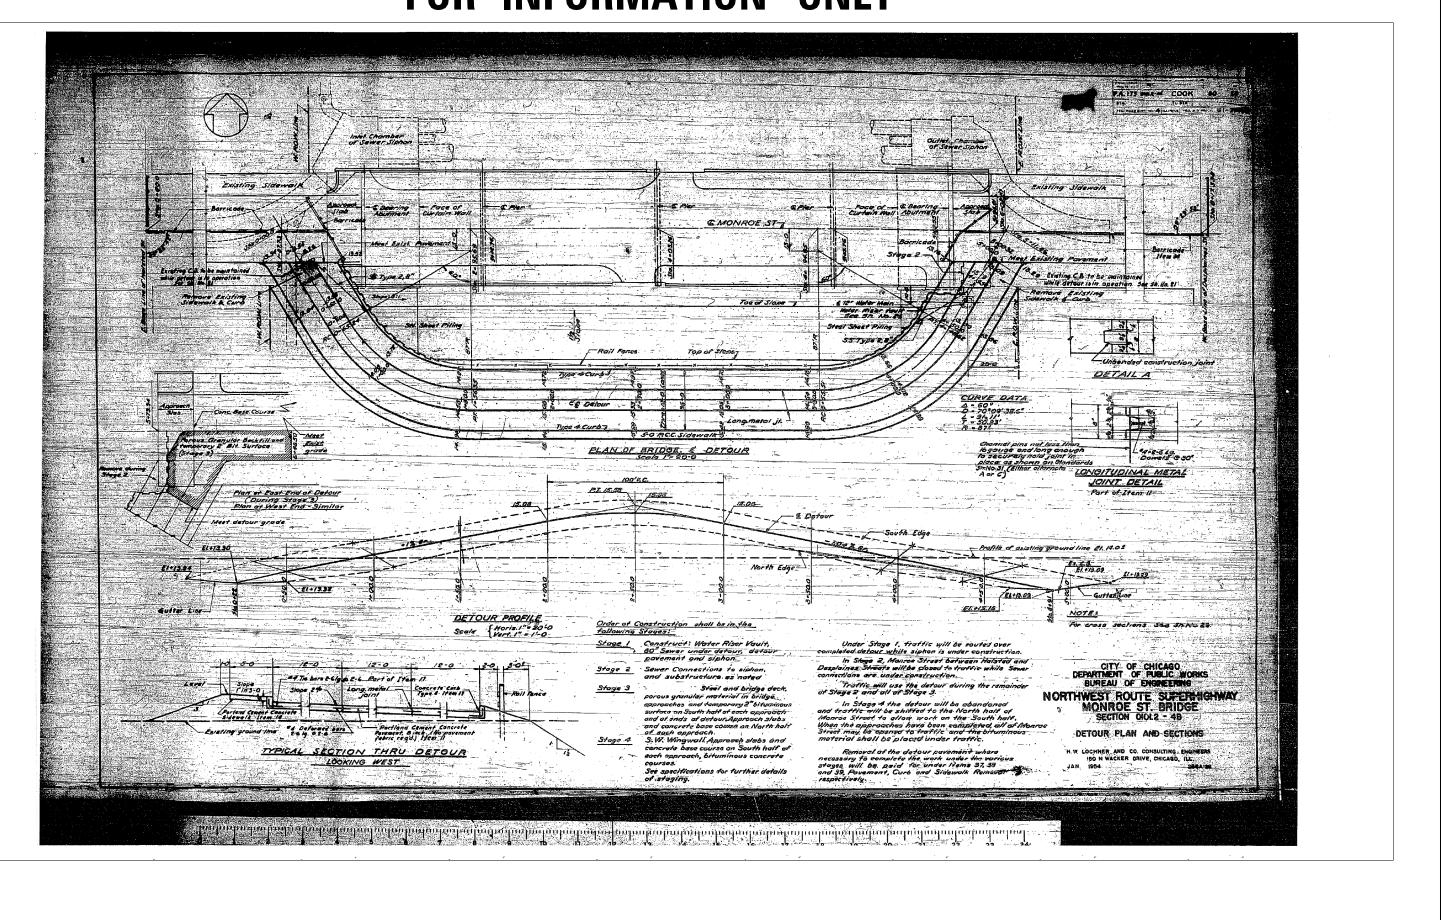


PARSONS BRINCKERHOFF	USER NAME = Dateid PLOT SCALE = N.T.S.	DESIGNED - CHECKED - DRAWN - DCP	REVISED - REVISED - REVISED -	STATE OF ILLINOIS DEPARTMENT OF TRANSPORTATION	EXISTING PLANS Structure NO. 016-
	PLOT DATE = 5/15/2017	CHECKED - JIG	REVISED -		SHEET NO. 81 OF 87 SHEE

ANS 016–2054	F.A.I. RTE.	SECTION	COUNTY	TOTAL SHEETS	SHEET NO.
016_2054	90/94	2014-016R&B	СООК	378	293
010-2034			CONTRACT	NO. 6	0X95
37 SHEETS		ILLINOIS FED, A	D PROJECT		

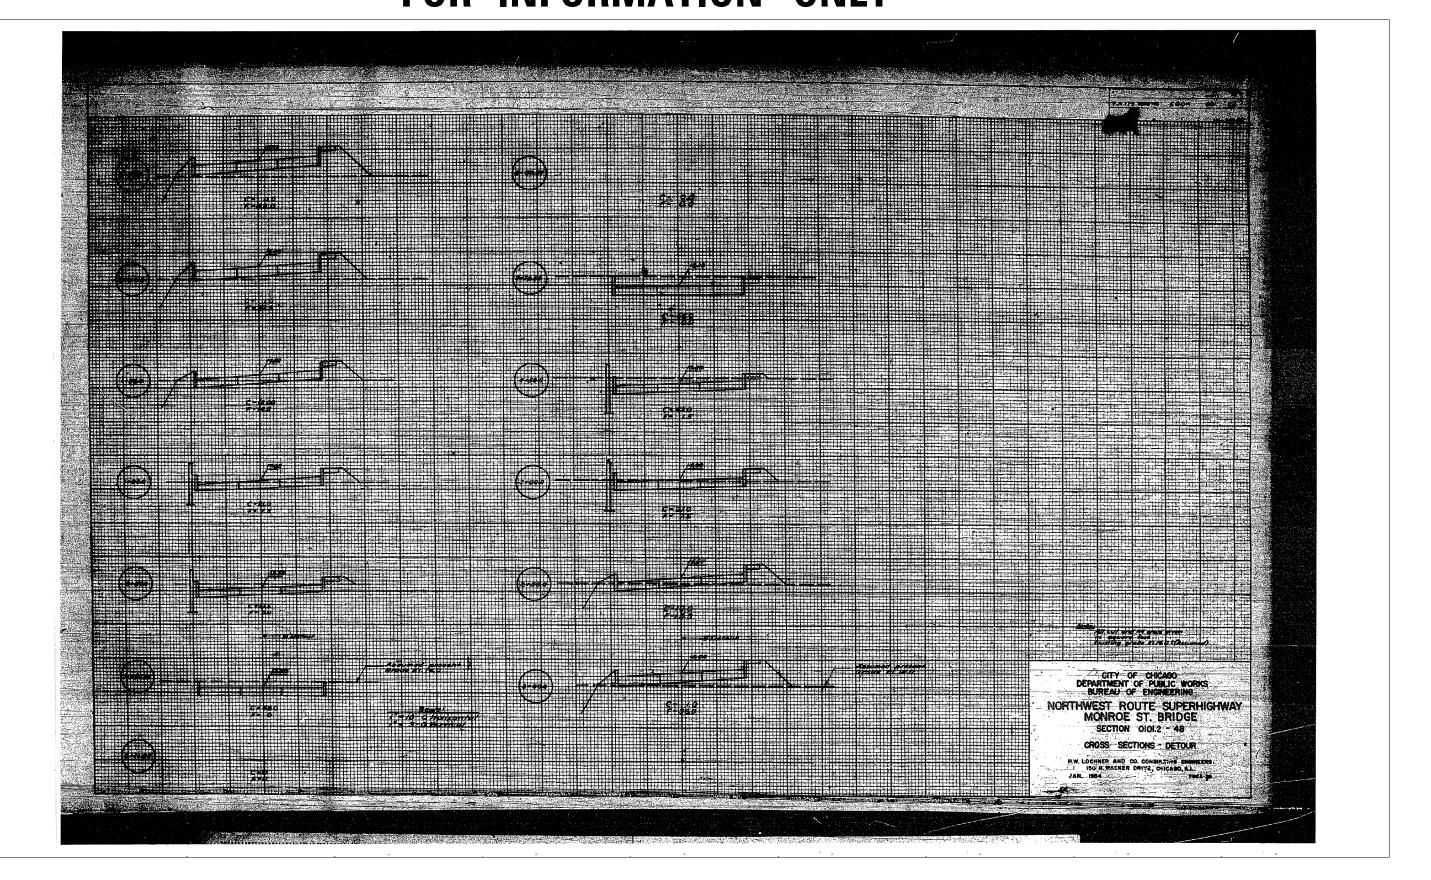

ń L						
ŝ		USER NAME = pateld	DESIGNED -	REVISED -		EXISTING PLANS
5	P ARSONS		CHECKED -	REVISED -	STATE OF ILLINOIS	
5	BRINCKERHOFF	PLOT SCALE = N.T.S.	DRAWN - DCP	REVISED -	DEPARTMENT OF TRANSPORTATION	STRUCTURE NO. 016–2
ġ,	2	PLOT DATE = 5/15/2017	CHECKED - JIG	REVISED -		SHEET NO. 82 OF 87 SHEE


LANS	F.A.I. RTE.	SECTION	COUNTY	TOTAL SHEETS	SHEET NO.
016–2054	90/94	2014-016R&B	COOK	378	294
010-2034			CONTRACT	NO. 6	0X95
B7 SHEETS		ILLINOIS FED. AI	D PROJECT		

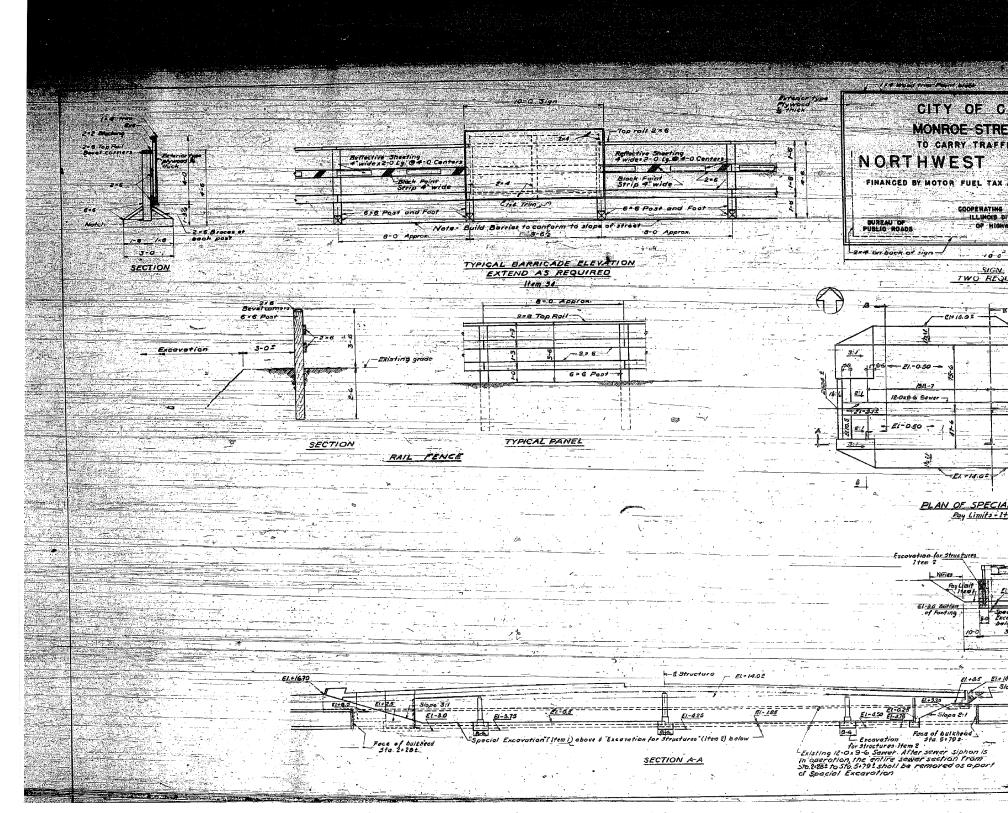

P ARSONS BRINCK ER HOFF	USER NAME = pateld PLOT SCALE = N.T.S.	DESIGNED - CHECKED - DRAWN - DCP	REVISED - REVISED - REVISED -	STATE OF ILLINOIS DEPARTMENT OF TRANSPORTATION	EXISTING PLANS STRUCTURE NO. 016-
	PLOT DATE = 5/15/2017	CHECKED - JIG	REVISED -		SHEET NO. 83 OF 87 SHE


HICAGO				
EXPRESSU	0K/			
EBICHES)		[1] (s - [1]) 		
	ground to be "Whi lack "except where ted Wood trim to b	te and Allock:		
The of slope				
El-1.25				
El-1,26				
ETOP of slope				
EXCAVATION T Existing 12-0x 9-6 set Semer Siphon Is in Semer Siphon Is in Semoros Si	inier to be moin operolion	ligin sd Until		
<u></u>	Consolidated Part of Jiam 3	1 Ground Lot Accenting		
d Excordinan above and dian fat Siruciutes this lipe 6	Co Co			
	JTE SUPER ST. BRIDG	HIGHWAY		
SECTION SPECIAL EXC BARRICADE &	OICI.2 - 48 AVATION LIMP MISCL. DETAI	IS LS		
JAN. INN		56 /-30		

ANS 016–2054	F.A.I. RTE.	SECTION	COUNTY	TOTAL SHEETS	SHEET NO.
016_2054	90/94	2014-016R&B	СООК	378	295
010-2037			CONTRACT	NO. 6	0X95
7 SHEETS		ILLINOIS FED. AI	D PROJECT		

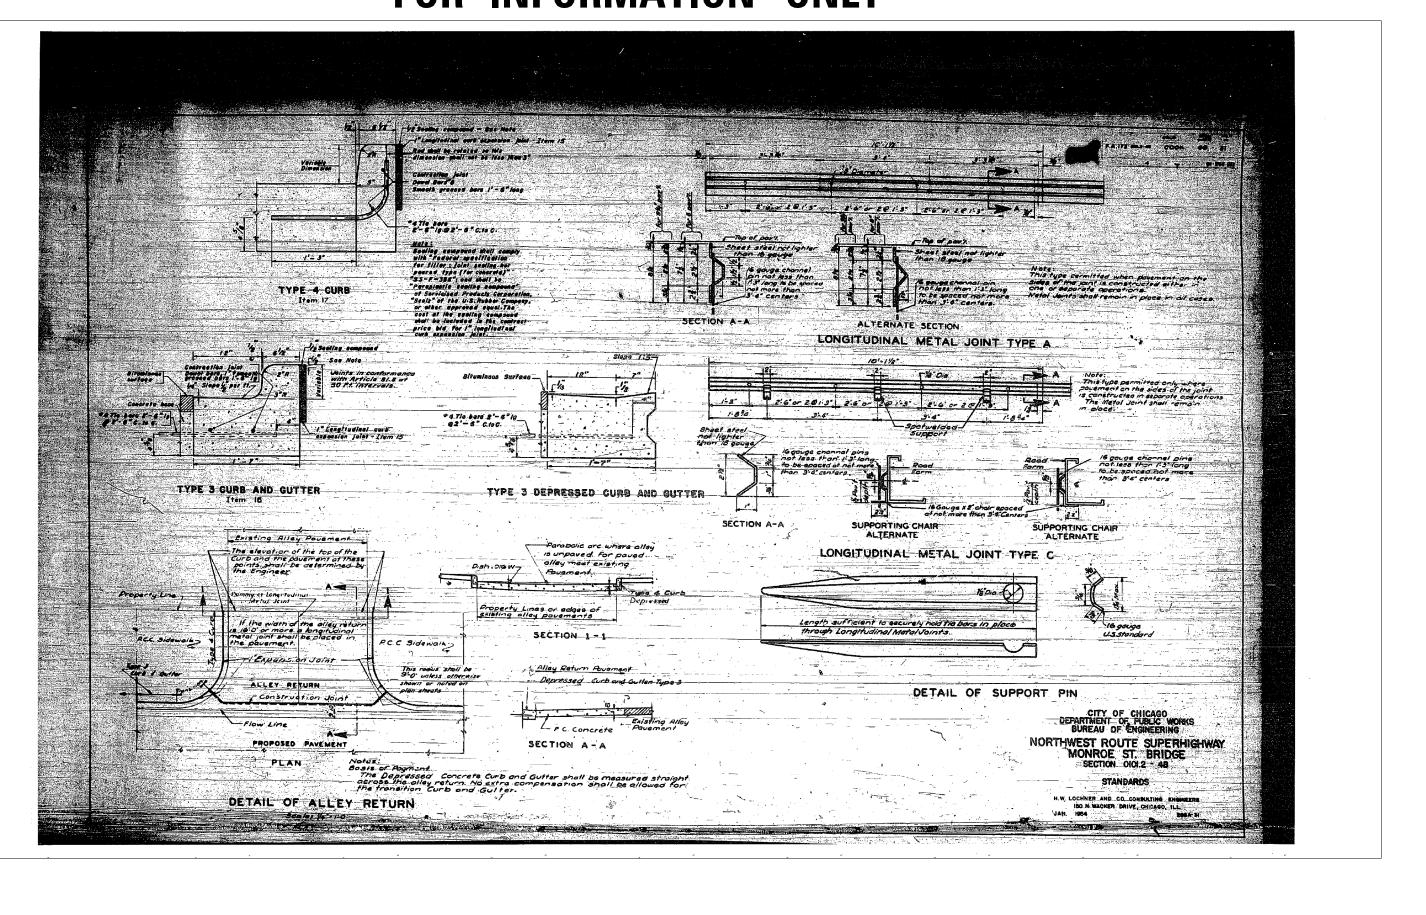


ת				-		
5		USER NAME = pateld	DESIGNED -	REVISED -		EXISTING PLANS
ŝ	PARSONS		CHECKED -	REVISED -	STATE OF ILLINOIS	
ē.	BRINCKERHOFF	PLOT SCALE = N.T.S.	DRAWN - DCP	REVISED -	DEPARTMENT OF TRANSPORTATION	STRUCTURE NO. 016-
910		PLOT DATE = 5/15/2017	CHECKED - JIG	REVISED -		SHEET NO. 84 OF 87 SHE
						/

LANS	F.A.I. RTE.	SECTION	COUNTY	TOTAL SHEETS	SHEET NO.
016–2054	90/94	2014-016R&B	COOK	378	296
010-2034			CONTRACT	NO. 6	0X95
7 SHEETS		ILLINOIS FED. AI	D PROJECT		

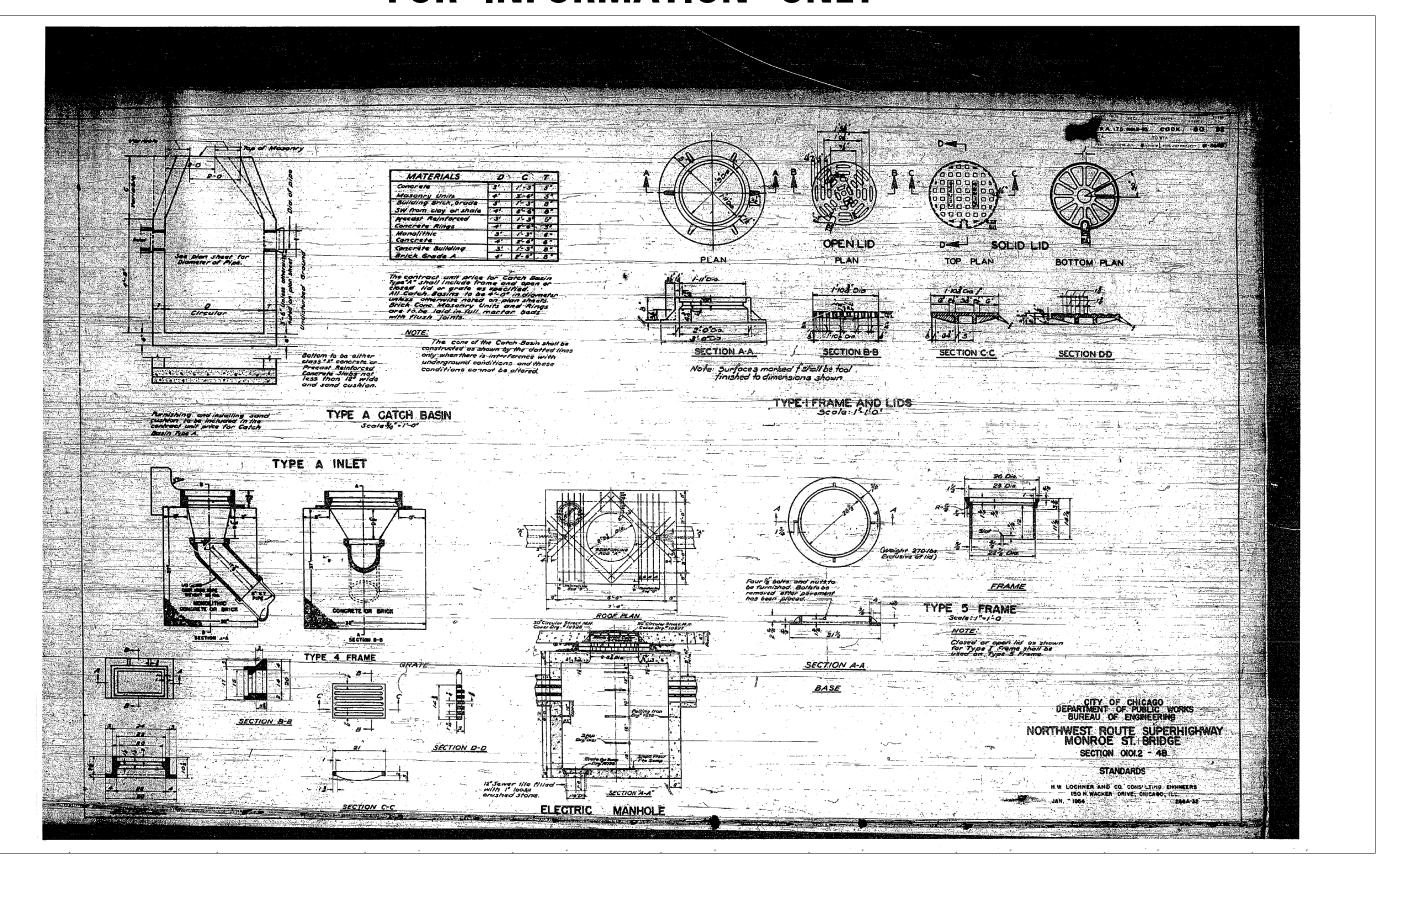


	PARSONS	USER NAME = pateld	DESIGNED - CHECKED -	REVISED - REVISED -	STATE OF ILLINOIS	EXISTING PLANS
2	BRINCKERHOFF	PLOT SCALE = N.T.S.	DRAWN - DCP	REVISED -	DEPARTMENT OF TRANSPORTATION	STRUCTURE NO. 016-
		PLOT DATE = 5/15/2017	CHECKED - JIG	REVISED -		SHEET NO. 85 OF 87 SHE

LANS 016–2054	F.A.I. RTE.	SECTION	COUNTY	TOTAL SHEETS	SHEET NO.
016_2054	90/94	2014-016R&B	COOK	378	297
010-2034			CONTRACT	NO. 6	0X95
7 SHEETS		ILLINOIS FED. AI	D PROJECT		

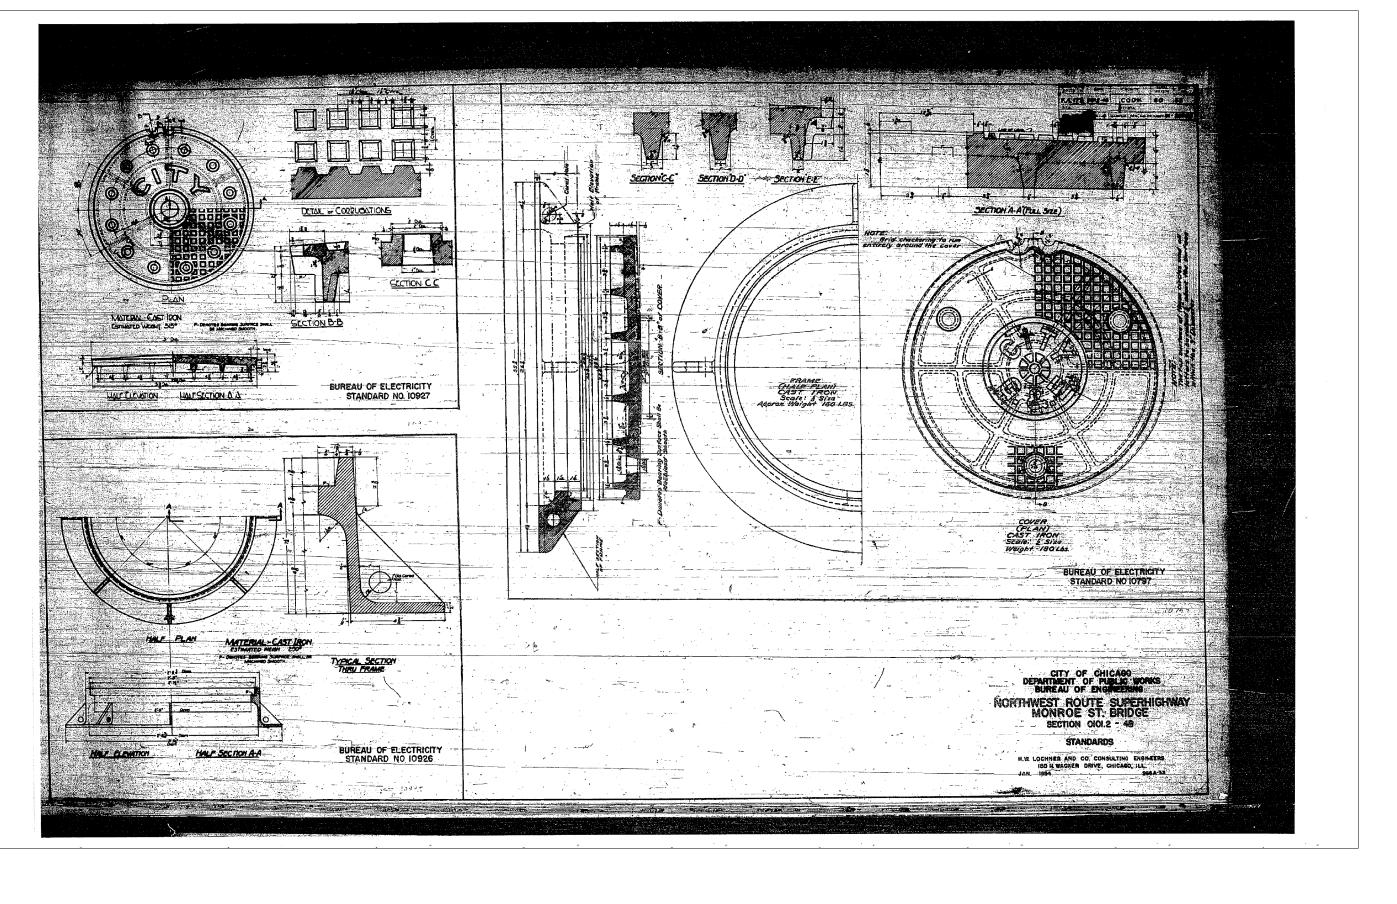


P ARSONS BRINCKERHOFF	USER NAME = pateld PLOT SCALE = N.T.S.	DESIGNED - CHECKED - DRAWN - DCP	REVISED - REVISED - REVISED -	STATE OF ILLINOIS DEPARTMENT OF TRANSPORTATION	EXISTING PLANS STRUCTURE NO. 016-
	PLOT DATE = 5/15/2017	CHECKED - JIG	REVISED -		SHEET NO. 86 OF 87 SHE

LANS	F.A.I. RTE.	SECTION	COUNTY	TOTAL SHEETS	SHEET NO.
016–2054	90/94	2014-016R&B	COOK	378	298
010-2034			CONTRACT	NO. 6	0X95
B7 SHEETS		ILLINOIS FED. AI	D PROJECT		

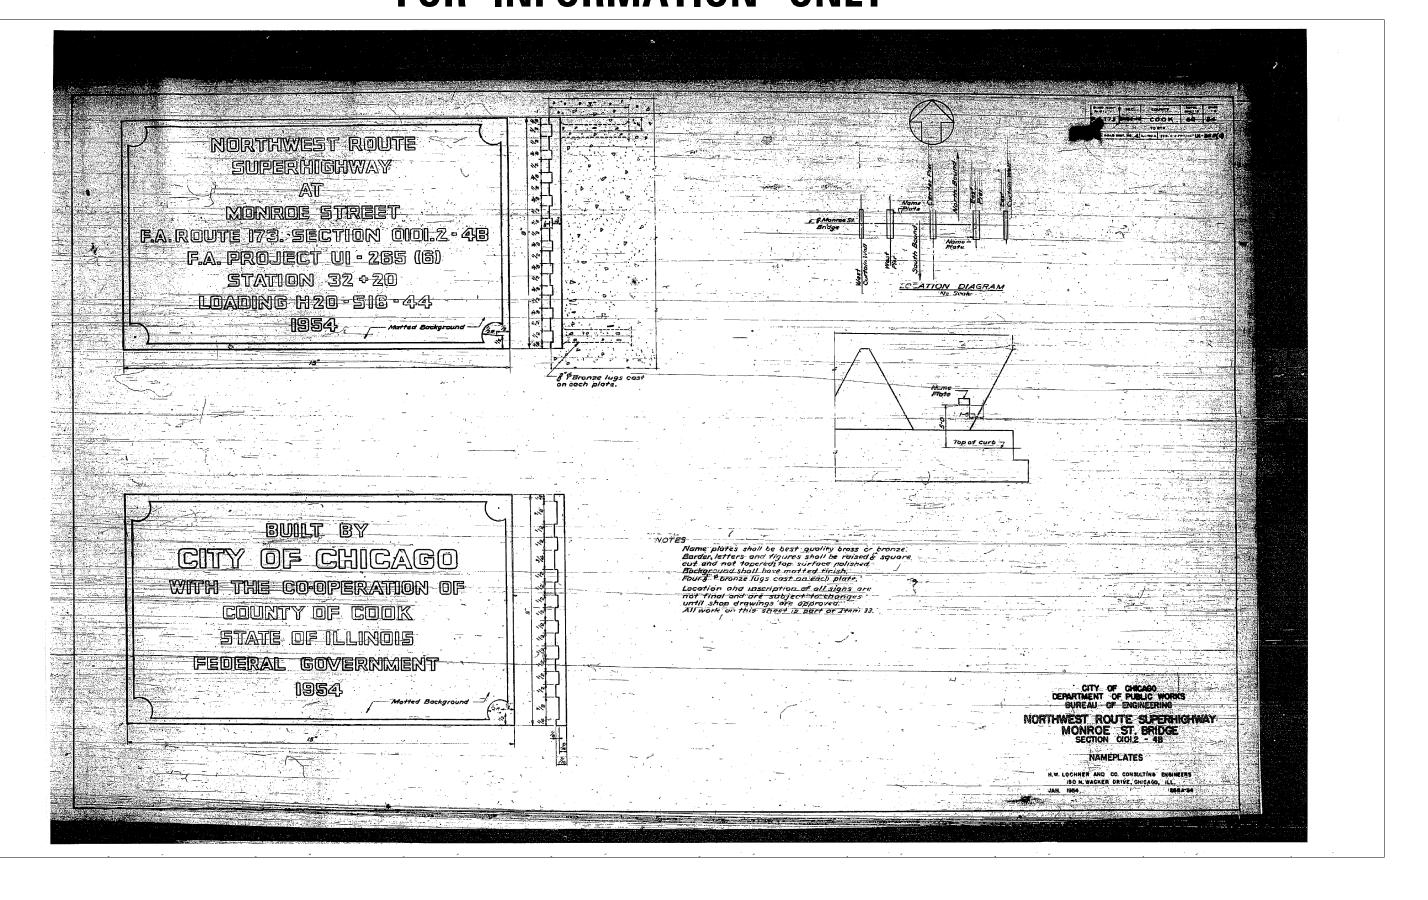

	PARSONS BRINCKERHOFF	USER NAME = pateid PLOT SCALE = N.T.S.	DESIGNED - CHECKED - DRAWN - DCP	REVISED - REVISED - REVISED -	STATE OF ILLINOIS DEPARTMENT OF TRANSPORTATION	EXISTING PLANS STRUCTURE NO.016-
Ľ	DHINCKENHOFF	PLOT DATE = 5/15/2017	CHECKED - JIG	REVISED -		SHEET NO. 87 OF 87 SHE

LANS	F.A.I. RTE.	SECTION	COUNTY	TOTAL SHEETS	SHEET NO.	
016-2054	90/94	2014-016R&B	СООК	378	299	
010-2037	1		CONTRACT	NO. 6	0X95	
37 SHEETS	ILLINOIS FED. AID PROJECT					

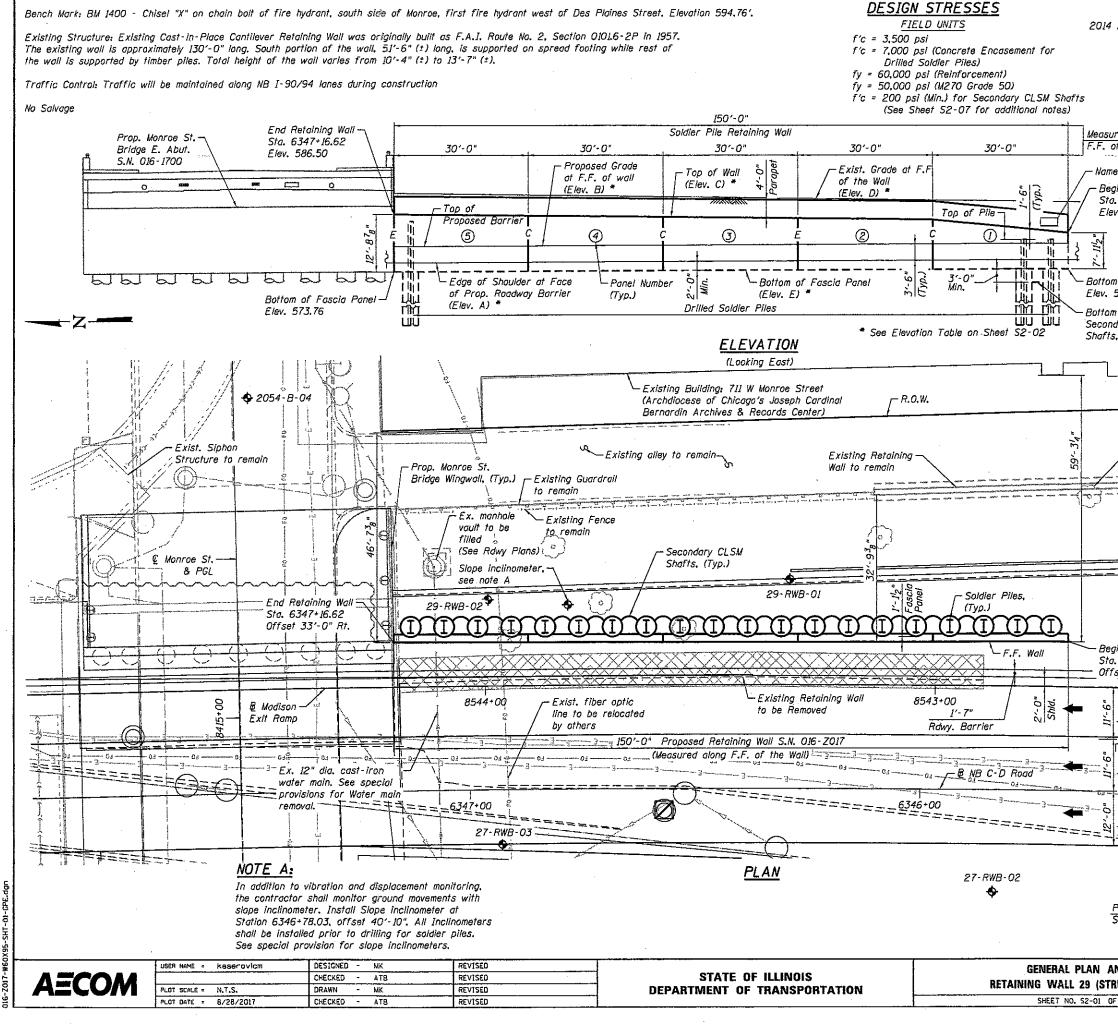

LEGEND:
Combined Sewer —<
Existing Storm Sewer
Electric — E
Soil Boring Location 🛛 🔶
Existing Fence
Fiber Optic F0
Existing Catch Basin O
C = Construction Joint
E = Expansion Joint
F.F denotes Front Face B.F denotes Back Face
y Only
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SALCTURA S
Amith T. Bhatt
LICENSE EXPIRES 11 /30 /2018

ure contract)
l offsets are measured along Road.
uilt along straight chords between joints.
ns for Drainage Structure to Pipe connection details.
ction Sequence, see Sheet S2-02.
RAL PLAN & ELEVATION
RETAINING WALL 29
F.A.I. RTE. 90/94
<u>SECTION 2014-016R&B</u> COOK COUNTY
<u>STA. 6345+67.55</u>
TO STA. 6347+16.62
<u>TO STA. 6347+16.62</u> RUCTURE NO. 016-Z017
TO STA. 6347+16.62