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11/18/2022 LETTING ITEM 081

HIGHWAY STANDARDS

DISTRICT 1 DETAILS SEE SHEET 2 FOR LIST OF DISTRICT 1 DETAILS

SEE SHEET 2 FOR LIST OF HIGHWAY STANDARDS

CITY OF NAPERVILLE DETAILS SEE SHEET 2 FOR LIST OF NAPERVILLE DETAILS STATE OF ILLINOIS

DEPARTMENT OF TRANSPORTATION **DIVISION OF HIGHWAYS**

PLANS FOR PROPOSED FEDERAL AID HIGHWAY

FAU 2552 (WASHINGTON STREET)
FROM FAU 1522 (AURORA AVENUE) TO FAU 1487 (CHICAGO AVENUE)
ROADWAY AND BRIDGE RECONSTRUCTION


SECTION NO.: 16-00167-00-BR PROJECT No.: 772J(145)

CITY OF NAPERVILLE **DUPAGE COUNTY**

EXISTING S.N. 022-0030 PROPOSED S.N. 022-6749 POST-TENSIONED CAST-IN-PLACE SUPERSTRUCTURE ON NEW

C-91-265-16



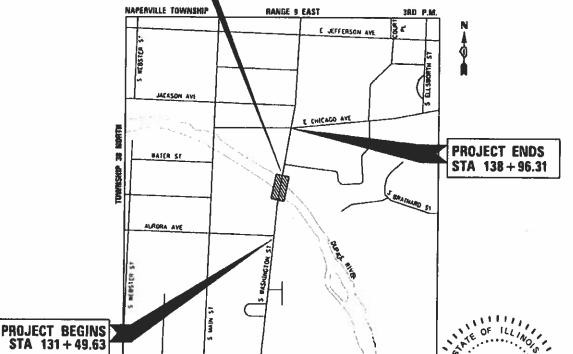

LOCATION MAP

PROJECT LENGTH

NET AND GROSS LENGTH = 323.4 FT. = 0.061 MILES

WASHINGTON STREET:

DATE: 8/8/2022 SEAL EXPIRES: 11/30/2023

SAUTER

081-006844

SEAL EXPIRES: 11/30/2022

PROJECT P-91-285-18

16-00167-00-BR

DUPAGE 261 1

2552





CìorbaGroup

DECIGN FIRM DECICED ATION MINNESS 184,001016

8725 W. Higgins Road, Suite 600 | Chicago, IL 60631 P 773,775,4009 | www.clorba.com

DESIGN DESIGNATION

DESIGN SPEED = 30 MPH POSTED SPEED = 25 MPH

TRAFFIC FACTOR - 4.10(PCC-20)

WASHINGTON STREET:
FUNCTIONAL CLASS = MINOR ARTERIAL
ADT (2016) = 22,300
ADT (2040) = 32,500

FULL SIZE PLANS HAVE BEEN PREPARED USING STANDARD ENGINEERING SCALES. REDUCED SIZED PLANS WILL NOT CONFORM TO STANDARD SCALES. IN MAKING MEASUREMENTS ON REDUCED PLANS, THE ABOVE SCALES MAY BE USED.

JOINT UTILITY LOCATION INFORMATION FOR EXCAVATION 1-800-892-0123 OR 811

TIMOTHY (KING 57-0G0931 STATE OF ILLINOIS DEPARTMENT OF TRANSPORTATION DATE, 8/8/2022 SEAL EXPIRES: 8/31/2022 062-056649 LICENSED PROFESSIONAL ENGINEER QF

PASSED SEPT.

CITY OF NAPERVILLE DEPUTY CITY ENGINEER

DISTRICT 1 ENGINEER OF LOCAL ROADS & STREETS

CONTRACT NO. 61G82

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LIST OF IDOT HIGHWAY STANDARDS

000001-08	STANDARD SYMBOLS, ABBREVIATIONS AND PATTERNS
001001-02	AREAS OF REINFORCÉMENT BARS
001006	DECIMAL OF AN INCH AND OF A FOOT
280001-07	TEMPORARY EROSION CONTROL SYSTEMS
353001-05	PCC BASE COURSE WITH HMA BINDER AND SURFACE COURSES
420001-10	PAVEMENT JOINTS
420111-04	PCC PAVEMENT ROUNDOUTS
420401-13	PAVEMENT CONNECTOR (PCC) FOR BRIDGE APPROACH SLAB
420701-03	PAVEMENT WELDED WIRE REINFORCEMENT
424001-11	PERPENDICULAR CURB RAMPS FOR SIDEWALKS
424011-04	CORNER PARALLEL CURB RAMPS FOR SIDEWALKS
424016-05	MID-BLOCK CURB RAMPS FOR SIDEWALKS
424021-06	DEPRESSED CORNER FOR SIDEWALKS
442201-03	CLASS C AND D PATCHES
515001-04	NAME PLATE FOR BRIDGES
601001-05	PIPE UNDERDRAINS
602001-02	CATCH BASIN - TYPE A
602301-04	INLET - TYPE A
602402-03	PRECAST MANHOLE, TYPE A, 5' (1.52m) DIAMETER
602406-11	PRECAST MANHOLE, TYPE A, 6' (1.83m) DIAMETER
602416-09	PRECAST MANHOLE, TYPE A, 8' (2.44m) DIAMETER
604001-05	FRAME AND LIDS TYPE 1
604041-03	FRAME AND GRATE TYPE 9
604051-04	FRAME AND GRATE TYPE 11
606001-08	CONCRETE CURB TYPE B AND COMBINATION CONCRETE CURB AND GUTTER
630001-12	STEEL PLATE BEAM GUARDRAIL
641006-01	SIGHT SCREEN WOOD PLANK FENCE TYPE P
664001-02	CHAIN LINK FENCE
701006-05	OFF-RD OPERATIONS, 2L, 2W, 15' TO 24" FROM PAVEMENT EDGE
701101-05	OFF-RD OPERATIONS, MULTILANE, 15' TO 24" FROM PAVEMENT EDGE
701301-04	LANE CLOSURE, 2L, 2W, SHORT TIME OPERATIONS
701311-03	LANE CLOSURE 2L, 2W MOVING OPERATIONS - DAY ONLY
701427-05	LANE CLOSURE, MULTILANE, INTERMITTENT OR MOVING OPER., FOR SPEEDS <= 40 MPH
701501-06	URBAN LANE CLOSURE, 2L, 2W, UNDIVIDED
701602-10	URBAN LANE CLOSURE, MULTILANE, 2W WITH BIDIRECTIONAL LEFT TURN LANE
701611-01	URBAN HALF ROAD CLOSURE, MULTILANE, 2W WITH MOUNTABLE MEDIAN
701701-10	URBAN LANE CLOSURE, MULTILANE INTERSECTION
701801-06	SIDEWALK, CORNER OR CROSSWALK CLOSURE
701901-08	TRAFFIC CONTROL DEVICES
704001-08	TEMPORARY CONCRETE BARRIER
782006-01	GUARDRAIL AND BARRIER WALL REFLECTOR MOUNTING DETAILS
814001-03	HANDHOLES
857001-01	STANDARD PHASE DESIGNATION DIAGRAMS AND PHASE SEQUENCES
877001-08	STEEL MAST ARM ASSEMBLY AND POLE 16' THROUGH 55'
877011-10	STEEL COMB. MAST ARM ASSEMBLY AND POLE 16' THROUGH 55'
878001-11	CONCRETE FOUNDATION DETAILS
880006-01	TRAFFIC SIGNAL MOUNTING DETAILS

IDOT DISTRICT 1 DETAILS

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TC-13 TC-14	DISTRICT ONE TYPICAL PAVEMENT MARKINGS TRAFFIC CONTROL AND PROTECTION AT TURN BAYS (TO REMAIN OPEN TO TRAFFIC)
TC-16 TC-22 TC-26 TS-02 TS-05	SHORT TERM PAVEMENT MARKING LETTERS AND SYMBOLS ARTERIAL ROAD INFORMATION SIGN DRIVEWAY ENTRACE SIGNING DISTRICT ONE MAST ARM MOUNTED STREET NAME SIGNS DISTRICT ONE STANDARD TRAFFIC SIGNAL DESIGN DETAILS

CITY OF NAPERVILLE DETAILS

	90.01	STORM MANHOLE - TYPE A CATCH BASIN - TYPE A
	90.05	INLET - TYPE A
	90.20	STORM SEWER TRENCH SECTION IN PAVED AREA
	90.01	SANITARY SEWER MANHOLE
	90.06	SANITARY MANHOLE FRAME & COVER
	90.10	TRENCH SECTION FOR PVC PIPE
	90.23	SANITARY SEWER CLEANOUT
	90.01	VALVE VAULT
	90.03	VALVE VAULT WITH CAST / DUCTILE IRON SLEEVE PRESSURE TAP VALVE VAULT WITH STAINLESS STEEL SLEEVE PRESSURE TAP VALVE VAULT FRAME & COVER
	90.04	VALVE VACET WITH STAINLESS STEEL SELEVE FIXESSORE TAP
	90.05	VALVE BOX
		HYDRANT
	90.10	WATER MAIN TRENCH SECTION
	90.11	THRUST BLOCK
	90.13	LOWER / ADJUSTING WATER MAIN
	90.15	POLYETHYLENE ENCASEMENT
	90.16	WATER MAIN CASING PIPE
	90.17	
	90.05	TYPICAL COMMERCIAL DRIVEWAY DETAIL
J	30.03	BRICKPRINT CROSSWALK DETAIL
5	90.14	DOWNTOWN STREETSCAPE - PAVEMENT SECTION
	90.15	DOWNTOWN STREETSCAPE - PAVEMENT SECTION DOWNTOWN STREETSCAPE - NARROW < 11' (PLAN)
	90.20	B-6.12 BARRIER CURB AND GUTTER
	90.23	TYPE B BARRIER CURB
	90.32	CURB RAMPS
	90.33	CROSSWALK
	90.06	TRUSS ARM STREET LIGHT DETAIL - 40 FOOT
	90.07	TRUSS ARM STREET LIGHT DETAIL - 40 FOOT TRUSS ARM STREET LIGHT DETAIL - 47.5 FOOT
	90.09	CAGED ACORN STREET LIGHT DETAIL - 10 FOOT (CBD ONLY)
	90.10	SIDE MOUNT STREET LIGHT DETAIL - 30 FOOT (CBD ONLY)
	90.10	LIGHT POLE AND CONTROLLER LABELING DETAIL
	90.12	HELIX TYPE POLE FOUNDATION DETAIL
	90.12	CONCRETE POLE FOUNDATION DETAIL - 18 INCH DIAMETER (CBD ONLY)
	90.14	CONCRETE POLE FOUNDATION DETAIL - 18 INCH DIAMETER (CBD ONLT)
	90.16	TRANSFORMER BASE - 9 INCH
	90.17	CAST IN PLACE CONCRETE HANDHOLE DETAIL
	90.18	COMPOSITE CONCRETE HANDHOLE DETAIL
	90.23	TYPICAL STREET LIGHT CONNECTION
	90.30	TYPICAL STREET LIGHT CONNECTION TYPICAL TRENCH DETAIL
	90.03	TEMPORARY EROSION CONTROL MEASURE - SILT FENCE
,	30.03	TEINI OTANT ENGOIGH GOINTHOL WILAGOINE - SILT I LINGE

ILLINOIS URBAN MANUAL

IUM-561D IUM-617A INLET PROTECTION - PAVED AREAS FLOATING SILT FENCE

USER NAME = Roadway	DESIGNED -	TBH	REVISED -
	DRAWN -	VZ	REVISED -
PLOT SCALE = 2.0000 '/ in.	CHECKED -	DD	REVISED -
PLOT DATE = 8/8/2022	DATE -	8/8/2022	REVISED -

WASHINGTON STREET BRIDGE	F.A.U. RTE	SECTION			COUNTY	TOTAL SHEETS	SHEET NO.
INDEX AND STANDARDS	2552	16-00167-00-BR			DUPAGE	261	2
INDEX AND STANDANDS					CONTRACT	NO. 610	G82
SCALE: N.T.S. SHEET 1 OF 1 SHEETS STA. TO STA.	FED. F	ROAD DIST. NO.	ILLINOIS	FED. AID	PROJECT		

Cìorba Group	ŀ
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GENERAL NOTES

- 1. THE OWNER OR HIS/HER/THEIR REPRESENTATIVE IS RESPONSIBLE TO OBTAIN ANY AND ALL PERMITS REQUIRED BY APPLICABLE GOVERNMENTAL AGENCIES.
- 2. ALL WORK SHALL BE PERFORMED IN ACCORDANCE WITH THE ILLINOIS DEPARTMENT OF TRANSPORTATION'S "STANDARD SPECIFICATIONS FOR ROAD AND BRIDGE CONSTRUCTION" (ADOPTED JANUARY 1, 2022); THE "SUPPLEMENTAL SPECIFICATIONS AND RECURRING SPECIAL PROVISIONS" (ADOPTED JANUARY 1, 2022); THE LATEST EDITION OF THE "ILLINOIS MANUAL ON UNIFORM TRAFFIC CONTROL DEVICES FOR STREETS, THE DETAILS" ON THE PLANS AND THE "SPECIAL PROVISIONS" INCLUDED IN THE CONTRACT DOCUMENTS. ANY REFERENCE TO STANDARDS THROUGHOUT THE PLANS OR SPECIAL PROVISIONS SHALL BE INTERPRETED AS THE LATEST STANDARD OF THE ILLINOIS DEPARTMENT OF TRANSPORTATION.
- ALL CONTRACTORS DOING WORK IN THE PUBLIC RIGHT-OF-WAY MUST BE LICENSED (WHEN APPLICABLE) TO MAKE PUBLIC IMPROVEMENTS WITHIN THE NAPERVILLE CORPORATE LIMITS.
- THE CONTRACTOR/DEVELOPER ASSUMES ALL RESPONSIBILITY AND LIABILITY FOR ANY ACTION RESULTING FROM THEIR WORK WITHIN THE PUBLIC RIGHT-OF-WAY.
- 5. THE CONTRACTOR/DEVELOPER SHALL INDEMNIFY AND HOLD HARMLESS THE CITY OF NAPERVILLE. PRIOR TO COMMENCEMENT OF ANY OFF-SITE CONSTRUCTION, THE CONTRACTOR SHALL SECURE WRITTEN AUTHORIZATION THAT ALL OFF-SITE EASEMENTS HAVE BEEN SECURED AND THAT PERMISSION HAS BEEN GRANTED TO ENTER ONTO PRIVATE PROPERTY.
- 6. A MINIMUM OF 48 HOURS NOTICE SHALL BE GIVEN TO THE CITY OF NAPERVILLE TED BUSINESS GROUP (630-420-6082) PRIOR TO STARTING WORK OR RESTARTING WORK AFTER SOME ABSENCE OF WORK FOR ANY REASON.
- 7. IT SHALL BE THE CONTRACTOR'S RESPONSIBILITY TO ADEQUATELY IDENTIFY AND LOCATE ALL EXISTING UTILITIES PRIOR TO EXCAVATION. BEFORE STARTING CONSTRUCTION, THE CONTRACTOR SHALL CONTACT JULIE FOR THE LOCATION OF ANY AND ALL UTILITIES. THE TOLL-FREE NUMBER IS 800-892- 0123. IT IS THE RESPONSIBILITY OF THE CONTRACTOR TO LOCATE ANY PRIVATE FACILITIES OR NON-JULIE MEMBER FACILITIES.
- 8. THE CONTRACTOR CAN SCHEDULE ALL NECESSARY SITE INSPECTIONS WITH THE CITY OF NAPERVILLE BY CALLING (630) 420-6082 BETWEEN THE HOURS OF 8:00AM AND 4:00PM (CLOSED 1:00PM TO 2:00PM DAILY) ON WEEKDAYS WHEN THE CITY IS OPEN FOR BUSINESS. THE CONTRACTOR WILL BE REQUIRED TO PROVIDE THE SITE PERMIT NUMBER FOR THE PROJECT IN ORDER TO SCHEDULE THE INSPECTION(S).
- RECORD DRAWINGS ARE REQUIRED TO BE SUBMITTED AND APPROVED BY THE ENGINEER AS COORDINATED WITH THE CITY OF NAPERVILLE PRIOR TO FINAL OCCUPANCY BEING GRANTED.
- 10. THE LOCATION AND ELEVATIONS OF THE UNDERGROUND UTILITIES AS SHOWN ON THE PLANS ARE NOT TO BE TAKEN AS EXACT. THE CONTRACTOR SHALL USE SPECIAL CARE WHEN CONDUCTING CONSTRUCTION OPERATIONS NEAR THEM TO PREVENT DAMAGE.
- 11. EXISTING STREET SIGNS AND TRAFFIC SIGNS THAT ARE WITHIN THE CONSTRUCTION LIMITS SHALL BE REMOVED AND RESET BY THE CONTRACTOR IN ACCORDANCE WITH ARTICLE 107.25
- 12. ALL CONSTRUCTION MATERIALS WITHIN THE CITY RIGHT-OF-WAY MUST BE IDOT CERTIFIED. DOCUMENTATION OF MATERIAL CERTIFICATIONS SHALL BE SUBMITTED TO THE ENGINEER FOR APPROVAL. ALL CONSTRUCTION MATERIAL NEEDING INSPECTION SHALL BE DONE ACCORDING TO THE LATEST IDOT PROJECT AND PROCEDURES GUIDE.
- 13. THE CONTRACTOR SHALL PROVIDE THE ENGINEER A LIST OF MATERIALS USED AND IDENTIFY THEIR ASSOCIATED IDOT CERTIFICATION, A COPY OF ALL MATERIAL TESTING COMPANY RESULTS, AND A WEEKLY FIELD REPORT UTILIZING THE APPROPRIATE IDOT FORM.
- 14. ALL COORDINATES SHOWN REFER TO THE ILLINOIS STATE PLANE COORDINATE SYSTEM(EAST ZONE) BASED ON THE NAD 83 (2007 ADJUSTMENT) HORIZONTAL DATUM. THE ORTHOMETRIC HEIGHTS SHOWN REFLECT THE NAVD88.
- 15. THE CONTRACTOR SHALL MAINTAIN THE SITE IN A CLEAN AND ORDERLY MANNER.

 DEBRIS AND ANY SURPLUS MATERIAL SHALL BE REMOVED AND RESTORATION SHALL PROCEED
 AS WORK PROCEEDS. IF THE ENGINEER SO DIRECTS, THE CONTRACTOR SHALL STOP ALL
 OTHER WORK AND CONCENTRATE ON CLEAN-UP AND RESTORATION. DEBRIS AND SURPLUS
 MATERIAL SHALL BE DISPOSED OF BY THE CONTRACTOR OFF-SITE. ANY DAMAGE CAUSED BY
 THE CONTRACTOR TO EXISTING PAVEMENT, CURB & GUTTER, AND SIDEWALK NOT SHOWN AS
 REMOVED OR WORKED ON DURING CONSTRUCTION SHALL BE REPAIRED AND REPLACED.
- 16. THE CONTRACTOR WILL NOT BE ALLOWED TO SET UP A YARD OR FIELD OFFICE ON CITY PROPERTY WITHOUT WRITTEN PERMISSION FROM THE CITY.
- 17. EXCAVATION AND PAVEMENT WIDENING ON BOTH SIDES OF THE PAVEMENT AT ANY ONE LOCATION AT THE SAME TIME WILL NOT BE PERMITTED PER ATICLE 701.08 OF THE IDOT SPECS.
- 18. ALL COMPENSATORY STORAGE SHOULD BE OPERATIONAL PRIOR TO PLACEMENT OF FILL, STRUCTURES, OR OTHER MATERIALS IN THE REGULATORY FLOOD PLAIN. GRADING IN FLOODPLAIN AREAS SHALL BE DONE IN SUCH A MANNER THAT THE EXISTING FLOOD PLAIN STORAGE IS MAINTAINED AT ALL TIMES.

- 19. THE CONTRACTOR SHALL THOROUGHLY DOCUMENT EXISTING CONDITIONS PRIOR TO THE START OF CONSTRUCTION VIA VIDEO RECORDING.
- 20. THE AGGREGATE GRADATION FOR THE AGGREGATE SUBGRADE IMPROVEMENT 12" LOWER LIFT SHALL BE CS 1 OR RR 1.
- THE SUBGRADE STABILITY SHALL BE VERIFIED BY PROOF ROLLING WITH A FULLY LOADED TANDEM-AXLE TRUCK.
- 22. AGGREGATE SUBGRADE IMPROVEMENT (CU YD) HAS BEEN PROVIDED FOR USE AT THE LOCATIONS INDICATED FOR SOILS THAT TEND TO BE UNSTABLE AND/OR UNSUITABLE. THE ACTUAL NEED FOR REMOVAL AND REPLACEMENT WITH ASI WILL BE DETERMINED IN THE FIELD AT THE TIME OF CONSTRUCTION BY THE GEOTECHNICAL ENGINEER. ALL POTENTIALLY UNSTABLE SOILS SHOULD BE TESTED WITH A STATIC OR DYNAMIC CONE PENETROMETER AND TREATED IN ACCORDANCE WITH ARTICLE 301.04 OF THE SSRBC AND IDOT SUBGRADE STABILITY MANUAL. IF UNSTABLE AND/OR UNSUITABLE SOILS ARE NOT ENCOUNTERED, THEN THE QUANTITY SHALL BE DEDUCTED, AND NO ADDITIONAL COMPENSATION WILL BE DUE TO THE CONTRACTOR.
- 23. ANY AGGREGATE SUBGRADE IMPROVEMENT CONTAMINATED AND/OR DAMAGED BY THE CONTRACTOR'S VEHICLES AND/OR EQUIPMENTS IS TO BE REMOVED AND REPLACED AS DIRECT BY THE ENGINEER AT CONTRACTOR EXPENSE.
- 24. PIPE UNDERDRAINS SHALL BE INSTALLED ACCORDING TO SECTION 601 OF THE SSRBC AND STANDARD 601001-05. TOP OF PIPE UNDERDRAINS SHALL BE PLACED MINIMUM 6"BELOW THE AGGREGATE SUBGRADE IMPROVEMENT LAYER. THE COST OF MAKING PIPE UNDERDRAINS CONNECTIONS TO DRAINAGE STRUCTURES SHALL BE INCLUDED IN THE COST OF THE PIPE UNDERDRAINS
- 25. BACKFILLING STORM SEWER CONSTRUCTED UNDER THE ROADWAY SPECIFIED UNDER ART. 550.07(b, c) OF THE SSRBC WILL NOT BE ALLOWED.

STORM SEWER NOTES

- NO CONNECTION TO AN EXISTING PUBLIC STORM SEWER MAY BE MADE WITHOUT PERMISSION OF THE CITY ENGINEER.
- 2. THE CONTRACTOR SHALL REPAIR ANY EXISTING FIELD DRAINAGE TILE DAMAGED DURING CONSTRUCTION AND PROPERLY REROUTE AND/OR CONNECT SAID TILE TO THE NEAREST STORM SEWER OUTLET. ALL LOCATIONS OF ENCOUNTERED FIELD DRAINAGE TILE SHALL BE PROPERLY INDICATED ON THE CONTRACTOR'S RECORD DRAWINGS.
- 3. THE FOLLOWING MATERIALS ARE PERMITTED FOR STORM SEWER AND PIPE CULVERTS. WHERE A PARTICULAR MATERIAL IS SPECIFIED IN THE PLANS OR SPECIAL PROVISIONS, NO OTHER KIND OF MATERIAL WILL BE PERMITTED:

REINFORCED CONCRETE PIPE (RCP) - REINFORCED CONCRETE PIPE SHALL CONFORM TO ASTM DESIGNATION C 76, CLASSES I, II, III, IV OR V. BITUMINOUS JOINTS SHALL CONFORM TO ASTM DESIGNATIONS C 14 OR C 76 AS MAY BE APPLICABLE. BITUMINOUS MATERIAL SHALL CONSIST OF A HOMOGENEOUS BLEND OF BITUMEN, INERT FILLER, AND SUITABLE SOLVENT APPROVED BY THE CITY ENGINEER. RUBBER GASKET JOINTS SHALL CONFORM TO ASTM C 433. REINFORCED CONCRETE PIPE SHALL ALSO BE PERMITTED AS ROUND, ELLIPTICAL, OR BOX SHAPED OR AS REINFORCED CONCRETE ARCH CULVERT.

- 4. BEDDING, OTHER THAN CONCRETE EMBEDMENT, SHALL CONSIST OF GRAVEL, CRUSHED GRAVEL, OR CRUSHED STONE 1/4 INCH TO 1 INCH IN SIZE. AS A MINIMUM, THE MATERIAL SHALL CONFORM TO THE REQUIREMENTS OF IDOT STANDARD SPECIFICATIONS. THE GRADATION SHALL CONFORM TO GRADATION CA-7 OR CA-11 OF THE STANDARD SPECIFICATIONS
- . BACKFILL MATERIAL SHALL CONFORM TO THE REQUIREMENTS OF IDOT STANDARD SPECIFICATIONS. THE GRADATION SHALL CONFORM TO GRADATION CA-6 OF THE STANDARD SPECIFICATIONS. BACKFILL MATERIAL SHALL BE COMPACTED TO 95% STANDARD PROCTOR DENSITY
- MANHOLES FOR STORM SEWERS SHALL HAVE A MINIMUM INSIDE DIAMETER OF 48 INCHES AND SHALL BE CONSTRUCTED OF PRECAST CONCRETE UNITS IN ACCORDANCE WITH ASTM C478-05 (OR LATEST EDITION) AND SHALL CONFORM TO THE CITY OF NAPERVILLE STANDARD DETAIL. ALL MANHOLES SHALL BE WATER-TIGHT. ALL VISIBLE LEAKS SHALL BE SEALED IN A MANNER ACCEPTABLE TO THE CITY ENGINEER. BACKFILLING.
- MANHOLES SHALL BE FURNISHED WITH A SELF-SEALING FRAME AND SOLID COVER (EAST JORDAN IRON WORKS 1022 WITH TYPE A SOLID COVER) WITH THE WORD "STORM" IMPRINTED ON THE COVER IN RAISED LETTERS. ALL FRAMES AND LIDS SHALL MEET OR EXCEED AASHTO H-20 LOADING SPECIFICATIONS. FRAMES SHALL BE SHOP PAINTED WITH ASPHALTIC BASE PAINT. BOTH THE MANHOLE FRAME AND COVER SHALL HAVE MACHINED HORIZONTAL AND VERTICAL BEARING SURFACES. INVERTED MANHOLE FRAMES ARE NOT ALLOWED. PICK HOLES SHALL NOT CREATE OPENINGS IN THE MANHOLE COVER.

- 8. ALL STORM SEWER STRUCTURE FRAMES WITHOUT INSIDE FLANGES SHALL BE SHAPED WITH HYDRAULIC CEMENT OR ELASTOMERIC JOINT SEALANT TO FORM A FILLET TO THE STRUCTURE OR ADJUSTING RINGS. WHEN ADJUSTMENTS ARE NECESSARY, PREFORMED ADJUSTING RINGS OF THE PROPER DIMENSIONS NEEDED TO MATE THE FRAME TO THE PRECAST STRUCTURE SHALL BE USED. NO MORE THAN 12 INCHES OF VERTICAL ADJUSTMENT MAY BE MADE USING THE MINIMUM PRACTICAL NUMBER OF INDIVIDUAL RINGS. ALL RINGS SHALL BE HIGH DENSITY POLYETHYLENE PLASTIC (HOPE), RECYCLED RUBBER, HIGH DENSITY EXPANDING POLYSTYRENE, EXPANDED POLYPROPYLENE (EPP), OR OTHER MATERIAL AS APPROVED BY THE CITY ENGINEER. PRECAST CONCRETE RINGS, BRICKS, ROCKS, SHIMS, OR CONCRETE BLOCKS WILL NOT BE ALLOWED. TAPERED ADJUSTING RINGS SHALL BE REQUIRED WHEN THE FRAME WILL NEED TO MATCH THE SLOPE OF THE ROADWAY.
- 9. FOR STRUCTURES LOCATED IN PAVED AREAS, A MINIMUM OF FOUR, 2-INCH DIAMETER HOLES SHALL BE DRILLED OR PRECAST INTO THE STRUCTURE WITHIN 1 FOOT OF THE LOWEST PIPE INVERT. THE HOLES SHALL BE DISTRIBUTED EQUIDISTANT AROUND THE PERIMETER OF THE STRUCTURE. A 1-FOOT BY 1- FOOT SECTION OF UNDERDRAIN FILTER CLOTH MATERIAL SHALL BE SUFFICIENTLY FIXED TO THE OUTSIDE OF THE MANHOLE WITH MASTIC MATERIAL TO PREVENT SLIPPAGE DURING 10.
- 10. THE CATCH BASINS AND INLETS SHALL HAVE A MINIMUM INSIDE DIAMETER OF 24 INCHES AND SHALL BE CONSTRUCTED OF PRECAST CONCRETE UNITS IN ACCORDANCE WITH ASTM C478-05 (OR LATEST EDITION) AND SHALL CONFORM TO THE CITY OF NAPERVILLE STANDARD DETAIL. ALL CATCH BASINS AND INLETS SHALL BE WATER-TIGHT AT ALL POINTS BELOW GRADE. ALL VISIBLE LEAKS SHALL BE SEALED IN A MANNER ACCEPTABLE TO THE CITY ENGINEER. CATCH BASINS AND INLETS SHALL BE FURNISHED WITH A FRAME AND GRATE BASED UPON THE LOCATION OF THE INSTALLATION AS LISTED BELOW. ALL FRAMES AND GRATES SHALL MEET OR EXCEED AASHTO H-20 LOADING SPECIFICATIONS. FRAMES SHALL BE SHOP PAINTED WITH ASPHALTIC BASE PAINT.
 - A) PAVEMENT: EAST JORDAN IRON WORKS 1022 FRAME WITH TYPE M1 RADIAL FLAT GRATE. B) BARRIER CURB AND GUTTER: EAST JORDAN IRON WORKS 7220 FRAME WITH TYPE M1 GRATE AND T1 CURB BOX.
 - C) DEPRESSED CURB: EAST JORDAN IRON WORKS 5120 FRAME AND GRATE.
- 11. ALL PIPE SHALL BE LAID TRUE TO LINE AND GRADE. DIRT AND OTHER FOREIGN MATERIAL SHALL BE PREVENTED FROM ENTERING THE PIPE OR PIPE JOINT DURING HANDLING OR LAYING OPERATIONS. ALL STORM SEWER PIPE TO PIPE CONNECTIONS SHALL BE SEALED WITH BUTYL MASTIC TO ENSURE WATER TIGHTNESS. LIFT HOLES TO BE SEALED USING BUTYL MASTIC AND CONCRETE PLUGS. AT NO TIME SHALL CONNECTIONS BETWEEN THE STORM SEWER AND SANITARY SEWER BE ALLOWED.

WATERMAIN AND SANITARY SEWER NOTES:

- NEW WATER MAIN VALVES, INCLUDING PRESSURE TAP VALVES, ADJACENT TO AN EXISTING WATER MAIN, AND EXISTING WATER MAIN VALVES SHALL ONLY BE OPERATED BY THE CITY OF NAPERVILLE, DEPARTMENT OF PUBLIC UTILITIES CEE/CM DIVISION PERSONNEL WITH 48-HOUR NOTICE (MONDAY-FRIDAY). CONTACT NAPERVILLE TED BUSINESS GROUP AT 630-420-6082 FOR SCHEDULING.
- 2. ANY EXISTING UTILITY STRUCTURES REQUIRING ADJUSTMENT OR RECONSTRUCTION SHALL BE COMPLETED BY THE CONTRACTOR TO THE SATISFACTION OF THE UTILITY OWNER. ADJUSTMENTS AND/OR RECONSTRUCTIONS NOT CALLED FOR ON THE PLANS SHALL BE CONSIDERED INCIDENTAL TO THE CONTRACT. NO MORE THAN A TOTAL OF 12 INCHES OF ADJUSTING RINGS AND/OR 2 ADJUSTING RINGS SHALL BE ALLOWED. ALL STRUCTURE FRAMES SHALL BE FLUSH WITH FINAL GRADE.
- 3. TREES SHALL BE INSTALLED A MINIMUM OF FIVE (5) FEET HORIZONTALLY FROM UNDERGROUND ELECTRICAL FEEDERS, SANITARY SEWERS, SANITARY SERVICES, WATER MAINS, AND WATER SERVICES. TREES SHALL BE INSTALLED A MINIMUM OF TEN (10) FEET HORIZONTALLY FROM UTILITY STRUCTURES AND APPURTENANCES, INCLUDING, BUT NOT LIMITED TO, MANHOLES, VALVE VAULTS, VALVE BOXES AND FIRE HYDRANTS. NO TREES, SHRUBS OR OBSTACLES WILL BE ALLOWED 10' IN FRONT OF, 5' ON THE SIDES, AND 7' TO THE REAR OF THE ELECTRICAL TRANSFORMER.
- 4. ALL RETAINER GLANDS WHEN REQUIRED TO RESTRAIN VALVES, FITTINGS, HYDRANTS, AND PIPE JOINTS SHALL BE MECHANICAL JOINT WEDGE ACTION TYPE MEGALUG 1100 SERIES AS MANUFACTURED BY EBBA IRON, INC. OR UNI-FLANGE BLOCKBUSTER 1400 SERIES AS MANUFACTURED BY FORD METER BOX CO. AND SHALL BE FOR USE ON DUCTILE IRON PIPE CONFORMING TO ANSI/AWWA C151/A21.51. FOR NOMINAL PIPE SIZES 3"THROUGH 48".
- RESTRAINING NEW PUSH-ON PIPE BELLS TO EXISTING DUCTILE IRON PIPE, OR VISA VERSA, SHALL BE COMPLETED WITH A SYSTEM COMPRISED OF A SPLIT BELL RESTRAINT HARNESS INCLUDING DUAL DUCTILE IRON GRIPPING RINGS AND STAINLESS STEEL RODS.
- RESTRAINING NEW MECHANICAL JOINTS TO EXISTING DUCTILE IRON PIPE, OR VISA VERSA, SHALL BE MADE WITH A SYSTEM COMPRISED OF A DUCTILE IRON GRIPPING RING AND STAINLESS STEEL BOLTS.
- . DUCTILE IRON WATER MAIN TO BE CLASS 52. ALL DUCTILE IRON PIPE IS TO BE ENCASED IN POLYETHYLENE FILM POLYETHYLENE ENCASEMENT TO BE INSTALLED IN ACCORDANCE WITH ANSI/AWWA C105/A21.5-05.



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SCALE: N.T.S.

WASHINGTON STREET BRIDGE					F.A.U. RTE	SECTION			COUNTY	TOTAL SHEETS	SHEET NO.			
GENERAL NOTES				2552	16-00167-00-BR			DUPAGE	261	3				
GENERAL NOTES									CONTRACT	NO. 61	IG82			
	SHEET	1 OF	2	SHEETS	STA.	TO STA.	EED BO	OAD DIST NO	ILLINOIS	EED ΔI	D PROJECT			

WATERMAIN AND SANITARY SEWER NOTES (CONT.):

- 8. RECORD DRAWINGS REFERRED TO IN GENERAL NOTE 9 SHALL SHOW THE ELEVATION AND LOCATION (TIED TO TWO POINTS) OF ALL NEW AND EXISTING STRUCTURES INCLUDING FIRE HYDRANTS, VALVE BOXES AND VAULTS, LINESTOP SLEEVES, WATER SERVICE CORPORATION STOPS, WATER MAIN FITTINGS/BENDS, MANHOLES, SANITARY SERVICE WYTES (MEASURED FROM DOWNSTREAM MANHOLE), AND ABANDONED WATER OR SANITARY SERVICE LINES. ALL ELEVATIONS SHOULD BE REFERENCED TO THE SAME BENCHMARK DATUM AS THE ORIGINAL DESIGN PLANS. HORIZONTAL TIES SHALL BE REFERENCED TO LOT LINES, BACK OF CURB, OR PROPERTY CORNERS.
- 9. ALL SANITARY SEWER PIPING SHALL BE PVC PIPE MEETING THE REQUIREMENTS OF ASTM D-2241 WITH JOINTS CONFORMING TO ASTM D-3139. ALL SANITARY SEWER FITTINGS SHALL BE PVC MEETING THE FOLLOWING REQUIREMENTS: 4"TO 12" SHALL BE INJECTION MOLDED FITTINGS MEETING ASTM D-2241. GREATER THAN 12" SHALL BE FABRICATED FITTINGS MEETING ASTM D-2241 OR C905. MINIMUM PRESSURE RATING SHALL BE 150 PSI.
- 10. THE VALVES LESS THAN 16" SHALL BE STANDARD PATTERN, GATE VALVES AND SHALL HAVE THE NAME OR MARK OF THE MANUFACTURER, SIZE AND WORKING PRESSURE PLAINLY CAST IN RAISED LETTERS ON THE VALVE BODY. VALVES MAY BE APPROVED FROM ONE OF THE FOLLOWING MANUFACTURERS: AMERICAN, CLOW, WATEROUS OR KENNEDY.
- 11. THE CONTRACTOR SHALL ROTATE AND/OR ADJUST ANY EXISTING AND/OR NEW HYDRANT TO THE SATISFACTION OF THE DEPARTMENT OF PUBLIC UTILITIES.
- 12. STAINLESS STEEL NUTS, BOLTS/T-BOLTS, AND WASHERS, TYPE 304 OR BETTER, WILL BE REQUIRED ON ALL WATERMAIN INSTALLATIONS. THIS WOULD APPLY TO HYDRANTS, TAPPING SLEEVES, VALVES, FITTINGS, RESTRAINT, AND OTHER APPURTENANCES BURIED OR IN VALVE VAULTS. MECHANICAL JOINTS AND RESTRAINT GLANDS REQUIRE 304 STAINLESS STEEL T-BOLTS. AN ANTI-SEIZE COMPOUND SHALL BE FACTORY APPLIED TO NUTS OR BOLTS ANY DAMAGE TO THIS COATING SHALL BE REPAIRED WITH FIELD APPLIED APPROVED ANTI-SEIZE COMPOUND THAT IS A MOLYBDENUM-BASE LUBRICANT, BOSTIK NEVER-SEEZ.
- 13. WATER MAINS SHALL BE SUBJECTED TO A HYDROSTATIC/LEAKAGE TEST IN ACCORDANCE WITH NAPERVILLE STANDARD SPECIFICATIONS. TEST PRESSURE SHALL BE NO LESS THAN 150 PSI FOR A PERIOD OF 4 HOURS AND NOT VARY BY MORE THAN +5 PSI. DURING THE TEST. THE TEST GAUGE SHALL BE APPROVED BY THE CITY AND SHALL BE GLYCERIN OR OIL FILLED, WITH A RANGE OF NOT MORE THAN 200 PSI AND INCREMENTS NOT GREATER THAN 5 PSI, 4" MINIMUM DIAL SIZE. WATER RECOVERY TEST SHALL BE COMPLETED AT THE END OF THE TESTING PERIOD TO SHOW ACTUAL LEAKING AND THAT THE WATER MAIN DID NOT HAVE TOO MUCH TRAPPED AIR IN THE TESTED SECTION.
- 14. THE CITY OF NAPERVILLE DPU-W/WW DOES NOT GUARANTEE THAT ANY VALVE OR FITTING IN THE EXISTING WATER DISTRIBUTION SYSTEM WILL HOLD AGAINST A HYDROSTATIC/LEAKAGE TEST. THE CONTRACTOR IS SOLELY RESPONSIBLE FOR PROVIDING AN ACCEPTABLE PRESSURE TEST WHICH SHALL INCLUDE PROVISIONS AROUND EXISTING VALVES AND FITTINGS.
- 15. FIRE HYDRANT SHOULD BE BAGGED "NOT IN SERVICE" UNTIL ALL TESTING AND DISINFECTION HAS BEEN COMPLETED AND NEW WATER MAIN SECTION IS SERVICE.
- 16. SANITARY SEWER AND WATER SHALL BE CONSTRUCTED, TESTED, AND PLACED INTO SERVICE IN ACCORDANCE WITH CITY OF NAPERVILLE STANDARD SPECIFICATION AND SPECIFICATIONS FOR WATER AND SEWER MAIN CONSTRUCTION IN ILLINOIS, LATEST EDITION
- 17. ALL VALVE BOXES, VAULTS, HYDRANTS, AND MANHOLES SHALL NOT BE COVERED WITH CONSTRUCTION DEBRIS AND SHALL REMAIN ACCESSIBLE TO THE RESPECTIVE UTILITY COMPANY
- 18. WATER SERVICE LINE SMALLER THAN 3"SHALL BE TYPE K COPPER. IF JOINTS ARE REQUIRED DUE TO LENGTH OF SERVICE, THEN ONLY COMPRESSION TYPE COUPLING SHALL BE PERMITTED. NO SOLDERED OR FLARED TYPE JOINTS ARE ALLOWED.
- 19. ALL SANITARY MANHOLES SHALL BE TESTED FOR LEAKAGE BY VACUUM TESTING. THE MANHOLE FRAME AND ADJUSTING RINGS SHALL BE IN PLACE WHEN TESTING. ANY LEAKS SHALL BE REPAIRED FROM EXTERIOR OF MANHOLE PATCHING INSIDE OF MANHOLE SHALL NOT BE ACCEPTABLE. A VACUUM OF 10"(254 MM) HG SHALL BE PLACE ON THE MANHOLE AND THE TIME SHALL BE MEASURED FOR THE VACUUM TO DROP TO 9"(229 MM) HG. THE VACUUM SHALL NOT DROP BELOW 9" (229 MM) HG FOR THE FOLLOWING TIME PERIODS FOR EACH SIZE OF MANHOLE:

A.) 48-INCH DIAMETER - 60 SECONDS B.) 60-INCH DIAMETER - 75 SECONDS C.)72-INCH DIAMETER - 90 SECONDS D.) 84-INCH DIAMETER - 105 SECONDS

ANY MANHOLES THAT FAIL THE TEST SHALL BE SEALED AND RE-TESTED UNTIL ACCEPTABLE.

20. THE CONTRACTOR SHALL PROVIDE INTERNAL TELEVISED INSPECTION OF ALL INSTALLED SANITARY SEWER, LATERALS, MANHOLES AND CONNECTIONS TO THE PUBLIC SYSTEM. FOLLOWING COMPLETION OF TELEVISING WORK, THE CONTRACTOR SHALL SUBMIT VIDEO RECORDINGS ON DVD OR FLASH DRIVE ALONG WITH A COMPREHENSIVE TELEVISING REPORT WHICH WILL INDICATE THE LOCATION, FOOTAGES AND NATURE OF ANY DEFECTS. ALL DEFECTS SHALL BE REPAIRED TO THE SATISFACTION OF THE WATER/WASTEWATER UTILITY AND RE-TELEVISED.

- 21. SANITARY PIPES WITH LESS THAN 4 FEET OR MORE THAN 25 FEET OF COVER SHALL BE CONSTRUCTED OF DUCTILE IRON PIPING (CLASS 50, MINIMUM) AND ENCASED IN POLYWRAP.
- 22. ALL EXCAVATIONS MORE THAN 20 FEET DEEP MUST BE PROTECTED BY A SYSTEM DESIGNED BY A REGISTERED PROFESSIONAL ENGINEER.
- 23. CONTRACTOR SHALL MAINTAIN 2' MINIMUM CLEARANCE BETWEEN EXISTING UTILITIES AND NEW FOUNDATIONS AND UNDERGROUND FACILITIES. IN AREAS WHERE FOUNDATIONS AND UNDERGROUND FACILITIES ARE PROPOSED ADJACENT TO EXISTING UTILITIES, THE CONTRACTOR SHALL POT HOLE BY VACUUM EXCAVATION OR HAND EXCAVATION TO LOCATE THE EXISTING UTILITY TO VERIFY MINIMUM CLEARANCE REQUIREMENT.
- 24. FENCES SHALL BE INSTALLED A MINIMUM OF 5 FEET FROM ANY WATER OR SANITARY MAINS WHEN RUNNING PARALLEL WITH THEM. WHERE FENCES ARE INSTALLED CROSSING WATER OR SANITARY MAINS, THE POSTS SHALL BE LOCATED TO HAVE THE MAIN BETWEEN THEM.
- 25. ALL BRASS COMPONENTS SHALL BE CERTIFIED TO BE LEAD FREE IN COMPLIANCE WITH NSF 61 AND NSF 372 AND IDENTIFIED WITH APPLICABLE MARKINGS.AA.SANITARY FORCE MAIN - FORCE MAN SHALL BE TESTED A MINIMUM OF 1 HOUR AT 1.5 THE SHUT OFF HEAD OF THE PUMP, 2.5 TIMES THE OPERATING PRESSURE, OR 20 PSI WHICHEVER IS GREATEST. ALLOWABLE LEAKAGE SHALL BE IN ACCORDANCE WITH SECTION 41-2.14C OF THE STANDARD SPECIFICATIONS FOR WATER AND SEWER CONSTRUCTION.

GEOMETRICS AND PAVING NOTES:

- THE CONTRACTOR SHALL HAVE THE RESPONSIBILITY TO ADEQUATELY PROTECT THE
 PAVEMENT AND PROPERTY, CURB AND GUTTER AND OTHER RIGHT-OF-WAY IMPROVEMENTS,
 WHETHER NEWLY CONSTRUCTED OR EXISTING, FROM ANY AND ALL DAMAGE. SUFFICIENT
 MEANS SHALL BE EMPLOYED BY THE CONTRACTOR TO PROTECT AGAINST SUCH DAMAGE TO THE
 SATISFACTION OF THE CITY ENGINEER.
- ANY NEW OR EXISTING IMPROVEMENTS THAT ARE DAMAGED SHALL BE REPAIRED OR REPLACED TO SATISFY THE IMPROVEMENTS SPECIFICATION.
- B. WHEREVER NEW WORK WILL MEET EXISTING CONDITIONS OTHER THAN LAWN AREAS, REGARDLESS OF WHETHER THE NEW OR EXISTING WORK IS ASPHALT OR CONCRETE, THE EXISTING ADJACENT SIDEWALK, DRIVEWAYS, PAVEMENT OR CURB SHALL BE NEATLY SAW CUT. THE SAW CUT SHALL BE IN A NEAT STRAIGHT LINE SUFFICIENTLY DEEP SO THAT IT RENDERS A SMOOTH VERTICAL FACE TO MATCH TO. IF THE CONTRACTOR IS NOT CAREFUL OR DOES NOT SAW DEEP ENOUGH AND THE CUT LINE BREAKS OUT OR CHIPS TO AN IMPERFECT EDGE, THEN THE EXISTING SIDE MUST BE RE-CUT SQUARE AND DONE OVER UNTIL IT IS CORRECT

TRAFFIC CONTROL AND PROTECTION NOTES:

- 1. ALL DEVELOPERS AND CONTRACTORS SHALL PROVIDE SUITABLE TRAFFIC CONTROL FOR THEIR CONSTRUCTION ACTIVITIES IN ACCORDANCE WITH PART 6 OF THE MANUAL ON UNIFORM TRAFFIC CONTROL DEVICES (MUTCD), LATEST EDITION. TRAFFIC CONTROL MUST BE PROVIDED FOR ANY ACTIVITY THAT IMPACTS TRAFFIC FLOW. THIS INCLUDES, BUT IS NOT LIMITED TO, ROAD CLOSURES REQUIRING DETOURS, DAILY LANE CLOSURES, LONG TERM LANE CLOSURES, NARROW LANES, AND CONSTRUCTION VEHICLES ENTERING AND EXITING THE PUBLIC ROADWAY. ALL TRAFFIC CONTROL SETUPS MAY BE INSPECTED BY THE CITY OF NAPERVILLE TO ENSURE THAT THEY ARE PROVIDING POSITIVE GUIDANCE TO MOTORISTS AND ARE NOT IN THEMSELVES PRESENTING A HAZARDOUS SITUATION. A REPRESENTATIVE OF THE DEVELOPER OR CONTRACTOR MUST PROVIDE PHONE NUMBERS AT WHICH THEY CAN BE REACHED 24 HOURS A DAY AND ON WEEKENDS SO THAT THEY CAN MAINTAIN TRAFFIC CONTROL DEVICES.
- . PEDESTRIANS MUST BE PROVIDED WITH A SAFE ALTERNATE ROUTE IF PEDESTRIAN FACILITIES ARE TO BE CLOSED AS A RESULT OF CONSTRUCTION ACTIVITIES. GUIDANCE MUST BE PROVIDED TO PEDESTRIANS SO THAT THEY MAY AVOID THE WORK ZONE. SAID PEDESTRIAN DETOUR PLAN (WITH SIGNAGE) IS TO BE REVIEWED AND ACCEPTED BY THE CITY IN WRITING, PRIOR TO THE COMMENCEMENT OF THE WORK.
- 3. THE CONTRACTOR SHALL EMPLOY THE APPROPRIATE METHODS OF TRAFFIC CONTROL IN ACCORDANCE WITH THE PLANS, SPECIFICATIONS AND THE MANUAL ON UNIFORM TRAFFIC CONTROL DEVICES, SUCH THAT THE SAFETY OF VEHICLES, AND PEDESTRIANS IS PRESERVED AT ALL TIMES. THE ERECTION AND MAINTENANCE OF THE TRAFFIC CONTROL DEVICES SHALL BE TO THE SATISFACTION OF THE AGENCY OF JURISDICTION AND THE CITY ENGINEER.
- 4. ANY TEMPORARY OPEN HOLES SHOULD BE BARRICADED AND PROTECTED IN ACCORDANCE WITH APPLICABLE STANDARDS.
- 5. LANE CLOSURES ON ARTERIAL ROADWAYS WITHIN THE CITY OF NAPERVILLE ARE NOT PERMITTED BETWEEN THE HOURS OF 6AM-9AM AND 3PM-7PM MONDAY THROUGH FRIDAY, UNLESS OTHERWISE PERMITTED BY THE CITY ENGINEER. LANE CLOSURES ON ARTERIAL STREETS ARE PERMITTED BETWEEN 7AM AND 7PM ON WEEKENDS, UNLESS OTHERWISE PERMITTED BY THE CITY ENGINEER. ARTERIAL ROADWAYS ARE DEFINED AS BOTH MAJOR AND MINOR ARTERIAL ROADWAYS AS DESIGNATED ON THE CITY'S MASTER THOROUGHFARE PLAN, LATEST EDITION.

- ANY WORK THAT IMPACTS A TRAFFIC LANE ON AN ARTERIAL ROADWAY REQUIRES AN ARROWBOARD AS PART OF THE TRAFFIC CONTROL.
- 7. FOR UTILITY WORK ON CHICAGO AVENUE, THE ROADWAY MUST BE COMPLETELY REOPENED TO TRAFFIC AT THE END OF EACH DAY OF WORK. ANY OPEN HOLES MUST BE PLATED OR COLD PATCHED; THE CITY WILL NOT ALLOW THE HOLES TO BE FILLED WITH GRAVEL.
- 8. FOR THE DURATION OF CONSTRUCTION, SEVEN TEMPORARY INFORMATION SIGNS ARE NEEDED TO ENCOURAGE REGIONAL TRAFFIC TO AVOID WASHINGTON STREET, EACH AT:
 - 1) SOUTHBOUND WASHINGTON STREET AND US 34
 - 2) SOUTHBOUND WASHINGTON STREET AND JEFFERSON AVENUE
 - 3) NORTHBOUND WASHINGTON STREET AND 75TH STREET
 - 4) NORTHBOUND WASHINGTON STREET AND HILLSIDE ROAD 5) EASTBOUND AURORA AVENUE AND WEST STREET
 - 6) WESTBOUND CHICAGO AVENUE AND NAPER BOULEVARD
 - 7) RIVERWALK ENTRANCE AT HILLSIDE ROAD
 - ADDITIONALLY, TWO DRIVEWAY ENTRANCE SIGNS SHALL BE PLACED AT EACH COMMERCIAL ENTRANCE WITHIN THE PROJECT LIMITS DURING CONSTRUCTION.

COMMITMENTS

- THE COMPLETED LOAD RATING ANALYSIS AND STRUCTURE LOAD RATING SUMMARY (FORM BBS-2795), SIGNED BY AN ILLINOIS LICENSED STRUCTURAL ENGINEER, MUST BE FORWARDED TO IDOT, AND CONCURRENCE RECEIVED, BEFORE TRANSFERRING TRAFFIC FOR STAGE 1 CONSTRUCTION. IN ADDITION, THE CONTRACT DOCUMENTS SHOULD INCLUDE GUIDE BRIDGE SPECIAL PROVISION "STRUCTURAL ASSESSMENT REPORTS FOR CONTRACTOR'S MEANS AND METHODS."
- TO AVOID POTENTIAL IMPACTS TO NORTHERN LONG-EARED BAT (MYOTIS SEPENTRIONALIS), TREE REMOVAL SHALL NOT OCCUR FROM JUNE 1ST THROUGH JULY 31ST.



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SCALE: N.T.S.

										80% FED 20% STATE		100% CITY	
SPECIALTY ITEM	SP	CODE NO.	ПЕМ	UNIT	TOTAL	RDWY 0004	BRIDGE REPLACE 0010	RDWY 0004					
Δ		20100110	TREE REMOVAL (6 TO 15 UNITS DIAMETER)	UNIT	93	93							
								T do market					
Δ		20100210	TREE REMOVAL (OVER 15 UNITS DIAMETER)	TINU	42	42							

		20101000	TEMPORARY FENCE	FOOT	286	286							
		20101100	TREE TRUNK PROTECTION	EACH	1	1							
						.,,							
Δ		20101200	TREE ROOT PRUNING	EACH	1	1							
		20200100	EARTH EXCAVATION	CU YD	1,700	1,700							
		20200200	ROCK EXCAVATION	CU YD	667			667					
		20201200	REMOVAL AND DISPOSAL OF UNSUITABLE MATERIAL	CU YD	85	85							
		20800150	TRENCH BACKFILL	CU YD	1,742	1,086		656					
		21001000	GEOTECHNICAL FABRIC FOR GROUND STABILIZATION	SQ YD	1,012	1,012							
				120									
		21101625	TOPSOIL FURNISH AND PLACE, 6"	5Q YD	457	457							
	*	21101645	TOPSOIL FURNISH AND PLACE, 12"	SQ YD	40	40							
Δ		25200110	SODDING, SALT TÖLERANT	SQ YD	707	707							
Δ	*	25200200	SUPPLEMENTAL WATERING	UNIT	16	16							

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WASHINGTON STREET BRIDGE SUMMARY OF QUANTITIES								
SCALE: N.T.S.	SHEET	1 OF	23	SHEETS STA.	TO STA.			

						80% FED :	20% STATE	100% CITY
SPECIAL TY ITEM	SP	CODE NO.	ITEM	UNIT	TOTAL	RDWY 0004	BRIDGE REPLACE 0010	RDWY 0004
		28000250	TEMPORARY EROSION CONTROL SEEDING	POUND	10	10		
		28000400	PERIMETER EROSION BARRIER	FOOT	302	302		
		28000510	INLET FILTERS	EACH	18	18		
		28001100	TEMPORARY EROSION CONTROL BLANKET	SQ YD	457	457		
	*	30300001	AGGREGATE SUBGRADE IMPROVEMENT	CU YD	338	338		
	*	30300112	AGGREGATE SUBGRADE IMPROVEMENT 12"	SQ YD	4,048	4,048		
					A CONTRACTOR OF THE CONTRACTOR			
		31101180	SUBBASE GRANULAR MATERIAL, TYPE B 2"	SQ YD	1,184	1,137		47
		31101810	SUBBASE GRANULAR MATERIAL, TYPE B 12"	SQ YD	302	302		
		35501310	HOT-MIX ASPHALT BASE COURSE, 6 1/2"	SQ YD	3,592	3,592		
		A CONTRACTOR OF THE CONTRACTOR		***				73.50.00
		35600702	HOT-MIX ASPHALT BASE COURSE WIDENING, 6 1/2"	SQ YD	42	42		
		The second secon						
		40600290	BITUMINOUS MATERIALS (TACK COAT)	POUND	5,504	4,874		630
							and the state of t	
		40600982	HOT-MIX ASPHALT SURFACE REMOVAL - BUTT JOINT	SQ YD	131	45		86
	*	40601005	HOT-MIX ASPHALT REPLACEMENT OVER PATCHES	TON	26	26		
					***************************************	ļ		
		40602978	HOT-MIX ASPHALT BINDER COURSE, IL- 9.5, N50	TON	39	39	The state of the s	
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WASHINGTON STREET BRIDGE SUMMARY OF QUANTITIES									
SCALE: N.T.S.	SHEET	2 (OF 2	SHEETS	STA.	TO STA.			

						80% FED	20% STATE	100% CITY
SPECIALTY ITEM	SP	CODE NO.	ПЕМ	UNIT	TOTAL	RDWY 0004	BRIDGE REPLACE 0010	RDWY 0004
		40603240	POLYMERIZED HOT-MIX ASPHALT BINDER COURSE, IL-19.0, N90	TON	689	567		122
		40604060	HOT-MIX ASPHALT SURFACE COURSE, IL-9.5, MIX "D", N50	TON	26	26		
		40604172	POLYMERIZED HOT-MIX ASPHALT SURFACE COURSE, IL-9.5, MIX "E", N70	TON	613	505		108
		42000060	WELDED WIRE REINFORCEMENT	SQ YD	362	362		
		42000080	PAVEMENT CONNECTOR (PCC) FOR BRIDGE APPROACH SLAB	SQ YD	362	362	- Annual Harry Control of the Contro	
		42001300	PROTECTIVE COAT	SQ YD	1,583		1,583	
		42300400	PORTLAND CEMENT CONCRETE DRIVEWAY PAVEMENT, 8 INCH	SQ YD	163	138		25
	*	42400200	PORTLAND CEMENT CONCRETE SIDEWALK 5 INCH	SQ FT	7,934.5	7,509		426
		42400800	DETECTABLE WARNINGS	SQ FT	210	210		
		44000100	PAVEMENT REMOVAL	SQ YD	3,241	3,241		
	William Control	44000166	HOT-MIX ASPHALT SURFACE REMOVAL, 4 1/4"	SQ YD	1,702	650		1052
						-		
		44000200	DRIVEWAY PAVEMENT REMOVAL	SQ YD	895	873		22
		44000300	CURB REMOVAL	FOOT	421	421		
		44000500	COMBINATION CURB AND GUTTER REMOVAL	FOOT	1,589	1,504		85
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STATE OF ILLINOIS DEPARTMENT OF TRANSPORTATION

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CONTRACT NO. 61	•
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FEO. ROAD DIST. NO. ILLINOIS FEO. AID PROJECT	

						80% FED	20% STATE	100% CITY
SPECIALTY ITEM	SP	CODE NO.	ITEM	UNIT	TOTAL	RDWY 0004	BRIDGE REPLACE 0010	RDWY 0004
		44000600	SIDEWALK REMOVAL	5Q FT	7,070	6,642		428
	*	44002217	HOT-MIX ASPHALT REMOVAL OVER PATCHES, 4 1/4"	SQ YD	273			273
		44201741	CLASS D PATCHES, TYPE II, 8 INCH	SQ YD	12			12
		44201747	CLASS D PATCHES, TYPE IV, 8 INCH	SQ YD	218			218
		50100300	REMOVAL OF EXISTING STRUCTURES NO. 1	EACH	1		1	
		50100400	REMOVAL OF EXISTING STRUCTURES NO. 2	EACH	1		1	
		50100500	REMOVAL OF EXISTING STRUCTURES NO. 3	EACH	1		1	
							į	
		50100600	REMOVAL OF EXISTING STRUCTURES NO. 4	EACH	1		1	
					PPOOR			
		50200100	STRUCTURE EXCAVATION	CU YD	261		261	
		50200400	ROCK EXCAVATION FOR STRUCTURES	CU YD	298		298	
		50300225	CONCRETE STRUCTURES	CU YD	450.8		450.8	
		50300255	CONCRETE SUPERSTRUCTURE	CU YĐ	87,4		87.4	
		50300260	BRIDGE DECK GROOVING	SQ YD	1,083		1,083	
		50300265	SEAL COAT CONCRETE	CU YD	88		88	

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WASHINGTON STREET BRIDGE SUMMARY OF QUANTITIES										
I	SCALE: N.T.S.	SHEET	4 C)F 23	SHEETS	STA.	TO STA.			

		SWIII.				80% FED :	20% STATE	100% CITY
SPECIALTY ITEM	SP	CODE NO.	ITEM	TIMU	TOTAL	RDWY 0004	BRIDGE REPLACE 0010	RDWY 0004
		50300280	CONCRETE ENCASEMENT	CU YĐ	251	0		251
		50301350	CONCRETE SUPERSTRUCTURE (APPROACH SLAB)	CU YD	159.8		159.8	
		50800105	REINFORCEMENT BARS	POUND	18,760		18,760	
		50800205	REINFORCEMENT BARS, EPOXY COATED	POUND	223,420		223,420	
		50800515	BAR SPLICERS	EACH	846		846	

		50800530	MECHANICAL SPLICERS	EACH	56		56	
Δ		50900805	PEDESTRIAN RAILING	FOOT	40	40		
							ANALYSIS OF THE PROPERTY OF TH	
		51500100	NAME PLATES	EACH	1	****	1	
		51603000	DRILLED SHAFT IN SOIL	CU YD	12.4		12.4	

		51604000	DRILLED SHAFT IN ROCK	CU YD	60		60	
								-
		52000110	PREFORMED JOINT STRIP SEAL	FOOT	170		170	
							a de la companya de l	
		52100010	ELASTOMERIC BEARING ASSEMBLY, TYPE 1	EACH	18		18	
							-	
		52100520	ANCHOR BOLTS, 1"	EACH	72		72	
	-	52200020	TEMPORARY SOIL RETENTION SYSTEM	SQ FT	1,589		1,589	

* INDICATES SPECIAL PROVISION



	USER NAME - Roadway	DESIGNED	-	ТВН	REVISED	
		DRAWN	-	VZ	REVISED	•
	PLOT SCALE = 2.0000 ' / in.	CHECKED	•	DD	REVISED	•
	PLOT DATE = 8/8/2022	DATE	-	8/8/2022	REVISED	-
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STATE OF ILLINOIS
DEPARTMENT OF TRANSPORTATION

					N STRE OF QU						
SCALE: N.T.S. SHEET S OF 23 SHEETS STA. TO STA.											

F.A.U. RTE.	SEC	TION	COUNTY	TOTAL SHEETS	SHEET NO.	
2552	16-0016	7-00-BR		DUPAGE	261	9
			CONTRACT	NO. 63	1G82	
 FED. R	OAD DIST. NO.	ILLINOIS	FED. A	D PROJECT		

SMODELNAMES

						80% FED :	20% STATE	100% CITY
SPECIALTY ITEM	SP	CODE NO.	ПЕМ	UNIT	TOTAL	RDWY 0004	BRIDGE REPLACE 0010	RDWY 0004
		550A0340	STORM SEWERS, CLASS A, TYPE 2 12"	FOOT	273	273		***************************************
		550A0410	STORM SEWERS, CLASS A, TYPE 2 24"	FOOT	201	201		
		55100500	STORM SEWER REMOVAL 12"	FOOT	185	185		
		55100900	STORM SEWER REMOVAL 18"	FOOT	133	133		
***************************************		55101200	STORM SEWER REMOVAL 24"	FOOT	208	208		
_								
Δ	*	56103000	DUCTILE IRON WATER MAIN 6"	FOOT	53	46		7
Δ	*	56103100	DUCTILE IRON WATER MAIN 8"	FOOT	22			22
Δ	*	56103300	DUCTILE IRON WATER MAIN 12"	FOOT	512	512		

	*	56105500	INSERTING VALVES 6"	EACH	2	1		1
Δ	*	56105600	INSERTING VALVES 8"	EACH	1			1
						······		
	*	56105702	INSERTING VALVES 12"	EACH	1	1		
Δ	*	56109210	WATER VALVES TO BE ADJUSTED	EACH	4	4		

Δ	*	56400500	FIRE HYDRANTS TO BE REMOVED	EACH	2	1		1
_			observed with Michigan to the control of the contro					
_	*	58600101	GRANULAR BACKFILL FOR STRUCTURES	CU YD	339		339	

* INDICATES SPECIAL PROVISION



	USER NAME ≈ Roadway	DESIGNED -	TBH	REVISED -
1		DRAWN	VZ	REVISED
1	PLOT SCALE = 2,0000 ' / in.	CHECKED -	DD	REVISED -
	PLOT DATE = 8/8/2022	DATE -	8/8/2022	REVISED -

	WASHINGTON STREET BRIDGE SUMMARY OF QUANTITIES									
SCALE: N.T.S. SHEET 6 OF 23 SHEETS STA. TO STA.										

F.A.U. RTE.	SÉC	TION		COUNTY	TOTAL SHEETS	SHEE NO.
2552	15-0016	7-00-BR	DUPAGE	261	10	
		CONTRACT	NO. 61	1G82		
FED. ROAD DIST. NO. ILLINOIS FED. A				D PROJECT		

MODEL: \$MODELNAME\$

						80% FED :	20% STATE	100% CITY
SPECIALTY ITEM	SP	CODE NO.	ITEM	UNIT	TOTAL	RDWY 0004	BRIDGE REPLACE 0010	RDWY 0004
		58700300	CONCRETE SEALER	SQ FT	685		685	
		59100100	GEOCOMPOSITE WALL DRAIN	SQ YD	267		267	
		60108204	PIPE UNDERDRAINS, TYPE 2, 4"	FOOT	1,321	1,321		
		60146304	PIPE UNDERDRAINS FOR STRUCTURES 4"	FOOT	257		257	
		60200105	CATCH BASINS, TYPE A, 4'-DIAMETER, TYPE 1 FRAME, OPEN LID	EACH	6	6		

		60200905	CATCH BASINS, TYPE A, 4'-DIAMETER, TYPE 9 FRAME AND GRATE	EACH	1	1		
		60203805	CATCH BASINS, TYPE A, 5'-DIAMETER, TYPE 1 FRAME, OPEN LID	EACH	2	2		
		60218400	MANHOLES, TYPE A, 4'-DIAMETER, TYPE 1 FRAME, CLOSED LID	EACH	2	2		

		60221000	MANHOLES, TYPE A, 5'-DIAMETER, TYPE 1 FRAME, OPEN LID	EACH	1	1		
		60224459	MANHOLES, TYPE A, 8'-DIAMETER, TYPE 1 FRAME, CLOSED LID	EACH	1	1		
		:						
		60236600	INLETS, TYPE A, TYPE 9 FRAME AND GRATE	EACH	1	1		
					:			
		60236800	INLETS, TYPE A, TYPE 11 FRAME AND GRATE	EACH	2	2		
		60300305	FRAMES AND LIDS TO BE ADJUSTED	EACH	15	15		
				***************************************		,,,,,,,,,,,,,,,,,,,,,,,,,,,,,,,,,,,,,,		
		60500040	REMOVING MANHOLES	EACH	5	5		

* INDICATES SPECIAL PROVISION



 USER NAME ⇒ Roadway	DESIGNED	-	твн	REVISED	-
	DRAWN	-	VZ	REVISED	-
PLOT SCALE = 2.0000 ' / In.	CHECKED	-	DD	REVISED	-
PLOT DATE = 8/8/2022	DATE	-	8/8/2022	REVISED	

	WASHINGTON STREET BRIDGE SUMMARY OF QUANTITIES										
SCALE: N.T.S. SHEET 7 OF 23 SHEETS STA. TO STA.											

******						80% FED 2	20% STATE	100% CITY
SPECIALTY ITEM	SP	CODE NO.	ITEM	UNIT	TOTAL	RDWY 0004	BRIDGE REPLACE 0010	RDWY 0004
	77000	60500060	REMOVING INLETS	EACH	5	5		
		7.						
		60600605	CONCRETE CURB, TYPE B	FOOT	322	322		
		60603800	COMBINATION CONCRETE CURB AND GUTTER, TYPE B-6.12	FOOT	1,698	1,598		100
								4.4.4
		60608300	COMBINATION CONCRETE CURB AND GUTTER, TYPE M-2.12	FOOT	70	70		
		63200310	GUARDRAIL REMOVAL	FOOT	46	46		
Δ		64100115	SIGHT SCREEN (WOODEN FENCE), TYPE P 6'	FOOT	14	14		
Δ		66400305	CHAIN LINK FENCE, 6'	FOOT	26	26		
Δ	*	66900200	NON-SPECIAL WASTE DISPOSAL	CU YD	1,296	1,179	57	60
Δ		66900530	SOIL DISPOSAL ANALYSIS	EACH	5	5	:	
							1	
Δ		66901001	REGULATED SUBSTANCES PRE-CONSTRUCTION PLAN	L SUM	1	1	***************************************	
	-							
Δ		66901003	REGULATED SUBSTANCES FINAL CONSTRUCTION REPORT	L SUM	1	1	***	
		and a second a second and a second a second and a second a second and a second and a second and					•	
Δ		66901006	REGULATED SUBSTANCES MONITORING	CAL DA	15	15	WARRANT TO THE PARTY TO THE PAR	
			- refraction of the second			ĺ	****	
		67100100	MOBILIZATION	L SUM	1	1		
			werdelijk fan Party y **		<u> </u>			
		70300100	SHORT TERM PAVEMENT MARKING	FOOT	5,500	5,500		
							ļ	

* INDICATES SPECIAL PROVISION



USER NAME = Roadway	DESIGNED	-	твн	REVISED	-
	DRAWN	-	VZ	REVISED	•
PLOT SCALE = 2.0000 ' / in.	CHECKED	-	DD	REVISED	•
PLOT DATE == 8/8/2022	DATE	-	8/8/2022	REVISED	=

·						80% FED	20% STATE	100% CITY
SPECIALTY ITEM	SP	CODE NO.	ITEM	UNIT	TOTAL	RDWY 0004	BRIDGE REPLACE 0010	RDWY 0004
		70300150	SHORT TERM PAVEMENT MARKING REMOVAL	5Q FT	1,834	1,834		
		70300211	TEMPORARY PAVEMENT MARKING LETTERS AND SYMBOLS - PAINT	SQ FT	1,014	1,014		100 1100 11
		70300221	TEMPORARY PAVEMENT MARKING - LINE 4"- PAINT	FOOT	33,564	33,564		
		70300241	TEMPORARY PAVEMENT MARKING - LINE 6"- PAINT	FOOT	3,058	3,058		
		7						
		70300261	TEMPORARY PAVEMENT MARKING - LINE 12"- PAINT	FOOT	1,044	1,044		
		70300281	TEMPORARY PAVEMENT MARKING - LINE 24"- PAINT	FOOT	701	701		
		70400100	TEMPORARY CONCRETE BARRIER	FOOT	1,300	1,300		
		70400125	PINNING TEMPORARY CONCRETE BARRIER	EACH	210	210		
		70400200	RELOCATE TEMPORARY CONCRETE BARRIER	FOOT	412.5	413		
		70600255	IMPACT ATTENUATORS, TEMPORARY (FULLY REDIRECTIVE, NARROW), TEST LEVEL 2	EACH	8	8		
						•		***************************************
		70600322	IMPACT ATTENUATORS, RELOCATE (FULLY REDIRECTIVE, NARROW), TEST LEVEL 2	EACH	5	5		
Δ		72000100	SIGN PANEL - TYPE 1	SQ FT	56	56		
Δ		72000200	SIGN PANEL - TYPE 2	SQ FT	128	128		
Δ		78000100	THERMOPLASTIC PAVEMENT MARKING - LETTERS AND SYMBOLS	SQ FT	458	458		

* INDICATES SPECIAL PROVISION



USER NAME = Readway	DESIGNED -	TBH	REVISED -
	DRAWN	V7	REVISED
PLOT SCALE = 2.0000 ' / in.	CHECKED .	DD	REVISED +
PLOT DATE = 8/8/2022	DATE -	8/8/2022	REVISED -

STATE OF ILLINOIS
DEPARTMENT OF TRANSPORTATION

WASHINGTON STREET BRIDGE									
i	S	UMMA	RY	OF QUA	ANTITIES				
SCALE; N.T.S.	SHEET	9 OF	23	SHEETS	STA.	TO STA.			

						80% FED	20% STATE	100% CITY
SPECIALTY ITEM	SP	CODE NO.	ITEM	UNIT	TOTAL	RDWY 0004	BRIDGE REPLACE 0010	RDWY 0004
Δ		78000200	THERMOPLASTIC PAVEMENT MARKING - LINE 4"	FOOT	4,019	4,019		
Δ		78000400	THERMOPLASTIC PAVEMENT MARKING - LINE 6"	FOOT	1,506	1,506		
Δ		78000600	THERMOPLASTIC PAVEMENT MARKING - LINE 12"	F00T	267	267		
Δ		78000650	THERMOPLASTIC PAVEMENT MARKING - LINE 24"	FOOT	293	293		
Δ		78008200	POLYUREA PAVEMENT MARKING TYPE I - LETTERS AND SYMBOLS	SQ FT	37	37		
				and the second s				
Δ		78008210	POLYUREA PAVEMENT MARKING TYPE I - LINE 4"	FOOT	475	475		
Δ		78008230	POLYUREA PAVEMENT MARKING TYPE I - LINE 6"	FOOT	146	146		
Δ		78200011	BARRIER WALL REFLECTORS, TYPE C	EACH	104	104		
Δ		78300202	PAVEMENT MARKING REMOVAL - WATER BLASTING	SQ FT	16,395	16,395		
Δ		81028200	UNDERGROUND CONDUIT, GALVANIZED STEEL, 2" DIA.	FOOT	625	625		
Δ		81028220	UNDERGROUND CONDUIT, GALVANIZED STEEL, 3" DIA.	FOOT	122	122		
Δ		81028240	UNDERGROUND CONDUIT, GALVANIZED STEEL, 4" DIA.	FOOT	250	250		
Δ		81028250	UNDERGROUND CONDUIT, GALVANIZED STEEL, 5" DIA.	1001	11/	117		

Δ		81028330	UNDERGROUND CONDUIT, PVC, 1 1/4" DIA.	FOOT	25	25		

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USER NAME = Roadway	DESIGNED	-	TBH	REVISED -
	DRAWN	+	VΖ	REVISED -
PLOT SCALE = 2.0000 ' / in.	CHECKED	• .	DD	REVISED -
PLOT DATE = 8/8/2022	DATE	-	8/8/2022	REVISED -

WASHINGTON STREET BRIDGE SUMMARY OF QUANTITIES									
SCALE: N.T.S.	SHEET	10 OF	23	SHEETS	STA.	TO STA.			

F.A.U. RTE,	SEC*	ПОИ		COUNTY	TOTAL	SHEE
2552	16-0016	DUPAGE	261	14		
				CONTRACT	NO. 6	1G82
FED. R	OAD DIST, NO.	ILLINOIS	FED. A	D PROJECT		

						80% FED :	100% CITY	
SPECIALTY ITEM	SP	CODE NO.	ITEM .	UNIT	TOTAL	RDWY 0004	BRIDGE REPLACE 0010	RDWY 0004
Δ		81028400	UNDERGROUND CONDUIT, PVC, 5" DIA.	FOOT	120	120		
Δ		81028720	UNDERGROUND CONDUIT, COILABLE NONMETALLIC CONDUIT, 1" DIA.	FOOT	474	474		
							7	
Δ		81028740	UNDERGROUND CONDUIT, COILABLE NONMETALLIC CONDUIT, 1 1/2" DIA.	FOOT	791	791		Annavan
Δ		81100320	CONDUIT ATTACHED TO STRUCTURE, 1" DIA., PVC COATED GALVANIZED STEEL	FOOT	10	10		
Δ		81200220	CONDUIT EMBEDDED IN STRUCTURE, 1 1/2" DIA., PVC	FOOT	134	134		
Δ		81200230	CONDUIT EMBEDDED IN STRUCTURE, 2" DIA., PVC	FOOT	260	260		
Δ		81301110	JUNCTION BOX, STAINLESS STEEL, EMBEDDED IN STRUCTURE, 12" X 8" X 6"	EACH	12	12		
Δ		83400100	HANDHOLE	EACH	9	9		
Δ		81400200	HEAVY-DUTY HANDHOLE	EACH	4	4		
Δ		81400730	HANDHOLE, COMPOSITE CONCRETE	EACH	2	2		
Δ		81603047	UNIT DUCT, 600V, 3-1C NO.6, 1/C NO.6 GROUND, (XLP-TYPE USE), 1 1/4" DIA, POLYETHYLENE	FOOT	559	559		
Δ		81702110	ELECTRIC CABLE IN CONDUIT, 600V (XLP-TYPE USE) 1/C NO. 10	FOOT	1,620	1,620		

Δ		81702120	ELECTRIC CABLE IN CONDUIT, 600V (XLP-TYPE USE) 1/C NO. 8	FOOT	35	35		

Δ		81702130	ELECTRIC CABLE IN CONDUIT, 600V (XLP-TYPE USE) 1/C NO. 6	FOOT	6,562	6,562		The state of the s
		f						
	•	•						

* INDICATES SPECIAL PROVISION



USER NAME == Roadway	DESIGNED	-	ТВН	REVISED	-
	DRAWN	-	VZ	REVISED	•
PLOT SCALE = 2.0000 ' / in.	CHECKED	-	OD	REVISED	•
PLOT DATE == 8/8/2022	DATE		8/8/2022	REVISED	-

WASHINGTON STREET BRIDGE SUMMARY OF QUANTITIES								
SCALE: N.T.S. SHEET 11 OF 23 SHEETS STA. TO ST								

F.A.U. RTE.	SEC	TION	COUNTY	TOTAL SHEETS	SHEET NO.	
2552		16-00167-00-BR			261	15
				CONTRACT	NO. 6	1G82
FED. RO	DAD DIST. NO.	ILLINO15	FED. A	D PROJECT		

					80% FED 20% STATE		100% CITY	
SPECIALTY ITEM	SP	CODE NO.	ITEM	UNIT	TOTAL	RDWY 0004	BRIDGE REPLACE 0010	RDWY 0004
Δ		81800230	AERIAL CABLE, 2-1/C NO. 6 WITH MESSENGER WIRE	FOOT	595	595		
Δ	*	82110008	LUMINAIRE, LED, ROADWAY, OUTPUT DESIGNATION H	EACH	3	3		
Δ		83008500	LIGHT POLE, ALUMINUM, 40 FT. M.H., 12 FT. MAST ARM	EACH	1	1		
Δ		83012100	LIGHT POLE, ALUMINUM, 30 FT. M.H., TENON MOUNT	EACH	2	2		
Δ		83050800	LIGHT POLE, ALUMINUM, 47.5 FT. M.H., 12 FT. MAST ARM	EACH	2	2		
Δ		83057355	LIGHT POLE, WOOD, 60 FOOT, CLASS 4, WITH 15FT MAST ARM	EACH	4	4		
								average and a second
Δ		83600200	LIGHT POLE FOUNDATION, 24" DIAMETER	FOOT	38	38		
Δ		83600356	LIGHT POLE FOUNDATION, METAL, 15" BOLT CIRCLE, 8 5/8" X 6'	EACH	1	1		
Δ		83800205	Breakaway Device, Transformer Base, 15 Inch Bolt Circle	EACH	5	5		
Δ		84200500	REMOVAL OF LIGHTING UNIT, SALVAGE	EACH	10	10		
Δ		84200804	REMOVAL OF POLE FOUNDATION	EACH	11	11		
Δ	*	85000200	MAINTENANCE OF EXISTING TRAFFIC SIGNAL INSTALLATION	EACH	4	4	and an analysis of the state of	
Δ		87300925	ELECTRIC CABLE IN CONDUIT, TRACER, NO. 14 1C	FOOT	935	935		
Δ		87301215	ELECTRIC CABLE IN CONDUIT, SIGNAL NO. 14 2C	FOOT	712	712		

* INDICATES SPECIAL PROVISION

CiorbaGroup
8725 W. Higgins Rd, Ste 600, Chicago, IL 60631
P 773.775.4009 | www.ciorba.com

USER NAME → Roadway	DESIGNED	-	твн	REVISED	-
	DRAWN	,	VZ	REVISED	-
PLOT SCALE = 2.0000 ' / in.	CHECKED	-	DD	REVISED	-
PLOT DATE == 8/8/2022	DATE	-	8/8/2022	REVISED	-

SCALE: N.T.S.

 F.A.U. SECTION			COUNTY	TOTAL SHEETS	SHEET NO.	
2552	16-0016	DUPAGE	261	16		
		CONTRACT NO. 61G82				
FED. R	OAD DIST. NO.	ILLINOIS	FED. A	D PROJECT		

						80% FED 2	20% STATE	100% CITY
SPECIALTY ITEM	SP	CODE NO.	ITEM	UNIT	TOTAL	RDWY 0004	BRIDGE REPLACE 0010	RDWY 0004
Δ		87301225	ELECTRIC CABLE IN CONDUIT, SIGNAL NO. 14 3C	FOOT	1,030	1,030		
Δ		87301245	ELECTRIC CABLE IN CONDUIT, SIGNAL NO. 14 5C	FOOT	2,027	2,027		
Δ		87301255	ELECTRIC CABLE IN CONDUIT, SIGNAL NO. 14 7C	FOOT	922	922		

Δ		87301305	ELECTRIC CABLE IN CONDUIT, LEAD-IN, NO. 14 1 PAIR	FOOT	767	767		
Δ		87301805	ELECTRIC CABLE IN CONDUIT, SERVICE, NO. 6 2 C	FOOT	153	153		***************************************
Δ		87301900	ELECTRIC CABLE IN CONDUIT, EQUIPMENT GROUNDING CONDUCTOR, NO. 6 1C	FOOT	486	486		
Δ		87502440	TRAFFIC SIGNAL POST, GALVANIZED STEEL 10 FT.	EACH	1	1		
Δ		87502500	TRAFFIC SIGNAL POST, GALVANIZED STEEL 16 FT.	EACH	1	1		
Δ		87700210	STEEL MAST ARM ASSEMBLY AND POLE, 34 FT.	EACH	1	1		
Δ		87702910	STEEL COMBINATION MAST ARM ASSEMBLY AND POLE 36 FT.	EACH	1	1		
Δ		87702940	STEEL COMBINATION MAST ARM ASSEMBLY AND POLE 42 FT.	EACH	1	1		
							e e e e e e e e e e e e e e e e e e e	
Δ		87800100	CONCRETE FOUNDATION, TYPE A	FOOT	4	4		
Δ		87800415	CONCRETE FOUNDATION, TYPE E 36-INCH DIAMETER	FOOT	38	38		
Δ		87900205	DRILL EXISTING HEAVY DUTY HANDHOLE	EACH	4	4		

 Δ denotes specialty item

* INDICATES SPECIAL PROVISION

CiorbaGroup

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	USER NAME = Roadway	DESIGNED	-	твн	REVISED	
		DRAWN	•	VZ	REVISED	-
Ì	PLOT SCALE == 2.0000 ' / in.	CHECKED		DD	REVISED	-
	PLOT DATE == 8/8/2022	DATE	-	8/8/2022	REVISED	-
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SCALE:

						80% FED	20% STATE	100% CITY
SPECIALTY	SP	CODE NO.	ITEM	UNIT	TOTAL	RDWY 0004	BRIDGE REPLACE 0010	RDWY 0004
Δ		88030020	SIGNAL HEAD, LED, 1-FACE, 3-SECTION, MAST-ARM MOUNTED	EACH	8	8		
Δ		88030100	SIGNAL HEAD, LED, 1-FACE, 5-SECTION, BRACKET MOUNTED	EACH	3	3		
Δ		88030110	SIGNAL HEAD, LED, 1-FACE, 5-SECTION, MAST-ARM MOUNTED	EACH	3	3		
			APPECTATION CICHAL HEAD CED 1 FACE SDACKET MOUNTED WITH					
Δ		88102717	PEDESTRIAN SIGNAL HEAD, LED, 1-FACE, BRACKET MOUNTED WITH COUNTDOWN TIMER	EACH	6			
Δ		88200410	TRAFFIC SIGNAL BACKPLATE, LOUVERED, FORMED PLASTIC	EACH	11	11		
		88200410	TRAFFIC SIGNAL BACKFEATE, LOUVERD, TORNIES TEASTIC	Encil	**	**		
Δ		88600100	DETECTOR LOOP, TYPE I	FOOT	402	402		THE STATE OF THE S
Δ		88700200	LIGHT DETECTOR	EACH	2	2		THE
Δ		88700300	LIGHT DETECTOR AMPLIFIER	EACH	1	1		
								
Δ		89000100	TEMPORARY TRAFFIC SIGNAL INSTALLATION	EACH	2	2		***************************************
Δ	*	89502210	MODIFY EXISTING CONTROLLER CABINET	EACH	3	3		
				FOOT	4.005	4.005		
Δ	**************************************	89502300	REMOVE ELECTRIC CABLE FROM CONDUIT	FOOT	4,095	4,095		
Δ	*	89502375	REMOVE EXISTING TRAFFIC SIGNAL EQUIPMENT	EACH	2	2		
			-					
Δ		89502380	REMOVE EXISTING HANDHOLE	EACH	7	7		
Δ		89502385	REMOVE EXISTING CONCRETE FOUNDATION	EACH	5	5		

* INDICATES SPECIAL PROVISION



-	USER NAME = Roadway	DESIGNED		твн	REVISED	-
		DRAWN		VZ	REVISED	-
	PLOT SCALE = 2.0000 ' / in.	CHECKED	-	DD	REVISED	-
	PLOT DATE	DATE		8/8/2022	REVISED	•

SCALE:

						80% FED 2	20% STATE	100% CfTY
SPECIAL TY ITEM	SP	CODE NO.	ITEM	UNIT	TOTAL	RDWY 0004	BRIDGE REPLACE 0010	RDWY 0004
Δ	*	B2000766	TREE, AMELANCHIER X GRANDIFLORA AUTUMN BRILLIANCE (AUTUMN BRILLIANCE SERVICE BERRY), 6' HEIGHT, SHRUB FORM, BALLED AND BURLAPPED	EACH	2	2		

Δ	*	B2001166	TREE, CERCIS CANADENSIS (EASTERN REDBUD), 6' HEIGHT, CLUMP FORM, BALLED AND BURLAPPED	EACH	1	1		
Δ	*	C20023G5	SHRUB, DIERVILLA LONICERA (BUSH HONEY SUCKLE), 5-GALLON	EACH	20	20		
			SHRUB, JUNIPERUS CHINENSIS KALLAY'S COMPACT (KALLAY'S COMPACT					-
Δ	*	C2015300	JUNIOR), CONTAINER GROWN, 3-GALLON	EACH	13	13		
Δ	*	K0012990	PERENNIAL PLANTS, ORNAMENTAL TYPE, GALLON POT	TINU	1	1		
Δ	*	K0026850	PERENNIAL PLANT CARE	SQ YD	150	150		
	*	X0300266	WOODEN FENCE REMOVAL	F00T	22	22		

Δ	*	X0300635	PLANTER	EACH	4		4	
	*	X0320051	CROSSHOLE SONIC LOGGING ACCESS DUCTS	FOOT	991		991	

	*	X0320052	CROSSHOLE SONIC LOGGING TESTING	EACH	9		9	
	*	X0322208	TEMPORARY STORM SEWER PLUGS	EACH	1	1		
				:				
Δ	*	X0322464	ABANDON AND FILL EXISTING SANITARY MANHOLE	EACH	3	1		2
	*	X0322916	PROPOSED STORM SEWER CONNECTION TO EXISTING STORM SEWER	EACH	1	1		
	*	X0322917	PROPOSED STORM SEWER CONNECTION TO EXISTING MANHOLE	EACH	1	1		
	<u></u>							

* INDICATES SPECIAL PROVISION



	USER NAME = Roadway	DESIGNED	-	твн	REVISED	•
1		DRAWN	-	VŽ	REVISED	•
	PLOT SCALE = 2.0000 ' / in.	CHECKED	•	DD	REVISED	•
	PLOT DATE	DATE	-	8/8/2022	REVISED	-
		·				

SCALE:

						80% FED	20% STATE	100% CITY
SPECIALTY ITEM	SP	CODE NO.	ІТЕМ	UNIT	TOTAL	RDWY 0004	BRIDGE REPLACE 0010	RDWY 0004
	*	X0322918	PROPOSED MANHOLE/CATCH BASIN CONNECTION OVER EXISTING STORM SEWER	EACH	5	5		
Δ	*	X0323449 REMOVE EXISTING WATER VALVE		EACH	7	4		3
	*	X0324056	REMOVAL OF EXISTING WOOD BOLLARDS	EACH	7	7		
Δ	*	X0324085	EMERGENCY VEHICLE PRIORITY SYSTEM LINE SENSOR CABLE, NO. 20 3/C	FOOT	276	276		
	*	X0324450	SEGMENTAL CONCRETE BLOCK WALL, SPECIAL	SQ FT	150			150
Δ	*	X0324599	ROD AND CLEAN EXISTING CONDUIT	FOOT	442	442		
Δ	*	X0325970	SOIL CONDITIONER 3"	SQ YD	10	10		
Δ	*	X0326407	WOOD GATE ASSEMBLY SPECIAL	EACH	1	1		
Δ	*	X0326485	DECORATIVE RAILING (DECK MOUNTED)	FOOT	120		120	
Δ	*	X0326486	DECORATIVE RAILING (PARAPET MOUNTED)	FOOT	58		58	
	*	X0326519	STEEL RAILING REMOVAL	FOOT	95	95		
Δ	*	X0326712	ABANDON AND FILL EXISTING SANITARY SEWER	EACH	7	2		5
	*	X0326806	WASHOUT BASIN	L SUM	1	1		
	*	X0326864	BRICK SIDEWALK REMOVAL	SQ FT	1,358	1,358		
	*	X0327357	CONSTRUCTION VIBRATION MONITORING	L SUM	1	1		

* INDICATES SPECIAL PROVISION

COUNTY TOTAL SHEET NO.

DUPAGE 261 20



I	USER NAME = Roadway	DESIGNED _	TBH	REVISED _
		DRAWN _	VZ	REVISED _
	PLOT SCALE = 2.0000 · / in.	CHECKED _	DD	REVISED _
j	PLOT DATE = 8/8/2022	DATE _	8/8/2022	REVISED _

SCALE:

								100% CITY
SPECIALTY	SP	CODE NO.	ITEM	UNIT	TOTAL	RDWY 0004	BRIDGE REPLACE 0010	RDWY 0004
	*	X0327611	REMOVE AND REINSTALL BRICK PAVER	SQ FT	2,114	2,114		
	*	X0327645	TEMPORARY SOIL RETENTION SYSTEM (SPECIAL)	SQ FT	384		384	
Δ	*	X0327694	GATE VALVE 8" WITH VAULT, 4' DIAMETER	EACH	1			1
Δ	*	X0327698	LED INTERNALLY ILLUMINATED STREET NAME SIGN	EACH	4	4		THE STATE OF THE S
	*	X0327993	STAIRCASE REMOVAL	L SUM	1	1		
	*	X0327999	ANTI-GRAFFITI COATING	SQ FT	3,058			3,058
						:		
	*	X0350810	BOLLARD REMOVAL	EACH	4	4		
Δ	*	X0487700	SANITARY SEWER REMOVAL 10"	FOOT	17	10		7
	*	X0900075	COFFERDAM (TYPE 1) (IN-STREAM/WETLAND WORK)	EACH	4		4	
Δ	*	X1200130	GATE VALVE 12" WITH VAULT, 5' DIAMETER	EACH	3	3		
Δ	*	X1400007	FIBER OPTIC CABLE IN CONDUIT, 24 FIBERS, SINGLE MODE	FOOT	935	935		
Δ	*	X1400238	LUMINAIRE, LED, SPECIAL	EACH	2	2		
	*	X1400337	WIRELESS IN PAVEMENT DETECTOR	EACH	28	28		
								and the same of th
Δ	*	X1400388	VIDEO VEHICLE DETECTION SYSTEM, SINGLE APPROACH	EACH	1	1		

* INDICATES SPECIAL PROVISION



	USER NAME - Roadway	DESIGNED	•	TBH	REVISED	-
		DRAWN	-	٧٧	REVISED	•
	PLOT SCALE ** 2.0000 ' / in.	CHECKED	-	DD	REVISED	-
	PLOT DATE = 8/8/2022	DATE	-	8/8/2022	REVISED	•
-						

SCALE:

W/	WASHINGTON STREET BRIDGE									
5	SUMMARY OF QUANTITIES									
HEET	17 OF	23	SHEETS	STA.	T	O STA.				

F.A.U. RTE.	SEC	TION	COUNTY	TOTAL SHEETS	SHEET NO.	
2552	15-0016	7-00-BR		DUPAGE	261	21
		CONTRACT NO. 61G82				
FED. R	DAD DIST. NO.	ILLINOIS	FED. A	D PROJECT		

					80% FED :	100% CITY		
SPECIALTY ITEM	SP	CODE NO.	ITEM	UNIT	TOTAL	RDWY 0004	BRIDGE REPLACE 0010	RDWY 0004
Δ	*	X1400424	ELECTRIC CABLE IN CONDUIT, STREET NAME SIGN, NO. 14 3C, TYPE SOOW	FOOT	671	671		
	*	X1700034	FORM LINER TEXTURED SURFACE, SPECIAL	SQ FT	4,190		4,190	
	*	X1700065	CLASS D PATCHES, TYPE IV, 10 INCH (SPECIAL)	SQ YD	231			231
,,,,-,,-,	*	X1700071	CLASS D PATCHES, TYPE II, 10 INCH (SPECIAL)	SQ YD	21			21
	*	X3400004	RETAINING WALL REMOVAL	FOOT	144	144		
	*	X4022000	TEMPORARY ACCESS (COMMERCIAL ENTRANCE)	EACH	10	10		
	*	X4060995	TEMPORARY RAMP. SPECIAL	SQ YD	135	135		
	*	X4400110	TEMPORARY PAVEMENT REMOVAL	SQ YD	296	296		
	*	X4421767	CLASS D PATCHES, TYPE III, 10 INCH (SPECIAL)	SQ YD	22			22
Δ	*	X5091755	PARAPET RAILING, SPECIAL	FOOT	274		274	
		- polytonia a na na		i i				
	*	X5210330	HIGH LOAD MULTI-ROTATIONAL BEARINGS, FIXED - 400K	EACH	9		9	
Δ	*	X5610656	WATER MAIN TO BE ABANDONED, 6"	гоот	1,091	705		386
Δ	*	X5610658	WATER MAIN TO BE ABANDONED, 8"	FOOT	296	65		231
Δ	*	X5610706	WATER MAIN REMOVAL, 6"	FOOT	22	12		10

* INDICATES SPECIAL PROVISION



	USER NAME - Roadway	DESIGNED	-	ТВН	REVISED	-
		DRAWN	-	VZ	REVISED	-
	PLOT SCALE = 2,0000 ' / in.	CHECKED	-	DD	REVISED	-
	PLOT DATE = 8:8/2022	DATE	-	8/8/2022	REVISED	•
_					•	

SCALE:

						80% FED 2	20% STATE	100% CITY
SPECIALTY ITEM	SP	CODE NO.	ITEM	UNIT	TOTAL	RDWY 0004	BRIDGE REPLACE 0010	RDWY 0004
Δ	*	X5610708	WATER MAIN REMOVAL, 8"	FOOT	11			11
Δ	*	X5620104	WATER SERVICE REPLACEMENT, 1.5" - LONG	EACH	1	1		
Δ	*	X5620126	WATER SERVICE LINE, SPECIAL	FOOT	50	50		
Δ	*	X5640175	FIRE HYDRANT COMPLETE	EACH	3	3		
Δ	*	X6020084	MANHOLE, SPECIAL	EACH	2			2
Δ	*	X6026055	SANITARY MANHOLE, SPECIAL	EACH	1			1
Δ	*	X6026622	VALVE VAULTS TO BE REMOVED	EACH	1	1		
	*	X6050040	REMOVING MANHOLES, SPECIAL	EACH	1	1		
Δ	*	X6300155	STEEL PLATE BEAM GUARDRAIL, ATTACHED TO STRUCTURES (SPECIAL)	FOOT	37.5	37.5		
	*	X6640706	TEMPORARY CHAIN LINK FENCE WITH SCREENING, 6'	FOOT	80	80		
	*	X6700410	ENGINEER'S FIELD OFFICE, TYPE A (SPECIAL)	CAL MO	19	19		
	*	X7010216	TRAFFIC CONTROL AND PROTECTION, (SPECIAL)	L SUM	1	1		
Δ	*	X8100863	INTERCEPT EXISTING CONDUIT	EACH	4	4		
Δ	*	X8211008	TEMPORARY LUMINAIRE, LED, ROADWAY, OUTPUT DESIGNATION H	EACH	4	4		
Δ	*	X8250500	LIGHTING UNIT COMPLETE, SPECIAL	EACH	14	14		

 Δ denotes specialty item

* INDICATES SPECIAL PROVISION

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USER NAME = Roadway	DESIGNED -	TBH	REVISED -
	DRAWN -	VZ	REVISED -
PLOT SCALE = 2.0000 / in.	CHECKED -	DD	REVISED -
PLOT DATE = 8/8/2022	DATE -	8/8/2022	REVISED -

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SPECIALTY ITEM	SP	CODE NO.	пем	UNIT	TOTAL	RDWY 0004	BRIDGE REPLACE 0010	RDWY 0004
Δ	*	X8360110	LIGHT POLE FOUNDATION, SPECIAL	гоот	48	48		
Δ	*	X8440120	REMOVE AND RE-ERECT EXISTING LIGHTING UNIT	EACH	3	3		
					_			***************************************
Δ	*	X8760200	ACCESSIBLE PEDESTRIAN SIGNALS	EACH	6	6		
Δ	*	X8780012	CONCRETE FOUNDATION, TYPE A 12-INCH DIAMETER	FOOT	6	6		
	*	XX003424	CONNECTION TO EXISTING STRUCTURE	EACH	7	7		
Δ	*	XX003470	SANITARY CLEANOUT 6"	EACH	2	2		
	*	XX003516	CONNECTION TO EXISTING WATER MAIN (NON-PRESSURE) - 8"	EACH	2	1		1
Δ	*	XX003517	CONNECTION TO EXISTING WATER MAIN (NON-PRESSURE) - 6"	EACH	4	3		1
_	*	XX004688	BRICK PAVER SIDEWALK	SQ FT	2,772	2,772		
Δ	*	XX005106	PVC CASING PIPE, 18"	FOOT	59	59		
Δ	*	XX005107	CONNECTIONS TO EXISTING WATER MAINS (NON-PRESSURE) - 12"	EACH	4	2		2
Δ	*	XX005526	SANITARY MANHOLE, 6' DIA	EACH	1			1
	*	XX005845	MODULAR CONCRETE PAVERS (SPECIAL)	SQ FT	898		898	
	*	XX005972	STAMPED ASPHALT CROSSWALK	SQ YD	206	206		
								ACCOUNTMENT ACCOUN

* INDICATES SPECIAL PROVISION



	USER NAME == Roadway	DESIGNED	-	твн	REVISED	-
)		DRAWN	-	VZ	REVISED	-
	PLOT SCALE == 2.0000 ' / fn.	CHECKED	•	DD	REVISED	-
	PLOT DATE = 8/8/2022	DATE	-	8/8/2022	REVISED	•

SCALE;

W	WASHINGTON STREET BRIDGE									
	SUMI									
EΤ	20	OF	23	SHEETS	STA.	TO STA.				

F.A.U. RTE.	SEC	COUNTY	TOTAL SHEETS	SHEET NO.		
2552	16-0016	7-00-BR	DUPAGE	261	24	
		CONTRACT NO. 61G82				
 FED. RO	AD DIST. NO.	ILLINOIS	D PROJECT			

						80% FED	100% CITY	
SPECIALTY ITEM	SP	CODE NO.	ПЕМ	UNIT	TOTAL	RDWY 0004	BRIDGE REPLACE 0010	RDWY 0004
Δ	*	XX006243	WATER SERVICE INSTALL, 1" COMPLETE	EACH	1			1
				1000				
Δ	*	XX006253	SANITARY MANHOLE, 4'-DIAMETER	EACH	3			3
	*	XX006745	FURNISHING, INSTALLING AND STRESSING POST-TENSIONING STRANDS	POUND	40,910		40,910	

	*	XX007174	CONCRETE HEADER BAND, 6"	FOOT	160	160		***************************************
Δ	*	XX007224	GATE VALVE 12" WITH VAULT, 6' DIAMTER (VALVE ATTACHED TO LINE TEE)	EACH	1	1		
	*	XX007415	MONUMENT TYPE A	EACH	12		12	
						!		Assault Hard
	*	XX007416	MONUMENT TYPE B	EACH	2		2,	
	*	XX007417	MONUMENT TYPE C	EACH	2		2	
Δ	*	XX007561	SANITARY SEWER, PVC SDR-21, 12"	FOOT	44			44
	*	XX007788	ORNAMENTAL METAL PANEL	EACH	4	4		
	*	XX008140	REMOVE AND RELOCATE EXISTING PLAQUE	EACH	1	1		
Δ	*	XX008160	DECORATIVE LIGHTING SYSTEM COMPLETE	L SUM	1	1		
Δ	*	XX008959	DUCTILE IRON WATER MAIN (SPECIAL)	FOOT	144	144		
Δ	*	XX009034	FIBER OPTIC TERMINATIONS 12 FIBER	EACH	3	3	:	

* INDICATES SPECIAL PROVISION



USER NAME = Roadway	DESIGNED		ТВН	REVISED	-
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PLOT SCALE = 2.0000 * / in.	CHECKED	-	DD	REVISED	•
PLOT DATE == 8/8/2022	DATE	-	8/8/2022	REVISED	*

SCALE:

	F.A.U. RTE.	SEC	non		COUNTY	TOTAL SHEETS	SHEET NO.
	2552	2552 16-00167-00-BR			DUPAGE	261	25
_					CONTRACT	NO, 61	IG82
		OAD OUT NO	TILINAIC	CED	UD GROVECT		

						80% FED 2	20% STATE	100% CITY
SPECIALTY ITEM	SP	CODE NO.	ITEM	UNIT	TOTAL	RDWY 0004	BRIDGE REPLACE 0010	RDWY 0004
	*	XX009076	ARCHITECTURAL PRECAST CONCRETE PANEL	SQ FT	100	100		
	*	Z0004552	APPROACH SLAB REMOVAL	SQ YD	311	311		
	*	Z0006012	BRIDGE DECK LATEX CONCRETE OVERLAY, 2 1/4 INCHES	SQ YD	822		822	
	*	Z0012142	BRIDGE DECK SCARIFICATION 2 1/4"	SQ YD	61		61	
	*	20012450	CONCRETE STEPS	CU YD	3	3		
						;		
	*	Z0013797	STABILIZED CONSTRUCTION ENTRANCE	SQ YD	223	223		
	*	Z0013798	CONSTRUCTION LAYOUT	L SUM	1	1		
	*	Z0023201	SEDIMENT CONTROL, SILT CURTAIN	EACH	4	4		
	*	Z0030850	TEMPORARY INFORMATION SIGNING	SQ FT	274	274		
Δ	*	Z0033028	MAINTENANCE OF LIGHTING SYSTEM	CAL MO	17	17		

Δ	*	Z0033046	RE-OPTIMIZE TRAFFIC SIGNAL SYSTEM LEVEL 2	EACH	1	1		
	*	Z0042300	PORTLAND CEMENT CONCRETE SIDEWALK CURB	FOOT	26	26		
						vvvii amanima v		
	*	20056668	STORM SEWERS, TYPE 2, WATER MAIN QUALITY PIPE, 12"	FOOT	96	96		
	*	20056670	STORM SEWERS, TYPE 2, WATER MAIN QUALITY PIPE, 18"	FOOT	184	184		
		A territoria					Annuary or an annuary or a	

* INDICATES SPECIAL PROVISION



USER NAME Roadway	DESIGNED	-	твн	REVISED	-
	DRAWN	-	VZ	REVISED	-
PLOT SCALE = 2.0000 ' / in.	CHECKED	-	DD	REVISED	•
PLOT DATE = 8,8/2022	DATE	-	8/8/2022	REVISED	-

STATE OF ILLINOIS DEPARTMENT OF TRANSPORTATION

SCALE:

	UMMA	RY	N STRE	ANTII	 _
SHEET	22 OF	23	SHEETS	STA.	 _

SECTION	COUNTY	TOTAL SHEETS	SHEET NO.
15-00167-00-BR	DUPAGE	261	26

F.A.U. RTE. 2552

TO STA.

FED. ROAD DIST. NO. | ILLINOIS | FED. AID PROJECT

						80% FED	80% FED 20% STATE	
SPECIALTY ITEM	SP	CODE NO.	ITEM	UNIT	TOTAL	RDWY 0004	BRIDGE REPLACE 0010	RDWY 0004
Δ	*	20056800	SANITARY SEWER 6"	FOOT	15			15
Δ	*	Z0057000	SANITARY SEWER 10"	FOOT	336			336
Δ	*	70057100	CANITADY COMED 12#	FOOT	60			60
		20057100	SANITARY SEWER 12"	1001	69			69
Δ	*	Z0057200	SANITARY SEWER 15"	FOOT	65			65
								7711
Δ	*	Z0058000	SANITARY SEWER, SPECIAL	FOOT	303			303

	*	20062456	TEMPORARY PAVEMENT	SQ YD	296	296		
Δ	*	Z0073510	TEMPORARY TRAFFIC SIGNAL TIMING	EACH	2	2		
	*	Z007550S	TIMBER RETAINING WALL REMOVAL	FOOT	50			50
		20013303	THE REPORT	1001				
	*	Z0076600	TRAINEES	HOUR	1,500	1,500		
	*	Z0076604	TRAINEES TRAINING PROGRAM GRADUATE	HOUR	1,500	1,500		
	*	Z0076870	UNDERDRAIN CONNECTION TO STRUCTURE	EACH	17	17		
		_						
	*	XX009546	DUCT BANK, CONCETE, TYPE A	FOOT	200			200
Δ	*	xx009547	DUCT BANK, CONCETE, TYPE B	FOOT	305			305
						-		
Δ	*	xx009548	DUCT BANK, CONCETE, TYPE C	FOOT	50			50
							-	

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 Δ DENOTES SPECIALTY ITEM

* INDICATES SPECIAL PROVISION

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USER NAME ⇒ Roadway	DESIGNED	-	TBH	REVISED	-
	DRAWN	•	VZ	REVISED	-
PLOT SCALE = 2.0000 ' / in.	CHECKED	-	DD	REVISED	-
PLOT DATE == 8/8/2022	DATE	-	8/8/2022	REVISED	•

STATE OF ILLINOIS
DEPARTMENT OF TRANSPORTATION

SCALE;

WA	SHING	TO	N STRE	ET BRID	GE
9	NMMU	RY	OF QU	ANTITIES	5
SHEET	23 OF	23	SHEETS	STA,	TO STA.

 F.A.U. RTE,	SEC	TION		COUNTY	TOTAL SHEETS	SHEET NO.
2552	2552 16-00167-00-BR			DUPAGE	261	21
				CONTRACT	NO. 6	1G82
FED. R	DAO DIST. NO.	ILLINOIS	FED. A	D PROJECT		
 FED. R	DAU DIST. NO.	LICUNOIS	rcu. A	D PROJECT		

					80% FED 2	20% STATE	100% CITY	
SPECIALTY ITEM	SP	CODE NO.	ITEM	UNIT	TOTAL	RDWY 0004	BRIDGE REPLACE 0010	RDWY 0004
	*	xx069549	HIGH PERFORMANCE CONCRETE SUPERSTRUCTURE	CU YD	770.5		770,5	1
	*	XX009550	LOW FLOW WALK	FOOT	114		114	

* INDICATES SPECIAL PROVISION




	USER NAME - Roadway	DESIGNED	-	твн	REVISED	•
-		DRAWN	-	VΣ	REVISED	•
	PLOT SCALE - 2.0000 ' / in,	CHECKED	-	DD	REVISED	-
	PLOT DATE = 8/8/2022	DATE	-	8/8/2022	REVISED	-

SCALE:


LEGEND



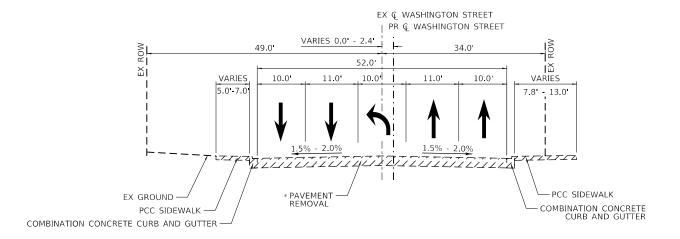

EXISTING TYPICAL SECTION

STA 131+49.62 TO STA 132+57.00 * 4.25" HMA REMOVAL (STA 131+49.62 TO STA 131+87.51)

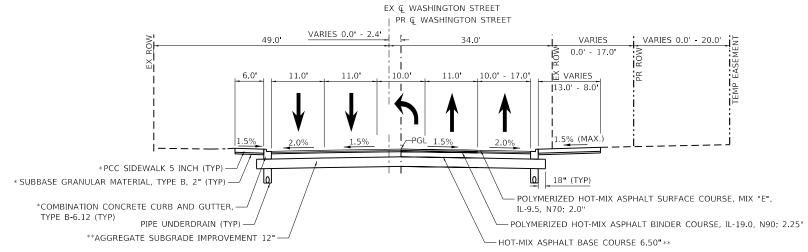

PROPOSED TYPICAL SECTION

STA 131+49.62 TO STA 132+57.00 *STA 131+81.00 TO STA 132+57.00 **STA 131+87.50 TO STA 132+57.00


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8725 W. Higgins Rd, Ste 600, Chicago, IL 60631
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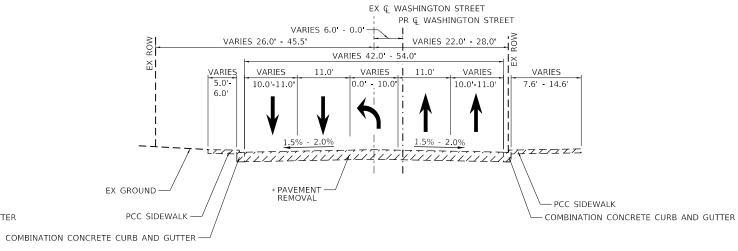
USER NAME = Roadway	DESIGNED -	TBH	REVISED -
	DRAWN -	VZ	REVISED -
PLOT SCALE = 20.0000 ' / in.	CHECKED -	DD	REVISED -
PLOT DATE = 8/8/2022	DATE -	8/8/2022	REVISED -

STATE OF ILLINOIS	
DEPARTMENT OF TRANSPORTATION	

	WASHINGTON STREET BRIDGE							F.A.U. SECTI			COUNTY	TOTAL SHEETS	SHEET NO.	
TYPICAL SECTIONS							2552	16-00167-00-BR			DUPAGE	261	29	
	TIFICAL SECTIONS									CONTRACT NO. 61G82				
	SCALE: 1" = 10'	SHEET	1 OF 3	SHEETS	STA.	TO STA.	FED. ROAD DIST. NO. ILLINOIS FED.			FED. A	AID PROJECT			





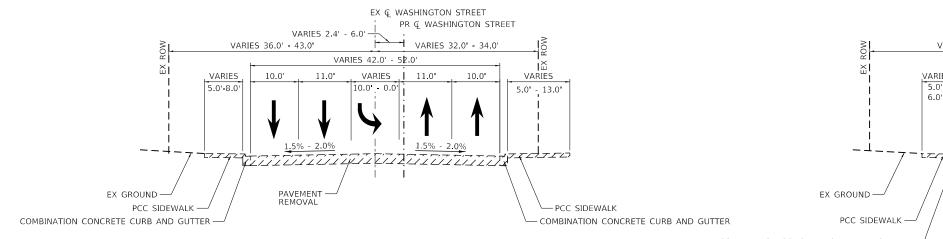



EXISTING TYPICAL SECTION

STA 132+57.00 TO STA 134+32.10 (BRIDGE OMMISION - STA 134+32.10 TO STA 136+29.27)

EXISTING TYPICAL SECTION

STA 136+29.27 TO STA 138+96.31 (BRIDGE OMMISION - STA 134+32.10 TO STA 136+29.27) * 4.25" HMA REMOVAL (STA 138+19.48 TO STA 139+18.00)

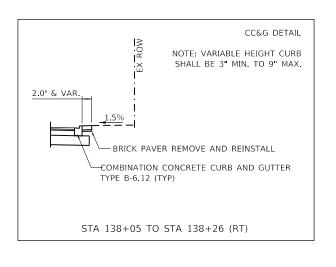

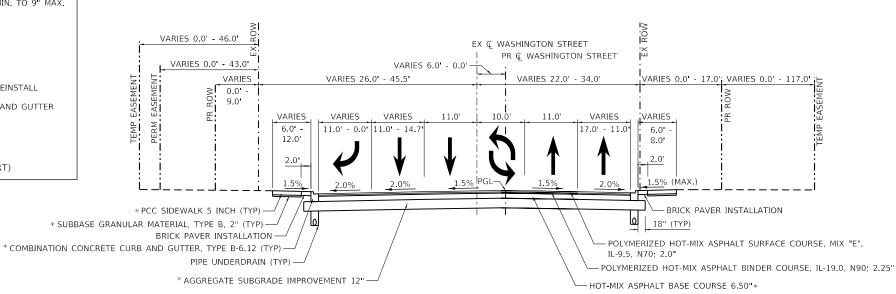

PROPOSED TYPICAL SECTION

STA 132+57.00 TO STA 139+18.00 (BRIDGE OMISSION: STA 134+37.77 TO STA 136+21.37) *STA 132+57.00 TO STA 138+19.25

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//- Ciarha Croup
Cìorba Group
8725 W. Higgins Rd, Ste 600, Chicago, IL 60631
D 772 775 4000 L


USER NAME = Roadway	DESIGNED - TBH	REVISED -
	DRAWN - VZ	REVISED -
PLOT SCALE = 20.0000 ' / in.	CHECKED - DD	REVISED -
PLOT DATE = 8/8/2022	DATE - 8/8/2022	REVISED -

STATE OF ILLINOIS	
DEPARTMENT OF TRANSPORTATION	

WASHINGTON STREET BRIDGE	F.A.U. RTE			COUNTY	TOTAL SHEETS	
TYPICAL SECTIONS	2552	16-0016	7-00-BR	DUPAGE	261	30
TH IOAL SECTIONS		NO. 6	1G82			
SCALE: 1" = 10' SHEET 2 OF 3 SHEETS STA. TO STA.	FED. R	OAD DIST. NO.	ILLINOIS FED. A	ID PROJECT		

EXISTING TYPICAL SECTION

STA 201+76.63 TO STA 203+00.00

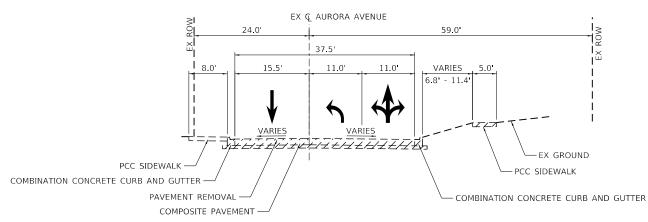

EXISTING TYPICAL SECTION


STA 203+00.00 TO STA 205+00.00

MIXTURE TYPE	PERCENT AIR VOIDS @ NDES	QMP
PAVEMENT RECONSTRUCTION		
POLYMERIZED HOT-MIX ASPHALT SURFACE COURSE, MIX "E", IL-9.5, N70; 2.0"	4% @ 70 GYR.	LR1030-2
POLYMERIZED HOT-MIX ASPHALT BINDER COURSE, IL-19.0, N90; 2.25"	4% @ 90 GYR.	LR1030-2
HOT-MIX ASPHALT BASE COURSE 6.5" (HMA BINDER IL-19.0)	4% @ 90 GYR.	LR1030-2
PAVEMENT RESURFACING	•	
POLYMERIZED HOT-MIX ASPHALT SURFACE COURSE, MIX "E", IL-9.5, N70; 2.0"	4% @ 70 GYR.	LR1030-2
POLYMERIZED HOT-MIX ASPHALT BINDER COURSE, IL-19.0, N90; 2.25"	4% @ 90 GYR.	LR1030-2
PATCHING		
HOT-MIX ASPHALT REPLACEMENT OVER PATCHES (HMA BINDER IL-19.0, N70)	4% @ 70 GYR.	LR1030-2
CLASS D PATCH (HMA BINDER COURSE, IL-19.0)	4% @ 70 GYR.	LR1030-2
CLASS D PATCHES (SPECIAL)		
HOT-MIX ASPHALT SURFACE COURSE, MIX "D", IL-9.5, N70; 2.0"	4% @ 70 GYR.	LR1030-2
HOT-MIX ASPHALT BINDER COURSE, IL-19.0, N70; 8.0"	4% @ 70 GYR.	LR1030-2
PAVEMENT BASE COURSE WIDENING		
HOT-MIX ASPHALT BASE COURSE WIDENING 6.5" (HMA BINDER IL-19.0)	4% @ 90 GYR.	LR1030-2
TEMPORARY PAVEMENT	<u> </u>	
HOT-MIX ASPHALT BINDER COURSE, IL-19.0, N70; 6.0"	4% @ 70 GYR.	LR1030-2
DRIVEWAY		
HOT-MIX ASPHALT SURFACE COURSE, MIX "D", IL-9.5, N50; 1.50"	4% @ 50 GYR.	LR1030-2
HOT-MIX ASPHALT BINDER COURSE, IL-9.5, N50; 2.25"	4% @ 50 GYR.	LR1030-2

EX Q AURORA AVENUE VARIES 45.0 - 59.0 24.0 VARIES 37.0 - 44.0 VARIES VARIES 14.0' - 11.0' 0.0' - 11.0' VARIES TOPSOIL FURNISH AND PLACE, 6" SODDING, SALT TOLERANT ** PCC SIDEWALK 5 INCH** POLYMERIZED HOT-MIX ASPHALT SURFACE COURSE, -SUBBASE GRANULAR MATERIAL, TYPE B, 2*** MIX "E", IL-9.5, N70; 2.0" COMBINATION CONCRETE CURB AND GUTTER, POLYMERIZED HOT-MIX ASPHALT TYPE B-6.12 (TYP) * BINDER COURSE, IL-19.0, N90; 2.25" * AGGREGATE SUBGRADE IMPROVEMENT 12" * HMA BASE COURSE WIDENING 6.5"-

PROPOSED TYPICAL SECTION

STA 201+76.63 TO STA 203+00.00 *STA 202+47.40 TO STA 203+00.00 **STA 202+79.05 TO STA 203+00.00

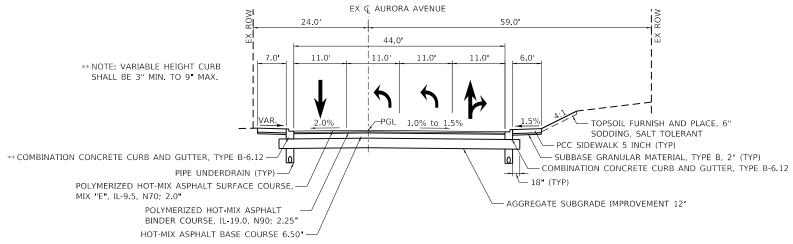

PROPOSED TYPICAL SECTION

STA 203+00.00 TO STA 205+00.00

- THE UNIT WEIGHT USED TO CALCULATE ALL HMA SURFACE MIXTURE QUANTITIES IS 112 LBS/SQ YD/IN.
- 2. THE "AC TYPE" FOR POLYMERIZED HMA MIXES SHALL BE "SBS/SBR PG 76-22" AND FOR NON POLYMERIZED HMA THE "AC TYPE" SHALL BE "PG 64-22" UNLESS MODIFIED BY RECLAIMED MATERIALS SPECIFICATIONS.

QMP DESIGNATION: QUALITY CONTROL/QUALITY ASSURANCE (QC/QA)



USER NAME = Roadway	DESIGNED - TBH	REVISED -
	DRAWN - VZ	REVISED -
PLOT SCALE = 20.0000 ' / in.	CHECKED - DD	REVISED -
PLOT DATE = 8/8/2022	DATE - 8/8/2022	REVISED -

STATE OF ILLINOIS
DEPARTMENT OF TRANSPORTATION

I									F.A.U. SECTION			COUNTY	TOTAL SHEETS	SHEET NO.
	TYPICAL SECTIONS							2552	16-00167-00-BR			DUPAGE	261	31
												CONTRACT NO. 61G82		1G82
	SCALE: 1" = 10'	SHEET	3 OF	3	SHEETS	STA.	TO STA.	FED, R	FED. ROAD DIST. NO. ILLINOIS FED. A		FED. A	ID PROJECT		

[1] COLUMN FOR INFORMATION ONLY.

// Charles Custom	I
Cìorba Group	ŀ
8725 W. Higgins Rd, Ste 600, Chicago, IL 60631	ŀ
P 773.775.4009 www.ciorba.com	l

USER NAME = Roadway	DESIGNED - TBH	REVISED -
	DRAWN - VZ	REVISED -
PLOT SCALE = 2.0000 / in.	CHECKED - DD	REVISED -
PLOT DATE = 8/8/2022	DATE - 8/8/2022	REVISED -

SCALE: N.T.S.

	WASHINGTON STREET BRIDGE			F.A.U. RTE	SEC ⁻	ΓΙΟΝ		COUNTY	TOTAL SHEETS	SHEET NO.					
SCHEDULE OF QUANTITIES					2552	16-0016	7-00-BR		DUPAGE	261	32				
	SOILEDGE OF QUANTITIES									CONTRACT	NO. 6	IG82			
	SHEET	1	OF	1	SHEETS	STA.		TO STA.	FED. R	OAD DIST, NO.	ILLINOIS	FED. A	ID PROJECT		

MODEL: \$MODELNAME\$
FILE NAME: N:PBOIN020794 01/Design

PROJECT COORDINATES


WASHINGTON STREET - PROPOSED ALIGNMENT					
DESCRIPTION	STATION	NORTHING	EASTING		
P.O.T.	125+08.88	1,858,034.15	1,034,645.69		
P.O.T.	131+08.88	1,858,632.14	1,034,694.83		
P.C.	131+49.63	1,858,672.75	1,034,698.17		
P.I.	132+70.20	1,858,792.92	1,034,708.04		
P.T.	133+90.57	1,858,911.46	1,034,730.06		
P.I.	136+69.36	1,859,185.57	1,034,780.97		
P.I.	138+19.48	1,859,334.14	1,034,802.47		
P.I.	139+64.86	1,859,477.08	1,034,829.02		
P.O.T.	143+64.86	1,859,876.67	1,034,847.12		


PROJECT COORDINATES


WASHIN	NGTON STREET	- EXISTING ALIG	NMENT	
DESCRIPTION	STATION	NORTHING	EASTING	
P.O.T.	31+08.88	1,858,632.14	1,034,694.83	
P.C.	32+59.88	1,858,851.60	1,034,714.63	
P.I.	33+29.32	1,858,851.84	1,034,712.88	
P.T.	33+98.65	1,858,920.12	1,034,725.56	
P.O.T.	39+65.14	1,859,477.08	1,034,829.02	


PROJECT COORDINATES

AURORA AVENUE - EXISTING ALIGNMENT								
DESCRIPTION	STATION	NORTHING	EASTING					
P.O.T.	200+00.00	1,858,799.00	1,034,207.33					
P.O.T.	205+00.00	1,858,779.64	1,034,706.95					

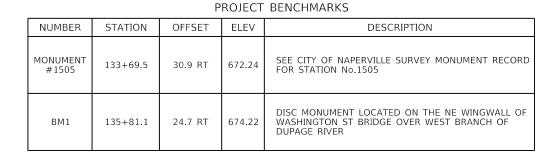

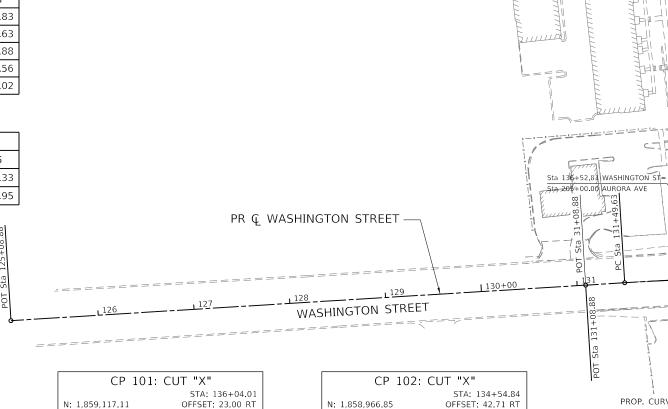

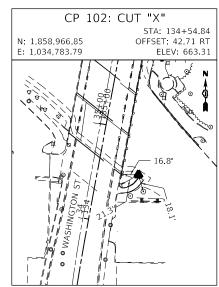

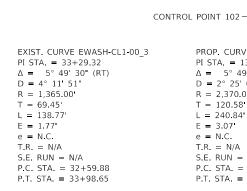

PROP. CURVE PWASH-CL1-01

EXIST. CURVE EWASH-CL1-00 3

CONTROL POINT 100 BM #1505

POT Sta 200+00.00

MAIN STREET

-EX Q AURORA AVENUE

PROP. CURVE PWASH-CL1-01_5 PI STA. = 132+70.20 $\Delta = 5^{\circ} 49' 30'' (RT)$ D = 2° 25' 03" R = 2,370.00T = 120.58L = 240.84E = 3.07' e = N.C. T.R. = N/AS.E. RUN = N/AP.C. STA. = 131+49.63P.T. STA. = 133+90.57

EX Q WASHINGTON STREET -

SN 022-0030-

BENCHMARK 1-

CONTROL POINT 101-




COUNTY

DUPAGE 261 33

CONTRACT NO. 61G82

→ @ Z

DUPAGE RIVER WEST BRANCH

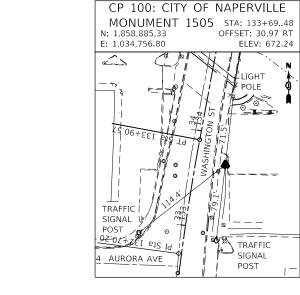

1 1 1 1 1 1 1 1 1 1 1 1 1 1 1 1 1 1 1	CLOCK TOWER BENCHMARK 3
DESIGNED - TBH	REVISED -
DRAWN - VZ	REVISED -

ELEV: 672.51

ROSEBUD

USER NAME = Roadway	DESIGNED -	ТВН	REVISED -
	DRAWN -	VZ	REVISED -
PLOT SCALE = 100.0000 ' / in.	CHECKED -	DD	REVISED -
PLOT DATE = 8/8/2022	DATE -	8/8/2022	REVISED -

E: 1,034,791.65

STATE OF ILLINOIS **DEPARTMENT OF TRANSPORTATION**

						F.A.U. RTE	SECTION		
	ALIGNI	MENT	TIF	SAND	RENG	CHMARKS	S	2552	16-00167-00-BR
	ALIGIN	VII.	,	J, AIID	DEIT		<i>-</i>		
SCALE: 1" = 50"	SHEET	1 0)F 2	SHEETS	STA.	125+08.88	TO STA. 137+00.00		ILLINOIS

CiorbaGroup

8725 W. Higgins Rd, Ste 600, Chicago, IL 60631 P 773.775.4009 | www.ciorba.com



PROJECT COORDINATES

WEST CHICAGO AVENUE - EXISTING ALIGNMENT							
DESCRIPTION	STATION	NORTHING	EASTING				
P.O.T.	400+00.00	1,859,384.21	1,034,408.41				
P.I.	402+64.29	1,859,375.31	1,034,672.55				
P.O.T.	404+02.60	1,859,381.84	1,034,810.70				

EX Q WASHINGTON STREET -

PROJECT COORDINATES

EAST CHICAGO AVENUE - EXISTING ALIGNMENT							
DESCRIPTION	STATION	NORTHING	EASTING				
P.O.T.	300+00.00	1,859,379.40	1,034,810.87				
P.I.	303+00.73	1,859,400.94	1,035,110.83				
P.I.	304+33.97	1,859,419.12	1,035,242.83				
P.O.T.	305+82.21	1,859,430.28	1,035,390.65				



POT Sta 305+82.21

EX Q WEST CHICAGO AVENUE

POT Sta 400+00.00

0 50' 100'




USER NAME = Roadway	DESIGNED - TBH	REVISED -	
	DRAWN - VZ	REVISED -	
PLOT SCALE = 100.0000 ' / in.	CHECKED - DD	REVISED -	
PLOT DATE = 8/8/2022	DATE - 8/8/2022	REVISED -	


STATE OF ILLINOIS
DEPARTMENT OF TRANSPORTATION


		WASHINGTON STREET BRIDGE											
ALIGNMENT, TIES, AND BENCHMARKS													
	SCALE: 1" = 50'	SHEET	2	OF	2	SHEETS	STA.	137+00.00	TO STA. 143+64.86				


RTE	SEC ⁻	ΓΙΟΝ	COUNTY	SHEETS	NO.	
2552	16-0016	7-00-BR		DUPAGE	261	34
			CONTRACT NO. 61G82			
		ILLINOIS	FED. A	ID PROJECT		


MODEL: \$MODELNAME\$
FILE NAME: NVPBON0020794 01/Design(N

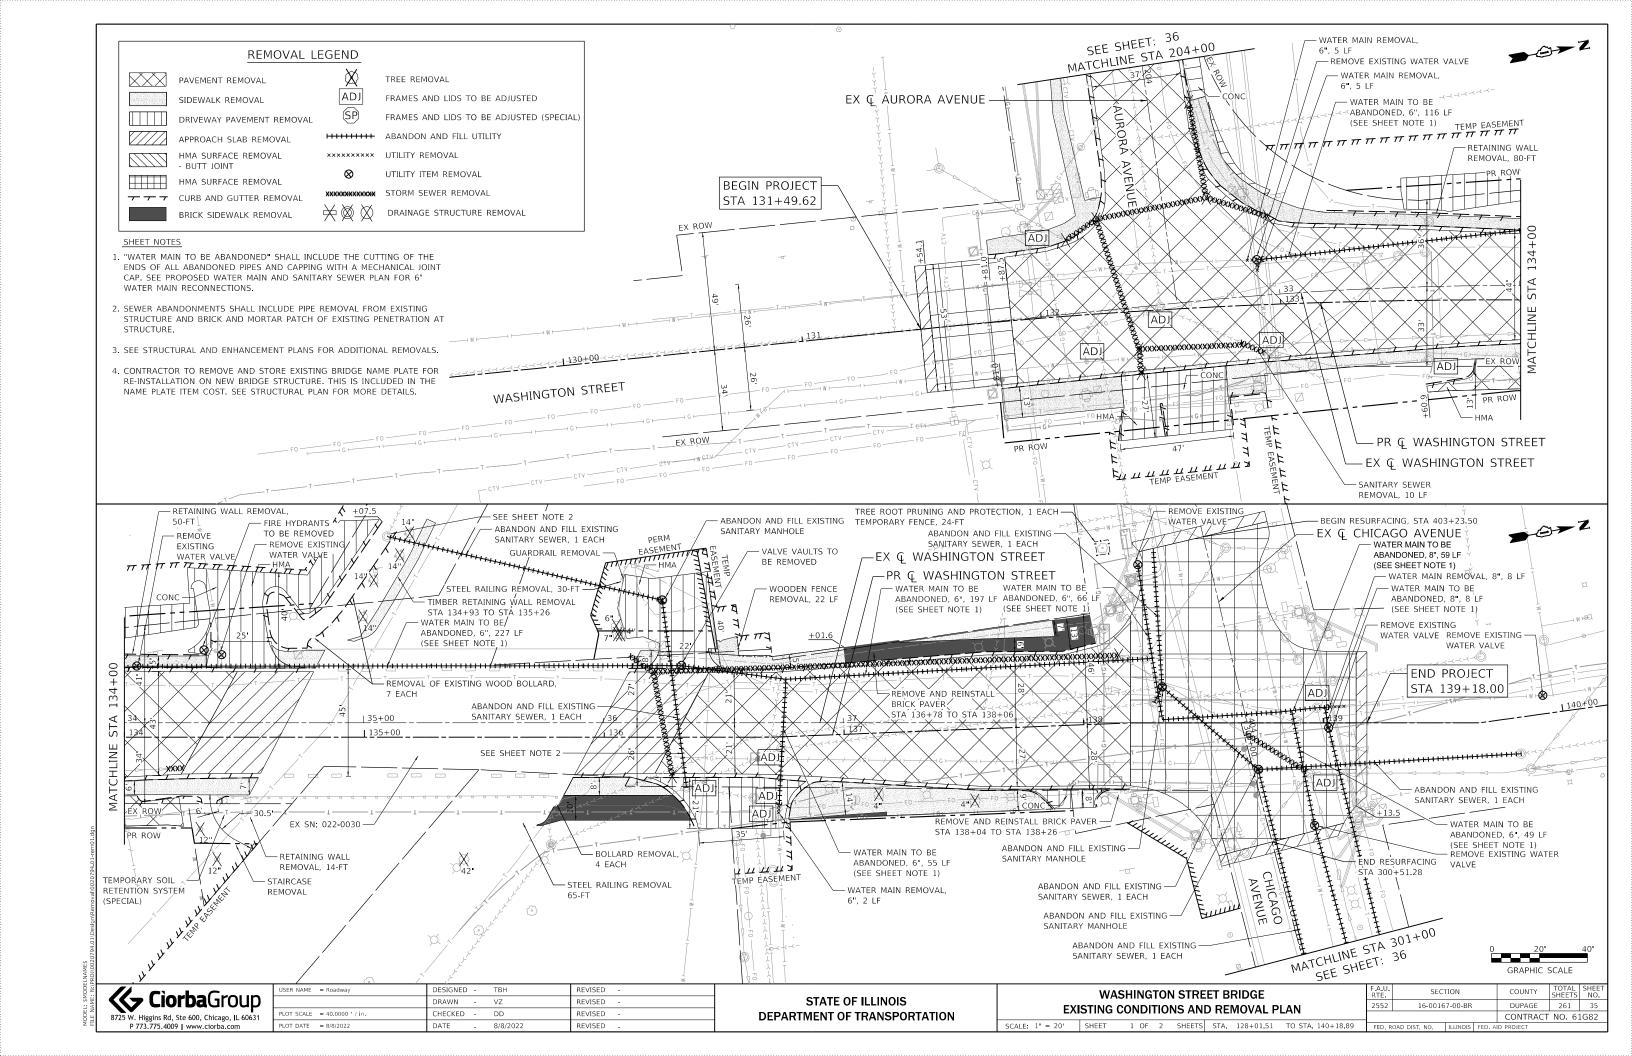


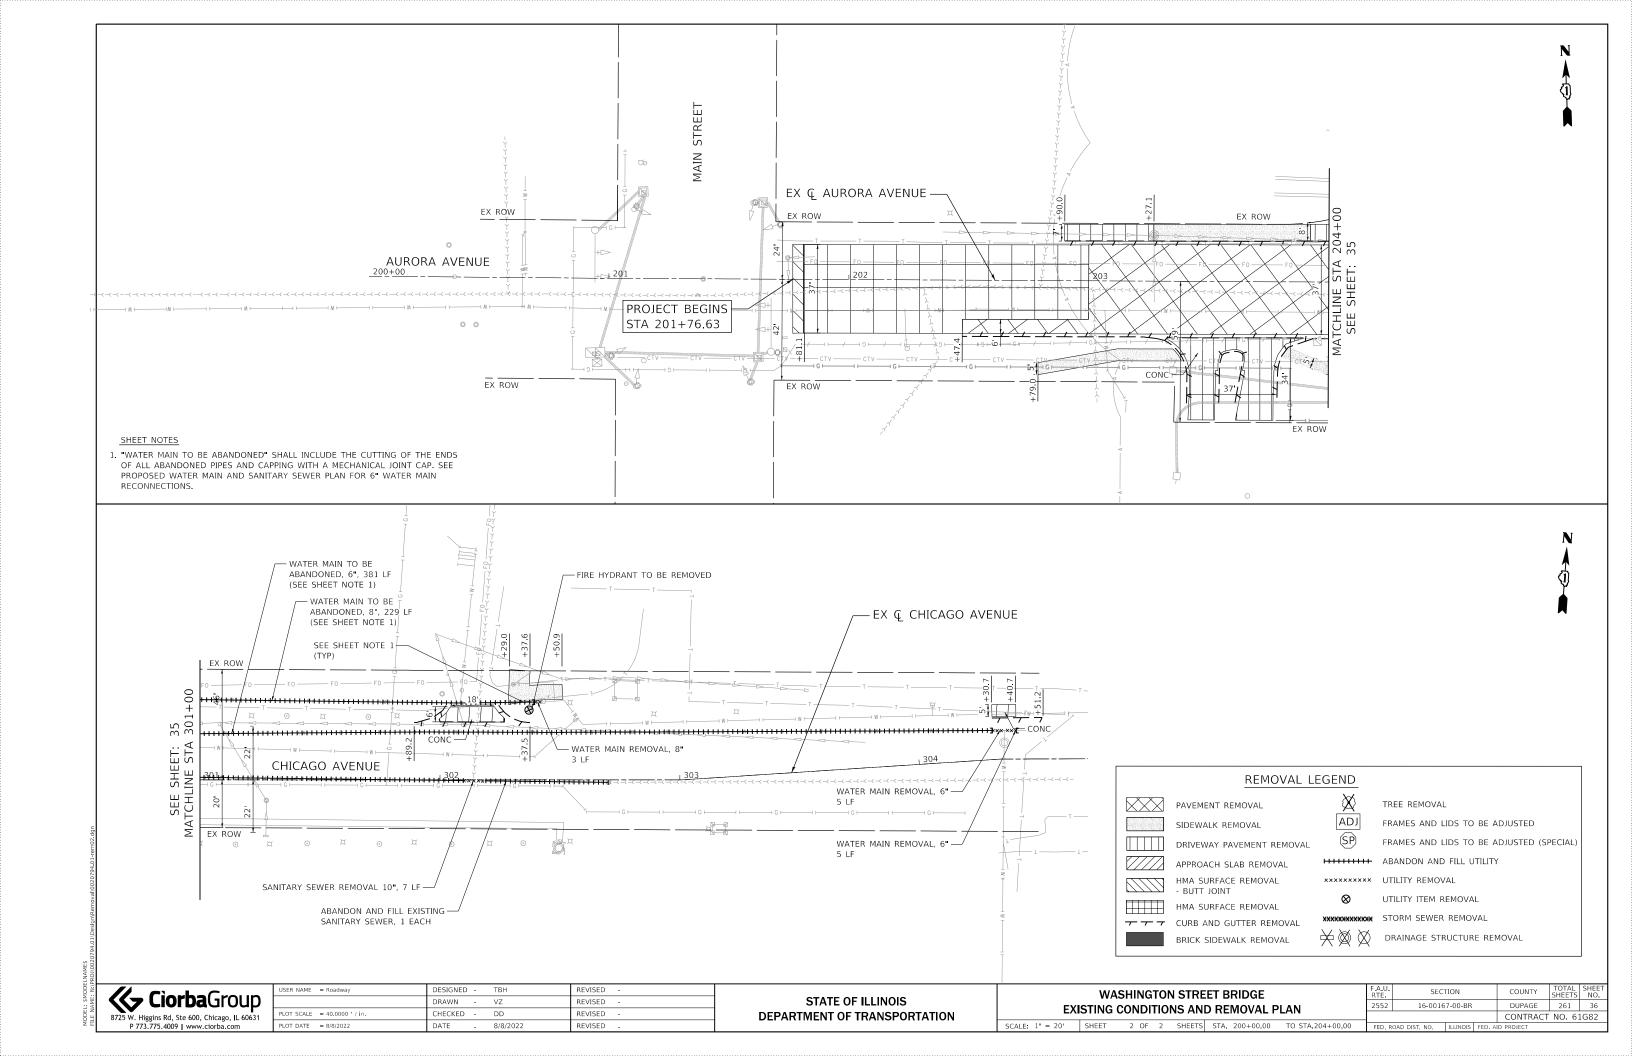

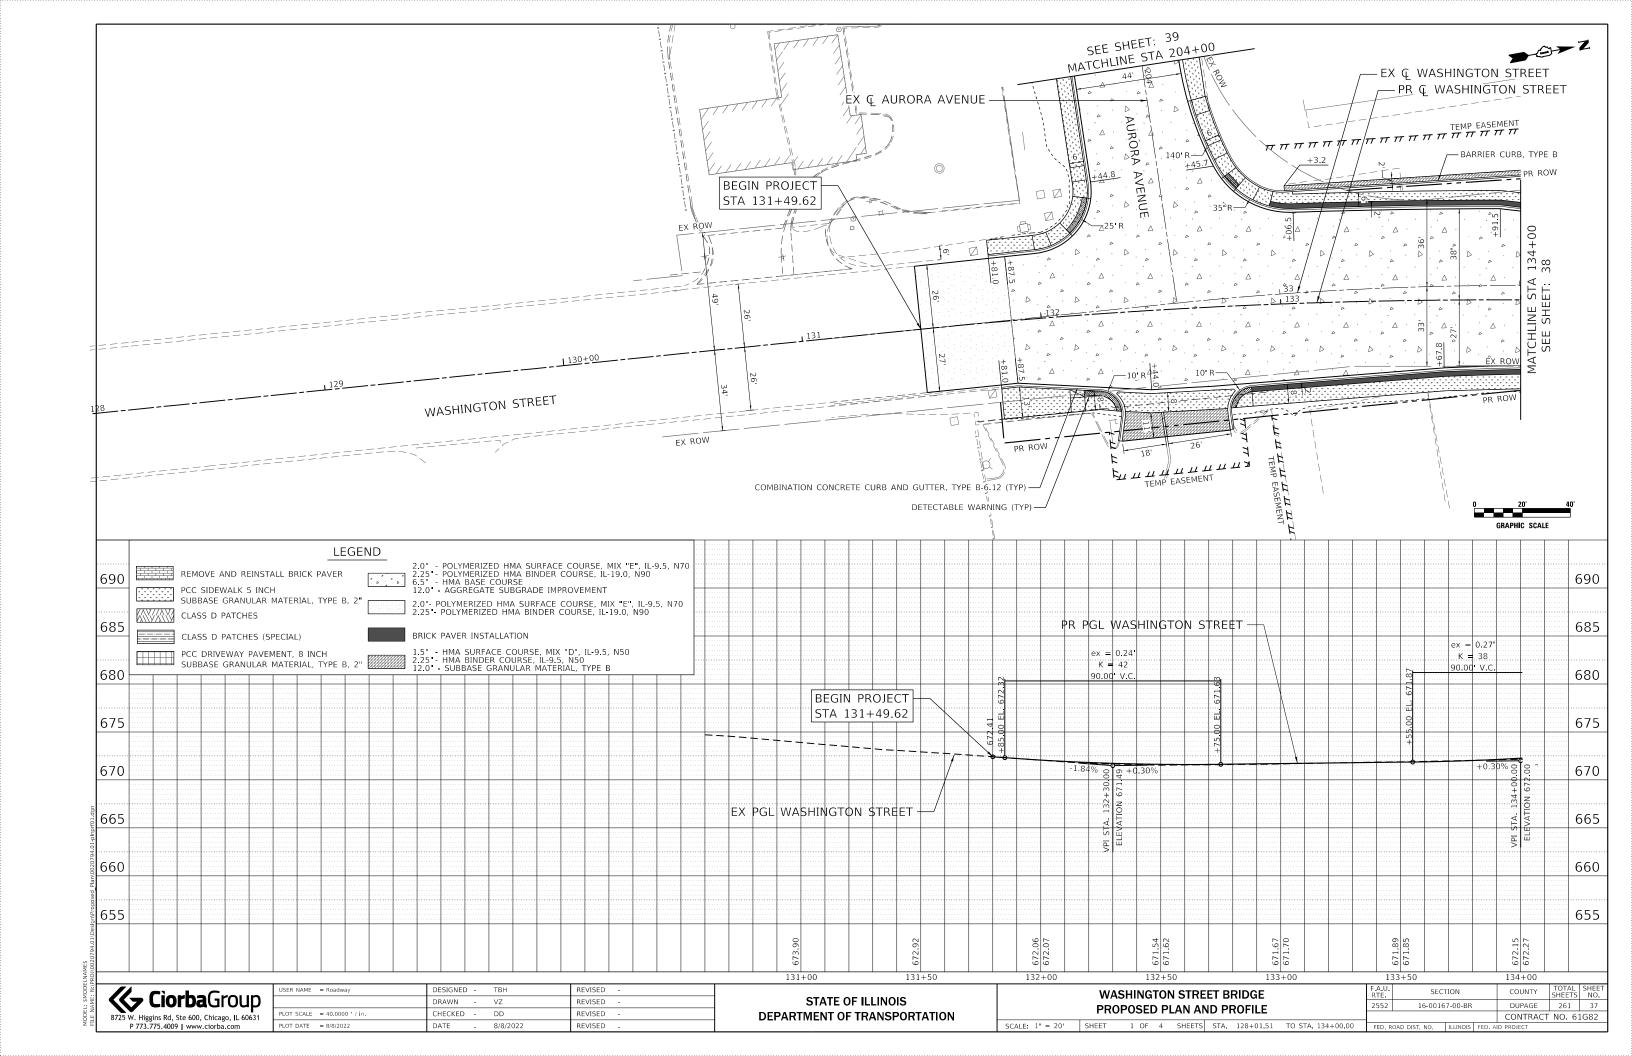

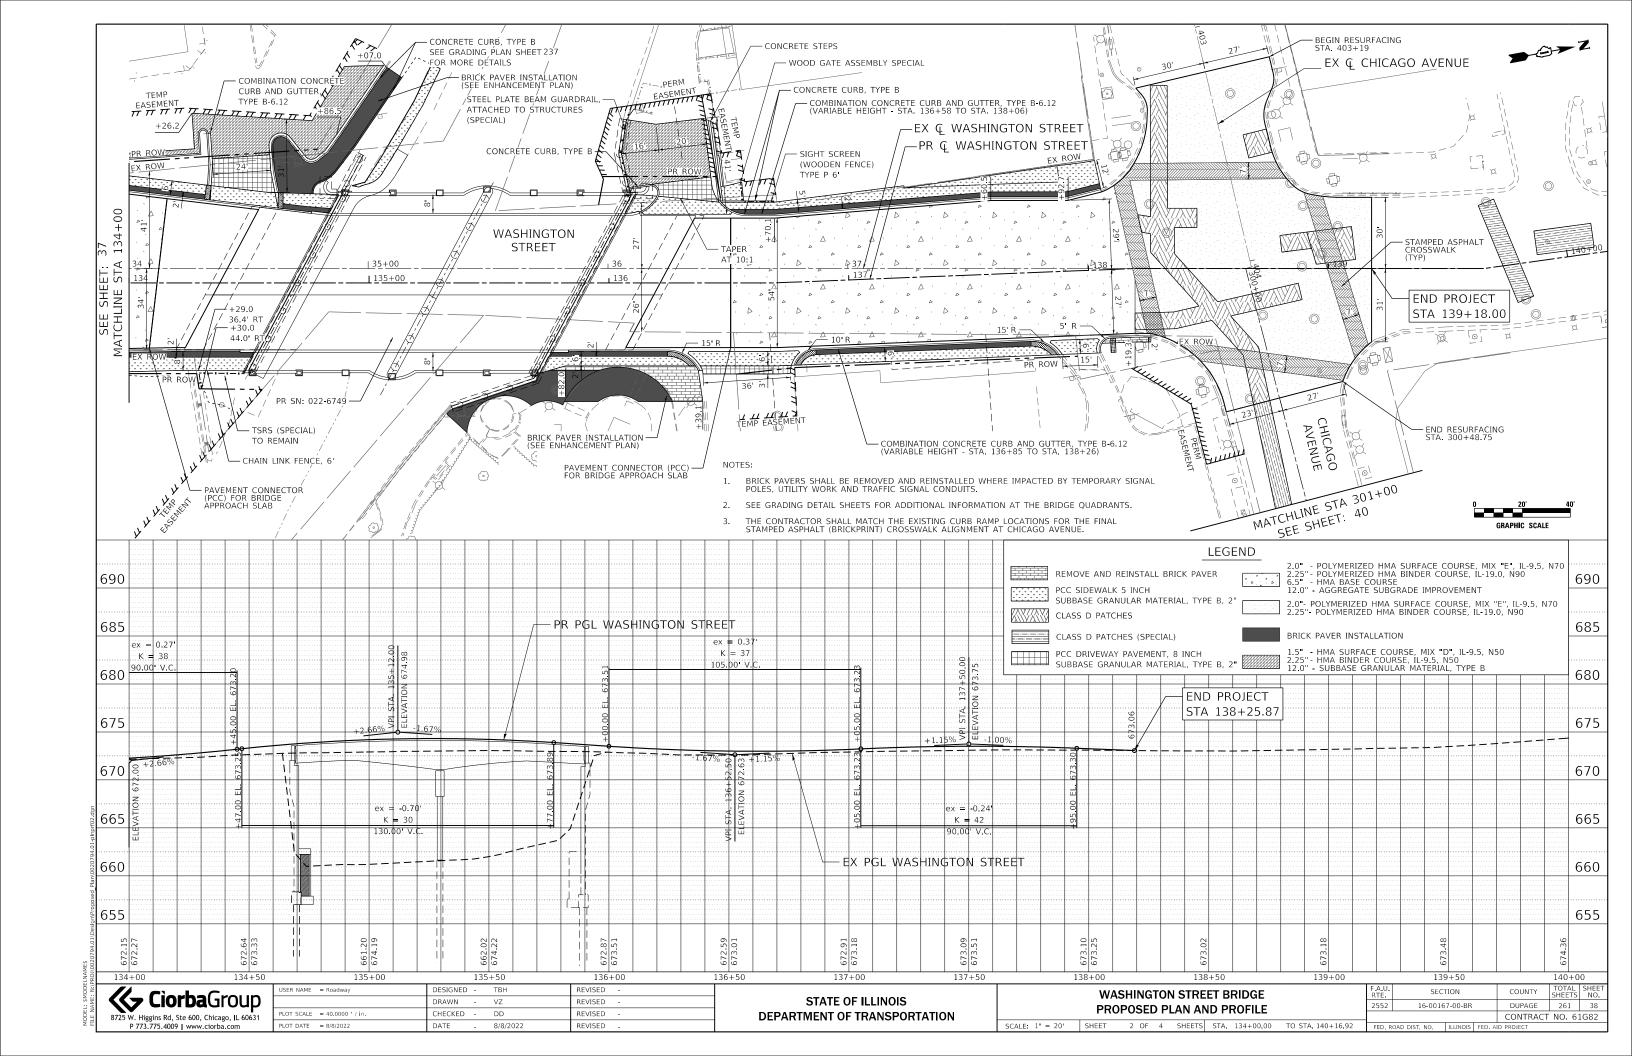

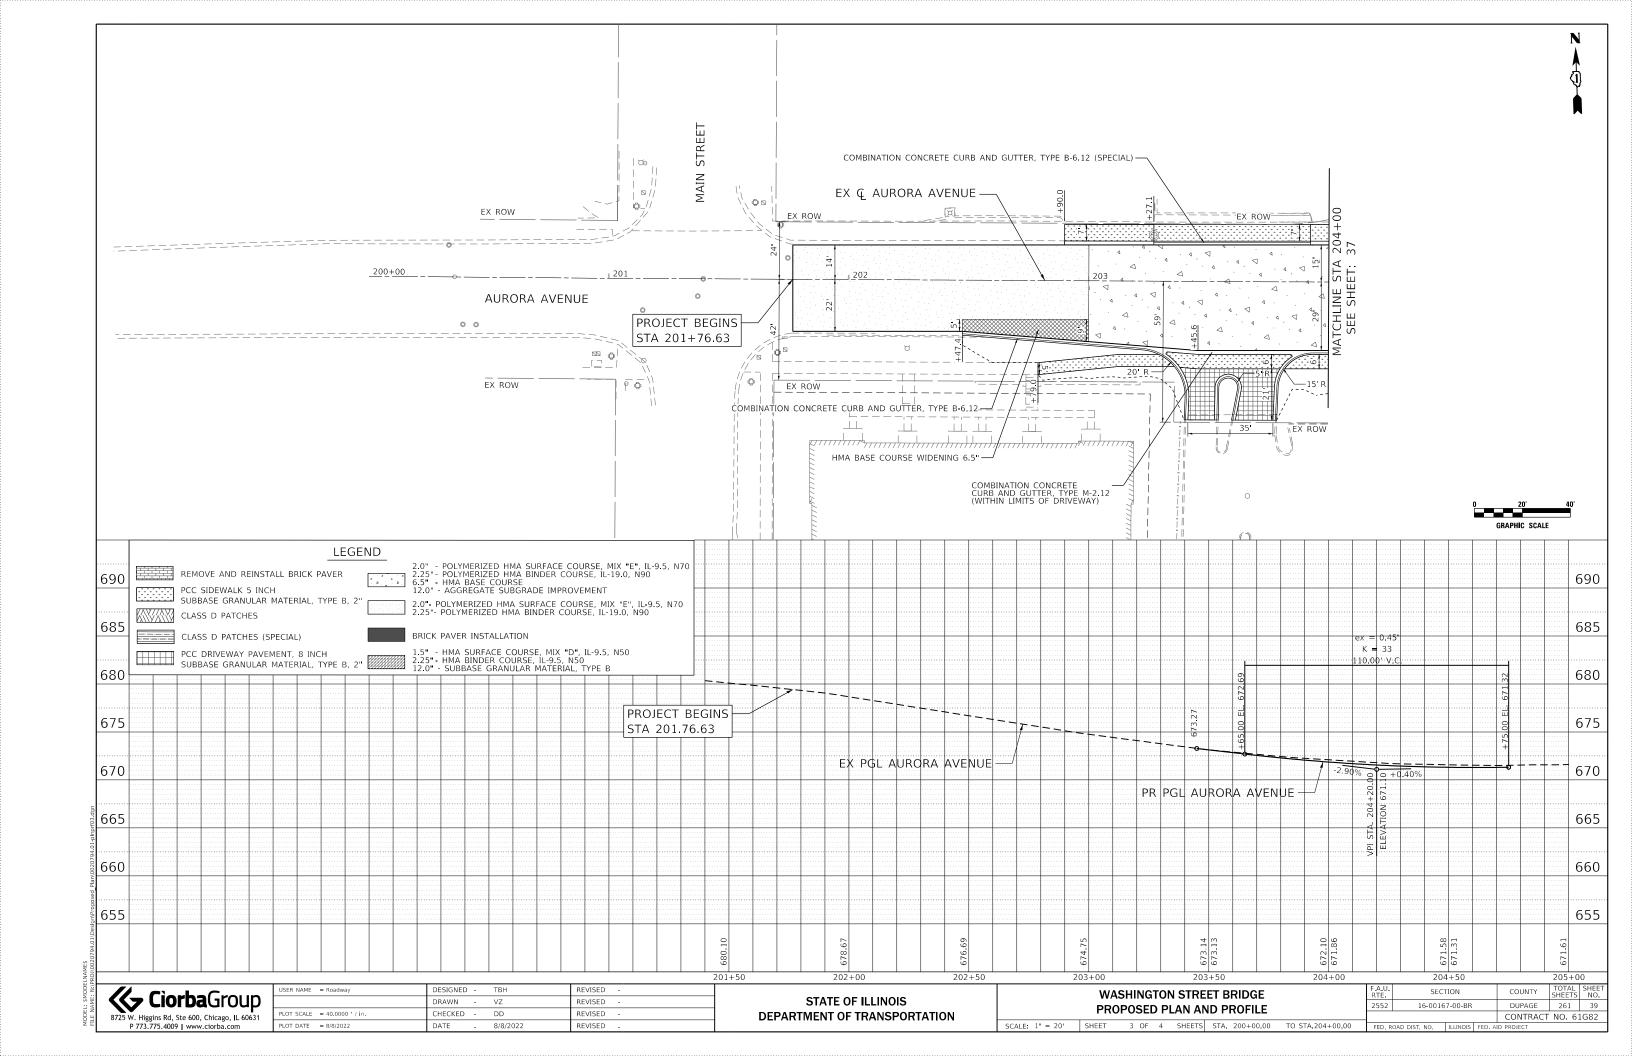

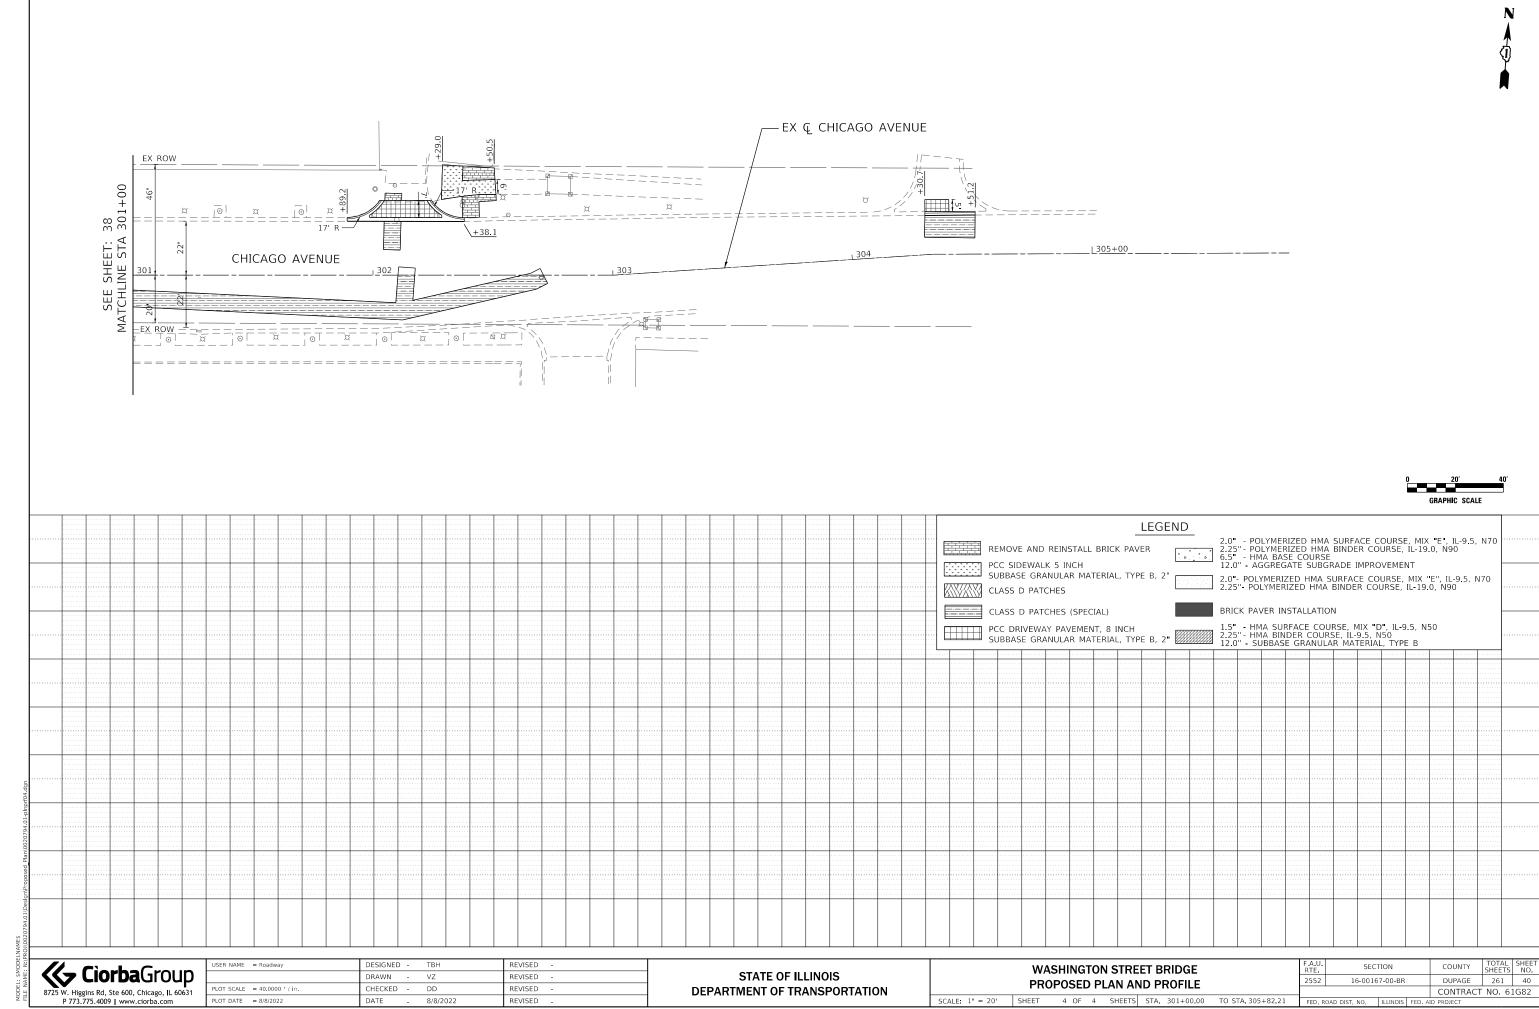

MAINTENANCE OF TRAFFIC - STAGE DESCRIPTION

PRE-STAGE

CONSTRUCTION:

THE CONTRACTOR SHALL INSTALL TEMPORARY TRAFFIC SIGNALS AT WASHINGTON/AURORA AND WASHINGTON/CHICAGO INTERSECTIONS AND TEMPORARY INTERCONNECT, INSTALL TEMPORARY LIGHTING.

MAINTENANCE OF TRAFFIC:

ONE LANE OF TRAFFIC SHALL BE MAINTAINED ON EXISTING PAVEMENT IN EACH DIRECTION ON WASHINGTON STREET, AURORA AVENUE, AND CHICAGO AVENUE. LANE CLOSURES AND LANE SHIFTS SHALL FOLLOW IDOT STANDARD 701602 AND 701501.

STAGE 1

CONSTRUCTION

THE CONTRACTOR SHALL REMOVE ALL PAVEMENT MARKINGS THAT CONFLICT WITH STAGE 1. ONLY PAVEMENT MARKING OUTSIDE OF THE PROPOSED STAGE 1 WORK ZONE WILL BE PAID FOR AS PAVEMENT MARKING REMOVAL - WATER BLASTING.

PLACE TEMPORARY PAVEMENT MARKINGS, TEMPORARY CONCRETE BARRIER WALL, AND IMPACT ATTENUATORS AT THE LOCATIONS SHOWN IN THE PLANS.

REMOVAL OF THE EXISTING APPURTENANCES AND TREE REMOVAL WITHIN THE WORK ZONE NECESSARY TO CONSTRUCT THE PROPOSED IMPROVEMENTS.

CONSTRUCT TEMPORARY PAVEMENT AS SHOWN IN PLANS ALONG THE NB SIDEWALK ON WASHINGTON STREET AS SHOWN ON THE PLANS

CONSTRUCT UTILITIES ON CHICAGO AVENUE AND COMPLETE PAVEMENT PATCHING OVER THE UTILITY TRENCHES.

WASHINGTON STREET:

CONSTRUCT NB LANE 1, NB LANE 2, CURB AND GUTTER, SIDEWALK, AND HALF OF WASHINGTON STREET BRIDGE OVER THE WEST BRANCH OF THE DUPAGE RIVER AS SHOWN ON THE PLANS. CONSTRUCT THE TWO COMMERCIAL DRIVEWAYS ALONG NB WASHINGTON STREET. CONSTRUCT THE PROPOSED WATER MAIN EAST AND WEST OF THE WASHINGTON STREET CENTERLINE. CONSTRUCT THE PROPOSED STORM SEWER AND UNDERGROUND ELECTRIC RELOCATION EAST OF THE WASHINGTON STREET CENTERLINE. CONSTRUCT THE PROPOSED SANITARY SEWER AND UNDERGROUND ELECTRIC WITHIN THE RIVER LIMITS AND WEST OF THE CROSSING ALONG THE RIVER.

MAINTENANCE OF TRAFFIC:

ONE LANE OF TRAFFIC SHALL BE MAINTAINED ON EXISTING PAVEMENT IN EACH DIRECTION ON WASHINGTON STREET AND CHICAGO AVENUE. LEFT-TURN LANES SHALL BE MAINTAINED AT LOCATIONS SHOWN ON THE PLANS. LANE CLOSURES AND LANE SHIFTS ON WASHINGTON STREET SHALL FOLLOW IDOT STANDARD 701602 AND ON CHICAGO AVENUE SHALL FOLLOW IDOT STANDARD 701501.

WINTER SHUTDOWN

CONSTRUCTION:

THE CONTRACTOR SHALL REMOVE ALL PAVEMENT MARKINGS THAT CONFLICT WITH THE WINTER SHUTDOWN AND WILL BE PAID FOR AS PAVEMENT MARKING REMOVAL - WATER BLASTING.

PLACE TEMPORARY PAVEMENT MARKINGS, TEMPORARY CONCRETE BARRIER WALL, AND IMPACT ATTENUATORS AT THE LOCATIONS SHOWN IN THE PLANS

AT&T WILL UTILIZE THE WINTER SHUTDOWN TO COMPLETE CUTOVERS BEFORE BRIDGE DEMOLITION.

MAINTENANCE OF TRAFFIC:

TWO LANES OF TRAFFIC SHALL BE MAINTAINED IN EACH DIRECTION ON WASHINGTON STREET. ONE LANE OF TRAFFIC SHALL BE BE MAINTAINED AT AURORA AVENUE AND CHICAGO AVENUE. LANE CLOSURES AND LANE SHIFTS SHALL FOLLOW IDOT STANDARD 701501 AND 701602.

STAGE 2A

CONSTRUCTION:

THE CONTRACTOR SHALL REMOVE ALL PAVEMENT MARKINGS THAT CONFLICT WITH STAGE 2. ONLY PAVEMENT MARKING OUTSIDE OF THE PROPOSED STAGE 2 WORK ZONE WILL BE PAID FOR AS TEMPORARY PAVEMENT MARKING REMOVAL.

PLACE TEMPORARY PAVEMENT MARKINGS, TEMPORARY CONCRETE BARRIER WALL, AND IMPACT ATTENUATORS AT THE LOCATIONS SHOWN IN THE PLANS.

REMOVAL OF THE EXISTING APPURTENANCES AND TREE REMOVAL WITHIN THE WORK ZONE NECESSARY TO CONSTRUCT THE PROPOSED IMPROVEMENTS.

WASHINGTON STREET:

CONSTRUCT SB LANE 1, HALF OF SB LANE 2, CURB AND GUTTER, SIDEWALK, AND HALF OF WASHINGTON STREET BRIDGE OVER THE WEST BRANCH OF THE DUPAGE RIVER AS SHOWN ON THE PLANS. CONSTRUCT THE RIGHT-TURN LANE TO AURORA AVENUE AND THE TWO COMMERCIAL DRIVEWAYS ALONG SB WASHINGTON STREET. CONSTRUCT THE PROPOSED SANITARY SEWER, STORM SEWER AND UNDERGROUND ELECTRIC RELOCATION WEST OF THE WASHINGTON STREET CENTERLINE.

AURORA AVENUE:

CONSTRUCT THE RIGHT-TURN LANE TO WASHINGTON STREET, CURB AND GUTTER, AND SIDEWALK AS SHOWN ON PLANS. CONSTRUCT THE COMMERCIAL DRIVEWAY ALONG EB AURORA AVENUE. CONSTRUCT THE SOUTHWEST CORNER OF THE WASHINGTON STREET INTERSECTION.

MAINTENANCE OF TRAFFIC:

ONE LANE OF TRAFFIC SHALL BE MAINTAINED IN EACH DIRECTION ON WASHINGTON STREET AND AURORA AVENUE. LEFT-TURN LANES SHALL BE MAINTAINED AT LOCATIONS SHOWN ON THE PLANS. LANE CLOSURES AND LANE SHIFTS ON BOTH WASHINGTON STREET AND AURORA AVENUE SHALL FOLLOW IDOT STANDARD 701501 AND 701602. PEDESTRIAN TRAFFIC WILL BE DETOURED PER THE DETOUR PLAN.

STAGE 2B

AURORA AVENUE:

CONSTRUCT TEMPORARY PAVEMENT RAMPS USING THE BINDER COURSE AT THE CENTER OF AURORA AVENUE TO CONNECT NEW PAVEMENT TO EXISTING PAVEMENT AS SHOWN ON THE PLANS

CONSTRUCT WB LANE 1, CURB AND GUTTER, AND SIDEWALK AS SHOWN ON PLANS. CONSTRUCT THE NORTHWEST CORNER OF THE WASHINGTON STREET AND AURORA AVENUE INTERSECTION. CONSTRUCT THE PROPOSED STORM SEWER AS SHOWN ON PLANS.

MAINTENANCE OF TRAFFIC:

ONE LANE OF TRAFFIC SHALL BE MAINTAINED IN EACH DIRECTION ON WASHINGTON STREET AND AURORA AVENUE. LANE CLOSURES AND LANE SHIFTS ON AURORA AVENUE SHALL FOLLOW IDOT STANDARD 701501 AND 701602.

STAGE 2C

AURORA AVENUE:

CONSTRUCT REMAINING PAVEMENT AT WASHINGTON STREET AND AURORA AVENUE AS SHOWN ON PLANS. PIN TEMPORARY CONCRETE BARRIER ADJACENT TO REMAINING PAVEMENT TO BE CONSTRUCTED ON AURORA AVENUE.

MAINTENANCE OF TRAFFIC:

ONE LANE OF TRAFFIC SHALL BE MAINTAINED IN EACH DIRECTION ON WASHINGTON STREET AND AURORA AVENUE. LANE CLOSURES AND LANE SHIFTS ON AURORA AVENUE SHALL FOLLOW IDOT STANDARD 701501 AND 701602.

STAGE 3A

CONSTRUCTION:

THE CONTRACTOR SHALL REMOVE ALL PAVEMENT MARKINGS THAT CONFLICT WITH STAGE 3. ONLY PAVEMENT MARKING OUTSIDE OF THE PROPOSED STAGE 3 WORK ZONE WILL BE PAID FOR AS PAVEMENT MARKING REMOVAL.

PLACE TEMPORARY PAVEMENT MARKINGS, TEMPORARY CONCRETE BARRIER WALL, AND IMPACT ATTENUATORS AT THE LOCATIONS SHOWN IN THE PLANS.

WASHINGTON STREET

CONSTRUCT HALF OF SB LANE 2 AND CENTER TURN LANE AS SHOWN ON THE PLANS.

MAINTENANCE OF TRAFFIC:

ONE LANE OF TRAFFIC SHALL BE MAINTAINED IN EACH DIRECTION ON WASHINGTON STREET. LANE CLOSURES AND LANE SHIFTS ON WASHINGTON STREET SHALL FOLLOW IDOT STANDARD 701602. WHILE CONTRACTOR IS WORKING, THE NORTHBOUND LEFT TURN LANE AT CHICAGO AVENUE SHALL BE CLOSED.

STAGE 3B

CONSTRUCTION AND STAGING CONFIGURATION SHALL BE THE SAME AS STAGE 3A AND THE FOLLOWING:

WASHINGTON STREET:

FINISH CONSTRUCTION OF SB LANE 2 AND CENTER TURN LANE AT AURORA AVENUE AS SHOWN ON PLANS.

MAINTENANCE OF TRAFFIC:

ONE LANE OF TRAFFIC SHALL BE MAINTAINED IN EACH DIRECTION ON WASHINGTON STREET. LANE CLOSURES AND LANE SHIFTS ON WASHTINGTON STREET SHALL FOLLOW IDOT STANDARD 701602.

STAGE 4

CONSTRUCTIO

THE CONTRACTOR SHALL REMOVE ALL PAVEMENT MARKINGS THAT CONFLICT WITH STAGE 3. ONLY PAVEMENT MARKING OUTSIDE OF THE PROPOSED STAGE 4 WORK ZONE WILL BE PAID FOR AS PAVEMENT MARKING REMOVAL.

PLACE TEMPORARY PAVEMENT MARKINGS, TEMPORARY CONCRETE BARRIER WALL, AND IMPACT ATTENUATORS AT THE LOCATIONS SHOWN IN THE PLANS

CONSTRUCTION AND STAGING CONFIGURATION SHALL BE THE SAME AS STAGE 3 AND THE FOLLOWING:

WASHINGTON STREET:

REMOVE TEMPORARY PAVEMENT AND CONSTRUCT NB SIDEWALK, RAILING AND PARAPET ON THE WASHINGTON STREET BRIDGE. CONSTRUCT SIDEWALK AND CURB AND GUTTER ADJACENT TO THE BRIDGE AS SHOWN ON PLANS.

MAINTENANCE OF TRAFFIC:

ONE LANE OF TRAFFIC SHALL BE MAINTAINED IN THE NB DIRECTION ON WASHINGTON STREET. LANE CLOSURES AND LANE SHIFTS ON WASHTINGTON STREET SHALL FOLLOW IDOT STANDARD 701602.

STAGE 5

ONSTRUCTION

CONSTRUCT HMA SURFACE COURSE AND PLACE PERMANENT PAVEMENT MARKINGS.

SCALE: 1" = 20"

REMOVE ALL TEMPORARY CONCRETE BARRIER WALL AND IMPACT ATTENUATORS AT THE LOCATIONS SHOWN IN THE PLANS FROM STAGE CONSTRUCTION.

MAINTENANCE OF TRAFFIC:

DURING CONSTRUCTION OF THE HMA SURFACE COURSE ON WASHINGTON STREET AND AURORA AVENUE, THE CONTRACTOR SHALL MAINTAIN TWO-WAY TRAFFIC AT ALL TIMES, WHILE ACTIVELY WORKING, BY USING FLAGGERS. WHEN NOT ACTIVELY WORKING, THE CONTRACTOR SHALL PROVIDE TWO PAVED AND TEMPORARILY STRIPPED LANES ON WASHINGTON STREET AND ONE LANE ON AURORA AVENUE, A MINIMUM OF TEN (10) FOOT WIDTH IN EACH DIRECTION. RESURFACING OPERATIONS SHALL BE PERFORMED FOLLOWING IDOT STANDARD'S TC-10, 701501-06, 701602-10, 701611-01 AND 701701-10.

USER NAME = Roadway	DESIGNED - TBH	REVISED -
	DRAWN - VZ	REVISED -
PLOT SCALE = 40.0000 / in.	CHECKED - DD	REVISED -
PLOT DATE = 8/8/2022	DATE - 8/8/2022	REVISED -

WASHINGTON STREET BRIDGE							F.A.U. RTE	SEC	TION		COUNTY	TOTAL SHEETS	SHEET NO.	
MAINT	MAINTENANCE OF TRAFFIC - STAGE DESCRIPTION							2552	16-0016	57-00-BR		DUPAGE	261	41
WAIN	MAINTENANCE OF TRAFFIC - STAGE DESCRIPTION											CONTRAC	F NO. 6	1G82
" = 20"	SHEET	1	OF	1	SHEETS	STA.	TO STA.	TILLINOIS LEED, AID PROJECT						

Cìorba Grou
8725 W. Higgins Rd, Ste 600, Chicago, I L 60 P 773.775.4009 www.ciorba.com

USER NAME = Roadway	DESIGNED - TBH	REVISED -	
	DRAWN - VZ	REVISED -	
PLOT SCALE = 20.0000 ' / in.	CHECKED - DD	REVISED -	
PLOT DATE = 8/8/2022	DATE - 8/8/2022	REVISED -	

STATE OF ILLINOIS DEPARTMENT OF TRANSPORTATION

		MAI	NTEN	ΙΑI	GTON S' NCE OF L SECTI	TRAFFIC	
CALE: N.T.S.	SHEET	1	OF	3	SHEETS	STA.	


TO STA.


COUNTY TOTAL SHEETS NO.


DUPAGE 261 42 SECTION 2552 16-00167-00-BR CONTRACT NO. 61G82

ROW I	EX Q WASHINGTON	N STREET	I No
ان 0′-6.0′I	PR @ WASHI	INGTON STREET	·
	26.0' - 45.0'	27.0' - 28.0'	<u> </u>
<u>≶</u> : !	6.0' - 0.0'		1.0'
PR ROW	——————————————————————————————————————	O'-12.0' SB LANE LT TURN (NB)	10.3' NB LANE TEMPORARY CONCRETE BARRIER * SEE PEDESTRIAN DETOUR PLAN FOR ALTERNATIVE ROUTES DURING STAGE 2, 3 AND 4. TEMPORARY PAVEMENT MARKING LINE 4" (WHITE)
	STA 131+49.62 TO STA	138+96.31 \	TEMPORARY PAVEMENT MARKING LINE 6" (WHITE) MPORARY PAVEMENT MARKING LINE 4" (DOUBLE YELLOW)
		└─ TEMPORARY	PAVEMENT MARKING LINE 4" (WHITE)

EX Q WASHINGTON STREET PR Q WASHINGTON STREET 26.0 45.0 6.0 - 0.0 0'-10.0' 10.3' 10.3' LT LANE | NB LANE | NB LANE 11.3'-12.0' 11.3'-12.0' SB LANE (NB) - TEMPORARY CONCRETE BARRIER WINTER SHUTDOWN

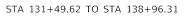

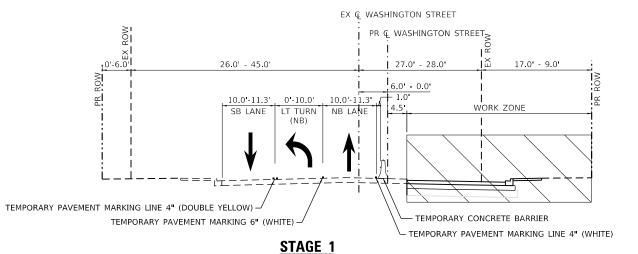

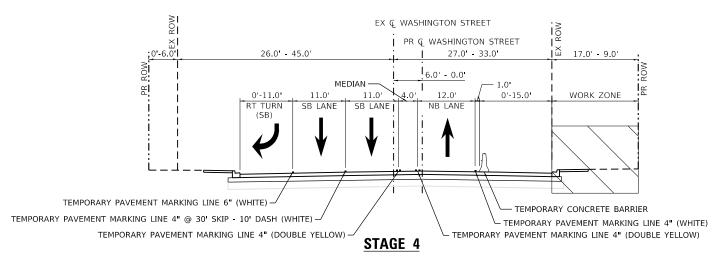

STA 131+49.62 TO STA 138+96.31

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//- Ciarba Eroup
Ciorba Group
(A 0.0.000
8725 W. Higgins Rd, Ste 600, Chicago, IL 60631
P 772 775 4000 Lyavay ciorba com


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	DRAWN - VZ	REVISED -
PLOT SCALE = 20.0000 ' / in.	CHECKED - DD	REVISED -
PLOT DATE = 8/8/2022	DATE - 8/8/2022	REVISED -

STATE OF ILLINOIS
DEPARTMENT OF TRANSPORTATION


		F.A.U. RTE	SEC	CTION		COUNTY TOTA		SHEET NO.						
	MAINTENANCE OF TRAFFIC							2552 16-00167-00-BR				DUPAGE	261	43
	TYPICAL SECTIONS											CONTRACT	NO. 6	1G82
	SCALE: N.T.S.	SHEET 2	OF	3	SHEETS	STA.	TO STA.	ILLINOIS FED AID			ID PROJECT			
_														_


FILE NAME: N.PROJ/0020794.01\Design\MOT\0020794.01-MOT


STA 201+76.63 TO STA 205+00.00

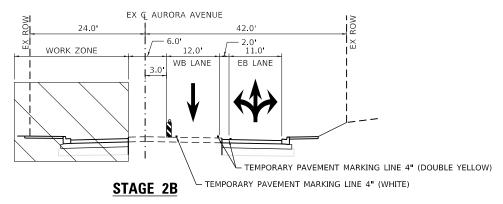

STA 201+76.63 TO STA 205+00.00

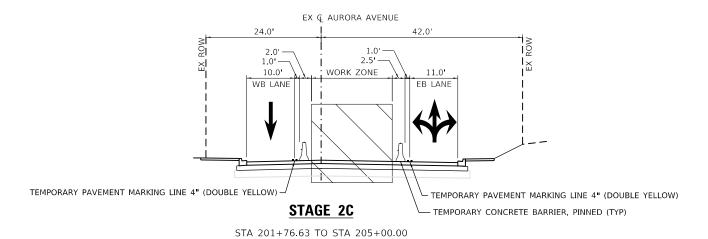

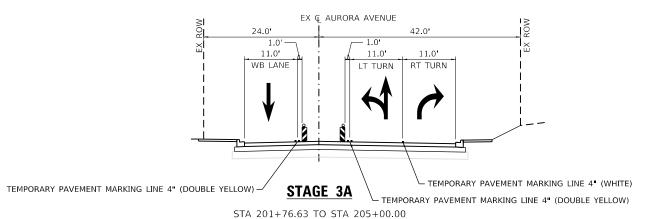

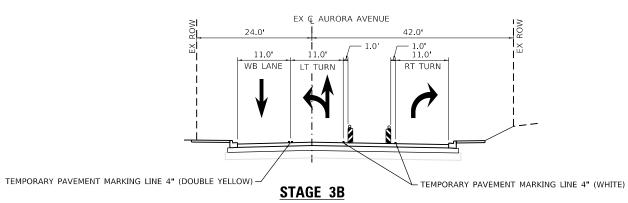

STA 201+76.63 TO STA 205+00.00

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Ciorba Group
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P 773 775 4009 L www ciorba com


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	DRAWN -	VZ	REVISED -
PLOT SCALE = 20.0000 ' / in.	CHECKED -	DD	REVISED -
PLOT DATE = 8/8/2022	DATE -	8/8/2022	REVISED -

STATE OF ILLINOIS
DEPARTMENT OF TRANSPORTATION


SCALE: N.T.S.


AURORA AVENUE							F.A.U. SECTION				COUNTY	TOTAL SHEETS	SHEET NO.	
MAINTENANCE OF TRAFFIC						2552	16-00167-00-BR			DUPAGE	261	44		
TYPICAL SECTIONS											CONTRACT	F NO. 6:	1G82	
	SHEET	3	OF	3	SHEETS	STA.	TO STA.	ILLINOIS FED A				D PROJECT		

MODEL: \$MODELNAME\$
FILE NAME: N3PB01/0020794.01/Deslan/MOT/0020794.01-

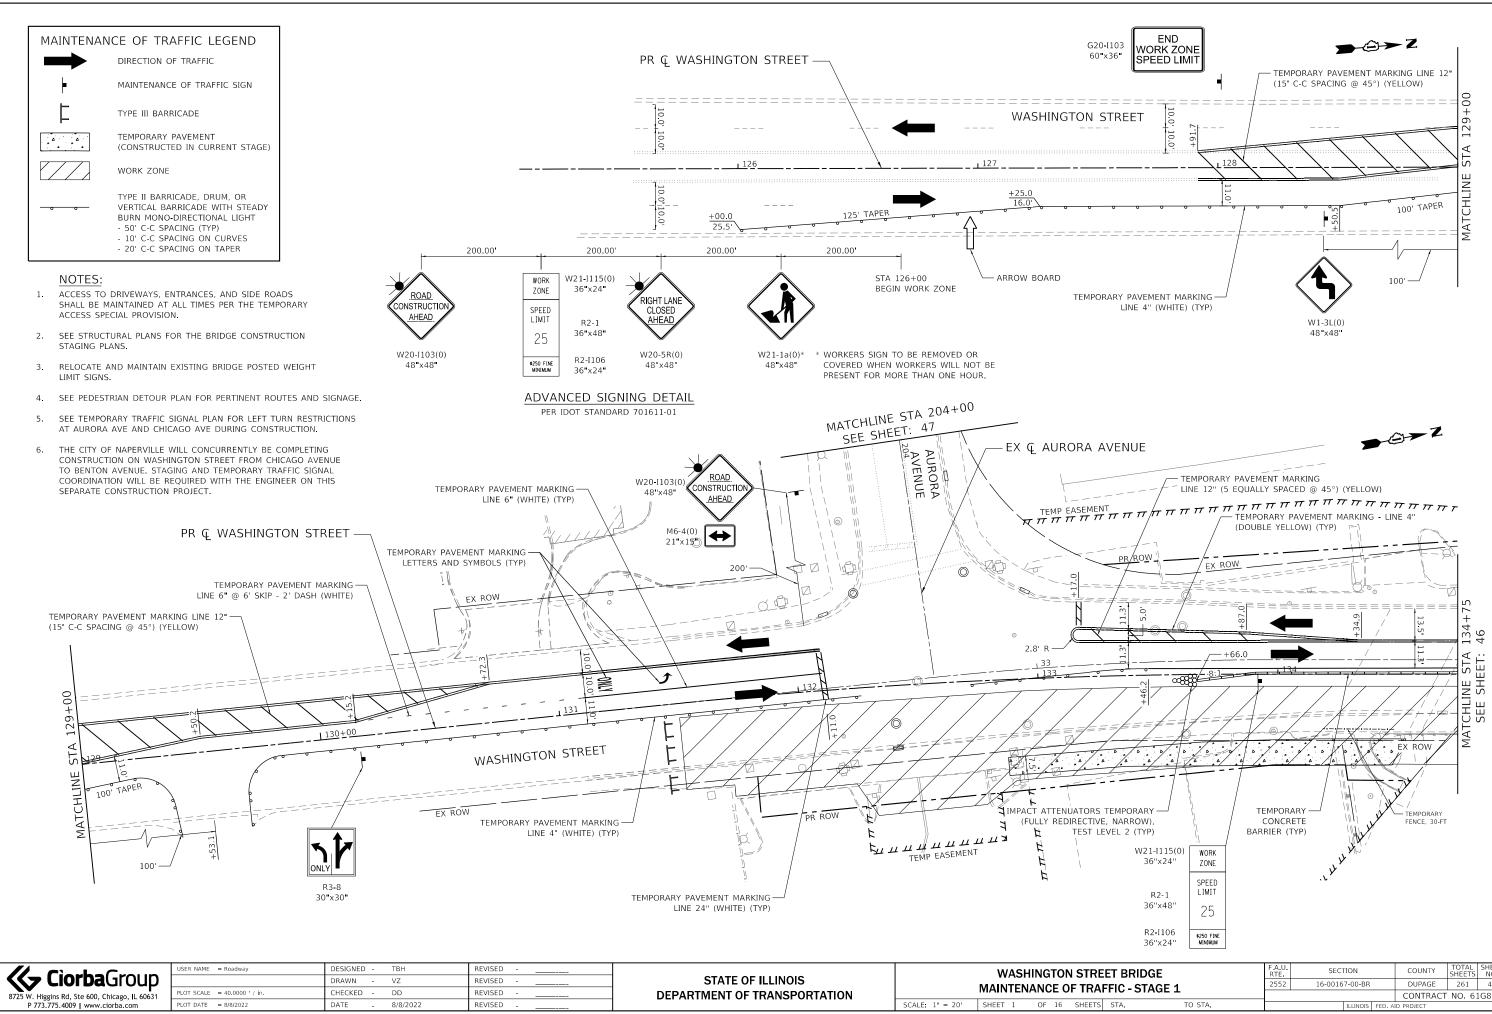

261 45 CONTRACT NO. 61G82

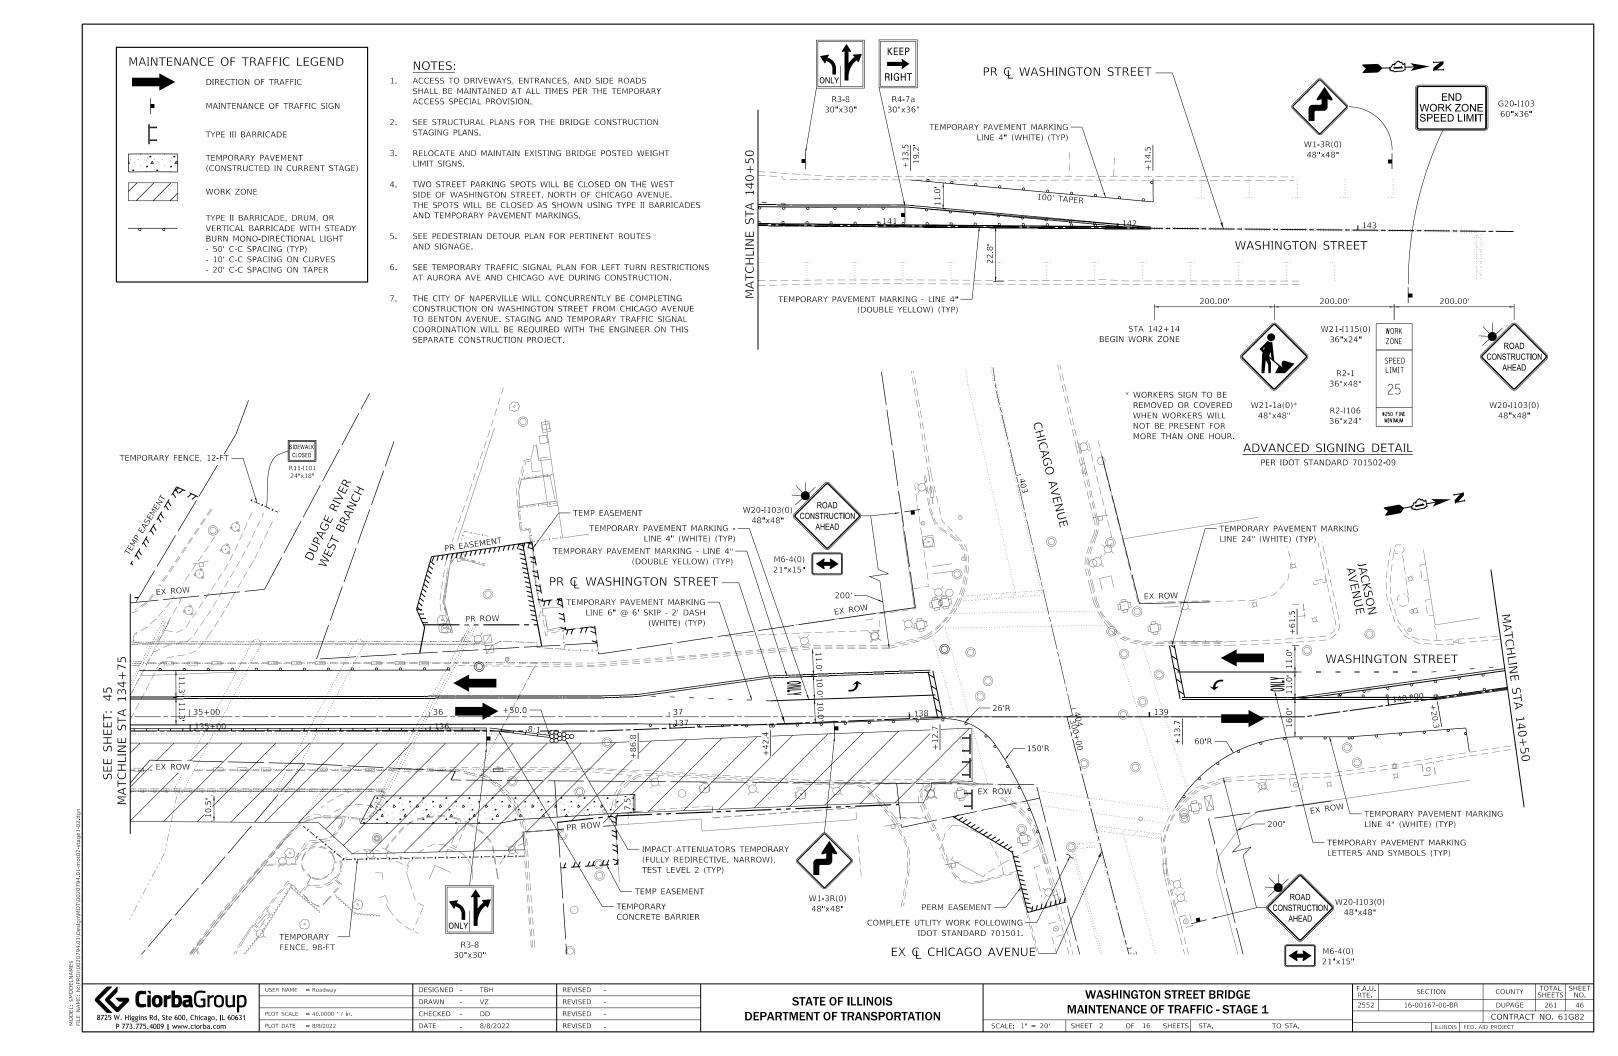

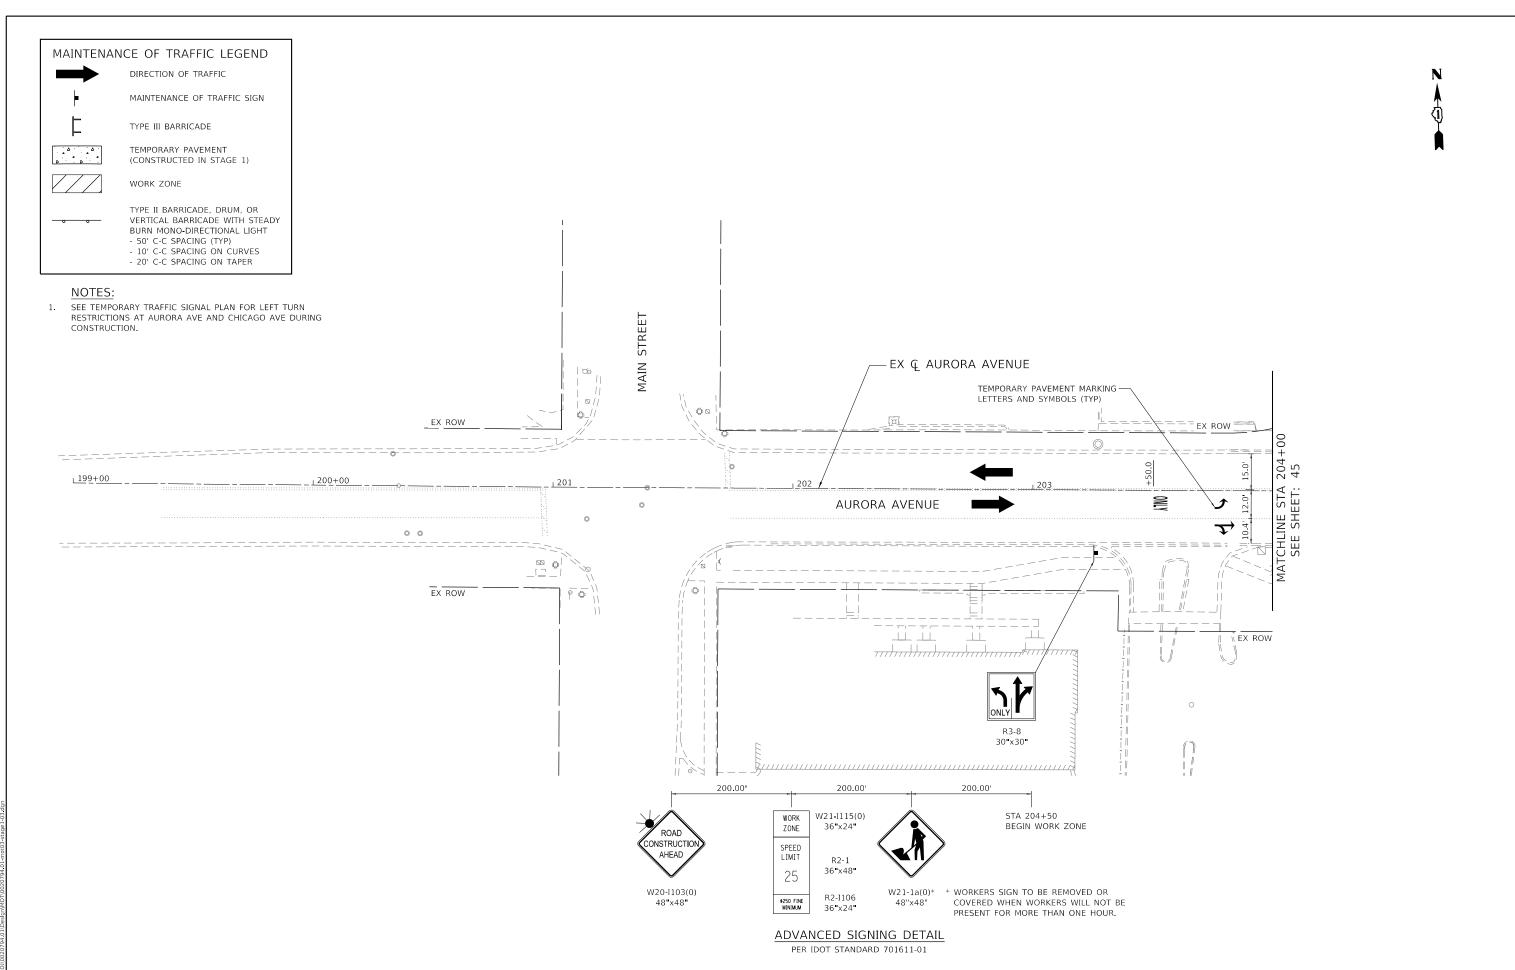

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 USER NAME
 = Roadway
 DESIGNED
 TBH
 REVISED

 DRAWN
 VZ
 REVISED

 PLOT SCALE
 = 40,0000 '/ in.
 CHECKED
 DD
 REVISED

 PLOT DATE
 = 8/8/2022
 DATE
 8/8/2022
 REVISED

STATE OF ILLINOIS
DEPARTMENT OF TRANSPORTATION

 WASHINGTON STREET BRIDGE
 F.A.U.

 MAINTENANCE OF TRAFFIC - STAGE 1


 SCALE: 1" = 20'
 SHEET 3
 OF 16
 SHEETS STA.
 TO STA.

 F.A.U. RTE.
 SECTION
 COUNTY
 TOTAL SHEETS
 SHEET NO.

 2552
 16-00167-00-BR
 DUPAGE
 261
 47

 CONTRACT NO. 61G82

 ILLINOIS FED. AID PROJECT

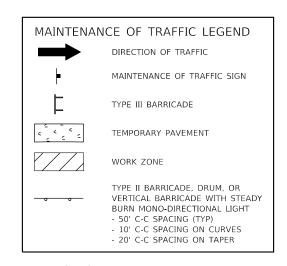


NOTES:

8725 W. Higgins Rd, Ste 600, Chicago, IL 60631

PLOT DATE = 8/8/2022

- ACCESS TO DRIVEWAYS, ENTRANCES, AND SIDE ROADS
 SHALL BE MAINTAINED AT ALL TIMES PER THE TEMPORARY ACCESS SPECIAL PROVISION.
- 2. SEE STRUCTURAL PLANS FOR THE BRIDGE CONSTRUCTION STAGING PLANS.

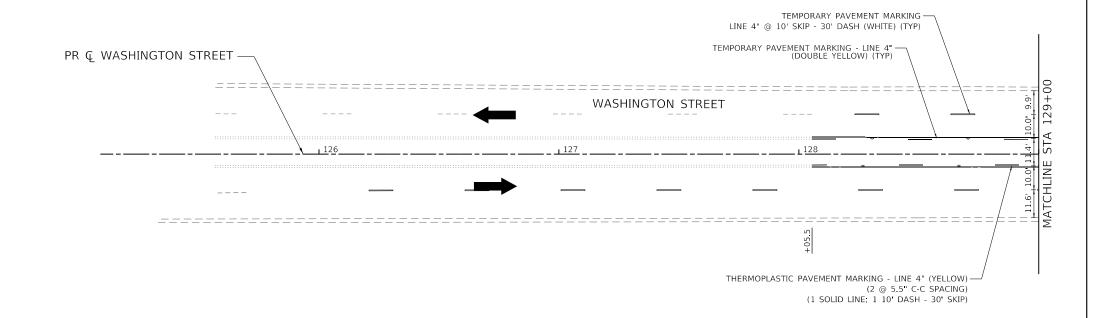


MAINTENANCE OF TRAFFIC - WINTER SHUTDOWN

SCALE: 1" = 20' SHEET 4 OF 16 SHEETS STA.

16-00167-00-BR

DUPAGE 261 48

CONTRACT NO. 61G82

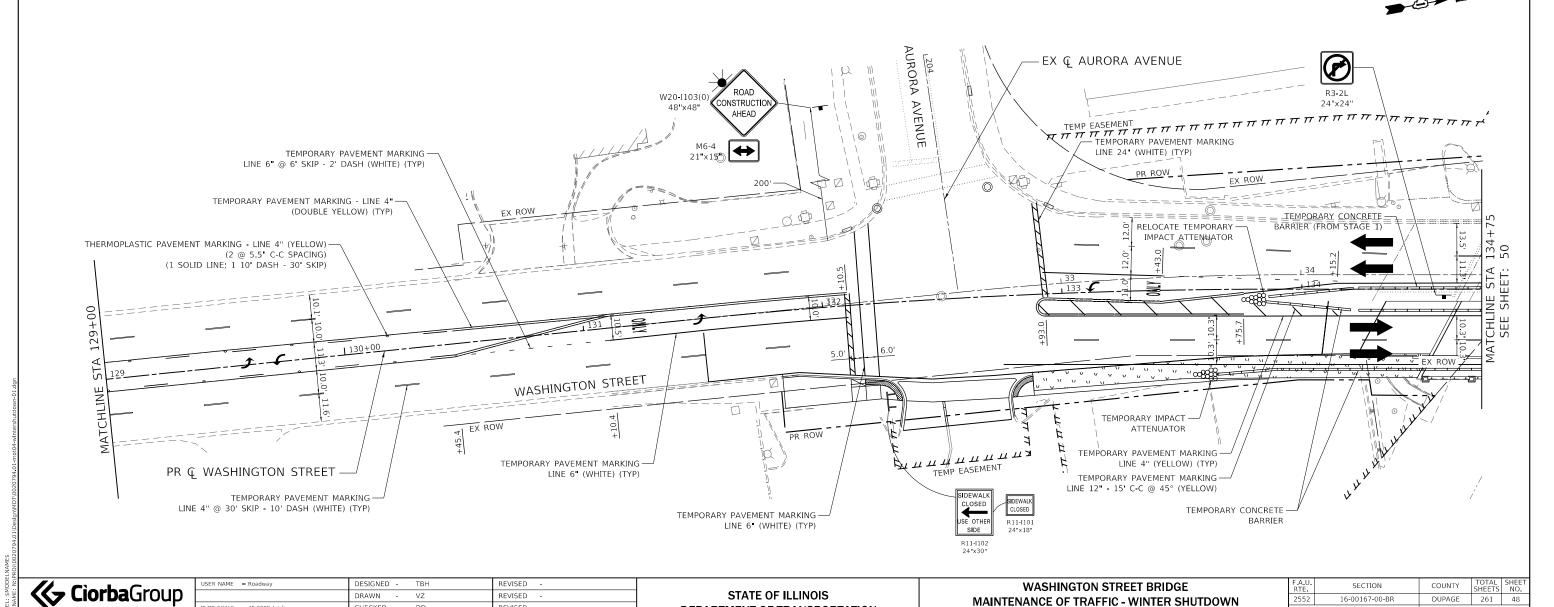



DEPARTMENT OF TRANSPORTATION


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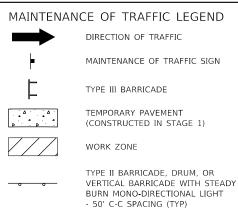
8/8/2022





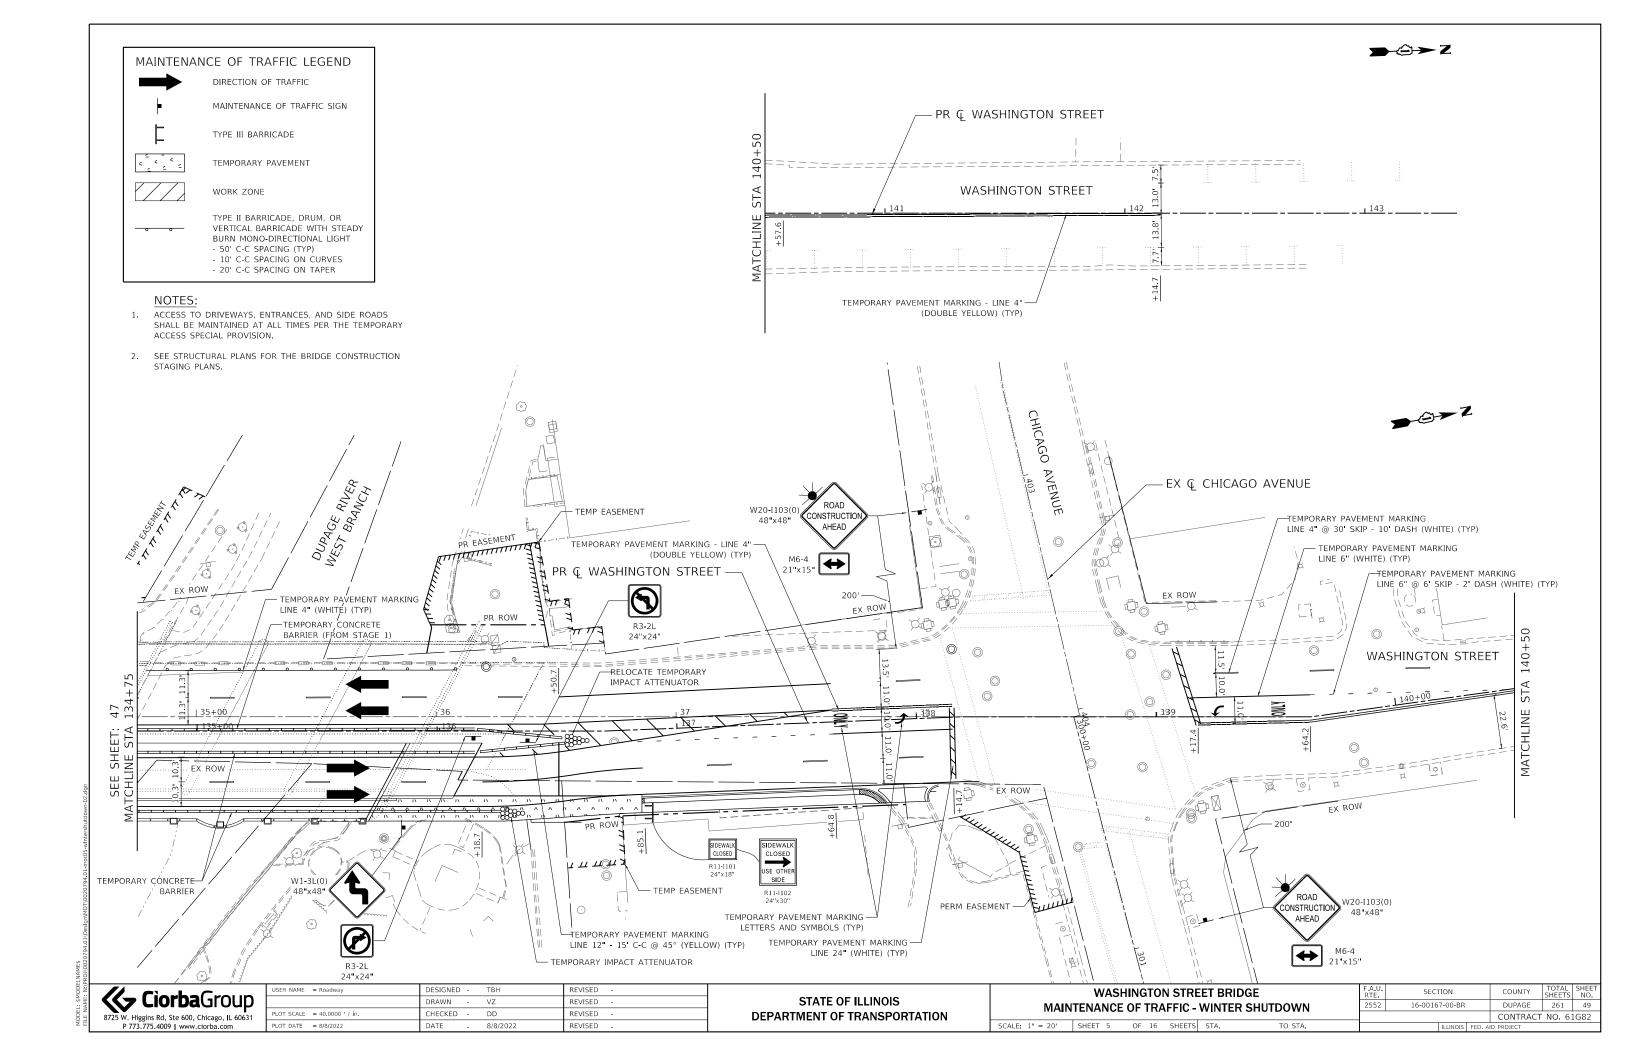


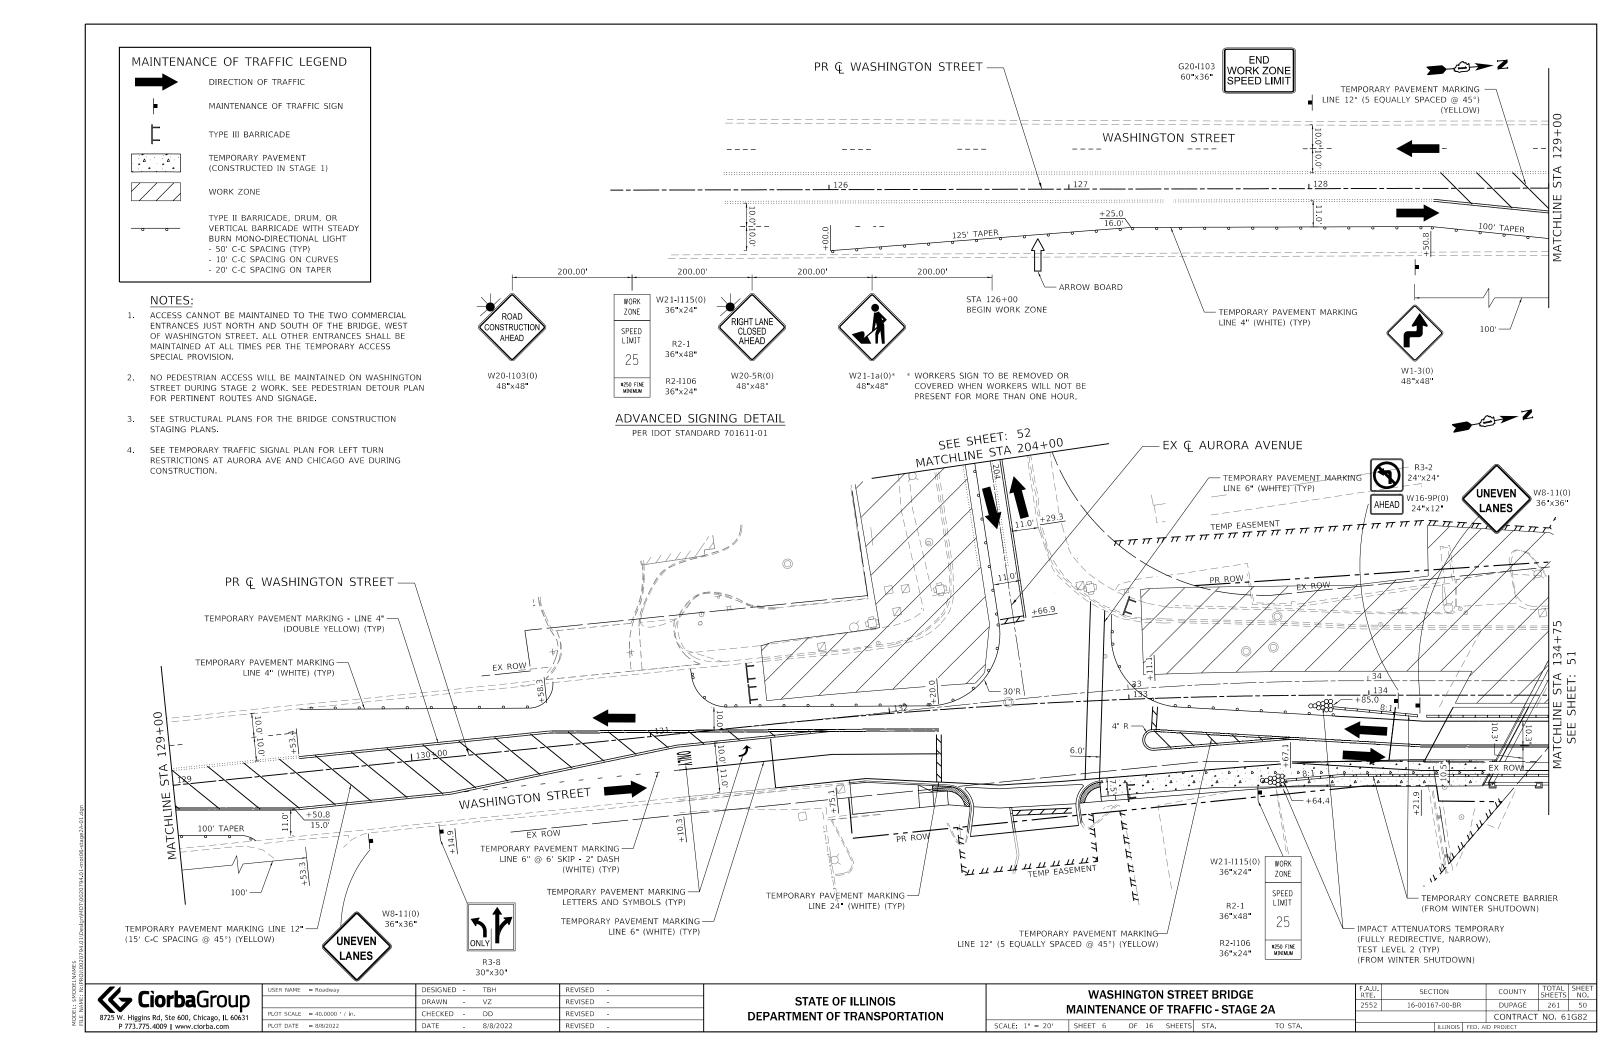

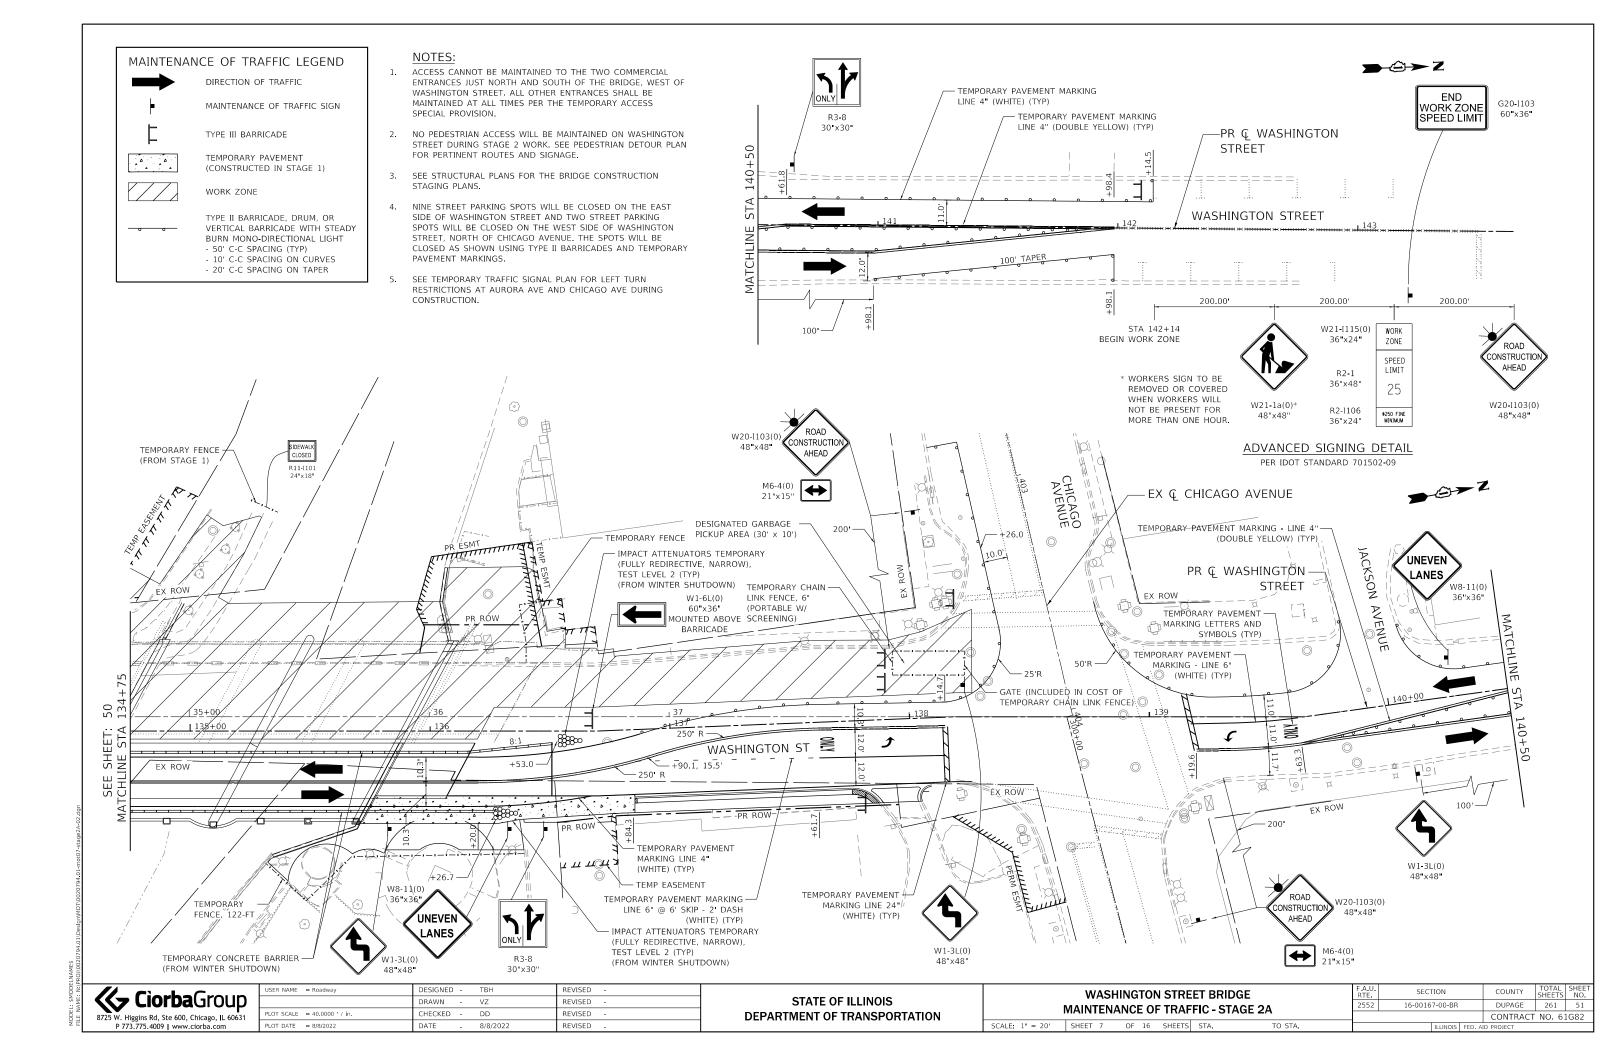

NOTES:

- ACCESS SHALL BE MAINTAINED PER THE TEMPORARY ACCESS SPECIAL PROVISION TO AT LEAST ONE OF THE TWO COMMERCIAL ENTRANCES ON THE NORTH SIDE OF AURORA AVENUE. THE CONTRACTOR SHALL ALSO STAGE THE DRIVEWAY SOUTH OF AURORA AVENUE PER THE SUBJECT SPECIAL PROVISION.
- NO PEDESTRIAN ACCESS WILL BE MAINTAINED ON WASHINGTON STREET DURING STAGE 2 WORK. SEE PEDESTRIAN DETOUR PLAN FOR PERTINENT ROUTES AND SIGNAGE.
- SEE STRUCTURAL PLANS FOR THE BRIDGE CONSTRUCTION STAGING PLANS.
- SEE TEMPORARY TRAFFIC SIGNAL PLAN FOR LEFT TURN RESTRICTIONS AT AURORA AVE AND CHICAGO AVE DURING CONSTRUCTION.

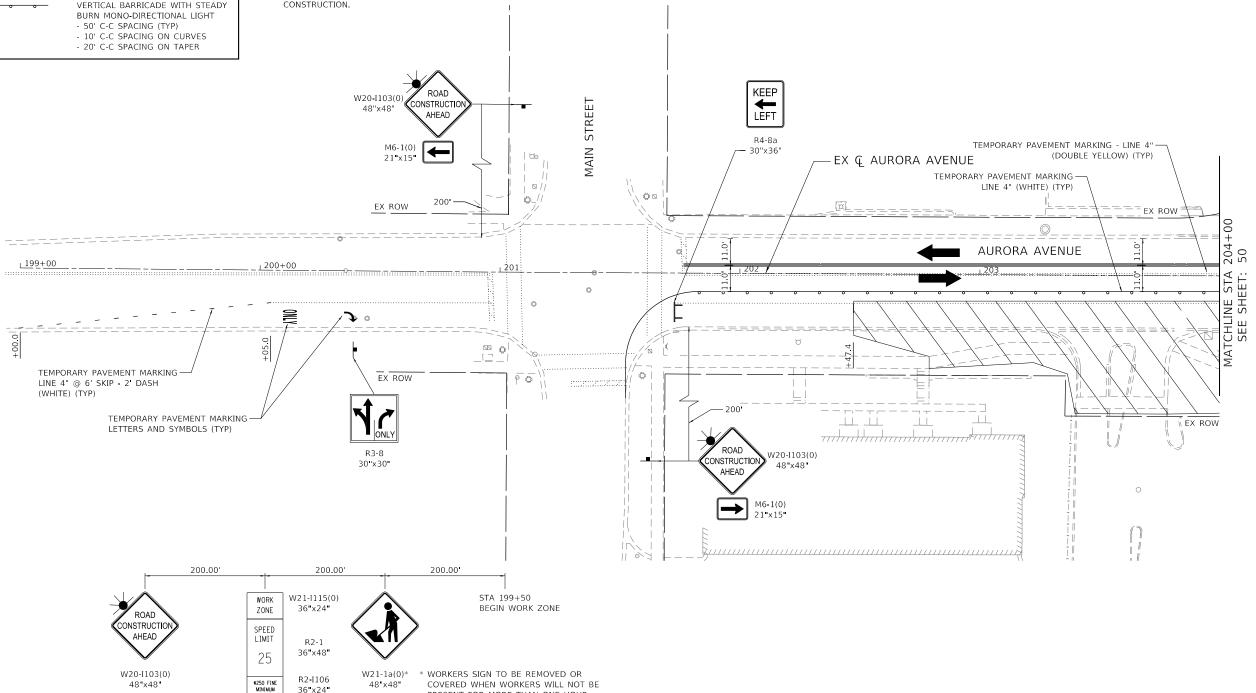

ADVANCED SIGNING DETAIL

PER IDOT STANDARD 701611-01


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8725 W. Higgins Rd, Ste 600, Chicago, IL 60631 P 773.775.4009 www.ciorba.com


USER NAME = Roadway	DESIGNED - TBH	REVISED -
	DRAWN - VZ	REVISED -
PLOT SCALE = 40.0000 ' / in.	CHECKED - DD	REVISED -
PLOT DATE = 8/8/2022	DATE - 8/8/2022	REVISED -
PEOT DATE = 0/0/2022	DATE - 6/6/2022	KEVISED -

PRESENT FOR MORE THAN ONE HOUR.

STATE OF ILLINOIS	
DEPARTMENT OF TRANSPORTATION	

	F.A.U. RTE	SECTION		COUNTY	TOTAL SHEETS	SHEET NO.
MAINTENANCE OF TRAFFIC - STAGE 2A	2552	16-00167-00-BR		DUPAGE	261	52
MAINTENANCE OF TRAFFIC STAGE 2A				CONTRACT	NO. 63	IG82
SCALE: 1" = 20' SHEET 8 OF 16 SHEETS STA. TO STA.		ILLINOIS	FED. AID	PROJECT		

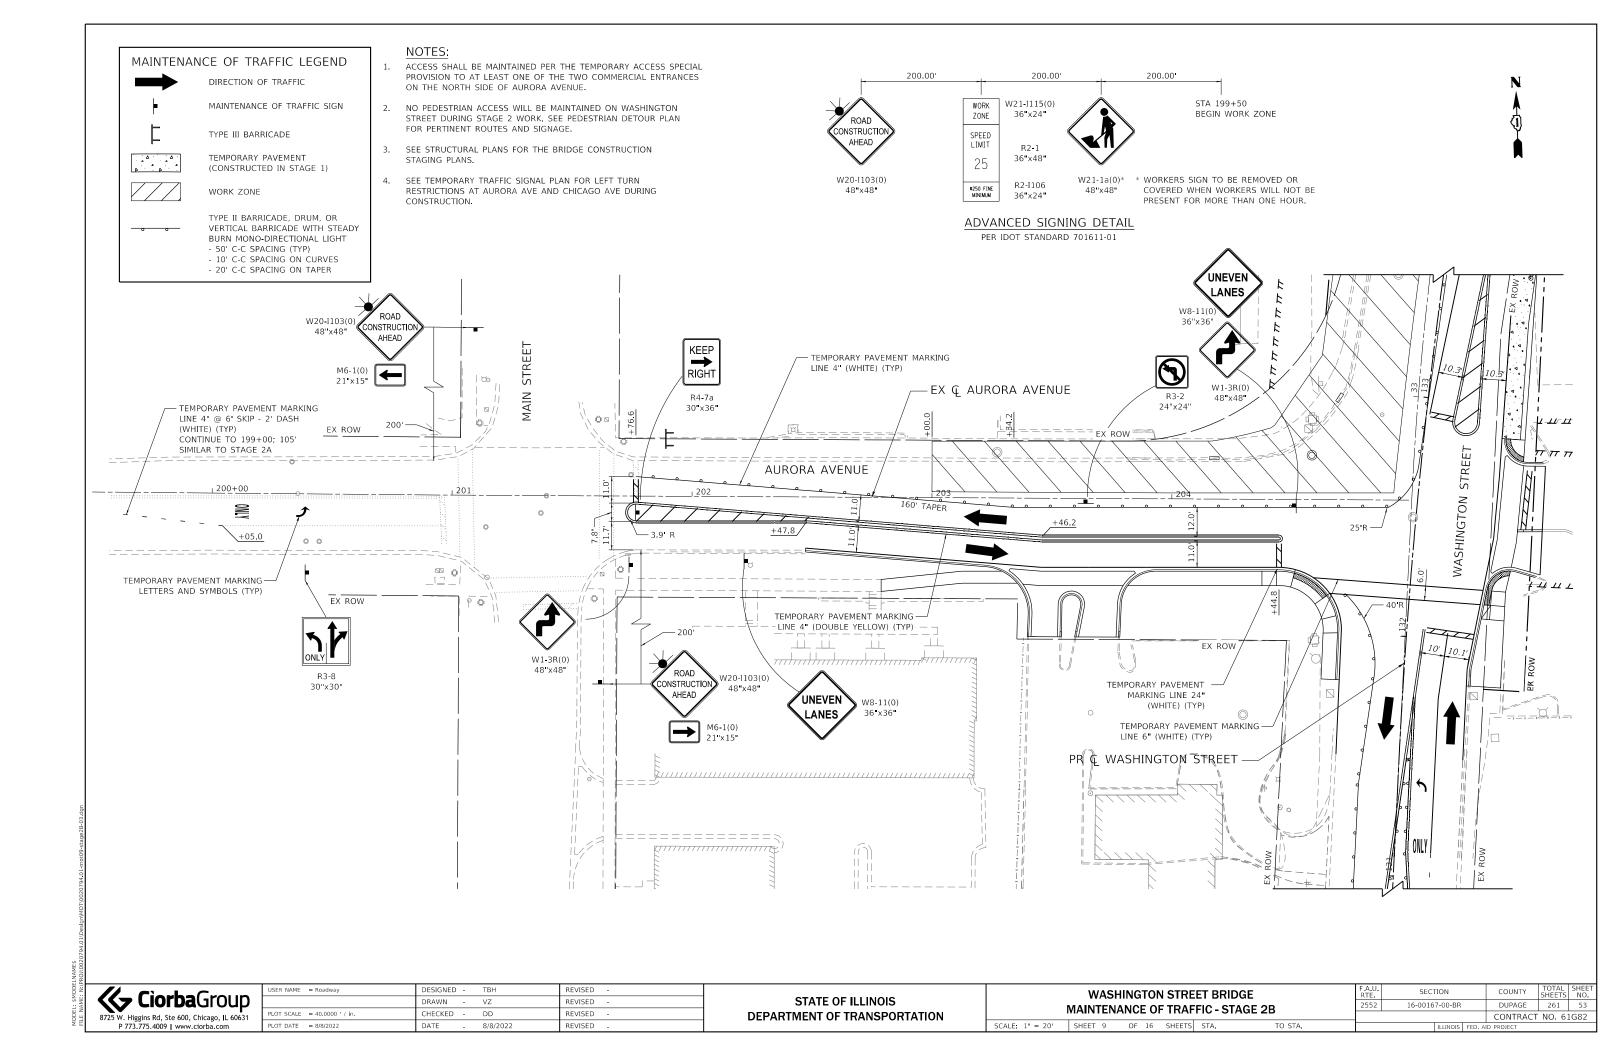

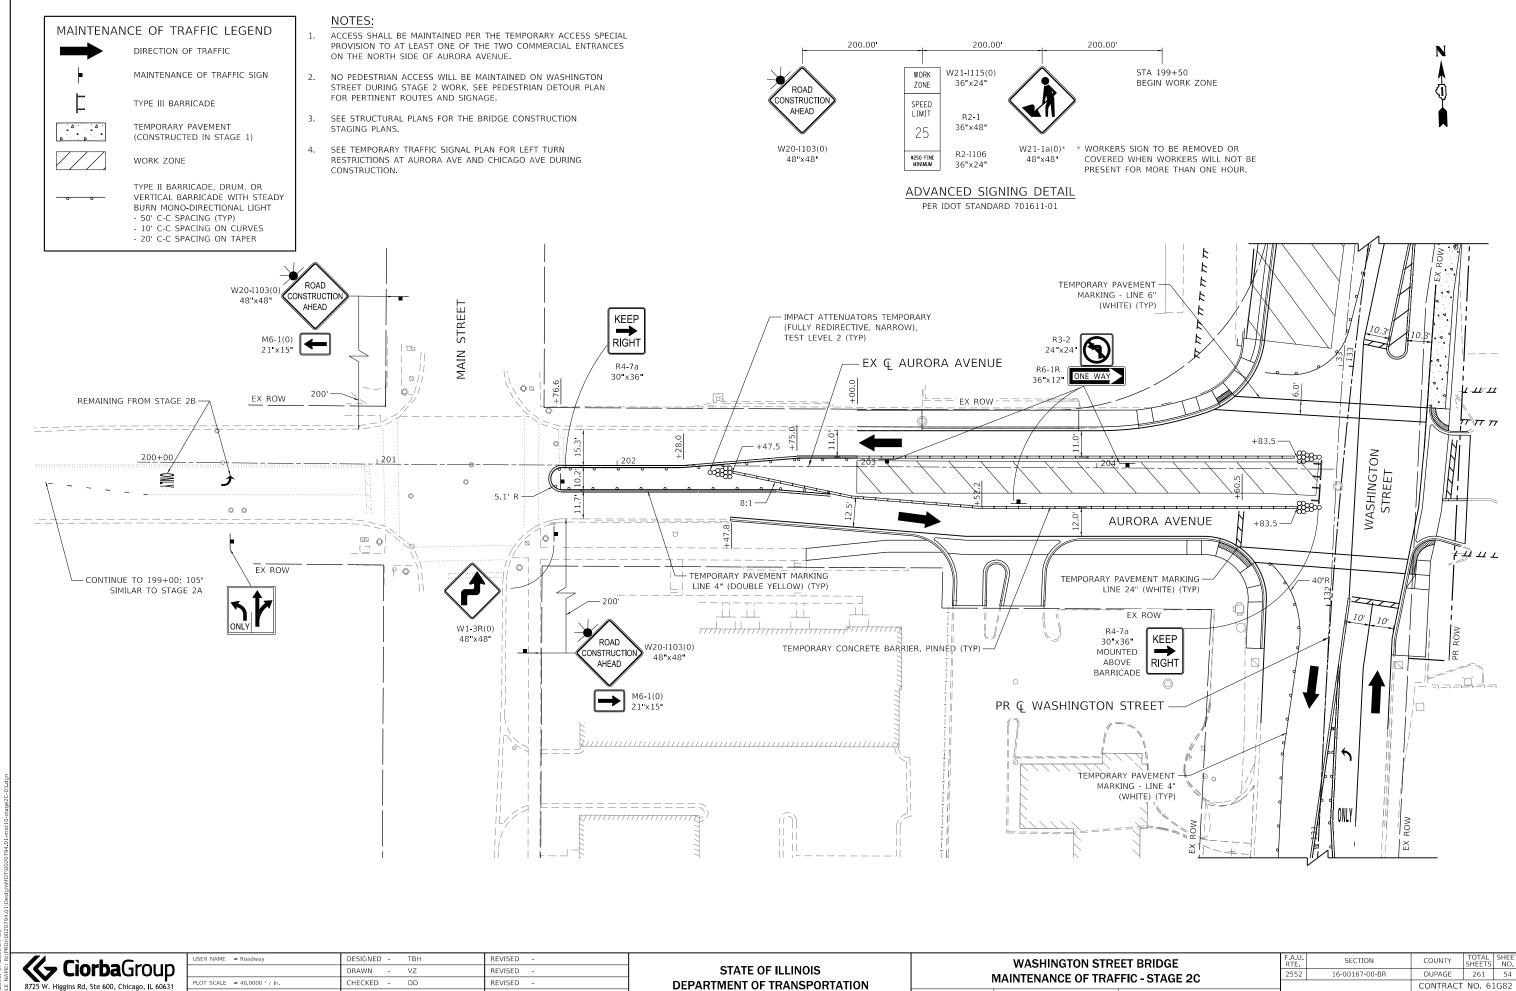

SCALE: 1" = 20' SHEET 10 OF 16 SHEETS STA.


MODEL: \$MODELNAME\$


P 773 775 4009 L www.ciorba.com


PLOT DATE = 8/8/2022

8/8/2022

REVISED

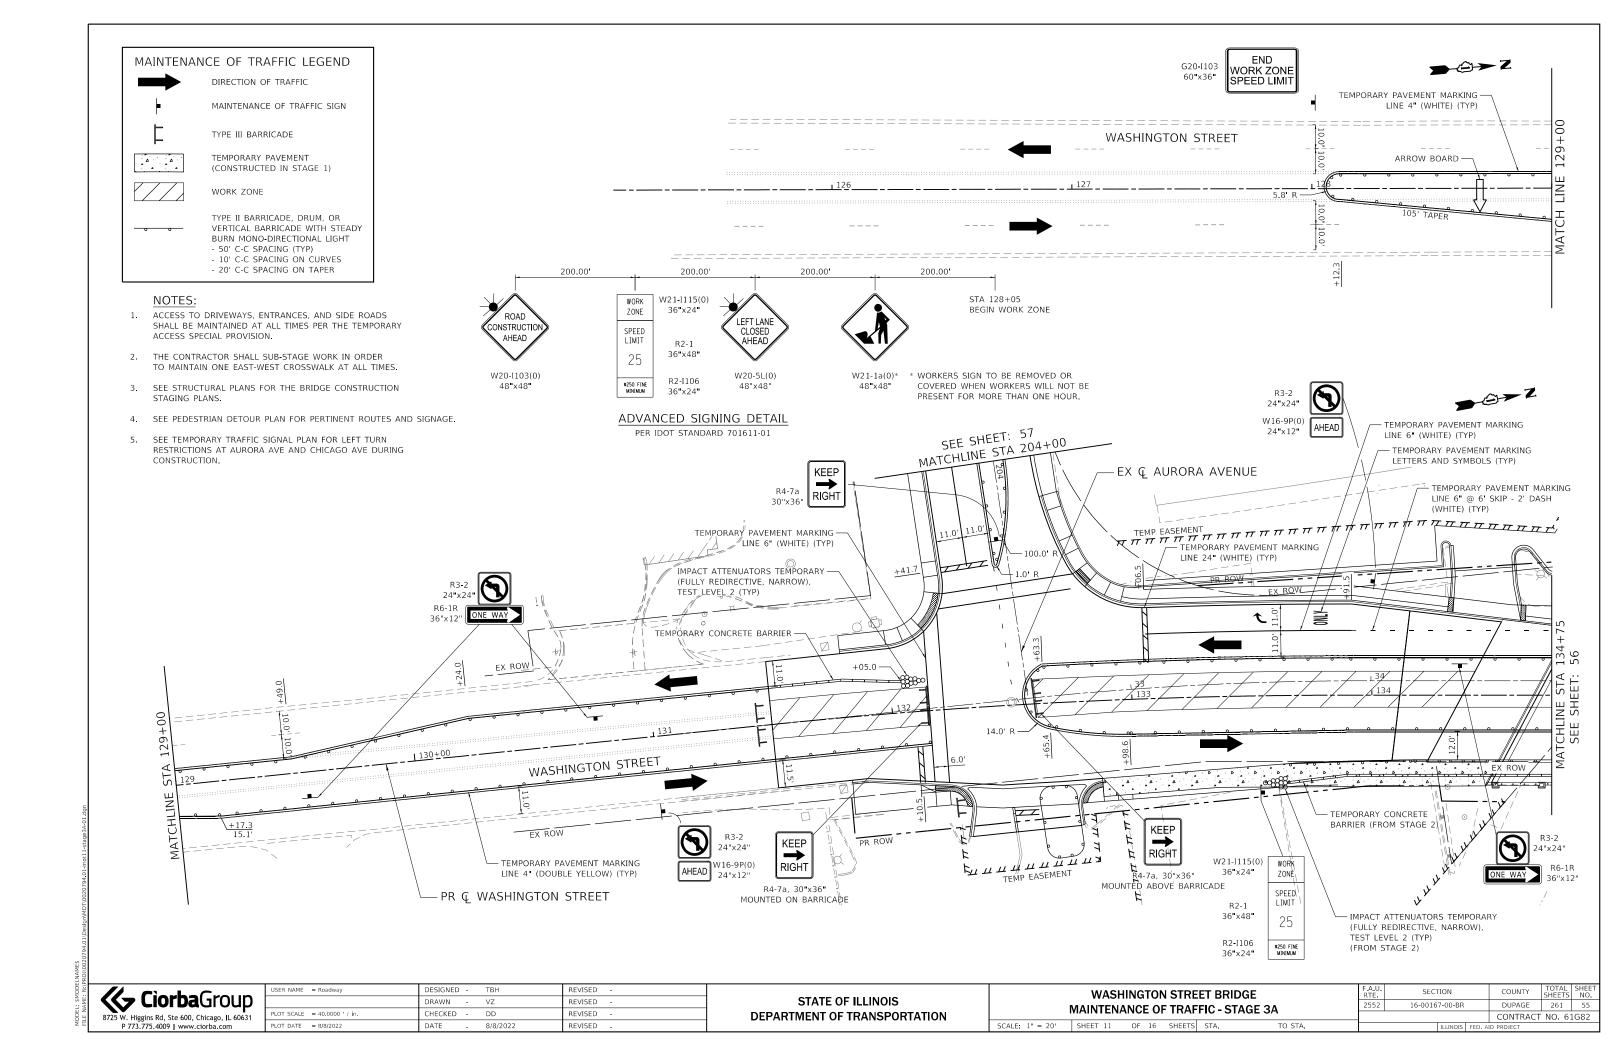


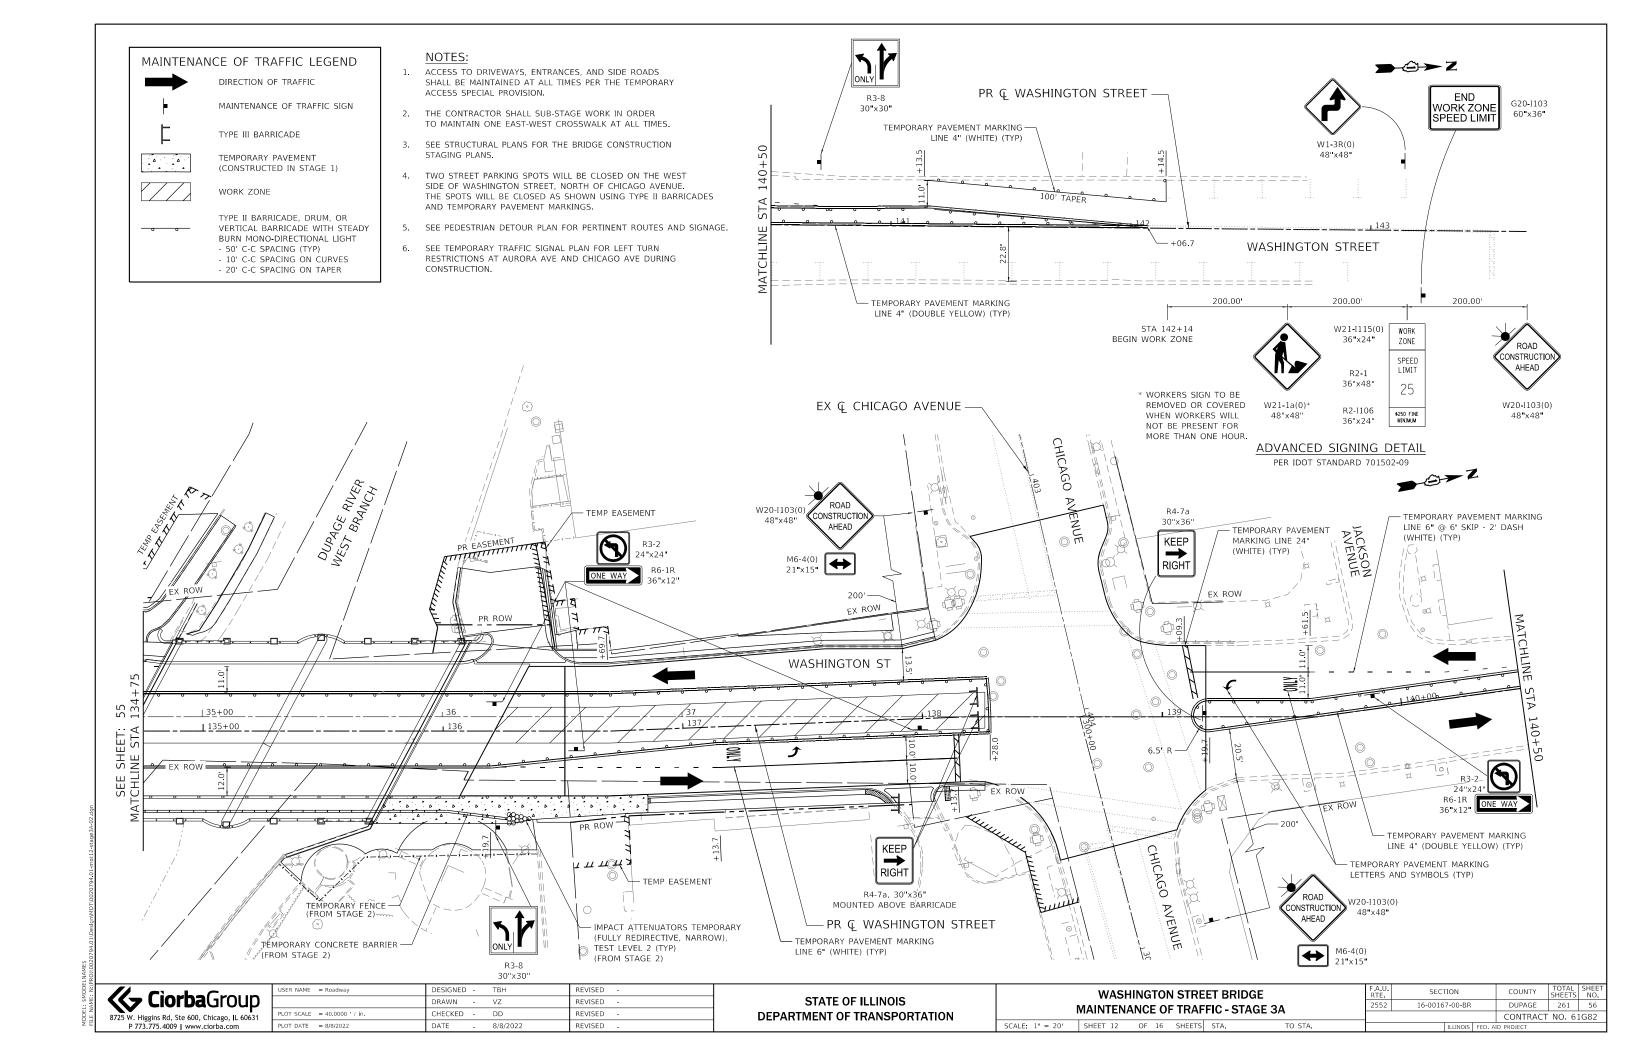


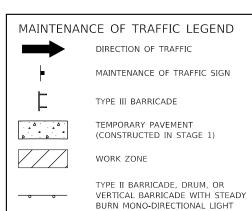

- 50' C-C SPACING (TYP) - 10' C-C SPACING ON CURVES - 20' C-C SPACING ON TAPER NOTES:

- ACCESS TO DRIVEWAYS, ENTRANCES, AND SIDE ROADS SHALL BE MAINTAINED AT ALL TIMES PER THE TEMPORARY ACCESS SPECIAL PROVISION.
- 2. THE CONTRACTOR SHALL SUB-STAGE WORK IN ORDER TO MAINTAIN ONE EAST-WEST CROSSWALK AT ALL TIMES.
- SEE STRUCTURAL PLANS FOR THE BRIDGE CONSTRUCTION STAGING PLANS.
- 1. SEE PEDESTRIAN DETOUR PLAN FOR PERTINENT ROUTES AND SIGNAGE.
- SEE TEMPORARY TRAFFIC SIGNAL PLAN FOR LEFT TURN RESTRICTIONS AT AURORA AVE AND CHICAGO AVE DURING CONSTRUCTION.

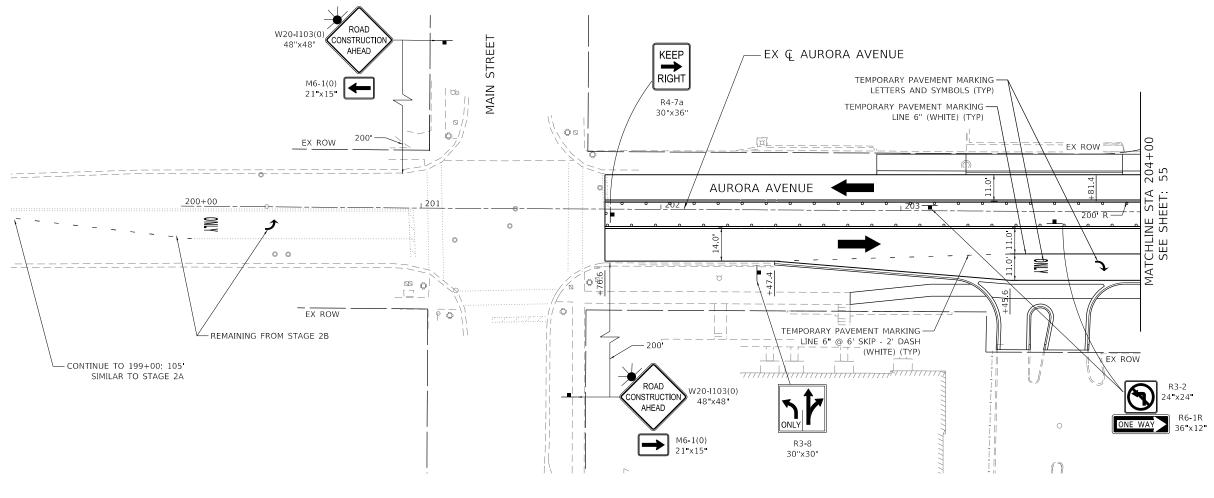

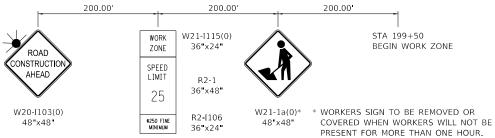

ADVANCED SIGNING DETAIL


PER IDOT STANDARD 701611-01


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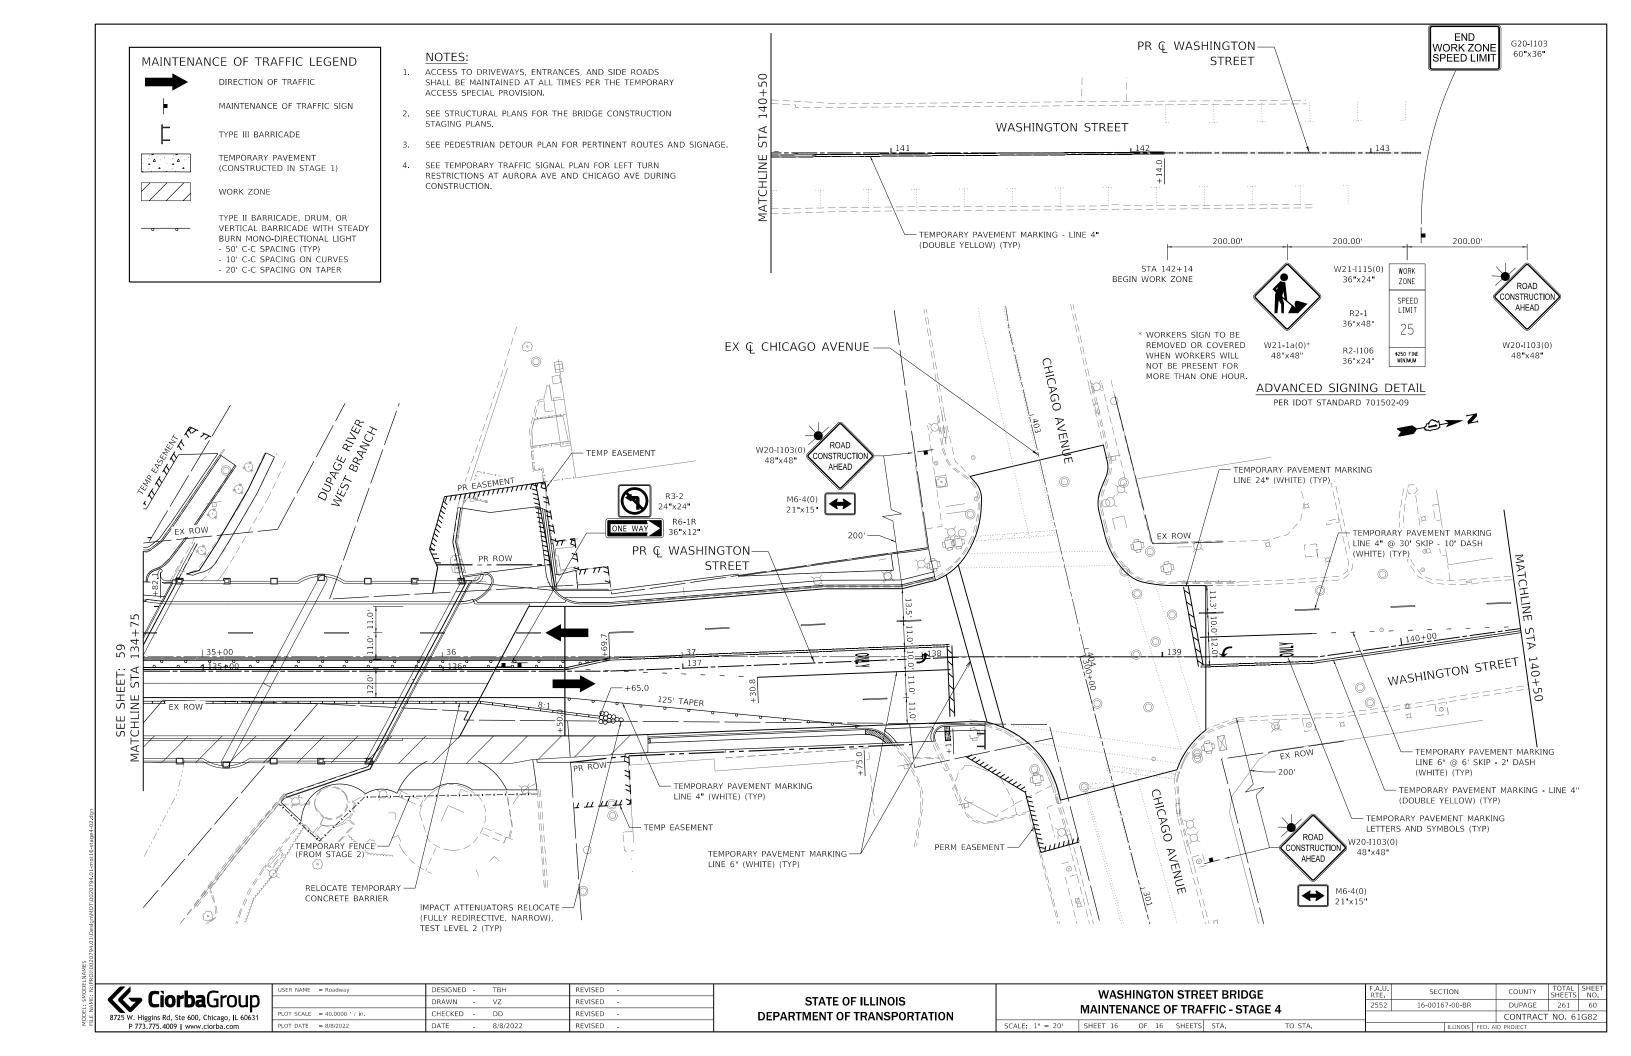
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	DRAWN -	VZ	REVISED -
PLOT SCALE = 40.0000 / in.	CHECKED -	DD	REVISED -
PLOT DATE = 8/8/2022	DATE -	8/8/2022	REVISED -

STATE OF ILLINOIS	
DEPARTMENT OF TRANSPORTATION	


WASHINGTON STREET BRIDGE	F.A.U. RTE	SECT	ΓΙΟΝ		COUNTY	TOTAL SHEETS	SHEET NO.
MAINTENANCE OF TRAFFIC - STAGE 3A	2552	16-0016	7-00-BR		DUPAGE	261	57
MAINTENANCE OF TRAITIO-STAGE OA					CONTRACT	F NO. 6	1G82
SCALE: 1" = 20' SHEET 13 OF 16 SHEETS STA. TO STA.			ILLINOIS	FED. AI	D PROJECT		



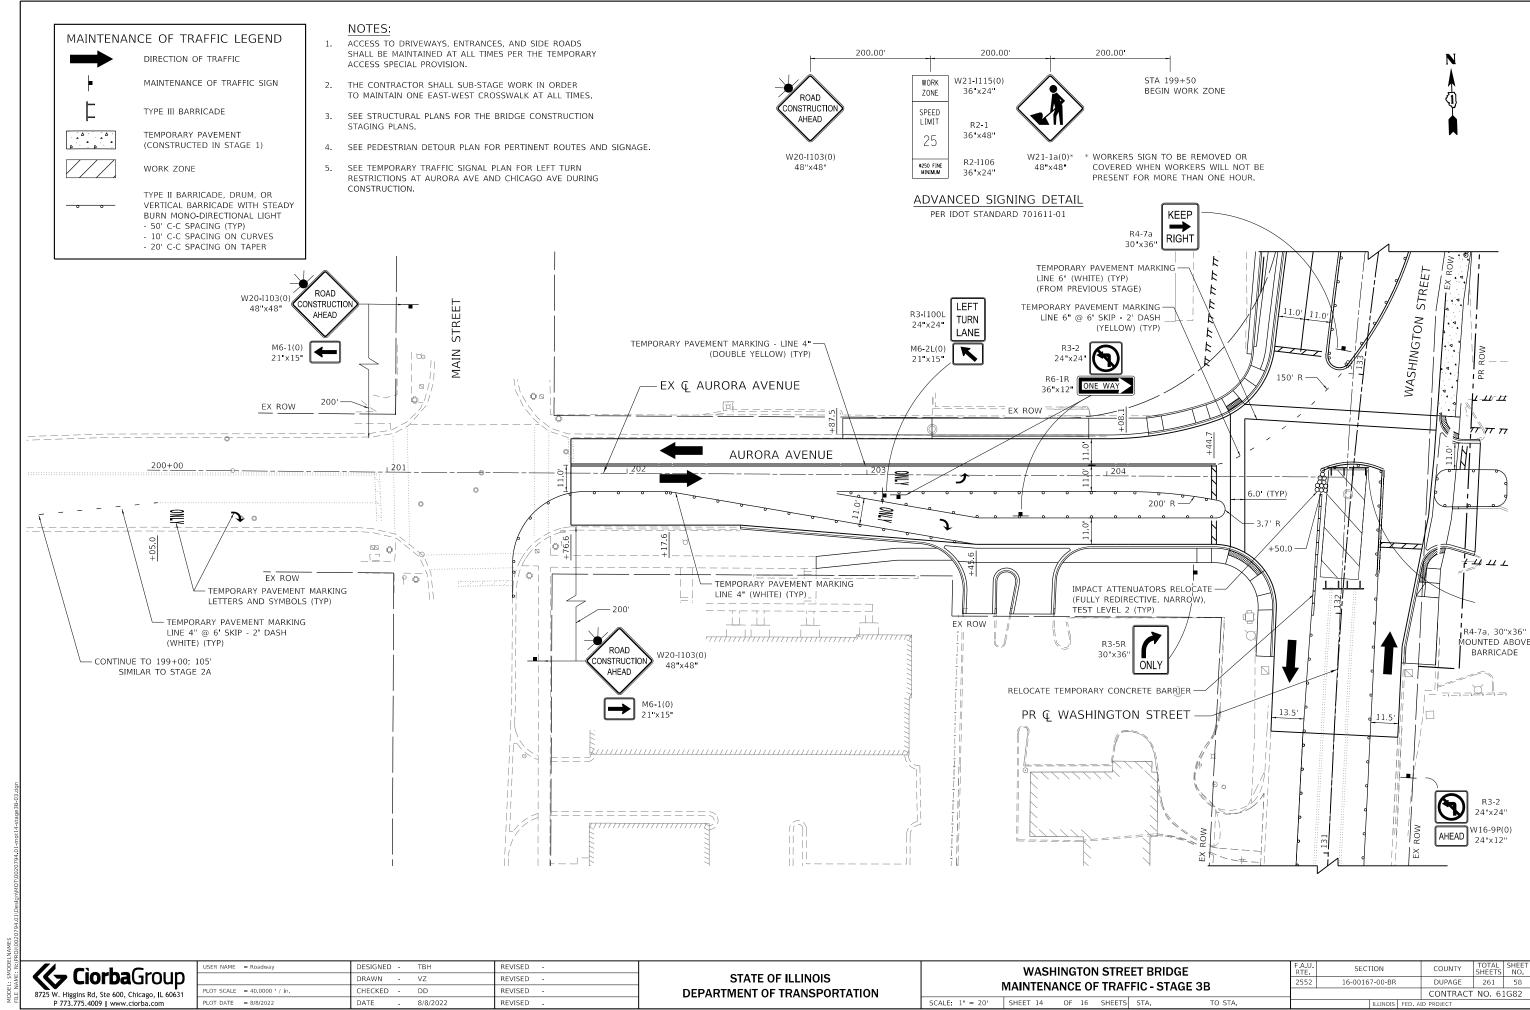

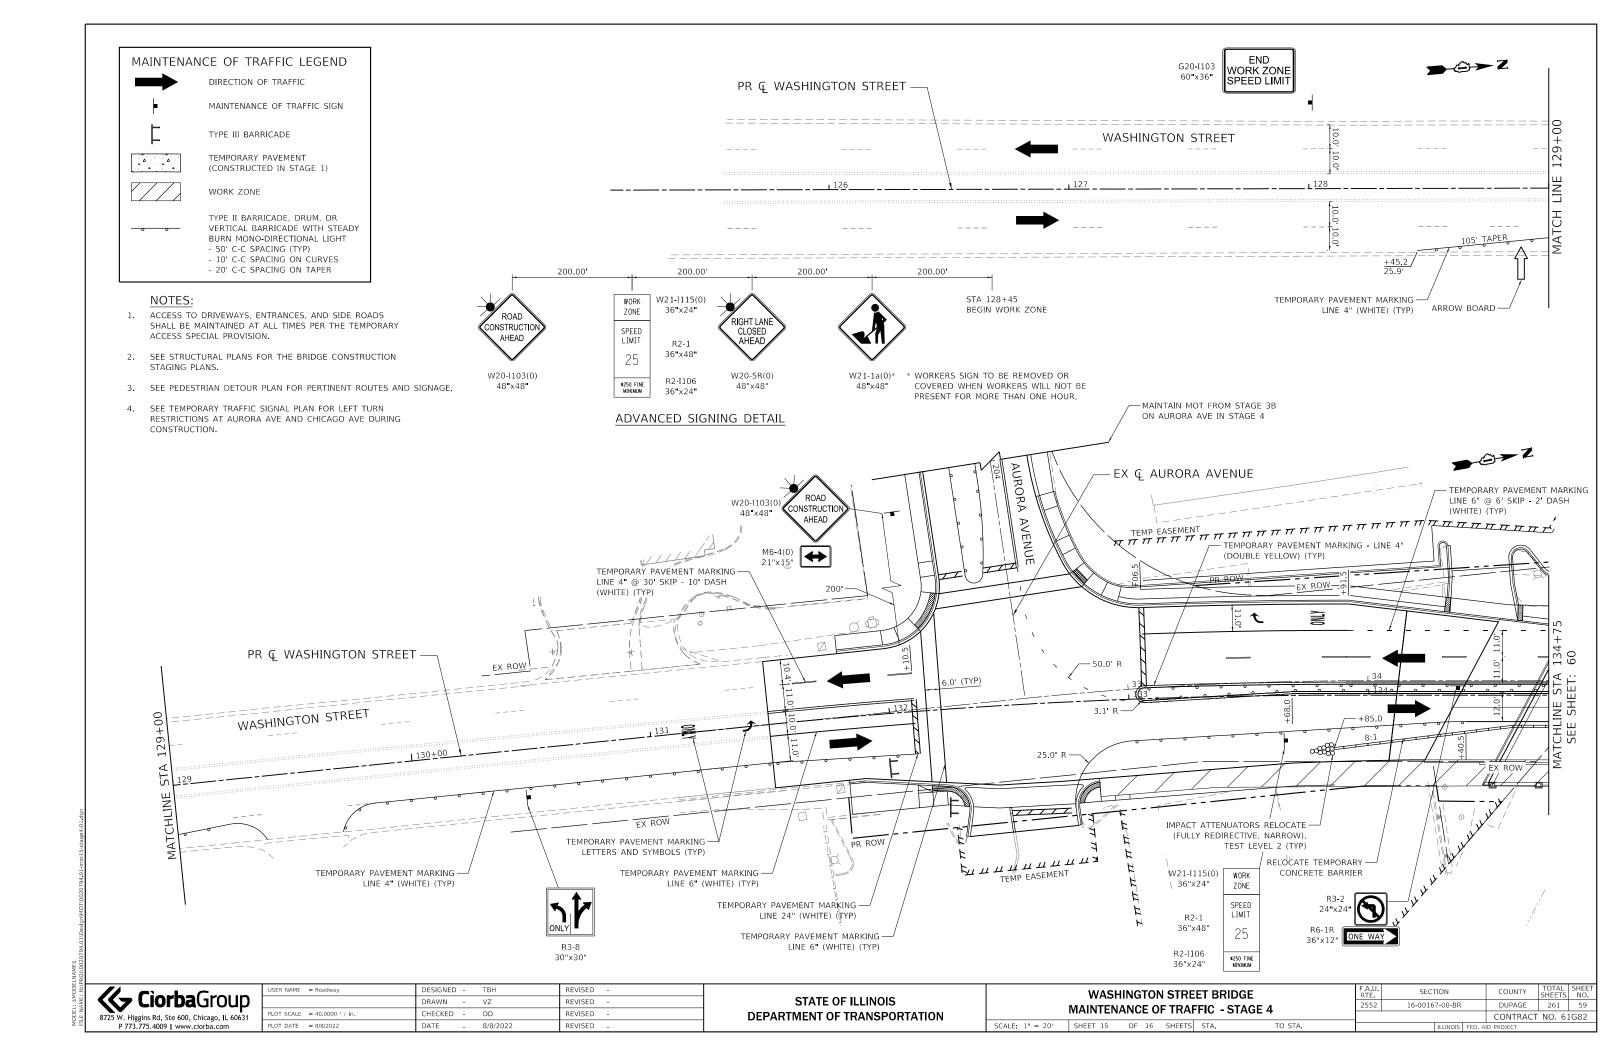

DUPAGE RIVER WATER TRAIL MCDOWELL GROVE TO KNOCH KNOLLS PARK

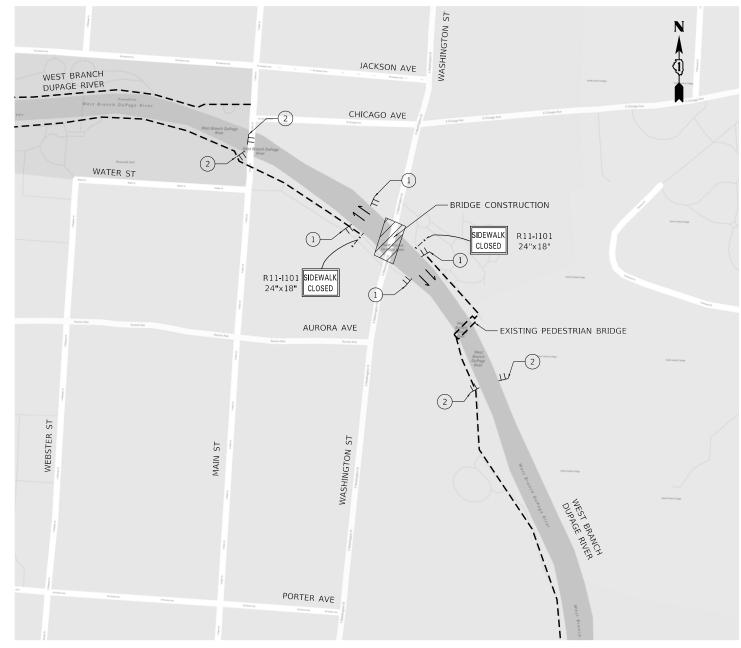

ADVANCED SIGNING PLAN SCALE: N.T.S




CONSTRUCTION SIGN


--- NAPERVILLE RIVERWALK

---- TEMPORARY FENCE

WORK AREA

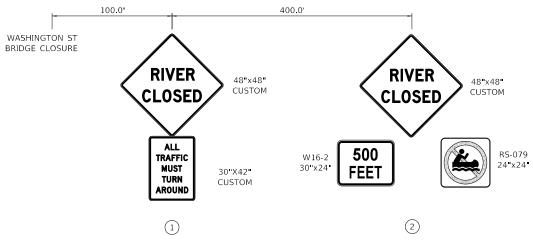

ADVANCED SIGNING DETAIL

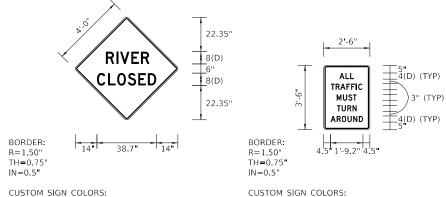

CUSTOM SIGN COLORS: LEGEND/FONT - BLACK

BACKGROUND - ORANGE (RETROFLECTIVE)

LEGEND/FONT - BLACK

BACKGROUND - ORANGE (RETROFLECTIVE)

GENERAL NOTES

NO THROUGH TRAFFIC ALLOWED FOR RIVERWALK OR RIVER DURING WASHINGTON ST BRIDGE CONSTRUCTION. ALL TRAFFIC MUST TURN AROUND. (STAGE 1 AND STAGE 2)

FOR THE DURATION OF CONSTRUCTION, ONE TEMPORARY INFORMATION SIGN IS NEEDED AT THE RIVERWALK ENTRANCE AT HILLSIDE ROAD TO INFORM OF ROAD WORK AT WASHINGTON STREET.

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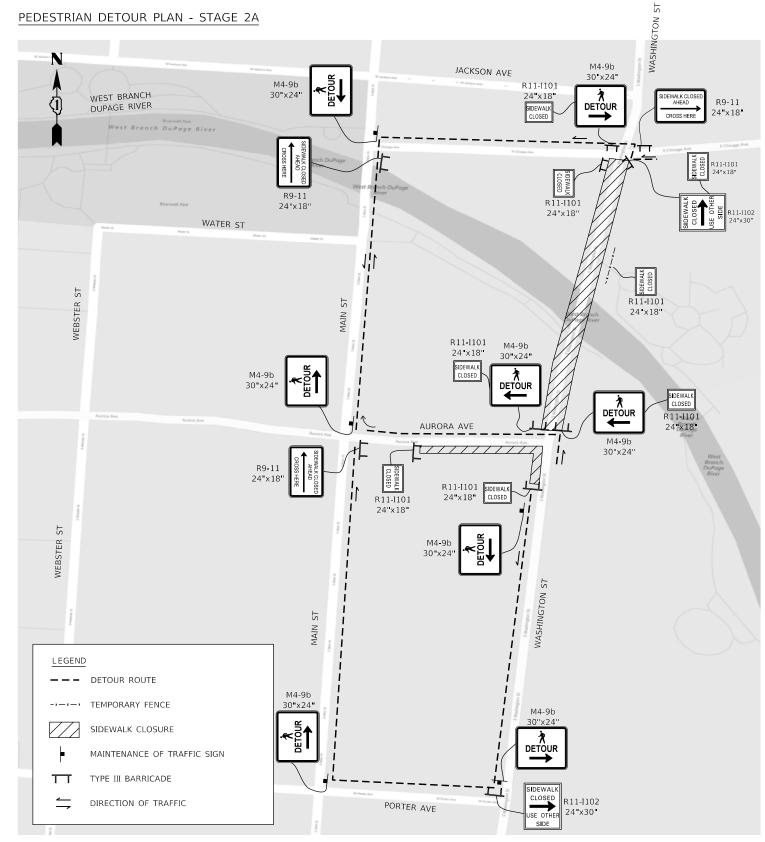
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USER NAME = Roadway	DESIGNED - TBH	REVISED -
	DRAWN - VZ	REVISED -
PLOT SCALE = 40.0000 ' / in.	CHECKED - DD	REVISED -
PLOT DATE = 8/8/2022	DATE - 8/8/2022	REVISED -


STATE OF ILLINOIS **DEPARTMENT OF TRANSPORTATION**

	W	ASHING	iΤΟ	N STRE	ЕТ В	RIDGE	ľ	F.
MAINTENAN	CE OF	TRAFF	C-	CANOE	ADV	ANCED SIGNING PLAN	F	2
CALE: N.T.S.	SHEET	1 OF	1	SHEETS	STA	TO STA	┺	-

SECTION COUNTY 16-00167-00-BR DUPAGE 261 61 CONTRACT NO. 61G82



PEDESTRIAN DETOUR PLAN
SCALE: N.T.S

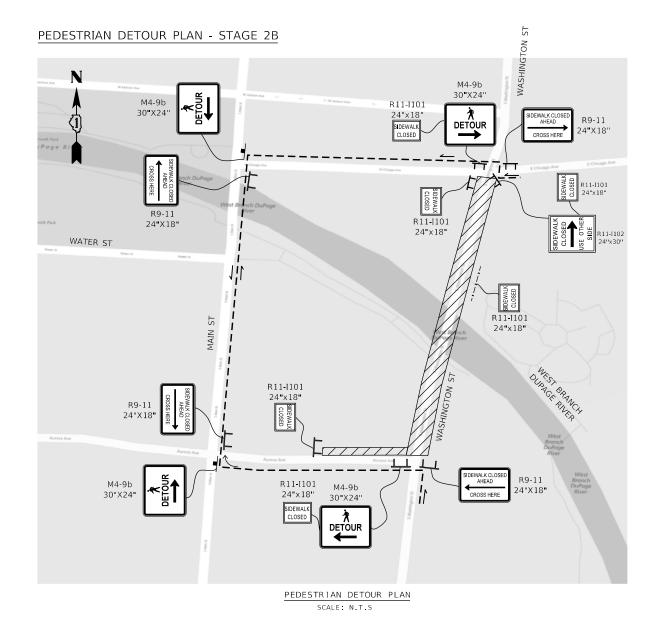


GENERAL NOTES

NO PEDESTRIAN ACCESS WILL BE MAINTAINED ON WASHINGTON STREET DURING STAGE 2 WORK. PEDESTRIANS SHALL USE MAIN STREET APPROXIMATELY 400' WEST OF WASHINGTON STREET.


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	DRAWN - VZ	REVISED -
PLOT SCALE = 40.0000 ' / in.	CHECKED - DD	REVISED -
PLOT DATE = 8/8/2022	DATE - 8/8/2022	REVISED -

	WASI	HINGTO	N STRE	ET BRI	IDGE	F.A.U. RTE	SECT	TION		COUNTY	TOTAL SHEETS	SHEET NO.
MAINTEN	MAINTENANCE OF TRAFFIC - PEDESTRIAN DETOUR PLAN						2 16-00167-00-BR			DUPAGE	261	62
MAINTEN	MAINTLINANCE OF TRAFFIC - PEDESTRIAN DETOUR FLAN									CONTRAC	T NO. 6	1G82
SCALE: N.T.S.	SHEET 1	OF 2	SHEETS	STA.	TO STA.			ILLINOIS	FED. A	ID PROJECT		


PEDESTRIAN DETOUR PLAN - STAGE 3A

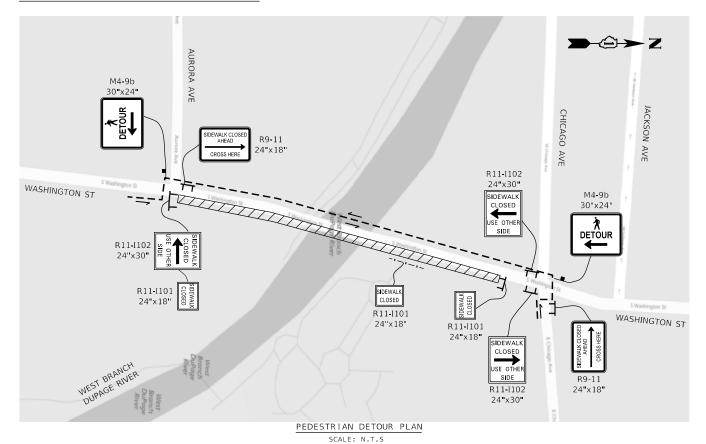

PEDESTRIAN DETOUR PLAN - STAGE 3B

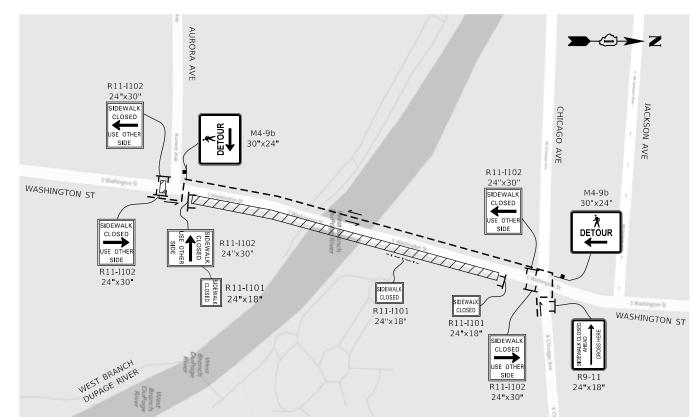


PEDESTRIAN DETOUR PLAN - STAGE 4

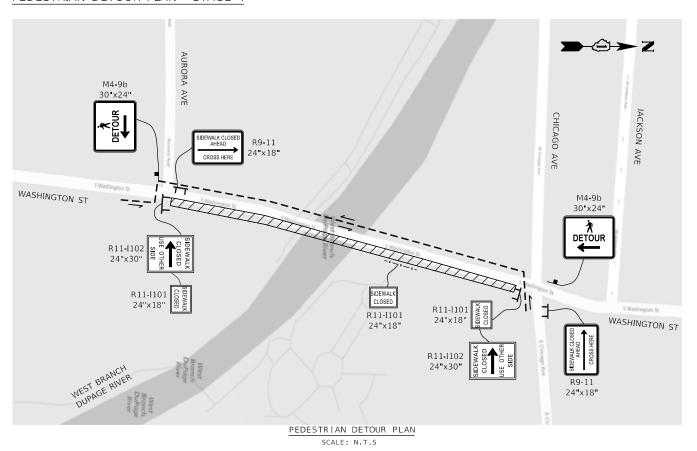

GENERAL NOTES

THE CONTRACTOR SHALL SUB-STAGE WORK IN ORDER TO MAINTAIN ONE EAST-WEST CROSSWALK AT ALL TIMES DURING STAGE 3.

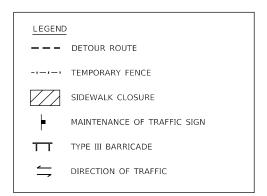



PEDESTRIAN DETOUR PLAN
SCALE: N.T.S

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<>> Ciorba Group
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8725 W. Higgins Rd, Ste 600, Chicago, JL 60631
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USER NAME = Roadway	DESIGNED -	TBH	REVISED -
	DRAWN -	VZ	REVISED -
PLOT SCALE = 40.0000 / in.	CHECKED -	DD	REVISED -
PLOT DATE = 8/8/2022	DATE -	8/8/2022	REVISED -

							F.A.U. RTE		SEC	TION		COUNTY	TOTAL SHEETS	SHEET NO.	
MAINTEN	ANCE OF	TRAI	FFIC	- PFD	FSTRI/	AN DETOLI	P DI AN	2552	2 16-00167-00-BR				DUPAGE	261	63
MAINTEN	MAINTENANCE OF TRAFFIC - PEDESTRIAN DETOUR PLAN												CONTRAC	T NO. 6	1G82
SCALE: N.T.S.	SHEET 2	OF	2	SHEETS	STA.	TO	STA.				ILLINOIS	FED. A	ID PROJECT		



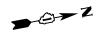
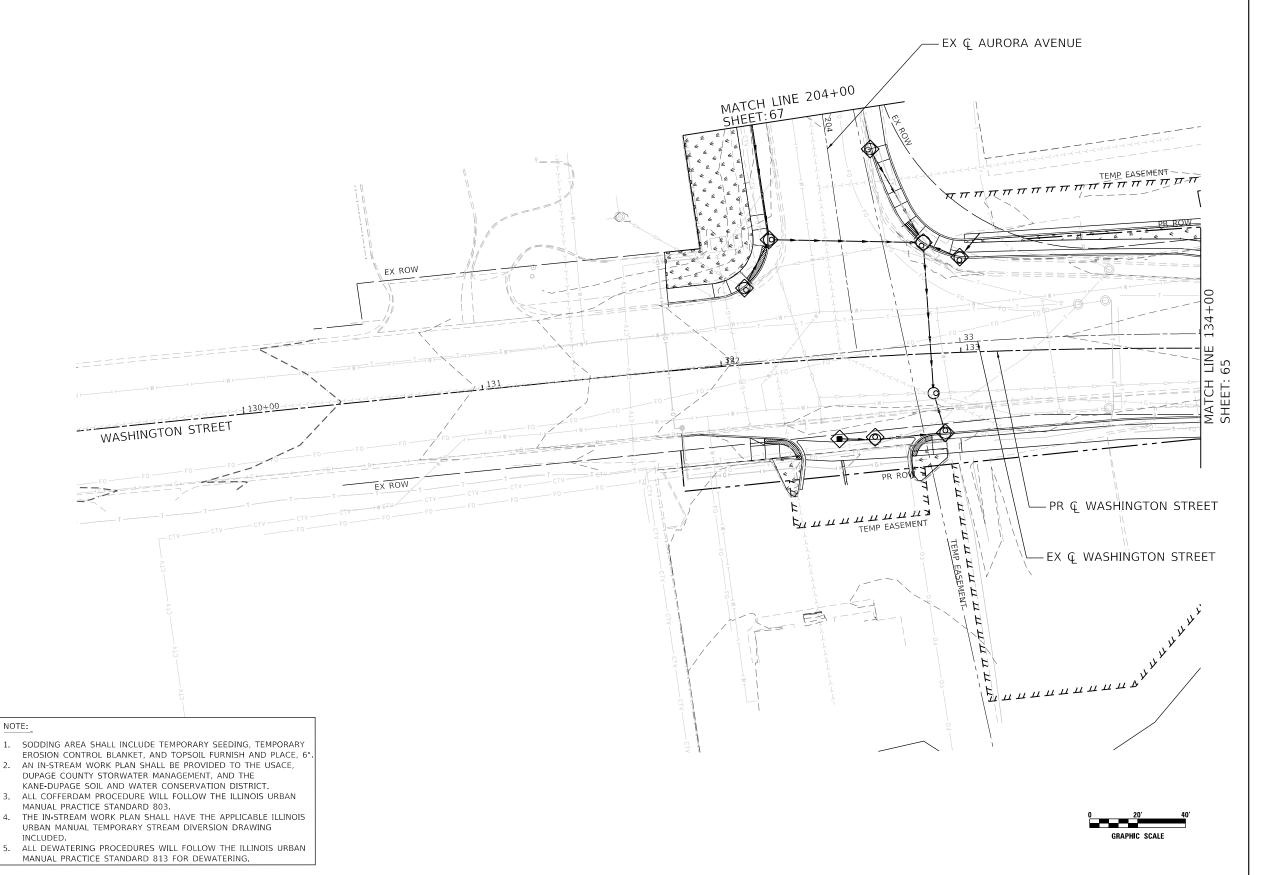
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INLET FILTER

SILT CURTAIN


SALT TOLERANT SODDING
(SEE NOTE 1)


PERIMETER EROSION BARRIER

STATE OF ILLINOIS
DEPARTMENT OF TRANSPORTATION

F.A.U. SECTION COUNTY TOTAL SHEET'S NO.
2552 16-00167-00-BR DUPAGE 261 64

CONTRACT NO. 61G82

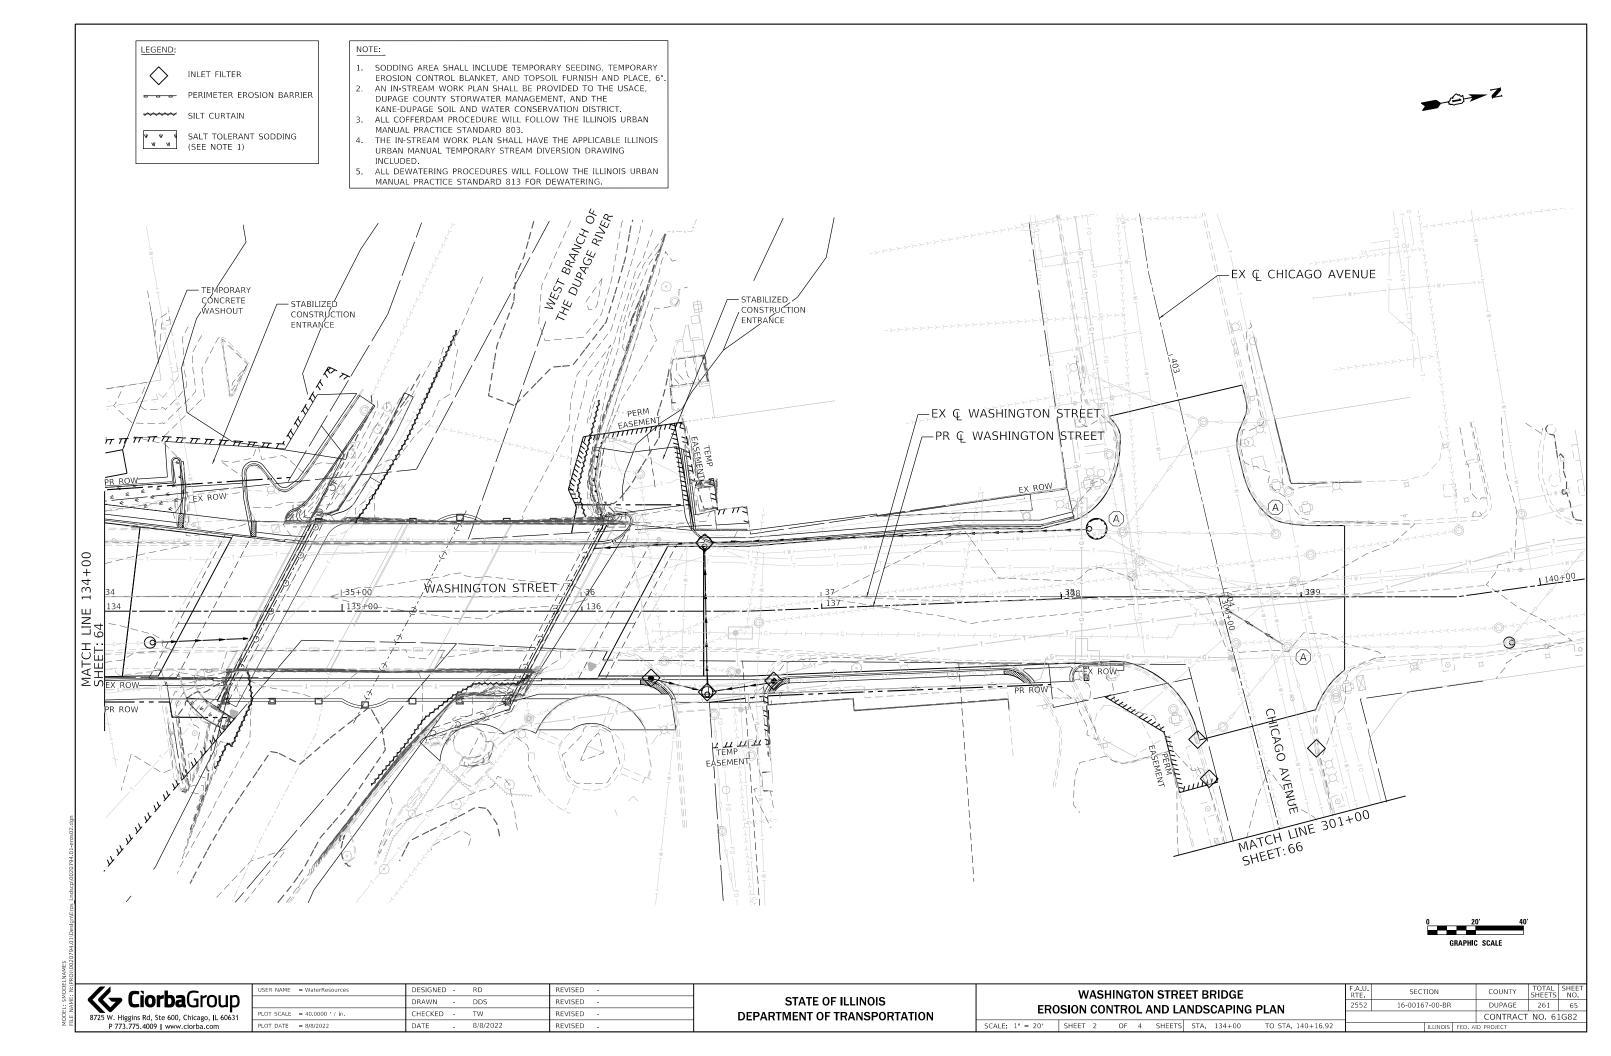

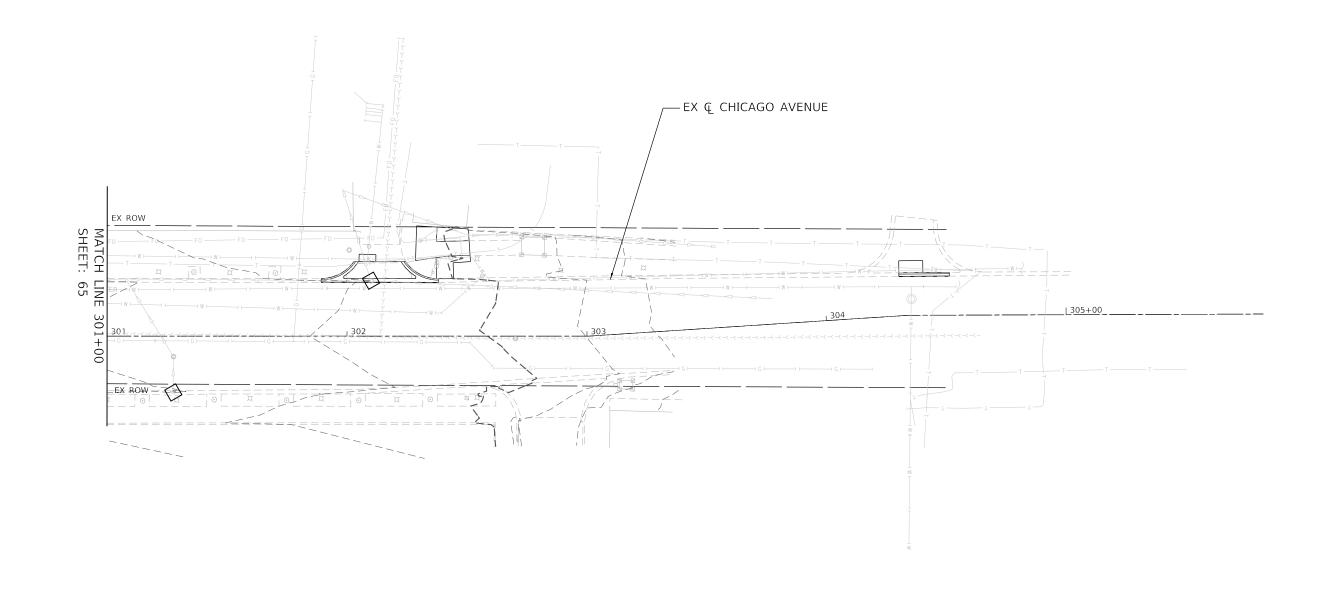





INLET FILTER

--- PERIMETER EROSION BARRIER

SILT CURTAIN

SALT TOLERANT SODDING
(SEE NOTE 1)

- 1. SODDING AREA SHALL INCLUDE TEMPORARY SEEDING, TEMPORARY EROSION CONTROL BLANKET, AND TOPSOIL FURNISH AND PLACE, 6".
- 2. AN IN-STREAM WORK PLAN SHALL BE PROVIDED TO THE USACE, DUPAGE COUNTY STORWATER MANAGEMENT, AND THE KANE-DUPAGE SOIL AND WATER CONSERVATION DISTRICT. ALL COFFERDAM PROCEDURE WILL FOLLOW THE ILLINOIS URBAN
- MANUAL PRACTICE STANDARD 803. THE IN-STREAM WORK PLAN SHALL HAVE THE APPLICABLE ILLINOIS URBAN MANUAL TEMPORARY STREAM DIVERSION DRAWING INCLUDED.
- ALL DEWATERING PROCEDURES WILL FOLLOW THE ILLINOIS URBAN MANUAL PRACTICE STANDARD 813 FOR DEWATERING.






USER NAME = WaterResources	DESIGNED -	RD	REVISED -
	DRAWN -	DDS	REVISED -
PLOT SCALE = 40.0000 / in.	CHECKED -	TW	REVISED -
PLOT DATE = 8/8/2022	DATE -	8/8/2022	REVISED -

STATE OF ILLINOIS
DEPARTMENT OF TRANSPORTATION

	WASH	IING	TON	STRE	ET B	RIDGE		F.A.U. RTE	SECT	ION		C
EROSION CONTROL AND LANDSCAPING PLAN							2552	16-00167	7-00-BR		С	
LIV	EROSION CONTROL AND LANDSCAFING FLAN											CC
SCALE: 1" = 20'	SHEET 3	OF	4	SHEETS	STA.	301+00	TO STA. 305+00			ILLINOIS	FED. AI	D PRO

COUNTY	TOTAL SHEETS	SHEE NO.
DUPAGE	261	66
CONTRACT	NO 6	1682

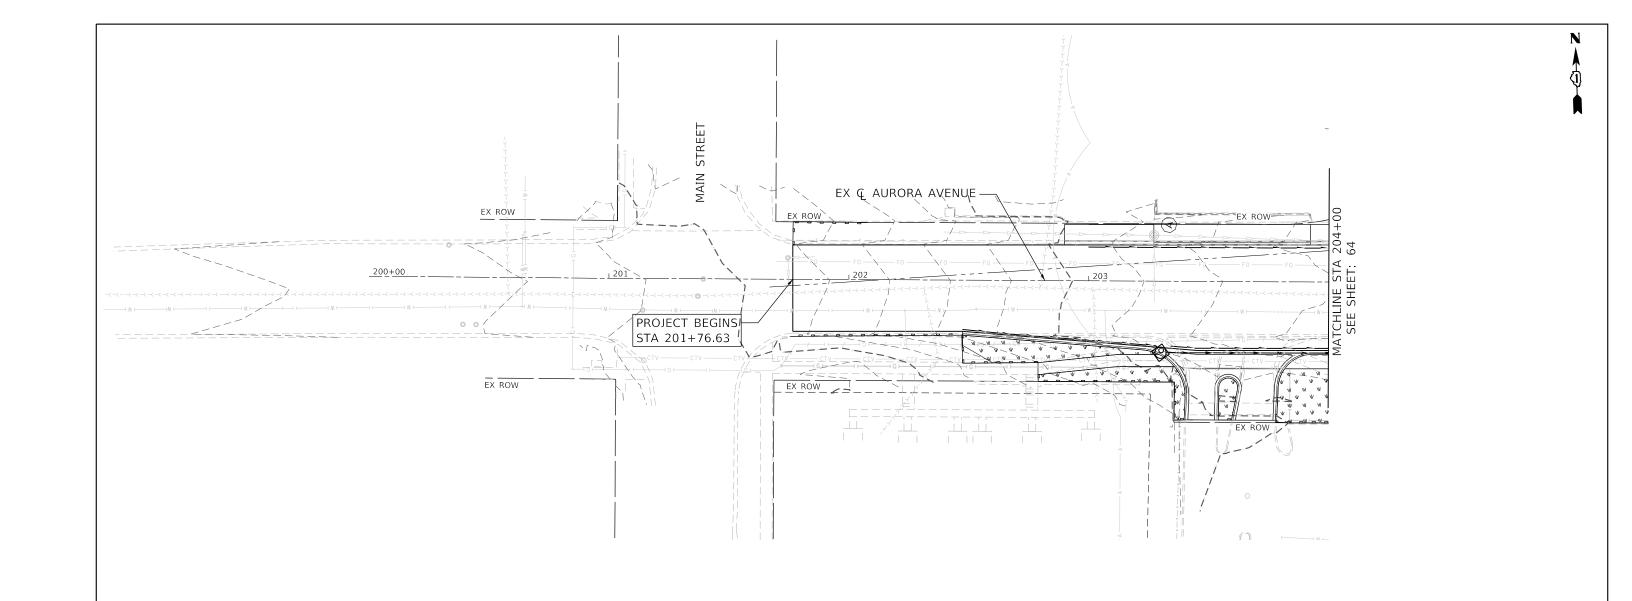





INLET FILTER

PERIMETER EROSION BARRIER



SILT CURTAIN



SALT TOLERANT SODDING
(SEE NOTE 1) (SEE NOTE 1)

NOTE:

- SODDING AREA SHALL INCLUDE TEMPORARY SEEDING, TEMPORARY EROSION CONTROL BLANKET, AND TOPSOIL FURNISH AND PLACE, 6°. AN IN-STREAM WORK PLAN SHALL BE PROVIDED TO THE USACE, DUPAGE COUNTY STORWATER MANAGEMENT, AND THE KANE-DUPAGE SOIL AND WATER CONSERVATION DISTRICT. ALL COFFERDAM PROCEDURE WILL FOLLOW THE ILLINOIS URBAN MANUAL PRACTICE STANDARD 803.

 THE IN-STREAM WORK PLAN SHALL HAVE THE APPLICABLE ILLINOIS URBAN MANUAL TEMPORARY STREAM DIVERSION DRAWING INCLUDED. INCLUDED.
- ALL DEWATERING PROCEDURES WILL FOLLOW THE ILLINOIS URBAN MANUAL PRACTICE STANDARD 813 FOR DEWATERING.





	USER NAME = WaterResources	DESIGNED -	RD	REVISED -
		DRAWN -	DDS	REVISED -
	PLOT SCALE = 40.0000 ' / in.	CHECKED -	TW	REVISED -
	PLOT DATE = 8/8/2022	DATE -	8/8/2022	REVISED -
_	* *			

STATE OF ILLINOIS	
DEPARTMENT OF TRANSPORTATION	

WASHINGTON STREET BRIDGE	F.A.U. RTE	SECTION	COUNTY	TOTAL SHEETS	SHEET NO.
EROSION CONTROL AND LANDSCAPING PLAN	2552	16-00167-00-BR	DUPAGE	261	67
ENOSIGN CONTINUE AND EARDSOAF ING FEAR			CONTRACT	NO. 6	1G82
SCALE: 1" = 20' SHEET 4 OF 4 SHEETS STA. 200+00 TO STA.204+00		ILLINOIS FED. A	ID PROJECT		

GENERAL EROSION CONTROL NOTES

- THE CONTRACTOR SHALL MAINTAIN PROPER DRAINAGE AT ALL TIMES DURING THE COURSE OF CONSTRUCTION AND PREVENT STORM WATER FROM RUNNING INTO OR STANDING IN EXCAVATED AREAS.
- DURING EXTENDED DRY PERIODS, THE CONSTRUCTION AREA(S) MAY NEED TO BE WATERED DOWN TO PREVENT THE BLOWING OF SOIL FROM THE SITE.
- 3. DURING CONSTRUCTION, A STABILIZED CONSTRUCTION ENTRANCE SHALL BE UTILIZED TO MINIMIZE THE TRACKING OF DIRT ONTO THE PUBLIC STREETS. IT IS THE CONTRACTOR'S RESPONSIBILITY TO KEEP PUBLIC STREET PAVEMENT CLEAN OF DIRT AND DEBRIS. ANY DIRT THAT IS TRACKED ONTO THE PUBLIC STREETS SHALL BE REMOVED THE SAME DAY. IF THE AMOUNT TRACKED ON THE PUBLIC STREET IS EXCESSIVE, CLEANING MAY BE REQUIRED MORE FREQUENTLY.
- 4. A REGIONAL 404 PERMIT WILL BE OBTAINED FOR THIS PROJECT AND THE CONDITIONS OF THAT PERMIT MUST BE ADHERED TO. THE CONTRACTOR MUST SUBMIT AN IN-STREAM WORK PLAN TO THE USACE, THE DUPAGE COUNTY STORWATER MANAGEMENT, AND THE KANE-DUPAGE SOIL AND WATER CONSERVATION DISTRICT FOR APPROVAL, PRIOR TO ANY WORK IN THE CREEK.
- 5. ALL EROSION CONTROL MEASURES SHALL BE PROPERLY INSTALLED, AS PERMITTED, PRIOR TO ANY LAND DISTURBANCE ACTIVITIES. ALL EROSION CONTROL SHALL BE MAINTAINED UNTIL TURF IS ESTABLISHED.
- ACCEPTABLE PERIMETER EROSION CONTROL INCLUDES SILT FENCE, SILT WORM AND ANY OTHER APPLICATION APPROVED BY THE CITY ENGINEER.
- 7. ALL OPEN GRATE STRUCTURES SHALL HAVE EROSION CONTROL PROTECTION IN ACCORDANCE WITH THE APPROVED EROSION CONTROL PLANS. INLET BASKETS ARE THE PREFERRED METHOD; STRAW BALES SHALL NOT BE USED.
- STABILIZATION OF DISTURBED AREAS MUST BE INITIATED WITHIN 1 WORKING DAY OF PERMANENT OR TEMPORARY CESSATION OF EARTH DISTURBING ACTIVITIES AND SHALL BE COMPLETED AS SOON AS POSSIBLE, BUT NO LATER THAN 14 DAYS FROM THE INITIATION OF THE STABILIZATION WORK IN AN AREA.
- BACKUP BEST MANAGEMENT PRACTICES SHALL BE KEPT ON SITE TO IMPLEMENT IMMEDIATE CORRECTIONAL ACTION FOLLOWING ANY INSTANCE OF NON-COMPLIANCE.
- 10. CONCRETE WASHOUT SHOULD BE CONTAINED AT ALL TIMES. WASHOUT MATERIAL SHOULD NOT BE ALLOWED TO ENTER WATER BODIES, STORM SEWERS OR LEACH INTO THE SOIL UNDER ANY CIRCUMSTANCES. ANY WASTE SHOULD BE DISPOSED OF PROPERLY AND THE LOCATION OF THE WASHOUT SHOULD BE DESIGNED WITH PROPER SIGNAGE. FAILURE TO COMPLY COULD RESULT IN A VIOLATION OF THE USACE PERMIT.

OPERATION AND MAINTENANCE NOTES

- 1. THE FOLLOWING OPERATION AND MAINTENANCE FOR ALL TEMPORARY AND PERMANENT EROSION AND SEDIMENT CONTROL SHALL BE PERFORMED BY THE CONTRACTOR.
 - A. SILT FENCE SHALL BE INSPECTED FREQUENTLY AND MAINTAINED OR REPLACED AS REQUIRED TO MAINTAIN BOTH THEIR EFFECTIVENESS AND INTEGRITY.
 - B. INLET FILTERS OR INLET PROTECTIONS WILL BE PLACED UNDER/OVER GRATES OF STORM SEWER INLETS AND CATCH BASINS, IN SUCH A MANNER TO MAINTAIN THE STABILITY OF THE FILTER FABRIC HOLDING THE SEDIMENT DURING CONSTRUCTION. THE INLET FILTERS AND PROTECTIONS SHALL BE CLEANED OR REPLACED AS NEEDED TO PROVIDE ADEOUATE FILTERING AND FLOW CAPACITY.
 - C. EACH SILT CURTAIN PRACTICE OR DEVICE SHALL BE INSPECTED DAILY AT A MINIMUM, USING A BOAT WHERE REQUIRED, THE INSPECTION SHALL CHECK THE CONDITION OF THE FLOATATION DEVICE, THE FABRIC, LOAD LINE, ANCHORS, AND BUOYS, AS WELL AS THE LOCATION AND FUNCTIONALITY. ADDITIONALLY, THE BOTTOM OF THE SILT CURTAIN SHALL BE INSPECTED FOR FOLDS AND ACCUMULATED SILT, WHICH MAY PULL THE SILT CURTAIN UNDER THE WATER. ADDITIONAL REQUIREMENTS OF SILT CURTAIN ARE LISTED IN THE SPECIAL PROVISIONS PREPARED FOR THIS PROJECT.
 - D. THE CONTRACTOR SHALL CLEAN ALL ROADS OF DIRT AND DEBRIS DEPOSITED BECAUSE OF CONSTRUCTION ACTIVITIES ASSOCIATED WITH THIS PROJECT AT THE END OF EACH DAY'S OPERATION.
 - E. VEGETATION STABILIZATION AREAS SHALL BE MAINTAINED BY FERTILIZING, MULCHING, RESEEDING, FILLING OF RIVULETS OR BY OTHER APPLICABLE AND GENERALLY ACCEPTABLE MEANS AS REQUIRED TO DEVELOP AN ACCEPTABLE STAND OF VEGETATION.
- SESC INSPECTIONS WILL BE CONDUCTED WEEKLY AND AFTER SIGNIFICANT RAINFALL EVENTS OF ½ INCH OR GREATER.

IN-STREAM WORK NOTES:

- WORK IN THE WATERWAY SHOULD BE TIMED TO TAKE PLACE DURING LOW OR NO-FLOW CONDITIONS. LOW FLOW CONDITIONS ARE FLOW AT OR BELOW THE NORMAL WATER FLEVATION.
- THE PLAN WILL BE DESIGNED TO ALLOW FOR THE CONVEYANCE OF THE 2-YEAR PEAK FLOW PAST THE WORK AREA WITHOUT OVERTOPPING THE COFFERDAM. THE CORPS HAS THE DISCRETION TO REDUCE THIS REQUIREMENT IF DOCUMENTED BY THE APPLICANT TO BE INFEASIBLE OR UNNECESSARY.
- 3. WATER SHALL BE ISOLATED FROM THE IN-STREAM WORK AREA USING COFFERDAM CONSTRUCTED OF NON-ERODIBLE MATERIALS (STEEL SHEET, AQUA BARRIERS, RIP RAP AND GEOTEXTILE LINER, ECT.). EARTHEN COFFERDAM ARE NOT PERMISSIBLE.
- 4. THE COFFERDAM MUST BE CONSTRUCTED FROM THE UPLAND AREA AND NO EQUIPMENT MAY ENTER FLOWING WATER AT ANY TIME. IF THE INSTALLATION OF THE COFFERDAM CANNOT BE COMPLETED FROM SHORE AND ACCESS IS NEEDED TO REACH THE AREA TO BE COFFERED, OTHER MEASURES, SUCH AS THE CONSTRUCTION OF A CAUSEWAY, WILL BE NECESSARY TO ENSURE THAT EQUIPMENT DOES NOT ENTER THE WATER. ONCE THE COFFERDAM IS IN PLACE AND THE ISOLATED AREA IS DEWATERED, EQUIPMENT MAY ENTER THE COFFERED AREA TO PERFORM THE REQUIRED WORK.
- 5. IF BYPASS PUMPING IS NECESSARY, THE INTAKE HOSE SHALL BE PLACED ON A STABLE SURFACE OR FLOATED TO PREVENT SEDIMENT FROM ENTERING THE HOSE. THE BYPASS DISCHARGE SHALL BE PLACED ON A NON-ERODIBLE, ENERGY DISSIPATING SURFACE PRIOR TO REJOINING THE STREAM FLOW AND SHALL NOT CAUSE EROSION. FILTERING OF BYPASS WATER IS NOT NECESSARY UNLESS THE BYPASS WATER HAS BECOME SEDIMENT-LADEN AS A RESULT OF THE CURRENT CONSTRUCTION ACTIVITIES.
- 6. DURING DEWATERING OF THE COFFERED WORK AREA ALL SEDIMENT-LADEN WATER MUST BE FILTERED TO REMOVE SEDIMENT. POSSIBLE OPTIONS FOR SEDIMENT REMOVAL INCLUDE BAFFLE SYSTEM, ANIONIC POLYMERS SYSTEMS, DEWATERING BAGS, OR OTHER APPOPRIATE METHODS. WATER SHALL HAVE SEDIMENT REMOVED PRIOR TO BEING RE-INTRODUCED TO THE DOWNSTREAM WATERWAY. A STABILIZED CONVEYANCE FROM THE DEWATERING DEVICE TO THE WATERWAY MUST BE IDENTIFIED IN THE PLAN. DISCHARGE WATER IS CONSIDERED CLEAN IF IT DOES NOT RESULT IN A VISUALLY IDENTIFIABLE DEGRADATION OF WATER CLARITY.
- 7. THE PORTION OF THE SIDE SLOPE THAT IS ABOVE THE OBSERVED WATER ELEVATION SHALL BE STABILIZED AS SPECIFIED IN THE PLANS PRIOR TO ACCEPTING FLOWS. THE SUBSTRATE AND TOE OF THE SLOPE THAT HAS BEED DISTURBED DUE TO CONSTRUCTION ACTIVITIES SHALL BE RESTORED TO PROPOSED OR PRECONSTRUCTION CONDITIONS AND FULLY STABILIZED PRIOR TO ACCEPTING FLOWS.

KANE-DUPAGE SOIL AND WATER CONSERVATION DISTRICT NOTES

- UNLESS OTHERWISE INDICATED, ALL VEGETATIVE AND STRUCTURAL EROSION AND SEDIMENT CONTROL PRACTICES WILL BE CONSTRUCTED ACCORDING TO MINIMUM STANDARDS AND SPECIFICATIONS IN THE ILLINOIS URBAN MANUAL LATEST EDITION.
- THE KANE-DUPAGE SOIL AND WATER CONSERVATION DISTRICT (KDSWCD) MUST BE NOTIFIED ONE WEEK PRIOR TO THE PRE-CONSTRUCTION CONFERENCE, ONE WEEK PRIOR TO THE COMMENCEMENT OF LAND DISTURBING ACTIVITIES, AND ONE WEEK PRIOR TO THE FINAL INSPECTION.
- A COPY OF THE APPROVED EROSION CONTROL AND SEDIMENT CONTROL PLAN SHALL BE MAINTAINED ON THE SITE AT ALL TIMES. THE PLAN SHALL BE UPDATED AS NEEDED TO MATCH EXISTING CONDITIONS.
- PRIOR TO COMMENCING LAND-DISTURBING ACTIVITIES IN AREAS OTHER THAN INDICATED ON THESE PLANS (INCLUDING, BUT NOT LIMITED TO, ADDITIONAL PHASES OF DEVELOPMENT AND OFF-SITE BORROW OR WASTE AREAS) A SUPPLEMENTARY EROSION CONTROL PLAN SHALL BE SUBMITTED TO THE OWNER FOR REVIEW BY THE KDSWCD.
- THE CONTRACTOR IS RESPONSIBLE FOR INSTALLATION OF ANY ADDITIONAL EROSION
 CONTROL MEASURES NECESSARY TO PREVENT EROSION AND SEDIMENTATION AS DETERMINED
 BY THE KDSWCD.
- 6. DURING DEWATERING OPERATIONS, WATER WILL BE FILTERED OR PUMPED INTO SEDIMENTATION BASINS OR SILT TRAPS. DEWATERING DIRECTLY INTO FIELD TILES OR STORMWATER STRUCTURES IS PROHIBITED.
- 7. IT IS THE RESPONSIBILITY OF THE LANDOWNER AND/OR GENERAL CONTRACTOR TO INFORM ANY SUB-CONTRACTOR(S) WHO MAY PERFORM WORK ON THIS PROJECT, OF THE REQUIREMENTS IN IMPLEMENTING AND MAINTAINING THESE ESOSION CONTROL PLANS AND ASSURE COMPLIANCE WITH ALL APPLICABLE LOCAL, STATE, AND FEDERAL REGULATIONS.




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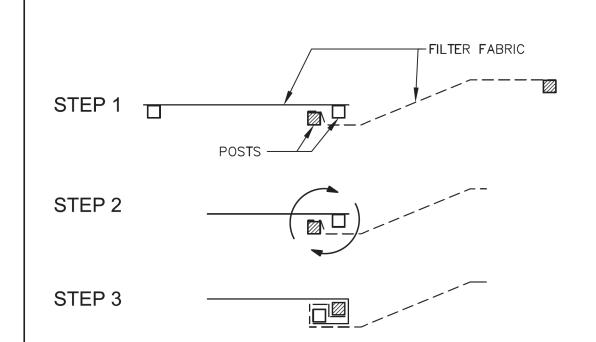
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DEPARTMENT OF TRANSPORTATION

SCALE: N.T.S.

WASHINGTON STREET BRIDGE									SECT
FI	ROSIOI	N C	ONTRO	L NOTES	3			2552	16-0016
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STEPS FOR THE ATTACHMENT OF TWO SILT FENCES:

- 1. PLACE THE END POST OF THE SECOND FENCE INSIDE THE END POST OF THE FIRST FENCE
- 2. ROTATE BOTH POSTS AT LEAST 180 DEGREESIN A CLOCKWISE DIRECTION TO CREATE A TIGHT SEAL WITH THE FABRIC MATERIAL.
- 3. DRIVE BOTH POSTS A MINIMUM OF 18 INCHES INTO THE GROUND AND BURY THE FLAP.

NOTES:

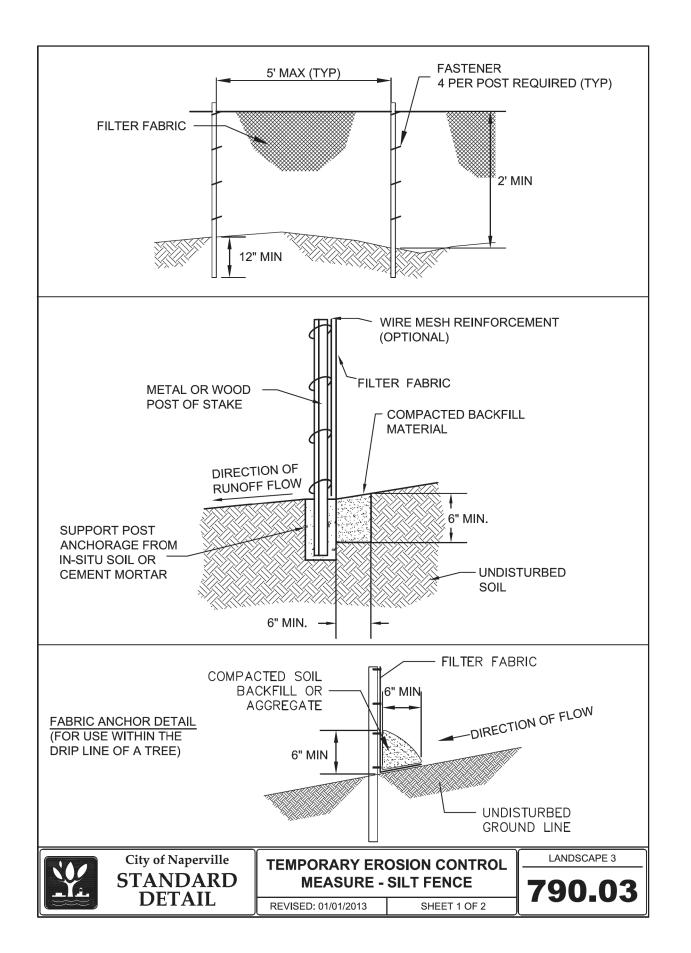- 1. TEMPORARY SILT FENCE SHALL BE INSTALLED PRIOR TO ANY GRADING WORK IN THE AREA TO BE PROTECTED. THEY SHALL BE MAINTAINED THROUGHOUT THE CONSTRUCTION PERIOD AND REMOVED IN CONJUNCTION WITH THE FINAL GRADING AND SITE STABILIZATION.
- 2. FILTER FABRIC SHALL MEET THE REQUIREMENTS OF MATERIAL SPECIFICATION 592 GEOTEXTILE TABLE 1 OR 2, CLASS I WITH EQUIVALENT OPENING SIZE OF AT LEAST 30 FOR NON-WOVEN OR 50 FOR WOVEN.
- 3. FENCE POSTS SHALL BE EITHER STANDARD STEEL POST OR WOOD POST WITH A MINIMUM CROSS-SECTIONAL AREA OF 3.0 SQ. IN.
- 4. DEPENDING UPON THE CONFIGURATION, ATTACH FABRIC AND WIRE MESH WITH HOG RINGS, STEEL POST WITH TIE WIRES, WOOD POST WITH NAILS.



TEMPORARY EROSION CONTROL MEASURE - SILT FENCE

REVISED: 01/01/2013 SHEET 2 OF 2

790.03

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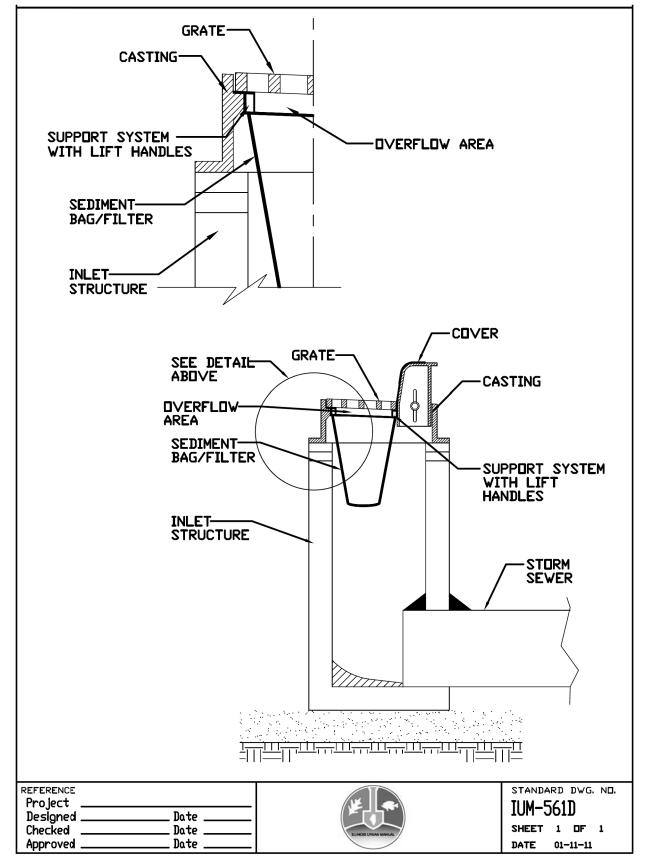
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STATE OF ILLINOIS
DEPARTMENT OF TRANSPORTATION

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SCALE: N.T.S.	SHEET 1	OF	3	SHEETS	STA.	TO STA.

FLOATING SILT CURTAIN - TYPICAL LAYOUT MOORING CABLE - ATTACHED TO LOADLINE BETWEEN PANELS CROWN BODY LOAD LINE ANCHOR LINE ISOLATED WORK AREA FLOATING SILT BARRIER SKIRT LENGTH TO BE APPROX. TEN PERCENT LONGER THAN WATER DEPTH -ANCHOR CHAIN BALLAST CHAIN TYPICAL COMPONENTS / ANCHORAGE SYSTEM HIGH WATER LEVEL-NORMAL WATER LEVEL-- ANCHOR FLOATING SILT CURTAIN, AS REQUIRED WORK AREA SECURE SILT CURTAIN — BEYOND HIGH WATER LINE LESS THAN 1/3 DF WATERCOURSE WIDTH TYPICALPLAN VIEW Maximum flow for waterbody shall be less than 5fps. Isolated work area shall not exceed more than 1/3 stream width. Silt curtain shall be placed parallel to stream flow. REFERENCE STANDARD DWG. No. Project IUM-617A Designed Date SHEET 1 OF 1 Checked Date Date Approved DATE 1-06-2012

INLET FILTER - PAVED AREAS DROP-IN PROTECTION





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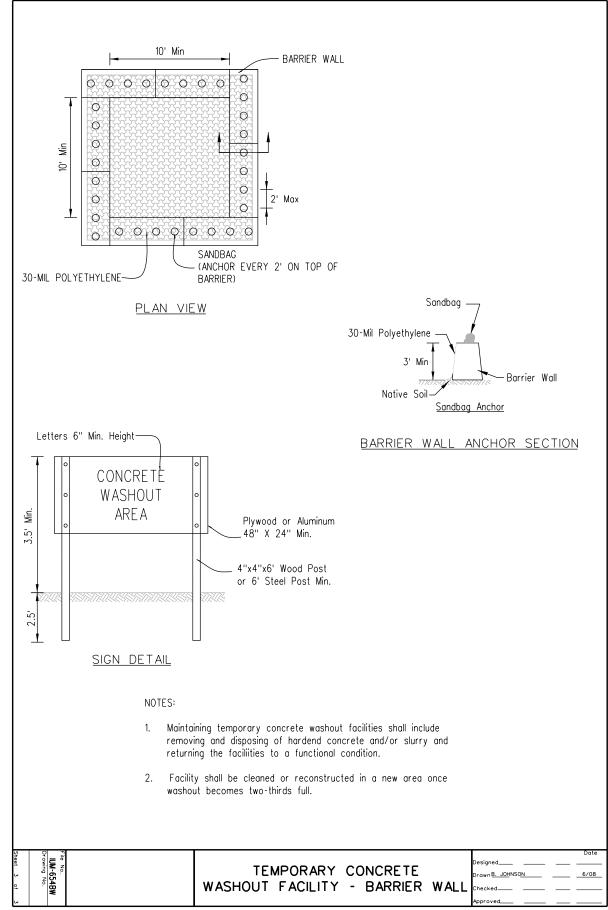
STATE OF ILLINOIS
DEPARTMENT OF TRANSPORTATION

SCALE: N.T.S.

WASHINGTON STREET BRIDGE
EROSION CONTROL DETAILS

SHEET 2 OF 3 SHEETS STA. TO STA.

FA.U. SECTION COUNTY TOTAL SHEETS NO.
2552 16-00167-00-BR DUPAGE 261 70
CONTRACT NO. 61G82



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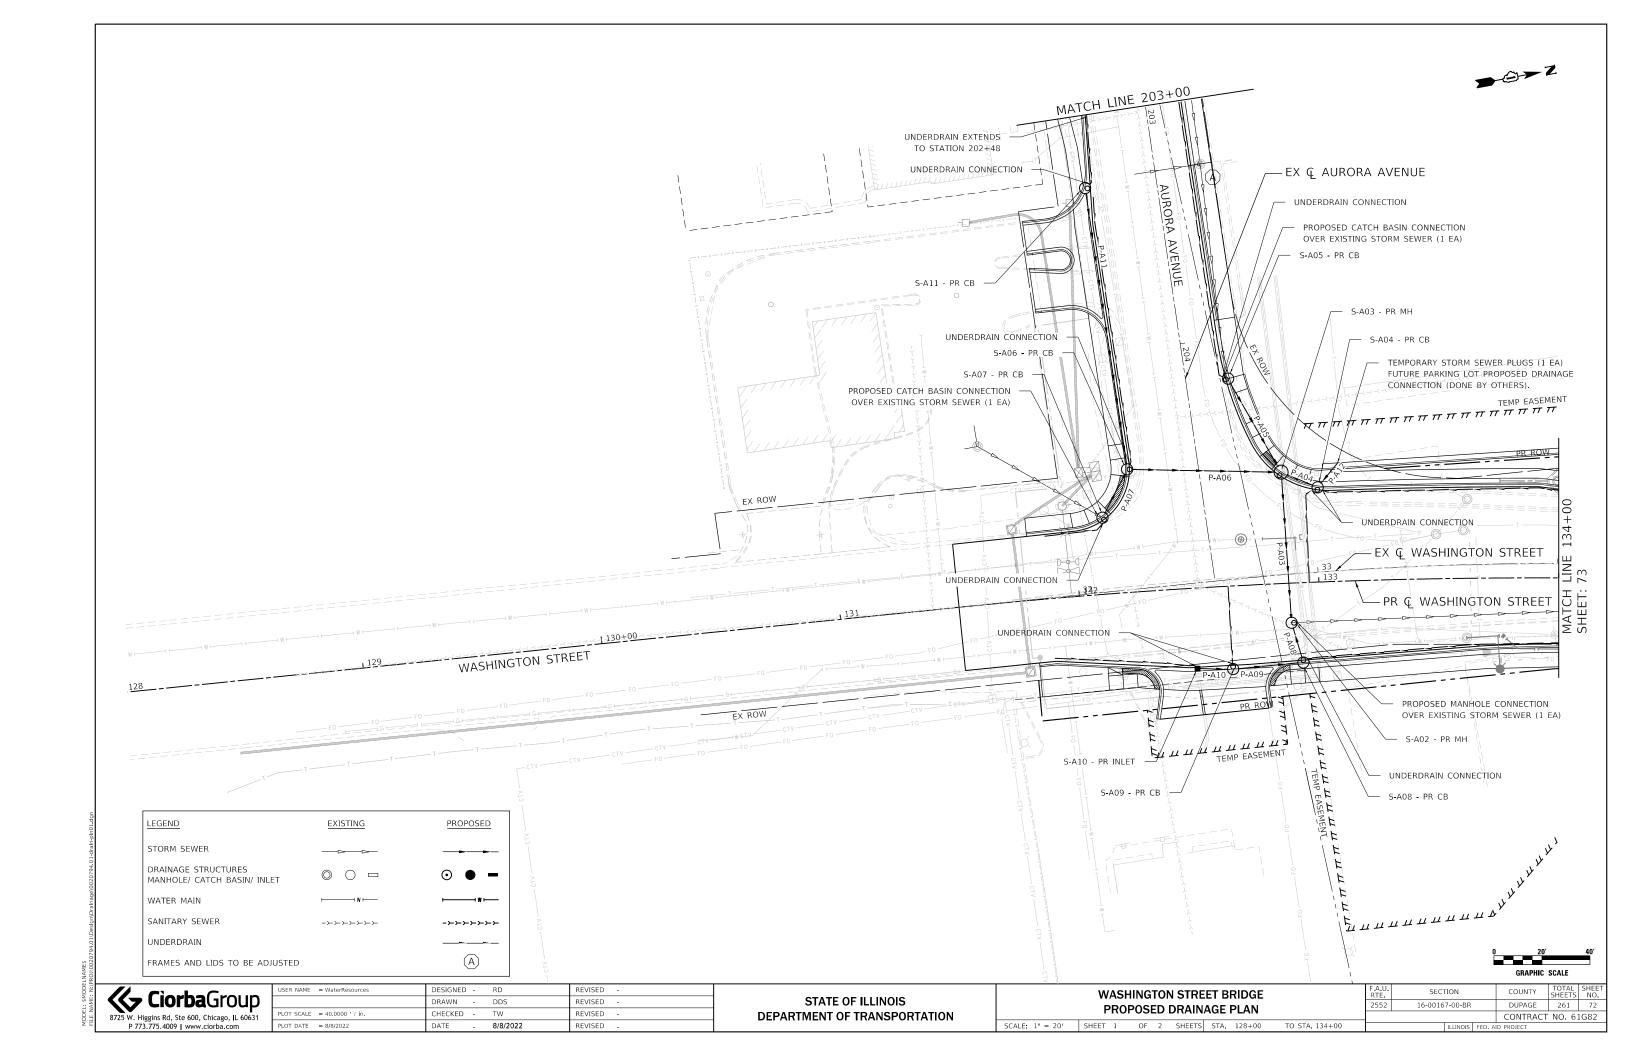
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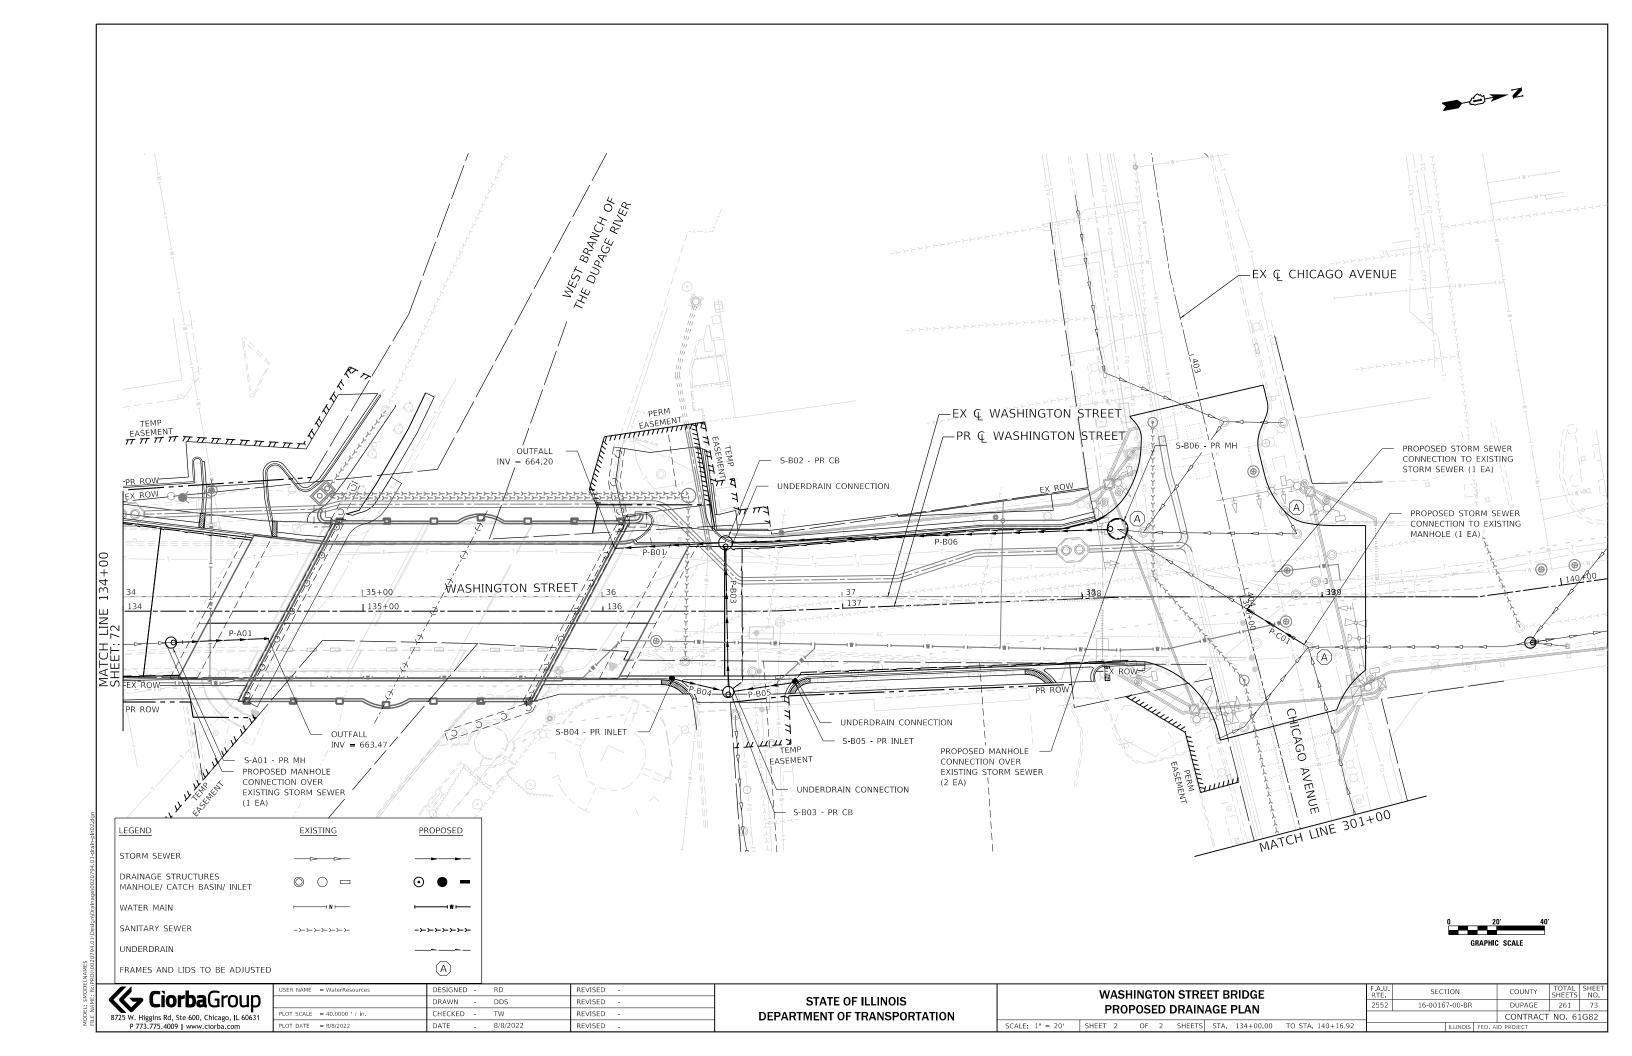
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STATE OF ILLINOIS DEPARTMENT OF TRANSPORTATION

SCALE: N.T.S.

SECTION WASHINGTON STREET BRIDGE COUNTY 16-00167-00-BR DUPAGE 261 71 **EROSION CONTROL DETAILS** CONTRACT NO. 61G82 SHEET 3 OF 3 SHEETS STA. TO STA.





							DR	AINAGI	E REMOVAI	L SCHEDULE	Ξ				
	[DRAINAGE RE	MOVALS				PIP	PΕ		60500040	60500060	55100500	55100900	55101200	20800150
REFERENCE		FROM			ТО		LENGTH	DIA	STRUCTURE	REMOVING	REMOVING	STORM SEWER	STORM SEWER	STORM SEWER	TRENCH BACKFILL
LINE	STATION	OFF:	SET	STATION	OFF	SET	(FT)	(IN)		MANHOLES (EACH)	INLETS (EACH)	REMOVAL, 12" (FT)	REMOVAL, 18" (FT)	REMOVAL, 24" (FT)	(CU YD)
WASHINGTON STREET	132+14	30.7	LT	132+27	38.4	LT	16	12	Y		1	16			2.0
WASHINGTON STREET	132+73	43.1	LT	132+27	38.4	LT	47	12	Y	1		47			6.0
WASHINGTON STREET	132+97	32.6	LT	132+73	43.1	LT	27	12	Υ		1	27			3.0
WASHINGTON STREET	132+70	83.2	LT	132+73	43.1	LT	41	12	Y		1	41			5.0
WASHINGTON STREET	132+27	38.4	LT	132+39	17.5	RT	57	18	Y	1			57		12.0
WASHINGTON STREET	132+39	27.5	RT	132+39	17.5	RT	10	12	Y		1	10			2.0
WASHINGTON STREET	132+39	17.5	RT	132+83	20	RT	47	18	Y	1			47		14.0
WASHINGTON STREET	136+28	22.2	RT	136+21	21	LT	44	12	Y		1	44			18.0
WASHINGTON STREET	136+21	21	LT	136+11	28.5	LT	13	24	Y	1				13	9.0
WASHINGTON STREET	138+15	28.3	LT	136+21	21	LT	195	24	Υ	1				195	114.0
WASHINGTON STREET	138+94	21.0	RT	138+69	5.6	RT	29	18	N				29		0.0
				TOTAL						5	5	185	133	208	185.0

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SCALE:

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DB	ΔΙΝΙ	\GE	ВE	ΜΩναι	SCHED	HIE		2552	16-0016	7-00-BR		DUPAGE	261	74
וטוע	MII 1/	·UL	· \ L	IVIOVAL	JOHED	OLL						CONTRACT	NO. 6	IG82
SHEET	1	OF	1	SHEETS	STA.		TO STA.			ILLINOIS	FED. AI	D PROJECT		

				PIF	PE SCHEDU	ILE				
						550A0340	550A0410	Z0056668	Z0056670	20800150
						STORM SEWERS	STORM SEWERS	STORM SEWERS, WATER MAIN QUALITY PIPE	STORM SEWERS, WATER MAIN QUALITY PIPE	TRENCH
PIPE NO.	FROM	ТО	PIPE	PIPE	PIPE	CL A TY 2	CL A TY 2	TY 2	TY 2	BACKFILL
	STRUCTURE	STRUCTURE	SLOPE	SIZE	LENGTH	12"	24"	12"	18"	
	NO.	NO.	%	IN	FT	FT	FT	FT	FT	CU YD
P-A01	S-A01	OUTFALL	1.72	18	39				39	51.0
P-A03	S-A03	S-A02	0.30	18	59				59	26.0
P-A04	S-A04	S-A03	0.45	12	12	12.0				2.0
P-A05	S-A05	S-A04	0.45	12	41	41.0				6.0
P-A06	S-A06	S-A03	0.45	12	59			59		1.0
P-A07	S-A07	S-A06	0.45	12	19	19.0				2.0
P-A08	S-A08	S-A02	0.45	12	15			15		2.0
P-A09	S-A09	S-A08	0.45	12	30	30.0				6.0
P-A10	S-A10	S-A09	0.45	12	13	13.0				3.0
P-A11	S-A11	S-A06	0.50	12	119	119.0				3.0
P-A12	-	S-A04	0.45	12	13	13.0				2.0
P-B01	S-B02	OUTFALL	1.50	24	44		44			59.0
P-B03	S-B03	S-B02	0.62	18	58				58	21.0
P - B04	S-B04	S-B03	0.60	12	22			22		6.0
P-B05	S-B05	S-B03	0.50	12	26	26.0				7.0
P-B06	S-B06	S-B02	1.65	24	157		157			86.0
P-C01	EX MH	EX SEWER	0.88	18	28				28	6.0
	•	TOTAL	•	•		273.0	201.0	96.0	184.0	289.0

						_				60108204	Z0076870
				UNDE	RDRAIN SCHEDUL	_E					
FROM ST	TRUCTURE	STRUCTURE OFFSET	INVERT	TO STI	RUCTURE	STRUCTURE OFFSET	INVERT	STRUCTURE OUTLET	PROPOSED ALIGNMENT	PIPE UNDERDRAINS, TYPE 2,	UNDERDRAIN CONNECTION TO STRUCTURE
NO.	STATION			NO.	STATION					(L.F.)	EACH
	131+88	RT	668.90	S-A10	132+47	RT	668.15	667.71	WASHINGTON STREET	59	1
	131+88	LT	668.90	S-A07	132+12	LT	669.16	667.98	WASHINGTON STREET	26	1
	132+62	CL	668.71	S-A09	132+62	RT	668.12	667.65	WASHINGTON STREET	33	1
	132+96	CL	668.79	S-A04	133+01	LT	668.12	667.68	WASHINGTON STREET	40	1
	134+23	RT	669.32	S-A08	132+92	RT	668.23	667.53	WASHINGTON STREET	128	1
	134+50	LT	669.90	S-A04	133+01	LT	668.12	667.68	WASHINGTON STREET	153	1
	136+58	CL	670.09	S-B03	136+52	RT	669.72	667.75	WASHINGTON STREET	35	1
	136+58	CL	670.09	S-B02	136+51	LT	669.13	665.07	WASHINGTON STREET	35	1
	138+11	LT	669.78	S-B02	136+51	LT	669.13	665.07	WASHINGTON STREET	159	1
	138+18	RT	669.76	S-B05	136+80	RT	669.23	667.52	WASHINGTON STREET	140	1
	202+48	RT	672.52	S-A11	203+30	RT	670.39	668.50	AURORA AVENUE	83	1
	203+00	LT	671.32	S-A05	204+18	LT	668.50	668.15	AURORA AVENUE	117	1
	203+33	RT	670.28	S-A06	204+49	RT	668.51	667.90	AURORA AVENUE	113	1
		-			CONTINGENCY					200	4
					TOTAL					1321	17

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DIDE	ANI) I I I	IDE	DDDA	N SCHE	DILLE	2552	16-00167-00-BR	DUPAGE	261	75
FIFE	. AINI	וט כ	וטו	האטהב	IN SCHE	DOLE			CONTRACT	F NO. 6	1G82
SHEET	1	OF	1	SHEETS	STA.	TO STA.		ILLINOIS FED.	AID PROJECT		

STRUCTURE SCHEDULE

		GTATION .				5.00	FRAME AND					ELEVATIONS				
TRUCTURE NO.	ALIGNMENT	STATION	OFFS	EI	STRUCTURE TYPE	PAY ITEM	GRATE	DIM				INV	ERTS			
								RIM	NORTH	SOUTH	EAST	WEST	NE	NW	SE	SW
S-A01	WASHINGTON STREET	134+20	13.1	RT	MANHOLES, TYPE A, 4'-DIAMETER, TYPE 1 FRAME, CLOSED LID	60218400		672.42	664.14	664.14 (EX)						
S-A02	WASHINGTON STREET	132+88	16.5	RT	MANHOLES, TYPE A, 4'-DIAMETER, TYPE 1 FRAME, CLOSED LID	60218400		671.41	667.45		667.45	667.45				
S-A03	WASHINGTON STREET	132+86	46.4	LT	MANHOLES, TYPE A, 5'-DIAMETER, TYPE 1 FRAME, OPEN LID	60221000		670.97		667.63	667.63		668.00			667.63
S-A04	WASHINGTON STREET	133+01	39.4	LT	CATCH BASINS, TYPE A, 4'-DIAMETER, TYPE 1 FRAME, OPEN LID	60200105		671.02						667.68		667.68
S-A05	AURORA AVENUE	204+17	17.6	LT	CATCH BASINS, TYPE A, 4'-DIAMETER, TYPE 1 FRAME, OPEN LID	60200105		671.40					668.18			
S-A06	AURORA AVENUE	204+48.50	29.3	RT	CATCH BASINS, TYPE A, 4'-DIAMETER, TYPE 1 FRAME, OPEN LID	60200105		671.41	667.90			667.90			667.90	
S-A07	WASHINGTON STREET	132+12	31.9	LT	CATCH BASINS, TYPE A, 4'-DIAMETER, TYPE 1 FRAME, OPEN LID	60200105		671.40						667.98		
S-A08	WASHINGTON STREET	132+92	33.2	RT	CATCH BASINS, TYPE A, 4'-DIAMETER, TYPE 1 FRAME, OPEN LID	60200105		671.13		667.52						667.52
S-A09	WASHINGTON STREET	132+62	33.6	RT	CATCH BASINS, TYPE A, 4'-DIAMETER, TYPE 9 FRAME AND GRATE	60200905	9	671.02	667.65	667.65						
S-A10	WASHINGTON STREET	132+47	33.6	RT	INLETS, TYPE A, TYPE 9 FRAME AND GRATE	60236600	9	671.05	667.71	667.71						
S-A11	AURORA AVENUE	203+30	30.1	RT	CATCH BASINS, TYPE A, 4'-DIAMETER, TYPE 1 FRAME, OPEN LID	60200105		673.29			668.50					
S-B02	WASHINGTON STREET	136+51	28.5	RT	CATCH BASINS, TYPE A, 5'-DIAMETER, TYPE 1 FRAME, OPEN LID	60203805		672.54	665.07	664.85	667.39					
S-B03	WASHINGTON STREET	136+52	33.7	LT	CATCH BASINS, TYPE A, 5'-DIAMETER, TYPE 1 FRAME, OPEN LID	60203805		672.62	668.35	668.35		667.75				
S-B04	WASHINGTON STREET	136+29	28.1	LT	INLETS, TYPE A, TYPE 11 FRAME AND GRATE	60236800	11	672.68	668.48							
S-B05	WASHINGTON STREET	136+79	29.3	LT	INLETS, TYPE A, TYPE 11 FRAME AND GRATE	60236800	11	673.02		668.48						
S-B06	WASHINGTON STREET	138+16	28.3	LT	MANHOLES, TYPE A, 8'-DIAMETER, TYPE 1 FRAME, CLOSED LID	60224459		672.73	668.16	667.76			667.85			

- NOTES:

 1. RIM ELEVATIONS ARE THE EOP OF THE PROPOSED PAVEMENT.

 2. STATION AND OFFSET ARE MEASURED FROM THE PROPOSED CENTERLINE TO THE CENTER OF THE STRUCTURE.

	X0322	2916		
PROPOSE	D STORM SEWER CONNEC	TION TO E	XISTING ST	TORM SEWER
STATION	ALIGNMENT	OFF	SET	EACH
138+68	WASHINGTON STREET	5.2	RT	1
	TOTAL			1

	X0322	2917		
PROPO	SED STORM SEWER CONN	ECTION TO	EXISTING	MANHOLE
STATION	ALIGNMENT	OFF	SET	EACH
138+94	WASHINGTON STREET	21.1	RT	1
	TOTAL			1

	X0322	2918		
PROPOSED MAN	NHOLE/CATCH BASIN CON	NECTION O	VER EXIST	NG STORM SEWER
STATION	ALIGNMENT	OFF	SET	EACH
204+18	AURORA AVENUE	17.2	LT	1
132+12	WASHINGTON STREET	31.2	LT	1
132+89	WASHINGTON STREET	16.5	RT	1
138+15	WASHINGTON STREET	28.1	LT	2
	TOTAL			5

	60300	305		
	FRAMES AND LIDS	TO BE ADJ	USTED	
STATION	ALIGNMENT	OFF	SET	EACH
203+27	AURORA AVENUE	22.1	LT	1
131+98	WASHINGTON STREET	29.7	LT	1
132+18	WASHINGTON STREET	19.6	RT	1
132+50	WASHINGTON STREET	1.2	LT	1
132+95	WASHINGTON STREET	19.1	RT	1
133+61	WASHINGTON STREET	24.8	RT	1
136+34	WASHINGTON STREET	20.9	RT	1
136+62	WASHINGTON STREET	25.3	RT	1
136+71	WASHINGTON STREET	33.5	RT	1
136+74	WASHINGTON STREET	4.9	RT	1
138+25	WASHINGTON STREET	26.8	LT	1
138+94	WASHINGTON STREET	21	RT	1
138+97	WASHINGTON STREET	6.3	LT	1
139+85	WASHINGTON STREET	35.6	LT	1
139+94	WASHINGTON STREET	21.1	RT	1
	TOTAL			15


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PLOT DATE = 8/8/2022	DATE -	8/8/2022	REVISED -

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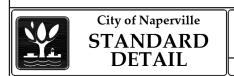
WASHINGTON STREET BRIDGE					F.A.U. RTE	SECTION		COUNTY	TOTAL SHEETS	SHEET NO.		
STRUCTURE SCHEDULE					2552	16-00167-00-BR		DUPAGE	261	76		
SIRUCIURE SCHEDULE								CONTRACT	NO. 63	IG82		
SHEET	1	OF	1	SHEETS	STA.	TO STA.		ILLINOIS F	FED. Al	D PROJECT		

WHEN MANHOLE DEPTH IS 12 FT OR LESS T = 8 INCHES WHEN MANHOLE DEPTH IS OVER 12 FT. T = 10 INCHES



NOTE:

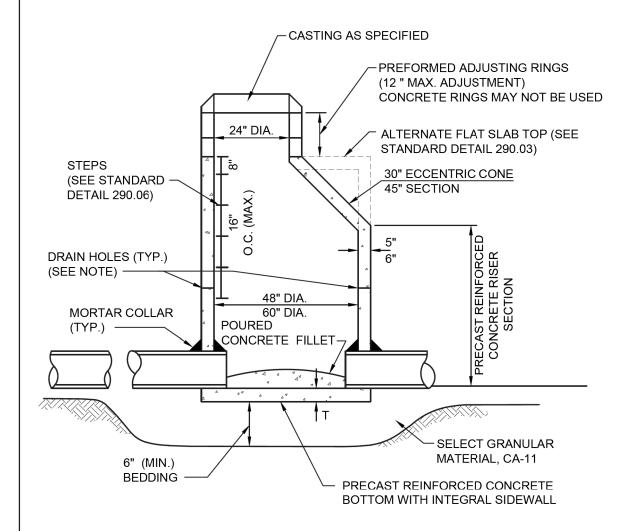A MINIMUM OF 4 PRECAST OR DRILLED 1" DIAMETER HOLES SHALL BE PROVIDED WITHIN 1' OF THE LOWEST PIPE INVERT. THE HOLES SHALL BE DISTRIBUTED EQUIDISTANT AROUND THE PERIMETER OF THE STRUCTURE. A 1' BY 1' SQUARE OF UNDERDRAIN FILTER CLOTH MATERIAL SHALL BE FIXED OVER EACH DRAIN HOLE ON THE OUTSIDE OF THE STRUCTURE WITH MASTIC MATERIAL TO PREVENT SLIPPAGE DURING BACKFILLING.




STORM MANHOLE-TYPE A

STORM 1

SHEET 1 OF 1

290.01

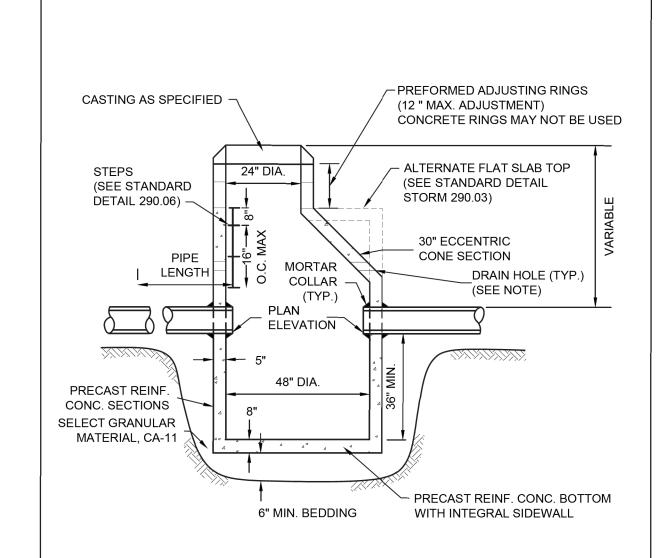

NOTE:

A MINIMUM OF 4 PRECAST OR DRILLED 1" DIAMETER HOLES SHALL BE PROVIDED WITHIN 1' OF THE LOWEST PIPE INVERT. THE HOLES SHALL BE DISTRIBUTED EQUIDISTANT AROUND THE PERIMETER OF THE STRUCTURE. A 1' BY 1' SQUARE OF UNDERDRAIN FILTER CLOTH MATERIAL SHALL BE FIXED OVER EACH DRAIN HOLE ON THE OUTSIDE OF THE STRUCTURE WITH MASTIC MATERIAL TO PREVENT SLIPPAGE DURING BACKFILLING.



CATCH BASIN - TYPE A

REVISED: 08/01/2018 SHEET 1 OF 1

STORM 2 290.02


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PLOT DATE = 8/8/2022	DATE -	8/8/2022	REVISED -

REVISED: 08/01/2018

STATE OF ILLINOIS **DEPARTMENT OF TRANSPORTATION**

WASHINGTON STREET BRIDGE					DGE	F.A.U. RTE			TOTAL SHEETS	SHEET NO.			
DRAINAGE DETAILS				2552	16-00167-00-BR			DUPAGE	261	77			
	DRAINAGE DETAILS									CONTRACT	NO. 63	IG82	
EET	1	OF	5	SHEETS	STA.	TO STA.			ILLINOIS	FED. AI	D PROJECT		

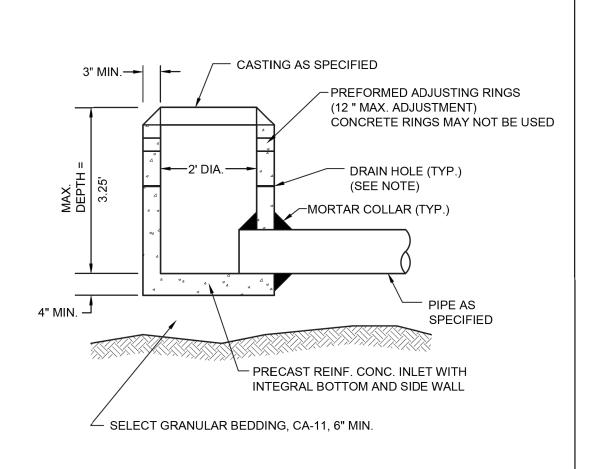

NOTE:


IN PAVED AREAS A MINIMUM OF 4 PRECAST OR DRILLED 1" DIAMETER HOLES SHALL BE PROVIDED WITHIN 1' OF THE LOWEST PIPE INVERT. THE HOLES SHALL BE DISTRIBUTED EQUIDISTANT AROUND THE PERIMETER OF THE STRUCTURE. A 1' BY 1' SQUARE OF UNDERDRAIN FILTER CLOTH MATERIAL SHALL BE FIXED OVER EACH DRAIN HOLE ON THE OUTSIDE OF THE STRUCTURE WITH MASTIC MATERIAL TO PREVENT SLIPPAGE DURING BACKFILLING.



INLET - TYPE A

SHEET 1 OF 1

STORM 5

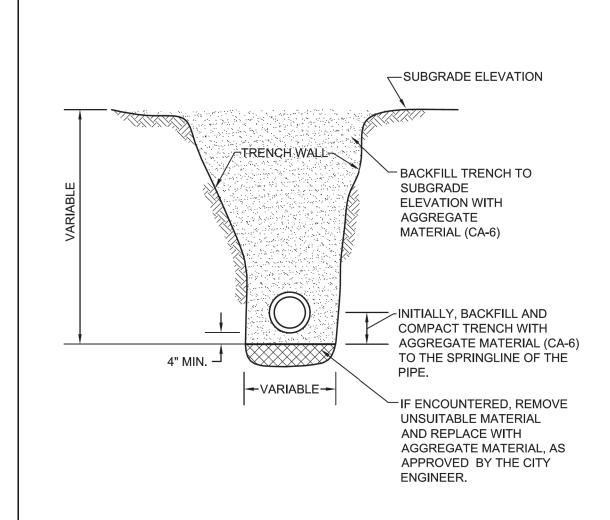

NOTES:

- 1. TRENCH BACKFILL MATERIAL SHALL BE COMPACTED IN ACCORDANCE WITH SECTION 550.07 OF THE IDOT STANDARD SPECIFICATIONS FOR ROAD AND BRIDGE CONSTRUCTION.
- 2. THIS DETAIL SHALL BE USED WHEREVER THE TRENCH IS MADE IN THE PROPOSED ROADWAY SUBGRADE, AND WHEREVER THE INNER EDGE OF THE TRENCH IS CLOSER THAN 2' TO THE EDGE OF THE PROPOSED PAVEMENT, CURB AND GUTTER, AND SIDEWALK.



SCALE: N.T.S.

STORM SEWER TRENCH **SECTION IN PAVED AREAS**

REVISED: 01/01/2013 SHEET 1 OF 1 STORM 20

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REVISED: 08/01/2018


STATE OF ILLINOIS **DEPARTMENT OF TRANSPORTATION**


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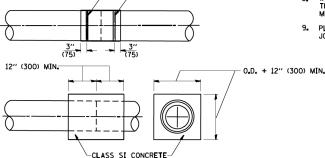
SECTION 16-00167-00-BR DUPAGE 261 78 CONTRACT NO. 61G82

DETAIL "A"

LATERAL CONNECTION TO EXISTING SEWER
OF 27" (675) OR SMALLER



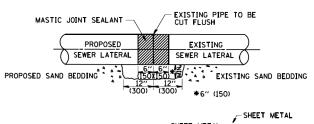

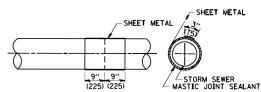


METAL BINDING

<u>DETAIL "B"</u> CLASS SI CONCRETE COLLAR

CONSTRUCTION SEQUENCE

- CUT THE EXISTING END OF THE PIPE SO AS TO PRESENT A FLUSH BUTT JOINT. BRUSH AND CLEAN ALL PIPES.
- APPLY THE MASTIC JOINT SEALANT TO THE FIRST 6" (150) OF EACH PIPE.
- 3. BUTT THE PIPES TOGETHER LEAVING A MINIMUM OF 12' × 6' (300 × 150) DEEP EXCAVATION UNDER AND AROUND EACH PIPE END.
- 4. CUT A PIECE OF SHEET METAL GAGE NO. 19 1.1 (0.0418) 18" (450) WIDE BY THE OUTSIDE CIRCUMFERANCE OF THE PIPE PLUS 3" (75) LONG.
- 5. WRAP THE SHEET METAL AROUND THE PIPES, 9" (225) ON EACH SIDE OF THE JOINT, STARTING AT THE TOP OF THE PIPE.
- 6. LAP THE SHEET METAL AT LEAST 3" (75) AT THE TOP OF THE PIPE AND PLACE THE MASTIC JOINT SEALANT BETWEEN THE LAP.
- 7. PLACE TWO METAL BANDS AROUND THE SHEET METAL AND TIGHTEN.
- WIPE OFF ANY EXCESS MASTIC JOINT SEALANT THAT OOZES OUT FROM BETWEEN THE SHEET METAL AND THE PIPES.
- 9. PLACE CLASS SI CONCRETE AROUND THE JOINT.

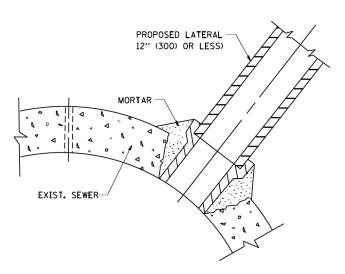

DETAIL "C"

PROPOSED LATERAL
CONNECTION TO EXISTING SEWER
OF 30" (750) OR LARGER

DETAIL OF STORM SEWER CONNECTION TO EXISTING SEWER

NOTES

MATERIAL

MATERIAL USED FOR THE TEE OR WYE SECTION SHALL BE COMPATIBLE WITH THE EXISTING STORM SEWER OR THE PROPOSED STORM SEWER.

CONSTRUCTION METHODS

- I. THIS WORK SHALL BE CONSTRUCTED IN CONFORMANCE WITH THE APPLICABLE PORTIONS OF SECTION 550 OF THE STANDARD SPECIFICATIONS.
- II. CONNECTION TO AN EXISTING STORM SEWER SHALL BE BY EITHER OF THE FOLLOWING METHODS:
 A) PROPOSED STORM SEWER CONNECTION TO EXISTING SEWER OF 27" (675) OR SMALLER SEE DETAIL "A" AND "B".
 - B) PROPOSED STORM SEWER CONNECTION TO EXISTING SEWER OF 30" (750) OR LARGER SEE DETAIL "C".

IF THE EXISTING SEWER PIPE IS CRACKED, BROKEN OR OTHERWISE DAMAGED BY THE CONTRACTOR IN MAKING THE CIRCULAR OPENING, THE CONTRACTOR SHALL REPLACE THAT SECTION OF PIPE WITH PIPE EQUAL AND SIMILAR IN ALL RESPECTS TO THE PIPE IN THE EXISTING SEWER, IN A CAREFUL WORKMANLIKE MANNER, WITHOUT EXTRA COMPENSATION.

GENERAL

CARE MUST BE TAKEN TO PREVENT DEBRIS FROM ENTERING THE SEWER. ALL DEBRIS WHICH ENTERS THE SEWER MUST BE REMOVED. THE SEWER MUST BE LEFT CLEAN AND UNOBSTRUCTED UPON COMPLETION OF THE CONTRACT.

CARE MUST BE TAKEN TO PREVENT ANY PART OF THE NEW PIPE CONNECTION FROM PROJECTING INTO THE EXISTING SEWER.

BASIS OF PAYMENT

TEE OR WYE CONNECTIONS SHALL BE PAID FOR AT THE CONTRACT UNIT PRICE EACH FOR STORM SEWER TEE OR WYE OF THE TYPE AND SIZE SPECIFIED IN THE PLANS, THIS PRICE SHALL INCLUDE ALL EXCAVATION OF THE TRENCH, REMOVAL OF THE EXISTING STORM SEWER, FURNISHING AND INSTALLING THE SPECIFIED TEE OR WYE SECTION, FURNISHING AND INSTALLING THE REQUIRED CONCRETE COLLAR, AND ALL OTHER MATERIAL NECESSARY TO COMPLETE THIS WORK AS SHOWN AND SPECIFIED.

REMOVAL AND REINSTALLATION OF EXISTING STORM SEWER ADJACENT TO THE PROPOSED TEE OR WYE SECTION, FOR THE PURPOSE OF FACILITATING THE INSTALLATION OF THE TEE OR WYE SECTION, WILL NOT BE PAID FOR SEPARATELY BUT SHALL BE INCLUDED IN THE UNIT PRICE BID FOR THE WORK.

TRENCH BACKFILL, EXCAVATION IN ROCK AND REMOVAL AND REPLACEMENT OF UNSUITABLE MATERIAL BELOW PLAN BEDDING GRADE WILL BE PAID FOR SEPARATELY.

SCALE: N.T.S.

CONCRETE COLLAR FOR CONNECTING A PROPOSED STORM SEWER TO AN EXISTING STORM SEWER WILL NOT BE PAID PAID FOR SEPARATELY BUT SHALL BE INCLUDED IN THE COST OF THE PROPOSED STORM SEWER.

ALL DIMENSIONS ARE IN INCHES (MILLIMETERS) UNLESS




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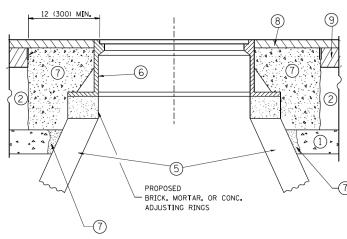
STATE OF ILLINOIS
DEPARTMENT OF TRANSPORTATION

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F.A.U. RTE	SECTION	COUNTY	TOTAL SHEETS	SHE
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NOTES:

EXISTING BROKEN FRAMES AND LIDS SHALL BE REMOVED AND DISPOSED OF BY THE CONTRACTOR AND SHALL BE REPLACED AS DIRECTED BY THE ENGINEER. REPLACEMENT FRAMES AND LIDS WILL BE PAID FOR IN ACCORDANCE WITH ARTICLE 109.04 OF THE STANDARD SPECIFICATIONS UNLESS A SEPARATE PAY ITEM HAS BEEN PROVIDED.

IF THE EXISTING LIDS ARE OPEN, THE FRAME WILL BE ADJUSTED TO THE ELEVATION OF THE MILLED PAVEMENT SURFACE PRIOR TO THE MILLING OPERATION. THE FRAME WILL NOT BE REMOVED AND COVERED BY THE METAL PLATE.

CITY OF CHICAGO CASTINGS ARE THE PROPERTY OF THE CITY AND THE CONTRACTOR SHALL NOTIFY THE CITY FOR REMOVAL AND DISPOSITION OF THE CASTINGS.

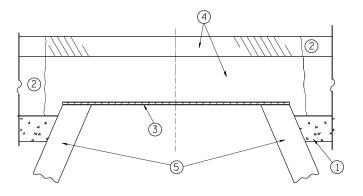THE METAL PLATE USED TO COVER THE STRUCTURE SHALL REMAIN THE PROPERTY OF THE CONTRACTOR.

WHEN STRUCTURES ARE TO BE ADJUSTED OR RECONSTRUCTED, THE LOWERING AND RAISING OF THE FRAMES AND LIDS WILL NOT BE PAID FOR SEPARATELY BUT WILL BE INCLUDED IN THE COST OF THE CORRESPONDING PAY ITEM.

SCALE: N.T.S.

CONSTRUCTION PROCEDURES

STAGE 1 (BEFORE PAVEMENT MILLING)

- A) REMOVE A MINIMUM OF 12 (300) OF THE PAVEMENT FROM AROUND THE STRUCTURE.
- B) REMOVE THE EXISTING FRAME AND LID FROM THE STRUCTURE.
- C) COVER THE STRUCTURE OPENING WITH A 36 (900) DIAMETER METAL PLATE.
- D) BACKFILL WITH CRUSHED STONE AND A MINIMUM 11/2 (40) THICK HMA SURFACE MIX APPROVED BY THE ENGINEER.

STAGE 2 (AFTER PAVEMENT MILLING)

- A) REMOVE THE HMA SURFACE MIX AND CRUSHED STONE.
- B) INSTALL THE FRAME AND LID; ADJUST THE FRAME TO ITS FINAL SURFACE ELEVATION.
- C) THE SURROUNDING SPACE SHALL BE FILLED WITH CLASS PP-1*
 CONCRETE TO THE ELEVATION OF THE SURFACE OF THE EXISTING
 BASE COURSE OR THE BINDER COURSE.
- * UNLESS OTHERWISE SPECIFIED IN THE PLANS.

THE PROCEDURE EXPLAINED ABOVE SHALL CONFORM TO THE APPLICABLE PORTIONS OF SECTIONS 353, 406, 602, AND 603 OF THE STANDARD SPECIFICATIONS EXCEPT THAT "THE CONTRACTOR SHALL ADJUST THE STRUCTURES TO THE FINISHED PAVEMENT ELEVATION NO MORE THAN 5 CALENDAR DAYS PRIOR TO PLACEMENT OF THE FINAL LIFT OF SURFACE UNLESS APPROVED BY THE ENGINEER."

LEGEND

- 1 SUB-BASE GRANULAR MATERIAL
- (6) FRAME AND LID (SEE NOTES)
- 2 EXISTING PAVEMENT
- 7 CLASS PP-1* CONCRETE
- 3 36 (900) DIAMETER METAL PLATE
- PROPOSED CRUSHED STONE AND HMA SURFACE MIX
- 8 PROPOSED HMA SURFACE COURSE
- (5) EXISTING STRUCTURE
- 9 PROPOSED HMA BINDER COURSE

LOCATION OF STRUCTURE

THE CONTRACTOR WILL BE REQUIRED TO KEEP A RECORD OF THE LOCATIONS OF THE BURIED STRUCTURES ACCORDING TO THE STATION AND DISTANCE LEFT OR RIGHT OF THE CENTERLINE OF PAVEMENT. UPON COMPLETION OF THE WORK, THE CONTRACTOR WILL DELIVER THE RECORD TO THE ENGINEER.

BASIS OF PAYMENT:

REMOVING FRAMES AND LIDS ON DRAINAGE AND UTILITY STRUCTURES IN THE PAVEMENT PRIOR TO MILLING, AND ADJUSTING TO FINAL GRADE PRIOR TO PLACING THE SURFACE COURSE, WILL BE PAID FOR AT THE CONTRACT UNIT PRICE EACH FOR "FRAMES AND LIDS TO BE ADJUSTED (SPECIAL)."

THIS WORK WILL NOT BE PAID FOR WHEN DRAINAGE AND UTILITY STRUCTURES ARE SPECIFIED FOR PAYMENT AS STRUCTURE RECONSTRUCTION.

NEW FRAMES AND LIDS, WHEN SPECIFIED, WILL BE PAID FOR SEPARATELY.

DETAILS FOR FRAMES AND LIDS ADJUSTMENT WITH MILLING

ALL DIMENSIONS ARE IN INCHES (MILLIMETERS) UNLESS OTHERWISE SHOWN



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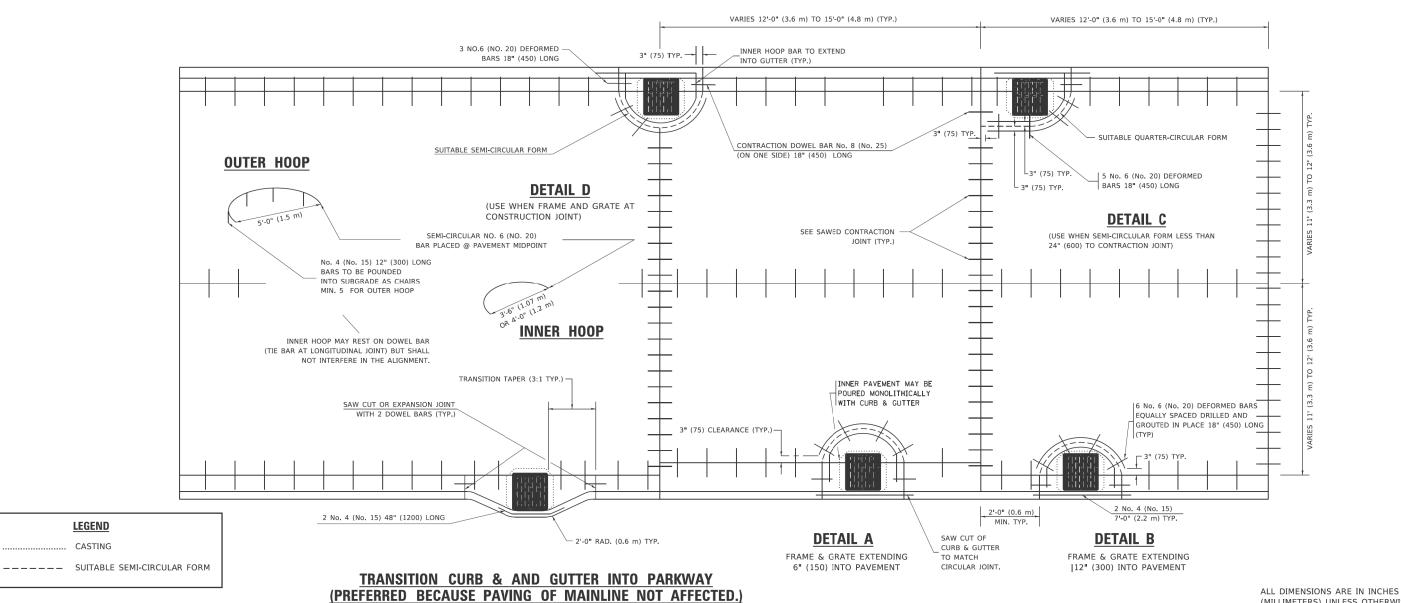
FRAME EXTENSION INTO PAVEMENT	INNER HOOP REINFORCEMENT DIAMETER	SEMI CIRCULAR FORM DIAMETER	OUTER HOOP REINFORCEMENT DIAMETER
UP TO 8" (200)	3'-6" (1.1 m)	4'-0" (1.2 m)	5'-0" (1.5 m)
> 8" (200) TO 14" (360)	4'-0" (1.2 m)	4'-6" (1.4 m)	5'-0" (1.5 m)

DESIGNER NOTE THIS DETAIL IS TO BE USED WHEN THE GUTTER FLAG IS I LESS THAN 24"

PCC PAVEMENT ROUNDOUTS AT CURB AND GUTTER

NOTES:

- HE ROUNDOUT AND ADDED REINFORCEMENT WILL NOT BE PAID SEPARATELY UT SHALL BE INCLUDED IN THE CONTRACT UNIT PRICE FOR THE PAVEMENT.
- TRANSVERSE JOINTS MAY BE MOVED TO ACCOMMODATE ROUNDOUT, EDGE OF CIRCULAR JOINT SHALL BE MINIMUM 12" (300) FROM TRANSVERSE JOINT. RELOCATED TRANSVERSE JOINT SHALL BE CONTINUOUS FROM EDGE OF PAVEMENT TO EDGE OF PAVEMENT.
- 3. SEMI-CIRCULAR FORM SHALL BE REMOVED PRIOR TO DRILL AND GROUT OF TIE BARS.
- 4. ALL REINFORCED BARS SHALL BE EPOXY COATED.
- 5. DRILL AND GROUT IS PREFERRED, HOWEVER TIE BARS CAN BE POURED IN PLACE IF CLEARANCE IS PROVIDED TO OUTER EDGE OF FRAME. MINIMUM 2" (50) CLEARANCE.
- WOOD SHIMS SHALL BE USED TO ADJUST ALL FRAMES. AFTER ADJUSTING MORTAR HAS CURED, THE WOOD SHIMS SHALL BE REMOVED AND THE VOIDS UNDER THE FRAMES FILLED WITH NON SHRINK GROUT.
- 7. HOOP REINFORCEMENT SHALL BE ONE PIECE CONSTRUCTION.
- 8. CIRCULAR FRAMES AND GRATES MAY BE SUBSTITUTED.
- CURB DOWELS MUST BE PLACED LEVEL & TRUE TO ALLOW CONTRACTION MOVEMENT.



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LEGEND


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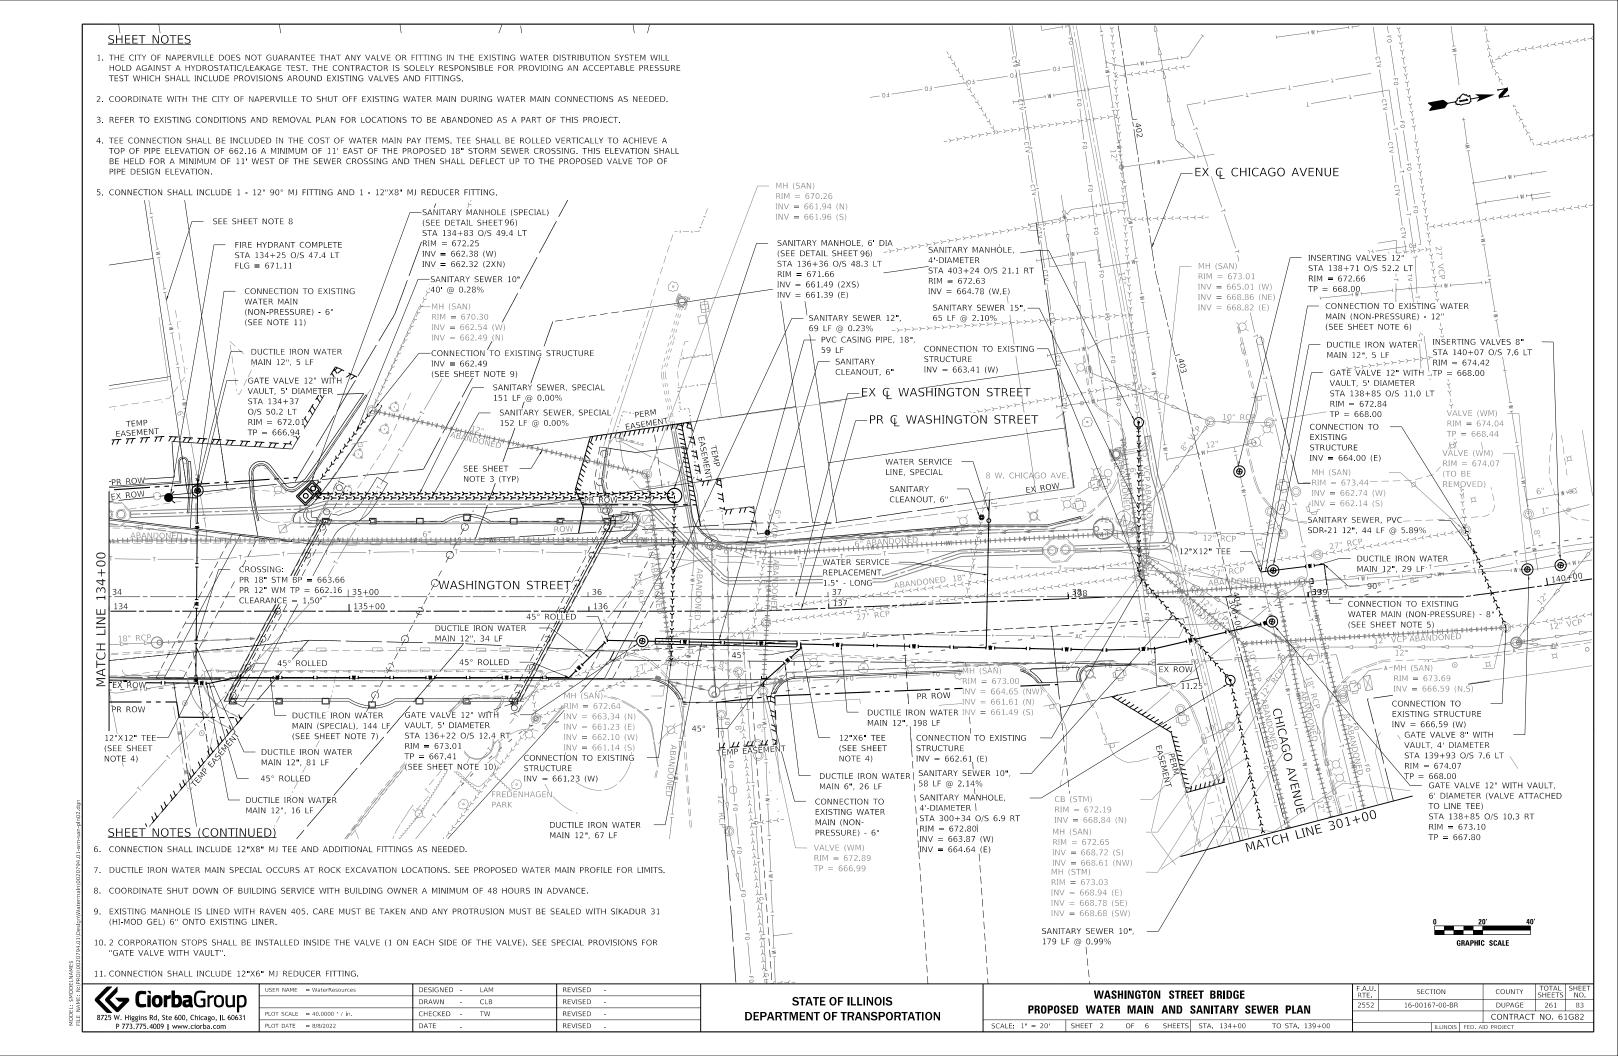
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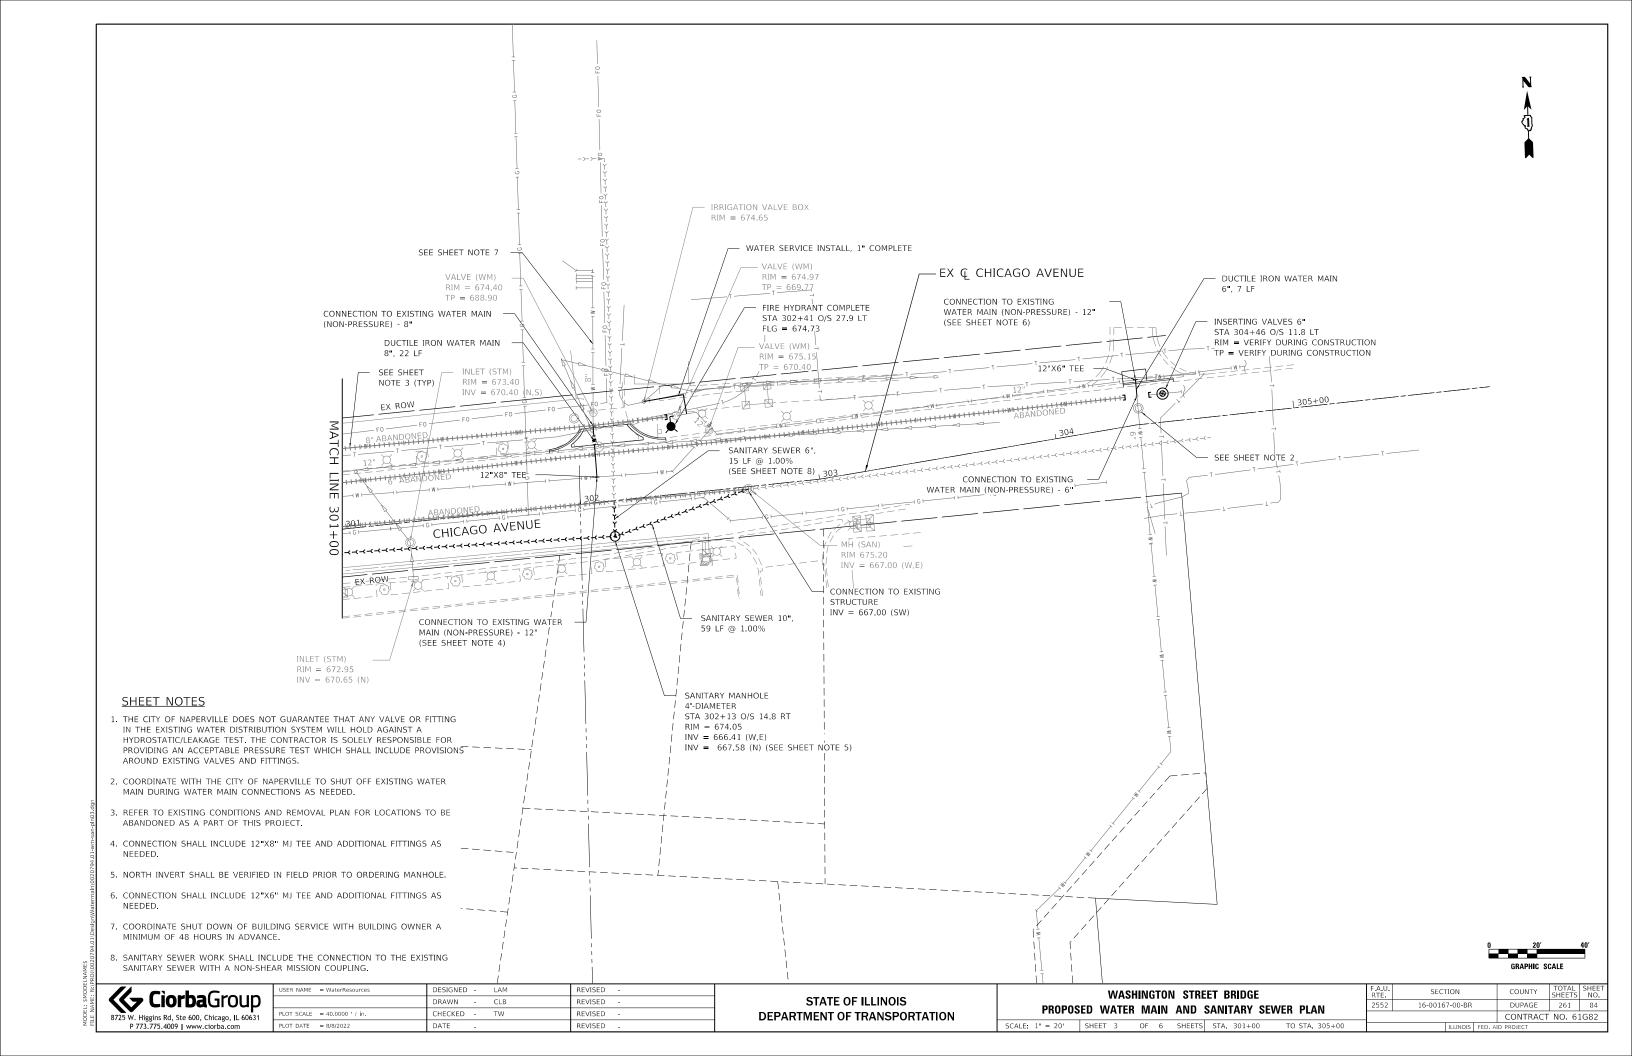
STATE OF ILLINOIS **DEPARTMENT OF TRANSPORTATION**


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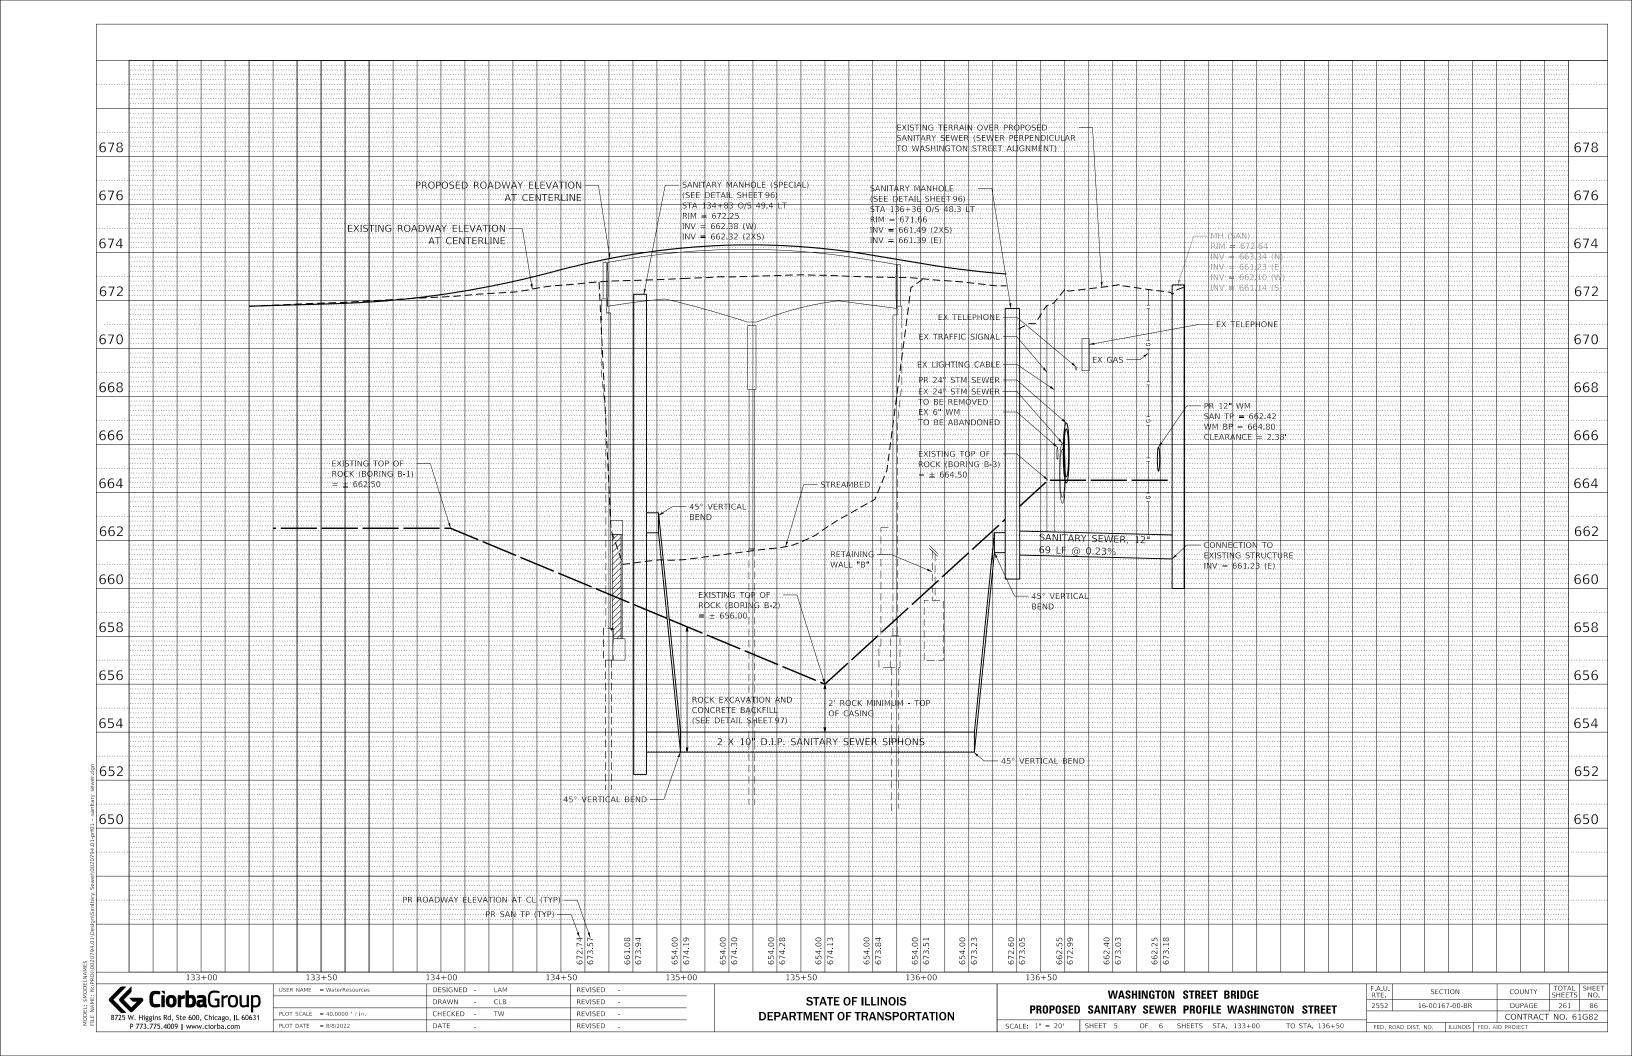
(MILLIMETERS) UNLESS OTHERWISE NOTED COUNTY WASHINGTON STREET BRIDGE 16-00167-00-BR DUPAGE 261 81 DRAINAGE DETAILS CONTRACT NO. 61G82 SHEET 5 OF 5 SHEETS STA. TO STA.










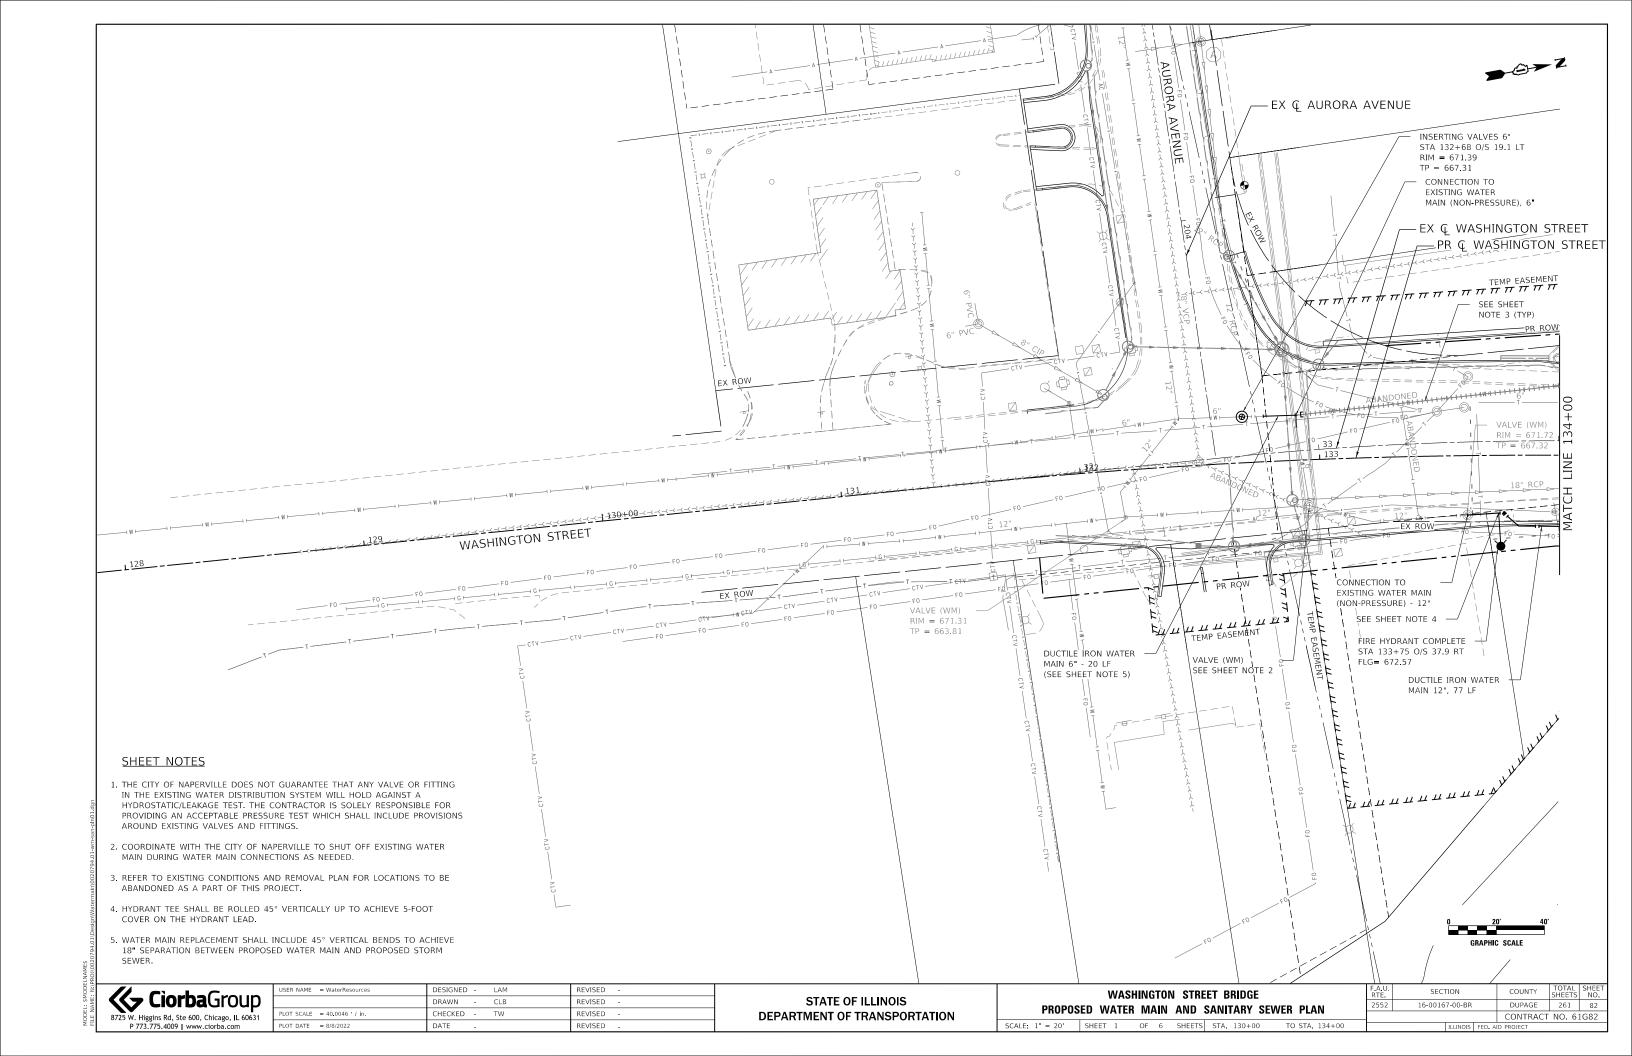

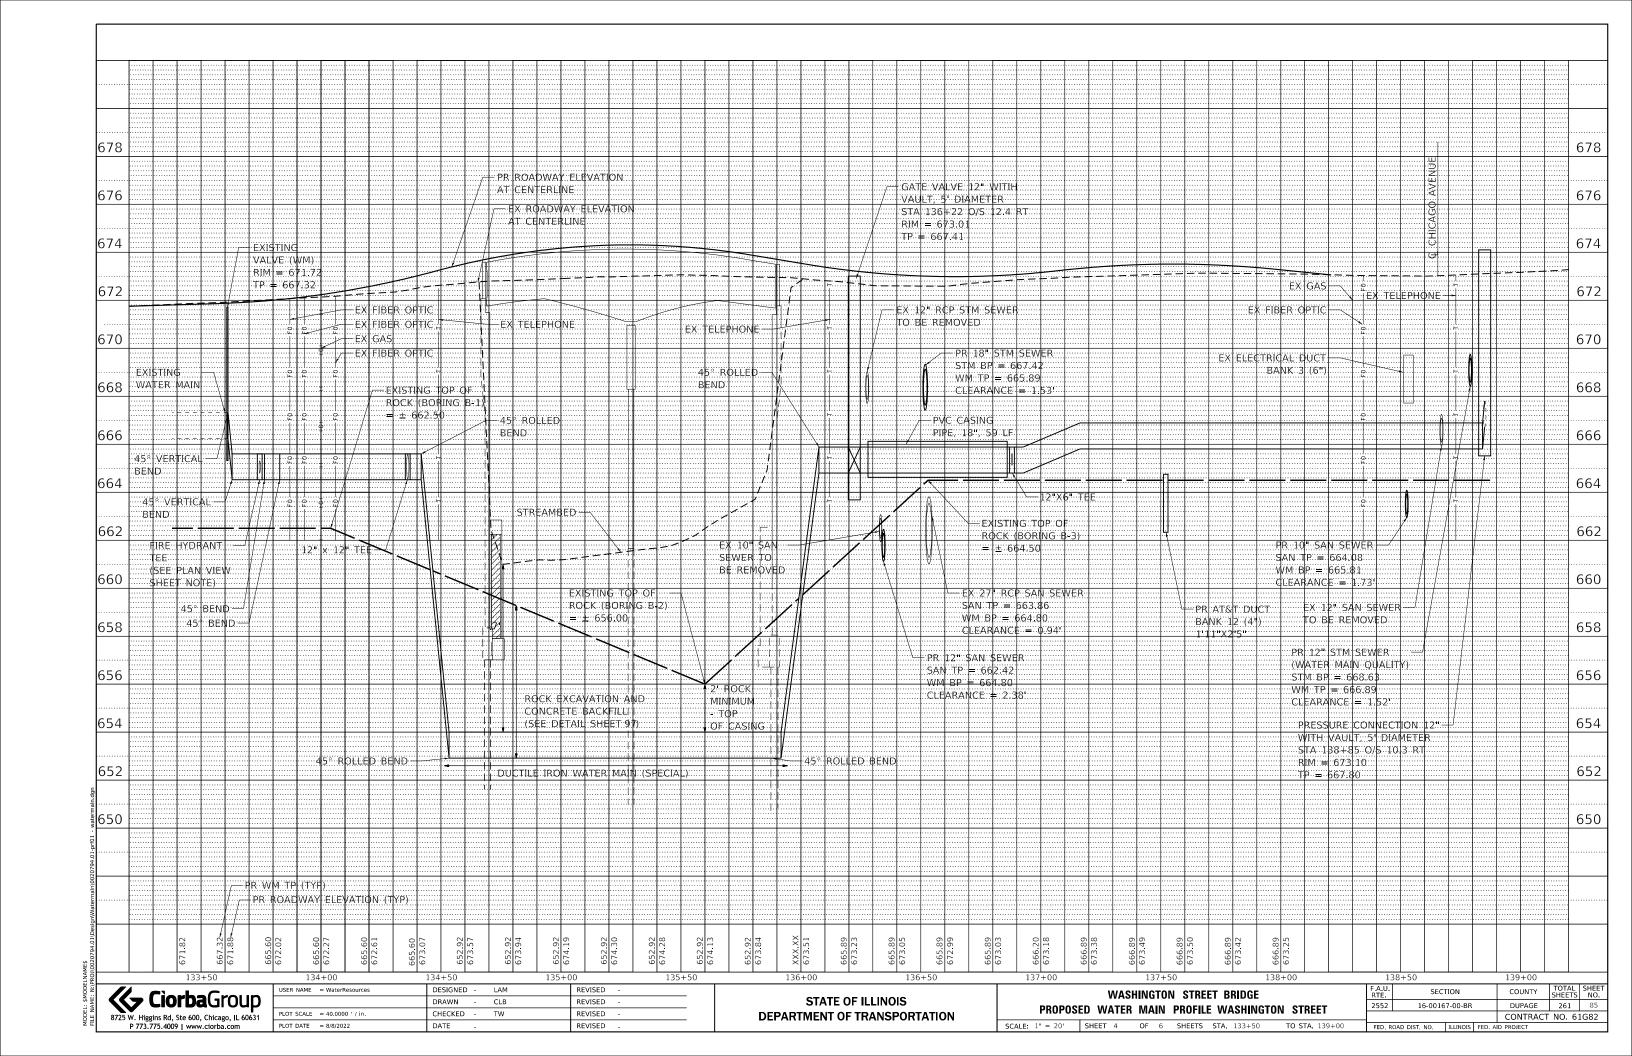

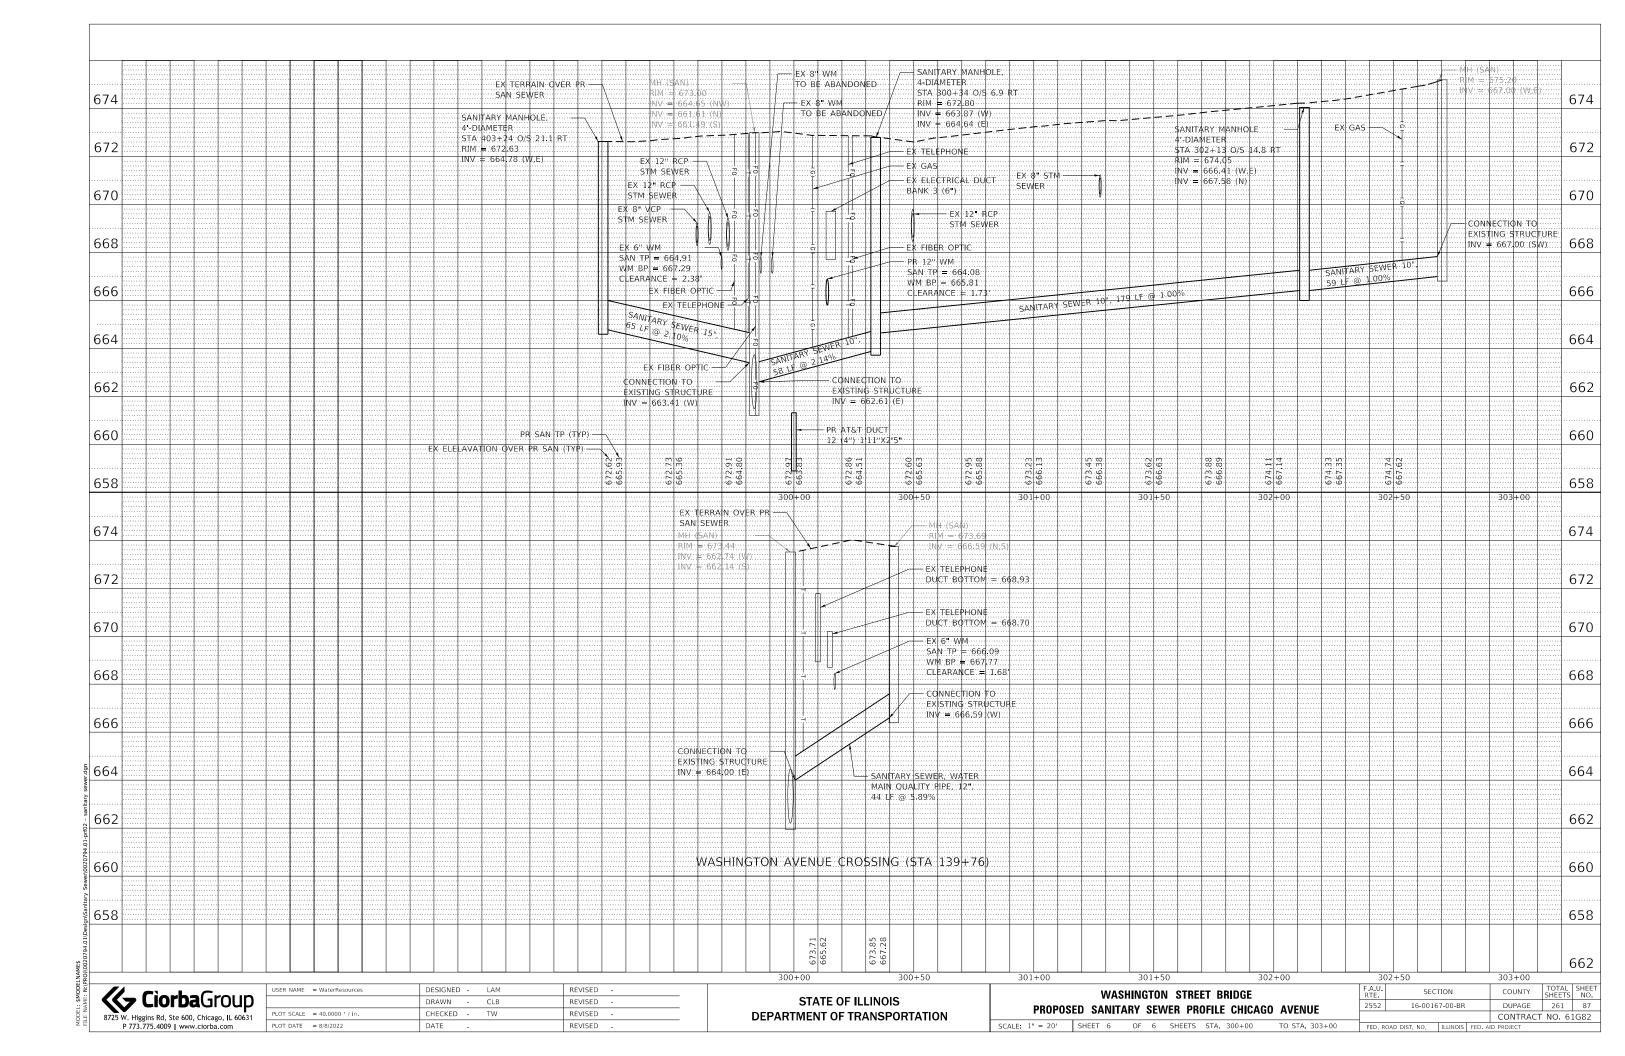

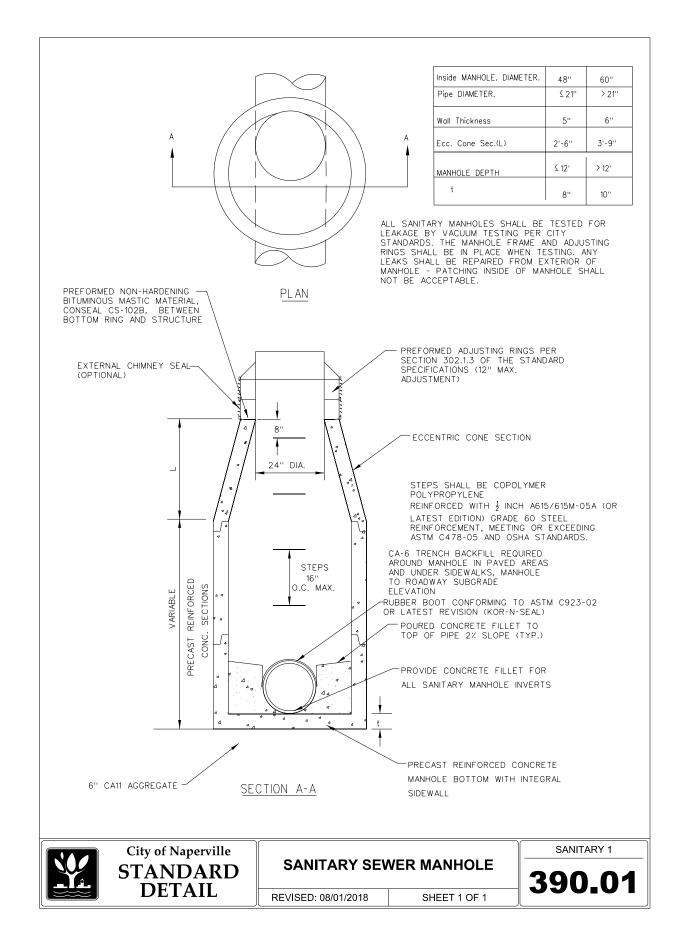

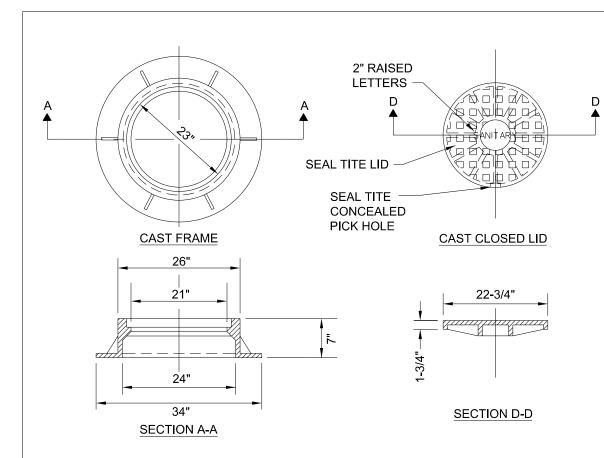

NOTES:

- 1) DUCTILE IRON SHALL BE GRADE 65-45-12 AND SHALL BE TESTED IN ACCORDANCE WITH FEDERAL SPECIFICATIONS.
- 2) ALL FRAMES AND COVERS SHALL HAVE MACHINED HORIZONTAL AND VERTICAL BEARING SURFACES, PICK HOLES SHALL NOT CREATE OPENINGS IN THE COVER.
- 3) THE MANHOLE COVERS SHALL HAVE 2" RAISED LETTERS AS SHOWN.
- 4) ALTERNATIVE TO DUCTILE IRON LID, GREY IRON CL 35 LID MAY BE USED.
- 5) CASTINGS ARE SHALL BE EAST JORDAN 1022-Z3; NEENAH R-1772.
- 6) WATERPROOF, BOLTDOWN FRAME AND COVER SHALL BE USED IN FLOOD PLAIN AREA, AND AS NOTED ON THE PLANS. NEENAH R-1916-F1, EAST JORDAN IRON WORKS 1022-Z1PT.
- 7. LIDS AND FRAMES TO MEET ASSHTO M306 PROOF LOADING SPECIFICATIONS



City of Naperville **STANDARD DETAIL**

SANITARY MANHOLE - FRAME & COVER

REVISED: 01/01/2013 SHEET 1 OF 1

390.06

SANITARY 6


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STATE OF ILLINOIS **DEPARTMENT OF TRANSPORTATION**

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SECTION COUNTY 16-00167-00-BR DUPAGE 261 88 390.01 AND 390.06 CONTRACT NO. 61G82






TRENCH SECTION FOR PVC PIPE

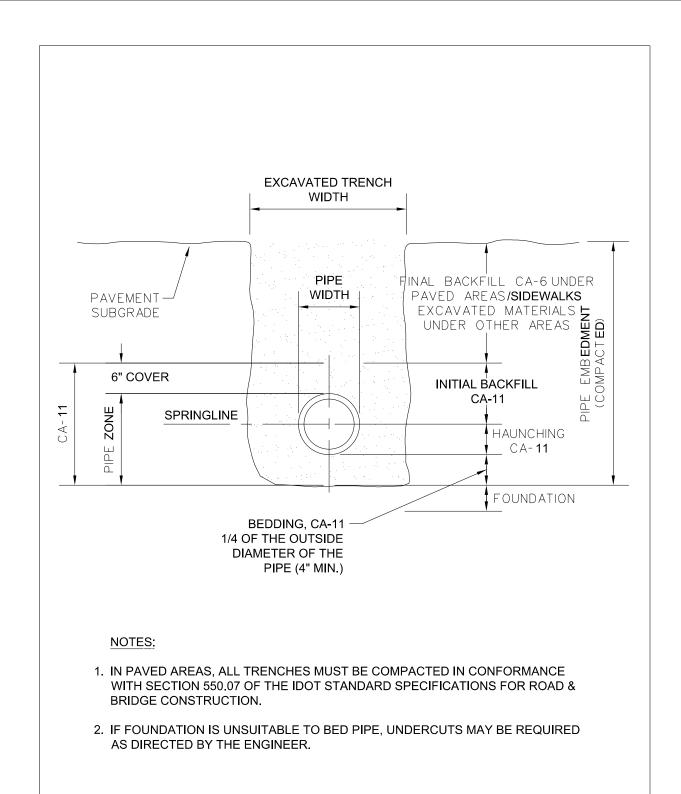SHEET 1 OF 1

390.10

SANITARY 10

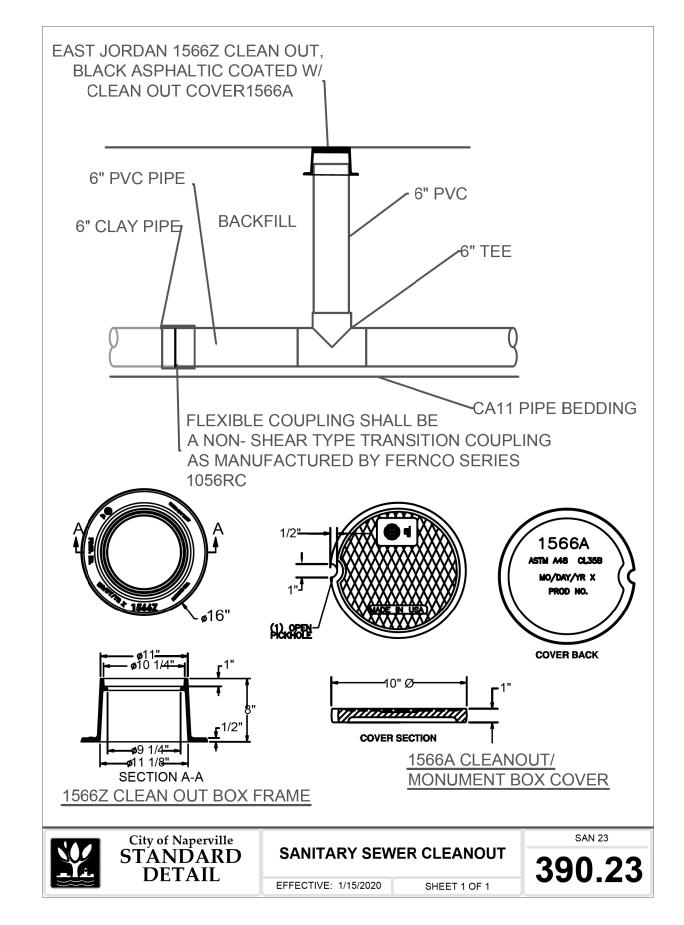

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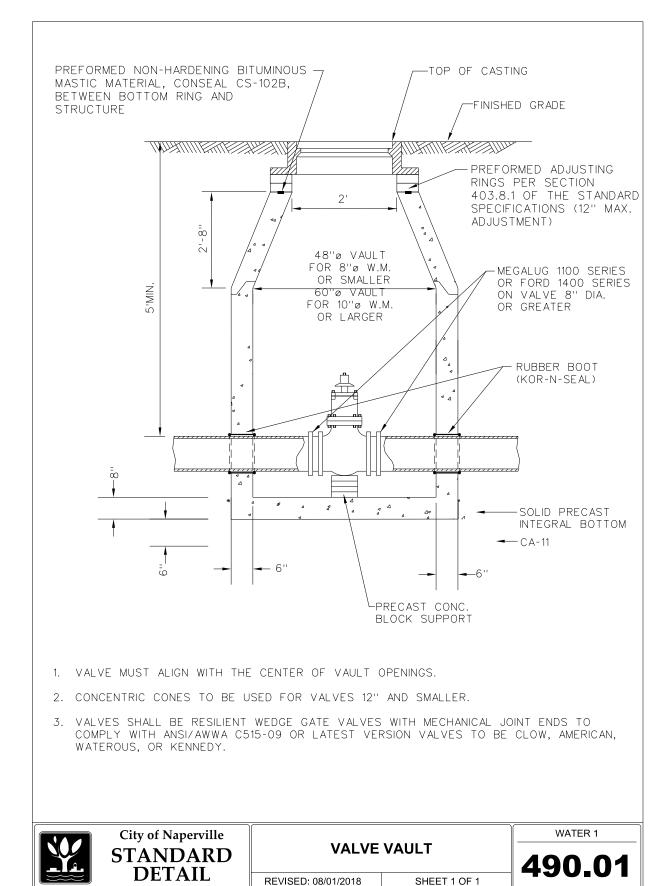
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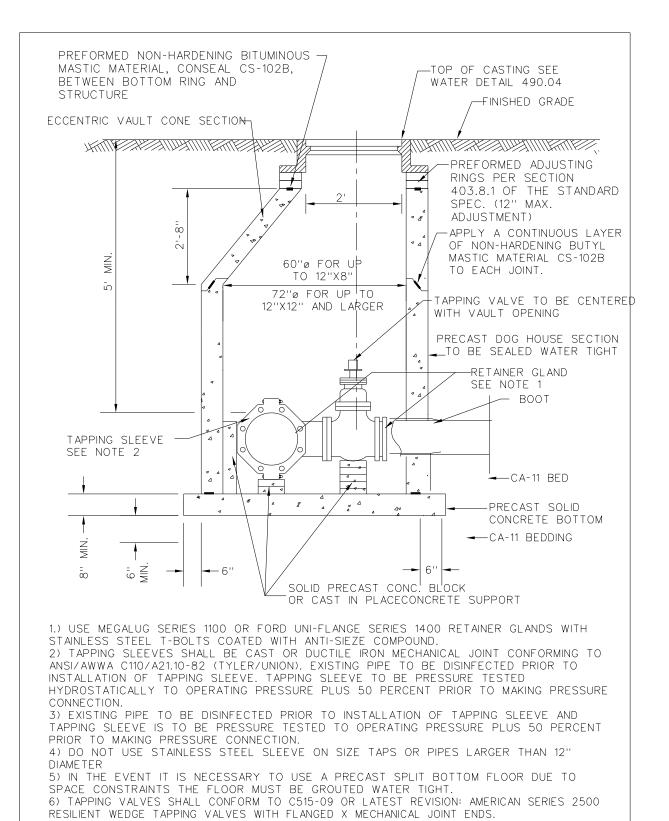
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DEPARTMENT OF TRANSPORTATION

WASHINGTON STREET BRIDGE CITY OF NAPERVILLE STANDARD DETAILS SHEET 2 OF 8 SHEETS STA.

SECTION 16-00167-00-BR DUPAGE 261 89 390.10 AND 390.23 CONTRACT NO. 61G82







City of Naperville **STANDARD DETAIL**

VALVE VAULT WITH CAST/DUCTILE **IRON SLEEVE PRESSURE TAP**

REVISED: 01/01/2013

WATER 2


490.02 SHEET 1 OF 1


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PLOT DATE = 8/8/2022	DATE -	REVISED -

SHEET 3 OF 8 SHEETS STA. -

SCALE: N.T.S.



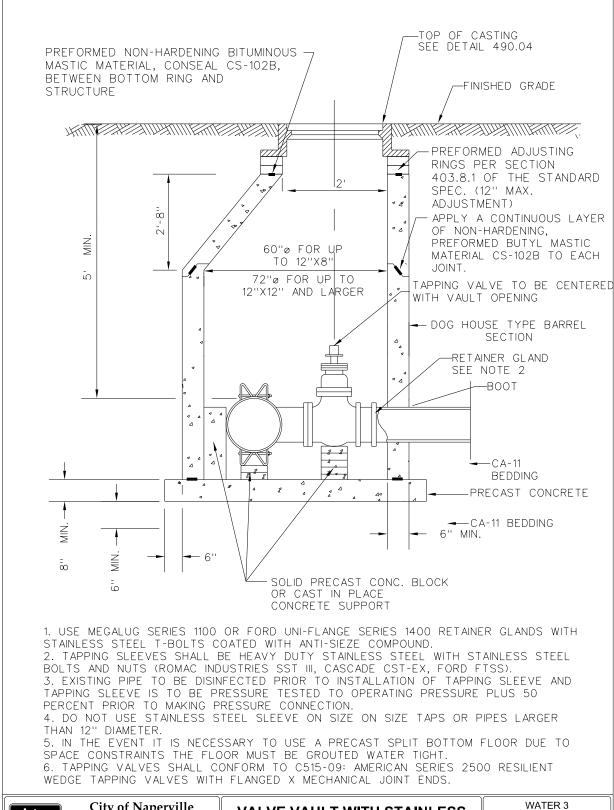

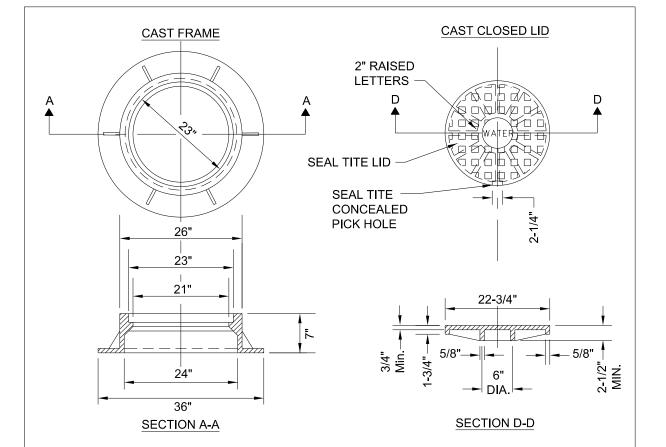NOTES:

- 1. DUCTILE IRON SHALL BE GRADE 65-45-12 AND SHALL BE TESTED IN ACCORDANCE WITH FEDERAL SPECIFICATIONS.
- 2. ALL FRAMES AND COVERS SHALL HAVE MACHINED HORIZONTAL AND VERTICAL BEARING SURFACES. PICK HOLES SHALL NOT CREATE OPENINGS IN THE COVER.
- 3. THE MANHOLE COVERS SHALL HAVE RAISED LETTERS AS SHOWN.
- 4. ALTERNATIVE TO DUCTILE IRON LID, GREY IRON CL 35 LID MAY BE USED.
- 5. DIMENSIONS FOR CASTINGS ARE COMPARABLE TO EAST JORDAN 1022 OR NEENAH R-1772-C, HEAVY DUTY.
- 6. LIDS AND FRAMES TO MEET AASHTO M306 PROOF LOADING SPECIFICATIONS.



SCALE: N.T.S.

City of Naperville **STANDARD DETAIL**

VALVE VAULT - FRAME & COVER

REVISED: 01/01/2013 SHEET 1 OF 1

WATER 4

City of Naperville **STANDARD DETAIL**

VALVE VAULT WITH STAINLESS STEEL SLEEVE PRESSURE TAP


REVISED: 01/01/2013 SHEET 1 OF 1 490.03

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PLOT DATE = 8/8/2022	DATE -	REVISED -

WASHINGTON STREET BRIDGE								F.A.U. RTE	SECTION		COUNTY	TOTAL SHEETS	SHEET NO.	
CITY OF NAPERVILLE STANDARD DETAILS							2552	16-00167-00-BF	DUPAGE	261	91			
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	SHEET	4	OF	8	SHEETS	STA.	-	TO STA		ILLINOIS	FED. A	ID PROJECT		

DEPARTMENT OF TRANSPORTATION

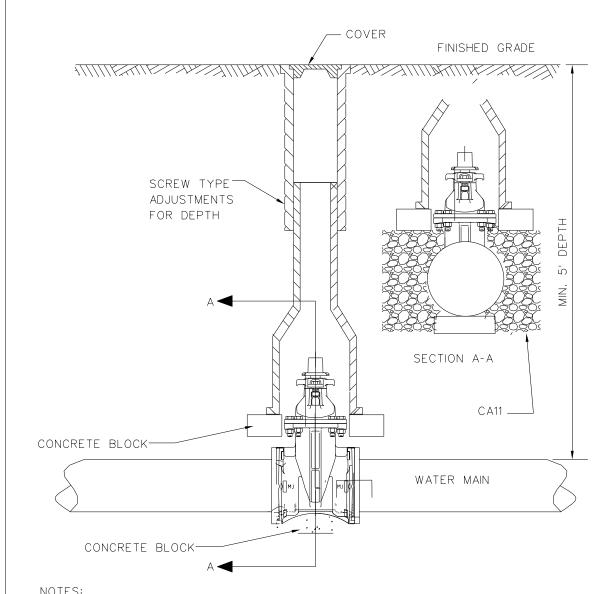

NOTES:

- 1. TYLER 6850. FOR LARGER VALVES TYLER 6860 WITH #6 BASE.
- 2. VALVE BOXES ARE NOT ALLOWED IN PAVED AREAS VALVE VAULT SHALL BE PROVIDED. CONTRACTOR SHALL SUBMIT IN WRITING ANY LOCATION WHERE A VAULT IS NOT INTENDED TO BE INSTALLED AND SPECIFIC REASON WHY IT CANNOT BE INSTALLED. THIS MUST BE APPROVED IN WRITING BY DPU-WATER.
- 3. RESTRAINT GLANDS REQUIRED ON EACH SIDE OF VALVE IF STUBBED FOR FUTURE CONNECTION OR PIPE BEND WITHIN TWO PIPE LENGTHS OF VALVE.




City of Naperville **STANDARD DETAIL**

VALVE BOX

490.05

WATER 5 REVISED: 01/01/2013 SHEET 1 OF 1

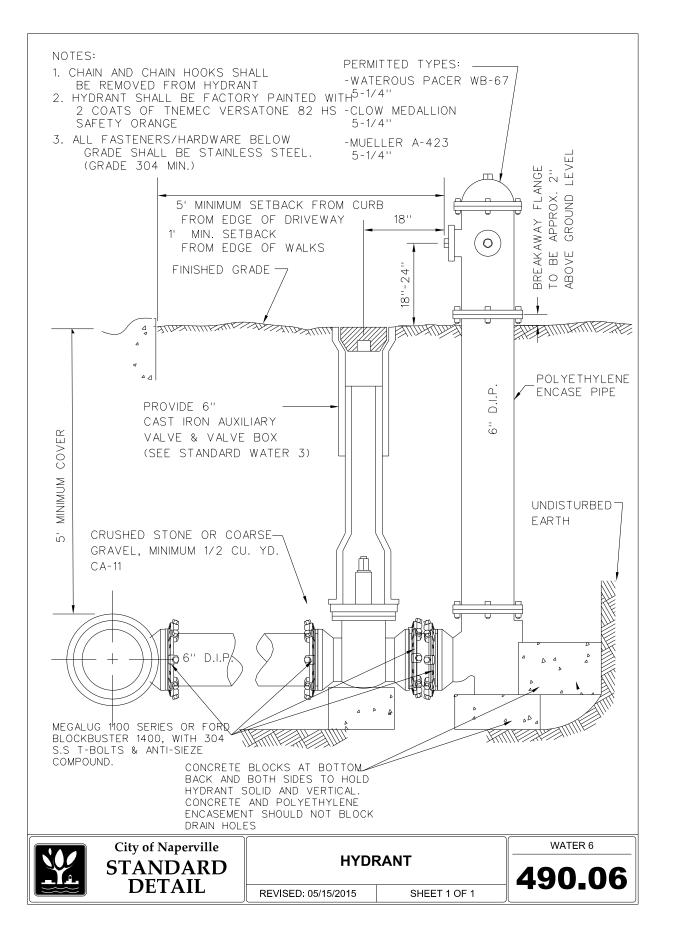

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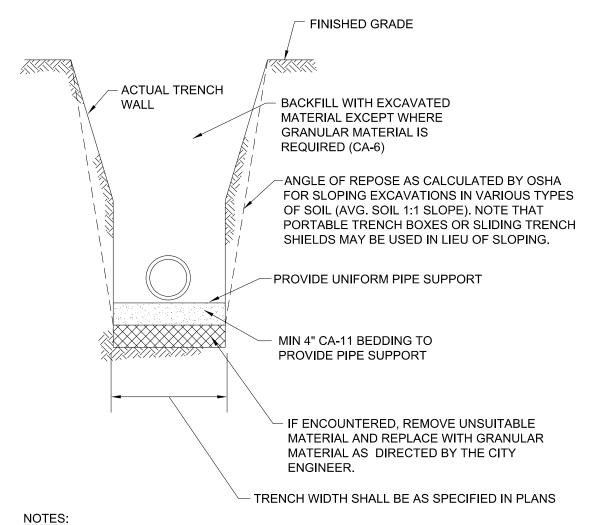
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STATE OF ILLINOIS **DEPARTMENT OF TRANSPORTATION**

SCALE: N.T.S.

SECTION COUNTY WASHINGTON STREET BRIDGE 16-00167-00-BR DUPAGE 261 92 CITY OF NAPERVILLE STANDARD DETAILS 490.05 AND 490.06 CONTRACT NO. 61G82 SHEET 5 OF 8 SHEETS STA.

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- 1. IN PAVED AREAS ALL TRENCHES SHALL BE COMPACTED IN ACCORDANCE WITH SECTION 550.07 OF THE IDOT STANDARD SPECIFICATIONS FOR ROAD AND BRIDGE CONSTRUCTION. METHOD 1. 95% MINIMUM STANDARD PROCTOR.
- 2. DUCTILE IRON WATER MAIN TO BE CLASS 52. ALL DUCTILE IRON PIPE IS TO BE ENCASED IN POLYETHYLENE FILM. POLYETHYLENE ENCASEMENT TO BE INSTALLED IN ACCORDANCE WITH AWWAC105A21.5-99.(OR LATEST EDITION)
- 3. STAINLESS STEEL NUTS, BOLTS/T-BOLTS, AND WASHERS, TYPE 304 OR BETTER, WILL BE REQUIRED ON ALL WATER MAIN INSTALLATIONS. THIS WOULD APPLY TO HYDRANTS, TAPPING SLEEVES, VALVES, FITTINGS, RESTRAINT, AND OTHER APPURTENANCES BURIED OR IN VALVE VAULTS. MECHANICAL JOINTS AND RESTRAINT GLANDS REQUIRE 304 STAINLESS STEEL T-BOLTS. AN ANTI-SEIZE COMPOUND SHALL BE FACTORY APPLIED TO NUTS OR BOLTS - ANY DAMAGE TO THIS COATING SHALL BE REPAIRED WITH FIELD-APPLIED, APPROVED ANTI-SEIZE COMPOUND THAT IS A MOLYBDENUM-BASE LUBRICANT, BOSTIK NEVER-SEEZ.




City of Naperville **STANDARD DETAIL**

490.10

WATER 10

WATER MAIN TRENCH SECTION

REVISED: 01/01/2013 SHEET 1 OF 1

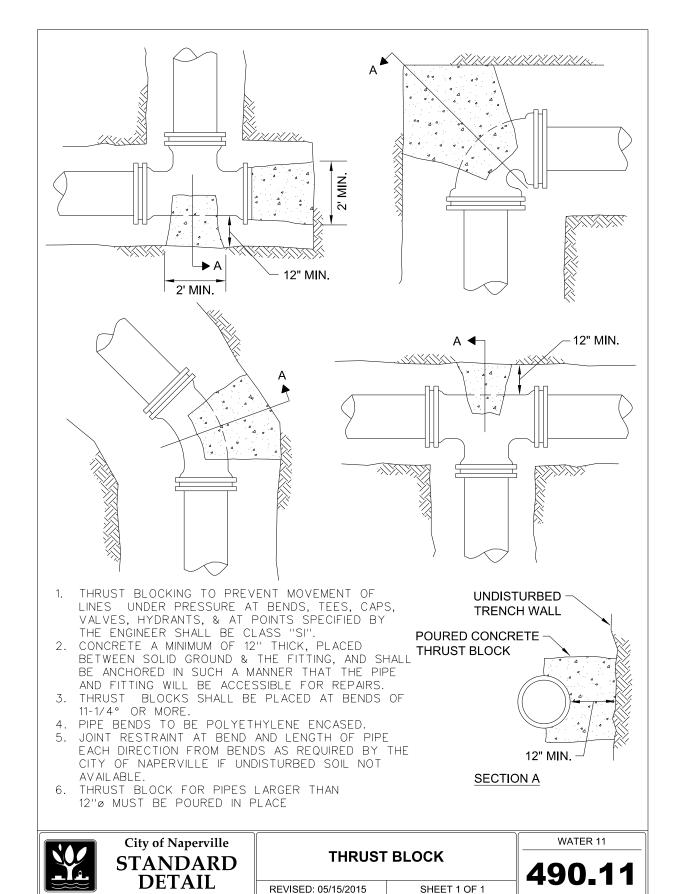

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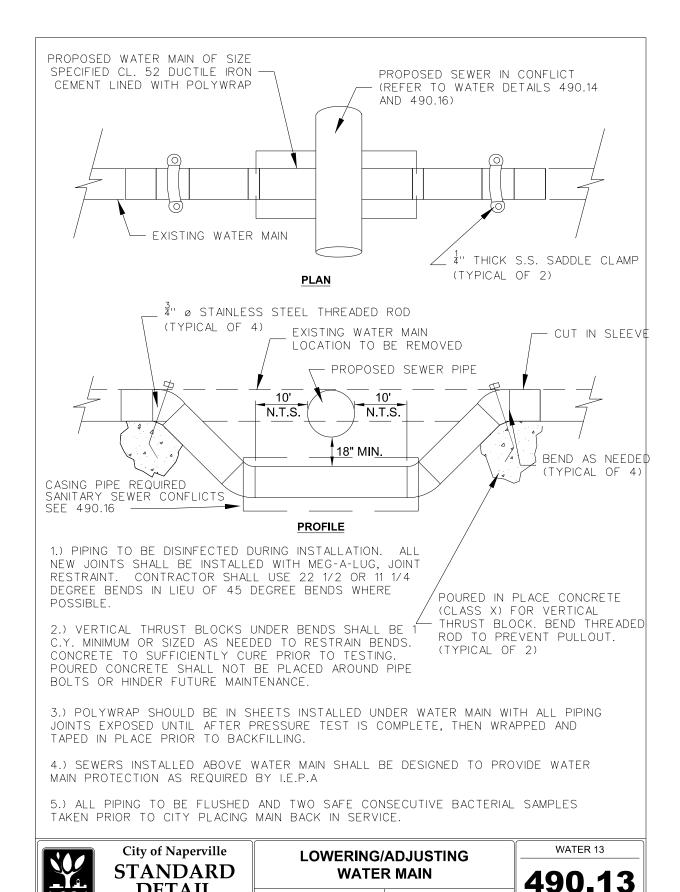
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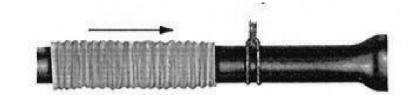
STATE OF ILLINOIS **DEPARTMENT OF TRANSPORTATION**

WASHINGTON STREET BRIDGE CITY OF NAPERVILLE STANDARD DETAILS SHEET 6 OF 8 SHEETS STA.


SECTION COUNTY 16-00167-00-BR DUPAGE 261 93 490.10 AND 490.11 CONTRACT NO. 61G82

SCALE: N.T.S.





CUT A SECTION OF POLYETHYLENE TUBE APPROXIMATELY TWO FEET LONGER THAN THE PIPE SECTION. REMOVE ALL LUMPS OF CLAY, MUD. CINDERS, OR OTHER MATERIAL THAT MIGHT HAVE ACCUMULATED ON THE PIPE SURFACE DURING STORAGE. SLIP THE POLYETHYLENE TUBE AROUND THE PIPE, STARTING AT THE SPIGOT END. BUNCH THE TUBE ACCORDION-FASHION ON THE END OF THE PIPE. PULL BACK THE OVERHANGING END OF THE TUBE UNTIL IT CLEARS THE PIPE END.

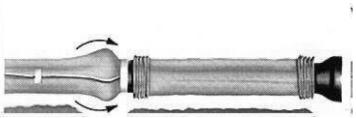

MAKE THE OVERLAP OF THE POLYETHYLENE TUBE BY PULLING BACK THE BUNCHED POLYETHYLENE FROM THE PRECEDING LENGTH OF PIPE AND SECURING IT IN PLACE. NOTE: THE POLYETHYLENE MAY BE SECURED IN PLACE BY USING TAPE, STRING, PLASTIC TIE STRAPS, OR ANY OTHER MATERIAL CAPABLE OF HOLDING THE POLYETHYLENE ENCASEMENT SNUGLY AGAINST THE PIPE.



TAKE UP SLACK IN THE TUBE ALONG THE BARREL OF THE PIPE TO MAKE A SNUG, BUT NOT TIGHT, FIT. FOLD EXCESS POLYETHYLENE BACK OVER THE TOP OF THE PIPE.



REPAIR ALL SMALL RIPS, TEARS OR OTHER TUBE DAMAGE WITH MANUFACTURER APPROVED ADHESIVE TAPE.

- 1. COVER BENDS, REDUCERS AND OTHER PIPE-SHAPED APPURTENANCES WITH POLYETHYLENE IN THE SAME MANNER AS THE PIPE.
- 2. WRAP VALVES, TEES AND OTHER ODD-SHAPED APPURTENANCES WITH A FLAT SHEET OR SPLIT LENGTH OF POLYETHYLENE TUBE BY PASSING THE SHEET UNDER THE APPURTENANCES AND BRINGING IT UP AROUND THE BODY. MAKE SEAMS BY BRINGING THE EDGES OF THE POLYETHYLENE SHEET TOGETHER, FOLDING OVER TWICE, AND TAPING
- 3. POLYETHYLENE ENCASEMENT TO BE IN ACCORDANCE WITH A.W.W.A. C105-990R LATEST VERSION.
- 4. COPPER SERVICE TAPS ARE TO BE WRAPPED WITH POLYETHELENE OR A SUITABLE DIELECTRIC APE FOR A MINIMUM CLEAR DISTANCE OF 3' AWAY FROM THE MAIN.



City of Naperville **STANDARD DETAIL**

POLYETHYLENE ENCASEMENT

REVISED: 01/01/2013

SHEET 1 OF 1

WATER 15

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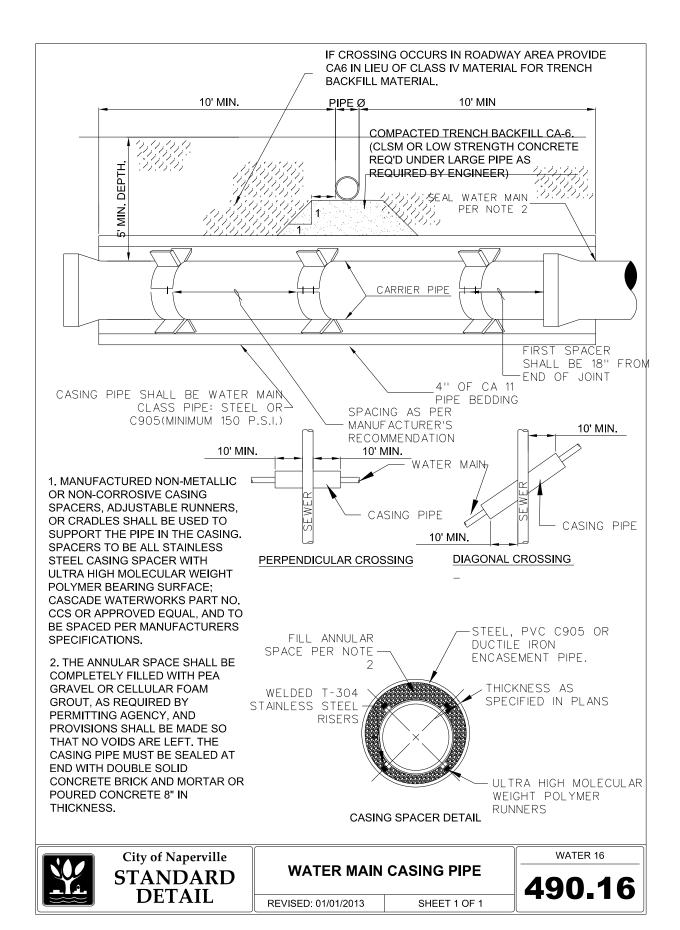
SHEET 1 OF 1


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STATE OF ILLINOIS

WASHINGTON STREET BRIDGE CITY OF NAPERVILLE STANDARD DETAILS

COUNTY 16-00167-00-BR DUPAGE 261 94 490.13 AND 490.15 CONTRACT NO. 61G82



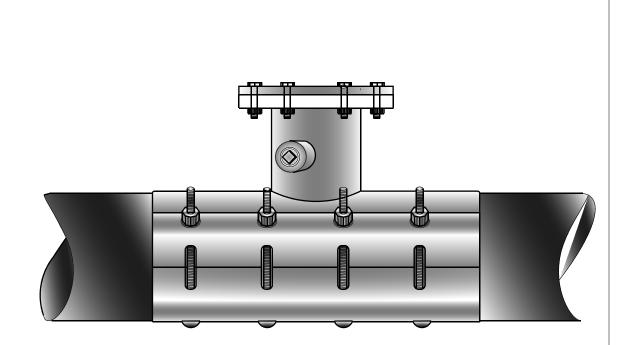

SLEEVE TO BE PRESSURE RATED AT 150 PSI WORKING PRESSURE AND 225 PSI TEST PRESSURE.

- 1. CONSTRUCTION TO BE ALL STAINLESS T-304, 18-8 STAINLESS STEEL , 14 GAUGE (MINIMUM).
- 2. GASKETS TO PROVIDE 360 DEGREE PIPE COVERAGE IN ADDITION TO A FULL CIRCUMFERENCE BRANCH SEAL GASKET.
- 3. EXISTING PIPE TO BE DISINFECTED PRIOR TO INSTALLATION OF LINE STOP
- 4. STAINLESS STEEL TEST PORT AND PLUG SHALL BE PROVIDED AND THE LINE STOP SLEEVE IS TO BE PRESSURE TESTED PRIOR TO CUTTING THE EXISTING
- 5. V-LUGS SHALL BE FABRICATED TO THE SLEEVE AND DROP-IN STAINLESS STEEL BOLTS, NUTS AND WASHERS (18-8 MINIMUM GRADE) PROVIDED. NUTS SHALL BE COATED WITH ANTI-SIEZE COMPOUND TO PREVENT GALLING.
- 6. PROVIDE AS-BUILT FOR LOCATION AND ELEVATION OF TOP OF FLANGE ON RECORD DRAWINGS.
- 7. ACCEPTABLE LINE STOP SLEEVES ARE HYDRA STOP PREMIER LINE STOP FITTING OF ALL STAINLESS STEEL CONSTRUCTION WITH DROP-IN BOLT OPTION AND SMITH BLAIR MODEL 685 ALL STAINLESS STEEL LINE STOP TAPPING SLEEVE WITH. ALL BOLTS, NUTS, AND WASHERS AND BLIND FLANGES TO BE 18-8 TYPE 304 STAINLESS. STOPPLE (COMPLETION) PLUG TO BE DUCTILE IRON OR STAINLESS STEEL.



SCALE: N.T.S.

City of Naperville **STANDARD DETAIL**

LINE STOP TAPPING SLEEVE

WATER 17

REVISED: 01/01/2013

SHEET 1 OF 1


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STATE OF ILLINOIS **DEPARTMENT OF TRANSPORTATION**

WASHINGTON STREET BRIDGE CITY OF NAPERVILLE STANDARD DETAILS SHEET 8 OF 8 SHEETS STA.

SECTION COUNTY 16-00167-00-BR DUPAGE 261 95 490.16 AND 490.17 CONTRACT NO. 61G82




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DEPARTMENT OF TRANSPORTATION

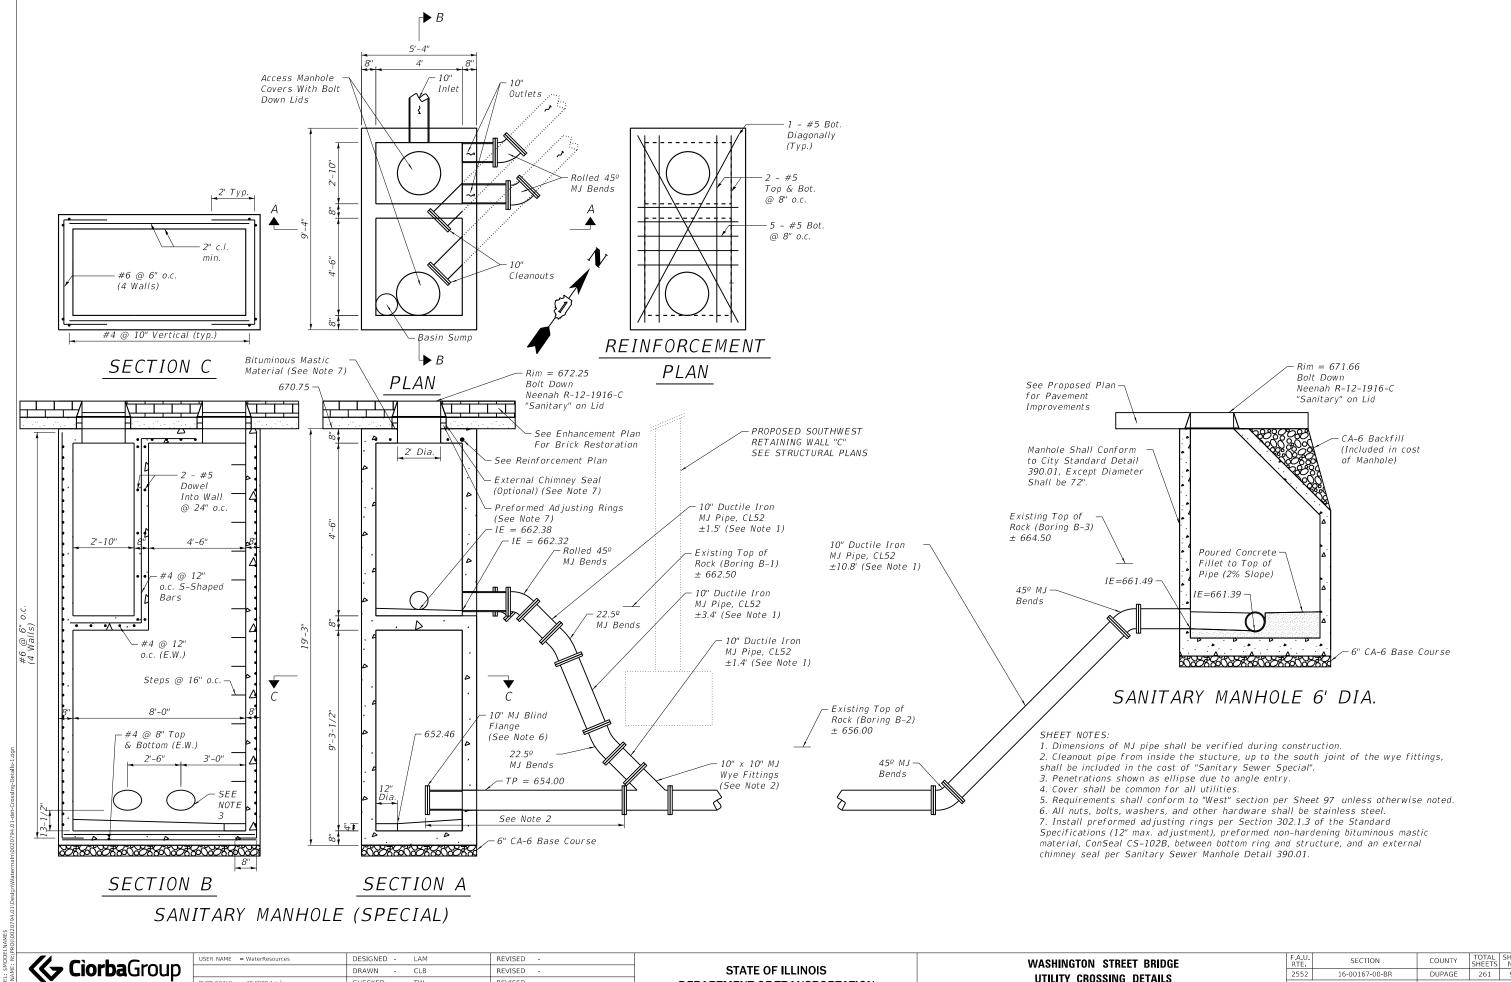SCALE: N.T.S.

16-00167-00-BR DUPAGE 261 96 UTILITY CROSSING DETAILS CONTRACT NO. 61G82 SHEET 1 OF 2 SHEETS STA. TO STA.



RIVER UTILITY CROSSING DETAILS

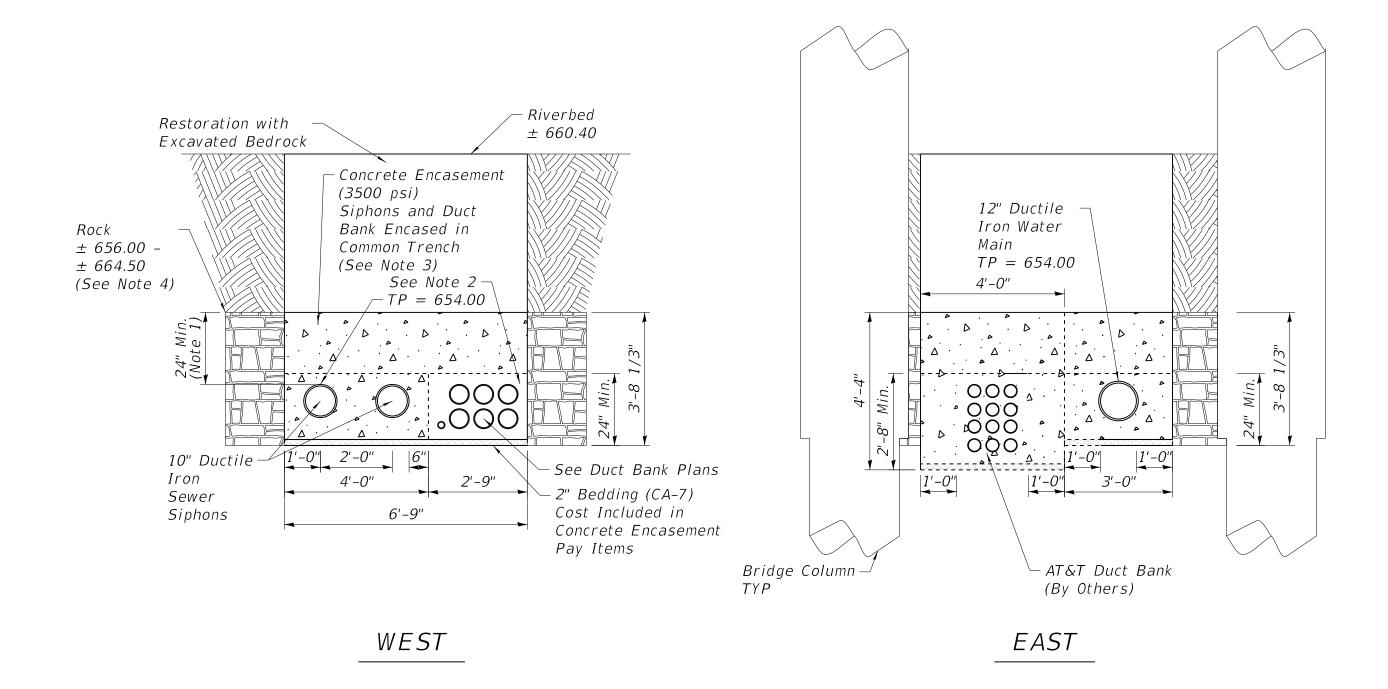SHEET NOTES:

1. Cover shall be common for all utilities.

2. $2'9" \times 22"$ concrete encasement and 2" bedding envelope for Electrical Duct Bank shall be included in electrical pay items.

3. Concrete encasement for Sanitary Sewer and Water Main shall only extend across river. Encasement for these utilities is not specified where tops of pipe are equal to or greater than 656.00.

4. Quantities for Rock Excavation are based on variable rock elevations from Borings B1-B3. Height of Rock Excavation is from the top of the rock encountered to the bottom of the detail section. Width of rock excavation is as shown on the detail.

SCALE: N.T.S.


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PLOT SCALE = 40.0000 / in.	CHECKED - TW	REVISED -	
PLOT DATE = 8/8/2022	DATE -	REVISED -	

WASHINGTON STREET BRIDGE UTILITY CROSSING DETAILS							F.A.U. RTE. 2552	SECTION 16-00167-00-BR	COUNTY DUPAGE	TOTAL SHEETS 261	SHEET NO. 97
OTILITY OHOODING DETAILS									CONTRACT	NO. 6	1G82
SHEET	2	OF	2	SHEETS	STA	TO STA	ILLINOIS FED. AID PROJECT				

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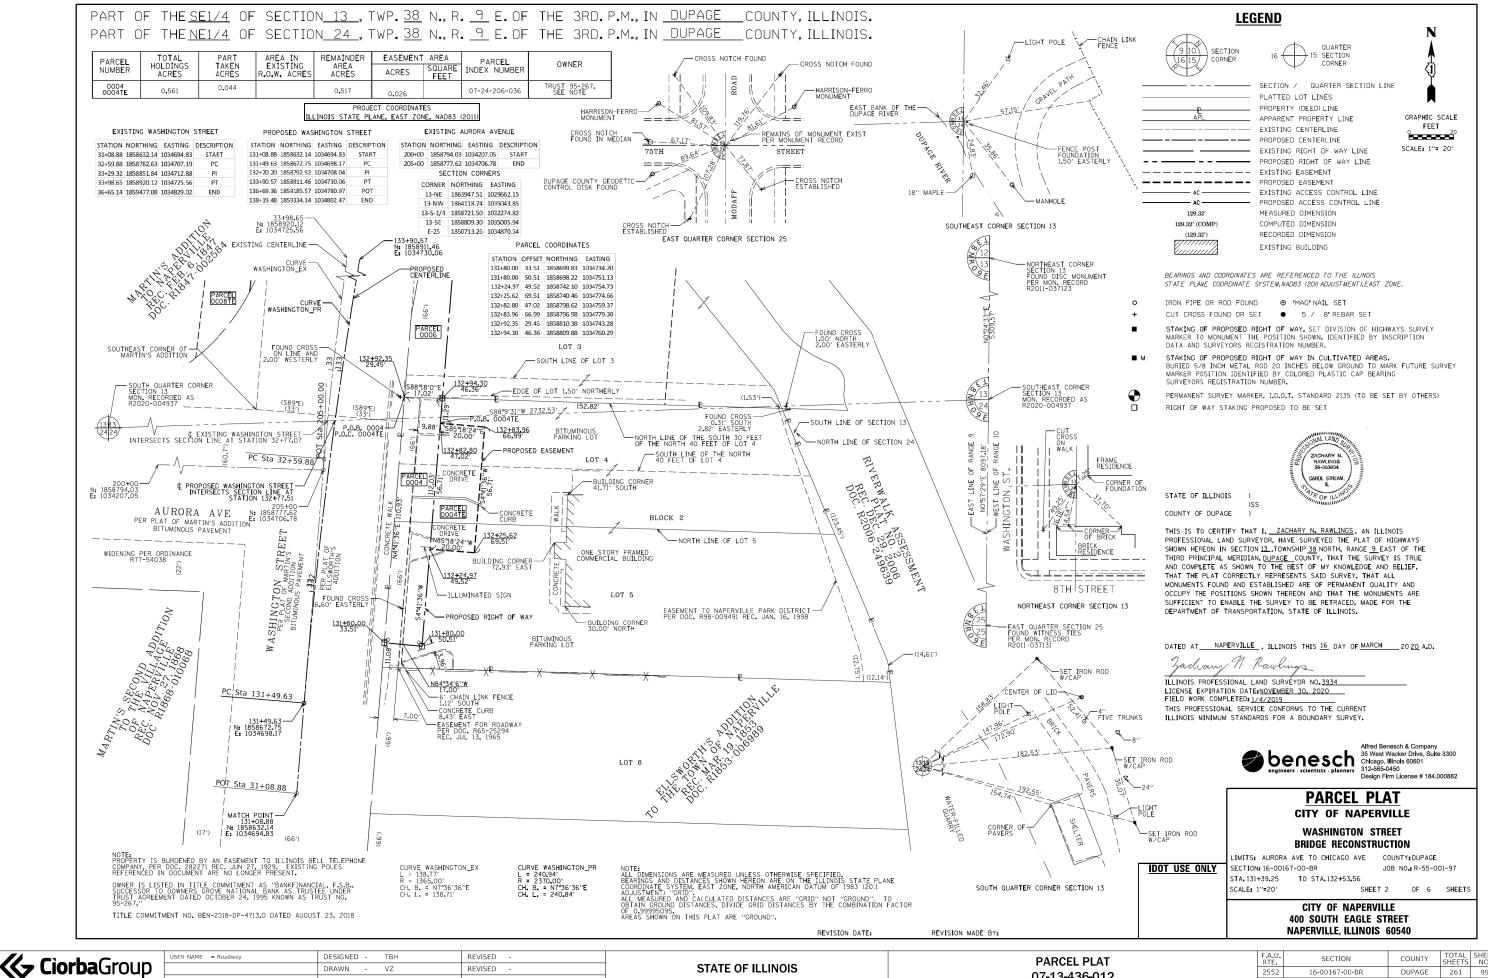
STATE OF ILLINOIS **DEPARTMENT OF TRANSPORTATION**

07-13-436-011 OF 6 SHEETS STA. SHEET 1

TO STA.

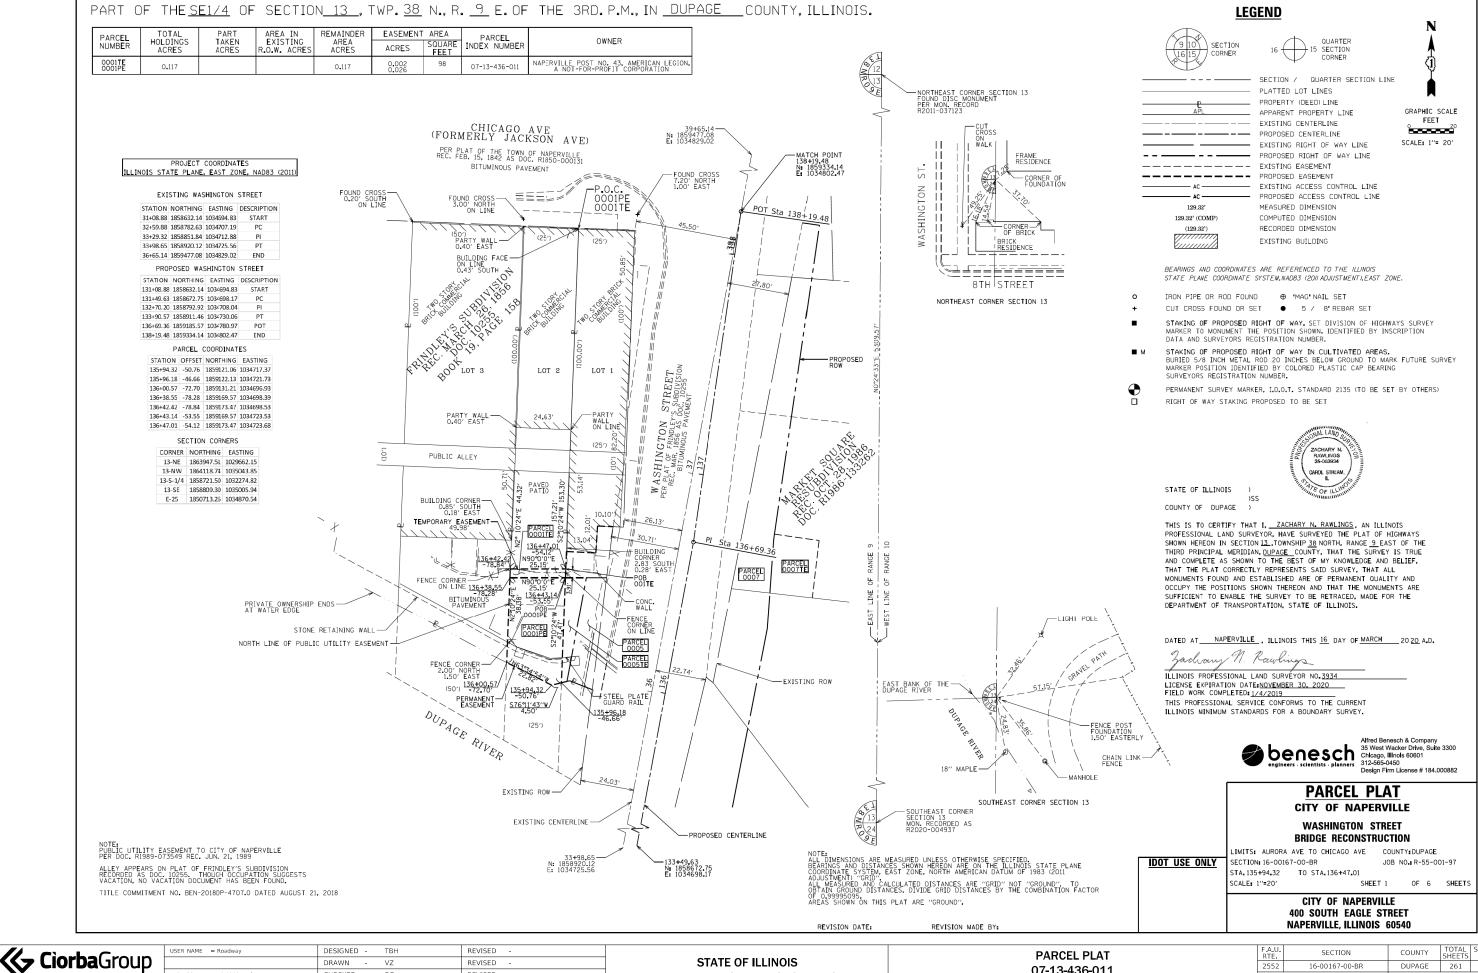SCALE: N.T.S.

2552 16-00167-00-BR DUPAGE 261 98 CONTRACT NO. 61G82



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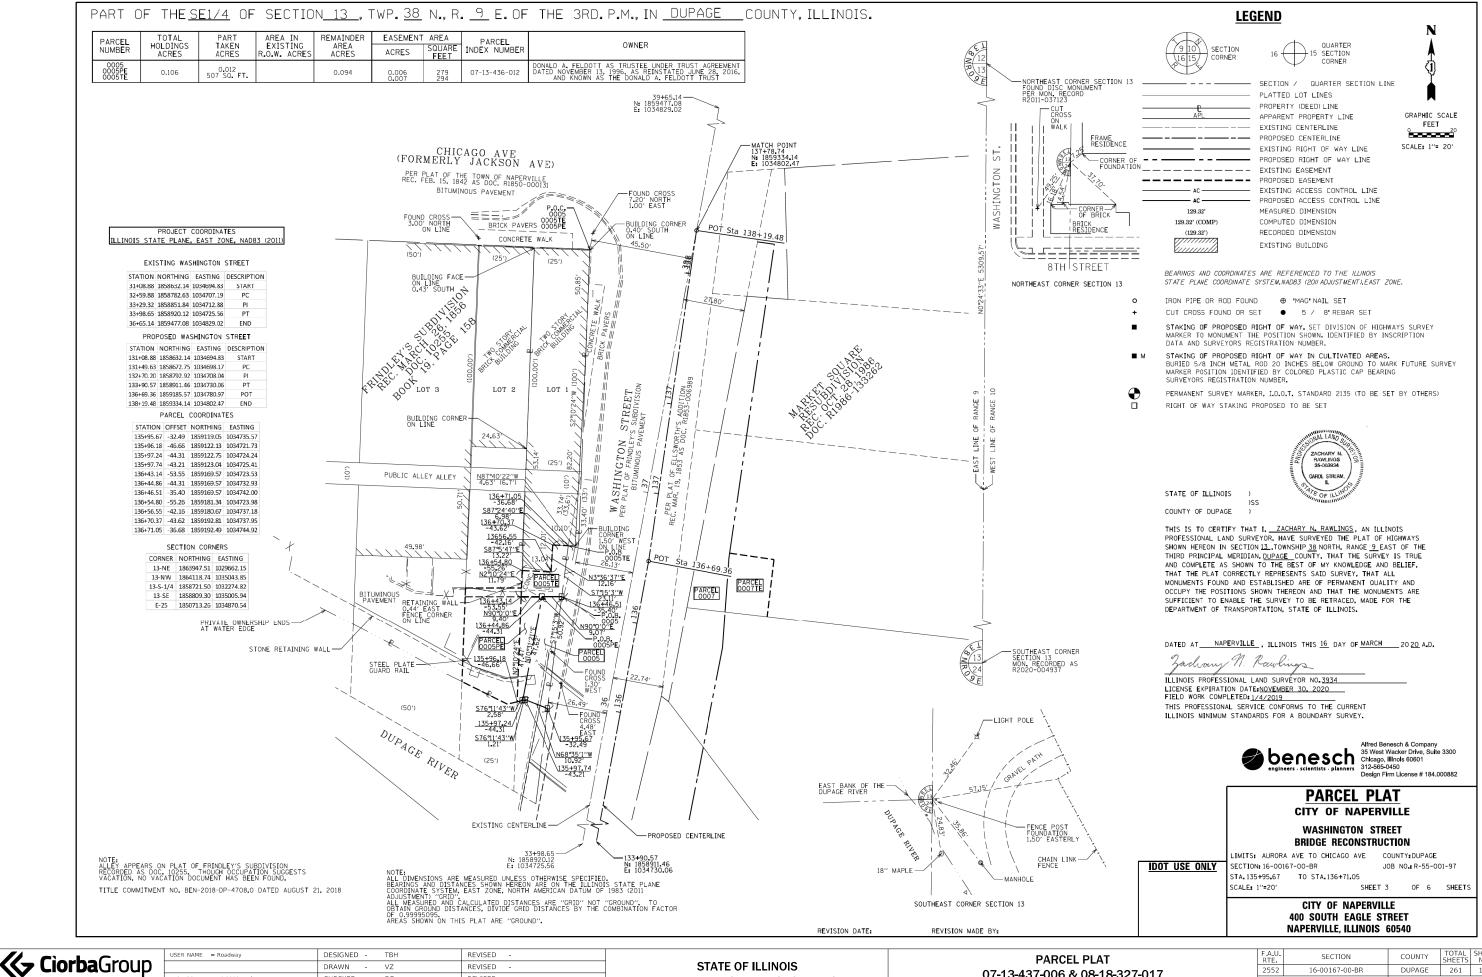
DEPARTMENT OF TRANSPORTATION

07-13-436-012 OF 6 SHEETS STA. SHEET 2

TO STA.

SCALE: N.T.S.

16-00167-00-BR 2552 DUPAGE 261 99 CONTRACT NO. 61G82



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DEPARTMENT OF TRANSPORTATION

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SHEET	3	OF	6	SHEETS	STA.	

TO STA.

SCALE: N.T.S.

F.A.U. RTE	SECTION	COUNTY	TOTAL SHEETS	SHEET NO.
2552	16-00167-00-BR	DUPAGE	261	100
		CONTRACT	NO. 6	1G82
	ILLINOIS FED.	AID PROJECT		