
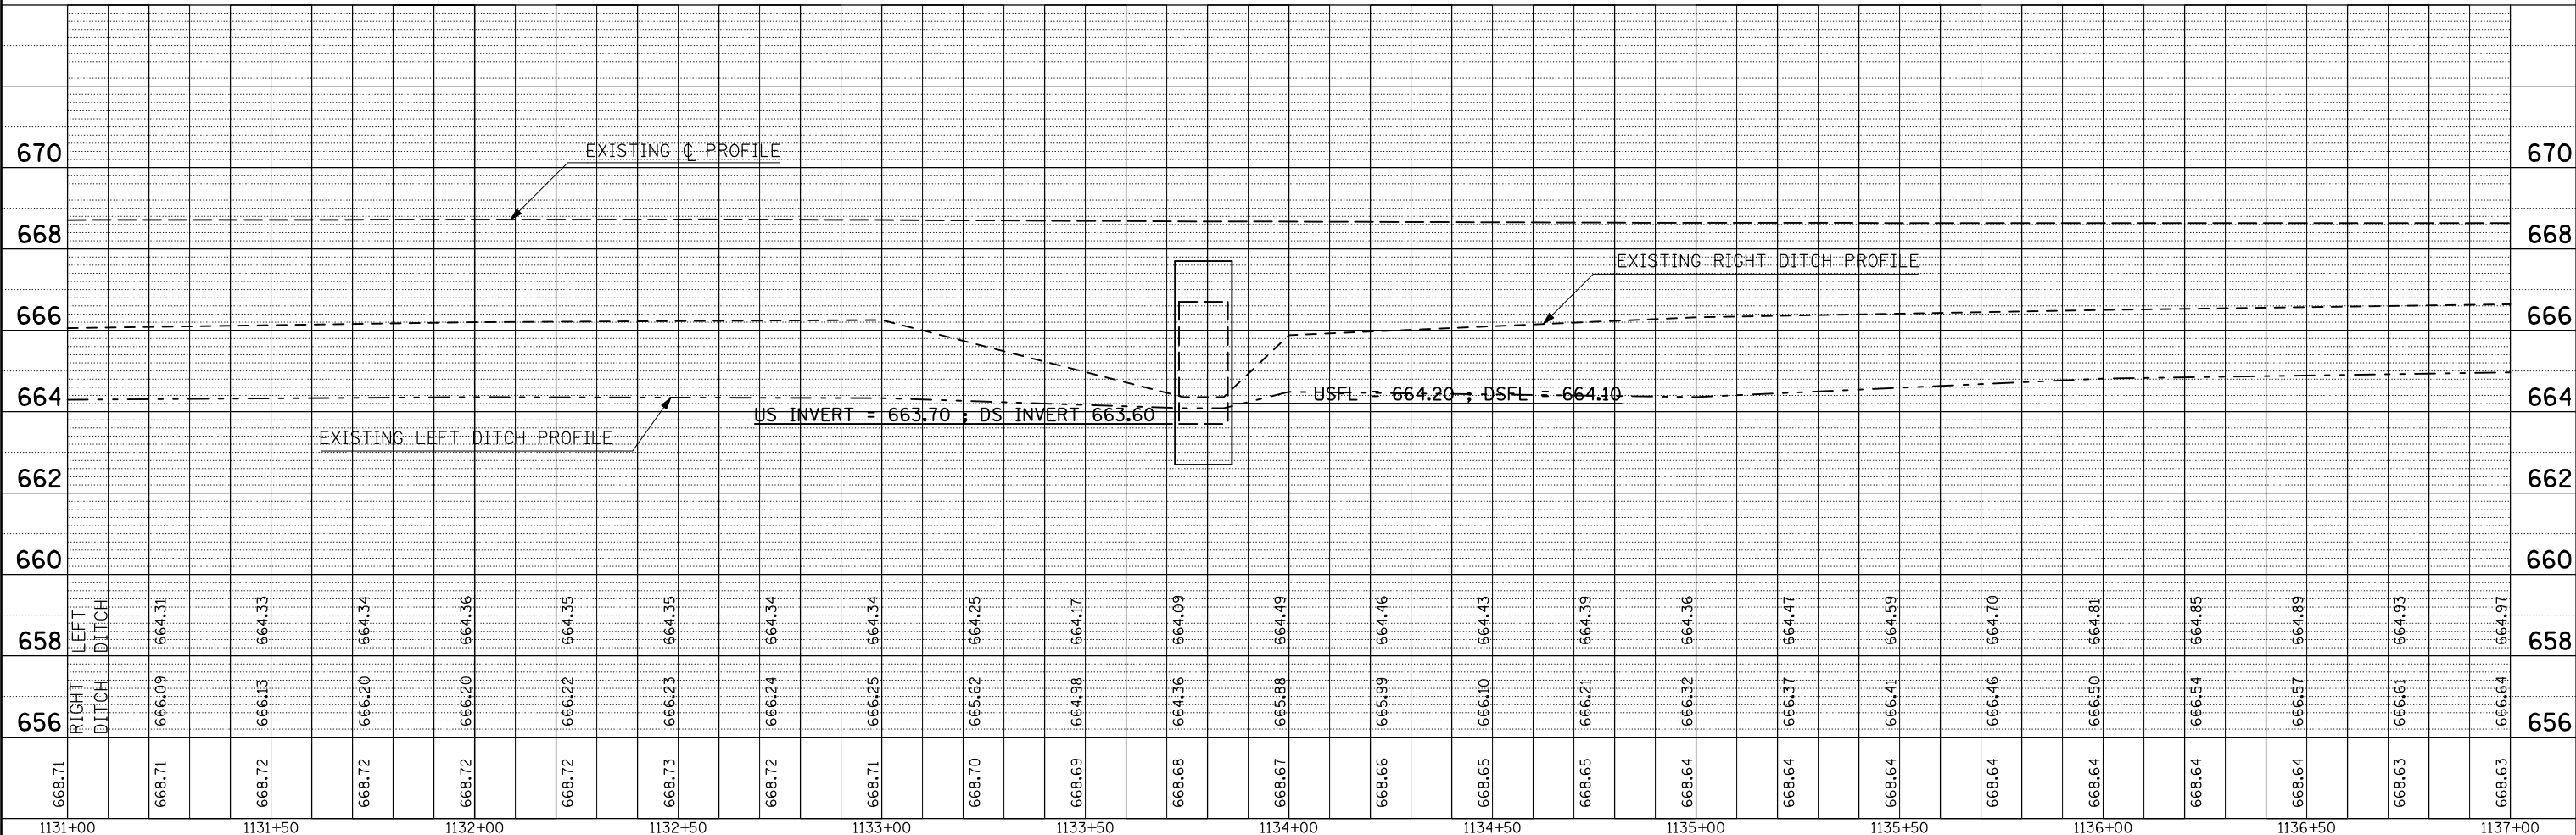
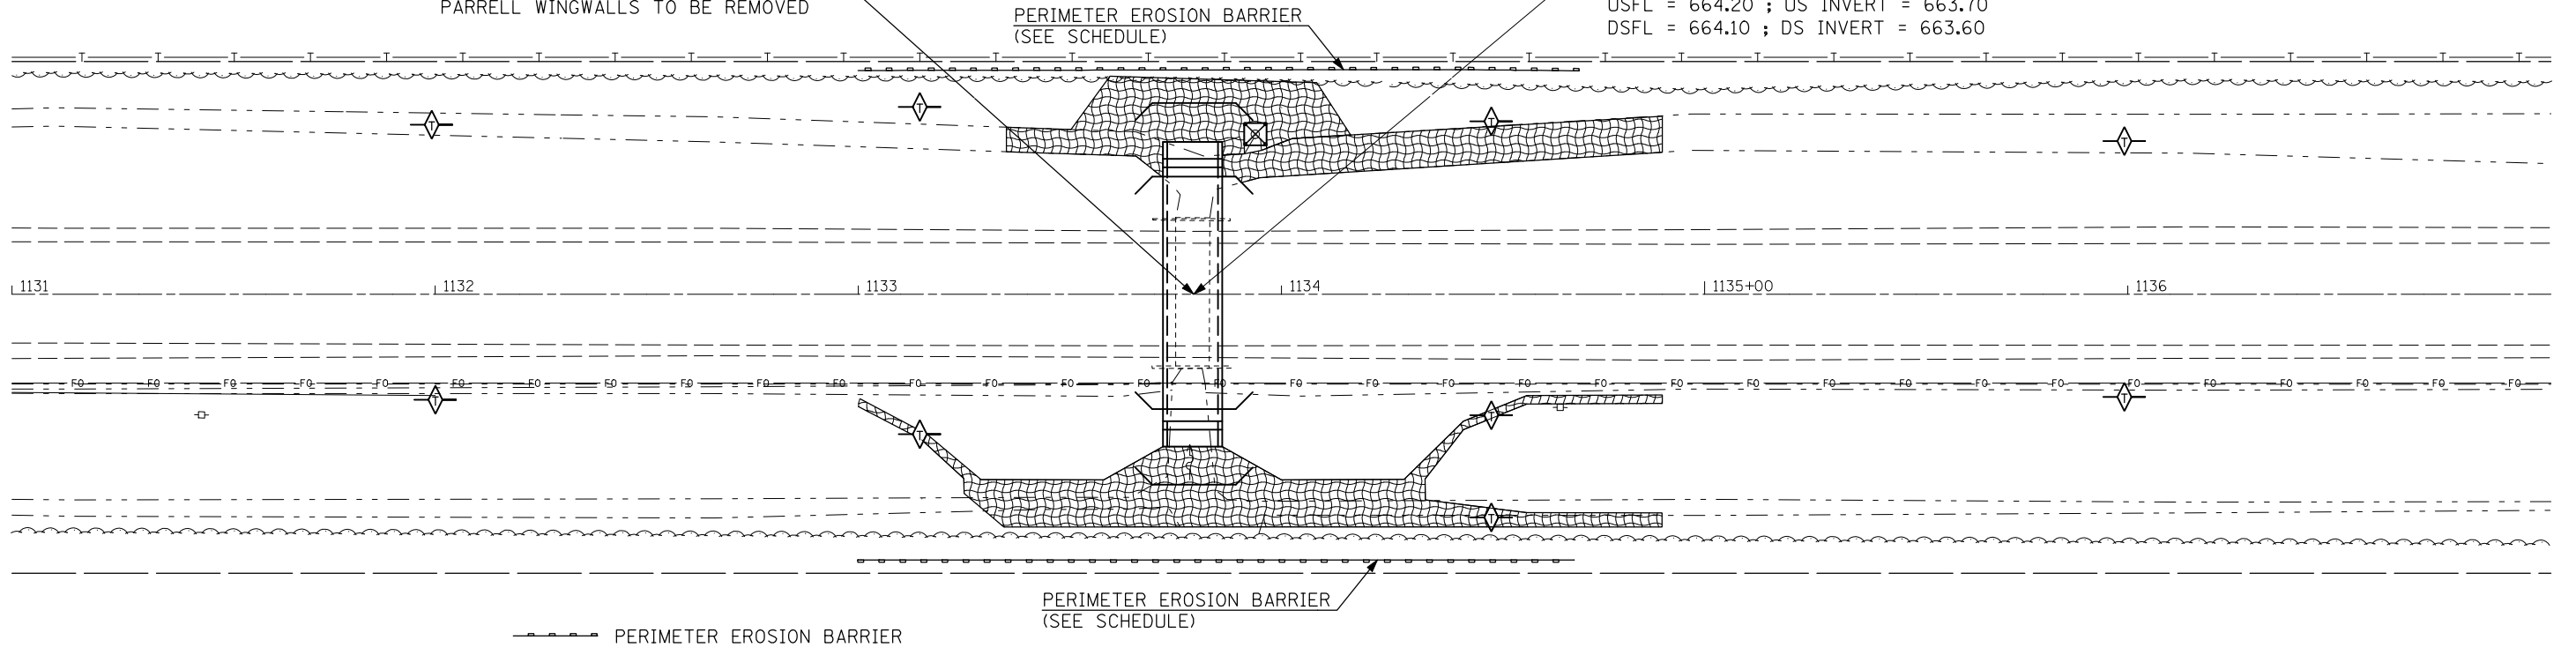


EROSION CONTROL PLAN

S.N. 010-8101
 STA. 1133+79
 EXISTING 8'x3'x34' RCBC WITH
 PARRELL WINGWALLS TO BE REMOVED

S.N. 010-8131
 STA. 1133+79
 PROPOSED 12'x3'x37.5' RCBC WITH PRECAST END SECTIONS
 USFL = 664.20 ; US INVERT = 663.70
 DSFL = 664.10 ; DS INVERT = 663.60

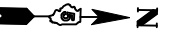

PLAN	SURVEYED	BY	DATE
	PLOTTED		
	CHECKED		
	AT 100% MAX		
	CADD FILE NAME		
	NO.		

PROFILE	SURVEYED	BY	DATE
	PLOTTED		
	CHECKED		
	AT 100% MAX		
	STRUCTURE NOTATION CHNO		
	NO.		

FILE NAME = C:\pwork\pwork\craig\0124546\0570698-SHT-DETAILS.dgn		USER NAME = craig		DESIGNED - RTB	REVISED - RTB	STATE OF ILLINOIS DEPARTMENT OF TRANSPORTATION	EROSION CONTROL PLAN			F.A.P. RTE. 836	SECTION 119CR	COUNTY CHAMPAIGN	TOTAL SHEETS 29	SHEET NO. 16
PLOT SCALE = 40.0000 ' / IN.		PLOT DATE = 10/23/2009		DRAWN - JJB	REVISED -		SCALE: 1" = 20'	SHEET NO. 2 OF 3 SHEETS	STA. 1131+00.00 TO STA. 1137+00.00	CONTRACT NO. 70698				
											FED. ROAD DIST. NO. ILLINOIS FED. AID PROJECT			