01-15-2021 LETTING ITEM 143

FOR INDEX OF SHEETS, SEE SHEET NO. 2 FOR LIST OF HIGHWAY STANDARDS, SEE SHEET NO. 2

MAJOR COLLECTOR

2,850 ADT (2016) 0% TRUCKS POSTED SPEED LIMIT = 30 MPH

HAUMBURG

Δ.

RAMOS

CARMEN

PROGRAM ENGINEER:

AD

FEDERAL


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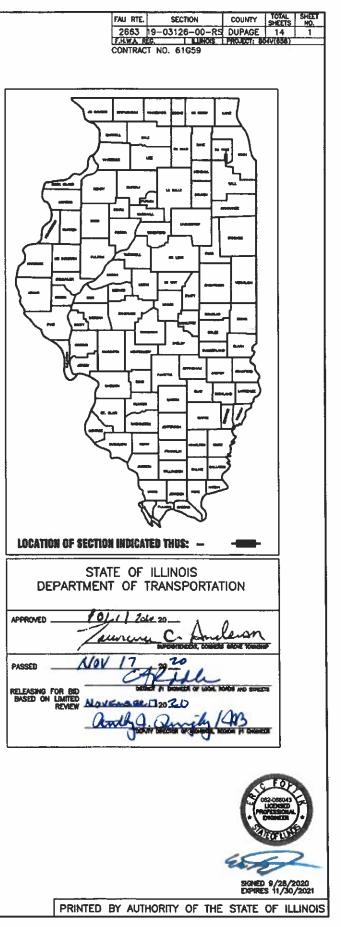
STATE OF ILLINOIS DEPARTMENT OF TRANSPORTATION DIVISION OF HIGHWAYS PLANS FOR PROPOSED FEDERAL AID HIGHWAY

(FAU 2663) CLARENDON HILLS ROAD FROM 91ST STREET TO 79TH STREET

RESURFACING

SECTION NO. 19-03126-00-RS PROJECT 804V(658) DOWNERS GROVE TOWNSHIP DUPAGE COUNTY JOB NO. C-91-401-19



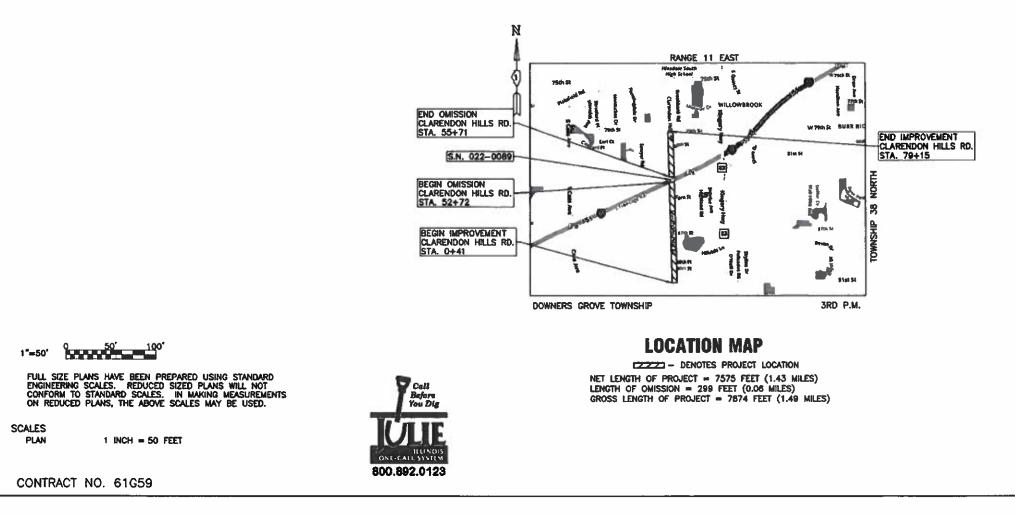

INDEX OF SHEETS

- COVER SHEET & LOCATION MAP
- INDEX OF SHEETS, HIGHWAY STANDARDS, AND GENERAL NOTES 2.
- SUMMARY OF QUANTITIES 3.
- 4.-5. TYPICAL SECTIONS
- 6.-8. ROADWAY AND PAVEMENT MARKING PLANS CLARENDON HILLS ROAD
- 9. DETAILS FOR FRAMES AND LIDS ADJUSTMENT WITH MILLING (BD-8)
- 10. PAVEMENT PATCHING FOR HMA SURFACED PAVEMENT (BD-22)
- 11. BUTT JOINT AND HMA TAPER DETAILS (BD32)
- TRAFFIC CONTROL AND PROTECTION FOR SIDE ROADS, INTERSECTIONS, AND 12. DRIVEWAYS (TC-10)
- 13. DISTRICT 1 TYPICAL PAVEMENT MARKINGS (TC-13)
- 14. ARTERIAL ROAD INFORMATION SIGN (TC-22)

- 12. THE CONTRACTOR SHALL PRESERVE AND PROTECT ALL EXISTING FIELD TILES. ANY FIELD TILES DAMAGED BY THE CONTRACTOR'S OPERATIONS SHALL BE REPAIRED OR REPLACED BY THE CONTRACTOR AT HIS SOLE EXPENSE. INVESTIGATION SHALL BE MADE TO INSURE THAT FIELD TILES DO NOT CONVEY OFF SITE WATER TILES THAT CONVEY OFF SITE WATER SHALL BE REROUTED THROUGH THE SITE. TILES THAT DO NOT CONVEY OFF SITE WATER SHALL BE ABANDONED IN AN APPROPRIATE MANNER APPROVED BY THE MUNICIPALITY. FIELD TILES WITHIN A RIGHT-OF-WAY SHALL BE REMOVED AND BACKFILLED WITH CA-6 COMPACTED IN EIGHT INCH LIFTS TO THE BOTTOM OF THE ROADWAY BASE. EXISTING FIELD TILES SHALL BE REMOVED BY SLIT TRENCHING
- 13. THE CONTRACTOR RESPONSIBLE FOR DRAINAGE IMPROVEMENTS SHALL BE RESPONSIBLE TO PLACE ALL FIRE HYDRANTS, FRAMES AND LIDS OR GRATES, AND ALL GRATES FOR MANHOLES, CATCH BASINS, INLETS AND VALVE VAULTS AT THE ELEVATIONS SHOWN AND SPECIFIED ON THE PLANS.
- 14. THE CONTRACTOR SHALL KEEP PUBLIC STREET PAVEMENTS CLEAN OF DIRT AND DEBRIS AND, WHEN NECESSARY, SHALL ON A DAILY BASIS CLEAN THE PAVEMENT OF SUCH DIRT AND DEBRIS RESULTING FROM CONSTRUCTION OPERATIONS.
- 15. THE CONTRACTOR SHALL EXAMINE THE DRAINAGE PATTERNS SHOWN ON THE PLANS AND MAKE CERTAIN THAT ALL OVERFLOW POINT ELEVATIONS AND CROSS SECTIONS ARE CONSTRUCTED STRICTLY IN ACCORDANCE WITH THOSE SHOWN ON THE PLANS.
- 16. THE CONTRACTOR SHALL CONTACT J.U.L.I.E. (1-800-892-0123) PRIOR TO ANY WORK IN THE RIGHT OF WAY OR EASEMENTS TO LOCATE UTILITIES, AND CONTACT THE OWNER'S REPRESENTATIVE SHOULD PUBLIC UTILITIES APPEAR TO BE IN CONFLICT WITH THE PROPOSED IMPROVEMENTS.
- 17. CURB SHALL BE REMOVED IN A WAY TO PREVENT DAMAGE TO EXISTING PAVEMENT
- 18. THE LOCATION OF CLASS D PATCHING OF VARIOUS TYPES WILL BE DIRECTED BY THE ENGINEER IN THE FIELD PRIOR TO STARTING CONSTRUCTION

- GENERAL NOTES
- 1. ALL EARTHWORK, GRADING, UTILITIES, AND STREET IMPROVEMENTS WORK SHALL BE PERFORMED IN ACCORDANCE WITH THE APRIL 1, 2016 EDITION OF THE ILLINOIS DEPARTMENT OF TRANSPORTATION DIVISION OF HIGHWAY'S STANDARD SPECIFICATIONS FOR ROAD AND BRIDGE CONSTRUCTION, THE STANDARD SPECIFICATIONS FOR WATER AND SEWER MAIN CONSTRUCTION IN ILLINOIS, AND ALL REVISIONS
- 2. THE CONTRACTOR SHALL BE RESPONSIBLE FOR PROVIDING SAFE AND HEALTHFUL WORKING CONDITIONS IN ACCORDANCE WITH SECTION 107 OF THE STANDARD SPECIFICATIONS FOR ROAD AND BRIDGE CONSTRUCTION THROUGHOUT THE CONSTRUCTION OF THE PROPOSED IMPROVEMENTS.
- 3. SOIL EROSION AND SEDIMENTATION CONTROL PRACTICES AND DEVICES SHALL BE IN ACCORDANCE WITH THE LATEST EDITION OF THE URBAN COMMITTEE OF THE ASSOCIATION OF ILLINOIS SOIL AND WATER CONSERVATION DISTRICTS' PROCEDURES AND STANDARDS FOR URBAN SOIL EROSION AND SEDIMENTATION CONTROL IN ILLINOIS AND ALL REVISIONS THERETO AND IN ACCORDANCE WITH THE DETAILS ON THE PLANS.
- 4. THE CONTRACTOR SHALL BE AWARE OF POTENTIAL CONFLICTS WITH EXISTING UTILITIES AS INDICATED ON THE PLANS. THE CONTRACTOR SHALL EXCAVATE AROUND UTILITIES TO DETERMINE ELEVATIONS BEFORE BEGINNING CONSTRUCTION.
- 5. THE CONTRACTOR SHALL BE RESPONSIBLE FOR NOTIFYING EACH OF THE UTILITY COMPANIES BEFORE ANY WORK COMMENCES. ALL UTILITIES SHALL BE STAKED PRIOR TO CONSTRUCTION.
- 6. THE OWNER WILL FURNISH THE CONTRACTOR WITH LINES, GRADES AND ELEVATIONS NECESSARY TO THE PROPER PROSECUTION AND CONTROL OF THE WORK ONCE
- THE CONTRACTOR SHALL GIVE THE ENGINEER AT LEAST SEVENTY-TWO (72) HOURS NOTICE FOR ANY STAKING TO BE DONE. EACH OF THE VARIOUS ITEMS OF WORK COVERED BY THIS CONTRACT WILL BE STAKED ONCE
- 8. THE CONTRACTOR SHALL INFORM THE RESIDENT ENGINEER, CITY ENGINEER, AND THE MUNICIPALITY AT LEAST FORTY-EIGHT (48) HOURS PRIOR TO COMMENCEMENT OF CONSTRUCTION.

TELEPHONE NUMBERS:	TOWNSHIP ENGINEER	- (630) 271-0770
	DOWNERS GROVE TOWNSHIP	. ,
	HIGHWAY DEPARTMENT	- (630) 719-6620

- 9. THE CONTRACTOR RESPONSIBLE FOR DRAINAGE IMPROVEMENTS (UNDERGROUND STRUCTURES AND CONDUITS) SHALL DISPOSE OF ALL SURPLUS EXCAVATED MATERIAL FROM TRENCHES OR STRUCTURE EXCAVATIÓNS AND SHALL DEPOSIT SAID SURPLUS MATERIALS ON THE SITE IN ACCORDANCE WITH THE GRADING PLAN OR AS DIRECTED BY THE ENGINEER.
- 10. THE CONTRACTOR SHALL NOT PLACE ANY EXCAVATED MATERIAL UPON ANY TOPSOIL. THE TOPSOIL SHALL BE REMOVED FROM ALL AREAS TO BE FILLED AND SHALL BE STOCKPILED IN AREAS AS DIRECTED BY THE
- 11. THE CONTRACTOR SHALL NOT DISCHARGE INTO STREAMS, PONDS, WETLANDS OR ITS TRIBUTARIES ANY MOTOR OIL, TRANSMISSION FLUID, LUBRICANTS OR ANY OTHER PETROLEUM DISTILLATES, ANY PETROLEUM DISTILLATES DISCHARGED ON THE GROUND SURFACE SHALL BE PROMPTLY AND PROPERLY REMOVED PRIOR TO THE RESUMPTION OF ANY WORK ON THE PROJECT

TRAFFIC CONTROL AND PROTECTION

- 1. AT THE PRECONSTRUCTION MEETING THE CONTRACTOR SHALL FURNISH THE NAME OF THE INDIVIDUAL IN HIS DIRECT EMPLOY WHO IS TO BE RESPONSIBLE FOR THE INSTALLATION AND MAINTENANCE OF THE TRAFFIC CONTROL FOR THIS PROJECT. IF THE ACTUAL INSTALLATION AND MAINTENANCE ARE TO BE ACCOMPLISHED BY A SUBCONTRACTOR, CONSENT SHALL BE REQUESTED OF THE ENGINEER AT THE TIME OF THE PRECONSTRUCTION MEETING IN ACCORDANCE WITH ARTICLE 108.01 OF THE STANDARD SPECIFICATIONS. THIS SHALL NOT RELEVE THE CONTRACTOR OF THE FOREGOING REQUIREMENT FOR A RESPONSIBLE INDIVIDUAL IN HIS DIRECT EMPLOY TO SUPERVISE THIS WORK.
- 2. THE GOVERNING FACTOR IN THE EXECUTION AND STAGING OF WORK FOR THIS PROJECT IS TO PROVIDE THE MOTORING PUBLIC WITH THE SAFEST POSSIBLE TRAVEL CONDITIONS ALONG THE ROADWAY THROUGH THIS CONSTRUCTION ZONE. THE CONTRACTOR SHALL SO ARRANGE HIS OPERATION AS TO KEEP THE CLOSING OF ANY LANE OF THE ROADWAY TO A MINIMUM.
- 3. THE CONTRACTOR SHALL ENSURE THAT ALL TRAFFIC CONTROL DEVICES INSTALLED BY HM/HER ARE OPERATIONAL 24 HOURS A DAY, INCLUDING SUNDAYS AND HOLIDAYS
- 4. CONTRACTOR VEHICLES SHALL ENTER OR LEAVE WORK AREAS IN A MANNER WHICH WILL NOT BE HAZARDOUS TO, OR WILL NOT INTERFERE WITH, TRAFFIC AND SHALL NOT PARK OR STOP EXCEPT WITHIN DESIGNATED WORK AREAS. PERSONAL VEHICLES SHALL NOT PARK WITHIN THE RIGHT-OF-WAY EXCEPT IN SPECIFIC AREAS DESIGNATED BY THE ENGINEER.
- 5. DELAYS TO THE CONTRACTOR CAUSED BY COMPLYING WITH THESE REQUIREMENTS WILL BE INCLUDED IN THE COST OF THE ITEM FOR TRAFFIC CONTROL AND PROTECTION.
- 6. THE CONTRACTOR SHALL CONTACT THE IDOT TRAFFIC CONTROL SUPERVISOR AT KALPANA.KANNAN-HOSADURGA@ILLINOIS.GOV AT LEAST 72 HOURS IN ADVANCE OF BEGINNING WORK

EXCAVATION

- ALL SITE CLEARING, EXCAVATION, GRADING, COMPACTION, SUBGRADE PREPARATION, BASE COURSE, SURFACE COURSE, PCC CURB AND GUTTER AND SIDEWALKS SHALL BE CONSTRUCTED IN CONFORMANCE WITH THE APPLICABLE SECTIONS OF THE STANDARD SPECIFICATIONS FOR ROAD AND BRIDGE CONSTRUCTION, DEPARTMENT OF TRANSPORTATION, STATE OF ILLINOIS, LATEST
- 2. EARTHWORK UNDER THIS CONTRACT SHALL INCLUDE THE FOLLOWING:
- A. REMOVAL OF EXISTING VEGETATION WITHIN CONSTRUCTION LIMITS FROM THE SITE.
- B. PROTECTION OF CERTAIN TREES AS SHOWN ON PLANS
- C. STRIPPING OF ALL TOPSOIL AND OTHER UNSUITABLE MATERIALS FROM BUILDING AND/OR PAVEMENT AREAS AND REMOVAL FROM SITE OF ALL EXCESS.
- D. COMPLETE REMOVAL AND DISPOSAL OF THE NATURAL GROUND TO THE PROPOSED SUB-GRADE ELEVATION OF NEW PAVEMENT

- EROSION EFFECTS

- GOVERNING MUNICIPALITY.
- TOWNSHIP

280001-07	TEN
442201-03	CLA
701301–04	LAN
701311-03	LAN
701501-06	URE
701801-06	SID
701901–08	TRA
780001-05	TYF

	USER NAME =	DESIGNED - EF	REVISED - 7/10/2020						
ŀ		DRAWN - CJS	REVISED -	STATE OF ILLINOIS	GENERAL NOT				
	PLOT SCALE =	CHECKED - AS	REVISED -	DEPARTMENT OF TRANSPORTATION	CLARENDON HILLS ROAD - 91ST S				
	PLOT DATE = Nov 13, 2020	DATE -	REVISED -		SCALE: –	SHEET NO. 1 OF 1 SHEETS S			

SOIL EROSION AND SEDIMENTATION CONTROL NOTES

THE FOLLOWING PRINCIPLES SHALL APPLY TO ALL MOVEMENT OF EARTH AND STORM DRAINAGE. SEDIMENT AND EROSION CONTROL DEVICES SHALL BE FUNCTIONAL BEFORE LAND IS OTHERWISE DISTURBED ON SITE.

2. THE SMALLEST PRACTICAL AREA OF LAND IS TO BE EXPOSED AT ANY GIVEN TIME DURING CONSTRUCTION. EXPOSURE SHALL BE KEPT TO AS SHORT A DURATION OF TIME AS IS PRACTICAL.

3 STABILIZE AND PROTECT DISTURBED AREAS, SOIL DISTURBANCE SHALL BE CONDUCTED IN SUCH A MANNER AS TO MINIMIZE EROSION. SOIL STABILIZATION MEASURES SHALL CONSIDER THE TIME OF YEAR, SITE CONDITIONS, AND THE USE OF TEMPORARY OR PERMANENT MEASURES. MECHANICAL, STRUCTURAL AND/OR VEGETATIVE CONTROL METHODS SHALL BE USED IN ORDER TO RETARD SOIL EROSION IF DIRECTED BY THE OWNER OR HIS AUTHORIZED REPRESENTATIVE.

4. KEEP RUN-OFF VELOCITIES LOW WITH SHORT SLOPES AND LOW GRADIENTS. THE INSTALLATION OF NATURAL VEGETATIVE COVER HELPS TO KEEP STORM WATER VELOCITIES LOW, AND THUS LIMIT SOIL

5 PROTECT DISTURBED AREAS FROM STORM WATER RUN-OFF, SOIL EROSION AND SEDIMENT CONTROL FEATURES SHALL BE CONSTRUCTED PRIOR TO THE COMMENCEMENT OF UPLAND DISTURBANCE PROTECTIVE MEASURES SHALL BE UTILIZED TO DIVERT RUN-OFF FROM DISTURBED AREAS.

6. ALL TEMPORARY EROSION AND SEDIMENT CONTROL MEASURES SHALL BE REMOVED WITHIN 30 DAYS AFTER FINAL SITE STABILIZATION IS ACHIEVED OR AFTER THE TEMPORARY MEASURES ARE NO LONGER NEEDED. TRAPPED SEDIMENT AND OTHER DISTURBED SOIL AREAS SHALL BE PERMANENTLY STABILIZED.

7 NATURAL PLANT COVER SHALL BE MAINTAINED AND PROTECTED AND ALL TEMPORARY AND PERMANENT EROSION CONTROL MEASURES SHALL BE MAINTAINED AND REPAIRED AS NEEDED. THE GENERAL CONTRACTOR WILL BE RESPONSIBLE FOR INSPECTION AND REPAIR DURING CONSTRUCTION.

8. PROTECTION OF EXISTING FACILITIES AND UTILITIES - THE CONTRACTOR SHALL PROVIDE AND MAINTAIN ALL NECESSARY FACILITIES FOR THE PROTECTION OF ALL EXISTING UTILITIES ON OR ADJACENT TO THE PROJECT. ALL STORM SEWER FACILITIES THAT ARE OR WILL BE FUNCTIONING DURING CONSTRUCTION SHALL BE PROTECTED, FILTERED, OR OTHERWISE TREATED TO REMOVE SEDIMENT. FURTHERMORE, ANY DAMAGE DONE BY HIM, HIS AGENTS, OR ASSIGNS SHALL BE REPAIRED AT NO ADDITIONAL COMPENSATION.

9. DIRT ON PAVEMENT - WHERE A CONTRACTOR'S EQUIPMENT IS OPERATED UPON AN EXISTING PAVEMENT USED BY TRAFFIC THE CONTRACTOR SHALL CLEAN THE PAVEMENT OF ALL DIRT AND DEBRIS AT THE END OF EACH DAY'S OPERATIONS AND AT OTHER TIMES AS DIRECTED BY THE OWNER, THE ENGINEER, OR THE

10. DUST CONTROL - THE CONTRACTOR SHALL BE RESPONSIBLE FOR THE CONTROL OF EXCESSIVE DUST DURING THE CONSTRUCTION PERIOD UNTIL PROPOSED IMPROVEMENTS COMPLETED. THE REQUIREMENT FOR DUST CONTROL SHALL BE AS DIRECTED BY THE LOCAL APPROVING AUTHORITIES OR THE ENGINEER.

11. THE EROSION CONTROL MEASURES INDICATED ON THE PLANS ARE THE MINIMUM REQUIREMENTS. ADDITIONAL MEASURES MAY BE REQUIRED, AS DIRECTED BY THE ENGINEER OR DOWNERS GROVE

12. THE CONTRACTOR SHALL MAKE AN EFFORT TO MINIMIZE USE OF HEAVY EQUIPMENT WITHIN THE DESIGNATED DRAINAGE FACILITIES.

LIST OF ILLINOIS DOT HIGHWAY STANDARDS

MPORARY EROSION CONTROL SYSTEMS ASS C AND D PATCHES NE CLOSURE, 2L, 2W. SHORT TIME OPERATIONS NE CLOSURE 2L, 2W MOVING OPERATIONS - DAY ONLY BAN LANE CLOSURE, 2L, 2W, UNDIVIDED EWALK CORNER OR CROSSWALK CLOSURE AFFIC CONTROL DEVICES PICAL PAVEMENT MARKINGS **D1 STANDARD DETAILS**

TYPICAL PAVEMENT MARKINGS

DTES STREET TO 79TH STREET		F.A.U. RTE.	SECTION	COUNTY	TOTAL SHEETS	SHEET NO.		
		2663	19-03126-00-RS	DUPAGE	14	2		
				CONTRACT	NO. 6	1G59		
	STA.	TO STA.		ILLINOIS FED. AID PROJECT 804V(658)				


			CONSTRUCTION
	SUMMARY OF QUANTITIES		CODE
	SUMMART OF QUANTITIES		0005
CODE NO.	ITEM DESCRIPTION	UNIT TOTAL	SUBTOTAL
	TUMINOUS MATERIALS (TACK COAT)	POUND 17781	
40603200 PC	OLYMERIZED HMA BINDER COURSE, IL-4.75, N50	TON 1216	1216
40000000111	DT-MIX ASPHALT SURFACE REMOVAL - BUTT JOINT	SQ YD 360	360
40000962 HL	JI-WIK ASPHALT SURFACE REMOVAL - BUTT JOINT	3010 300	300
40604062 Hr	DT-MIX ASPHALT SURFACE COURSE, IL-9.5, MIX "D", N70	TON 2213	2213
		0.010 100	
42300100 PC	ORTLAND CEMENT CONCRETE DRIVEWAY PAVEMENT - 5"	SQ YD 186	186
44000200 D'	RVEWAY PAVEMENT REMOVAL	SQ YD 1004	1004
44000159 HM	MA SURFACE REMOVAL, 2.5"	SQ YD 583	583
44201713 C	ASS D PATCHES, TYPE I, 6 INCH	SQ YD 184	184
44201713 01			104
44201717 CI	ASS D PATCHES, TYPE II, 6 INCH	SQ YD 919	919
44201721 [C]	ASS D PATCHES, TYPE III, 6 INCH	SQ YD 735	735
44300100 AF	REA REFLECTIVE CRACK CONTROL TREATMENT	SQ YD 21699	21699
48203100 HC	DT-MIX ASPHALT SHOULDERS	TON 390	390
60300105 FI	RAMES AND GRATES TO BE ADJUSTED	EACH 4	4
67100100 M	OBILIZATION	LSUM 1	1
70102520 T	AFFIC CONTROL AND PROTECTION, STANDARD 701501	L SUM 1	1
70102020 16	WEEK CONTROLAND FROTECTION, STANDARD 101301		
70102640 TF	RAFFIC CONTROL AND PROTECTION, STANDARD 701801	L SUM 1	1
70300100 SH	HORT TERM PAVEMENT MARKING	FOOT 7360	7360
70300150 SI	HORT TERM PAVEMENT MARKING REMOVAL	SQ FT 2453	2453
- 78000200 TH	ERMOPLASTIC PAVEMENT MARKING - LINE 4"	FOOT 17090	17090
+ 78000600 TE	IERMOPLASTIC PAVEMENT MARKING - LINE 12"	FOOT 78	78
7800000 11			,,,,,,,,,,,,,,,,,,,,,,,,,,,,,,,,,,,,,,,
XX006215 BF	RICK PAVER REMOVAL AND REPLACEMENT	SQ YD 38	38
7000454011	A DRIVEWAY PAVEMENT 5"	SQ YD 911	911
			911
X4401198 Hr	A SURFACE REMOVAL, VARIABLE DEPTH	SQ YD 214	214
Z0030850 TE	MPORARY INFORMATION SIGNING	SQ FT 50	50
· DENOTES SPE			

r JATE. Nov 17, 2020 NAME: HV18-TP/3009 - Clarendon Hills Road Inprovenents/Plans/Rev-3/18-TP-3009-SITE 2020-11-02.deg

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	USER NAME =	DESIGNED - EF DRAWN - CJS	REVISED - 7/10/2020 REVISED -	STATE OF ILLINOIS DEPARTMENT OF TRANSPORTATION	SUMMARY OF QUANTITIE CLARENDON HILLS ROAD - 91ST STREET				
ſ	PLOT SCALE =	CHECKED - AS	REVISÉD -		CLAREN	JON HILLS ROAD - 9	91515	IREEI	
	PLOT DATE = Nov 17, 2020	DATE -	REVISED -		SCALE: –	SHEET NO. 1 OF 1 SH	SHEETS	STA.	


ΓIES	F.A.U. RTE.	SECTION	COUNTY	TOTAL SHEET SHEETS NO.
ET TO 79TH STREET	2663	19-03126-00-RS	DUPAGE CONTRACT	14 3 NO. 61G59
TO STA.		ILLINOIS FED.	AID PROJECT 804	/(658)

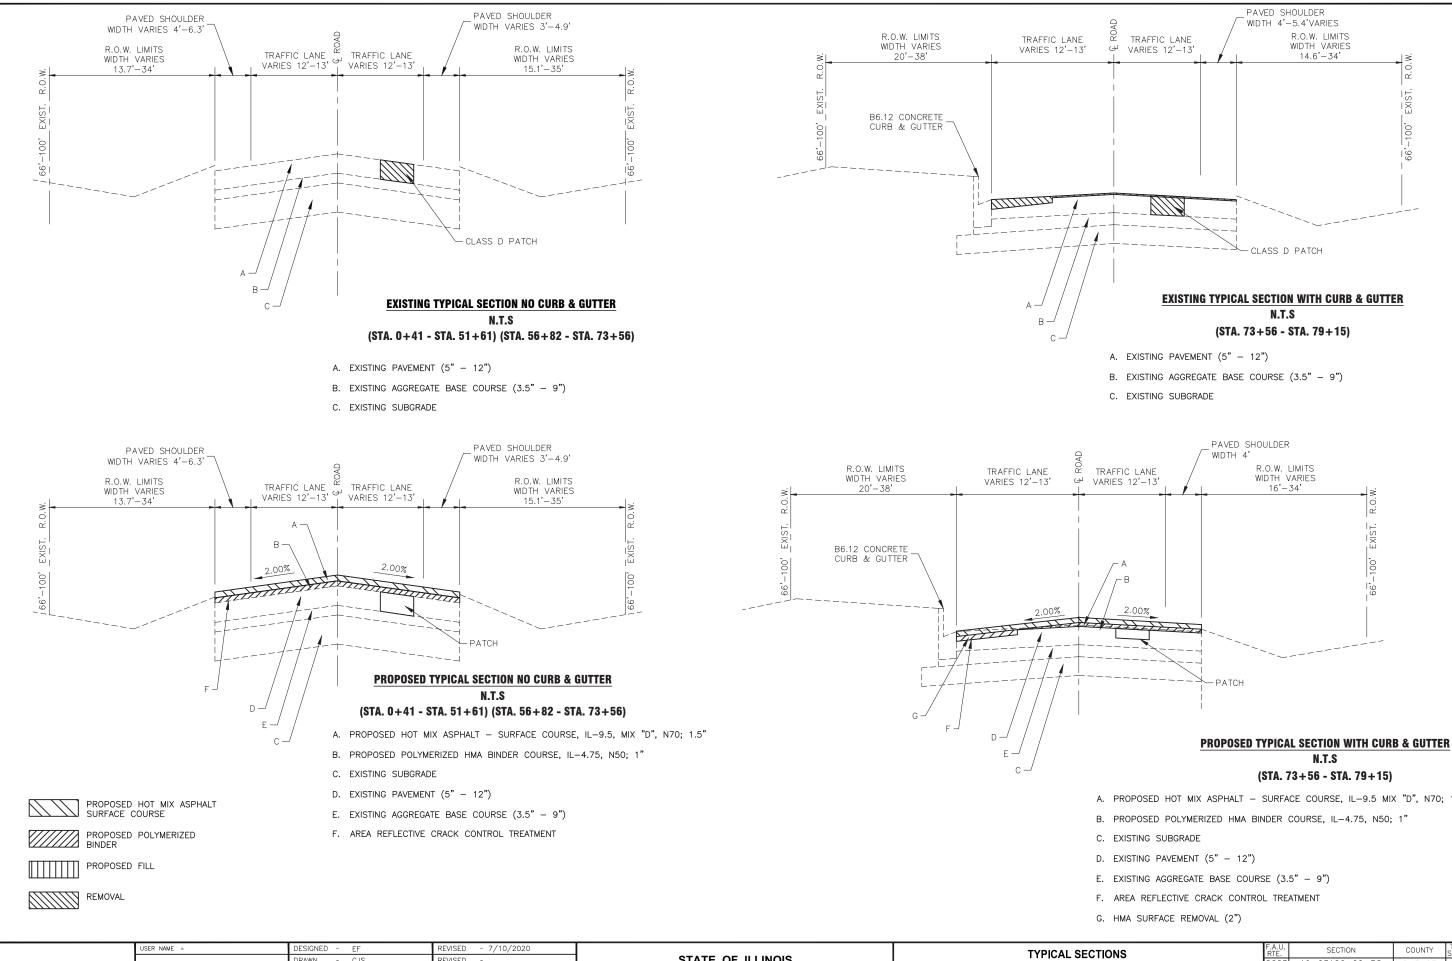


STATE OF ILLINOIS REVISED RAWN CJS **CLARENDON HILLS ROAD - 91ST S** DEPARTMENT OF TRANSPORTATION PLOT SCALE = CHECKED - AS REVISED PLOT DATE = Nov 17, 2020 DATE REVISED SCALE: N.T.S. SHEET NO. 1 OF 2 SHEETS

A. PROPOSED HOT MIX ASPHALT - SURFACE COURSE, IL-9.5 MIX "D", N70; 1.5"

TIONS STREET TO 79TH STREET		F.A.U. RTE.	SECT	ΓION	COUNTY	TOTAL SHEETS	SHEET NO.
		2663	19-03126	5-00-RS	DUPAGE	14	4
					CONTRACT	NO. 6	1G59
STA.	TO STA.			ILLINOIS FED.	AID PROJECT 804V	(658)	

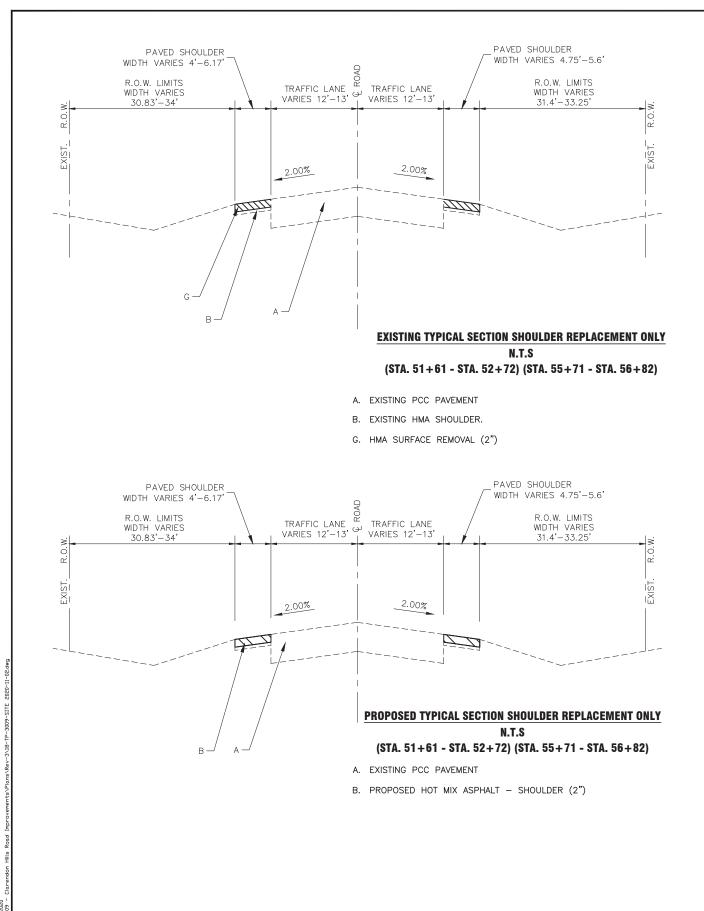

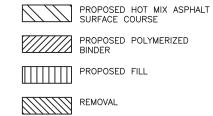


HMA DRIVEWAY	HMA SURFACE, MIX "D", N50, (IL-9.5mm) 2"	4% @ 50 Gyr	
PAVEMENT 5"	HMA BINDER COURSE, 3"	4% @ 50 Gyr	LIFT THICKNESS
PATCHING	CLASS D PATCH HMA BINDER COURSE, IL-19	4% @ 70 Gyr	
PAVEMENT & SHOULDER	HMA SURFACE COURSE, MIX "D", N70, (IL-9.5mm)	4% @ 70 Gyr	1.5"
RESURFACING	POLYMERIZED HMA BINDER COURSE, IL-4.75, N50	3.5% @ 50 Gyr	1" MAX.
HMA SHOULDER	HMA SURFACE COURSE, MIX "D", N70, (IL-9.5mm)	4% @ 70 Gyr	2"

THE UNIT WEIGHT USED TO CALCULATE ALL HMA SURFACE MIXTURE QUANTITIES IS 112 LBS/SQ YD/IN.

FOR USE OF RECYCLED MATERIALS, SEE SPECIAL PROVISIONS.

USER NAME =	DESIGNED - EF	REVISED - 7/10/2020		TYPICAL SECTIONS	F.A.U. SECTION COUNTY TOTAL SHEET
	DRAWN - CJS	REVISED -	STATE OF ILLINOIS		2663 19-03126-00-RS DUPAGE 14 5
PLOT SCALE =	CHECKED - AS	REVISED -	DEPARTMENT OF TRANSPORTATION	CLARENDON HILLS ROAD - 91ST STREET TO 79TH STREET	CONTRACT NO. 61G59
PLOT DATE = Nov 17, 2020	DATE -	REVISED -		SCALE: N.T.S. SHEET NO. 2 OF 2 SHEETS STA. TO STA.	ILLINOIS FED. AID PROJECT 804V(658)

THE "AC TYPE" FOR POLYMERIZED HMA MIXES SHALL BE "SBS/SBR PG 76-22" AND FOR NON-POLYMERIZED HMA THE "AC TYPE" SHALL BE "PG 64-22" UNLESS MODIFIED BY SPECIAL PROVISIONS.

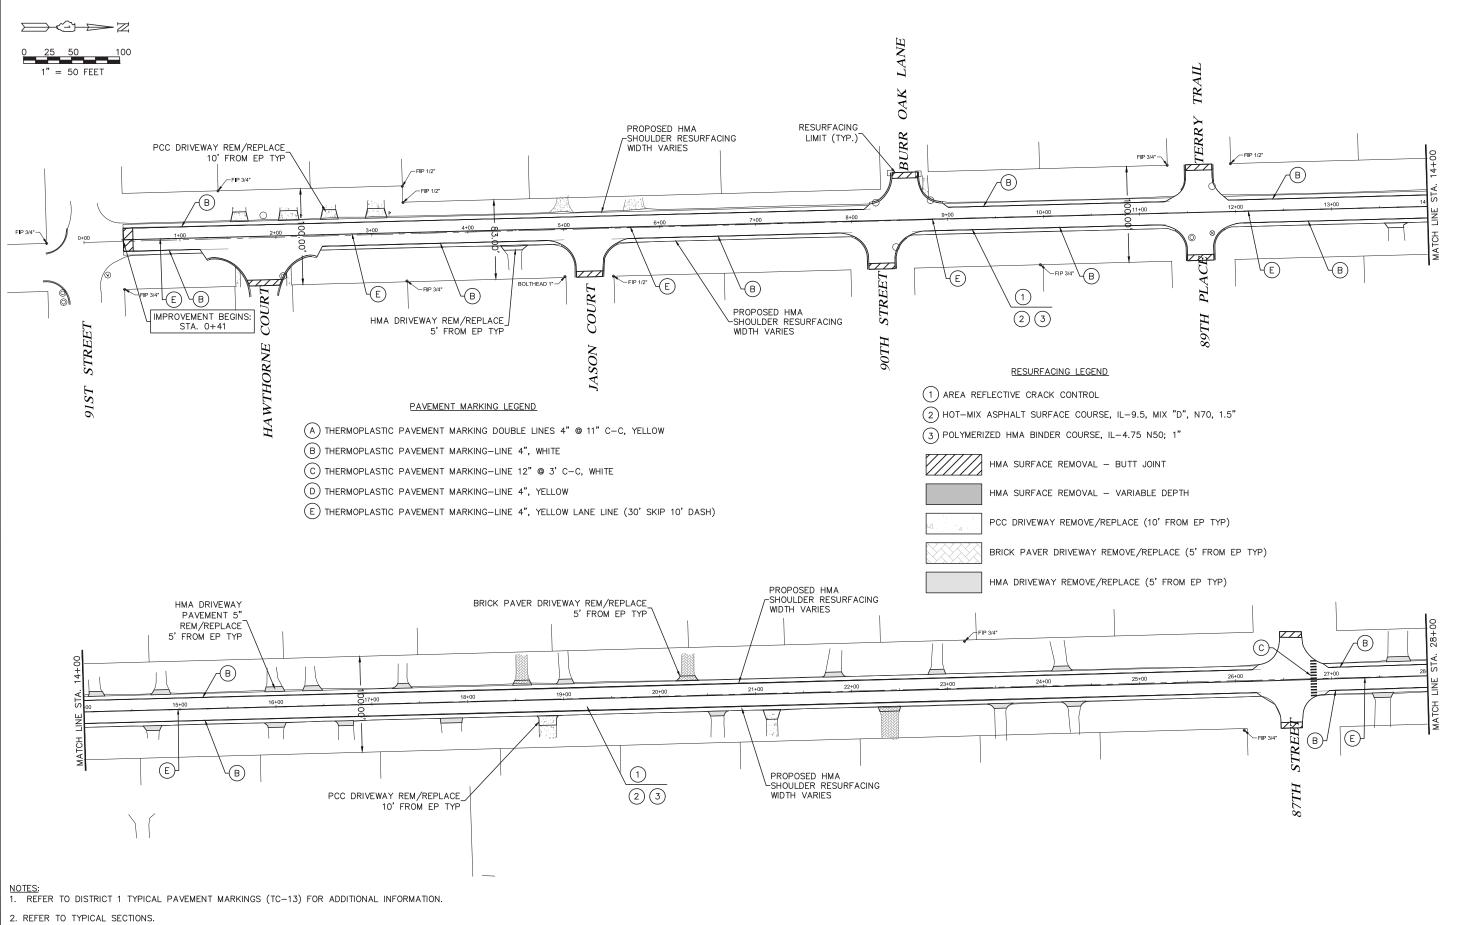

USER NAME =	DESIGNED - EF	REVISED - 7/10/2020		ROADWAY AND PAVEMENT MARKING PLANS - CLARENDON HILLS RD.
	DRAWN - CJS	REVISED -	STATE OF ILLINOIS	2
PLOT SCALE =	CHECKED - AS	REVISED -	DEPARTMENT OF TRANSPORTATION	CLARENDON HILLS ROAD - 91ST STREET TO 79TH STREET
PLOT DATE = Nov 17, 2020	DATE -	REVISED -		SCALE: 1"=50' SHEET NO. 1 OF 3 SHEETS STA. 0+00 TO STA. 28+00

SECTION

19-03126-00-RS

COUNTY


ILLINOIS FED. AID PROJECT 804V(658)

DUPAGE 14 6

CONTRACT NO. 61G59



1" = 50 FEET

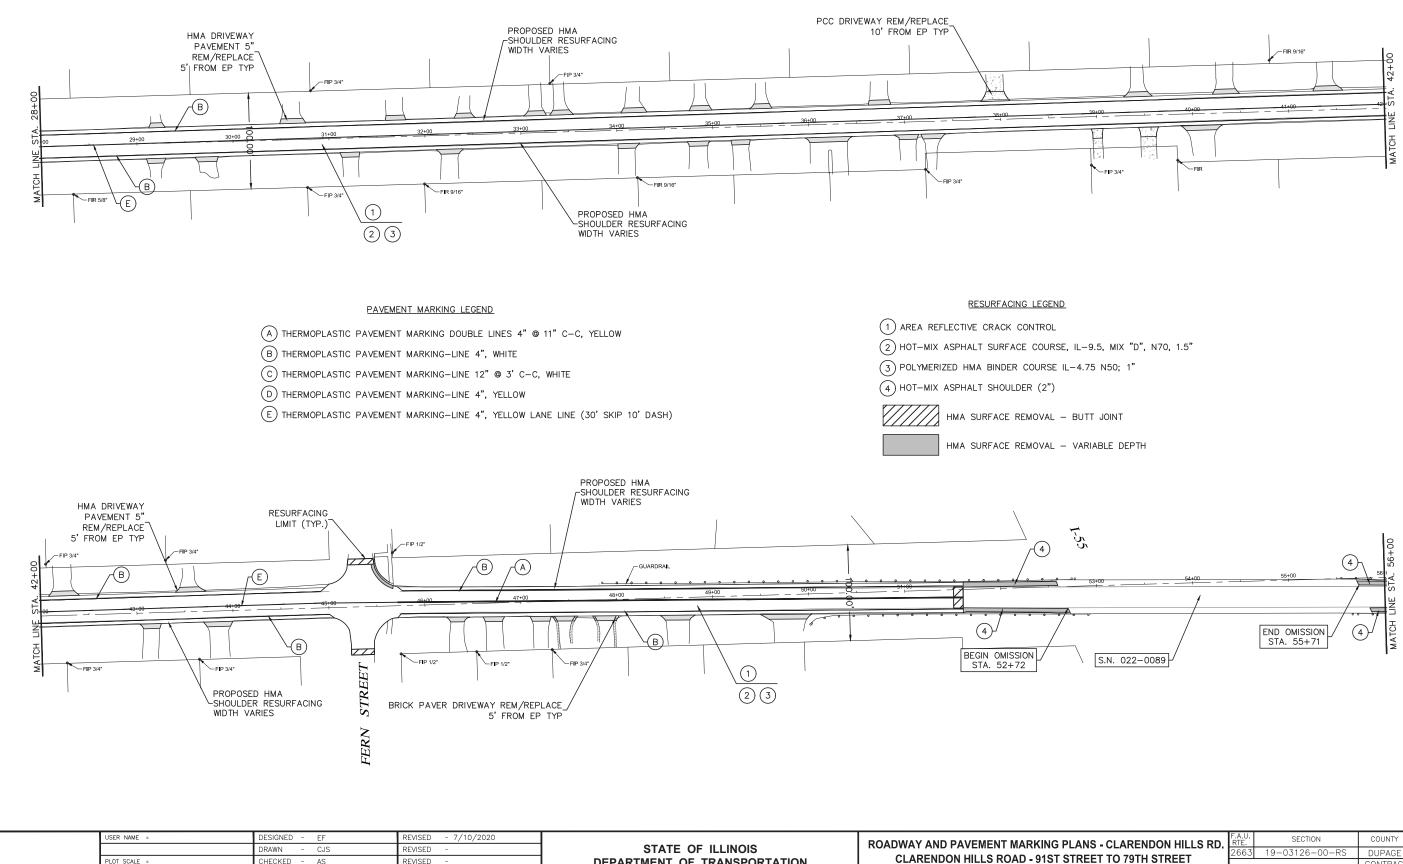

DEPARTMENT OF TRANSPORTATION

PLOT SCALE =

PLOT DATE = Nov 17, 2020

CHECKED - AS

DATE


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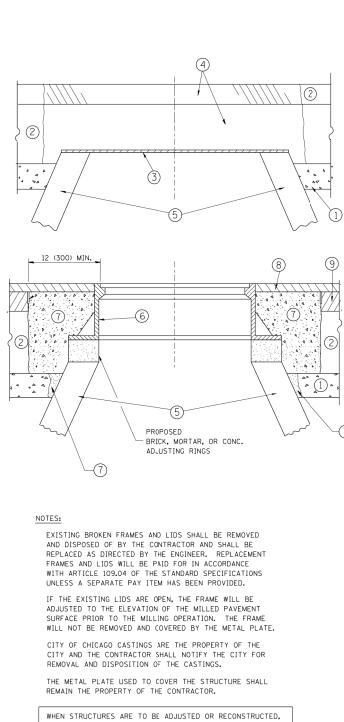
ROADWAY AN	D PAVEMENT MARKING F	PLANS - CLAR		HILLS RD.	F.A.U. RTE.	SECTION	COUNTY	TOTAL SHEETS	SHEET NO.
	DON HILLS ROAD - 91ST S				2663	19-03126-00-RS	DUPAGE	14	7
	DON HILLS ROAD - 9151 3	SIREET TO 79	INSIKE				CONTRACT	NO. 6	1G59
SCALE: 1"=50'	SHEET NO. 2 OF 3 SHEETS	STA. 28+00	TO STA.	56+00		ILLINOIS FED. AI	D PROJECT 804V	(658)	



1" = 50 FEET



PLANS - CLARENDON HILLS RD.				III I S RD.	F.A.U. RTE.	SECTION	COUNTY	TOTAL SHEETS	SHEET NO.
					2663	19-03126-00-RS	DUPAGE	14	8
STREET TO 79TH STREET					CONTRACT	NO. 6	1G59		
	STA.	56+00	TO STA.	79+15	ILLINOIS FED. AID PROJECT 804V(658)				

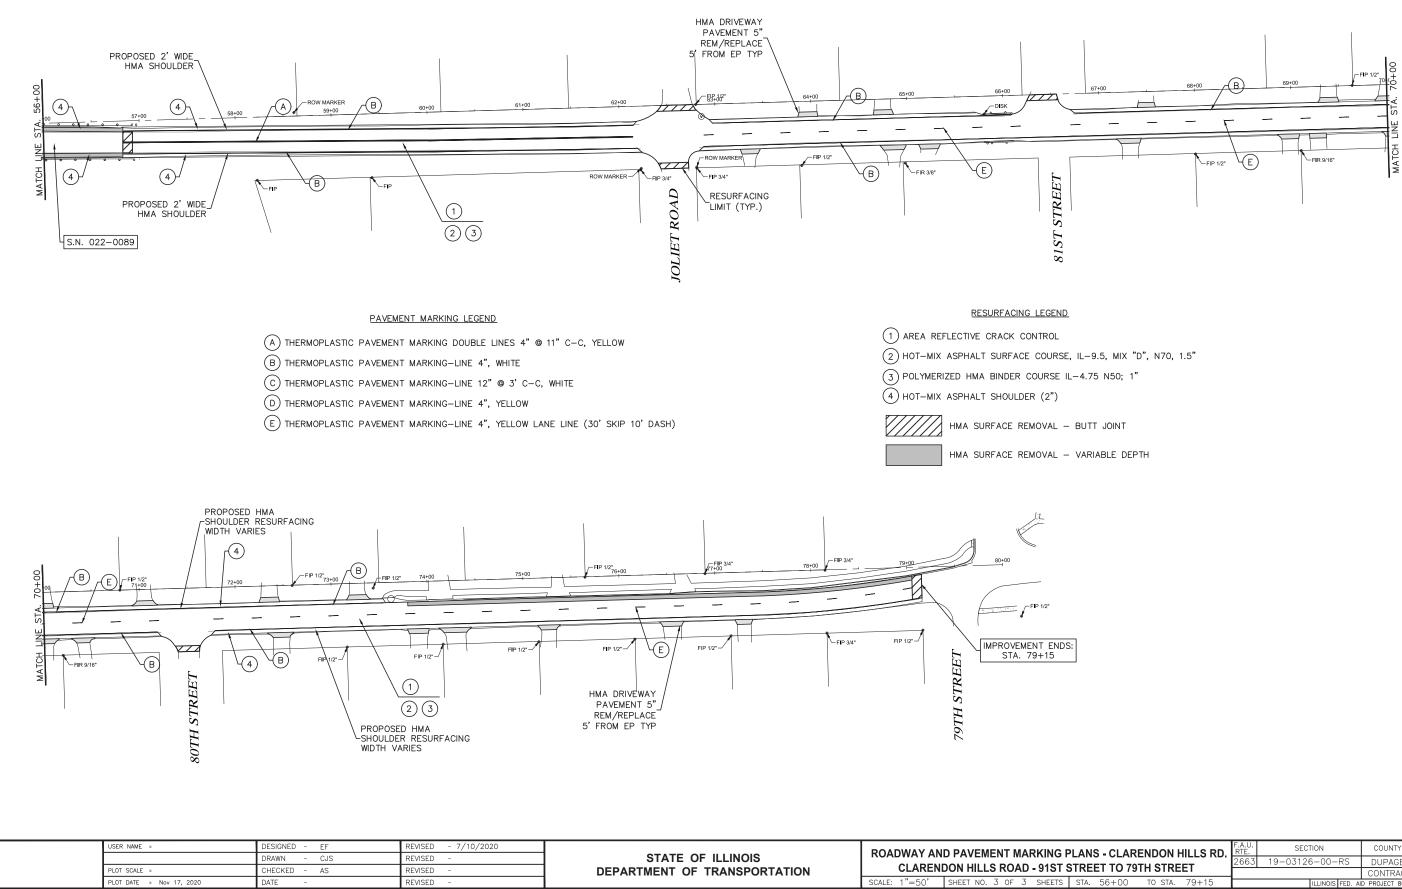

THE LOWERING AND RAISING OF THE FRAMES AND LIDS WILL NOT BE PAID FOR SEPARATELY BUT WILL BE INCLUDED IN THE

WITH MILLING

COST OF THE CORRESPONDING PAY ITEM.

FILE NAME =	USER NAME = bauerdl	DESIGNED - R. SHAH	REVISED - R. WIEDEMAN 05-14-04			DETAILS FOR	F.A.U. SECTION	COUNTY TOTAL SHEET
c:\pw_work\pwidot\bauerdl\d0108315\bd08.	lgn	DRAWN -	REVISED - R. BORO 01-01-07	STATE OF ILLINOIS			2663 19-03126-10-RS	DUPAGE 14 9
	PLOT SCALE = 1968.5000 ′ / m	CHECKED -	REVISED - R. BORO 03-09-11	DEPARTMENT OF TRANSPORTATION		FRAMES AND LIDS ADJUSTMENT WITH MILLING	BD600-03 (BD-8)	CONTRACT NO. 61G59
	PLOT DATE = 12/6/2011	DATE - 10-25-94	REVISED - R. BORO 12-06-11		SCALE: NONE	SHEET NO. 1 OF 1 SHEETS STA. TO STA.	FED. ROAD DIST. NO. 1 ILLINOIS FE	D. AID PROJECT 804V(658)

CONSTRUCTION PROCEDURES

STAGE 1 (BEFORE PAVEMENT MILLING)

- A) REMOVE A MINIMUM OF 12 (300) OF THE PAVEMENT FROM AROUND THE STRUCTURE. B) REMOVE THE EXISTING FRAME AND LID FROM THE STRUCTURE.
- C) COVER THE STRUCTURE OPENING WITH A 36 (900) DIAMETER METAL PLATE. D) BACKFILL WITH CRUSHED STONE AND A MINIMUM $1\frac{1}{2}$ (40)
- THICK HMA SURFACE MIX APPROVED BY THE ENGINEER.
- STAGE 2 (AFTER PAVEMENT MILLING)
 - A) REMOVE THE HMA SURFACE MIX AND CRUSHED STONE.
 - B) INSTALL THE FRAME AND LID; ADJUST THE FRAME TO ITS FINAL SURFACE ELEVATION.
 - C) THE SURROUNDING SPACE SHALL BE FILLED WITH CLASS PP-1* CONCRETE TO THE ELEVATION OF THE SURFACE OF THE EXISTING BASE COURSE OR THE BINDER COURSE.
 - * UNLESS OTHERWISE SPECIFIED IN THE PLANS.

THE PROCEDURE EXPLAINED ABOVE SHALL CONFORM TO THE APPLICABLE PORTIONS OF SECTIONS 353, 406, 602, AND 603 OF THE STANDARD SPECIFICATIONS EXCEPT THAT "THE CONTRACTOR SHALL ADJUST THE STRUCTURES TO THE FINISHED PAVEMENT ELEVATION NO MORE THAN 5 CALENDAR DAYS PRIOR TO PLACEMENT OF THE FINAL LIFT OF SURFACE UNLESS APPROVED BY THE ENGINEER."

LEGEND

1	SUB-BASE GRANULAR MATERIAL	6 FRAME AND LID (SEE NOTES)
2	EXISTING PAVEMENT	CLASS PP-1* CONCRETE
3	36 (900) DIAMETER METAL PLATE	(8) PROPOSED HMA SURFACE COURSE
4	PROPOSED CRUSHED STONE AND HMA SURFACE MIX	<u> </u>
(5)	EXISTING STRUCTURE	9 PROPOSED HMA BINDER COURSE

LOCATION OF STRUCTURES:

THE CONTRACTOR WILL BE REQUIRED TO KEEP A RECORD OF THE LOCATIONS OF THE BURIED STRUCTURES ACCORDING TO THE STATION AND DISTANCE LEFT OR RIGHT OF THE CENTERLINE OF PAVEMENT. UPON COMPLETION OF THE WORK, THE CONTRACTOR WILL DELIVER THE RECORD TO THE ENGINEER.

BASIS OF PAYMENT:


REMOVING FRAMES AND LIDS ON DRAINAGE AND UTILITY STRUCTURES IN THE PAVEMENT PRIOR TO MILLING, AND ADJUSTING TO FINAL GRADE PRIOR TO PLACING THE SURFACE COURSE, WILL BE PAID FOR AT THE CONTRACT UNIT PRICE EACH FOR "FRAMES AND LIDS TO BE ADJUSTED (SPECIAL)."

THIS WORK WILL NOT BE PAID FOR WHEN DRAINAGE AND UTILITY STRUCTURES ARE SPECIFIED FOR PAYMENT AS STRUCTURE RECONSTRUCTION.

NEW FRAMES AND LIDS, WHEN SPECIFIED, WILL BE PAID FOR SEPARATELY.

DETAILS FOR FRAMES AND LIDS ADJUSTMENT

ALL DI	MENSIONS	ARE	ΙN	INCHES	(MILLIMETERS)	UNLESS	OTHERWISE	SHOWN	
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FILE NAME =	USER NAME = bauerdl	DESIGNED - R. SHAH	REVISED - A. ABBAS 04-27-98		DAVEMEN	T PATCHING FOR	F.A.U. SECTION	COUNTY TOTAL SHEET
c:\projects\diststd22x34\bd22.dgn		DRAWN -	REVISED - R. BORO 01-01-07	STATE OF ILLINOIS			2663 19-03126-10-RS	DUPAGE 14 10
	PLOT SCALE = 50.000 '/ IN.	CHECKED -	REVISED - R. BORO 09-04-07	DEPARTMENT OF TRANSPORTATION			BD400–04 (BD–22)	CONTRACT NO. 61G59
	PLOT DATE = 10/27/2008	DATE - 10-25-94	REVISED - K. ENG 10-27-08		SCALE: NONE SHEET NO. 1 OF 1	SHEETS STA. TO STA.		AID PROJECT 804V(658)

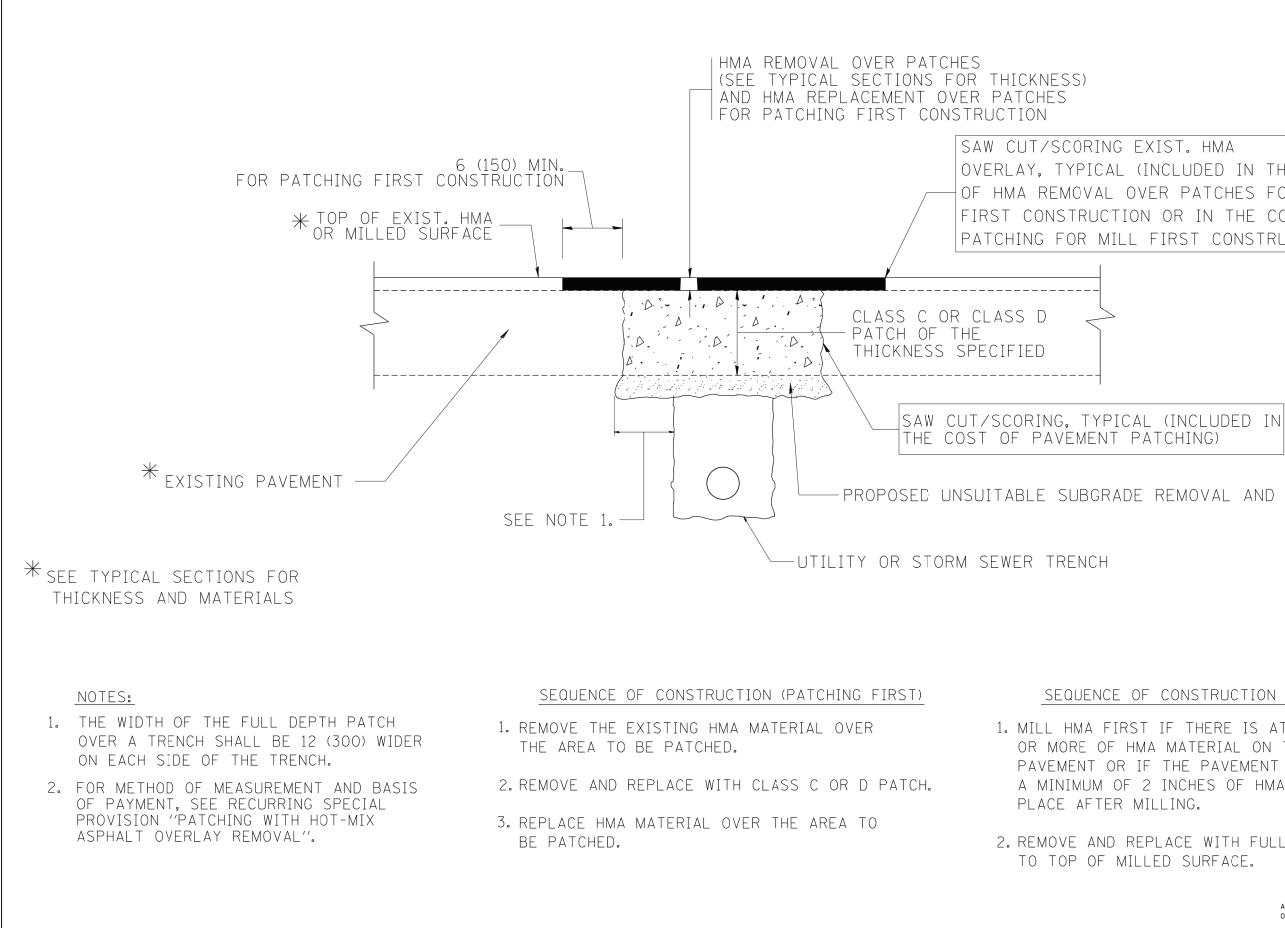OVERLAY. TYPICAL (INCLUDED IN THE COST OF HMA REMOVAL OVER PATCHES FOR PATCHING FIRST CONSTRUCTION OR IN THE COST OF PAVEMENT PATCHING FOR MILL FIRST CONSTRUCTION).


PROPOSED UNSUITABLE SUBGRADE REMOVAL AND REPLACEMENT

SEQUENCE OF CONSTRUCTION (MILLING FIRST)

1. MILL HMA FIRST IF THERE IS AT LEAST $4\frac{1}{2}$ INCHES OR MORE OF HMA MATERIAL ON TOP OF THE EXISTING PAVEMENT OR IF THE PAVEMENT IS FULL DEPTH HMA. A MINIMUM OF 2 INCHES OF HMA MATERIAL SHALL BE IN


2. REMOVE AND REPLACE WITH FULL DEPTH CLASS D PATCHES TO TOP OF MILLED SURFACE.

> ALL DIMENSIONS ARE IN INCHES (MILLIMETERS) UNLESS OTHERWISE SHOWN.

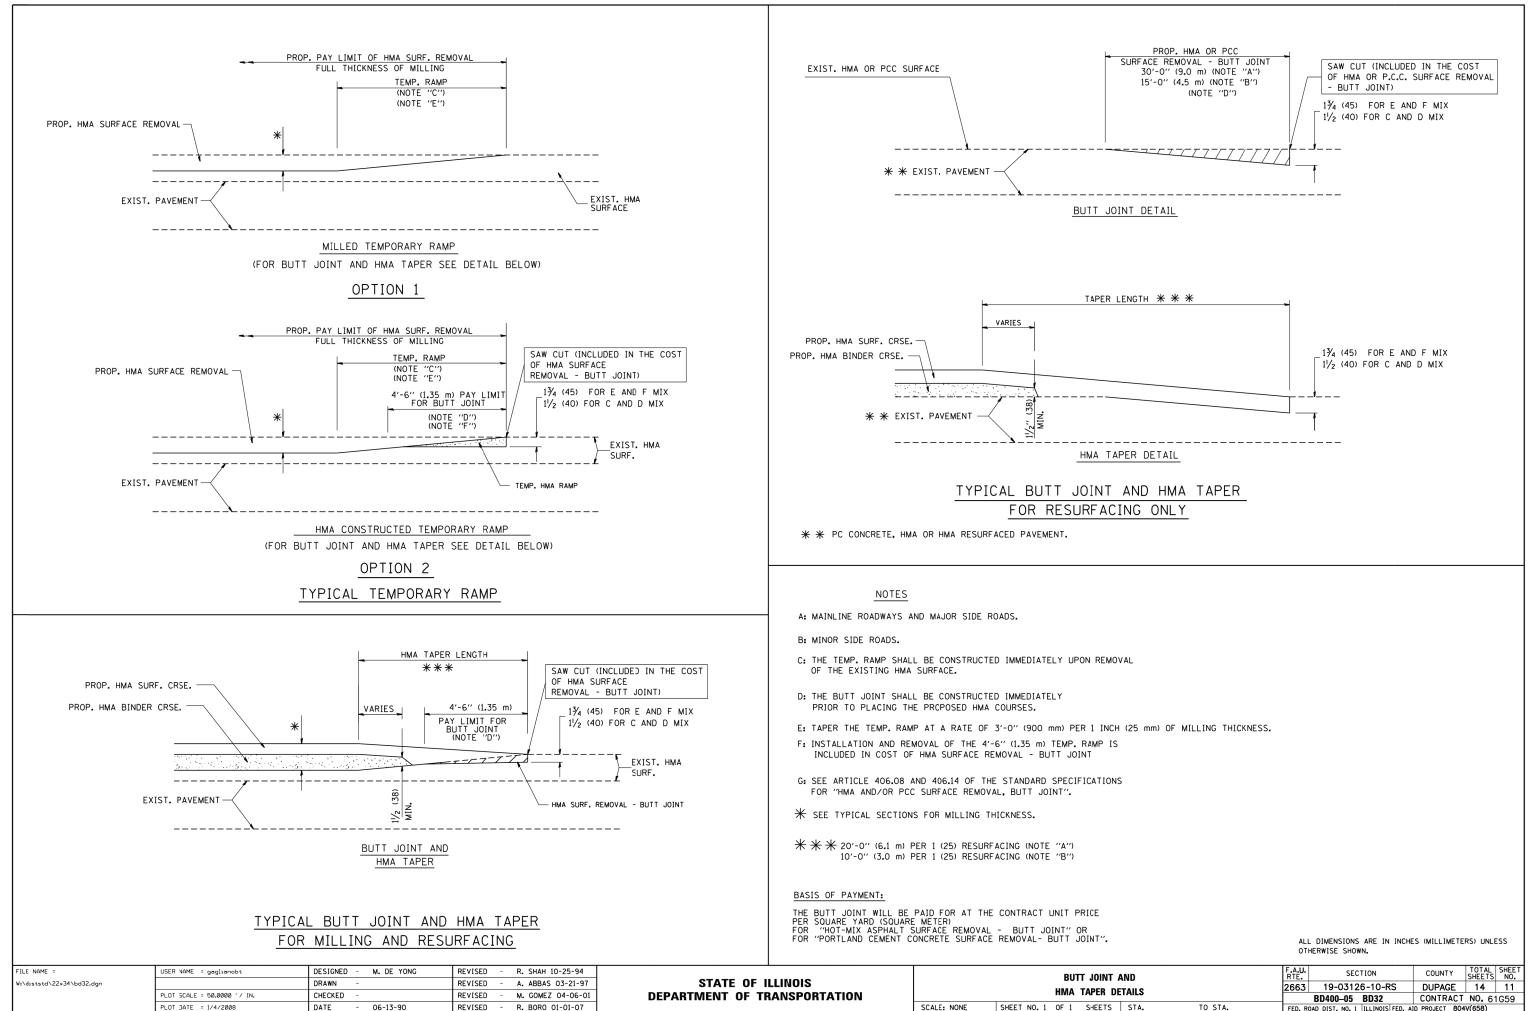

AND DETAILS		F.A.U. RTE. SECTION				SHEET NO.
		19-03126-10-RS		DUPAGE	14	11
		BD400-05	BD32	CONTRACT	NO. 6'	IG59
STA. TO STA.	FED. R	DAD DIST. NO. 1	ILLINOIS FED. A	D PROJECT 804	V(658)	

FILE NAME =	USER NAME = gaglianobt	DESIGNED - LHA	REVISED - J. OBERLE 10-18-95			TRAFFIC CONTROL AND PRO		F.A.U. SEC	CTION	COUNTY TO	OTAL SHEET
W:\diststd\22x34\tc10.dgn		DRAWN -	REVISED - A. HOUSEH 03-06-96	STATE OF ILLINOIS				2663 19-0312	26-10-RS	DUPAGE 1	14 12
	PLOT SCALE = 50.000 ' / IN.	CHECKED -	REVISED - A. HOUSEH 10-15-96	DEPARTMENT OF TRANSPORTATION		SIDE ROADS, INTERSECTIONS, A	AND DRIVEWAYS	TC-1		CONTRACT NO	0.61659
	PLOT DATE = 1/4/2008	DATE - 06-89	REVISED -T. RAMMACHER 01-06-00		SCALE: NONE	SHEET NO. 1 OF 1 SHEETS	STA. TO STA.			ID PROJECT 804V(65	

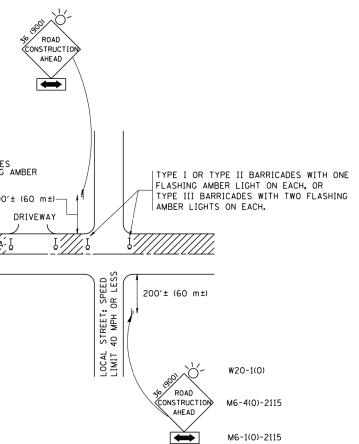


SIDE ROADS, INTERSECTIONS, AND DRIVEWAYS

B. FOR A LANE CLOSURE ON A SIDE ROAD OR DRIVEWAY:
USE APPLICABLE PORTIONS OF THE TYPICAL APPLICATION OF TRAFFIC
CONTROL DEVICES (STD. 701501, STD. 701606 OR THE APPROPRIATE STANDARD).
THE SPACING OF SIGNS AND BARRICADES SHALL BE ADJUSTED FOR FIELD
CONDITIONS AS DIRECTED BY THE ENGINEER. THE DIRECTIONAL ARROW
SHALL BE COVERED OR REMOVED WHEN NO LONGER CONSISTENT WITH THE
SIDE ROAD LANE CLOSURE.

- C. ADVANCE WARNING SIGNS ARE TO BE OMITTED ON DRIVEWAY UNLESS OTHERWISE NOTED.
- D. THE TRAFFIC CONTROL AND PROTECTION FOR SIDE ROADS, INTERSECTIONS, AND DRIVEWAYS SHALL BE INCIDENTAL TO THE COST OF SPECIFIED TRAFFIC CONTROL STANDARDS OR ITEMS.

All dimensions are in millimeters (inches) unless otherwise shown.

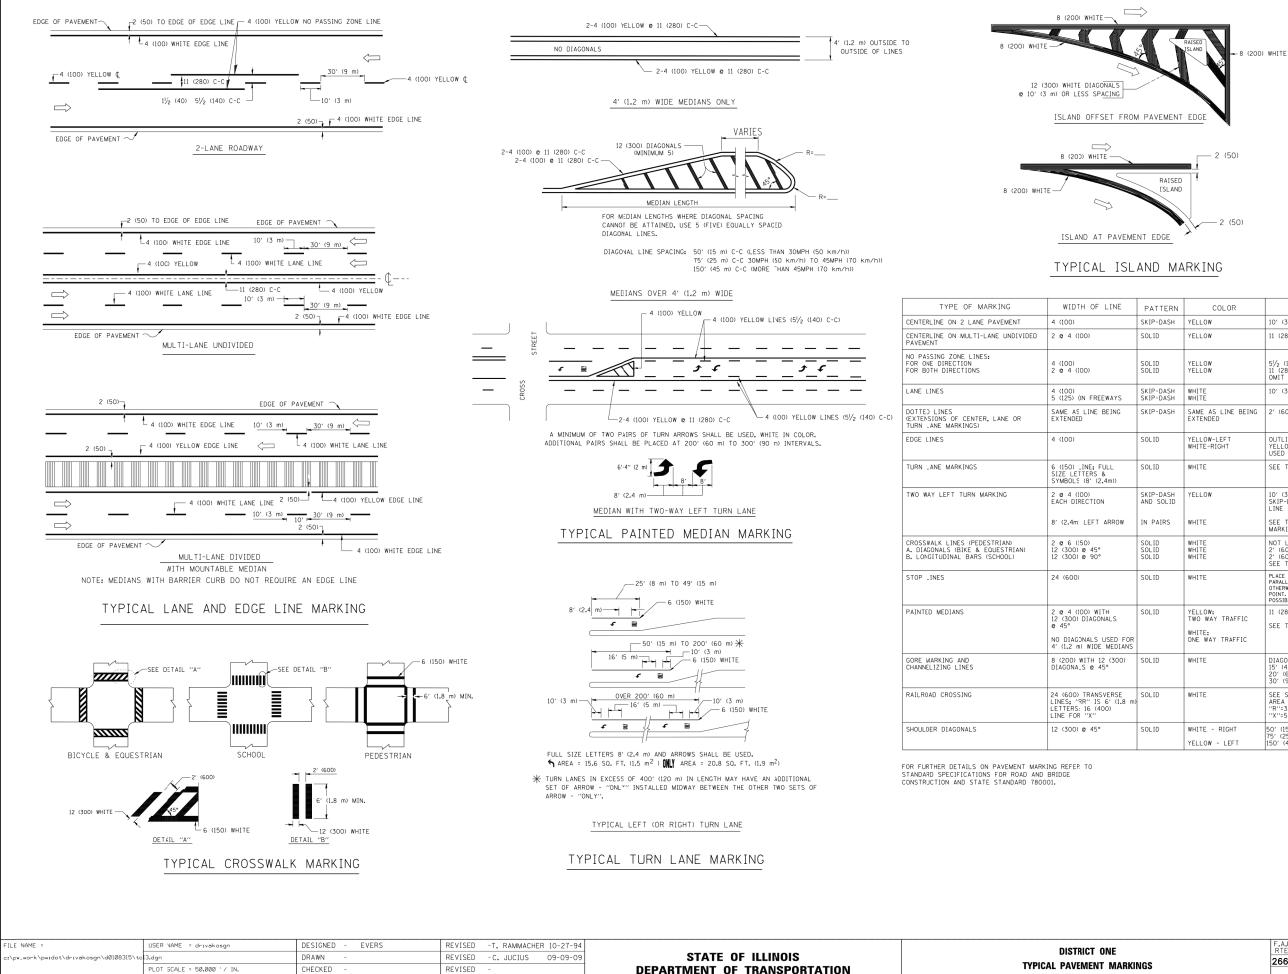

PLOT DATE = 9/9/2009

DATE

03-19-90


REVISED

·	0. 000100	05 05 05				
)	-		DEPARTMENT OF TRANSPORTATION		TYPICAL PAVEMENT	MA
)	-			SCALE: NONE	SHEET NO. 1 OF 1 SHEETS	ST

LINE	PATTERN	COLOR	SPACING / REMARKS
	SKIP-DASH	YELLOW	10' (3 m) LINE WITH 30' (9 m) SPACE
	SOLID	YELLOW	11 (280) C-C
	SOLID SOLID	YELLOW YELLOW	5½ (140) C-C FROM SKIP-DASH CENTERLINE 11 (280) C-C OMIT SKIP-DASH CENTERLINE BETWEEN
EWAYS	SKIP-DASH SKIP-DASH	WHITE WHITE	10' (3 m) LINE WITH 30' (9 m) SPACE
BEING	SKIP-DASH	SAME AS LINE BEING EXTENDED	2' (600) LINE WITH 6' (1.8 m) SPACE
	SOLID	YELLOW-LEFT WHITE-RIGHT	OUTLINE MOUNTABLE MEDIANS IN YELLOW: EDGE LINES ARE NOT USED NEXT TO BARRIER CURB
ULL & .4m))	SOLID	WHITE	SEE TYPICAL TURN LANE MARKING DETAIL
N	SKIP-DASH AND SOLID	YELLOW	10' (3 m) LINE WITH 30' (9 m) SPACE FOR SKIP-DASH; 51/2 (140) C-C BETWEEN SOLID LINE AND SKIP-DASH LINE
ARROW	IN PAIRS	WHITE	SEE TYPICAL TWO-WAY LEFT TURN MARKING DETAIL
	SOLID SOLID SOLID	WHITE WHITE WHITE	NOT LESS THAN 6' (1.8 m) APART 2' (600) APART 2' (600) APART SEE TYPICAL CROSSWALK MARKING DETAILS.
	SOLID	WHITE	PLACE 4'(1.2 m)IN ADVANCE OF AND PARALLEL TO CROSSWALK, IF PRESENT. OTHERWISE, PLACE AT DESIRED STOPPING POINT, PARALLEL TO CROSSROAD CENTERLINE, WHERE POSSIBLE
TH NALS	SOLID	YELLOW: Two way traffic	11 (280) C-C FOR THE DOUBLE LINE
USED FOR MEDIANS		WHITE: ONE WAY TRAFFIC	SEE TYPICAL PAINTED MEDIAN MARKING.
2 (300) 5°	2 (300) SOLID WHITE		DIAGONALS: 15'(4,5 m) C-C (LESS THAN 30MPH (50 km/h)) 20'(6 m) C-C 30MPH (50 km/h) TO 45MPH (70 km/h)) 30'(9 m) C-C (0VER 45MPH (70 km/h))
VERSE 6′(1.8 m) DO)	SOLID	WHITE	SEE STATE STANDARD 780001 AREA OF: "R"=3.6 SO. FT. (0.33 m ²) EACH "X"=54.0 SO. FT. (5.0 m ²)
	SOLID	WHITE - RIGHT YELLOW - LEFT	50' (15 m) C-C (LESS THAN 30MPH (50 km/h)) 75' (25 m) C-C (30 MPH (50 km/h) TO 45MPH (70 km/h)) 150' (45 m) C-C (0VER 45MPH (70 km/h))

All dimensions are in inches (millimeters) unless otherwise shown.

DNE		F.A.U. RTE.	SECTION	COUNTY	TOTAL SHEETS	SHEET NO.	
MARKINGS			2663	19-03126-10-RS	DUPAGE	14	13
				TC-13	CONTRACT NO. 61G59		
	STA.	TO STA.	FED. RC	DAD DIST. NO. 1 ILLINOIS FED. A	ID PROJECT 804	V(658)	

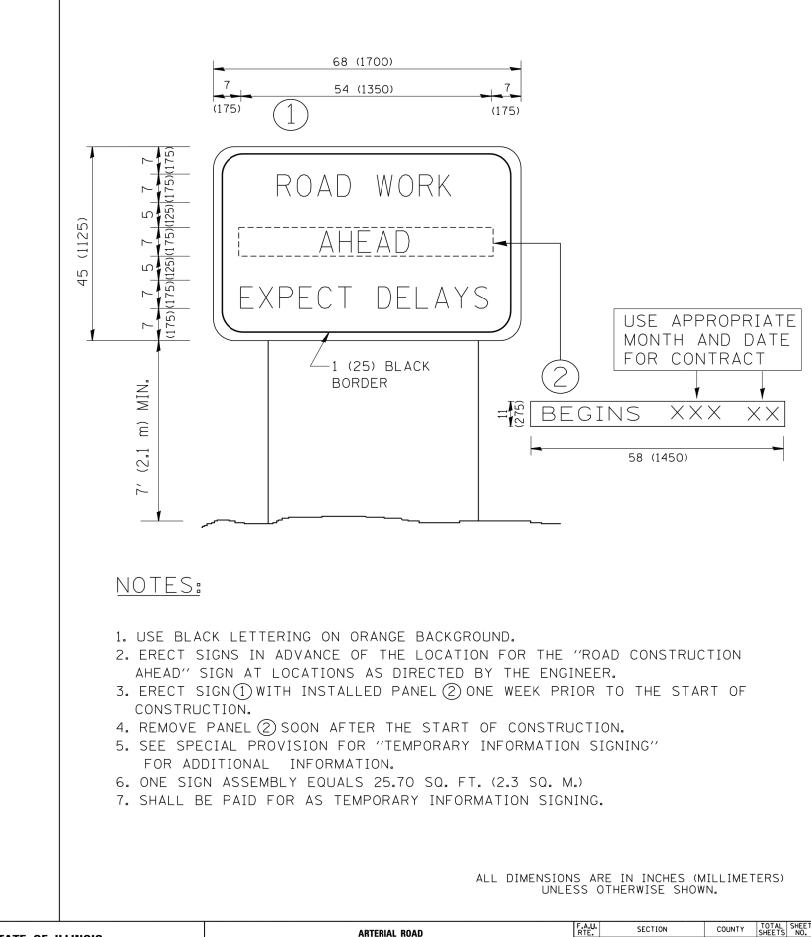

FILE NAME =	USER NAME = gaglianobt	DESIGNED -	REVISED - R. MIRS 09-15-97	· · · ·	ARTERIAL ROAD		F.A.U.	SECTION	COUNTY TOTAL SHEET	
W:\diststd\22x34\tc22.dgn		DRAWN -	REVISED - R. MIRS 12-11-97	STATE OF ILLINOIS				2663	19-03126-10-RS	DUPAGE 14 14
	PLOT SCALE = 50.000 '/ IN.	CHECKED -	REVISED -T. RAMMACHER 02-02-99	DEPARTMENT OF TRANSPORTATION	INFORMATION SIGN				TC-22	CONTRACT NO. 61G59
	PLOT DATE = 1/4/2008	DATE -	REVISED - C. JUCIUS 01-31-07		SCALE: NONE	SHEET NO. 1 OF 1 SHEETS STA.	TO STA.	FED. ROAD	DIST. NO. 1 ILLINOIS FED. A	ID PROJECT 804V(658)