#### INDEX\_OF\_SHEETS:

SHEE	T	NO.	DESCRIPTION
1 2 3		13A	COVER SHEET INDEX OF SHEETS, GENERAL NOTES, AND HIGHWAYS STANDARDS SUMMARY OF QUANTITIES
14			TYPICAL SECTIONS
17	-	10	SCHEDULE OF QUANTITIES
18			
19			ALIGNMENT, TIES AND BENCHMARKS REMOVAL PLAN
20			PLAN AND PROFILE
21			DETOUR PLAN
***		30	
		32	ROADWAY DETAILS
		33A	
34		497	DRAINAGE AND UTILITIES
35			PAVEMENT MARKING AND LANDSCAPING PLANS
36		43	LIGHTING PLANS
44		-	TRAFFIC SIGNAL PLANS
70			STRUCTURAL PLANS - SN 022-0158
		• -	BD-01 DRIVEWAY DETAILS - DISTANCE SETWEEN R.O.W. AND FACE OF CURB
96			& EDGE OF SHOULDER >= 15'
97			BD-8 DETAILS FOR FRAMES AND LIDS ADJUSTMENT WITH MILLING
98			80-24 CURB OR CURB AND GUTTER REMOVAL AND REPLACEMENT
99			BD36 FIRE HYDRANT TO BE MOVED
100			BD-48 PCC PAVEMENT ROUNDOUTS AT CURB AND GUTTER
101			TC-10 TRAFFIC CONTROL AND PROTECTION FOR SIDE ROADS, INTERSECTIONS AND DRIVEWAYS
102			TC-11 TYPICAL APPLICATIONS RAISED REFLECTIVE PAVEMENT MARKERS (SNOW-PLOW RESISTANT)
103			TC-13 DISTRICT ONE TYPICAL PAVEMENT MARKINGS
104			TC-14 TRAFFIC CONTROL AND PROTECTION AT TURN BAYS (TO REMIAN OPEN TO TRAFFIC)
105			TC-16 PAVEMENT MARKING LETTERS AND SYMBOLS FOR TRAFFIC STAGING
106			TC-21 DETOUR SIGNING FOR CLOSING STATE HIGHWAYS
107			TC-22 ARTERIAL ROAD INFORMATION SIGN
108			TC-26 DRIVEWAY ENTRANCE SIGNING
109			TS-07 DISTRICT 1 - DETECTOR LOOP INSTALLATION DETAILS FOR ROADWAY RESURFACING
110 -		111	CROSS SECTIONS

## INDEX OF HIGHWAY STANDARDS:

STANDARD NO.  DESCRIPTION  O00001 - 0			
280001. 07 TEMPORARY EROSION CONTROL SYSTEMS 420011 - 03 PCC PAVEMENT ROUNDOUTS 420111 - 03 PCC PAVEMENT ROUNDOUTS 420401 - 00 BRIDGE APPROACH PAVEMENT CONNECTOR 420701 - 02 PAVEMENT FABRIC 424001 - 07 PERPENDICULAR CURB RAMPS FOR SIDEWALKS 424013 - 01 CORNER PARALLEL CURB RAMPS FOR SIDEWALKS 515001 - 03 NAME PLATE FOR BRIDGES 606001 - 05 CONCRETE CURB TYPE B AND COMBINATION CURB AND GUTTER 606301 - 04 PC CONCRETE ISLANDS AND MEDIANS 609006 - 05 BRIDGE APPROACH PAVEMENT (ORAIN DETAIL) 63001 - 00 STEEL PLATE BEAM GUARDRAIL 630301 - 00 STEEL PLATE BEAM GUARDRAIL 630000 - 03 REFLECTOR AND TERMINAL TYPE 6 635001 - 01 DELINEATORS 635001 - 02 REFLECTOR AND TERMINAL MARKER PLACEMENT 635011 - 02 REFLECTOR MARKER AND MOUNTING DETAILS 643001 - 02 SAND MODULE IMPACT ATTENUATORS 701101 - 04 OFF-RO OPERATIONS, MULTILANE, IS TO 24" FROM PAVEMENT EDGE 701427 - 02 LANE CLOSURE, MULTILANE, INTERMITTENT OR MOVING OPER, FOR SPEEDS 5 40 MPH 701601 - 09 URBAN LANE CLOSURE, MULTILANE, INTERMITTENT OR MOVING OPER, FOR SPEEDS 6 40 MPH 701701 - 09 URBAN LANE CLOSURE, MULTILANE, INTERMITTENT OR MOVING OPER, FOR SPEEDS MEDIAN 701701 - 09 URBAN LANE CLOSURE, MULTILANE, INTERMITTENT OR MOVING OPER, FOR SPEEDS MEDIAN 701701 - 09 URBAN LANE CLOSURE, MULTILANE, INTERMITTENT OR MOVING OPER, FOR SPEEDS MEDIAN 701701 - 09 URBAN LANE CLOSURE, MULTILANE, INTERMITTENT OR MOVING OPER, FOR SPEEDS MEDIAN 701701 - 09 URBAN LANE CLOSURE, MULTILANE, INTERMITTENT OR MOVING OPER, FOR SPEEDS MEDIAN 701701 - 09 URBAN LANE CLOSURE, MULTILANE, INTERMITTENT OR MOVING OPER, FOR SPEEDS MEDIAN 701701 - 09 URBAN LANE CLOSURE, MULTILANE, INTERMITTENT OR MOVING OPER, FOR SPEEDS MEDIAN 701701 - 03 TRAFFIC CONTROL DEVICES	STANDARD NO.	DESCRIPTION	
42001 - 07 PAVEMENT JOINTS 42011 - 03 PCC PAVEMENT ROUNDOUTS 420401 - 0 BRIDGE APPROACH PAVEMENT CONNECTOR 420401 - 07 PAVEMENT FABRIC 424001 - 07 PERPENDICULAR CURB RAMPS FOR SIDEWALKS 424006 - 0/ DIAGONAL CURB RAMPS FOR SIDEWALKS 424011 - 01 CORNER PARALLEL CURB RAMPS FOR SIDEWALKS 515001 - 03 NAME PLATE FOR BRIDGES 606001 - 05 CONCRETE CURB TYPE B AND COMBINATION CURB AND GUTTER 606301 - 04 PC CONCRETE ISLANDS AND MEDIANS 609006 - 05 BRIDGE APPROACH PAVEMENT (DRAIN DETAIL) 63001 - 10 STEEL PLATE BEAM CUARDRAIL 630301 - 06 SHOULDER WIDENING FOR TYPE 1 (SPECIAL) CUARDRAIL TERMINALS 631031 - 12 TRAFFIC BARRIER TERMINAL, TYPE 6 635001 - 01 DELINEATORS 635001 - 02 REFLECTOR AND TERMINAL MARKER PLACEMENT 635011 - 02 REFLECTOR MARKER AND MOUNTING DETAILS 643001 - 02 SAND MODULE IMPACT ATTENUATORS 701101 - 04 OFF-RD OPERATIONS, MULTILANE, IS TO 24" FROM PAVEMENT EDGE 701427 - 02 LANE CLOSURE, MULTILANE, INTERMITTENT OR MOVING OPER, FOR SPEEDS 5 40 MPH 701601 - 09 URBAN LANE CLOSURE, MULTILANE, INTERMITTENT OR MOVING OPER, FOR SPEEDS MEDIAN 701701 - 09 URBAN LANE CLOSURE, MULTILANE, INTERMITTENT OR MOVING OPER, FOR SPEEDS MEDIAN 701701 - 09 URBAN LANE CLOSURE, MULTILANE, INTERMITTENT OR MOVING OPER, FOR SPEEDS MEDIAN 701701 - 09 URBAN LANE CLOSURE, MULTILANE, INTERMITTENT OR MOVING OPER, FOR SPEEDS MEDIAN 701701 - 09 URBAN LANE CLOSURE, MULTILANE, INTERMITTENT OR MOVING OPER, FOR SPEEDS MEDIAN 701701 - 09 URBAN LANE CLOSURE, MULTILANE, INTERMITTENT OR MOVING OPER, FOR SPEEDS MEDIAN 701701 - 09 URBAN LANE CLOSURE, MULTILANE, INTERMITTENT OR MOVING OPER, FOR SPEEDS MEDIAN 701701 - 09 URBAN LANE CLOSURE, MULTILANE, INTERMITTENT OR MOVING OPER, FOR SPEEDS MEDIAN 701701 - 09 URBAN LANE CLOSURE, MULTILANE, INTERMITTENT OR MOVING OPER, FOR SPEEDS MEDIAN 701701 - 09 URBAN LANE CLOSURE, MULTILANE, INTERMITTENT OR MOVING OPER, FOR SPEEDS MEDIAN 701701 - 03 TRAFFIC CONTROL DEVICES	000001 -060	SYMBOLS, ABBREVIATION, AND PATTERNS	
42011 - 03 PCC PAVEMENT ROUNDOUTS 420401 - 10 BRIDGE APPROACH PAVEMENT CONNECTOR 420701 - 0Z PAVEMENT FABRIC 424001 - 07 PERPENDICULAR CURB RAMPS FOR SIDEWALKS 424001 - 01 DIAGONAL CURB RAMPS FOR SIDEWALKS 424011 - 01 CORNER PARALLEL CURB RAMPS FOR SIDEWALKS 515001 - 03 NAME PLATE FOR BRIDGES 606001 - 05 CONCRETE CURB TYPE 8 AND COMBINATION CURB AND GUTTER 606301 - 04 PC CONCRETE ISLANDS AND MEDIANS 609006 - 05 BRIDGE APPROACH PAVEMENT (DRAIN DETAIL) 630001 - 10 STEEL PLATE BEAM GUARDRAIL 630001 - 10 STEEL PLATE BEAM GUARDRAIL 63001 - 04 SHOULDER WIDENING FOR TYPE 1 (SPECIAL) GUARDRAIL TERMINALS 631031 - 12 TRAFFIC BARRIER TERMINAL, TYPE 6 635001 - 01 DELINEATORS 635001 - 02 REFLECTOR AND TERMINAL MARKER PLACEMENT 635001 - 02 REFLECTOR MARKER AND MOUNTING DETAILS 633001 - 02 SAND MODULE IMPACT ATTENUATORS 701101 - 04 OFF-RD OPERATIONS, MULTILANE, 15' TO 24" FROM PAVEMENT EDGE 701427 - 02 LANE CLOSURE, MULTILANE, INTERMITTENT OR MOVING OPER,, FOR SPEEDS 5 40 MPH 701601 - 09 URBAN LANE CLOSURE, MULTILANE, IW OR ZW WITH MOUNTABLE MEDIAN 701701 - 09 URBAN LANE CLOSURE, MULTILANE, 2W WITH MOUNTABLE MEDIAN 701901 - 03 TRAFFIC CONTROL DEVICES	280001-07	TEMPORARY EROSION CONTROL SYSTEMS	
### REPUBLIC REPUBLICANT CONNECTOR  #### REPUBLICANT CURB RAMPS FOR SIDEWALKS  ###################################	420001 - 07	PAYEMENT JOINTS	
420701-0Z PAVEMENT FABRIC  424001-07 PERPENDICULAR CURB RAMPS FOR SIDEWALKS  424006-0/ DIAGONAL CURB RAMPS FOR SIDEWALKS  424011-0/ CORNER PARALLEL CURB RAMPS FOR SIDEWALKS  515001-03 NAME PLATE FOR BRIDGES  606001-05 CONCRETE CURB TYPE 8 AND COMBINATION CURB AND CUTTER  606301-04 PC CONCRETE ISLANDS AND MEDIANS  609006-05 BRIDGE APPROACH PAVEMENT (DRAIN DETAIL)  630001-06 SHOULDER WIDENING FOR TYPE 1 (SPECIAL) GUARDRAIL TERMINALS  631031-02 TRAFFIC BARRIER TERMINAL, TYPE 6  635001-01 DELINEATORS  635001-02 REFLECTOR AND TERMINAL MARKER PLACEMENT  635001-02 REFLECTOR MARKER AND MOUNTING DETAILS  643001-02 SAND MODULE IMPACT ATTENUATORS  701101-04 OFF-00 PERATIONS, MULTILANE, IS' TO 24" FROM PAVEMENT EDGE  101427-02 LANE CLOSURE, MULTILANE, INTERMITTENT OR MOVING OPER,, FOR SPEEDS & 40 MPH  701601-09 URBAN LANE CLOSURE, MULTILANE, IW OR 2W WITH NONTRANSVERSABLE MEDIAN  701701-09 URBAN LANE CLOSURE, MULTILANE, 2W WITH MOUNTABLE MEDIAN  701901-03 TRAFFIC CONTROL DEVICES	420111 - 03	PCC PAVEMENT ROUNDOUTS	
424001 - 07 PERPENDICULAR CURB RAMPS FOR SIDEWALKS 424010 - 0/ DIAGONAL CURB RAMPS FOR SIDEWALKS 424011 - 0/ CORNER PARALLEL CURB RAMPS FOR SIDEWALKS 515001 - 03 NAME PLATE FOR BRIDGES 606001 - 05 CONCRETE CURB TYPE B AND COMBINATION CURB AND GUTTER 606301 - 04 PC CONCRETE ISLANDS AND MEDIANS 609006 - 05 BRIDGE APPROACH PAVEMENT (DRAIN DETAIL) 630001 - 10 STEEL PLATE BEAM GUARDRAIL 630301 - 00 SHOULDER WIDENING FOR TYPE 1 (SPECIAL) GUARDRAIL TERMINALS 631031 - 12 TRAFFIC BARRIER TERMINAL, TYPE 6 635001 - 0/ DELINEATORS 635001 - 0/ DELINEATORS 635006 - 0/3 REFLECTOR AND TERMINAL MARKER PLACEMENT 635011 - 0/2 REFLECTOR MARKER AND MOUNTING DETAILS 643001 - 0/2 SAND MODULE IMPACT ATTENUATORS 701101 - 0/4 OFF-RO OPERATIONS, MULTILANE, 15' TO 24" FROM PAVEMENT EDGE 701427 - 0/2 LANE CLOSURE, MULTILANE, 18 OR 2W WITH NONTRANSVERSABLE MEDIAN 701606 - 0/9 URBAN LANE CLOSURE, MULTILANE, 2W WITH MOUNTABLE MEDIAN 701701 - 0/9 URBAN LANE CLOSURE, MULTILANE, 2W WITH MOUNTABLE MEDIAN 701901 - 0/3 TRAFFIC CONTROL DEVICES	420401 - 10	BRIDGE APPROACH PAVEMENT CONNECTOR	
424006-0/ DIAGONAL CURB RAMPS FOR SIDEWALKS 424011-0/ CORNER PARALLEL CURB RAMPS FOR SIDEWALKS 515001-03 NAME PLATE FOR BRIDGES 606001-05 CONCRETE CURB TYPE B AND COMBINATION CURB AND GUTTER 606301-04 PC CONCRETE ISLANDS AND MEDIANS 609006-05 BRIDGE APPROACH PAVEMENT (DRAIN DETAIL) 630001-06 STEEL PLATE BEAM GUARDRAIL 630301-06 SHOULDER WIDENING FOR TYPE 1 (SPECIAL) GUARDRAIL TERMINALS 631031-12 TRAFFIC BARRIER TERMINAL, TYPE 6 635001-0/ DELINEATORS 635001-0/ DELINEATORS 635001-0/ REFLECTOR AND TERMINAL MARKER PLACEMENT 635011-0/ REFLECTOR MARKER AND MOUNTING DETAILS 643001-0/ SAND MODULE IMPACT ATTENUATORS 701101-0/ OFF PROPERATIONS, MULTILANE, 15' TO 24" FROM PAVEMENT EDGE 701427-0/ LANE CLOSURE, MULTILANE, INTERMITTENT OR MOVING OPER,, FOR SPEEDS & 40 MPH 701601-0/ URBAN LANE CLOSURE, MULTILANE, W OR 2W WITH NONTRANSVERSABLE MEDIAN 701701-0/ URBAN LANE CLOSURE, MULTILANE, 2W WITH MOUNTABLE MEDIAN 701701-0/ URBAN LANE CLOSURE, MULTILANE, W OR 2W WITH MOUNTABLE MEDIAN 701901-0/3 TRAFFIC CONTROL DEVICES	420701-0Z	PAVEMENT FABRIC	
424011-01 CORNER PARALLEL CURB RAMPS FOR SIDEWALKS  S15001-03 NAME PLATE FOR BRIDGES  G0G001-05 CONCRETE CURB TYPE 8 AND COMBINATION CURB AND GUTTER  G0G301-04 PC CONCRETE ISLANDS AND MEDIANS  G0G006-05 BRIDGE APPROACH PAVEMENT (DRAIN DETAIL)  G30001-10 STEEL PLATE BEAM GUARDRAIL  G30301-04 SHOULDER WIDENING FOR TYPE 1 (SPECIAL) GUARDRAIL TERMINALS  G31031-12 TRAFFIC BARRIER TERMINAL, TYPE 6  G35001-01 DELINEATORS  G35006-03 REFLECTOR AND TERMINAL MARKER PLACEMENT  G35011-02 REFLECTOR MARKER AND MOUNTING DETAILS  G43001-02 SAND MODULE IMPACT ATTENUATORS  T01101-04 OFF-RD OPERATIONS, MULTILANE, IS' TO 24" FROM PAVEMENT EDGE  T01427-02 LANE CLOSURE, MULTILANE, INTERMITTENT OR MOVING OPER., FOR SPEEDS & 40 MPH  T01601-09 URBAN LANE CLOSURE, MULTILANE, W OR 2W WITH NONTRANSVERSABLE MEDIAN  T01701-09 URBAN LANE CLOSURE, MULTILANE, W TERMITTENE MEDIAN  T01901-03 TRAFFIC CONTROL DEVICES	424001 ~07	PERPENDICULAR CURB RAMPS FOR SIDEWALKS	
S15001-03 NAME PLATE FOR BRIDGES  606001-05 CONCRETE CURB TYPE 8 AND COMBINATION CURB AND GUTTER  606301-04 PC CONCRETE ISLANDS AND MEDIANS  609006-05 BRIDGE APPROACH PAVEMENT (ORAIN DETAIL)  630001-70 STEEL PLATE BEAM CUARDRAIL  630301-06 SHOULDER WIDENING FOR TYPE 1 (SPECIAL) GUARDRAIL TERMINALS  631031-72 TRAFFIC BARRIER TERMINAL, TYPE 6  635001-01 DELINEATORS  635001-02 REFLECTOR AND TERMINAL MARKER PLACEMENT  635011-02 SAND MODULE IMPACT ATTENUATORS  70101-04 OFF-RD OPERATIONS, MULTILANE, 15' TO 24" FROM PAVEMENT EDGE  701427-02 LANE CLOSURE, MULTILANE, INTERMITTENT OR MOVING OPER., FOR SPEEDS & 40 MPH  701601-09 URBAN LANE CLOSURE, MULTILANE, 1W OR 2W WITH NONTRANSVERSABLE MEDIAN  701701-09 URBAN LANE CLOSURE, MULTILANE, 2W WITH MOUNTABLE MEDIAN  701901-03 TRAFFIC CONTROL DEVICES	424006 - 0/	DIAGONAL CURB RAMPS FOR SIDEWALKS	
CONCRETE CURB TYPE 8 AND COMBINATION CURB AND GUTTER  606301 - 04 PC CONCRETE ISLANDS AND MEDIANS  608006 - 05 BRIDGE APPROACH PAVEMENT (DRAIN DETAIL)  630001 - 70 STEEL PLATE BEAM GUARDRAIL  630301 - 06 SHOULDER WIDENING FOR TYPE 1 (SPECIAL) GUARDRAIL TERMINALS  631031 - 72 TRAFFIC BARRIER TERMINAL, TYPE 6  635001 - 01 DELINEATORS  635001 - 02 REFLECTOR AND TERMINAL MARKER PLACEMENT  635001 - 02 REFLECTOR MARKER AND MOUNTING DETAILS  643001 - 02 SAND MODULE IMPACT ATTENUATORS  701101 - 04 OFF-RD OPERATIONS, MULTILANE, 15' TO 24" FROM PAVEMENT EDGE  701427 - 02 LANE CLOSURE, MULTILANE, INTERMITTENT OR MOVING OPER., FOR SPEEDS & 40 MPH  701601 - 09 URBAN LANE CLOSURE, MULTILANE, 2W WITH MOUNTANSVERSABLE MEDIAN  701701 - 09 URBAN LANE CLOSURE, MULTILANE, 2W WITH MOUNTABLE MEDIAN  701901 - 03 TRAFFIC CONTROL DEVICES	424011 -01	CORNER PARALLEL CURB RAMPS FOR SIDEWALKS	
606301- 04 PC CONCRETE ISLANDS AND MEDIANS 609006-05 BRIDGE APPROACH PAVEMENT (DRAIN DETAIL) 630001-70 STEEL PLATE BEAM GUARDRAIL 630301-06 SHOULDER WIDENING FOR TYPE 1 (SPECIAL) GUARDRAIL TERMINALS 631031-72 TRAFFIC BARRIER TERMINAL, TYPE 6 635001-01 DELINEATORS 635001-02 REFLECTOR AND TERMINAL MARKER PLACEMENT 635011-02 REFLECTOR MARKER AND MOUNTING DETAILS 643001-02 SAND MODULE IMPACT ATTENUATORS 701101-04 OFF-RD OPERATIONS, MULTILANE, 15' TO 24" FROM PAVEMENT EDGE 701427-02 LANE CLOSURE, MULTILANE, INTERMITTENT OR MOVING OPER, FOR SPEEDS & 40 MPH 701601-09 URBAN LANE CLOSURE, MULTILANE, IW OR 2W WITH MONTRANSVERSABLE MEDIAN 701701-09 URBAN LANE CLOSURE, MULTILANE, 2W WITH MOUNTABLE MEDIAN 701901-03 TRAFFIC CONTROL DEVICES	515001 - 03	NAME PLATE FOR BRIDGES	
609006 - 05  BRIDGE APPROACH PAVEMENT (ORAIN DETAIL)  630001 - 10  STEEL PLATE BEAM CUARDRAIL  630301 - 06  SHOULDER WIDENING FOR TYPE 1 (SPECIAL) CUARDRAIL TERMINALS  631031 - 12  TRAFFIC BARRIER TERMINAL, TYPE 6  635001 - 01  GELIMEATORS  635001 - 02  REFLECTOR AND TERMINAL MARKER PLACEMENT  635011 - 02  REFLECTOR MARKER AND MOUNTING DETAILS  643001 - 02  SAND MODULE IMPACT ATTENUATORS  701101 - 04  OFF-RD OPERATIONS. MULTILANE, 15' TO 24" FROM PAVEMENT EDGE  101427 - 02  LANE CLOSURE, MULTILANE, INTERMITTENT OR MOVING OPER., FOR SPEEDS & 40 MPH  701606 - 09  URBAN LANE CLOSURE, MULTILANE, 1W OR 2W WITH NONTRANSVERSABLE MEDIAN  701701 - 09  URBAN LANE CLOSURE, MULTILANE, 2W WITH MOUNTABLE MEDIAN  701901 - 03  TRAFFIC CONTROL DEVICES	606001 - <i>05</i>	CONCRETE CURB TYPE 8 AND COMBINATION CURB AND CUTTER	
63001-70 STEEL PLATE BEAM CUARDRAIL 630301-06 SHOULDER WIDENING FOR TYPE I (SPECIALI CUARDRAIL TERMINALS 631031-72 TRAFFIC BARRIER TERMINAL, TYPE 6 635001-01 DELINEATORS 635001-02 REFLECTOR AND TERMINAL MARKER PLACEMENT 635011-02 REFLECTOR MARKER AND MOUNTING DETAILS 643001-02 SAND MODULE IMPACT ATTENUATORS 701101-04 OFF-RD OPERATIONS. MULTILANE, 15' TO 24" FROM PAVEMENT EDGE 701427-02 LANE CLOSURE, MULTILANE, INTERMITTENT OR MOVING OPER., FOR SPEEDS & 40 MPH 701606-09 URBAN LANE CLOSURE, MULTILANE, 1W OR 2W WITH NONTRANSVERSABLE MEDIAN 701701-09 URBAN LANE CLOSURE, MULTILANE, 2W WITH MOUNTABLE MEDIAN 701901-03 TRAFFIC CONTROL DEVICES	606301 - 04	PC CONCRETE ISLANDS AND MEDIANS	
630301-06 SHOULDER WIDENING FOR TYPE 1 (SPECIAL) GUARDRAIL TERMINALS 631031-72 TRAFFIC BARRIER TERMINAL, TYPE 6 635001-01 DELINEATORS 635006-03 REFLECTOR AND TERMINAL MARKER PLACEMENT 635011-02 REFLECTOR MARKER AND MOUNTING DETAILS 643001-02 SAND MODULE IMPACT ATTENUATORS 701101-04 OFF-RD OPERATIONS, MULTILANE, IS' TO 24" FROM PAVEMENT EDGE LANE CLOSURE, MULTILANE, INTERMITTENT OR MOVING OPER, FOR SPEEDS & 40 MPH 701601-09 URBAN LANE CLOSURE, MULTILANE, IW OR 2W WITH NONTRANSVERSABLE MEDIAN 701701-09 URBAN LANE CLOSURE, MULTILANE, 2W WITH MOUNTABLE MEDIAN 701701-09 TRAFFIC CONTROL DEVICES	609006-05	BRIDGE APPROACH PAVEMENT (DRAIN DETAIL)	
631031 ~ /2 TRAFFIC BARRIER TERMINAL, TYPE 6 635001~01 DELINEATORS 635001~02 REFLECTOR AND TERMINAL MARKER PLACEMENT 635001 ~ 02 REFLECTOR MARKER AND MOUNTING DETAILS 643001~02 SAND MODULE IMPACT ATTENUATORS 701101~04 OFF-RD OPERATIONS. MULTILANE, 15' TO 24" FROM PAVEMENT EDGE 701427~02 LANE CLOSURE, MULTILANE, INTERMITTENT OR MOVING OPER., FOR SPEEDS & 40 MPH 701606~09 URBAN LANE CLOSURE, MULTILANE, 1W OR 2W WITH NONTRANSVERSABLE MEDIAN 701701~09 URBAN LANE CLOSURE, MULTILANE, 2W WITH MOUNTABLE MEDIAN 701901~03 TRAFFIC CONTROL DEVICES	630001-10	STEEL PLATE BEAM CUARDRAIL	
631031 ~ /2 TRAFFIC BARRIER TERMINAL, TYPE 6 635001~01 DELINEATORS 635001~02 REFLECTOR AND TERMINAL MARKER PLACEMENT 635001 ~ 02 REFLECTOR MARKER AND MOUNTING DETAILS 643001~02 SAND MODULE IMPACT ATTENUATORS 701101~04 OFF-RD OPERATIONS. MULTILANE, 15' TO 24" FROM PAVEMENT EDGE 701427~02 LANE CLOSURE, MULTILANE, INTERMITTENT OR MOVING OPER., FOR SPEEDS & 40 MPH 701606~09 URBAN LANE CLOSURE, MULTILANE, 1W OR 2W WITH NONTRANSVERSABLE MEDIAN 701701~09 URBAN LANE CLOSURE, MULTILANE, 2W WITH MOUNTABLE MEDIAN 701901~03 TRAFFIC CONTROL DEVICES	630301-06	SHOULDER WIDENING FOR TYPE I (SPECIAL) CUARDRAIL TERMINALS	
635006-03 REFLECTOR AND TERMINAL MARKER PLACEMENT 635011-02 REFLECTOR MARKER AND MOUNTING DETAILS 643001-02 SAND MODULE IMPACT ATTENUATORS 701101-04 OFF-RD OPERATIONS. MULTILANE. 15' TO 24" FROM PAVEMENT EDGE 701427-02 LANE CLOSURE, MULTILANE. INTERMITTENT OR MOVING OPER., FOR SPEEDS & 40 MPH 701601-09 URBAN LANE CLOSURE, MULTILANE, IW OR 2W WITH NONTRANSVERSABLE MEDIAN 701701-09 URBAN LANE CLOSURE, MULTILANE. 2W WITH MOUNTABLE MEDIAN 701701-09 TRAFFIC CONTROL DEVICES			
635011 - 02 REFLECTOR MARKER AND MOUNTING DETAILS 643001 - 02 SAND MODULE IMPACT ATTENUATORS 701101 - 04 OFF-RD OPERATIONS. MULTILANE. 15' TO 24" FROM PAVEMENT EDGE 101427 - 02 LANE CLOSURE, MULTILANE. INTERMITTENT OR MOVING OPER., FOR SPEEDS & 40 MPH 101601 - 09 URBAN LANE CLOSURE, MULTILANE, IW OR 2W WITH NONTRANSVERSABLE MEDIAN 101701 - 09 URBAN LANE CLOSURE, MULTILANE. 2W WITH MOUNTABLE MEDIAN 101701 - 09 TRAFFIC CONTROL DEVICES	635001~ <i>01</i>	DELINEATORS	
635011 - 02 REFLECTOR MARKER AND MOUNTING DETAILS 643001 - 02 SAND MODULE IMPACT ATTENUATORS 701101 - 04 OFF-RD OPERATIONS. MULTILANE. 15' TO 24" FROM PAVEMENT EDGE 101427 - 02 LANE CLOSURE, MULTILANE. INTERMITTENT OR MOVING OPER., FOR SPEEDS & 40 MPH 101601 - 09 URBAN LANE CLOSURE, MULTILANE, IW OR 2W WITH NONTRANSVERSABLE MEDIAN 101701 - 09 URBAN LANE CLOSURE, MULTILANE. 2W WITH MOUNTABLE MEDIAN 101701 - 09 TRAFFIC CONTROL DEVICES	63SO06 <i>~ O3</i>	REFLECTOR AND TERMINAL MARKER PLACEMENT	
643001-02 SAND MODULE IMPACT ATTENUATORS  701101-04 OFF-RD OPERATIONS. MULTILANE, IS' TO 24" FROM PAVEMENT EDGE  701427-02 LANE CLOSURE, MULTILANE, INTERMITTENT OR MOVING OPER, FOR SPEEDS & 40 MPH  701601-09 URBAN LANE CLOSURE, MULTILANE, IW OR 2W WITH NONTRANSVERSABLE MEDIAN  701701-09 URBAN LANE CLOSURE, MULTILANE, 2W WITH MOUNTABLE MEDIAN  701701-03 TRAFFIC CONTROL DEVICES			
701427 - 02 LANE CLOSURE, MULTILANE, INTERMITTENT OR MOVING OPER, FOR SPEEDS & 40 MPH 701601 - 09 URBAN LANE CLOSURE, MULTILANE, IW OR 2W WITH NONTRANSVERSABLE MEDIAN 701701 - 09 URBAN LANE CLOSURE, MULTILANE INTERSECTION 701901 - 03 TRAFFIC CONTROL DEVICES			
701427 - 02 LANE CLOSURE, MULTILANE, INTERMITTENT OR MOVING OPER, FOR SPEEDS & 40 MPH 701601 - 09 URBAN LANE CLOSURE, MULTILANE, IW OR 2W WITH NONTRANSVERSABLE MEDIAN 701701 - 09 URBAN LANE CLOSURE, MULTILANE INTERSECTION 701901 - 03 TRAFFIC CONTROL DEVICES	701101 - 04	OFF-RD OPERATIONS, MULTILANE, 15' TO 24" FROM PAVEMENT EDGE	
701601 - 09  URBAN LANE CLOSURE, MULTILANE, IW OR 2W WITH NONTRANSVERSABLE MEDIAN  701606 - 09  URBAN LANE CLOSURE, MULTILANE, 2W WITH MOUNTABLE MEDIAN  101701 - 09  URBAN LANE CLOSURE, MULTILANE INTERSECTION  101901 - 03  TRAFFIC CONTROL DEVICES			
701606 - 09 URBAN LANE CLOSURE, MULTILANE. 2W WITH MOUNTABLE MEDIAN 701701 - 09 URBAN LANE CLOSURE. MULTILANE INTERSECTION 701901 - 03 TRAFFIC CONTROL DEVICES	701601 - <i>09</i>		
701701- 09 URBAN LANE CLOSURE. MULTILANE INTERSECTION 701901- 03 TRAFFIC CONTROL DEVICES	701606 - <i>09</i>		
701901 - 03 TRAFFIC CONTROL DEVICES	701701-09		
704001 - 07 TEMPORARY CONCRETE BARRIER	701901-03		
	704001 - 07	TEMPORARY CONCRETE BARRIER	

#### INDEX\_OF\_HIGHWAY\_STANDARDS\_(CONT.):

STANDARD NO.	DESCRIPTION
701801 <i>-0</i> 5	SIDEWALK, CORNER, OR CROSSWALK CLOSURE
120001-01	SIGN PANEL MOUNTING DETAILS
780001~ <i>04</i>	TYPICAL PAVEMENT MARKINGS
781001- <i>03</i>	TYPICAL APPLICATIONS RAISED REFLECTIVE PAVEMENT MARKERS
782001	PRISMATIC CURB REFLECTORS
805001-01	ELECTRICAL SERVICE INSTALLATION DETAILS
814001-0Z	HANDHOLES
814006 <i>~02</i>	DOUBLE HANDHOLES
857001-0/	STANDARD PHASE DESIGNATION DIAGRAMS AND PHASE SEQUENCES
862001-01	UNINTERRUPTABLE POWER SUPPLY (UPS)
873001- <i>02</i>	TRAFFIC SIGNAL GROUNDING & BONDING
877001-05	STEEL MAST ARM ASSEMBLY AND POLE 16' THROUGH 55'
878001 <i>-09</i>	CONCRETE FOUNDATION DETAILS
880001-01	SPAN WIRE MOUNTED SIGNALS AND FLASHING BEACON INSTALLATION
880006-01	TRAFFIC SIGNAL MOUNTING DETAILS
886001-01	DETECTOR LOOP INSTALLATIONS
886006 - <i>01</i>	TYPICAL LAYOUT FOR DETECTION LOOPS

#### **GENERAL NOTES:**

- BEFORE STARTING ANY EXCAVATION, THE CONTRACTOR SHALL CALL JULLIE, AT (800) 892-0123 OR BIL FOR FIELD LOCATIONS OF BURIED ELECTRIC, TELEPHONE. AND GAS UTILITIES (48 HOUR NOTICE IS REQUIRED).
- 2 THE CONTRACTOR WILL NOT BE ALLOWED TO SET UP A YARD OR FIELD OFFICE ON STATE RIGHT-OF-WAY OR PROPERTY WITHOUT PRIOR WRITTEN PERMISSION FROM THE ENGINEER.
- 3 THE CONTRACTOR SHALL COORDINATE CONSTRUCTION ACTIVITIES WITH AFFECTED UTILITY COMPANIES AND THE VILLAGE OF VILLA PARK AND CITY OF ELMHURST.
- 10 FOOT TRANSITIONS SHALL BE USED TO MATCH PROPOSED CURB AND GUTTER AND MEDIAN ITEMS OF WORK TO EXISTING CURB AND GUTTER AND MEDIAN ITEMS IN THE FIELD. UNLESS OTHERWISE SHOWN. THE TRANSITIONS SHALL BE PAID FOR AT THE CONTRACT UNIT PRICE FOR THE PROPOSED LARGER ITEM OF SPECIFIED WORK.
- PRIOR TO EMBANKMENT PLACEMENT, ALL VEGETATION, LOOSE MATERIAL.

  AND UNSTABLE MATERIAL SHOULD BE REMOVED TO DEPTH ENCOUNTERED

  AND REPLACED WITH SUITABLE EMBANKMENT MATERIAL. ANY

  EMBANKMENT WIDENING ON EXISTING SLOPES SHOULD BE BENCHED IN

  ACCORDANCE WITH ARTICLE 205.04 OF THE STANDARD SPECIFICATIONS

  FOR ROAD AND BRIDGE CONSTRUCTION.
- 6 COM ED WIRES ARE NOT INSULATED AND EXTRA CAUTION AND VICILANCE MUST BE ADMERED TO WHEN WORKING AROUND THEM, CONTRACTORS SHOULD ALKWAYS USE CAUTION IN OPERATING CRANES AND OR OTHER EQUIPMENT MEAR OVERHEAD ELECTRICAL FACILITIES. THE OCCUPATIONAL HEALTH AND SAFETY ORGANIZATION (OSHA) RULES REQUIRE THAT WORKERS AND EQUIPMENT SHALL NOT APPROACH WITHIN IEN (10) FEET AWAY OF OVERHEAD ELECTRICAL EQUIPMENT WITHOUT APPROPRIATE SUPPLEMENTAL PROTECTION, PLEASE BE CERTAIN THAT ALL WORKERS ON THIS PROJECT HAVE BEEN FULLY TRAINED AND CONFORM TO OSHA RULES AND OTHER APPLICABLE GUIDELINES REGARDING WORKING SAFELY AROUND ELECTRICAL POWER INFEC
- 7 NIGHT OPERATIONS: WHEN ARTIFICIAL LIGHTING IS UTILIZED IN NIGHT OPERATIONS. THE CONTRACTOR SHALL EXERCISE THE UTMOST PRECAUTION IN PREVENTING ADVERSE VISIBILITY TO THE MOTORING PUBLIC AS WELL AS THE ADJOINING RESIDENTIAL AREAS.
- BEFORE BEGINNING ANY WORK THE CONTRACTOR SHALL RETAIN AND RECORD FOR FUTURE REFERENCE, ALL EXISTING PAVEMENT MARKING LINES (AND RAISED REFLECTIVE PAVEMENT MARKERS) IN ORDER THAT THESE LOCATIONS CAN BE RE-ESTABLISHED FOR STRIPING, EXACT LOCATIONS OF ALL PAVEMENT MARKINGS SHALL BE AS DIRECTED BY THE ENGINEER.
- FOR WORK OUTSIDE THE LIMITS OF BRIDGE APPROACH PAVEMENT, ALL REFERENCES IN THE HIGHWAY STANDARDS AND STANDARD SPECIFICATIONS FOR REINFORCEMENT, DOWEL BARS AND TIE BARS IN PAVEMENT, SHOULDERS, CURB, GUTTER, COMBINATION CURB AND GUTTER AND MEDIAN, AND CHAIR SUPPORTS FOR CRC PAVEMENT, SHALL BE EPOXY COATED, UNLESS NOTED ON THE PLAN.

9A. THE GENERAL CONTRACTOR IS REQUIRED TO HIRE AN ENVIRONMENTAL FIRM WITH AT LEAST FIVE (5)
DOCUMENTED LEAKING UNDERGROUND STORAGE TANK CLEANUPS OR THAT IS PRE-QUALIFIED IN
HAZARDOUS WASTE BY THE DEPARTMENT TO REMEDIATE THE SOIL CONTAMINATION AND MONITOR FOR
WORKER PROTECTION.

SCALE

# GENERAL NOTES (CONT.):

- 10 BEFORE ORDERING STORM SEWERS. CATCH BASINS, PIPE CULVERTS, PIPE DRAINS, MANHOLES, INLETS. AND SCUPPERS, THE CONTRACTOR SHALL REVIEW THE EXISTING FIELD CONDITIONS AND THE DRAINAGE SCHEDULES FOUND IN THE PLANS FOR THE EXACT LENGTH AND QUANTITY REQUIRED.
- THE CONTRACTOR SHALL MAINTAIN THE SURFACE DRAINAGE OF ALL ROADWAYS DURING CONSTRUCTION OF THIS PROJECT. WHEN EXISTING DRAINAGE FACILITIES ARE DISTURBED. THE CONTRACTOR SHALL PROVIDE AND MAINTAIN TEMPORARY OUTLETS AND CONNECTIONS FOR ALL PRIVATE OR PUBLIC DRAINS, SEWERS, INLETS, AND CATCH BASINS. THE CONTRACTOR SHALL PROVIDE FACILITIES TO TAKE IN ALL STORM WATER, WHICH WILL BE RECEIVED BY THESE DRAINS AND SEWERS AND DISCHARGE SAME. THE CONTRACTOR SHALL PROVIDE AND MAINTAIN A TEMPORARY OUTLET AND BE PREPARED AT ALL TIMES TO DISPOSE OF THE WATER RECEIVED FROM ALL THESE TEMPORARY CONNECTIONS UNTIL INSTALLATION IS COMPLETE. INCLUDING PAVEMENT. THIS WORK SHALL NOT BE PAID FOR DIRECTLY BUT SHALL BE CONSIDERED INCLUDED IN THE CONTRACT. COORDINATION WITH ALL AGENCIES INVOLVED IS REQUIRED.
- DURING CONSTRUCTION OPERATIONS, IF ANY LOOSE MATERIAL IS DEPOSITED IN THE FLOW LINE OF DRAINAGE STRUCTURES SUCH THAT THE NATURAL FLOW OF WATER IS OBSTRUCTED. THE MATERIAL SHALL BE REMOVED AT THE CLOSE OF EACH WORKING DAY, AT THE CONCLUSION OF CONSTRUCTION OPERATIONS, ALL UTILITY STRUCTURES SHALL BE FREE FROM DUST AND DEBRIS. THE WORK SPECIFIED ABOVE WILL NOT BE PAID SEPARATELY BUT SHALL BE INCLUDED IN THE COST OF THE CONTRACT.
- ACCREGATE SUBGRADE IMPROVEMENT HAS BEEN PROVIDED FOR USE AT THE LOCATIONS INDICATED FOR SOILS THAT TEND TO BE UNSUITABLE OR UNSTABLE. THE ACTUAL NEED FOR THE REMOVAL AND REPLACEMENT WITH AGGRECATE SUBGRADE IMPROVEMENT WILL BE DETERMINED IN THE FIELD AT THE TIME OF CONSTRUCTION BY THE GEOTECHNICAL ENGINEER. ALL POTENTIALLY UNSTABLE SOILS SHOULD BE TESTED WITH A STATIC CONE PENETROMETER AND TREATED IN ACCORDANCE WITH ARTICLE 301,04 AND THE 100T SUBGRADE STABILITY MANUAL. IF UNSTABLE AND/OR UNSUITABLE MATERIAL IS ENCOUNTERED, THE SOIL SHALL BE REMOVED AND REPLACED WITH AGGREGATE SUBGRADE IMPROVEMENT OR EMBANKMENT AS DETERMINED BY THE CEOTECHNICAL ENGINEER. IF UNSTABLE AND/OR UNSUITABLE MATERIAL IS NOT ENCOUNTERED. THEN THEN UNANTITY SHALL BE DEDUCTED AND NO ADDITIONAL COMPENSATION WILL BE DUE TO THE CONTRACTOR.
- 14 THE CONTRACTOR SHALL MAINTAIN ALL ROADWAYS OPEN TO TRAFFIC AS SHOWN ON THE MAINTENANCE OF TRAFFIC PLANS.
- 15 THE CONTRACTOR SHALL CONTACT THE IDOT TRAFFIC CONTROL SUPERVISOR. AT 847-705-4470 A MINIMUM OF 72 HOURS PRIOR TO THE PLACEMENT OF ANY TEMPORARY TRAFFIC CONTROL DEVICES.
- 16 THE RESIDENT ENGINEER SHALL CONTACT DON CHIARUGI AT (847) 741-9857 A MINIMUM OF TWO (2) WEEKS PRIOR TO PLACING THE PERMANENT PAVEMENT MARKINGS.
- 7 THE CONTRACTOR SHALL USE CARE IN GRADING OR EXCAVATING NEAR ANY AND ALL EXISTING ITEMS THAT WILL NOT BE REMOVED. ANY DAMAGE DONE TO EXISTING ITEMS BY THE CONTRACTOR SHALL BE REPAIRED OR REPLACED TO THE SATISFACTION OF THE ENGINEER AT THE CONTRACTOR'S DWN EXPENSE.
- 18 THE CONTRACTOR SHALL BE RESPONSIBLE FOR THE PROTECTION OF ALL UNDERGROUND OR SURFACE UTILITIES EVEN THOUGH THEY MAY NOT BE SHOWN ON THE PLANS. ANY UTILITY THAT IS DAMAGED DURING CONSTRUCTION SHALL BE REPAIRED OR REPLACED TO THE SATISFACTION OF THE ENGINEER. THIS WORK SHALL BE AT THE CONTRACTOR'S EXPENSE.
- 19 FOR STORM SEWER CONSTRUCTED UNDER THE ROADWAY, BACKFILLING METHODS TWO AND THREE AUTHORIZED UNDER THE PROVISIONS OF ARTICLE 550.07 OF THE STANDARD

CONTRACTOR SHOULD BE AWARE OF OVERHEAD UTILITIES TO DETERMINE MEANS AND

# METHODS AND SHOULD BE REFLECTED IN THE BID PRICE. SALL CREEK GREENWAY TRAIL

- THE TRAIL UNDER THE BRIDGE SHALL REMAIN OPEN ON WEEKENDS.
   ANY CLOSURE FOR THE REMOVAL AND REPLACEMENT OF THE SUPERSTRUCTURE
   SHOULD TAKE PLACE DURING THE WEEK.
- THE CONTRACTOR SHALL TAKE NECESSARY PRECAUTIONS TO ENSURE THAT NO DEBRIS WILL ENDANCER OR INTERFERE WITH TRAFFIC ON THE TRAIL BENEATH THE BRIDGE ACCORDING TO ARTICLE 107.09 OF THE STANDARD SPECIFICATIONS. THIS WORK WILL NOT BE PAID FOR SEPARATELY BUT SHALL BE INCLUDED IN THE CONTRACT UNIT PRICE FOR THE APPROPRIATE PAY ITEMS INVOLVED AND NO ADDITIONAL COMPENSATION WILL BE ALLOWED.

#### COMMITMENTS:

NONE

COTTALCER	USER NAME * rgall	DESIGNED -	REVISED . A RAG 1300	2013
COLLINS		DRAWN .	REVISEO -	
ENGINEERSZ	PLOT SCALE . 2.0000 '/ in.	CHECKED -	REVISED -	
	PLOT CATE - 19/24/2013	DATE -	REVISEO -	

STATE OF ILLINOIS
DEPARTMENT OF TRANSPORTATION

1	L ROUTE 64	OVER SALT	CREEK	F.A.P RTE,	SECTION	COUNTY	TOTAL	SHEE NO.
INDEX	OF SHEETS	& HIGHWAY	STANDARDS	307	1318-88	DUPAGE	ЦЦ	2
SHEET	^-	SUSSEEL CEL				CONTRACT	NO. 6	0V24
35651	0F	SHEETS! STA.	TO SYA.		ILL MOIS FED. A	D PROFCT		

						· · · · · · · · · · · · · · · · · · ·	CONSTRUCTIO	N CODE			
					***************************************		IC SIGNALS	ROADWAY LIG	HTING / EVP	SIDEV	VALK
						IL64 AT VILLA AVE.	IL 64 AT ELMHURST PL.				
			URBAN	80% FEDER	AL / 20% STATE	80% FED / 10% STATE / 5% DUPAGE CO / 5% VILLA PARK	100% ELMHURST	100% VILLA PARK	100% ELMHURST	80% STATE / 20% VILLA PARK	80% STATE / 20% ELMHURST
	1		T	ROADWAY	BRIDGE	SAFETY	SAFETY	SAFETY	SAFETY	SAFETY	SAFETY
CODE			TOTAL	0004-	0014	0021	0021	0021	0021	0021	0021
NO.	ITEM	UNIT	QUANTITY		SN 022-0158						
63100167	TRAFFIC BARRIER TERMINAL, TYPE 1 (SPECIAL) TANGENT	EACH	2	2							
63200310	GUARDRAIL REMOVAL	FOOT	159	159							
07000400	ENGASTRO ESTA OFFICE MOSA	04: 140		7							
67000400	ENGINEER'S FIELD OFFICE, TYPE A	CAL MO	7	7							
67100100	MOBILIZATION	LSUM	1	1							
70301000	WORK ZONE PAVEMENT MARKING REMOVAL	SQ FT	4758	4758							
70400100	TEMPORARY CONCRETE BARRIER	FOOT	888	888							
70400200	RELOCATE TEMPORARY CONCRETE BARRIER	FOOT	576	576							
	CFULLY			~~~							
70600235	IMPACT ATTENUATORS, TEMPORARY (NON-REDIRECTIVE), TEST LEVEL 2	EACH	4	4							
	CFULLY										
70600320	IMPACT ATTENUATORS, RELOCATE (NON- REDIRECTIVE), TEST LEVEL 2	EACH	4	4	<b>4</b>						
72000100	SIGN PANEL - TYPE 1	SQ FT	15			6	9				
72400500	RELOCATE SIGN PANEL ASSEMBLY - TYPE A	EACH	12	12							
			<u> </u>								
78001130	PAINT PAVEMENT MARKING - LINE 6"	FOOT	253	253							
78008200	POLYUREA PAVEMENT MARKING TYPE I - LETTERS AND SYMBOLS	SQ FT	128	128							
78008210	POLYUREA PAVEMENT MARKING TYPE I - LINE 4"	FOOT	1260	1260							
								<b></b>			
<b>L</b>		<u> </u>	1	<u> </u>	±	<u> </u>	Marian de la companya del companya de la companya del companya de la companya de	<u> </u>	1	<u>I</u>	

COLLINS STATE FOR THE STATE OF THE STATE OF

USER NAME , rgall	DESIGNED -	REVISED -
	DRAWN -	REVISED -
PLOT SCALE . 2.9000 '/ 10.	CHECKED -	REVISED -
PLGT DATE + 10/28/2013	DATE ^	REVISEO -

STATE OF ILLINOIS
DEPARTMENT OF TRANSPORTATION

SCALE:

IL ROUTE 64 (NORTH AVE) OVER SALT CREEK
SUMMARY OF QUANTITIES

SHEET OF SHEETS STA. TO STA.

• - DENOTES SPECIALTY ITEM

ì				<u> </u>		TRACE	CONSTRUCTIO	ROADWAY LIG	HTING / EVP	SIDE	MALK
						IL64 AT VILLA AVE.	IL 64 AT ELMHURST PL.	TOADWAT LIG	HING/EVP	SIDE	VWFV
			YRBAN	80% FEDER	AL / 20% STATE	80% FED / 10% STATE / 5% DUPAGE CO / 5% VILLA PARK	100% ELMHURST	100% VILLA PARK	100% ELMHURST	80% STATE / 20% VILLA PARK	80% STATE / 20 ELMHURST
				ROADWAY	BRIDGE	SAFETY	SAFETY	SAFETY	SAFETY	SAFETY	SAFETY
CODE			TOTAL	0004	0014	0021	0021	0021	0021	0021	0021
NO.	ITEM	UNIT	QUANTITY		SN 022-0158						
85000200	MAINTENANCE OF EXISTING TRAFFIC SIGNAL INSTALLATION	EACH	1			1					
87300925	ELECTRIC CABLE IN CONDUIT, TRACER, NO. 14 1C	FOOT	751			751					
87301215	ELECTRIC CABLE IN CONDUIT, SIGNAL NO. 14 2C	FOOT	1029			1029					
87301225	ELECTRIC CABLE IN CONDUIT, SIGNAL NO. 14 3C	FOOT	1594			1071		523			
87301245	ELECTRIC CABLE IN CONDUIT, SIGNAL NO. 14 5C	FOOT	3344			(2246)/	1098				
87301255	ELECTRIC CABLE IN CONDUIT, SIGNAL NO. 14 7C	FOOT	2487			2189	298				
87301305	ELECTRIC CABLE IN CONDUIT, LEAD-IN, NO. 14 1 PAIR	FOOT	1544			(1544)/					
87301900	ELECTRIC CABLE IN CONDUIT, EQUIPMENT GROUNDING CONDUCTOR, NO. 6	FOOT	438			415	23				
87500600	TRAFFIC SIGNAL POST, 10 FT.	EACH	1			1					
87700260	STEEL MAST ARM ASSEMBLY AND POLE, 44 FT.	EACH	1				1				
87700280	STEEL MAST ARM ASSEMBLY AND POLE, 48 FT.	EACH	1				1				
87700300	STEEL MAST ARM ASSEMBLY AND POLE, 52 FT.	EACH	1			1					
87700310	STEEL MAST ARM ASSEMBLY AND POLE, 54 FT.	EACH	1			1					
87800100	CONCRETE FOUNDATION, TYPE A	FOOT	4			4					

COLLINS 131 % 600% a COLLINS 1

DESIGNED -REVISEO -DRAWN -REVISED -PLOT SCALE = 2.8800 '/ in. PLOT DATE = 10/28/2013 CHECKED -REVISED -DATE REVISED -

STATE OF ILLINOIS
DEPARTMENT OF TRANSPORTATION

IL ROUTE 64 (NORTH AVE) OVER SALT CREEK SUMMARY OF QUANTITIES SCALE:

SECTION

. - DENOTES SPECIALTY ITEM

1						CONSTRUCTION CODE TRAFFIC SIGNALS ROADWAY LIGHTING / EVF			HTING / EVP	VP SIDEWALK		
						IL64 AT VILLA AVE.	IL 64 AT ELMHURST PL.					
			URBAN	80% FEDER	AL / 20% STATE	80% FED / 10% STATE / 5% DUPAGE CO / 5% VILLA PARK	100% ELMHURST	100% VILLA PARK	100% ELMHURST	VILLA PARR	80% STATE / 2 ELMHURST	
		T		ROADWAY	BRIDGE	SAFETY	SAFETY	SAFETY	SAFETY	SAFETY	SAFETY	
CODE			TOTAL	0004	0014	0021	0021	0021	0021	0021	0021	
NO.	ITEM	UNIT	QUANTITY		SN 022-0158							
87800415	CONCRETE FOUNDATION, TYPE E 36-INCH DIAMETER	FOOT	56			30	26					
											W	
87900200	DRILL EXISTING HANDHOLE	EACH	7			5	2					
87900205	DRILL EXISTING HEAVY DUTY HANDHOLE	EACH	1			1			-			
88030020	SIGNAL HEAD, LED, 1-FACE, 3-SECTION, MAST-ARM MOUNTED	EACH	(12)			(7)	5		<u> </u>			
88030050	SIGNAL HEAD, LED, 1-FACE, 3-SECTION, BRACKET MOUNTED	EACH	2				2					
88030100	SIGNAL HEAD, LED, 1-FACE, 5-SECTION, BRACKET MOUNTED	EACH	1			1						
88030110	SIGNAL HEAD, LED, 1-FACE, 5-SECTION, MAST-ARM MOUNTED	EACH	3			2	1					
88030220	SIGNAL HEAD, LED, 2-FACE, 5-SECTION, BRACKET MOUNTED	EACH	1			1						
88102717	PEDESTRIAN SIGNAL HEAD, LED, 1-FACE, BRACKET MOUNTED WITH COUNTDOWN TIMER	EACH	2			2						
88102747	PEDESTRIAN SIGNAL HEAD, LED, 2-FACE, BRACKET MOUNTED WITH COUNTDOWN TIMER	EACH	2			2						
88200210	TRAFFIC SIGNAL BACKPLATE, LOUVERED, ALUMINUM	EACH	(15)	Δ		(9)A	6					
88600100	DETECTOR LOOP, TYPE I	FOOT	(1000	Δ		(616)/\	472					
88800100	PEDESTRIAN PUSH-BUTTON	EACH	6			6						
89000100	TEMPORARY TRAFFIC SIGNAL INSTALLATION	EACH	2	2								

● 0021 80%, FED. /20%, STATE

1 Rev. 1-9-14

• - DENOTES SPECIALTY ITEM

COLLINS 121 % NOW P.

COLLINS 121 % NOW P.

ENGINEERS 2 for 12121 101-1500

ENGINEERS 2 for 12121 101-1500

ALPROS MORE SOURCE STANDARD COMMON PLOT SCALE = 2.00000

ALPROS MORE SOURCE STANDARD MAJERIAN PROPERTY 107-28.

	USEA NAME > rgoll	DESIGNED	*	REVISED	•
		DRAWN	•	REVISED	*
	PLOT SCALE = 2.0000 '/ 1/1.	CHECKED	•	REVISED	•
1	PLOT DATE = 10/28/2013	DATE	*	REVISED	•

STATE OF ILLINOIS
DEPARTMENT OF TRANSPORTATION

IL ROUTE	*	I AVE) OVER SA OF QUANTITIES	
 CUEET	00	CUECTO CTA	TO 517

	ILLINO(S) FEO. AID PROJECT								
		CONTRACT	NO. 6	0V24					
307	1318~BR	DUPAGE	111	11					
TÉ.	SECTION	COUNTY	SHEETS	NO.					

******						TRAFF	CONSTRUCTIO	ROADWAY LIG	HTING / EVP	SIDEV	VALK
of college de secretaries						IL64 AT VILLA AVE.	IL 64 AT ELMHURST PL.			1	
ALI KUTANTAN KANTAN					AL / 20% STATE	80% FED / 10% STATE / 5% DUPAGE CO / 5% VILLA PARK	100% ELMHURST	100% VILLA PARK		VILLA PAKK	ELMHURST
				ROADWAY	BRIDGE	SAFETY	SAFETY	SAFETY	SAFETY	SAFETY	SAFETY
CODE			TOTAL	0001	(0014)	0021	0021	0021	0021	0021	0021
NO.	ITEM	UNIT	QUANTITY		SN 022-0158						
89501400	RELOCATE EXISTING EMERGENCY VEHICLE PRIORITY SYSTEM, DETECTOR UNIT	EACH	2			2					
89502210	MODIFY EXISTING CONTROLLER CABINET	EACH	2			1	1				
89502300	REMOVE ELECTRIC CABLE FROM CONDUIT	FOOT	4394			3524	870				
89502375	REMOVE EXISTING TRAFFIC SIGNAL EQUIPMENT	EACH	2			1	1				
89502380	REMOVE EXISTING HANDHOLE	EACH	2			2					
89502385	REMOVE EXISTING CONCRETE FOUNDATION	EACH	4			2	2				
X0323491	SLOPE WALL CRACK SEALING	FOOT	14		14						
X0324085	EMERGENCY VEHICLE PRIORITY SYSTEM LINE SENSOR CABLE, NO. 20 3/C	FOOT	523					523			
X0327638	STREAM GAUGE	EACH	0		(1)	$\wedge$					
X5030305	CONCRETE WEARING SURFACE, 5"	SQ YD	1702		1702						
X5537800	STORM SEWERS TO BE CLEANED 12"	FOOT	136	136							
X5538200	STORM SEWERS TO BE CLEANED 24"	FOOT	61	61							
X5538600	STORM SEWERS TO BE CLEANED 36"	FOOT	90	90							
X6330705	RUB RAIL	FOOT	20	20							

□ NP- (1001/.STATE)

DESIGNED -REVISED -CHECKED -REVISED -PLOT SCALE = 2.0020 1/ (h, PLOT DATE + 10/28/2013 DATE " REVISED -

STATE OF ILLINOIS
DEPARTMENT OF TRANSPORTATION

△Rev. 12-30-13 IL ROUTE 64 (NORTH AVE) OVER SALT CREEK SUMMARY OF QUANTITIES SHEET OF SHEETS STA. TO STA. SCALE:

. - DENOTES SPECIALTY ITEM \$ECTION

F.A.P RTE, 307 1318-BR

COLLINS 15 # 2007 D 100000 T 1000000 T 100000 T 100000 T 100000 T 100000 T 100000 T 100000 T 1000000 T 100000 T 100000 T 100000 T 100000 T 100000 T 100000 T 1000000 T 100000 T 100000 T 100000 T 100000 T 100000 T 100000 T 1000000 T 100000 T 100000 T 100000 T 100000 T 100000 T 100000 T 1000000 T 100000 T 100000 T 100000 T 100000 T 100000 T 100000 T 1000000 T 100000 T 100000 T 100000 T 100000 T 100000 T 100000 T 1000000 T 100000 T 100000 T 100000 T 100000 T 100000 T 100000 T 1000000 T 100000 T 100000 T 100000 T 100000 T 100000 T 100000 T 1000000 T 100000 T 100000 T 100000 T 100000 T 100000 T 100000 T 1000000 T 100000 T 100000 T 100000 T 100000 T 100000 T 100000 T 1000000 T 100000 T 100000 T 100000 T 100000 T 100000 T 100000 T 1000000 T 100000 T 100000 T 100000 T 100000 T 100000 T 100000 T 1000000 T 100000 T 100000 T 100000 T 100000 T 100000 T 100000 T 1000000 T 100000 T 100000 T 100000 T 100000 T 100000 T 100000 T 1000000 T 100000 T 100000 T 100000 T 100000 T 100000 T 100000 T 1000000 T 100000 T 100000 T 100000 T 100000 T 100000 T 100000 T 1000000 T 100000 T 1000000 T 100000 T 100000 T 100000 T 100000 T 100000 T 100000 T 1000000 T 100000 T 100000 T 100000 T 100000 T 100000 T 100000 T 1000000 T 100000 T 100000 T 100000 T 100000 T 100000 T 100000 T 1000000 T 100000 T 100000 T 100000 T 100000 T 100000 T 100000 T 1000000 T 100000 T 100000 T 100000 T 100000 T 1000000 T 100000 T 10000

1 1	1 1 1 1 1 1							CONSTRUCTIO	N CODE			· · · · · · · · · · · · · · · · · · ·		
***************************************						· · · · · · · · · · · · · · · · · · ·		IC SIGNALS	ROADWAY LIG	HTING / EVP	SIDE	VALK		
***************************************							IL64 AT VILLA AVE.	IL 64 AT ELMHURST PL.						
***************************************	10.11.11.11.11.11.11.11.11.11.11.11.11.1		URBAN				80% FEDERA	AL / 20% STATE	80% FED / 10% STATE / 5% DUPAGE CO / 5% VILLA PARK	100% ELMHURST	100% VILLA PARK	100% ELMHURST	80% STATE / 20% VILLA PARK	80% STATE / 20% ELMHURST
Ì			· · · · · · · · · · · · · · · · · · ·	T	ROADWAY	BRIDGE	SAFETY	SAFETY	SAFETY	SAFETY	SAFETY	SAFETY		
	CODE			TOTAL	0004	(0014 )/\	0021	0021	0021	0021	0021	0021		
	NO.	ITÉM	UNIT	QUANTITY		SN 022-0158								
			l			Water Control of the				***************************************				
	Z0033028	AMADITENANOS OS CIOUTINO OVOTENA			<b>-</b>									
•	20053028	MAINTENANCE OF LIGHTING SYSTEM	CAL MO	6					3	3				
	1			İ										
	20033044	RE-OPTIMIZE TRAFFIC SIGNAL SYSTEM LEVEL 1	EACH	1	<b> </b>		1			<u> </u>				
	2.0000044	WE OF THREE HAPPING GIONAL OF STEWN ECASE I	EACH	ļ			l							
]								•	i					
	20062456	TEMPORARY PAVEMENT	SQYD	212	212				<u> </u>	<u> </u>				
					212									
<b>Ø</b>	Z0073510	TEMPORARY TRAFFIC SIGNAL TIMING	EACH	2	2	· · · · · · · · · · · · · · · · · · ·		<del></del>						
	<b> </b>			<del> </del>				<del>*</del>		<del></del>				
			l											
0	20076600	TRAINEES	HOUR	500	500									
1									<b>}</b>		····			
	<u> </u>													
0	70076604	TRAINEES TRAINING PROGRAM GRADUATE	HOLIR	500	500									
7					200			· · · · · · · · · · · · · · · · · · ·						
_~				<u></u>										
( ) <sub>4</sub>	10/09/12/10	NON-SPECIAL WASTE DISPOSAL	CUYD	260	260									
7	WE TOOK DO	NON-SPECIAL WASTE DISPOSAL	100 10	200	200									
7	<u> </u>													
(*	1010900450	SPECIAL WASTE PLANS AND REPORTS	L SUM	1	, )									
ζ^	1	Little This This This This This This This This		<b> </b>	· \			···		· · · · · · · · · · · · · · · · · · ·				
(	<b> </b>			ļ										
(*	66900530	SOIL DISPOSAL ANALYSIS	EACH	3	3 {					,				
۷.	<u> </u>		7				·····	······································						
,,	<del> </del>		<del>~ ~~</del> ~								<del> </del>			
X	88600700	PREFORMED DETECTOR LOOP	FOOT	135			135							
>	****													
			<del></del>	<u> </u>			<del></del>	**************************************		~ <del></del>				
X	89500100	RELOCATE EXISTING SIGNAL HEAD	EACH	/			/ \							
$\overline{}$	+		4~~	<u> </u>			/							
				<b></b>			······································	······································						
										···	·			
1											······································	······································		
-	<del></del>						······································	**************************************						
-														
***************************************	<u> </u>		· · · · · · · · · · · · · · · · · · ·	<b></b>							····			
-														

@ 0021 BOXFED, 120% STATE COLLINS SUFFER TO COLUND 
DESIGNED -REVISED -REVISED . CHECKED -PLOT SCALE = 2,0000 1/ sh. REVISED PLOT DATE \* 10/28/2013 REVISED DATE

STATE OF ILLINOIS
DEPARTMENT OF TRANSPORTATION

A Rev. 12-30-13 IL ROUTE 64 (NORTH AVE) OVER SALT CREEK SUMMARY OF QUANTITIES

SHEET OF SHEETS STA.

SCALE:

SECTION COUNTY TOTAL SHEET
SHEETS NO.


1318-BR DUPAGE III 13A
CONTRACT NO. 60V24


[RUNOIS]FED, AID PROJECT


F.A.P RTE. 307


TO STA.

. - DENOTES SPECIALTY ITEM

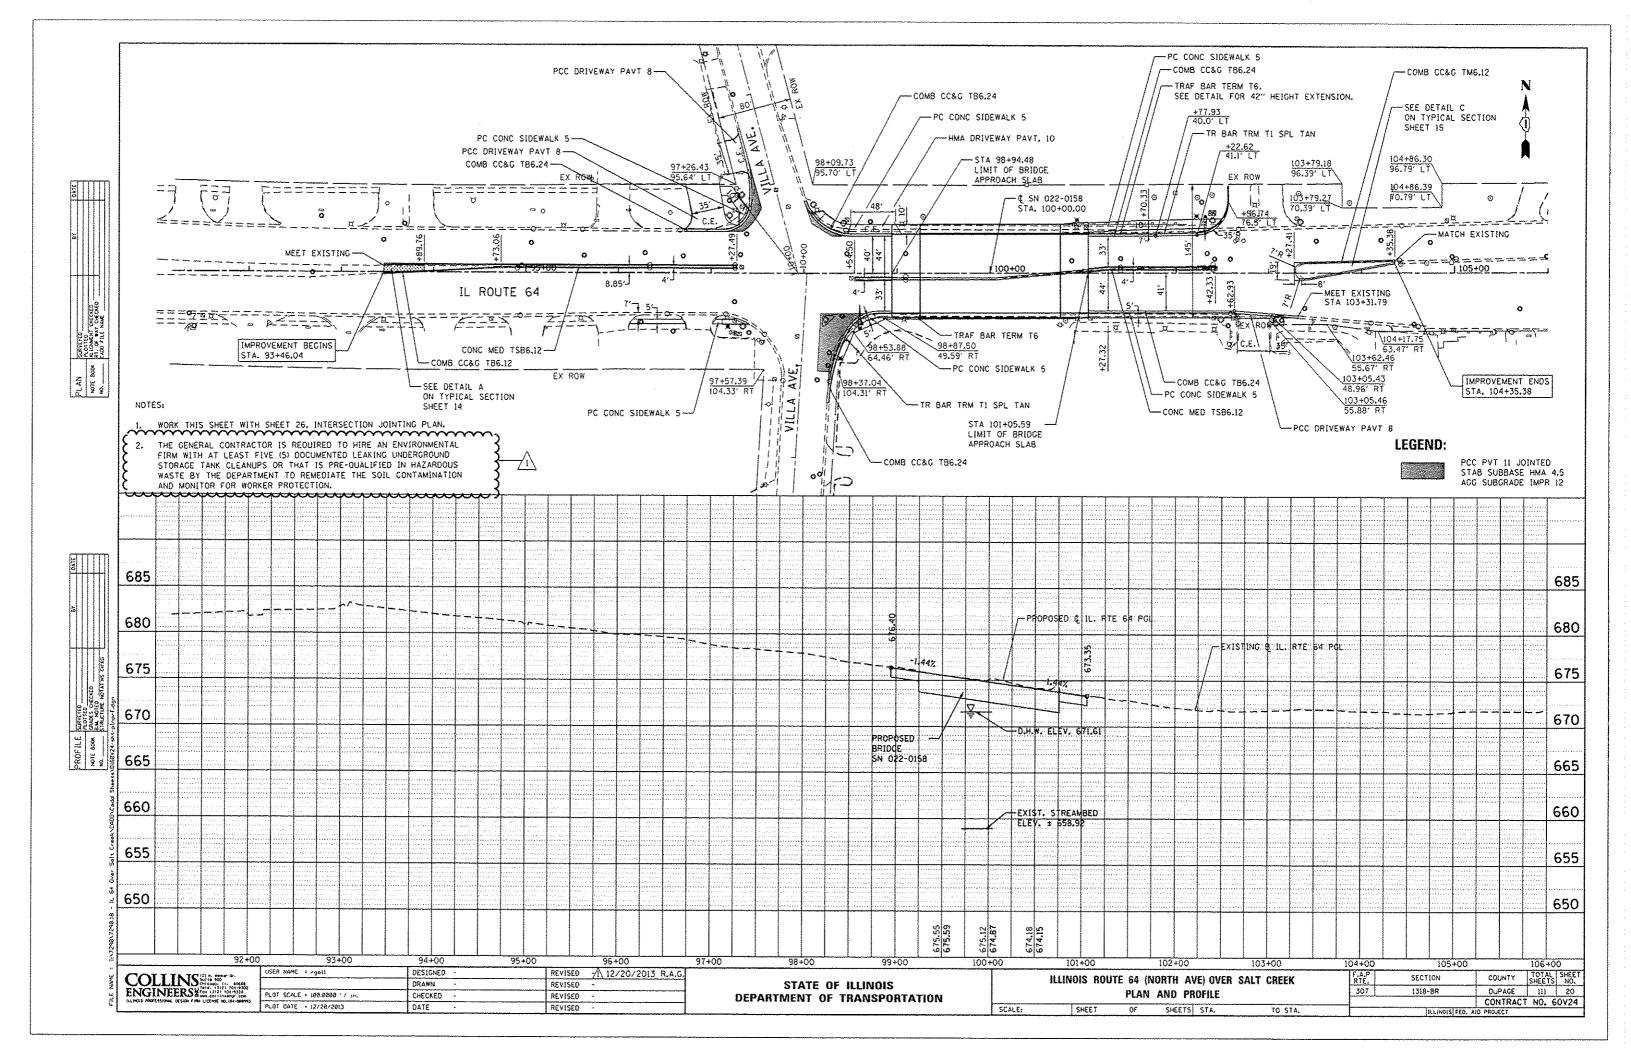

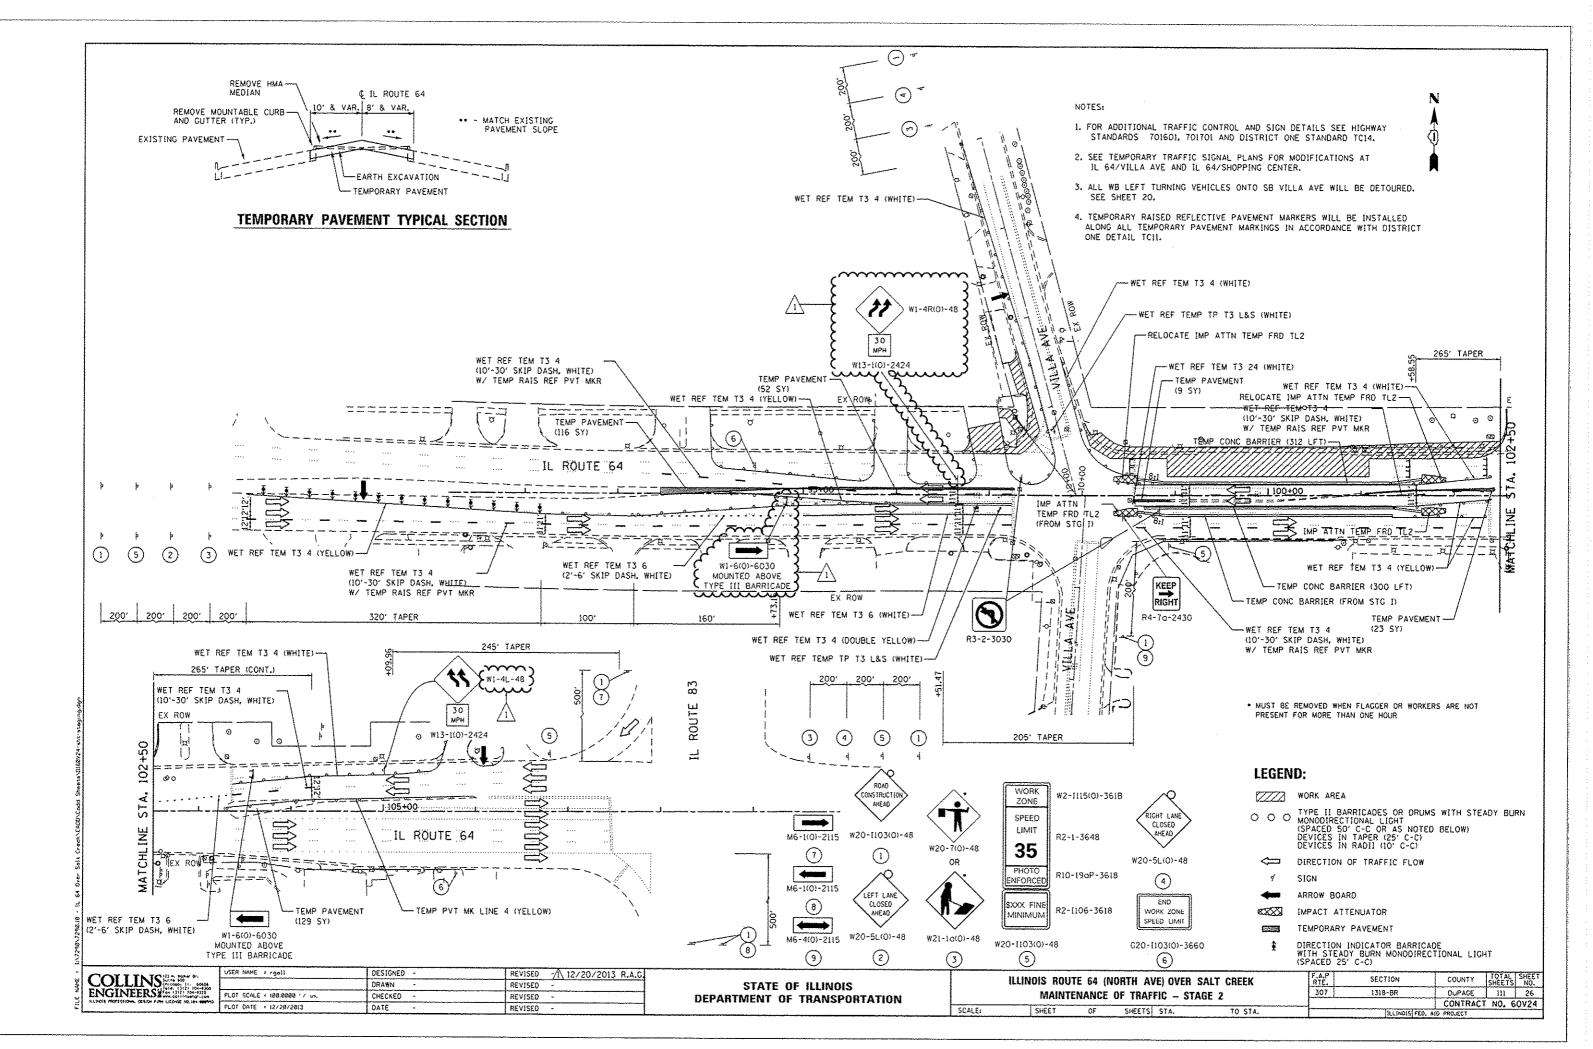

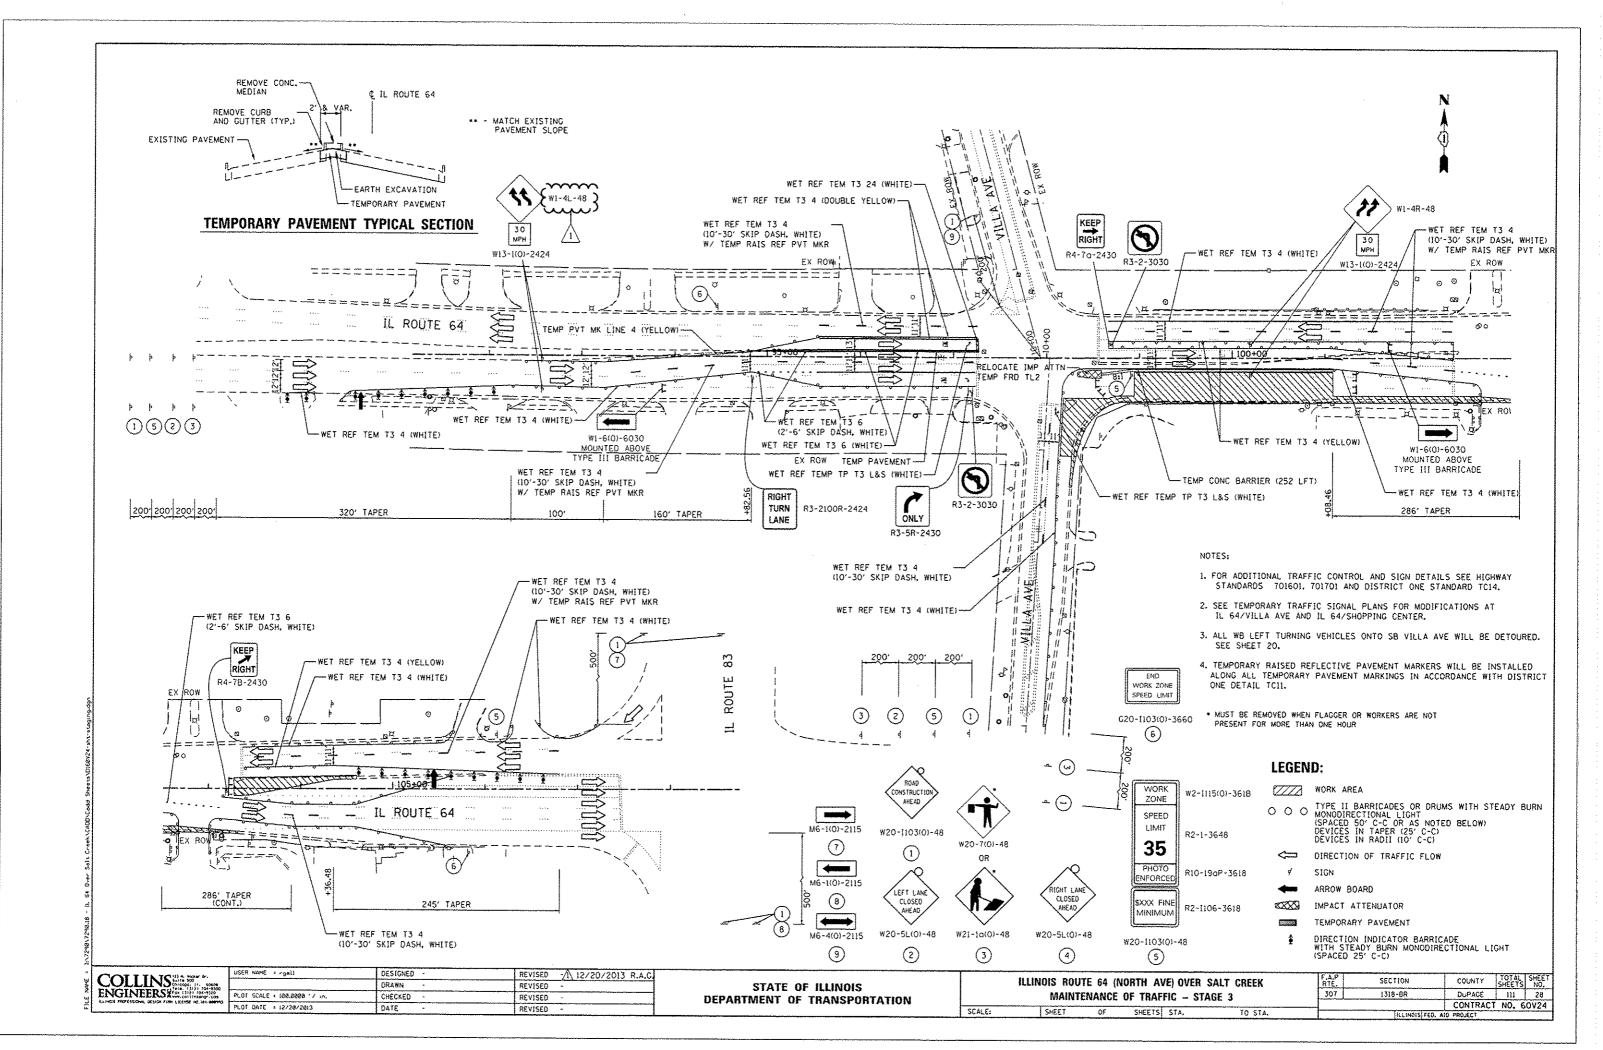

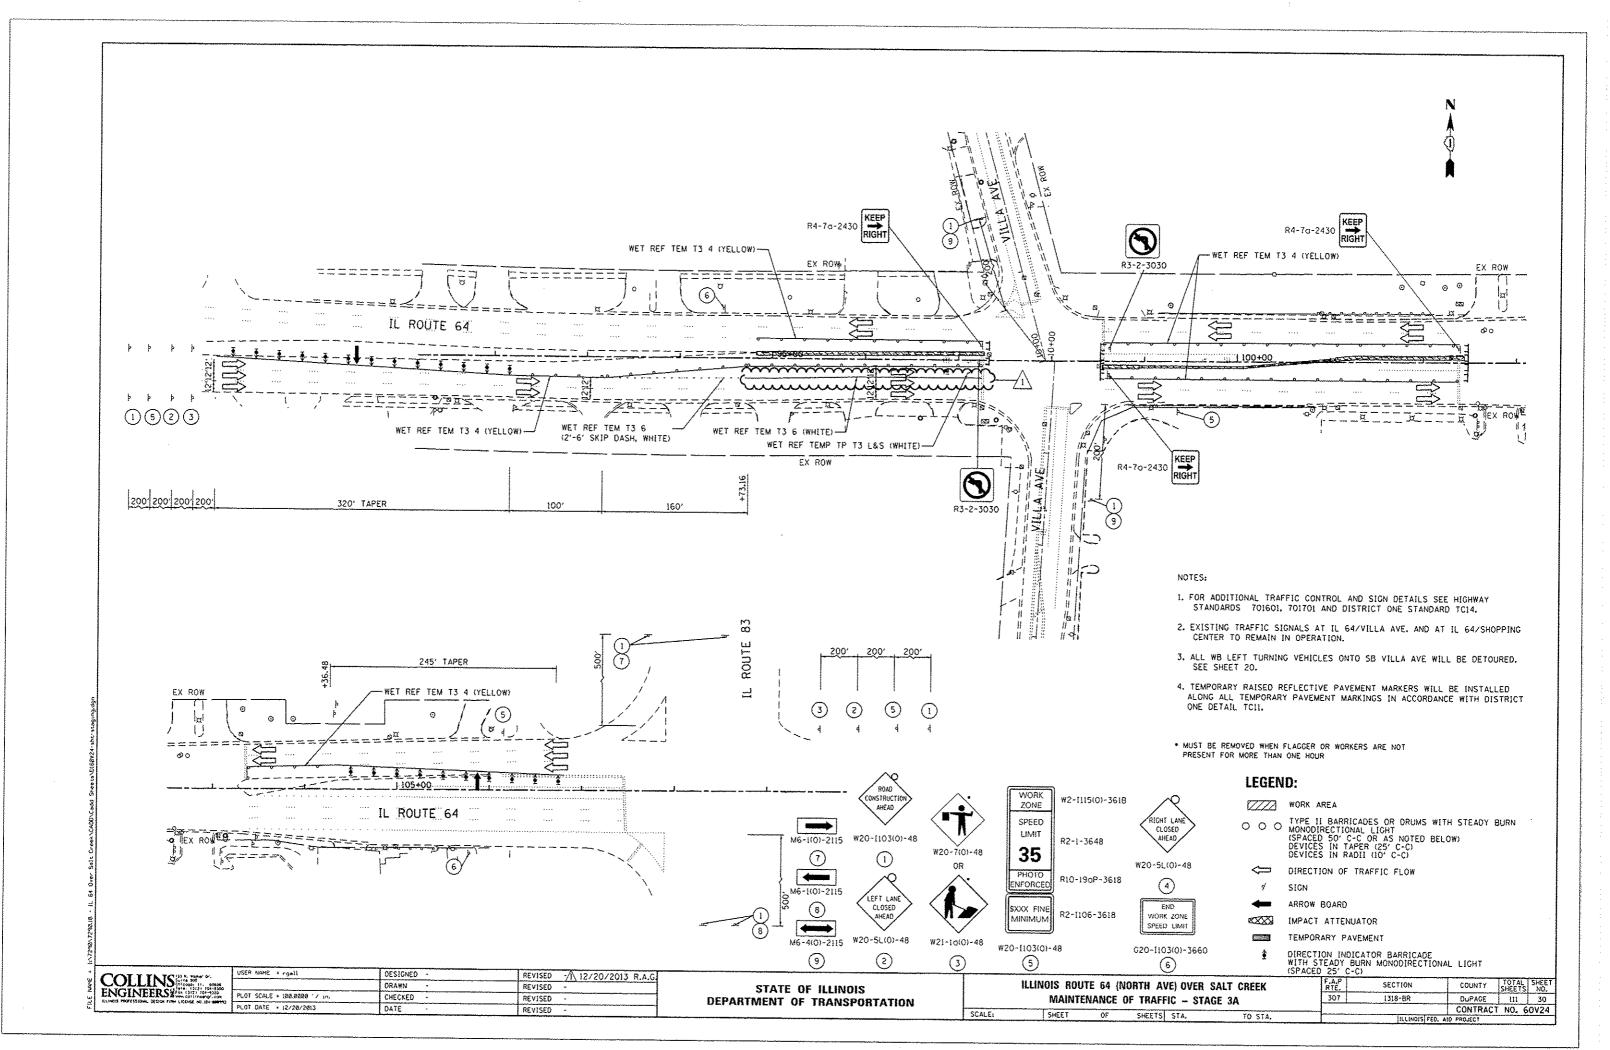

- ALL CONTROL EQUIPMENT INCLUDING EMERGENCY PRE-EMPTION AND COMMUNICATION DEVICES FOR THE TEMPORARY TRAFFIC SIGNAL(S) SHALL BE FURNISHED BY THE CONTRACTOR.
- ONLY CONTROLLERS SUPPLIED BY ONE OF THE DISTRICT APPROVED CLOSED LOOP EQUIPMENT MANUFACTURERS WILL BE APPROVED FOR USE AT TEMPORARY SIGNAL LOCATIONS. ALL CONTROLLERS USED FOR TEMPORARY SIGNALS SHALL BE FULLY ACTUATED NEMA MICROPROCESSOR BASED WITH RS232 DATA ENTRY PORTS COMPATIBLE WITH EXISTING MONITORING SOFTWARE APPROVED BY IDOT DISTRICT 1, INSTALLED IN A NEMA TS2 CABINET. ONLY ONE BRAND OF CONTROLLER WILL BE ACCEPTED FOR ANY ONE CONTRACT.
- ALL TRAFFIC SIGNAL SECTIONS AND PEDESTRIAN SIGNAL SECTIONS SHALL BE LED AND 12"
  (300MM) DIAMETER, HEADS SHALL BE PLACED AS INDICATED ON THE TEMPORARY TRAFFIC
  SIGNAL PLAN OR AS DIRECTED BY THE ENGINEER, PEDESTRIAN SIGNALS SHALL INCLUDE
  SOLID INTERNATIONAL SYMBOLS. PEDESTRIAN SIGNALS WITH COUNTDOWN TIMERS SHALL BE SOLIO INTERNATIONAL SYMBOLS. PEDESTRIAN SIGNALS WITH COUNTDOWN TIMERS SHALL BE USED WHEN THE EXISTING INSTALLATION UTILIZES COUNTDOWN TYPE OR AS DIRECTED BY THE ENGINEER. COUNTDOWN TYPE PEDESTRIAN SIGNALS ARE NOT TO BE INSTALLED AT A RAILROAD INTERSECTION, THE CONTRACTOR SHALL FURNISH ENOUGH CABLE SLACK TO RELOCATE HEADS TO ANY POSITION ON THE SPAN WIRE OR AT LOCATIONS ILLUSTRATED ON THE PLANS FOR CONSTRUCTION STAGING. THE TEMPORARY TRAFFIC SIGNAL HEMAIN IN OPERATION DURING ALL SIGNAL HEAD RELOCATIONS. EACH TEMPORARY TRAFFIC SIGNAL HEAD SHALL HAVE ITS OWN CABLE FROM THE CONTROLLER CABINET TO THE SIGNAL HEAD.
- ALL EXISTING STREET NAME AND INTERSECTION REGULATORY SIGNS SHALL BE REMOVED FROM EXISTING POLES, RELOCATED AND SECURELY FASTENED TO THE SPAN WIRE OR WOOD POLE AS
- ANY TEMPORARY SIGNAL WITHIN AN EXISTING CLOSED LOOP TRAFFIC SIGNAL SYSTEM SHALL BE INTERCONNECTED TO THAT SYSTEM USING SIMILAR BRAND CONTROL EQUIPMENT.
- THE TEMPORARY TRAFFIC SIGNAL SHALL HAVE THE SIGNAL HEAD DISPLAYS, SIGNAL HEAD PLACEMENTS AND CONTROLLER PHASING MATCH THE EXISTING TRAFFIC SIGNAL, AT THE TIME OF THE TURN ON, IF NO TRAFFIC STAGING IS IN PLACE OR WILL NOT BE STAGED ON THE DAY
- UNINTERRUPTIBLE POWER SUPPLY (UPS) SYSTEMS SHALL BE INSTALLED AND MADE OPERATIONAL AT TEMPORARY TRAFFIC SIGNAL INSTALLATIONS WHERE UPS IS INSTALLED AT THE EXISTING TRAFFIC SIGNAL TEMPORARY TRAFFIC SIGNALS AT RAILROAD INTERSECTIONS, AND TEMPORARY TRAFFIC SIGNALS AT INTERSECTIONS WITH FIRE STATION ACTUATED EMERGENCY VEHICLE
- TRAFFIC SIGNAL MANAGEMENT SYSTEMS SHALL BE MAINTAINED IN OPERATION AS INDICATED ON THE PLANS OR AS DIRECTED BY THE ENGINEER, REQUIRED EQUIPMENT SHALL BE AS SHOWN ON THE PLANS AND THE CONTRACTOR HALL PLACE THE EQUIPMENT IN OPERATION TO THE SATISFACTION OF THE ENGINEER AND THE AGENCY RESPONSIBLE FOR THE TRAFFIC SIGNAL MANAGEMENT SYSTEM
- DETECTION AT TEMPORARY TRAFFIC SIGNALS SHALL BE INCLUDED FOR ALL APPROACHES OF THE INTERSECTION UNLESS INDICATED OTHERWISE ON THE PLANS. THE DETECTION SYSTEM MUST MEET THE SPECIFICATION OF DISTRICT 1 AND THE CONTRACTOR SHALL PLACE THE DETECTORS INTO OPERATION TO THE SATISFACTION OF THE ENGINEER,
- 10. WHEN PAN, TILT, ZOOM CAMERAS ARE INSTALLED AT THE EXISTING INTERSECTION OR ARE CALLED FOR IN THE PLANS, THE CONTRACTOR SHALL BE RESPONSIBLE FOR INSTALLING AND MAINTAINING THE CAMERAS TO THE SATISFACTION OF THE ENGINEER AND THE AGENCY

#### GENERAL NOTES:


- IT SHALL BE THE CONTRACTOR'S RESPONSIBILITY TO VERIFY ALL DIMENSIONS AND CONDITIONS EXISTING IN THE FIELD PRIOR TO ORDERING MATERIALS AND BEGINNING CONSTRUCTION. THIS SHALL INCLUDE LOCATING THE MAST ARM FOUNDATIONS AND VERIFYING THE MAST ARMS LENGTHS,
- THE EXACT LOCATION OF ALL UTILITIES SHALL BE FIELD VERIFIED BY THE CONTRACTOR BEFORE ORDERING ANY MATERIALS AND STARTING ANY WORK, FOR LOCATIONS OF UTILITIES, LOCALLY OWNED EQUIPMENT, LEASED ENFORCEMENT CAMERA SYSTEM FACILITIES AND IDOT UNDERGROUND FACILITIES, CONTACT THE LOCAL COUNTIES, MUNICIPALITIES AND IDOT FOR LOCATES, THE CONTRACTOR SHALL CALL JULIE AT 1800) 892-0123 OR 811, IN THE CITY OF CHICAGO, CONTACT DIGGER AT (312) 744-7000 FOR FIELD LOCATIONS OF BURIED UTILITIES (48 HOURS NOTIFICATION REQUIRED).
- THE CONTRACTOR SHALL CHECK THE PROPOSED TRAFFIC SIGNAL EQUIPMENT LOCATIONS FOR OVERHEAD UTILITY CONFLICTS. THE CONTRACTOR SHALL COORDINATE ANY CONFLICTS WITH THE UTILITY COMPANIES AND THE RESIDENT ENGINEER BEFORE ORDERING MATERIALS.
- THE CONTRACTOR SHALL COORDINATE CONSTRUCTION ACTIVITIES WITH UTILITY COMPANIES, LOCAL GOVERNMENT AGENCIES AND IDOT.

#### CONSTRUCTION NOTES:

- THE YELLOW ARROW AND GREEN ARROW INDICATION ON THE 5-SECTION SIGNAL HEAD FOR THE WESTBOUND DIRECTION SHALL BE USED ONLY DURING PRE-CONSTRUCTION AND INTERIM STAGES AND SHALL BE BAGGED AND DISCONNECTED AT THE CONTROLLER DURING CONSTRUCTION STAGES
- THE CONTRACTOR SHALL RELOCATE THE EXISTING EMERGENCY VEHICLE PRIORITY SYSTEM EQUIPMENTS TO THE PROPOSED MAST ARMS.
- ALL NEW LED TRAFFIC SIGNAL HEADS AND TRAFFIC SIGNAL BACKPLATES INSTALLED UNDER IDOT CONTRACT 60WOO WILL BE RETURNED TO THE STATE.

CONTRACTOR SHALL RELOCATE THE EXISTING 5-SECTION SIGNAL HEAD. (SEE SHEET 55)

RESTORATION OF WORK AREA
RESTORATION OF THE TRAFFIC SIGNAL WORK AREA SHALL BE INCLUDED IN THE
RELATED PAY ITEM SUCH AS FOUNDATION, CONDUIT, HANDHOLE, ETC., AND NO EXTRA COMPENSATION SHALL BE ALLOWED. ALL ROADWAY SURFACES SUCH AS SHOULDERS, MEDIAN, SIDEWALKS, PAVEMENT. ETC. SHALL BE REPLACED IN KIND. ALL DAMAGE TO MOWED LAWNS SHALL BE REPLACED WITH AN APPROVED SOD, AND ALL DAMAGED TO UNMOWED FIELDS SHALL BE SEEDED IN ACCORDANCE WITH STANDARD SPECIFICATIONS 252 AND 250 RESPECTIVELY.

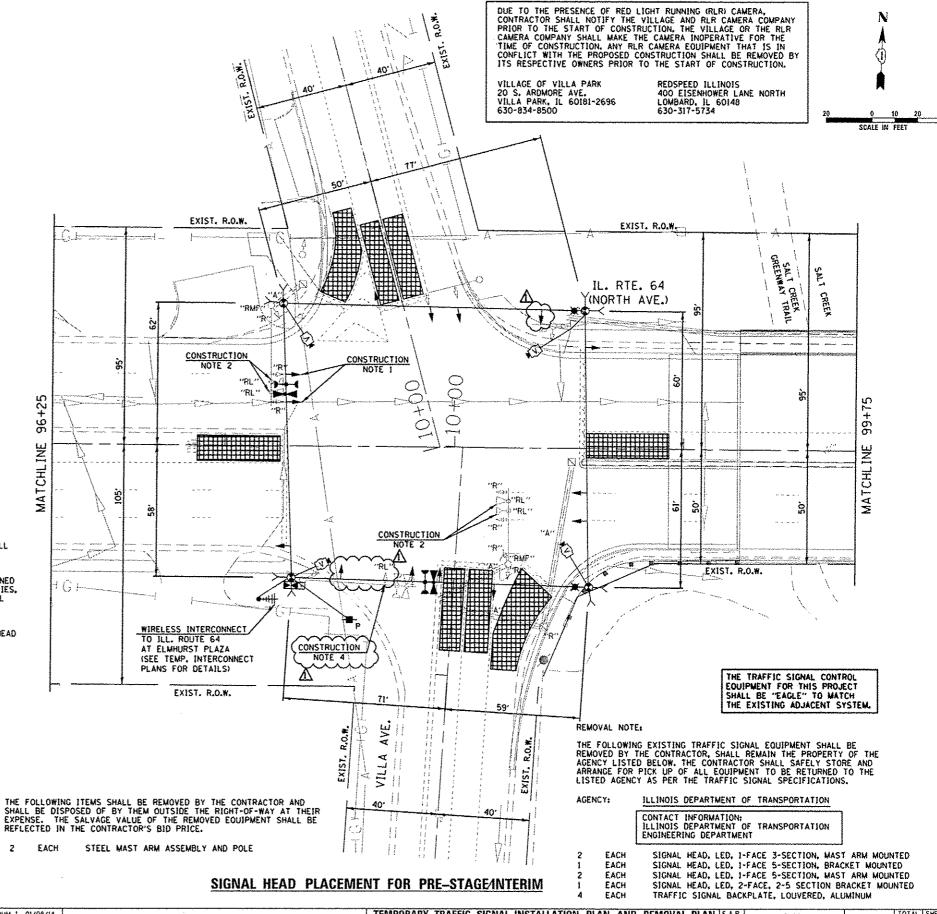


SINGH USER NAME - INGARVIDA


DESIGNED - NG REVISED A- ADDENDUM 1 01/08/14 DRAWN - MG REVISED -PLOT SCALE . 48,0600001,80000 CHECKED - KGP REVISED SNOH - ASSOCIATE, INC.
CONSULTING ENGINEES PLOY DATE = 88-JAN-2614 15:54 REVISED DATE - 10/25/2013


STATE OF ILLINOIS **DEPARTMENT OF TRANSPORTATION** 

TEMPORARY TRAFFIC SIGNAL INSTALLATION PLAN AND REMOVAL PLAN F.A.P. COUNTY TOTAL SHEET NO.

DUPAGE 111 50 SECTION ILLINOIS ROUTE 64 (NORTH AVENUE) AT VILLA AVENUE 1318-88 PRE-STAGE/INTERIM CONTRACT NO. 60V24 SCALE: AS NOTED SHEET NO. 7 OF 26 SHEETS STA. TO STA.

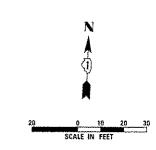

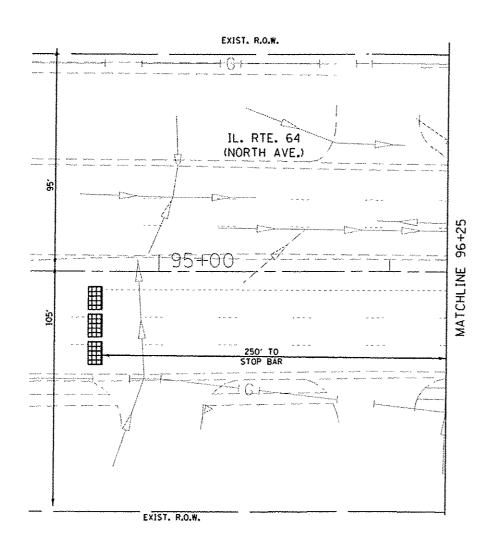

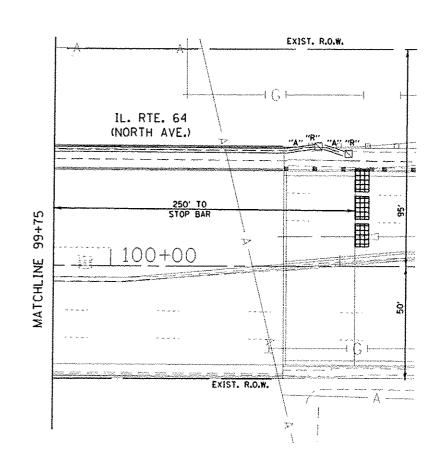

CONSTRUCTION NOTES:

1. FAR OUT VIDEO DETECTION ZONES SHALL BE REDEFINED FOR EACH CONSTRUCTION STAGE AS NECESSARY. THIS WORK SHALL BE PART OF "TEMPORARY TRAFFIC SIGNAL INSTALLATION."


THE TRAFFIC SIGNAL CONTROL EQUIPMENT FOR THIS PROJECT SHALL BE "EAGLE" TO MATCH THE EXISTING ADJACENT SYSTEM.


5	*	N	G	H	
•	Ħ	# #	v	##	Γ
		A HON	MOCAL NO IND	STANC PAREN	r


ı	USER NAME * mgorvida	DESIGNED -	MG	REVISED A - ADDENOUM 1 01/08/14
ı		DRAWN -	MG	REVISED -
ı	PLOT SCALE • 49.0000001.0000000	CHECKED -	KGP	REVISED -
ā	PLOT DATE = 98-JAN-2014 15:54	DATE -	10/25/2013	REVISED -
		· · · · · · · · · · · · · · · · · · ·		<del></del>


STATE OF ILLINOIS
DEPARTMENT OF TRANSPORTATION

*****	TEMPORARY TR	AFFIC SIGNA	L INSTALLATI	ON PLA	N AND	REMOVAL PLAN	F.A.P. RTE.	SECTION	COUNTY	TOTAL	SHEET NO.
ı	ILLINOIS ROUTE 64 (NORTH AVENUE) AT VILLA AVENUE							131B-BR	DUPAGE	111	5;
į			PRE-STAG	<del></del>					CONTRACT	NO. 6	60V24
L	SCALE: AS NOTED	SHEET NO. 8	OF 26 SHEETS	STA.	TO ST	Δ,		ILLINOIS FED, A	O PROJECT		

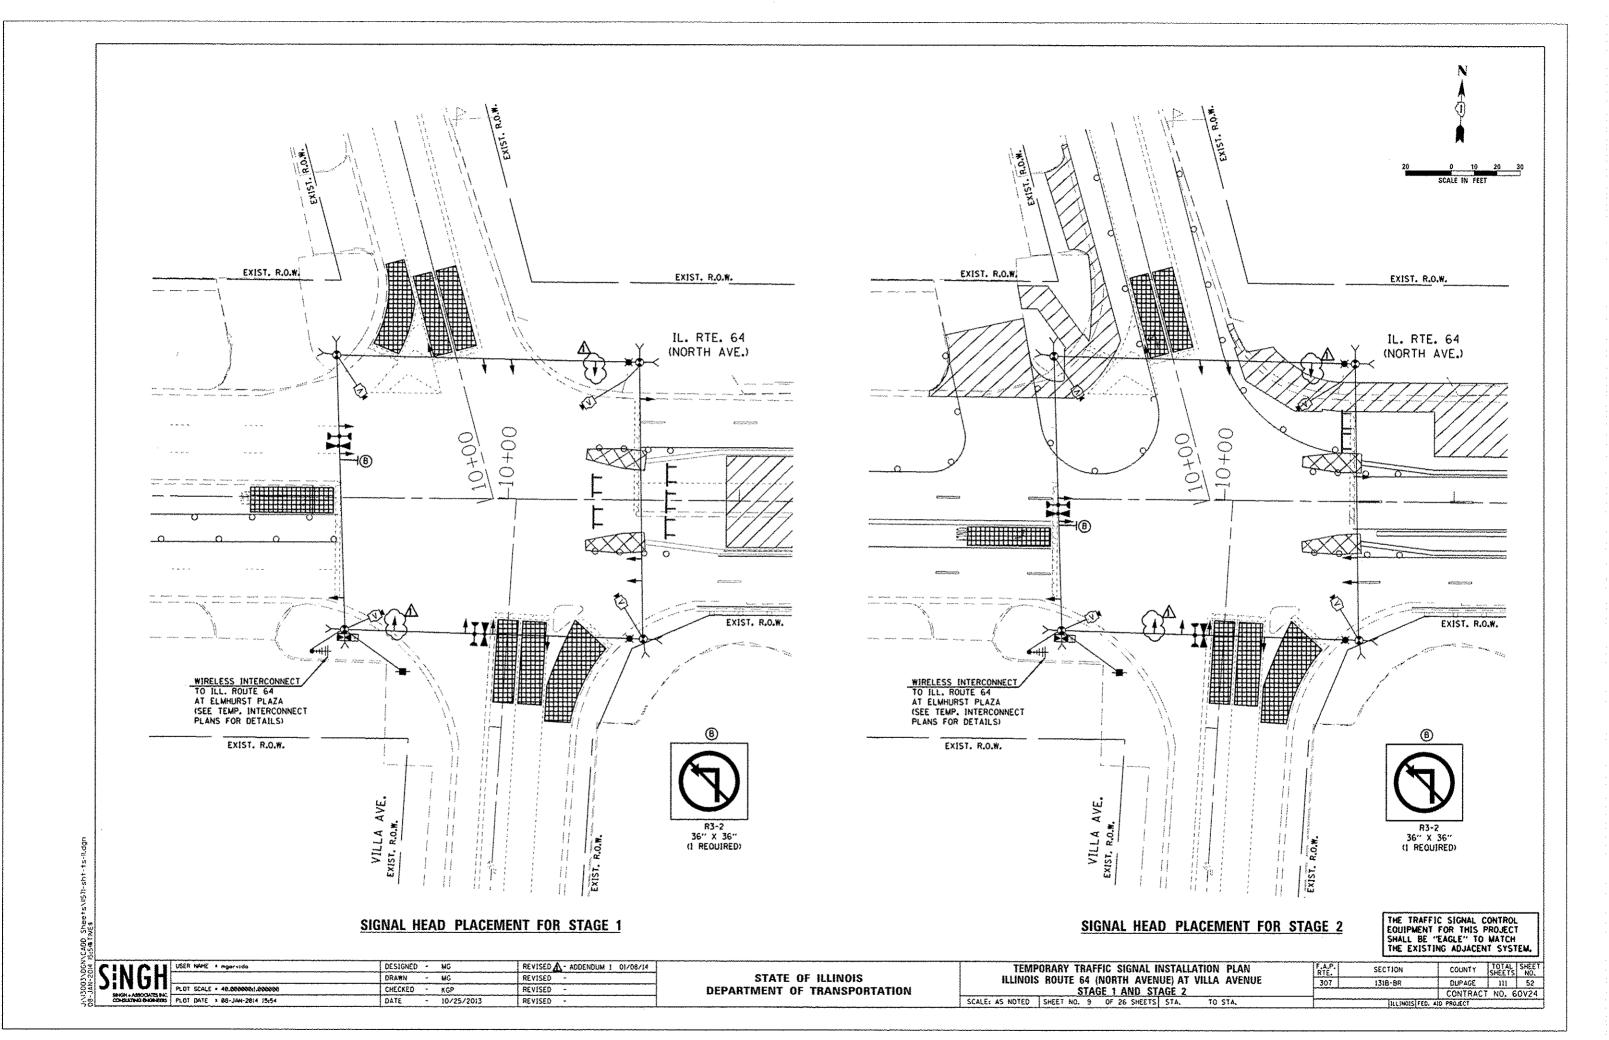

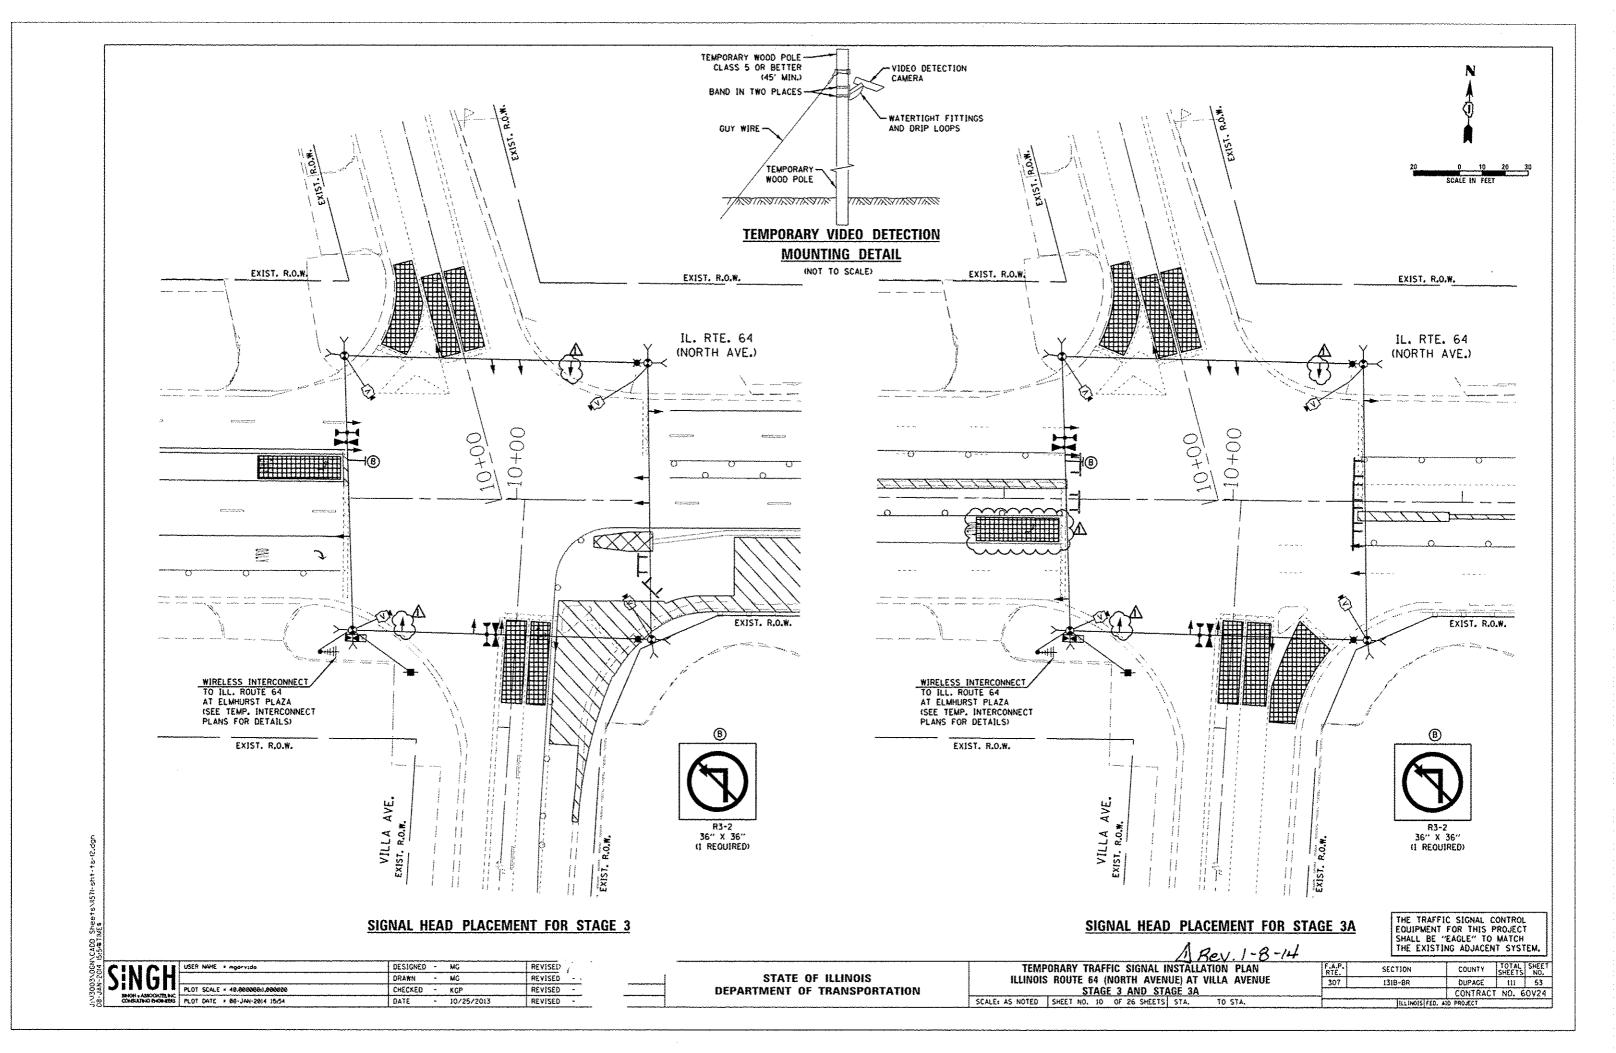

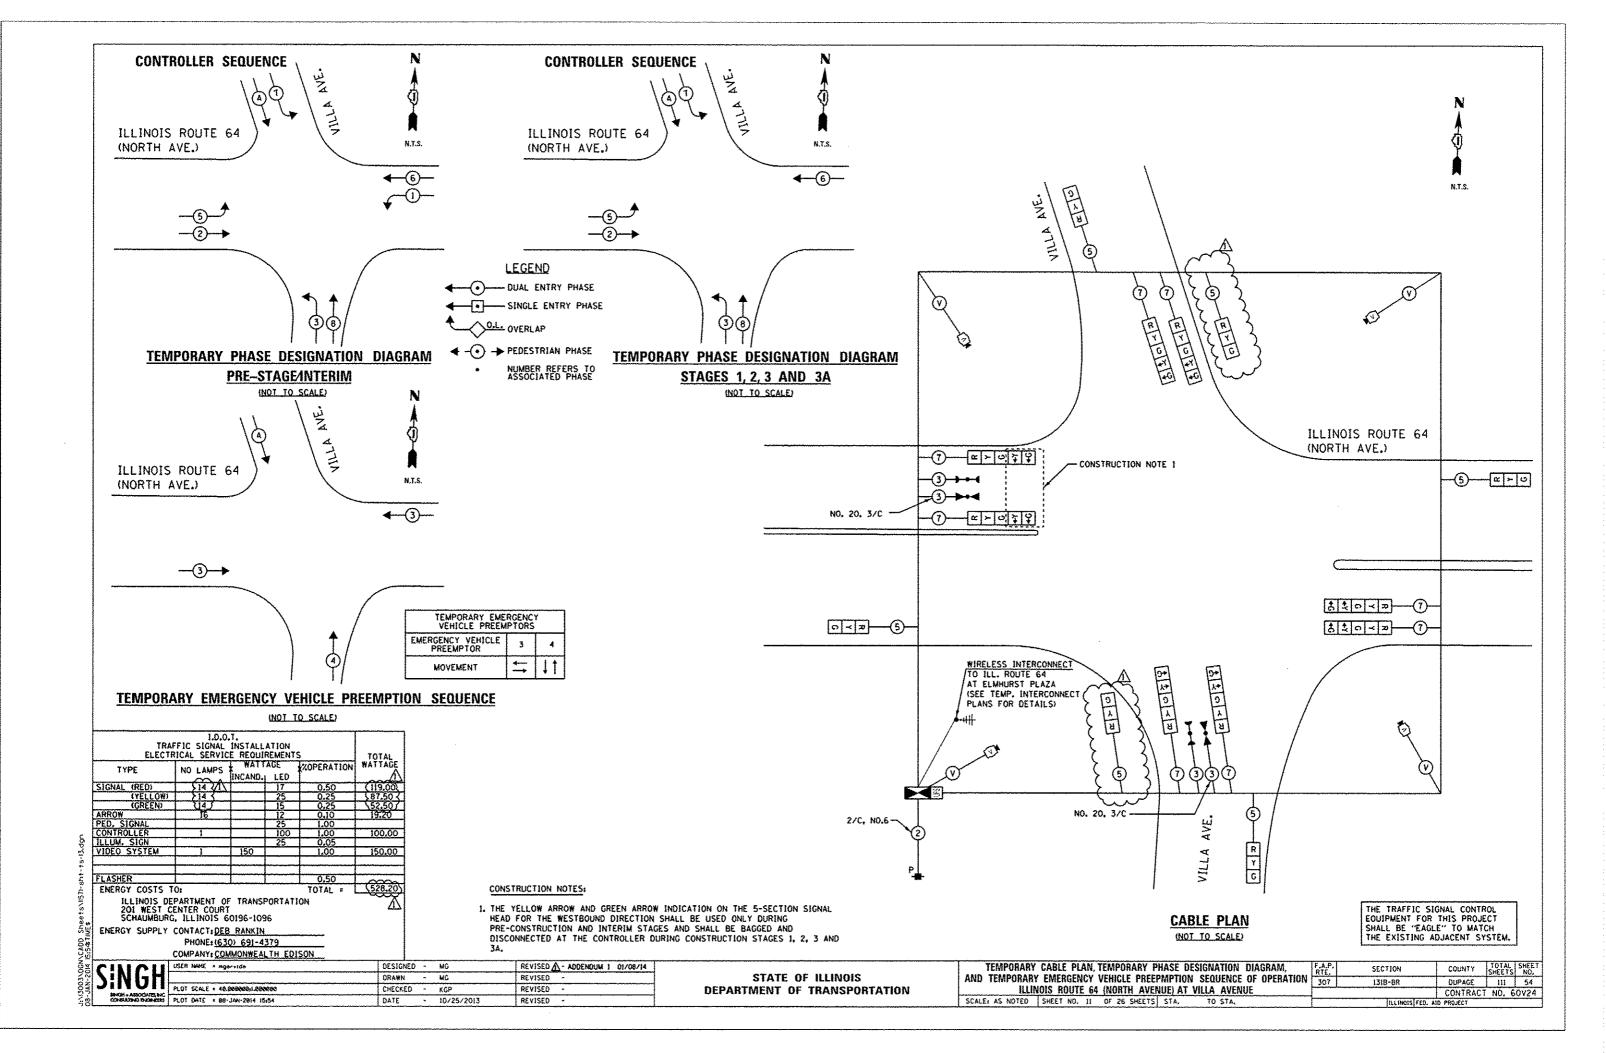

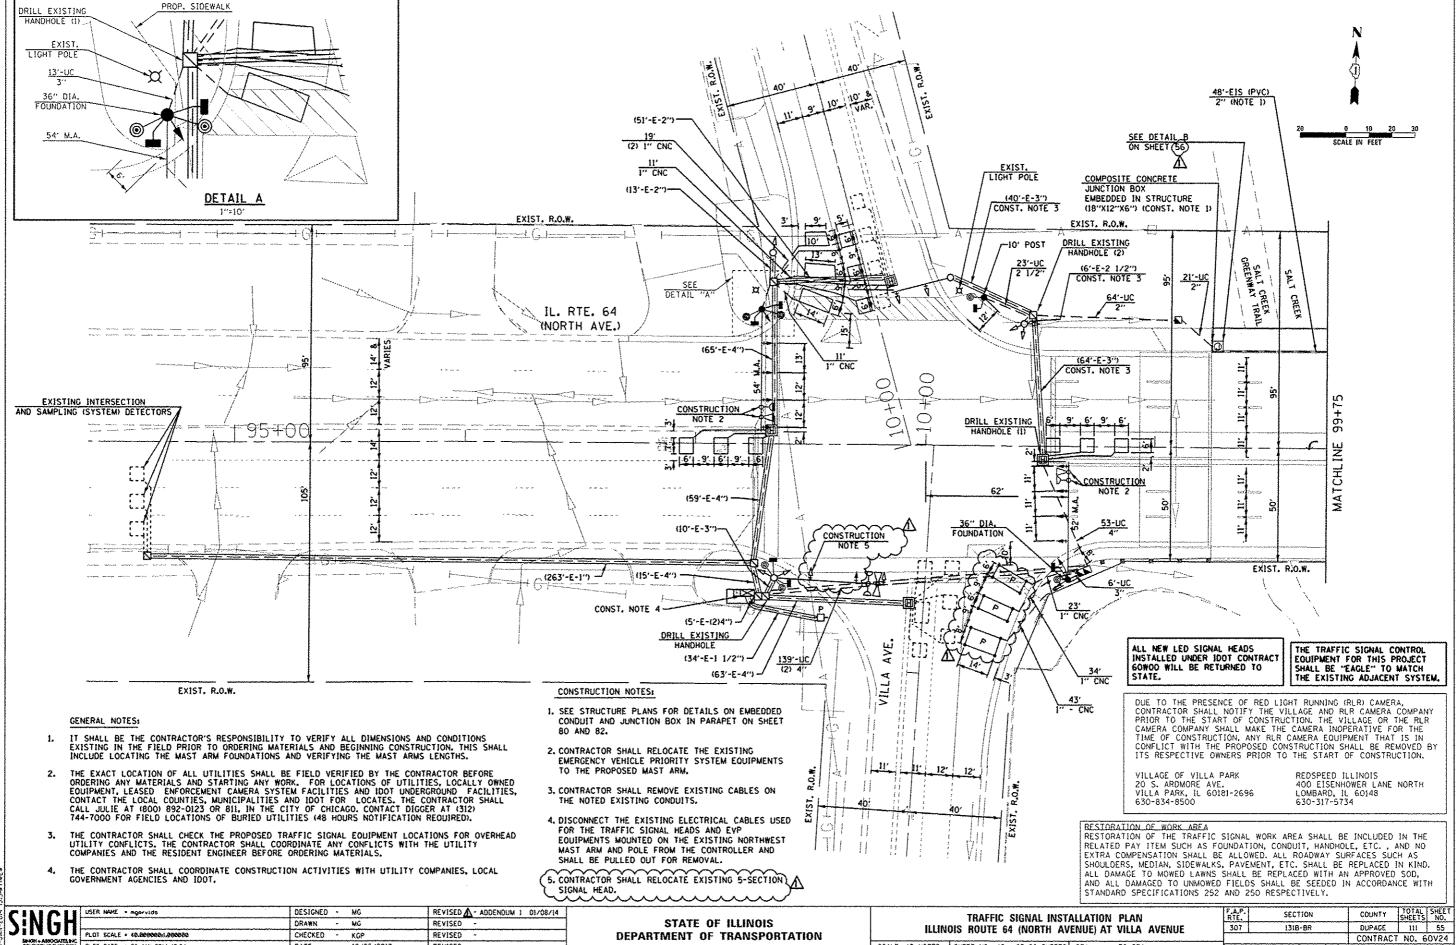

DEPARTMENT OF TRANSPORTATION

SCALE: AS NOTED SHEET NO. 12 OF 26 SHEETS STA.

TO STA.

CONTRACT NO. 60V24

SHIGH+ASSOCIATES PLOT DATE - 88-JAN-2814 15:54


CHECKED - KGP

- 10/25/2013

DATE

REVISED


REVISEO

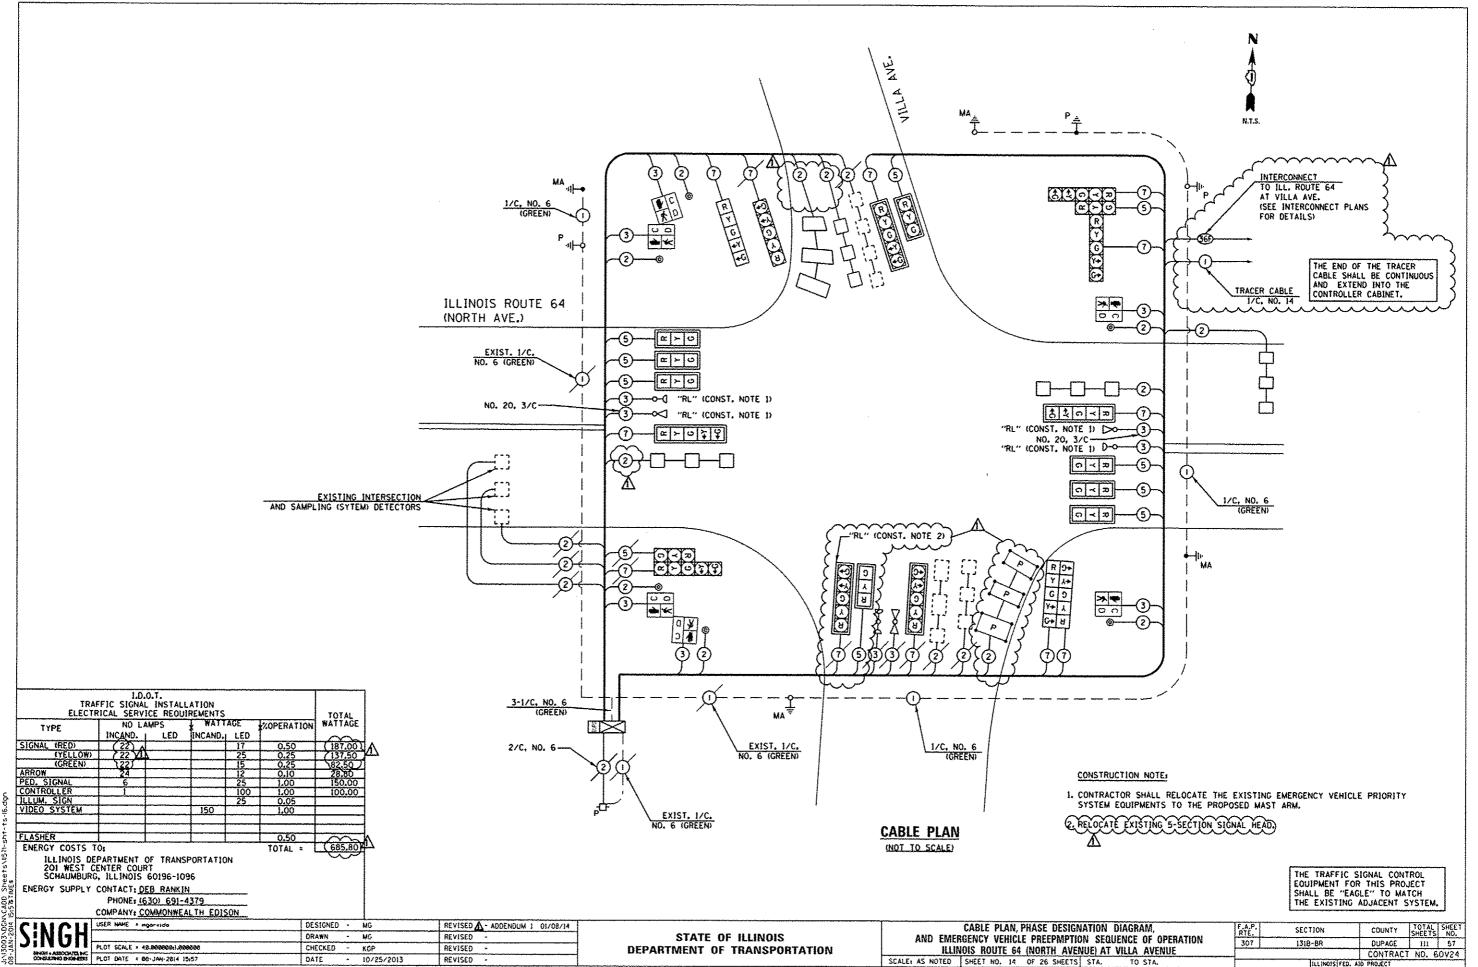



ILLINOIS FED. AID PROJECT

#### SCHEDULE OF QUANTITIES

QU.	ANTITY	UNIT	ITEM
	6	SQ FT	SIGN PANEL - TYPE 1
	129	FOOT	UNDERGROUND CONDUIT, GALVANIZED STEEL, 2° DIA
	23	FOOT	UNDERGROUND CONDUIT, GALVANIZED STEEL, 2 1/2" DIA,
	19	FOOT	UNDERGROUND CONDUIT, GALVANIZED STEEL, 3" DIA
	331	FOOT	UNDERGROUND CONDUIT, GALVANIZED STEEL, 4° DIA.
	146	FOOT	CONDUIT EMBEDDED IN STRUCTURE, 2" DIA, PVC
	2	EACH	JUNCTION 80X EMBEDDED IN STRUCTURE 18" X 12" X 6"
	2	EACH	HANDHOLE
	1	EACH	DOUBLE HANDHOLE
	1029	FOOT	ELECTRIC CABLE IN CONDUIT, SIGNAL NO. 14 2C
	1594	FOOT	ELECTRIC CABLE IN CONDUIT, SIGNAL NO. 14 3C
K	2246	FOOT	ELECTRIC CABLE IN CONDUIT, SIGNAL NO. 14 5C
/	2189	FOOT	ELECTRIC CABLE IN CONDUIT, SIGNAL NO. 14 7C
/ (	1544)	FOOT	ELECTRIC CABLE IN CONDUIT, LEAD-IN, NO. 14 1 PAIR
//	415	FOOT	ELECTRIC CABLE IN CONDUIT, EQUIPMENT GROUNDING CONDUCTOR, NO. 6 1C
//	1	EACH	TRAFFIC SIGNAL POST, 10 FT.
//	1	EACH	STEEL MAST ARM ASSEMBLY AND POLE, 52 FT.
//	1	EACH	STEEL MAST ARM ASSEMBLY AND POLE, 54 FT.
//	4	TOOT	CONCRETE FOUNDATION, TYPE A
//	30	FOOT	CONCRETE FOUNDATION, TYPE E 36-INCH DIAMETER
//	4	EACH	DRILL EXISTING HANDHOLE
	1	EACH	DRILL EXISTING HEAVY DUTY HANDHOLE
4\	$\mathfrak{D}$	EACH	SIGNAL HEAD, LED, 1-FACE, 3-SECTION, MAST-ARM MOUNTED
1	1	EACH	SIGNAL HEAD, LED, 1-FACE, 5-SECTION, BRACKET MOUNTED
//	2	EACH	SIGNAL HEAD, LED, 1-FACE, 5-SECTION. MAST-ARM MOUNTED
	1	EACH	SIGNAL HEAD, LED, 2-FACE, 5-SECTION, BRACKET MOUNTED
	2	EACH	PEDESTRIAN SIGNAL HEAD, LED, 1-FACE, BRACKET MOUNTED WITH COUNTDOWN TIMER
	2	EACH	PEDESTRIAN SIGNAL HEAD, LED, 2-FACE, BRACKET MOUNTED WITH COUNTDOWN TIMER
\ \ \	ا کرو	EACH	TRAFFIC SIGNAL BACKPLATE, LOUVERED, ALUMINUM
/ }	616	FOOT	DETECTOR LOOP, TYPE I
) {	135	FOOT	PREFORMED DETECTOR LOOP
\	6	EACH	PEDESTRIAN PUSH-BUTTON
\	1	EACH	TEMPORARY TRAFFIC SIGNAL INSTALLATION
Y	$\alpha$	<b>EACH</b>	RELOCATE EXISTING SIGNAL HEAD
*	2	EACH	RELOCATE EXISTING EMERGENCY VEHICLE PRIORITY SYSTEM, DETECTOR UNIT
	1	EACH	MODIFY EXISTING CONTROLLER CABINET
	1996	FOOT	REMOVE ELECTRIC CABLE FROM CONDUIT
	1	EACH	remove existing traffic signal equipment
	2	EACH	REMOVE EXISTING HANDHOLE
	2	EACH	REMOVE EXISTING CONCRETE FOUNDATION
*	523	FOOT	EMERGENCY VEHICLE PRIORITY SYSTEM LINE SENSOR CABLE, NO. 20 3/C
	1	EACH	TEMPORARY TRAFFIC SIGNAL TIMING
* 100%	COST TO VII	LAGE OF	VILLA PARK

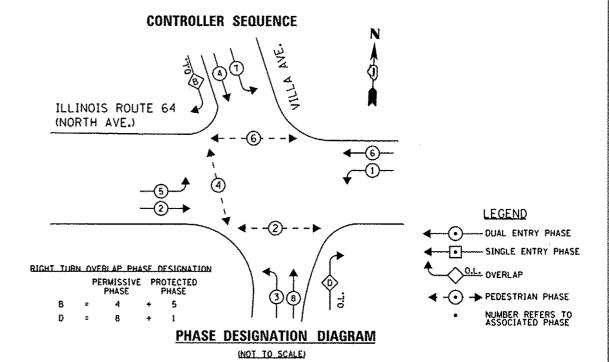

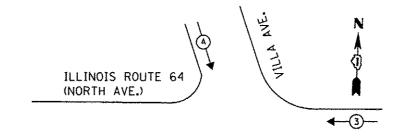

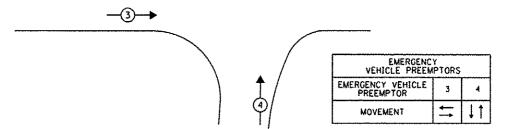

# EMERGENCY VEHICLE PREEMPTION SEQUENCE

(NOT TO SCALE)


THE TRAFFIC SIGNAL CONTROL EQUIPMENT FOR THIS PROJECT SHALL BE "EAGLE" TO MATCH THE EXISTING ADJACENT SYSTEM.

CINICII USER NAME = mgarvida	DESIGNED - MG	REVISED A - ADDENDUM 1 01/08/14
SINGH USER NAME * mgarvido	DRAWN - MG	REVISEO -
PLOT SCALE > 48,9999881,899999	CHECKED - KGP	REVISED -
CONSIDERATING ENGINEERS PLOT DATE × 88-JAN-2814 15:54	DATE - 10/25/2013	REVISED -

STATE OF ILLINOIS
DEPARTMENT OF TRANSPORTATION

PHASE DESIGNATION DIAGRAM, EMERGENCY VEHICLE PREEMPTION SEQUENCE OF OPERATION, AND SCHEDULE OF QUANTITIES ILLINOIS ROUTE 64 (NORTH AVENUE) AT VILLA AVENUE

SCALE; AS NOTED SHEET NO. 15 OF 26 SHEETS STA. TO STA.

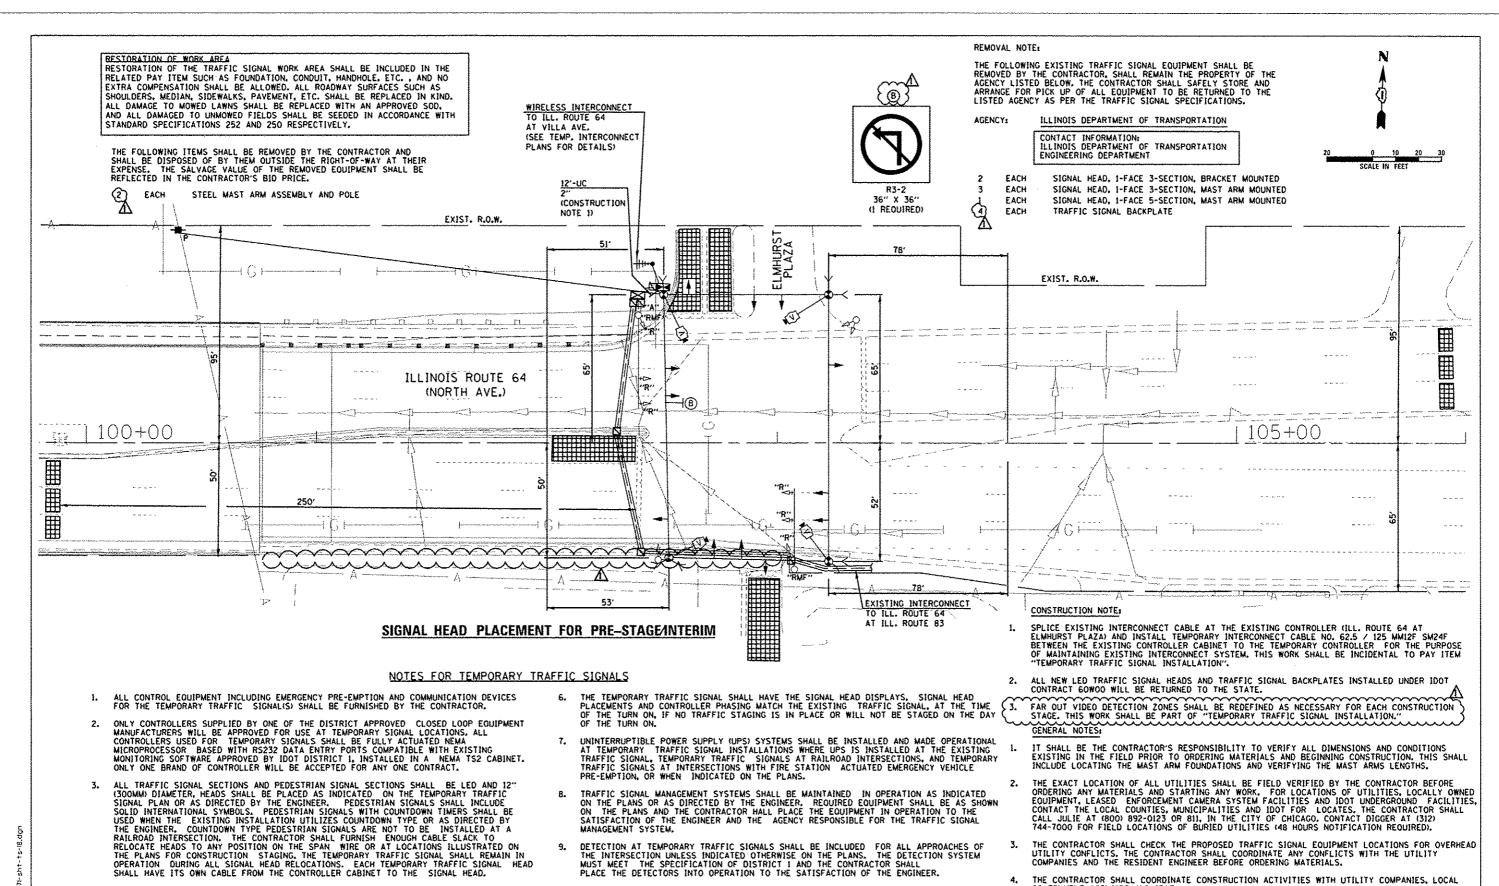

- SINGH USER NAME . moorvide DESIGNED - MG DRAWN PLOT SCALE . 48.800008:1.0000 CHECKED - KOP PLOT DATE : 88-JAN-2814 15:55 DATE

ALL EXISTING STREET NAME AND INTERSECTION REGULATORY SIGNS SHALL BE REMOVED FROM EXISTING POLES. RELOCATED AND SECURELY FASTENED TO THE SPAN WIRE OR WOOD POLE AS

ANY TEMPORARY SIGNAL WITHIN AN EXISTING CLOSED LOOP TRAFFIC SIGNAL SYSTEM SHALL BE INTERCONNECTED TO THAT SYSTEM USING SIMILAR BRAND CONTROL EQUIPMENT.

- MG

- 10/25/2013

REVISED A- ADDENDUM 1 01/08/14

REVISED

REVISED

REVISED

TEMPORARY TRAFFIC SIGNAL INSTALLATION PLAN AND REMOVAL PLAN F.A. ILLINOIS ROUTE 64 (NORTH AVENUE) AT ELMHURST PLAZA PRE-STAGE/INTERIM SCALE: AS NOTED SHEET NO. 16 OF 26 SHEETS STA. TO STA.

THE EXISTING ADJACENT SYSTEM. TOTAL SHEET SHEETS NO. SECTION 131B-BR DUPAGE 111 59

THE TRAFFIC SIGNAL CONTROL EQUIPMENT FOR THIS PROJECT

SHALL BE "EAGLE" TO MATCH


STATE OF ILLINOIS DEPARTMENT OF TRANSPORTATION

PLACE THE DETECTORS INTO OPERATION TO THE SATISFACTION OF THE ENGINEER.

WHEN PAN, TILT, ZOOM CAMERAS ARE INSTALLED AT THE EXISTING INTERSECTION OR ARE CALLED FOR IN THE PLANS, THE CONTRACTOR SHALL BE RESPONSIBLE FOR INSTALLING AND MAINTAINING THE CAMERAS TO THE SATISFACTION OF THE ENGINEER AND THE AGENCY RESPONSIBLE FOR THE CAMERAS

307 CONTRACT NO. 60V24 ILLINOIS FED. AID PROJECT

THE CONTRACTOR SHALL COORDINATE CONSTRUCTION ACTIVITIES WITH UTILITY COMPANIES, LOCAL GOVERNMENT AGENCIES AND IDOT.

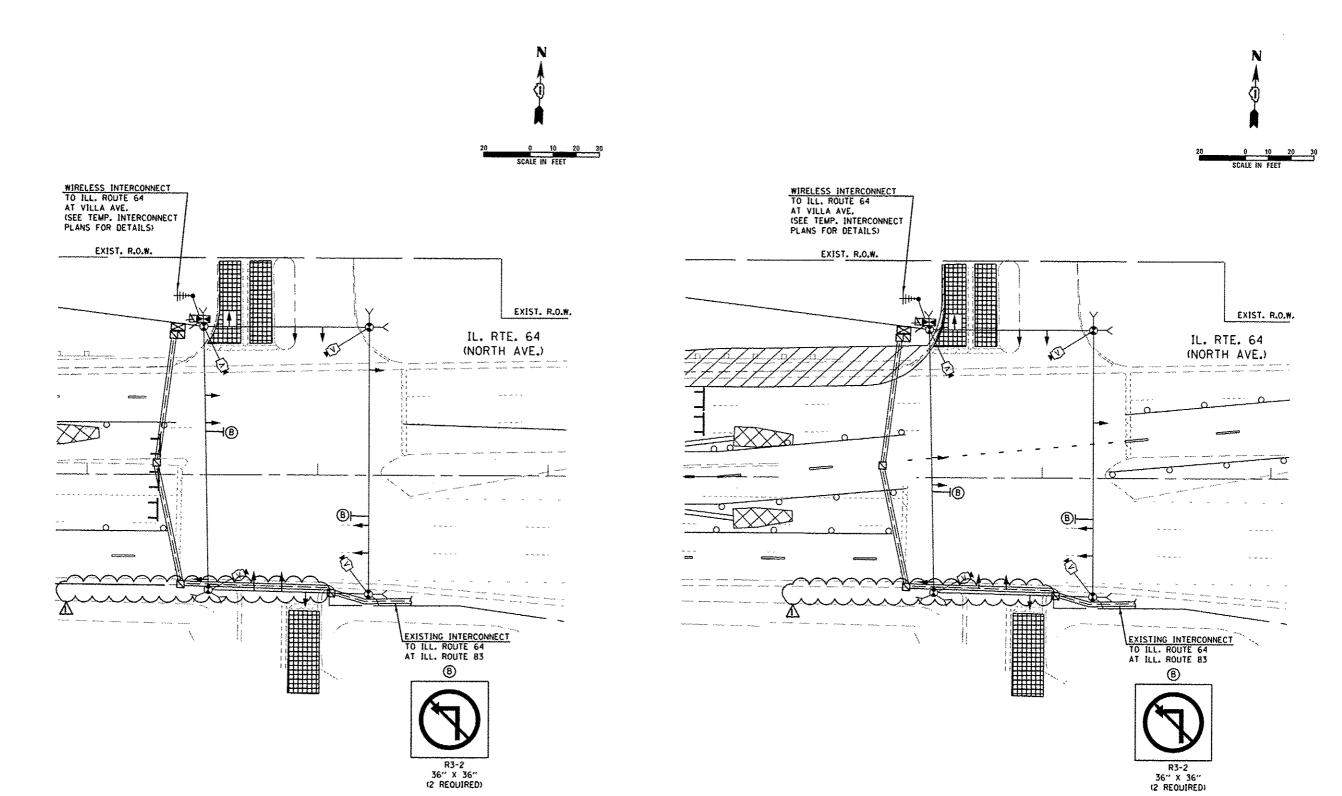

# SIGNAL HEAD PLACEMENT FOR STAGE 1

REVISED A - ADDENDUM 1 01/08/14

REVISED .

REVISED

REVISED

# SIGNAL HEAD PLACEMENT FOR STAGE 2

THE TRAFFIC SIGNAL CONTROL EQUIPMENT FOR THIS PROJECT SHALL BE "EAGLE" TO MATCH THE EXISTING ADJACENT SYSTEM.


C	MOH	USER NAME * mgorvido	DESIGNED	-	MC
•	!NI:H		DRAWN		MG
•	SHORI + ADSCRIPTION	PLOT SCALE . 48,05000001,000000	CHECKED	-	KGP
	CONSULTAND BHON 2335	PLOT DATE * 88-JAN-2814 15:55	DATE	-	10/25/2013
			· · · · · · · · · · · · · · · · · · ·		

STATE OF ILLINOIS
DEPARTMENT OF TRANSPORTATION


TEMPORARY TRAFFIC SIGNAL INSTALLATION PLAN
ILLINOIS ROUTE 64 (NORTH AVENUE) AT ELMHURST PLAZA
STAGE 1 AND STAGE 2


SCALE: AS NOTED SHEET NO. 17 OF 26 SHEETS STA. TO STA.

Es

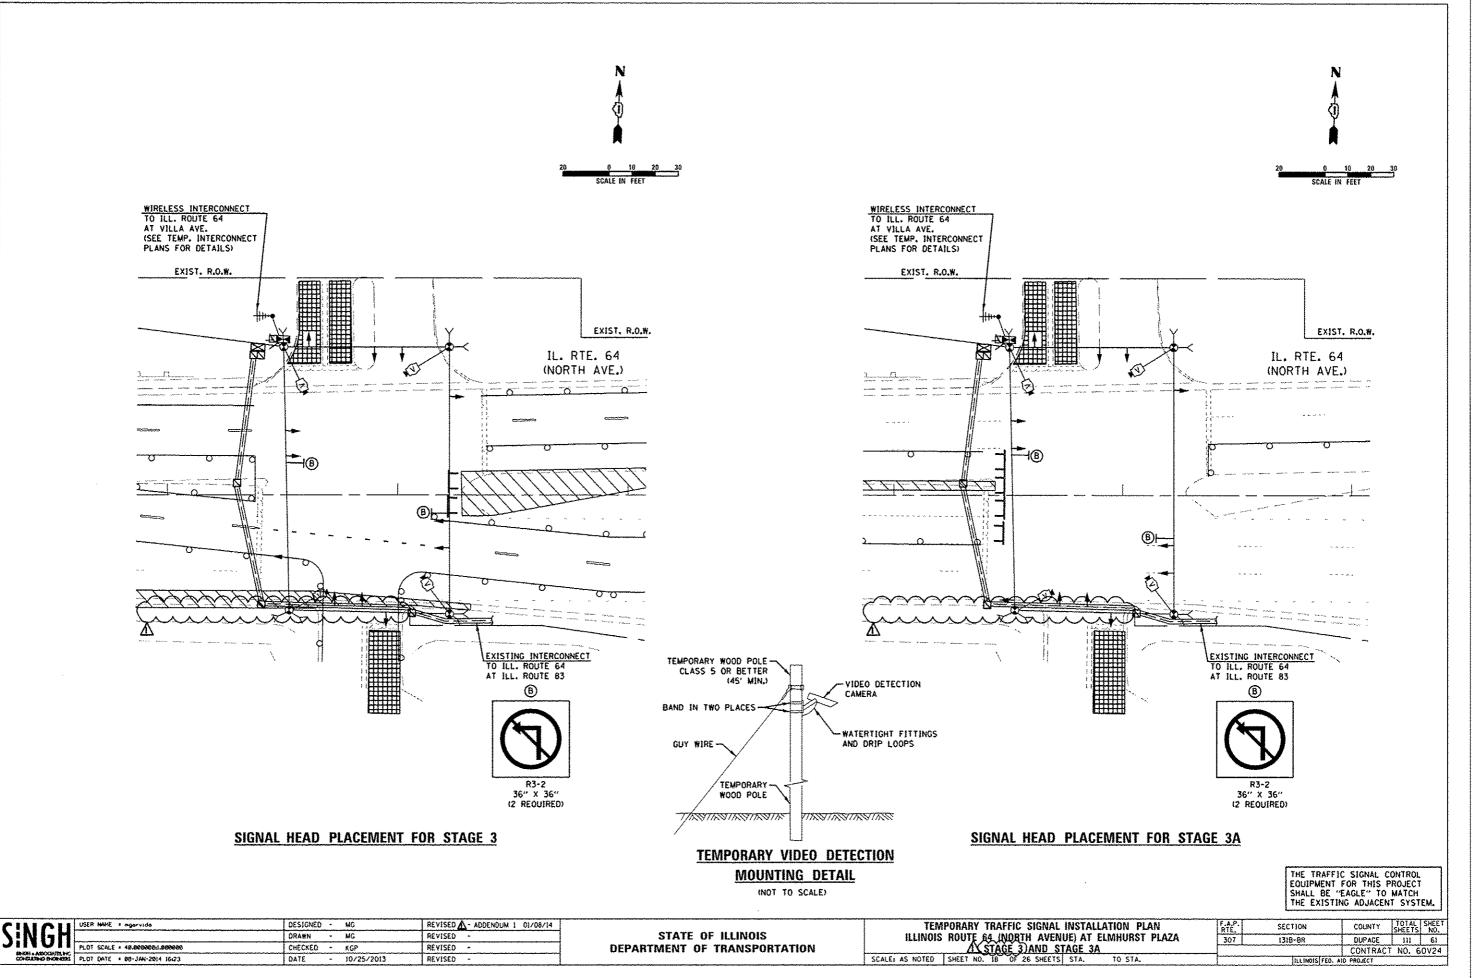

3\DGN\CADD Sheets\#571-sht-ts-20.dg

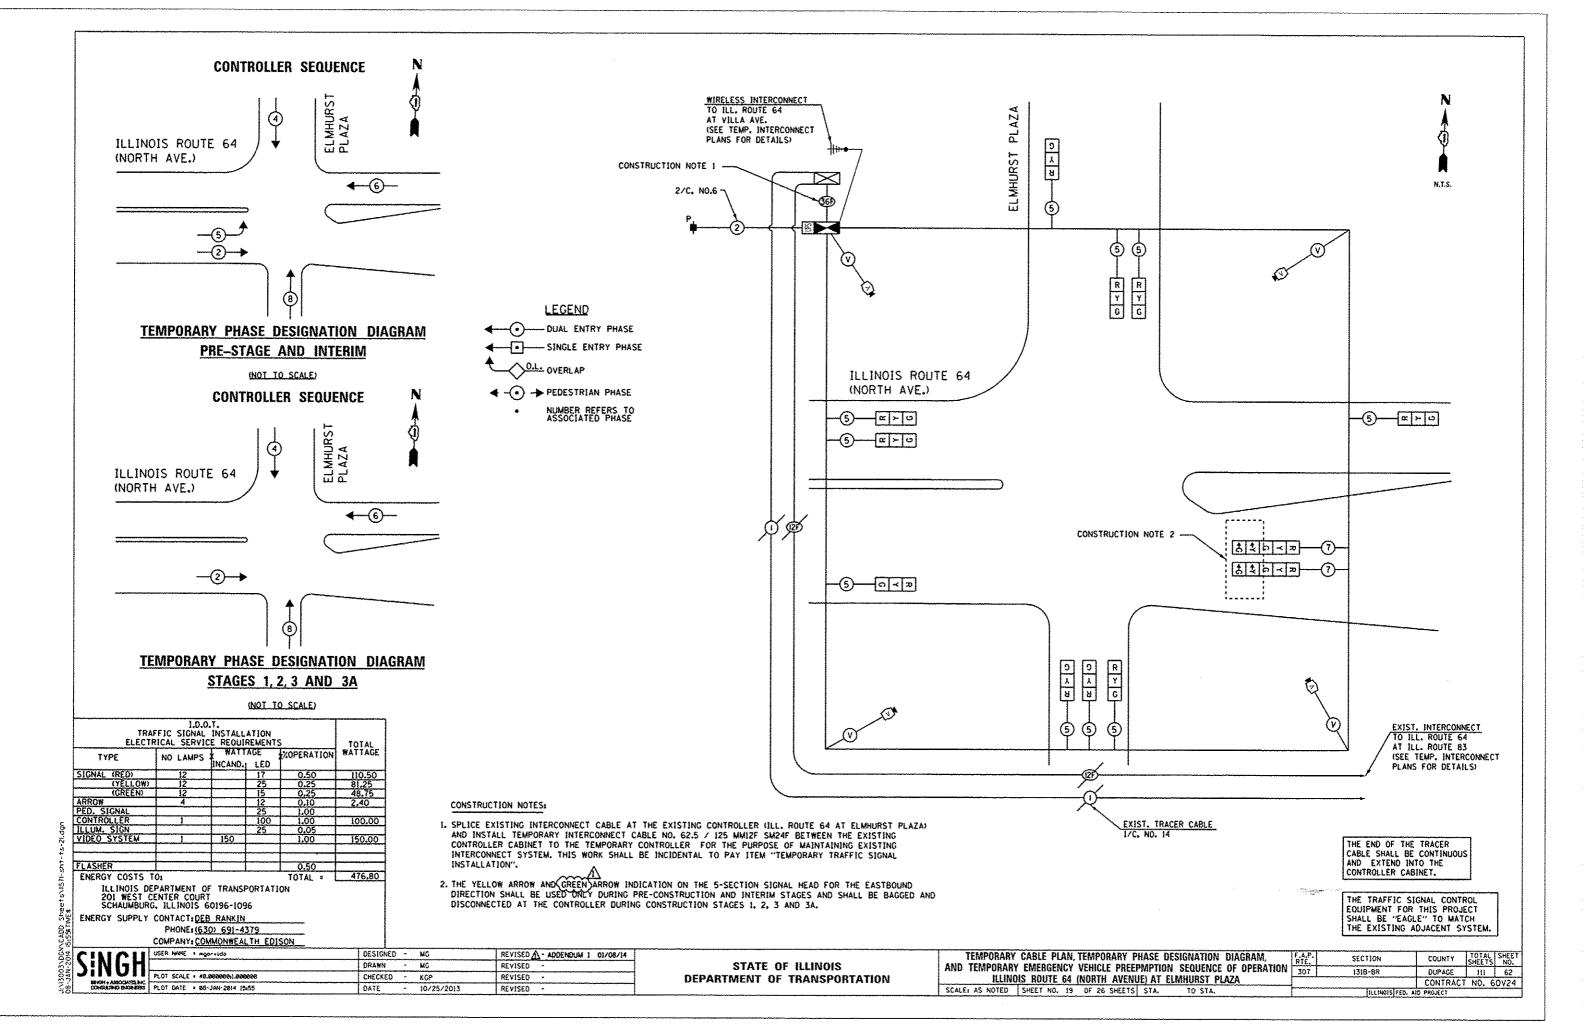

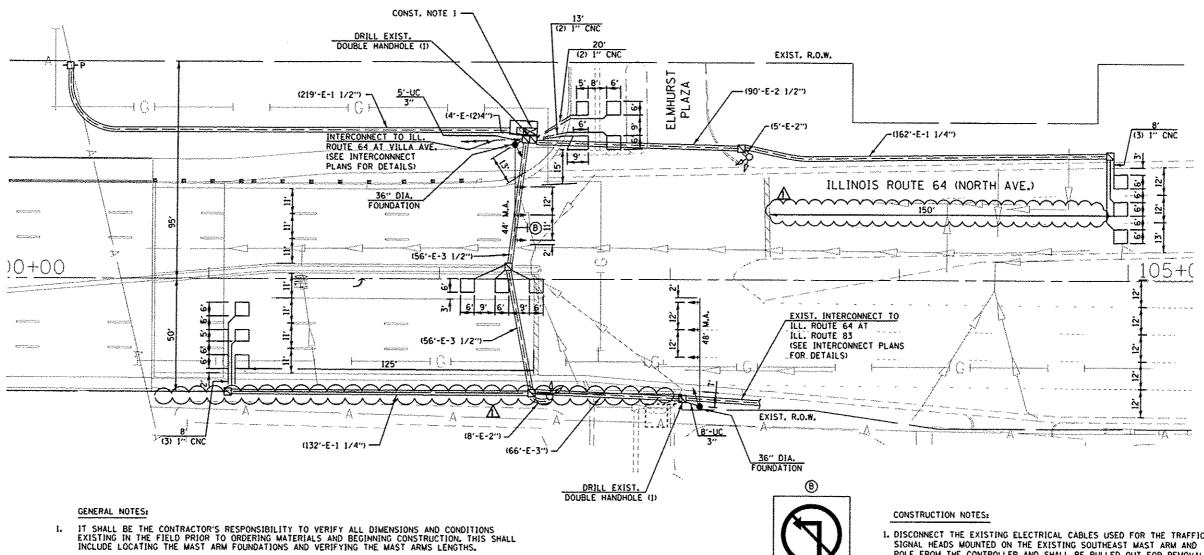

- 2. THE EXACT LOCATION OF ALL UTILITIES SHALL BE FIELD VERIFIED BY THE CONTRACTOR BEFORE ORDERING ANY MATERIALS AND STARTING ANY WORK. FOR LOCATIONS OF UTILITIES, LOCALLY OWNED EQUIPMENT, LEASED EMPORCEMENT CAMERA SYSTEM FACILITIES AND IDOT UNDERGROUND FACILITIES, CONTACT THE LOCAL COUNTIES, MUNICIPALITIES AND IDOT FOR LOCATES. THE CONTRACTOR SHALL CALL JULIE AT (800) 892-0123 OR 811. IN THE CITY OF CHICAGO. CONTACT DIGGER AT (312) 744-7000 FOR FIELD LOCATIONS OF BURIED UTILITIES (48 HOURS NOTIFICATION REQUIRED).
- THE CONTRACTOR SHALL CHECK THE PROPOSED TRAFFIC SIGNAL EQUIPMENT LOCATIONS FOR OVERHEAD UTILITY CONFLICTS. THE CONTRACTOR SHALL COORDINATE ANY CONFLICTS WITH THE UTILITY COMPANIES AND THE RESIDENT ENGINEER BEFORE ORDERING MATERIALS.
- THE CONTRACTOR SHALL COORDINATE CONSTRUCTION ACTIVITIES WITH UTILITY COMPANIES, LOCAL GOVERNMENT AGENCIES AND IDOT.

DISCONNECT THE EXISTING ELECTRICAL CABLES USED FOR THE TRAFFIC SIGNAL HEADS MOUNTED ON THE EXISTING SOUTHEAST MAST ARM AND POLE FROM THE CONTROLLER AND SHALL BE PULLED OUT FOR REMOVAL.

## RESTORATION OF WORK AREA

RESTORATION OF THE TRAFFIC SIGNAL WORK AREA SHALL BE INCLUDED IN THE RELATED PAY ITEM SUCH AS FOUNDATION, CONDUIT, HANDHOLE, ETC. . AND NO EXTRA COMPENSATION SHALL BE ALLOWED. ALL ROADWAY SURFACES SUCH AS SHOULDERS, MEDIAN, SIDEWALKS, PAVEMENT, ETC, SHALL BE REPLACED IN KIND. ALL DAMAGE TO MOWED LAWNS SHALL BE REPLACED WITH AN APPROVED SOD, AND ALL DAMAGED TO LINHOWED FIELDS SHALL BE SEEDED IN ACCORDANCE WITH STANDARD SPECIFICATIONS 252 AND 250 RESPECTIVELY.

307

THE TRAFFIC SIGNAL CONTROL EQUIPMENT FOR THIS PROJECT SHALL BE "EAGLE" TO MATCH THE EXISTING ADJACENT SYSTEM

SINGH DUST SCALE - 48,00000001,000000 DESIGNED - MG REVISED A - ADDENDUM : 01/08/14 DRAWN - MG REVISED -CHECKED - KGP REVISED SHORE ASSOCIATE NC CONSUMPLY PLOT DATE # 08-JAN-2014 15:55 DATE - 10/25/2013 REVISED


STATE OF ILLINOIS **DEPARTMENT OF TRANSPORTATION** 


TRAFFIC SIGNAL INSTALLATION PLAN ILLINOIS ROUTE 64 (NORTH AVENUE) AT ELMHURST PLAZA SCALE; AS NOTED SHEET NO. 20 OF 26 SHEETS STA. TO STA.

R3-2

36" X 36"

COUNTY TOTAL SHEET NO. SECTION DUPAGE 111 63 1318-BR CONTRACT NO. 60V24 ILLINOIS FED. AID PROJECT

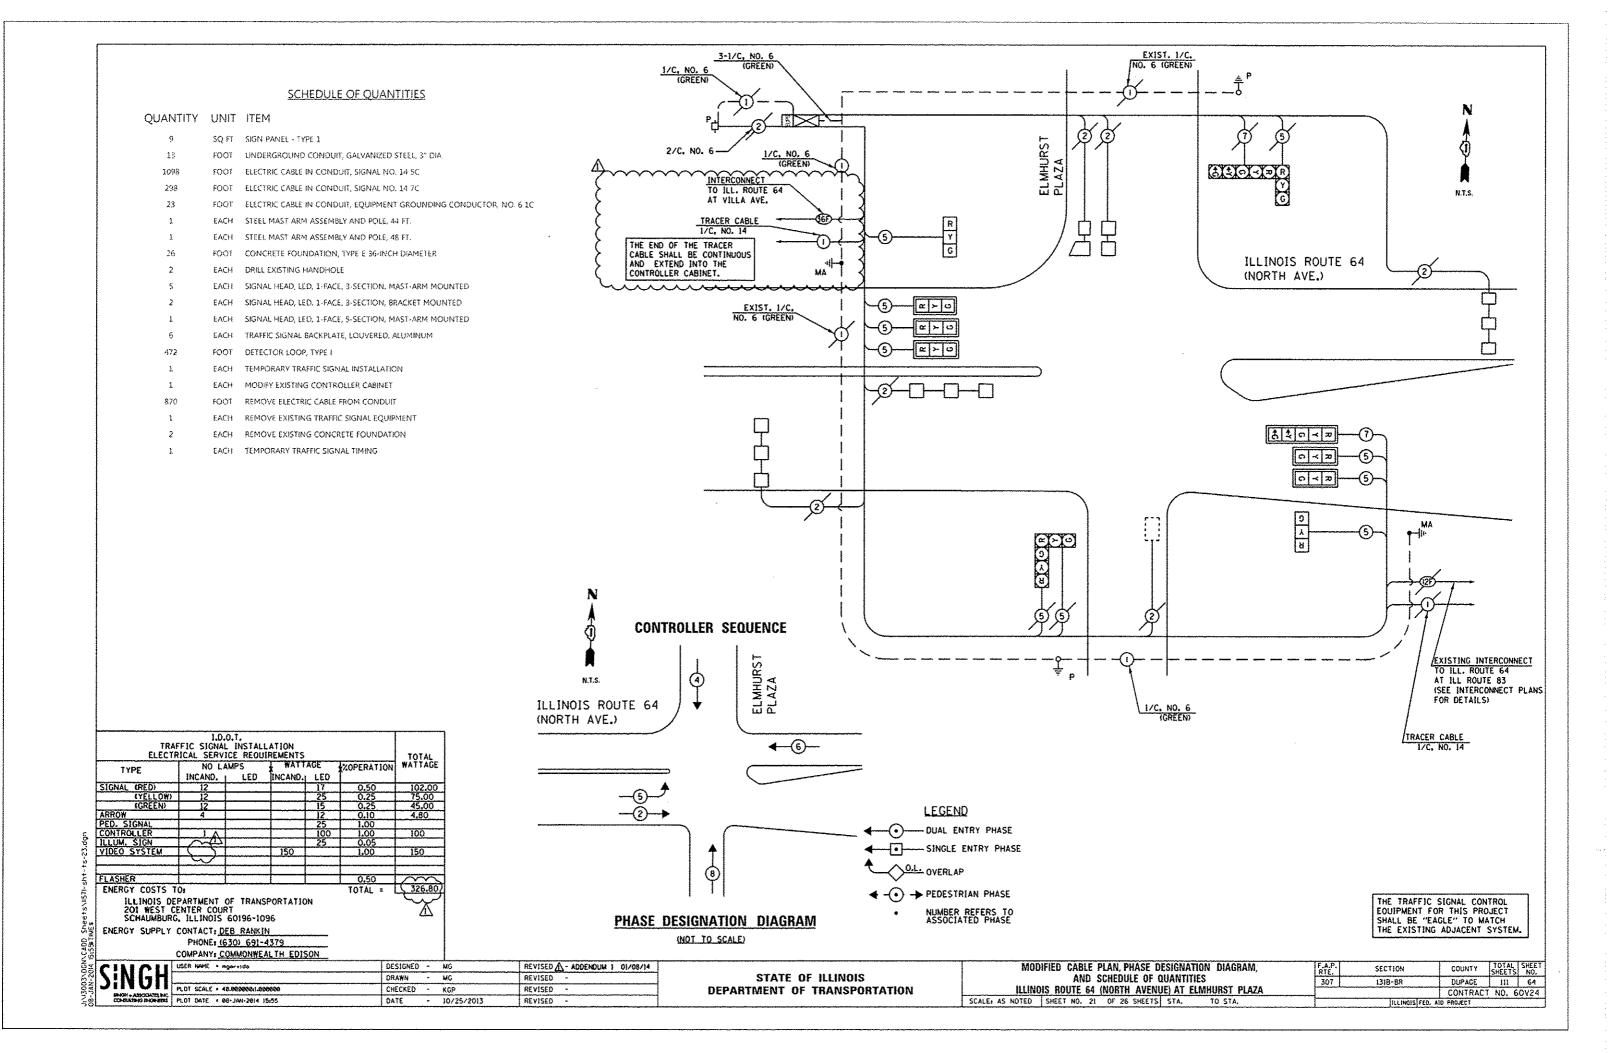

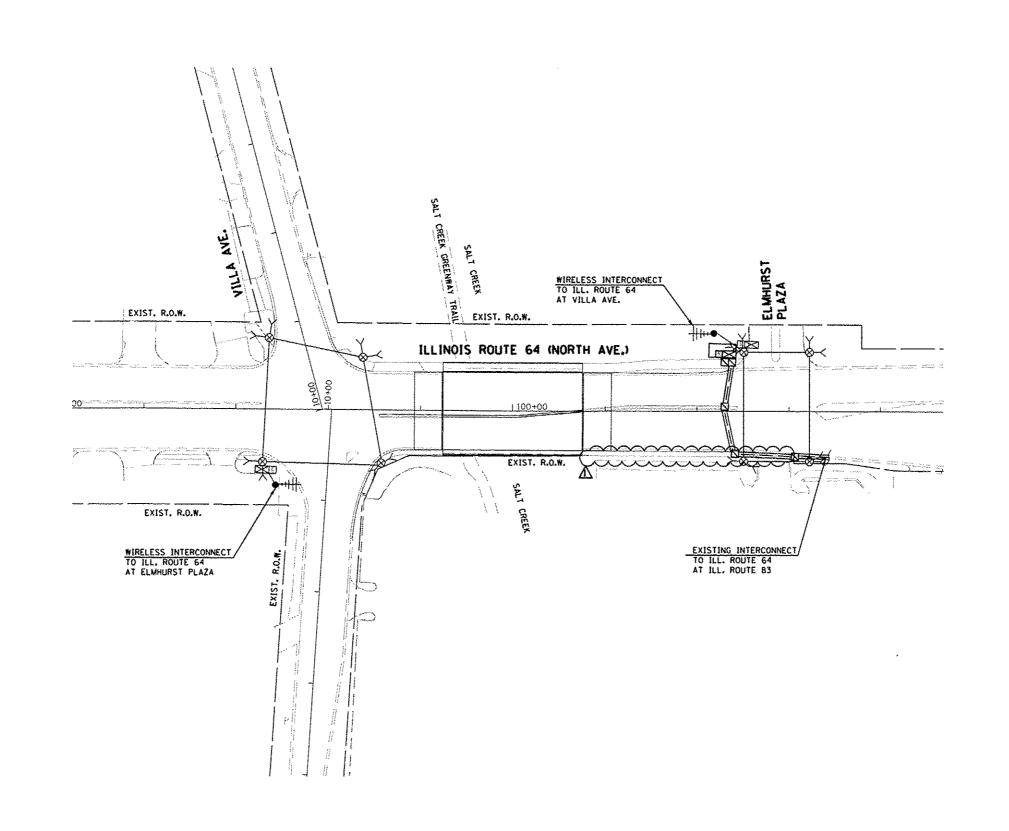

THE TRAFFIC SIGNAL CONTROL EQUIPMENT FOR THIS PROJECT SHALL BE "EAGLE" TO MATCH THE EXISTING ADJACENT SYSTEM.

SINGH USER NAME \* ngoryida

PLOT SCALE \* [80.8008001].000000 DESIGNED - MG REVISEDA - ADDENDUM 1 01/08/14 DRAWN - MG REVISED -CHECKED - KGP REVISED -SHORN-ASSOCIATES AND PLOT DATE × 88-JAN-2814 15:56 DATE - 10/25/2013 REVISED .

STATE OF ILLINOIS DEPARTMENT OF TRANSPORTATION


TEMPORARY RADIO INTERCONNECT PLAN ILLINOIS ROUTE 64 (VILLA AVE. TO ELMHURST PLAZA) SCALE: AS NOTED SHEET NO. 22 OF 26 SHEETS STA.

COUNTY TOTAL SHEET NO.

DUPAGE 111 65

CONTRACT NO. 60V24 SECTION 131B-BR



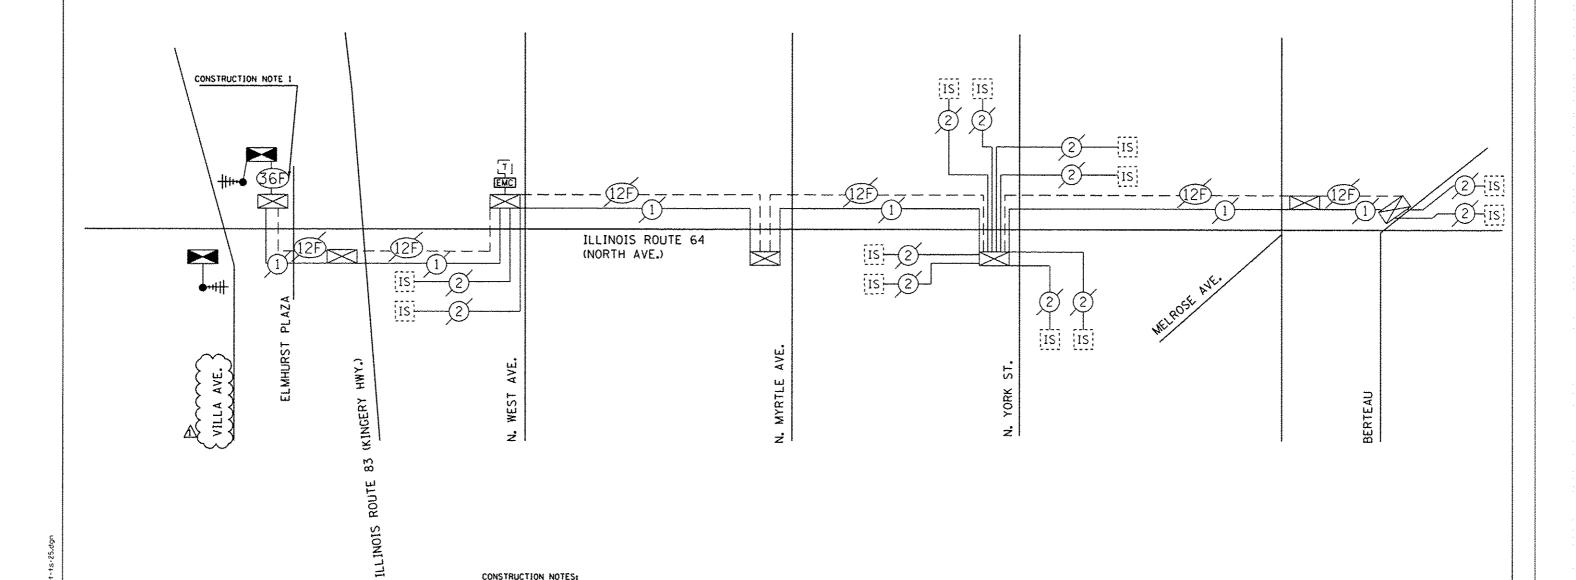

CONSTRUCTION NOTES:

I. SPLICE EXISTING INTERCONNECT CABLE AT THE EXISTING CONTROLLER (ILL. ROUTE 64 AT ELMHURST PLAZA) AND INSTALL TEMPORARY INTERCONNECT CABLE NO. 62.5 / 125 MMI2F SM24F BETWEEN THE EXISTING CONTROLLER CABINET TO THE TEMPORARY CONTROLLER FOR THE PURPOSE OF MAINTAINING EXISTING INTERCONNECT SYSTEM. THIS WORK SHALL BE INCIDENTAL TO PAY ITEM "TEMPORARY TRAFFIC SIGNAL INSTALLATION".


THE TRAFFIC SIGNAL CONTROL EQUIPMENT FOR THIS PROJECT SHALL BE "EAGLE" TO MATCH THE EXISTING ADJACENT SYSTEM.


SIN	GH
SHICK + AC	COCATES NC

11	USER NAME * regarvide	DESIGNED -	MG	REVISED A - ADDENDUM 1 01/08/14
Н		DRAWN -	¥6	REVISED -
	PLOT SCALE = 48.8898081.888888	CHECKED -	KGP	REVISED -
NEEKS NEEKS	PLOT DATE = 88-JAN-2814 15:56	DATE -	10/25/2013	REVISED -

STATE OF ILLINOIS DEPARTMENT OF TRANSPORTATION

TEMPORARY SCHEMATIC DIAGRAM	RTE	\$E
ILLINOIS ROUTE 64 (VILLA AVE. TO BERTEAU AVE.)	307	13
· · · · · · · · · · · · · · · · · · ·		
SCALE: AS NOTED SHEET NO. 23 OF 26 SHEETS STA. TO STA.		

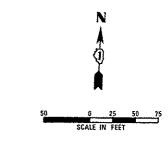

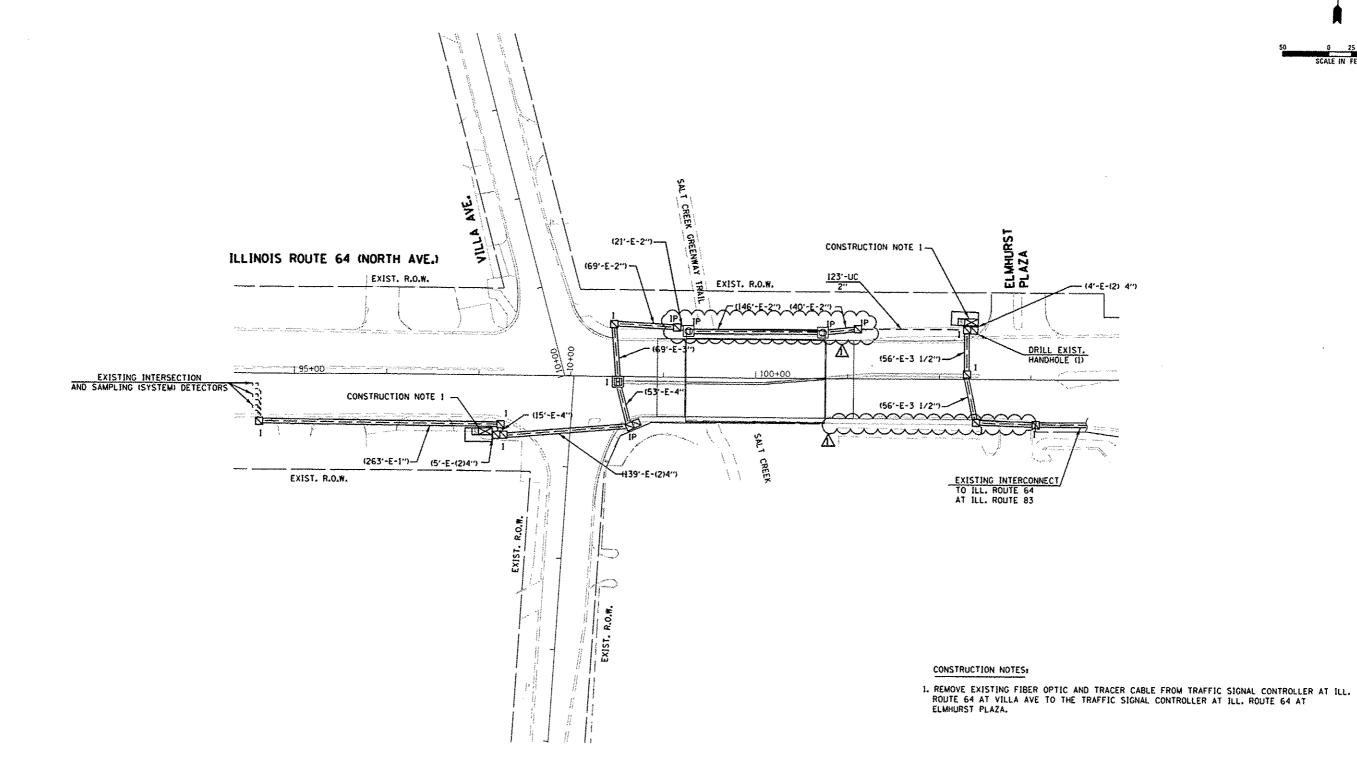

THE TRAFFIC SIGNAL CONTROL EQUIPMENT FOR THIS PROJECT SHALL BE "EAGLE" TO MATCH THE EXISTING ADJACENT SYSTEM.

SINGH USER NAME \* mgarvido
PLOT SCALE \* 190.0000001.000000 DESIGNED - MG REVISED A- ADDENDUM 1 01/08/14 DRAWN - MG REVISED -CHECKED - KGP REVISED SNOH + ASSOCIATE NC PLOT DATE = 88-JAN-2814 15:56 DATE - 10/25/2013 REVISED

STATE OF ILLINOIS **DEPARTMENT OF TRANSPORTATION** 

INTERCONNECT PLAN
ILLINOIS ROUTE 64 (VILLA AVE. TO ILLINOIS ROUTE 83) SCALE: AS NOTED SHEET NO. 24 OF 26 SHEETS STA. TO STA.

COUNTY TOTAL SHEET NO.
DUPAGE 111 67 CONTRACT NO. 60V24

