



2 TYPICAL STAIR WINDOW  
SCALE: 3/8" = 1'-0"

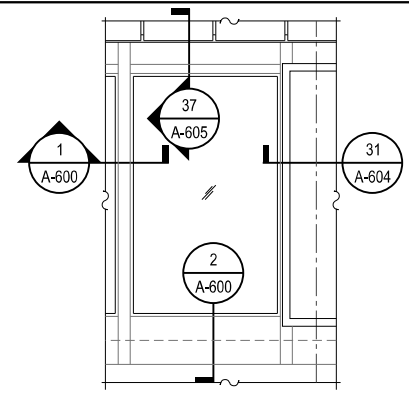


3 TYPICAL TRANSLUCENT METAL PANEL  
SCALE: 3/8" = 1'-0"

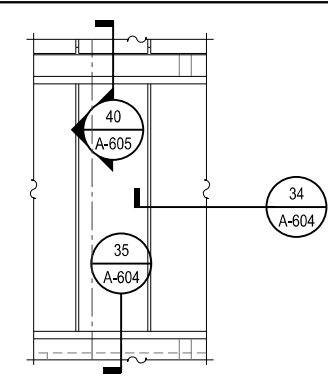

4 TYPICAL WINDOW DETAIL  
SCALE: 3/8" = 1'-0"

- KEY NOTES:
1. TRANSLUCENT PANEL ROOF SYSTEM
  2. INSULATED METAL PANEL WALL SYSTEM
  3. FINISH GRADE
  4. PLATFORM LEVEL
  5. NEW CANOPY COLUMN
  6. TRANSLUCENT PANEL WALL SYSTEM TO MATCH ROOF COLOR
  7. PAINTED STEEL HOISTWAY STRUCTURE-SEE STR DWGS
  8. NEW STEEL TUBE STRUCTURAL-SEE STR DWGS
  9. NEW STRUCTURAL FRAMING-SEE STR DWGS
  10. STRUCTURAL BEAM-SEE STR DWGS
  11. FINISH FLOOR
  12. PLATFORM, CANOPY AND CANOPY COLUMNS DASHED FOR CLARITY
  13. DEGLAZE EXST STAIR WINDOWS.
  14. RELOCATE EXST STAIR.
  15. REGLAZE RELOCATED EXIST STAIR WINDOWS.
  16. CONCRETE PARTITION WALL.

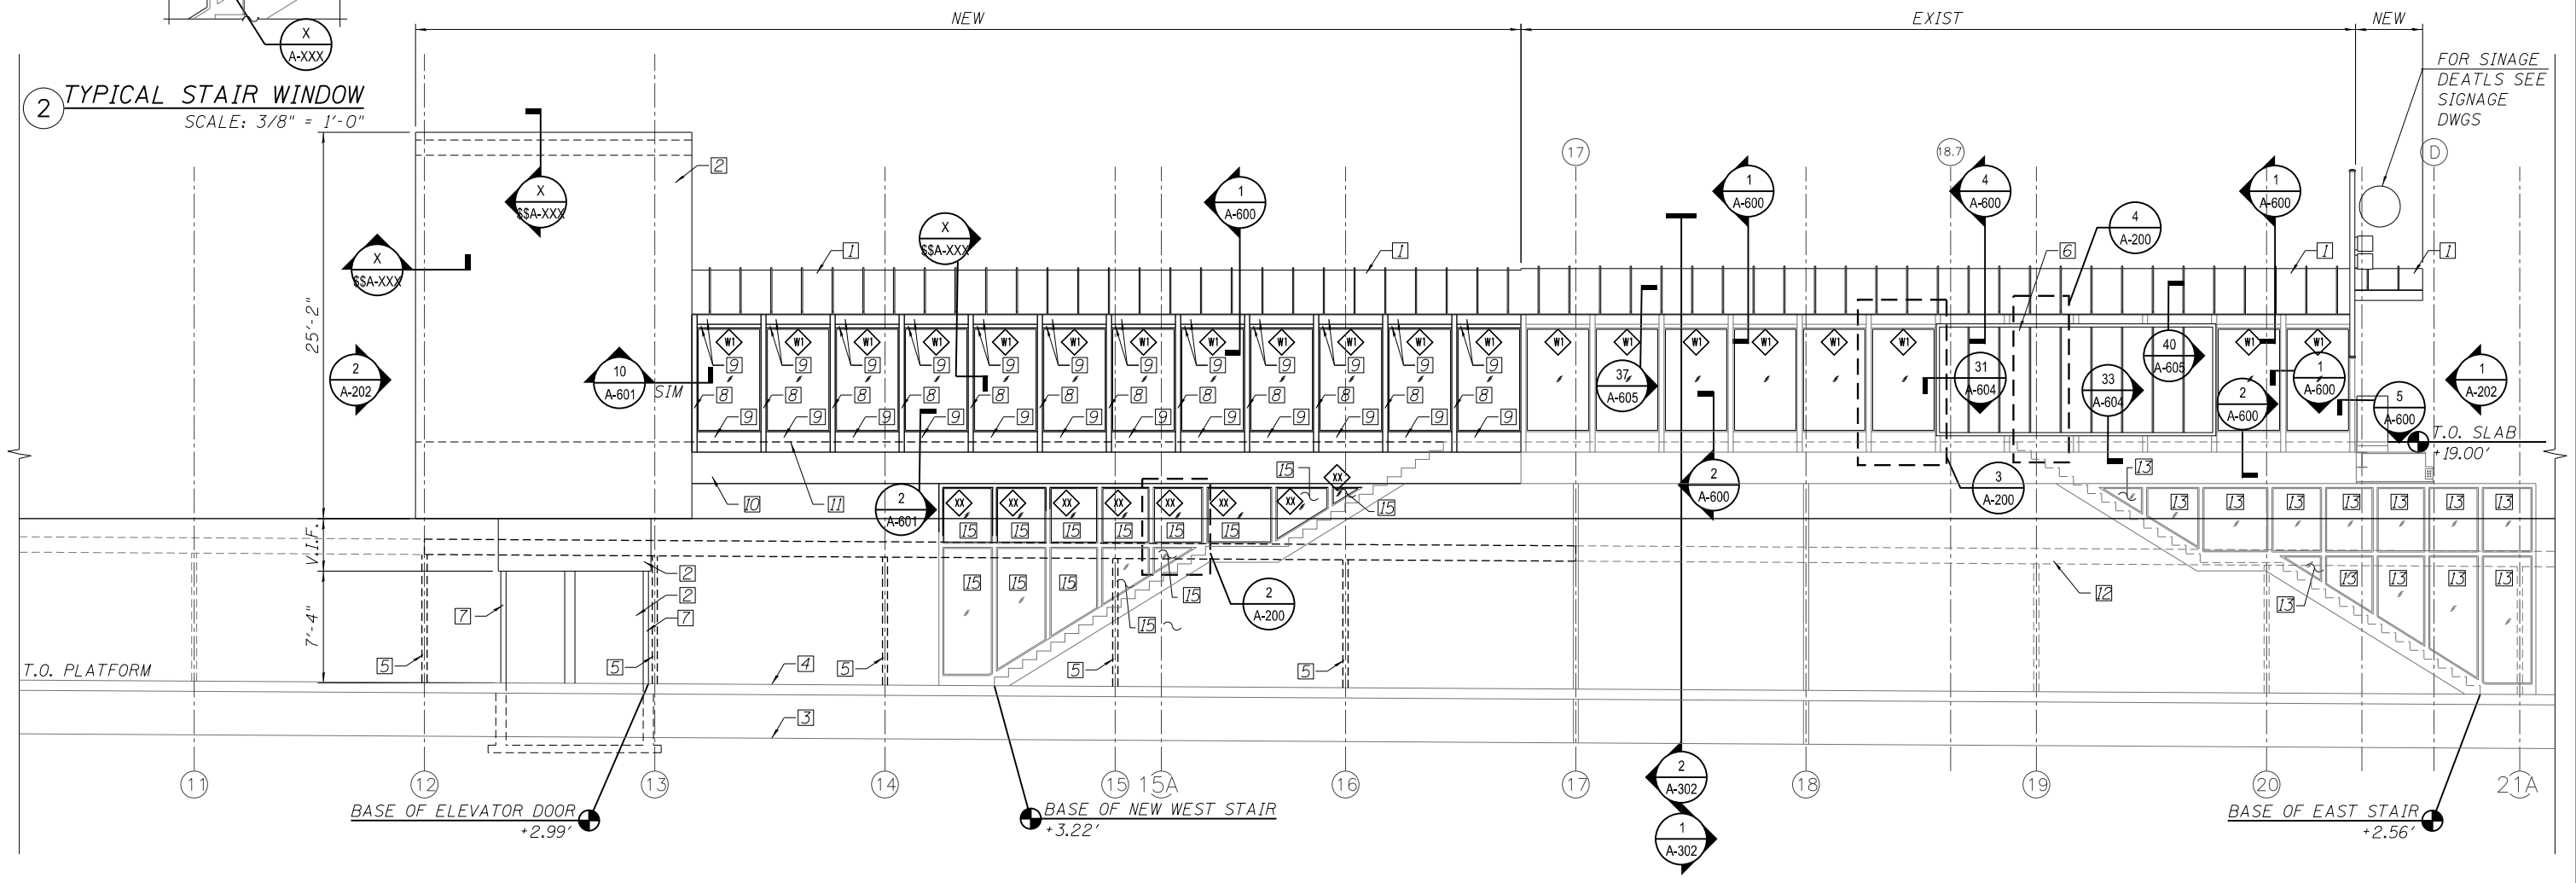

1 STATION SOUTH ELEVATION  
SCALE: 3/16" = 1'-0"

10/16/14: AM 0161708-60W29-A-200.dgn



USER NAME = BAWitorf	DESIGNED - WHB	REVISED
	CHECKED - CRR	REVISED
PLOT SCALE = 10:8.0012 ' / in.	DRAWN - WHB	REVISED
PLOT DATE = 10/29/2013	CHECKED - CRR	REVISED

STATE OF ILLINOIS  
DEPARTMENT OF TRANSPORTATION

PEORIA STREET STATION  
STATION ELEVATION

SHEET NO. A-200 OF 117 SHEETS

PRELIMINARY NOT FOR CONSTRUCTION

MUN	SECTION	COUNTY	TOTAL SHEETS	SHEET NO.
2090	2013-011R	COOK	356	234
CONTRACT NO. 60W29				
ILLINOIS FED. AID PROJECT		FED. AID PROJECT		