
- 1. ALL EQUIPMENT SHOWN IS EXISTING TO REMAIN.
- 2. REFER TO COMMUNICATION EQUIPMENT SCHEDULE FOR PORT ASSIGNMENTS.

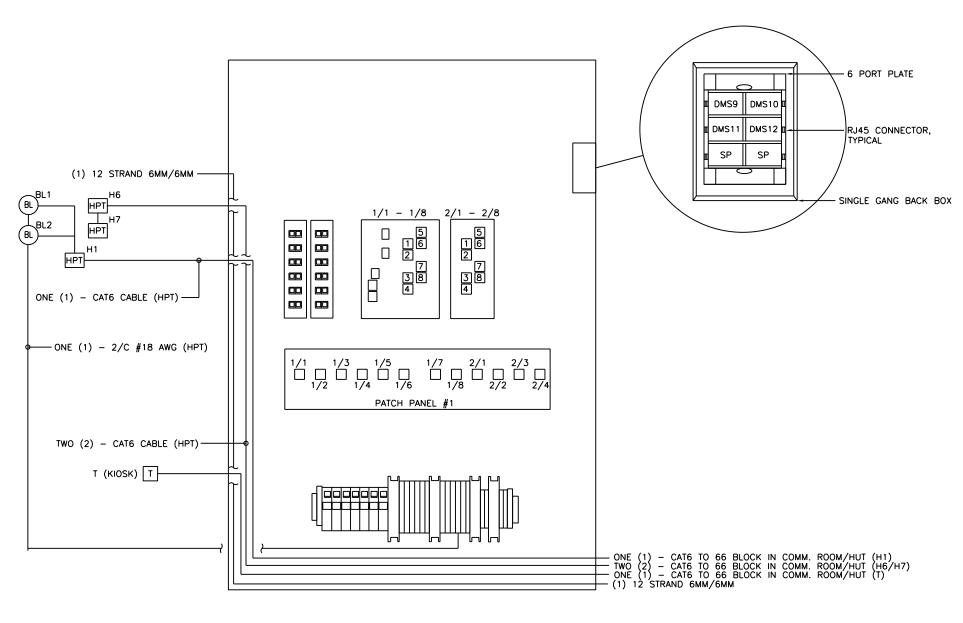

1 HUB1 EXISTING HUB BOX DETAIL
HUB4-UIC-HALSTED PLATFORM INB TYPE 2

FOR INFORMATION ONLY


PRELIMINARY NOT FOR CONSTRUCTION

Phone 647-647-6900 - Fac 647-647-4710

AAA ENGINEERING
WBE/DBE CERTIFIED

USER NAME = habib	DESIGNED -	REVISED
	CHECKED -	REVISED
PLOT SCALE = 2.0000 / in.	DRAWN -	REVISED
PLOT DATE = 10/28/2013	CHECKED -	REVISED

- 1. ALL EQUIPMENT SHOWN IS EXISTING TO REMAIN.
- 2. REFER TO COMMUNICATION EQUIPMENT SCHEDULE FOR PORT ASSIGNMENTS.

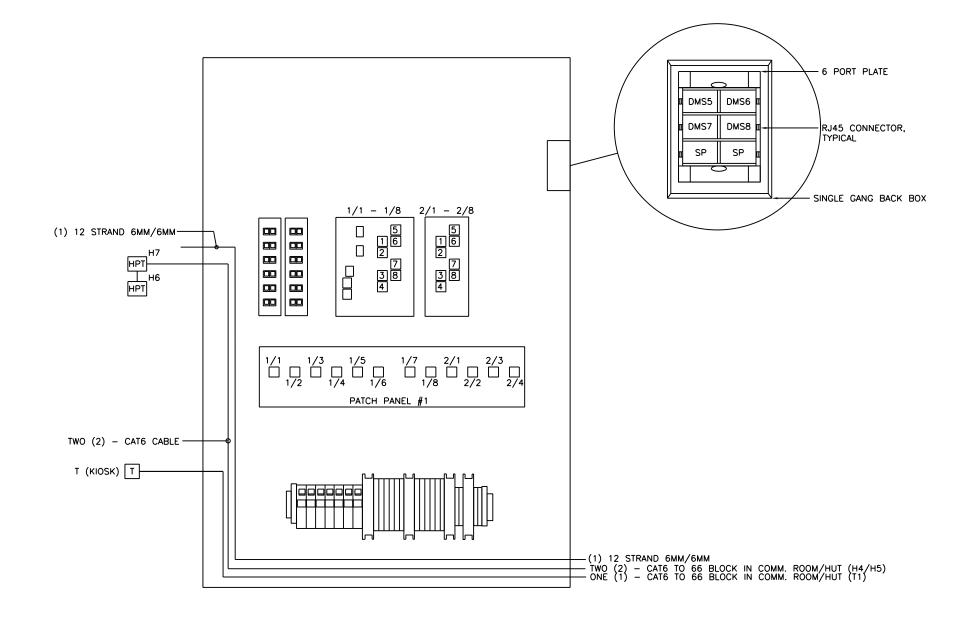

1 HUB2 EXISTING HUB BOX DETAIL
HUB4-UIC-HALSTED PLATFORM OTB TYPE 2

FOR INFORMATION ONLY


PRELIMINARY NOT FOR CONSTRUCTION

Phone 947-647-6900 - Fac 947-647-4710

AAA ENGINEERING WBE/DBE CERTIFIED

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PLOT DATE = 10/28/2013	CHECKED -	REVISED

- EXISTING DEVICES ARE IN LIGHT AND NEW OR RELOCATED DEVICES ARE BOLD.
- 2. REFER TO COMMUNICATION EQUIPMENT SCHEDULE FOR PORT ASSIGNMENTS.
- 3. REFER TO SHEET 304 STANDARD COMMUNICATION HUB FOR EQUIPMENT REQUIREMENTS.
- PROVIDE TEMPORARY HUB PANEL AS NEEDED. MOUNT TEMP PANEL AT PLATFORM LEVEL NEXT TO WEST HUB PANEL.
- PROVIDE NEW HUB 4 PANEL AND LOCATED IN NEW COMMUNICATIONS ROOM. PROVIDED ADDITIONAL DEVICES AS SHOWN.

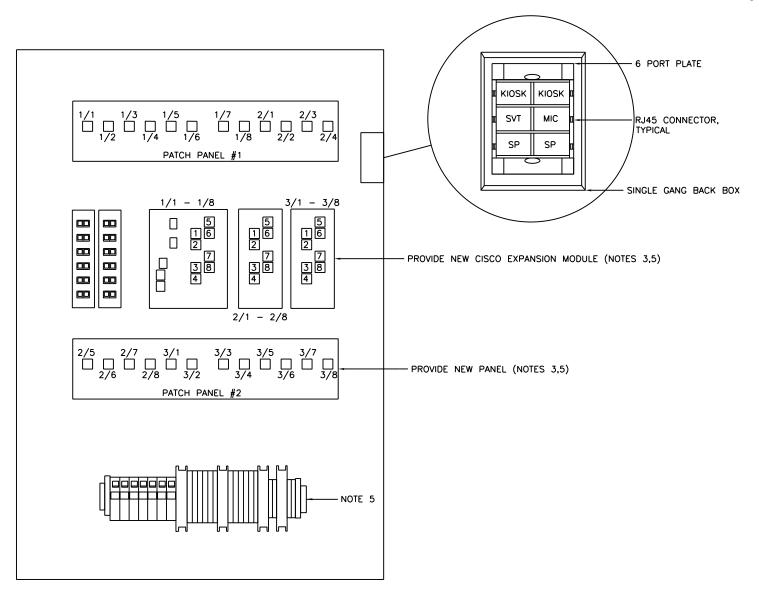

1 HUB4 EXISTING HUB BOX DETAIL

HUB4-UIC-HALSTED PEORIA STATION TYPE 2



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STATE OF ILLINOIS DEPARTMENT OF TRANSPORTATION PEORIA STREET STATION


COMMUNICATION EXISTING HUB DETAILS PART 3

SHEET NO. 112 OF 117 SHEETS

 MUN
 SECTION
 COUNTY SHEETS NO.

 2090
 2013-011R
 COOK
 356
 303

 CONTRACT NO. 60W29

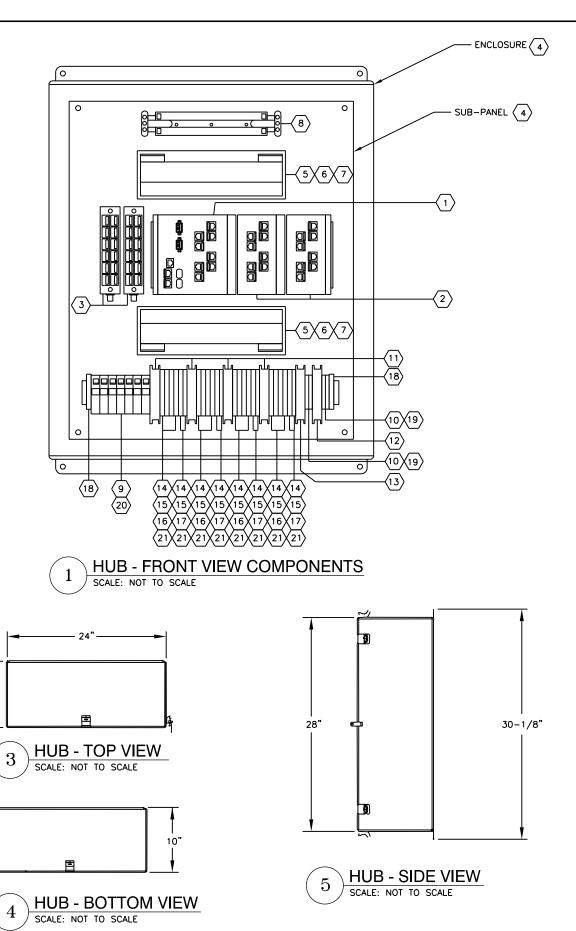

ITEM ID	MANUFACTURER	PART NUMBER	ITEM	QUANTITY
1	CISCO	IE-3000-8TC	8-PORT INDUSTRIAL ETHERNET SWITCH WITH RUGGED GE MM SX SFP, LC CONNECTOR	1
2	CISCO	IE-3000-8TM	8-PORT ETHERNET SWITCH EXPANSION MODULE	2
(3)	CORNING	SPH-120TS-12E7H	OPTITIP 12 STRAND MM SC SINGLE PANEL HOUSING	2
4	J&A SHEET METAL		24" X 28" X 10" ENCLOSURE NEMA 4 STAINLESS TYPE 304 12 GAUGE -HINGED DOOR WITH LOCKING HASP -WELDED STUDS AND PLATE INSERT -MOUNTING TABS	1
(5)	LEVITON	492B0-QP0	12 PORT PATCH BLOCK	2
6	LEVITON	61110-RE6	CAT6 QUICKPORTS - BLACK	22
7	LEVITON	61110-RR6	CAT6 QUICKPORTS - RED	2
8	LEVITON	41AW1-50	50 PAIR TYPE 110 TERMINATION BLOCK	1
9	ALLEN-BRADLEY	1492-J35	TERMINAL BLOCK W/ 1492-M7X12 MARKER AS REQUIRED	8
(10)	ALLEN-BRADLEY	1492-J4	TERMINAL BLOCK W/ 1492-M7X12 MARKER AS REQUIRED	4
(11)	ALLEN-BRADLEY	1489-A1C200	20A CIRCUIT BREAKER	4
(12)	ALLEN-BRADLEY	1489-A1C100	10A CIRCUIT BREAKER	1
(13)	ALLEN-BRADLEY	1489-A1C030	3A CIRCUIT BREAKER	1
(14)	ALLEN-BRADLEY	1492-JD3FB	FUSE AND FEED THROUGH TB W/ 1492-MR6XB AND M6X5 MARKERS AS REQUIRED	24
(15)	ALLEN-BRADLEY	1492-SJ8A-3	3 POLE JUMPER	8
(16)	BUSSMANN	GMA-3	3A FUSE	16
(17)	BUSSMANN	GMA-4	4A FUSE	8
(18)	ALLEN-BRADLEY	1492-EAJ35	TB END ANCHOR	2
(19)	ALLEN-BRADLEY	1492-EBJ3	END BARRIERS	8
20>	ALLEN-BRADLEY	1492-EBJ16	END BARRIERS	2
21>	ALLEN-BRADLEY	1492-EBJD3FB	END BARRIERS	24
(22)			CAT6 PATCH CABLES 12" - BLACK	22
23			CAT6 PATCH CABLES 12" - RED	2
24			FIBER PATCH CABLE (MM-SC-LC) - 1 METER DUPLEX	2

2 HUB - MATERIAL SCHEDULE
SCALE: NOT TO SCALE

AAA ENGINEERING
WBE/DBE CERTIFIED

S940 Wear Torthy Avenue, Suite 2'90, Miles, IL 60714

Phone: 647-647-9900 - Fax: 647-647-4719

Systems

10"

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STATE OF ILLINOIS
DEPARTMENT OF TRANSPORTATION

PEORIA STREET STATION
COMMUNICATION STANDARD DETAILS COMMUNICATION HUB

SHEET NO. 113 OF 117 SHEETS


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 COUNTY SHEETS NO.
 TOTAL SHEET NO.
 SHEET NO.


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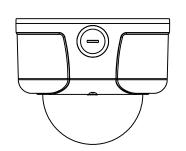
 CONTRACT NO.
 60W29

 ILLINOIS FED. AID PROJECT

- 1. GRS CONDUIT 1 1/2".
- 2. PENDANT MOUNT.



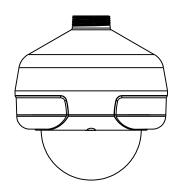

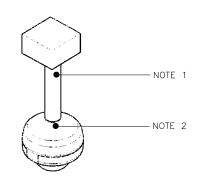

1 FIXED CAMERA - PENDANT MOUNT

2 FIXED CAMERA - PENDANT DETAIL

FIXED CAMERA - SURFACE MOUNT
SCALE NTS

AAA ENGINEERING
WBE/DBE CERTIFIED

5940 West Toury Avenue, State 210, Nacs, IL 60714
Photos 647-647-5900 - Fax 647-647-4710

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	PLOT	DAT

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T DATE = 10/28/2013	CHECKED -	REVISED	

STATE OF ILLINOIS DEPARTMENT OF TRANSPORTATION PEORIA STREET STATION
COMMUNICATION CCTV CAMERA DETAILS

SHEET NO. 114 OF 117 SHEETS

 MUN
 SECTION
 COUNTY SHEETS NO.
 TOTAL SHEET NO.

 2090
 2013-011R
 COOK
 356
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 CONTRACT NO.
 60W29

 ILLINOIS FED. AID PROJECT

		EQUIP	MENT WIRING REQUIREMENT S	CHEDULE		
DEVICE	QTY/CR	RITERIA	COMM CABLE	то	POWER CABLE	то
	PLATFORM	STATION				
CCTV CAMERAS	SEI	E DWGS	(1) CAT-6 EACH	NEAREST HUB	2/C #14 AWG	NEAREST HUB
PA SPEAKERS	SEE	DWGS	(1) 2/C #16 AWG PER PA SPEAKER CIRCUIT	COMM HUT/ROOM		
PA AMBIENT NOISE SENSOR (NS)	1 PEF	R PA ZONE	(1) 3 PAIR SHIELDED #22 AWG CABLE	COMM HUT/ROOM		
TYPE I TELEPHONE		1 PER EQUIPMENT ROOM	(1) CAT-6 EACH	COMM HUT/ROOM WALL FIELD		
TYPE II TELEPHONE	1 EACH DIRECTION ON PLATFORM AT 8 CAR MARKER		(1) CAT-6 EACH	COMM HUT/ROOM WALL FIELD		
DAS	IF APP	PLICABLE	(1) CAT -6 EACH FACE (OR (2) CAT-6 PER DOUBLE FACE)	NEAREST COMM HUB	20A/1P CIRCUIT EACH FACE	ELECT ROOM NORMAL POWER
DMS (SINGLE FACE)	8 SINGLE FACE (2 SINGLE FACE BACK TO- BACK, EACH DIRECTION) AT 1/4 AND 3/4 PLATFORM, PERPENDICULAR TO THE TRACKS	2 SINGLE FACE BACK- TO-BACK, VIEWABLE FROM PAID AND UNPAID AREA	(1) CAT-6 EACH FACE	NEAREST HUB/COMM. ROOM	10A/1P CIRCUIT FOR EACH SET OF 2 DMS	COMM HUT RELIABLE POWER
HPT - TYPE IV TELEPHONE	1 AT 1/2 PLATFORM	1 IN PAID AREA, 1 IN UNPAID AREA	(1) CAT-6 EACH	NEAREST HUB/VOICE PATCH	2/C #18 AWG	сомм нит
BLUE LIGHT FOR HPT	1 PER DIRECTION AT PLATFORM EDGE	1 PER STATION			2/C #18 AWG	NEAREST HUB
HPT TO BLUE LIGHT			(1) 2/C #18 AWG PER BLUE LIGHT	НРТ		
WAP - DA	1 AT EACH END OF PLATFORM		(1) CAT-6 EACH	NEAREST HUB	2/C #14 AWG	NEAREST HUB
WAP - OMNI		1 AT CURB LANE OF STOREFRONT	(1) CAT-6 EACH	NEAREST HUB	2/C #14 AWG	NEAREST HUB
ISIGN (TOUCHSCREEN)		1	(1) CAT-6 EACH	NEAREST HUB	20A/1P CIRCUIT EACH	COMM HUT/ROOM
HUB - TYPE 3M	AS NEED	DED	(1) 12-STRAND MM FIBER OPTIC, (3) CAT-6	COMM HUT/ROOM	8-#8'S / 2-#14 AWG	COMM HUT/ROOM
HUB - TYPE 4M	AS NEED	DED	(1) 12-STRAND MM FIBER OPTIC, (3) CAT-6 (1) 25-PR CAT-5E FOR STATION HUB	COMM HUT/ROOM	8-#8'S / 2-#14 AWG	COMM HUT/ROOM
CA KIOSK	QTY AT CA K	CIOSK				
SVT(SECURITY VIDEO TERMINAL)	1 PER CA B	воотн	(1) CAT-6 EACH	COMM HUT/ROOM PASS THRU HUB		
i. VGA EXTENDERS-APANTEC PART NUMBER TSE-1-Eu AND TSE-1Ru .ii TX-CONNECTS TO ii. TX-CONNECTS TO TELESTE ATI-4670 IN COMM ROOM/HUT iii. RX-VGA/USB/AUDIO CABLE CONNECTED TO SVT MONITOR IN KIOSK	1 PER CA BOOTH		(1) CAT-6 EACH	COMM HUT PASS THRU HUB	20A/1P CIRCUIT EACH	BEST SOURCE
TYPE III TELEPHONE	1 PER CA B	воотн	(1) CAT-6 EACH	COMM HUT PASS THRU HUB		
MICROPHONE	1 PER CA B		(1) CAT-6 EACH	COMM HUT PASS THRU HUB		
DATA			(1) CAT-6 DATA/(1) CAT-6 SPARE/ (1) 6SM/6MM FO CABLE	NEAREST HUB		

AAA ENGINEERING
WBE/DBE CERTIFIED

REVISED REVISED USER NAME = habib DESIGNED -STATE OF ILLINOIS
DEPARTMENT OF TRANSPORTATION CHECKED PLOT SCALE = 2.0000 / in. REVISED DRAWN PLOT DATE = 10/28/2013 CHECKED REVISED

PEORIA STREET STATION COMMUNICATION EQUIPMENT WIRING REQUIREMENT SCHEDULE SHEET NO. 115 OF 117 SHEETS

COUNTY TOTAL SHEET NO.

COOK 356 306 MUN SECTION 2090 2013-011R CONTRACT NO. 60W29

	חראופר	LILLE	DODT	IΡ	MAKE /	MOUNT	LUCUNT					EVICTING TO	
DEVICE	DEVICE NUMBER	HUB NUMBER	PORT NUMBER	ADDRESS	MAKE/ MODEL	MOUNT TYPE	HEIGHT	LENS	LOCATION	NEW	EXISTING	EXISTING TO REPLACE	REMARKS
FIXED CAMERA	CAM01	HUB1	Fa1/1	10.106.116.188	IEE-20DN	N/A	N/A	N/A	INBOUND PLATFORM		×		
FIXED CAMERA	CAM02	HUB1	Fa1/2	10.106.116.187	IEE-20DN	N/A	N/A	N/A	INBOUND PLATFORM		x		
FIXED CAMERA	CAM03	HUB1	Fa1/3	10.106.116.186	IEE-20DN	N/A	N/A	N/A	INBOUND PLATFORM		x		
FIXED CAMERA	CAM04	HUB2	Fa1/1	10.106.116.185	IEE-20DN	N/A	N/A	N/A	INBOUND PLATFORM		x		
FIXED CAMERA	CAM05	HUB2	Fa1/2	10.106.116.184	IEE-20DN	N/A	N/A	N/A	INBOUND PLATFORM		х		
FIXED CAMERA	САМО6	HUB2	Fa1/3	10.106.116.183	IEE-20DN	N/A	N/A	N/A	OUTBOUND PLATFORM		×		
FIXED CAMERA	CAM07	HUB2	Fa1/7	10.106.116.182	IEE-20DN	N/A	N/A	N/A	OUTBOUND PLATFORM		х		
FIXED CAMERA	CAM08	HUB2	Fa1/5	10.106.116.181	IEE-20DN	N/A	N/A	N/A	OUTBOUND PLATFORM		х		
FIXED CAMERA	САМО9	HUB1	Fa1/4	10.106.116.180	IEE-20DN	N/A	N/A	N/A	OUTBOUND PLATFORM		x		
FIXED CAMERA	CAM10	HUB1	Fa1/5	10.106.116.179	IEE-20DN	N/A	N/A	N/A	OUTBOUND PLATFORM		х		
FIXED CAMERA	CAM11	HUB1	Fa1/6	10.106.116.178	IEE-20DN	N/A	N/A	N/A	WEST WALKWAY		х		
FIXED CAMERA	CAM16	HUB4	Fa1/1	10.106.116.173	IEE-20DN	N/A	N/A	N/A	STATION (PEORIA)			х	LOCATED AS SHOWN ON DWG
FIXED CAMERA	CAM17	HUB4	Fa1/2	10.106.116.172	IEE-20DN	N/A	N/A	N/A	STATION (PEORIA)			х	LOCATED AS SHOWN ON DW
FIXED CAMERA	CAM18	HUB4	Fa1/3	10.106.116.171	IEE-20DN	N/A	N/A	N/A	STATION (PEORIA)			х	LOCATED AS SHOWN ON DW
FIXED CAMERA	CAM19	HUB4	Fa1/4	10.106.116.170	IEE-20DN	N/A	N/A	N/A	STATION (PEORIA)			х	LOCATED AS SHOWN ON DW
FIXED CAMERA	CAM20	HUB4	Fa1/5	10.106.116.169	IEE-20DN	CEILING	100"	2.8	STATION (PEORIA)			х	LOCATED AS SHOWN ON DW
FIXED CAMERA	CAM21	HUB4	Fa1/6	10.106.116.168	IEE-20DN	CEILING	100"	2.8	STATION (PEORIA)			х	LOCATED AS SHOWN ON DWG
FIXED CAMERA	CAM22	HUB4	Fa1/7	10.106.116.167	IEE-20DN	CEILING	100"	2.8	STATION (PEORIA)			х	LOCATED AS SHOWN ON DW
FIXED CAMERA	CAM23	HUB4	Fa1/8	10.106.116.166	IEE-20DN	N/A	N/A	N/A	STATION (PEORIA)			х	LOCATED AS SHOWN ON DW
FIXED CAMERA	CAM36	HUB4	Fa2/1	10.106.116.TBD	IEE-20DN	CEILING	100"	2.8	STATION (PEORIA)	х			
FIXED CAMERA	CAM37	HUB4	Fa2/2	10.106.116.TBD	IEE-20DN	CEILING	100"	2.8	PLATFORM ELEVATOR	Х			
FIXED CAMERA	CAM27	HUB2	Fa2/1	10.106.116.162	IEE-20DN	CEILING	100"	2.8	PLATFORM STAIRS			х	LOCATED AS SHOWN ON DWG
FIXED CAMERA	CAM28	HUB2	Fa2/2	10.106.116.161	IEE-20DN	CEILING	100"	2.8	PLATFORM STAIRS			х	LOCATED AS SHOWN ON DWG
FIXED CAMERA	CAM29	HUB2	Fa2/3	10.106.116.160	IEE-20DN	CEILING	100"	2.8	PLATFORM STAIRS			х	LOCATED AS SHOWN ON DWG
FIXED CAMERA	CAM31	HUB1	Fo1/8	10.106.116.158	IEE-20DN	CEILING	100"	2.8	STATION (PEORIA)			х	LOCATED AS SHOWN ON DWG
PTZ CAMERA	CAM32	HUB2	Fa2/6	10.106.116.157	D5118	N/A	N/A	N/A	OUTBOUND PLATFORM		×		
PTZ CAMERA	САМЗЗ	HUB1	Fa1/7	10.106.116.156	D5118	N/A	N/A	N/A	INBOUND PLATFORM		х		
CISCO IEM3000-8FM		INSIDE				INSIDE							
XPANSION MODULES	HUB4	HUB4	8	N/A	N/A	HUB4	N/A	N/A	STATION (PEORIA)	Х			
DIGITAL MESSAGE SYSTEM	D1	HUB1	Fa2/1	10.106.114.194	GDS	BRACKET	103"	N/A	INBOUND PLATFORM		×		
DIGITAL MESSAGE SYSTEM	D2	HUB1	Fa2/2	10.106.114.195	GDS	BRACKET	103"	N/A	INBOUND PLATFORM		×		
DIGITAL MESSAGE SYSTEM	D3	HUB1	Fa2/3	10.106.114.196	GDS	BRACKET	103"	N/A	INBOUND PLATFORM		×		
DIGITAL MESSAGE SYSTEM	D4	HUB1	Fo2/4	10.106.114.197	GDS	BRACKET	103"	N/A	INBOUND PLATFORM		х		
DIGITAL MESSAGE SYSTEM	D5	HUB2	Fa2/5	10.106.114.198	GDS	BRACKET	103"	N/A	OUTBOUND PLATFORM		x		
DIGITAL MESSAGE	D6	HUB2	Fa2/6	10.106.114.199	GDS	BRACKET		N/A	OUTBOUND PLATFORM		×		
SYSTEM DIGITAL MESSAGE	D7	HUB2	Fa2/7	10.106.114.200	GDS	BRACKET	103"	N/A	OUTBOUND PLATFORM		×		
SYSTEM DIGITAL MESSAGE		HUB2	· ·					•	OUTBOUND PLATFORM				
SYSTEM DIGITAL MESSAGE	D8		Fo2/8	10.106.114.201	GDS	BRACKET		N/A			X		
SYSTEM	D9	HUB1	Fo2/5	10.106.114.202	GDS	BRACKET	103"	N/A	INBOUND PLATFORM		X		
DIGITAL MESSAGE SYSTEM	D10	HUB1	Fa2/6	10.106.114.203	GDS	BRACKET	103"	N/A	INBOUND PLATFORM		X		
DIGITAL MESSAGE SYSTEM	D11	HUB1	Fa2/7	10.106.114.204	GDS	BRACKET	103"	N/A	INBOUND PLATFORM		х		
DIGITAL MESSAGE SYSTEM	D12	HUB1	Fa2/8	10.106.114.205	GDS	BRACKET	103"	N/A	INBOUND PLATFORM		х		
DIGITAL MESSAGE SYSTEM	D15	HUB4	Fa2/2	10.106.114.208	GDS	BRACKET	103"	N/A	STATION (PEORIA)		х		RELOCATE AS SHOWN ON DW
DIGITAL MESSAGE	D16	HUB4	Fa2/3	10.106.114.209	GDS	BRACKET	103"	N/A	STATION (PEORIA)		×		RELOCATE AS SHOWN ON DW

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PLOT DATE = 10/28/2013 REVISED DRAWN CHECKED REVISED

STATE OF ILLINOIS
DEPARTMENT OF TRANSPORTATION

PEORIA STREET STATION COMMUNICATION EQUIPMENT SCHEDULE PART 1 SHEET NO. 116 OF 117 SHEETS

PRELIMINARY NOT FOR CONSTRUCTION MUN COUNTY TOTAL SHEET NO.

COOK 356 307 SECTION 2090 2013-011R CONTRACT NO. 60W29

	EQUIPMENT SCHEDULE (CONTINUED)												
DEVICE	DEVICE NUMBER	HUB NUMBER	PORT NUMBER	IP ADDRESS	MAKE/ MODEL	MOUNT TYPE	MOUNT HEIGHT	LENS	LOCATION	NEW	EXISTING	EXISTING TO REPLACE	REMARKS
ISIGN	1-2	HUB4	Fa2/4	FUTURE	FUTURE	FLOOR			STATION (PEORIA)	х			
SECURITY VIDEO TERMINAL	SVT	HUB4	Fa2/5	N/A	LITEMAX/ SLKD1954	DESK	TBD	N/A	STATION (PEORIA)		х		RELOCATE AS SHOWN ON DWGS
DIGITAL MESSAGE SYSTEM	МІ	HUB4	Fa2/6	N/A	TBD	DESK	TBD	N/A	STATION (PEORIA)		х		RELOCATE AS SHOWN ON DWGS
HELP POINT TELEPHONE	Н1	COMM ROOM	PS SYS. 66 BLK.	N/A	GAI-TRONICS 393AL-001	COLUMN	48"	N/A	INBOUND PLATFORM		x		
HELP POINT TELEPHONE	H4		PS SYS. 66 BLK.	N/A	GAI-TRONICS 393AL-001	WALL	48"	N/A	STATION (PEORIA)			х	LOCATED AS SHOWN ON DWGS
HELP POINT TELEPHONE	Н5	COMM ROOM	PS SYS. 66 BLK.	N/A	GAI-TRONICS 393AL-001	WALL	48"	N/A	STATION (PEORIA)			х	LOCATED AS SHOWN ON DWGS
BLUE LIGHT	BL1	Н1	N/A	N/A	TOMAR 500L -1228-B	CEILING	100"	N/A	INBOUND PLATFORM		х		
BLUE LIGHT	BL2	Н1	N/A	N/A	TOMAR 500L -1228-B	CEILING	100"	N/A	OUTBOUND		х		
BLUE LIGHT	BL4	H4/H5	N/A	N/A	TOMAR 500L -1228-B	CEILING	100"	N/A	STATION (PEORIA)			х	LOCATED AS SHOWN ON DWGS
SPEAKERS INBOUND	A/B	IED	PA SYSTEM	N/A	BOGEN /A2T	CANOPY	N/A	N/A	INBOUND PLATFORM		34		
SPEAKERS OUTBOUND	C/D	IED	PA SYSTEM	N/A	BOGEN /A2T	CANOPY	N/A	N/A	OUTBOUND PLATFORM		34		
SPEAKERS STATION	F	IED	PA SYSTEM	N/A	BOGEN /A2T	CEILING	N/A	N/A	STATION (PEORIA)	7			LOCATED AS SHOWN ON DWGS
NOISE SENSOR N1	N1	IED	N/A	N/A	IED/212	N/A	N/A	N/A	INBOUND PLATFORM		2		
NOISE SENSOR N2	N2	IED	N/A	N/A	IED/212	N/A	N/A	N/A	OUTBOUND PLATFORM		2		
NOISE SENSOR N4	N4	IED	N/A	N/A	IED/212	N/A	N/A	N/A	STATION (PEORIA)			1	LOCATED AS SHOWN ON DWGS




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STATE OF ILLINOIS
DEPARTMENT OF TRANSPORTATION

SHEET NO. 117 OF 117 SHEETS


SHEET NO. 117 OF 117 SHEETS


SHEET NO. 117 OF 117 SHEETS

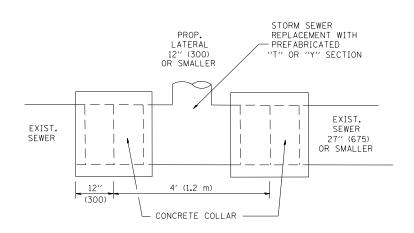


DETAIL "A"

LATERAL CONNECTION TO EXISTING SEWER OF 27" (675) OR SMALLER

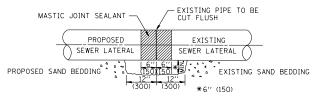

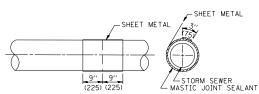

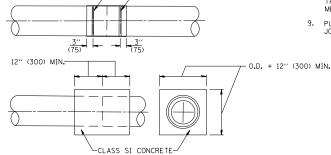


METAL BINDING

DETAIL "B" CLASS SI CONCRETE COLLAR

CONSTRUCTION SEQUENCE

- 1. CUT THE EXISTING END OF THE PIPE SO AS TO PRESENT A FLUSH BUTT JOINT. BRUSH AND CLEAN ALL PIPES.
- 2. APPLY THE MASTIC JOINT SEALANT TO THE FIRST 6" (150) OF EACH PIPE.
- 3. BUTT THE PIPES TOGETHER LEAVING A MINIMUM OF 12' × 6' (300 × 150) DEEP EXCAVATION UNDER AND AROUND EACH PIPE END.
- 4. CUT A PIECE OF SHEET METAL GAGE NO. 19 1.1 (0.0418) 18" (450) WIDE BY THE OUTSIDE CIRCUMFERENCE OF THE PIPE PLUS 3" (75) LONG.
- 5. WRAP THE SHEET METAL AROUND THE PIPES, 9" (225) ON EACH SIDE OF THE JOINT, STARTING AT THE TOP OF THE PIPE.
- 6. LAP THE SHEET METAL AT LEAST 3" (75) AT THE TOP OF THE PIPE AND PLACE THE MASTIC JOINT SEALANT BETWEEN THE LAP.
- 7. PLACE TWO METAL BANDS AROUND THE SHEET METAL AND TIGHTEN.
- 8. WIPE OFF ANY EXCESS MASTIC JOINT SEALANT THAT OOZES OUT FROM BETWEEN THE SHEET METAL AND THE PIPES.
- 9. PLACE CLASS SI CONCRETE AROUND THE JOINT.

ALL DIMENSIONS ARE IN INCHES (MILLIMETERS UNLESS OTHERWISE SHOWN.

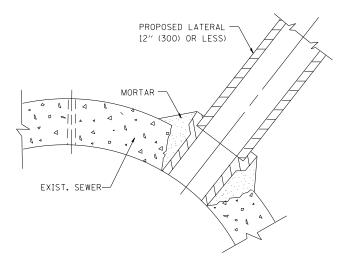

DETAIL "C"

PROPOSED LATERAL CONNECTION TO EXISTING SEWER OF 30" (750) OR LARGER

NOTES

MATERIAL

MATERIAL USED FOR THE TEE OR WYE SECTION SHALL BE COMPATIBLE WITH THE EXISTING STORM SEWER OR THE PROPOSED STORM SEWER.

- I. THIS WORK SHALL BE CONSTRUCTED IN CONFORMANCE WITH THE APPLICABLE PORTIONS OF SECTION 550 OF THE STANDARD SPECIFICATIONS.
- II. CONNECTION TO AN EXISTING STORM SEWER SHALL BE BY EITHER OF THE FOLLOWING METHODS: A) PROPOSED STORM SEWER CONNECTION TO EXISTING SEWER OF 27" (675) OR SMALLER SEE
 - B) PROPOSED STORM SEWER CONNECTION TO EXISTING SEWER OF 30" (750) OR LARGER SEE

IF THE EXISTING SEWER PIPE IS CRACKED, BROKEN OR OTHERWISE DAMAGED BY THE CONTRACTOR IN MAKING THE CIRCULAR OPENING, THE CONTRACTOR SHALL REPLACE THAT SECTION OF PIPE WITH PIPE EQUAL AND SIMILAR IN ALL RESPECTS TO THE PIPE IN THE EXISTING SEWER, IN A CAREFUL WORKMANLIKE MANNER, WITHOUT EXTRA COMPENSATION.

GENERAL

CARE MUST BE TAKEN TO PREVENT DEBRIS FROM ENTERING THE SEWER. ALL DEBRIS WHICH ENTERS THE SEWER MUST BE REMOVED. THE SEWER MUST BE LEFT CLEAN AND UNOBSTRUCTED UPON COMPLETION OF THE CONTRACT.

CARE MUST BE TAKEN TO PREVENT ANY PART OF THE NEW PIPE CONNECTION FROM PROJECTING INTO THE EXISTING SEWER.

BASIS OF PAYMENT

TEE OR WYE CONNECTIONS SHALL BE PAID FOR AT THE CONTRACT UNIT PRICE EACH FOR STORM SEWER TEE OR WYE OF THE TYPE AND SIZE SPECIFIED IN THE PLANS, THIS PRICE SHALL INCLUDE ALL EXCAVATION OF THE TRENCH, REMOVAL OF THE EXISTING STORM SEWER, FURNISHING AND INSTALLING THE SPECIFIED TEE OR WYE SECTION, FURNISHING AND INSTALLING THE REQUIRED CONCRETE COLLAR, AND ALL OTHER MATERIAL NECESSARY TO COMPLETE THIS WORK AS SHOWN AND SPECIFIED.

REMOVAL AND REINSTALLATION OF EXISTING STORM SEWER ADJACENT TO THE PROPOSED TEE OR WYE SECTION, FOR THE PURPOSE OF FACILITATING THE INSTALLATION OF THE TEE OR WYE SECTION, WILL NOT BE PAID FOR SEPARATELY BUT SHALL BE INCLUDED IN THE UNIT PRICE BID FOR THE WORK.

TRENCH BACKFILL, EXCAVATION IN ROCK AND REMOVAL AND REPLACEMENT OF UNSUITABLE MATERIAL BELOW PLAN BEDDING GRADE WILL BE PAID FOR SEPARATELY.


SCALE: NONE


CONCRETE COLLAR FOR CONNECTING A PROPOSED STORM SEWER TO AN EXISTING STORM SEWER WILL NOT BE PAID FOR SEPARATELY BUT SHALL BE INCLUDED IN THE COST OF THE PROPOSED

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OF TRANSP	NSPORT

TATION

DISTRICT 1 STANDARD DETAILS						F.A.I. RTE.	SECTION	COUNTY	TOTAL SHEETS	SHEET NO.
			BD-07			•	2013-011R	COOK	356	309
							BD500-01 (BD-7)	CONTRACT	NO.	50W29
SHEET NO. 1	OF .	22	SHEETS	STA.	TO STA.	FFD. RO	DAD DIST, NO. 1 JULINOIS FED. A	D PROJECT		

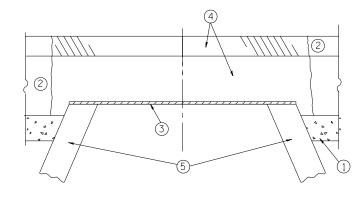

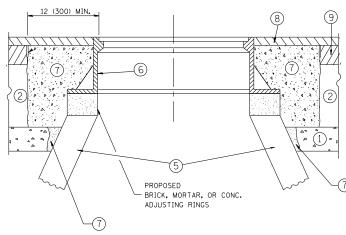

EXISTING BROKEN FRAMES AND LIDS SHALL BE REMOVED AND DISPOSED OF BY THE CONTRACTOR AND SHALL BE REPLACED AS DIRECTED BY THE ENGINEER. REPLACEMENT FRAMES AND LIDS WILL BE PAID FOR IN ACCORDANCE WITH ARTICLE 109.04 OF THE STANDARD SPECIFICATIONS UNLESS A SEPARATE PAY ITEM HAS BEEN PROVIDED.

IF THE EXISTING LIDS ARE OPEN, THE FRAME WILL BE ADJUSTED TO THE ELEVATION OF THE MILLED PAVEMENT SURFACE PRIOR TO THE MILLING OPERATION. THE FRAME WILL NOT BE REMOVED AND COVERED BY THE METAL PLATE.

CITY OF CHICAGO CASTINGS ARE THE PROPERTY OF THE CITY AND THE CONTRACTOR SHALL NOTIFY THE CITY FOR REMOVAL AND DISPOSITION OF THE CASTINGS.

THE METAL PLATE USED TO COVER THE STRUCTURE SHALL REMAIN THE PROPERTY OF THE CONTRACTOR.

WHEN STRUCTURES ARE TO BE ADJUSTED OR RECONSTRUCTED, THE LOWERING AND RAISING OF THE FRAMES AND LIDS WILL NOT BE PAID FOR SEPARATELY BUT WILL BE INCLUDED IN THE COST OF THE CORRESPONDING PAY ITEM.

CONSTRUCTION PROCEDURES

STAGE 1 (BEFORE PAVEMENT MILLING)

- A) REMOVE A MINIMUM OF 12 (300) OF THE PAVEMENT FROM
- AROUND THE STRUCTURE.

 B) REMOVE THE EXISTING FRAME AND LID FROM THE STRUCTURE.
- C) COVER THE STRUCTURE OPENING WITH A 36 (900) DIAMETER METAL PLATE.

 D) BACKFILL WITH CRUSHED STONE AND A MINIMUM 11/2 (40)
- THICK HMA SURFACE MIX APPROVED BY THE ENGINEER.

STAGE 2 (AFTER PAVEMENT MILLING)

- A) REMOVE THE HMA SURFACE MIX AND CRUSHED STONE.
- B) INSTALL THE FRAME AND LID; ADJUST THE FRAME TO ITS FINAL SURFACE ELEVATION.
- C) THE SURROUNDING SPACE SHALL BE FILLED WITH CLASS PP-1* CONCRETE TO THE ELEVATION OF THE SURFACE OF THE EXISTING BASE COURSE OR THE BINDER COURSE.
- *UNLESS OTHERWISE SPECIFIED IN THE PLANS.

THE PROCEDURE EXPLAINED ABOVE SHALL CONFORM TO THE APPLICABLE PORTIONS OF SECTIONS 353, 406, 602, AND 603 OF THE STANDARD SPECIFICATIONS EXCEPT THAT "THE CONTRACTOR SHALL ADJUST THE STRUCTURES TO THE FINISHED PAVEMENT ELEVATION NO MORE THAN 5 CALENDAR DAYS PRIOR TO PLACEMENT OF THE FINAL LIFT OF SURFACE UNLESS APPROVED BY THE

LEGEND

- 1 SUB-BASE GRANULAR MATERIAL
- (6) FRAME AND LID (SEE NOTES)
- 2 EXISTING PAVEMENT
- (7) CLASS PP-1* CONCRETE
- 3 36 (900) DIAMETER METAL PLATE
- PROPOSED CRUSHED STONE AND HMA SURFACE MIX
- (8) PROPOSED HMA SURFACE COURSE
- (5) EXISTING STRUCTURE
- (9) PROPOSED HMA BINDER COURSE

LOCATION OF STRUCTURES:

THE CONTRACTOR WILL BE REQUIRED TO KEEP A RECORD OF THE LOCATIONS OF THE BURIED STRUCTURES ACCORDING TO THE STATION AND DISTANCE LEFT OR RIGHT OF THE CENTERLINE OF PAVEMENT. UPON COMPLETION OF THE WORK, THE CONTRACTOR WILL DELIVER THE RECORD TO THE ENGINEER.

BASIS OF PAYMENT:

REMOVING FRAMES AND LIDS ON DRAINAGE AND UTILITY STRUCTURES IN THE PAVEMENT PRIOR TO MILLING, AND ADJUSTING TO FINAL GRADE PRIOR TO PLACING THE SURFACE COURSE, WILL BE PAID FOR AT THE CONTRACT UNIT PRICE EACH FOR "FRAMES AND LIDS TO BE ADJUSTED

THIS WORK WILL NOT BE PAID FOR WHEN DRAINAGE AND UTILITY STRUCTURES ARE SPECIFIED FOR PAYMENT AS STRUCTURE RECONSTRUCTION.

NEW FRAMES AND LIDS, WHEN SPECIFIED, WILL BE PAID FOR SEPARATELY.

DETAILS FOR FRAMES AND LIDS ADJUSTMENT WITH MILLING


ALL DIMENSIONS ARE IN INCHES (MILLIMETERS) UNLESS OTHERWISE SHOWN

FILE NAME = DESIGNED - R. SHAH REVISED - R. WIEDEMAN 05-14-04 USER NAME = BAWitort wx/\388039-pwintl.aecomonline.local:PWAEEOM00\Documents\01 Americas\Transportation\\$0D\$R#NN Circle\Phase_II\000_CAD\006_Roadk4REN6E6\60w29RCoBGAGt\0169w29FCoBGAG CHECKED REVISED REVISED - R. BORO 12-06-11 PLOT DATE = 10/28/2013 DATE

STATE OF ILLINOIS **DEPARTMENT OF TRANSPORTATION**

DISTRICT 1 STANDARD DETAILS SCALE: NONE SHEET NO. 2 OF 22 SHEETS STA.


COUNTY 2013-011R COOK 356 310 BD600-03 (BD-8) CONTRACT NO. 60W29 TO STA.

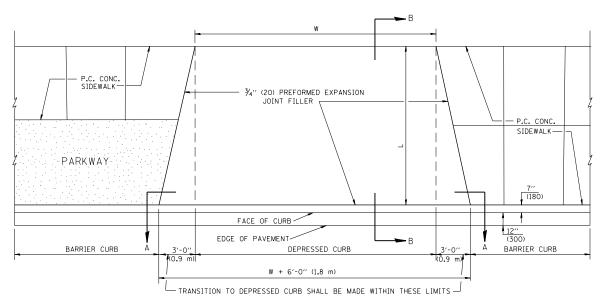


PLAN VIEW


NOTES:

- EXPANSION JOINTS SHALL BE CONSTRUCTED AS SHOWN ON THE DETAILS FOR P.C.C. SIDEWALK.
- THE CURB BETWEEN ADJACENT DRIVEWAYS SHALL BE FULL HEIGHT FOR A DISTANCE OF AT LEAST FOUR 4 FEET (1.2 METERS)
- 3. P.C. CONCRETE DRIVEWAYS SHALL BE CONSTRUCTED AT LOCATIONS SHOWN ON THE PLANS OR AS DIRECTED BY THE ENGINEER.
- ¾4" (20) PREFORMED EXPANSION JOINTS WILL NOT BE PAID FOR SEPARATELY BUT SHALL BE CONSIDERED INCIDENTAL TO P.C.C. DRIVEWAY PAVEMENT 8" (200).
 COMBINATION CONC. CURB AND GUTTER SHALL BE
- COMBINATION CONC. CURB AND GUTTER SHALL BE MEASURED STRAIGHT ACROSS THE DRIVEWAY. NO ADDITIONAL COMPENSATION WILL BE ALLOWED FOR THE TRANSITION CURB AND GUTTER.

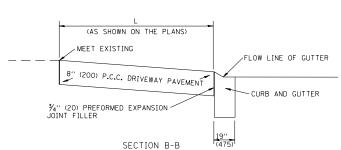

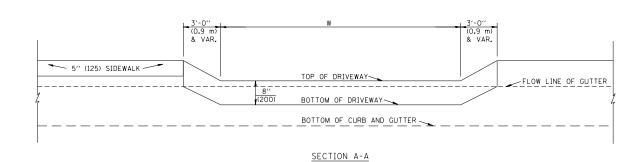

P.C.C. DRIVEWAY PAVEMENT DETAIL

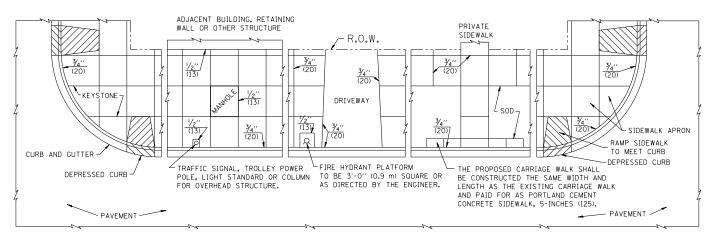

SIDEWALK SIDEWALK 1" (25) PREFORMED EXPANSION JOINT FILLER


SLOPE FOR SIDEWALK 1" (25) IN 3'-0" (0.9 m) IN CHICAGO


NOTES:

- ONE-HALF INCH THICK EXPANSION JOINTS SHALL BE PLACED BETWEEN THE SIDEWALK AND ALL STRUCTURES SUCH AS LIGHT STANDARDS, TRAFFIC LIGHT STANDARDS, MANHOLES, WHICH EXTEND THROUGH THE SIDEWALK.
- 2. ¾4" (20) THICK EXPANSION JOINTS SHALL BE PLACED AT INTERVALS OF NOT MORE THAN 100 FEET (30 METERS) IN THE SIDEWALK, WHERE THE SIDEWALK IS CONSTRUCTED ADJACENT-TO PAVEMENT OR CURB HAVING EXPANSION JOINTS, THE EXPANSION JOINTS IN THE SIDEWALK SHALL BE PLACED OPPOSITE THE EXISTING EXPANSION JOINTS AS NEARLY AS PRACTICABLE. EXPANSION JOINTS SHALL ALSO BE PLACED WHERE THE SIDEWALK ABUTS EXISTING SIDEWALKS, BETWEEN DRIVEWAY PAVEMENT AND SIDEWALK, AND BETWEEN SIDEWALK AND CURBS WHERE THE-SIDEWALK ABUTS A CURB.

PORTLAND CEMENT CONCRETE SIDEWALK DETAILS

NOTES: NO EXTRA COMPENSATION SHALL BE ALLOWED FOR THE GUTTER FLARE

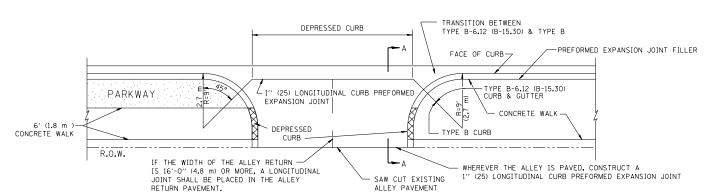

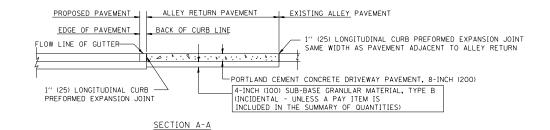


ALLEY RETURN DETAIL

ALL DIMENSIONS ARE IN INCHES (MILLIMETERS) UNLESS OTHERWISE SHOWN

FILE NAME =	USER NAME = BAWitort	DESIGNED - M. DE YONG	REVISED -			DISTRICT 1 STANDARD DETAIL	c	F.A.I. SE	CTION	COUNTY	TOTAL S	HEET NO.
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	PLOT SCALE = 100.0000 ' / in.	CHECKED -	REVISED -	DEPARTMENT OF TRANSPORTATION				BD400-03	(BD-17)	CONTRACT	NO. 601	129
	PLOT DATE = 10/28/2013	DATE - 06-13-90	REVISED -		SCALE: NONE	SHEET NO. 3 OF 22 SHEETS STA.	TO STA.	FED. ROAD DIST. NO.	1 ILLINOIS FED. AI	D PROJECT		


• 90/94/290

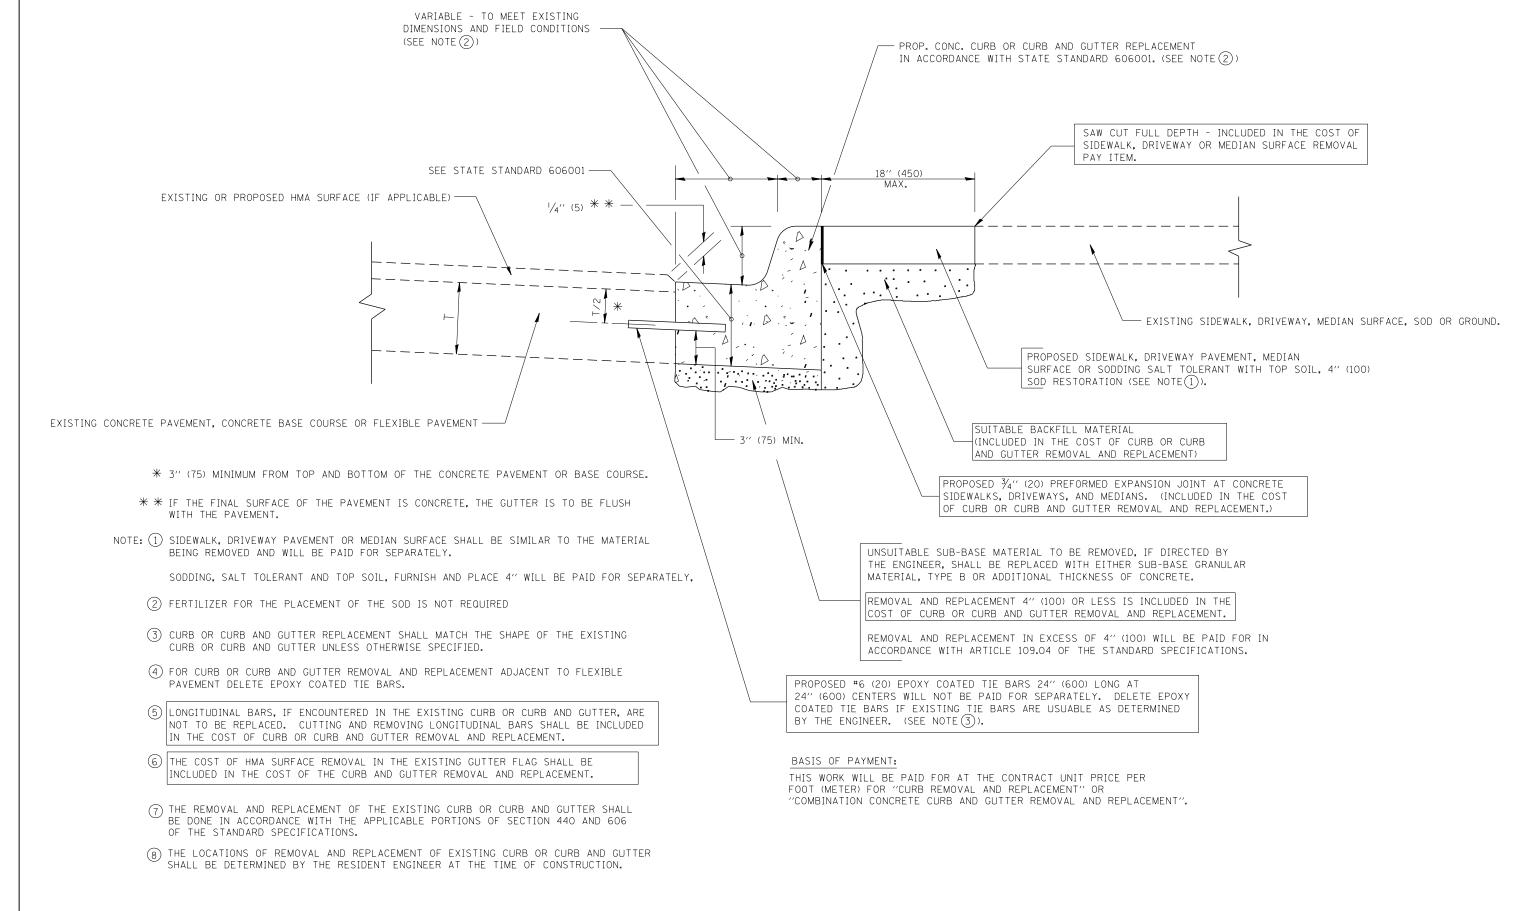


CURB OR CURB AND GUTTER REMOVAL AND REPLACEMENT

ALL DIMENSIONS ARE IN INCHES (MILLIMETERS) UNLESS OTHERWISE SHOWN.

FILE NAME =	USER NAME = BAWitort	DESIGNED - A. HOUSEH	REVISED - R. SHAH 10-03-96		DISTRICT 1 STANDARD DETAILS	F.A.	e I SECTION	COUNTY	SHEETS	SHEET NO.
pw:\\388039-pwintlaecomonline.local:PWA	AECOM00\Documents\01 Americas\Transporta	tion\\$0 069AWN Circle\Phase_II\000_CAD\006_Roa	dvagE\$H&EB\60W29_CAntABBAB160W2915H971	Ol-Detail-04.dgn STATE OF ILLINOIS		•	2013-011R	соок	356	312
	PLOT SCALE = 100.000 ' / in.	CHECKED -	REVISED - M. GOMEZ 01-22-01	DEPARTMENT OF TRANSPORTATION	KII_/4			NO. 60	.0W29	
	PLOT DATE = 10/28/2013	DATE - 03-11-94	REVISED - R. BORO 12-15-09		SCALE: NONE SHEET NO. 4 OF 22 SHEETS STA. TO STA.	FED		AID PROJECT		

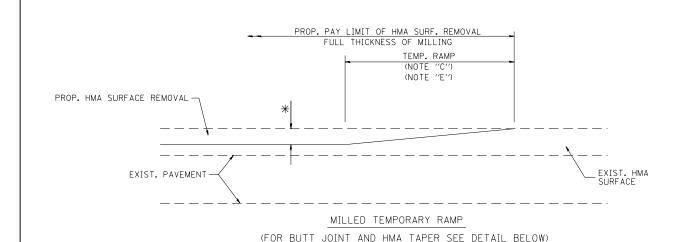


OPTION 1

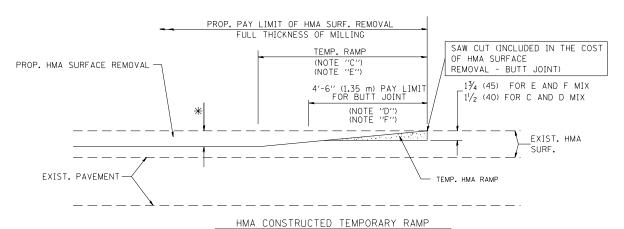

(FOR BUTT JOINT AND HMA TAPER SEE DETAIL BELOW)


OPTION 2


TYPICAL TEMPORARY RAMP

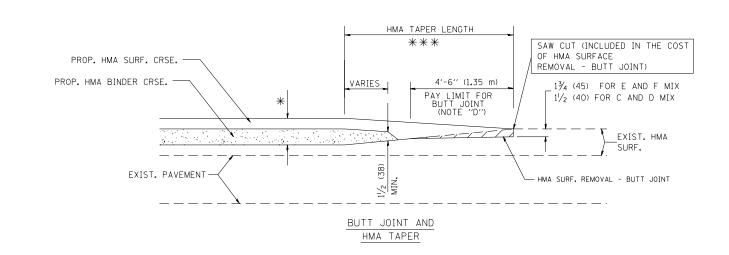

TYPICAL BUTT JOINT AND HMA TAPER FOR MILLING AND RESURFACING

STATE OF ILLINOIS
DEPARTMENT OF TRANSPORTATION

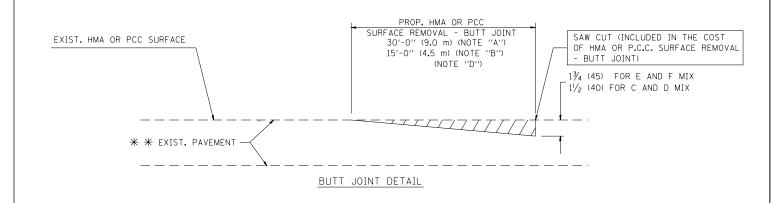

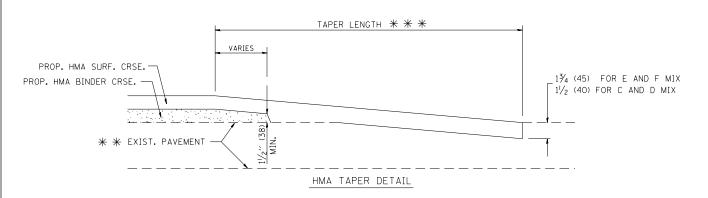

TYPICAL BUTT JOINT AND HMA TAPER FOR RESURFACING ONLY

* * PC CONCRETE, HMA OR HMA RESURFACED PAVEMENT.

NOTES

- A: MAINLINE ROADWAYS AND MAJOR SIDE ROADS.
- : MINOR SIDE ROADS.
- C: THE TEMP. RAMP SHALL BE CONSTRUCTED IMMEDIATELY UPON REMOVAL OF THE EXISTING HMA SURFACE.
- D: THE BUTT JOINT SHALL BE CONSTRUCTED IMMEDIATELY PRIOR TO PLACING THE PROPOSED HMA COURSES.
- E: TAPER THE TEMP. RAMP AT A RATE OF 3'-0" (900 mm) PER 1 INCH (25 mm) OF MILLING THICKNESS.
- F: INSTALLATION AND REMOVAL OF THE 4'-6" (1.35 m) TEMP. RAMP IS INCLUDED IN COST OF HMA SURFACE REMOVAL BUTT JOINT
- G: SEE ARTICLE 406.08 AND 406.14 OF THE STANDARD SPECIFICATIONS FOR "HMA AND/OR PCC SURFACE REMOVAL, BUTT JOINT".
- * SEE TYPICAL SECTIONS FOR MILLING THICKNESS.

BASIS OF PAYMENT:

THE BUTT JOINT WILL BE PAID FOR AT THE CONTRACT UNIT PRICE PER SQUARE YARD (SQUARE METER) FOR "HOT-MIX ASPHALT SURFACE REMOVAL - BUTT JOINT" OR FOR "PORTLAND CEMENT CONCRETE SURFACE REMOVAL- BUTT JOINT".

ALL DIMENSIONS ARE IN INCHES (MILLIMETERS) UNLESS OTHERWISE SHOWN.

FRAME EXTENSION INTO PAVEMENT	INNER HOOP REINFORCEMENT DIAMETER	SEMI CIRCULAR FORM DIAMETER	OUTER HOOP REINFORCEMENT DIAMETER
UP TO 8" (200)	3′-6′′ (1.1 m)	4'-0'' (1.2 m)	5′-0″ (1.5 m)
> 8" (200) T0 14" (360)	4'-0'' (1.2 m)	4'-6" (1.4 m)	5′-0″ (1.5 m)

DESIGNER NOTE: THIS DETAIL IS TO BE USED WHEN THE GUTTER FLAG IS LESS THAN 24"

LEGEND:

pw:\\388039-pwintl.secomonline.local:PWAELDM00\Documents\01 Americas\Transportation\\$08\$7700 Circle\Phat6MI\00MID0SB06.Road_#RS%6ED\60W24.CMA76H1SD60W09992H00HDetail-06.dgr

DATE

PLOT DATE = 10/28/2013

CHECKED - A. ABBAS

- 01-04-99

REVISED - T. MATOUSEK 04-25-02

REVISED - P. LAFLEUR 08-27-02


FILE NAME =

- NOTES :
- 1. THE ROUNDOUT AND ADDED REINFORCEMENT WILL NOT BE PAID SEPARATELY, BUT SHALL BE INCLUDED IN THE CONTRACT UNIT PRICE FOR THE PAVEMENT.
- TRANSVERSE JOINTS MAY BE MOVED TO ACCOMMODATE ROUNDOUT, EDGE OF CIRCULAR JOINT SHALL BE MINIMUM 12" (300) FROM TRANSVERSE JOINT. RELOCATED TRANSVERSE JOINT SHALL BE CONTINUOUS FROM EDGE OF PAVEMENT TO EDGE OF PAVEMENT.
- 3. SEMI-CIRCULAR FORM SHALL BE REMOVED PRIOR TO DRILL AND GROUT OF TIE BARS.
- 4. ALL REINFORCED BARS SHALL BE EPOXY COATED.
- 5. DRILL AND GROUT IS PREFERRED, HOWEVER TIE BARS CAN BE POURED IN PLACE IF CLEARANCE IS PROVIDED TO OUTER EDGE OF FRAME. MINIMUM 2" (50) CLEARANCE.
- 6. WOOD SHIMS SHALL BE USED TO ADJUST ALL FRAMES. AFTER ADJUSTING MORTAR HAS CURED, THE WOOD SHIMS SHALL BE REMOVED AND THE VOIDS UNDER THE FRAMES FILLED WITH NON SHRINK GROUT.
- 7. HOOP REINFORCEMENT SHALL BE ONE PIECE CONSTRUCTION.
- 8. CIRCULAR FRAMES AND GRATES MAY BE SUBSTITUTED.
- 9. CURB DOWELS MUST BE PLACED LEVEL & TRUE TO ALLOW CONTRACTION MOVEMENT.

DISTRICT 1 STANDARD DETAILS

SHEET NO. 6 OF 22 SHEETS STA.

SCALE: NONE

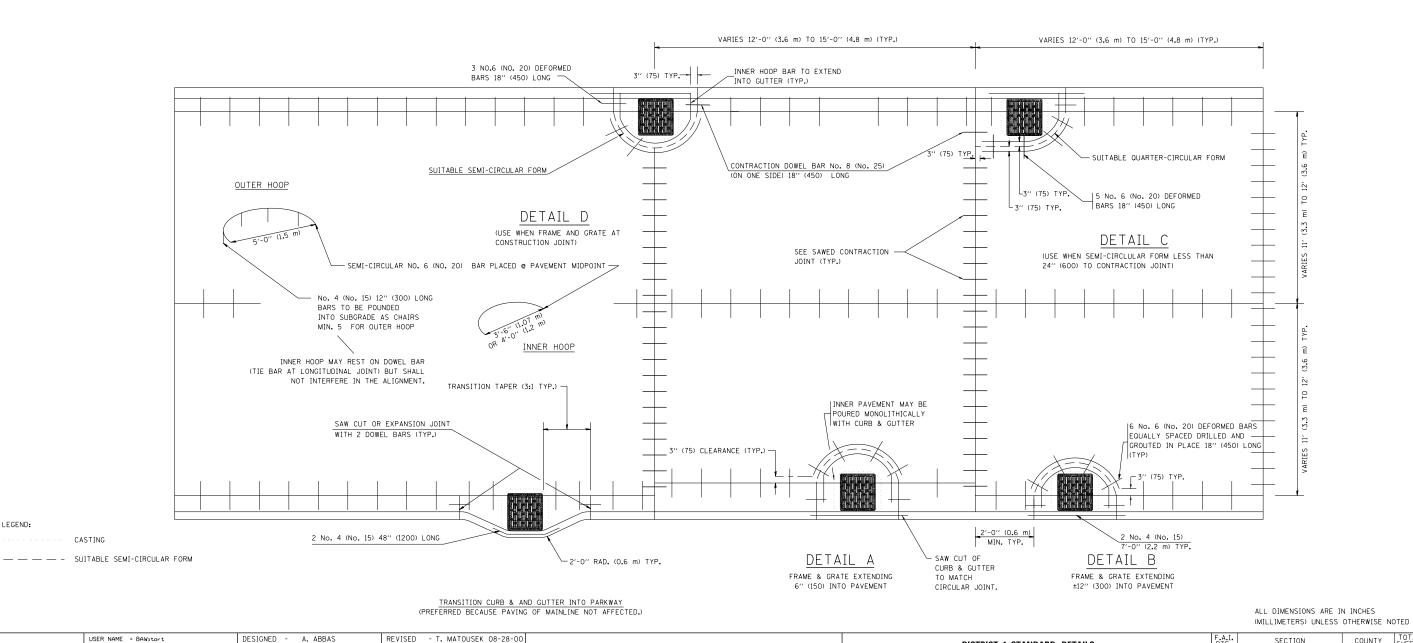

STATE OF ILLINOIS

DEPARTMENT OF TRANSPORTATION

FED. ROAD DIST. NO. 1 IL

TO STA.


2013-011R

COUNTY

COOK

356 314

CONTRACT NO. 60W29

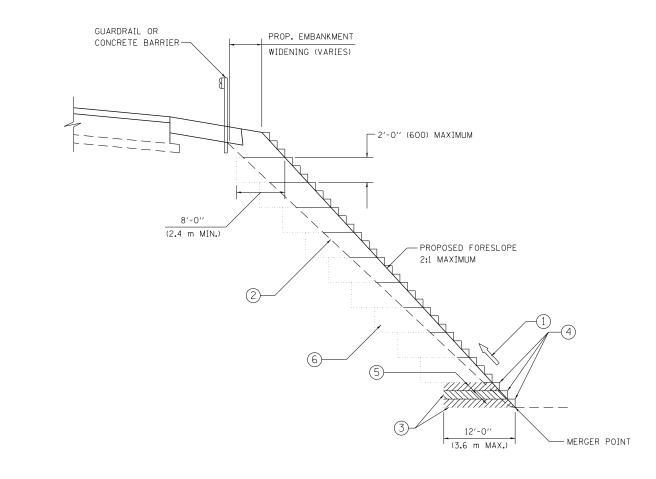

TYPICAL BENCHING DETAIL FOR EMBANKMENT

NOTES:

- CONSTRUCT SUCCEEDING BENCH CUTS AND EMBANKMENT PLACEMENT AND COMPACTION FROM BOTTOM TO TOP IN STAIRSTEP FASHION.
- EXISTING FORESLOPE PREPARED IN ACCORDANCE WITH ARTICLE 205.03 OF THE STANDARD SPECIFICATIONS.
- BENCH CUT EXISTING SLOPE TYPICAL FOR EACH STEP.
- (4) TRIM TO FINAL SLOPE.
- EQUAL 8-INCH (200) LIFTS OF EMBANKMENT COMPACTED IN ACCORDANCE WITH ARTICLE 205.05 OF THE STANDARD SPECIFICATIONS.
- EXCAVATION OF BENCH CUTS WITHIN EXISTING EMBANKMENT WILL BE PAID FOR AT THE CONTRACT UNIT PRICE PER CUBIC METER OR CUBIC YARD FOR "EARTH EXCAVATION". THIS PRICE WILL INCLUDE ALL LABOR AND MATERIAL, NO ADDITIONAL COMPENSATION WILL BE ALLOWED.
- SLOPES SHALL BE BENCHED ACCORDING TO THIS DETAIL WHEN THE SLOPE IS STEEPER THAN 4:1 AND THE HEIGHT IS GREATER THAN 5' (1.5 m).


ALL DIMENSIONS ARE IN INCHES (MILLIMETERS) UNLESS OTHERWISE SHOWN.

COOK 356 315

FILE NAME = USER NAME = BAWitort DESIGNED -REVISED pw:\\388039-pwintl.aecomonline.local:PWAE\$0M00\Documents\01 Americas\Transportation\\$00679881 Circle\Ph&&DD\000_CAD\000_CAD\006_Road+d}\\$96560029-Contract\D1600029-SHT-D1 |Detail-07.dgn CHECKED - S.E.B. REVISED PLOT DATE = 10/28/2013 - 06-16-04 REVISED DATE


STATE OF ILLINOIS **DEPARTMENT OF TRANSPORTATION**

COUNTY DISTRICT 1 STANDARD DETAILS 2013-011R CONTRACT NO. 60W29 SCALE: NONE SHEET NO. 7 OF 22 SHEETS STA. TO STA. FED. ROAD DIST. NO. 1 ILL

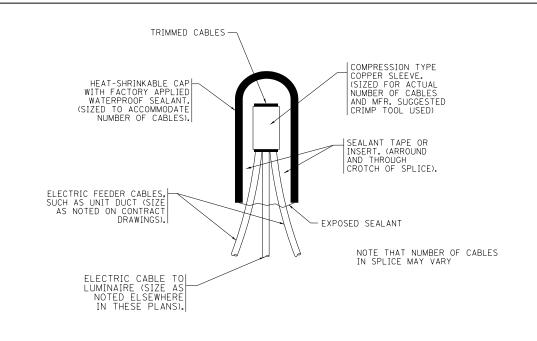

TYPICAL SPLICE DETAIL

N.T.S.

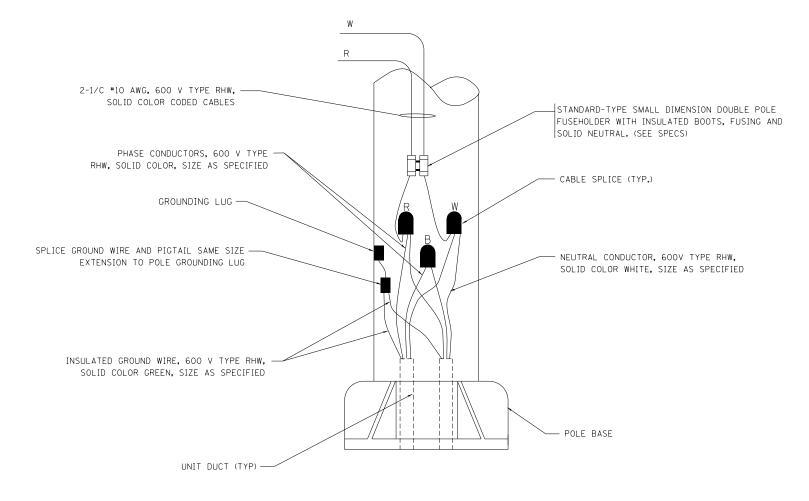

POLE WIRING DETAIL

N.T.S.

FILE NAME =	USER NAME = BAWitort	DESIGNED -	REVISED - 08-08-03			DISTRICT 1 STANDARD DETAILS	F.A.I. RTE.	SECTION	COUNTY TOTAL SHEET SHEETS NO.
pw:\\388039-pwintlaecomonline.local:Pl	WAECOM00\Documents\01 Americas\Transport PLOT SCALE = 100.000 '/ in.	ation\\$0069A88 Circle\Phase_II\000_CAD\006_F CHECKED -	oad - 485 SH&EB \ 60 \	Budge STATE OF ILLINOIS DEPARTMENT OF TRANSPORTATION		BE-702	•	2013-011R	COOK 356 316
	PLOT DATE = 10/28/2013	DATE -	REVISED -	DEI AITIMENT OF THANSFORTATION	SCALE: NONE	SHEET NO. 8 OF 22 SHEETS STA. TO STA.	FED. ROA	BE-702 D DIST. NO. 1 ILLINOIS FED. 7	CONTRACT NO. 60W29 AID PROJECT

• 90/94/290

12" (305) MAXIMUM WIDTH EXCEPT AS APPROVED BY THE ENGINEER

12" (305)

- WARNING TAPE AS SPECIFIED


UNIT DUCT OR OTHER RACEWAY AND WIRING AS PER PLANS. COMPLETE

WITH INTERNAL INSULATED EQUIPMENT GROUND WIRE.


TYPICAL WIRING IN TRENCH DETAIL

N.T.S.


30" (762) MINIMUM COVER

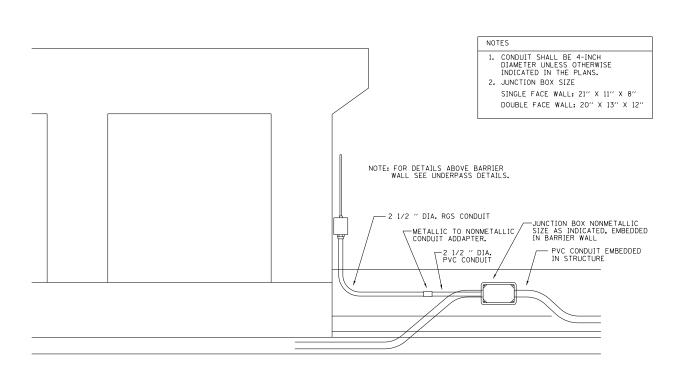


ED - BWD ELECTRIC CONNECTION TO UNDERPASS LIGHTING

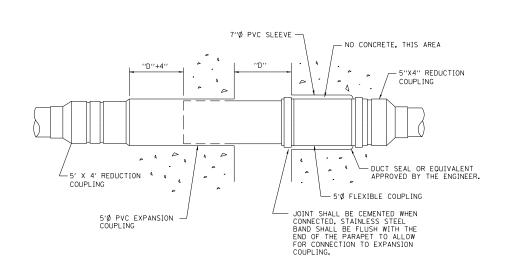

INSTALLATION OF CONDUIT IN BRIDGE PARAPET EXPANSION JOINT (N.T.S.)

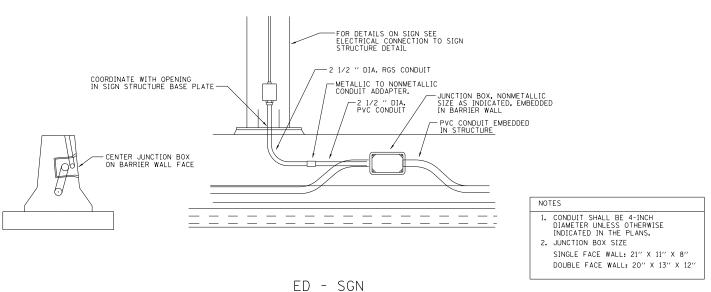

JUNCTION BOX EMBEDDED IN BARRIER WALL FOR SIGN LIGHTING

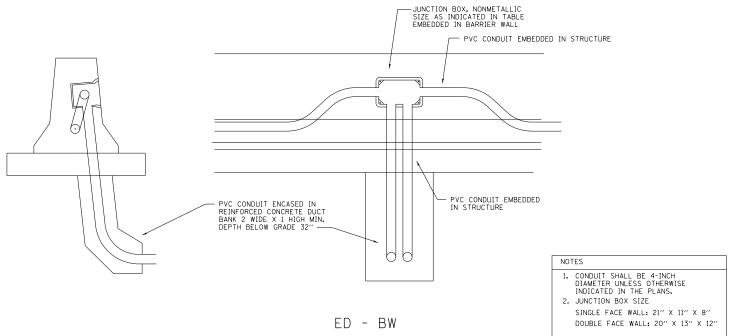

JUNCTION BOX EMBEDDED IN BARRIER WALL

FILE NAME =	USER NAME = BAWitort	DESIGNED -	REVISED -
D160W29-SHT-D1-Detail-09.dgn		DRAWN -	REVISED -
	PLOT SCALE = 100.0000 ' / in.	CHECKED -	REVISED -
	PLOT DATE = 10/28/2013	DATE - 01-20-2009	REVISED -


STATE OF ILLINOIS **DEPARTMENT OF TRANSPORTATION**

SECTION COUNTY DISTRICT 1 STANDARD DETAILS 2013-011R COOK BE-703 BE-703 CONTRACT NO. 60W29 SCALE: NONE SHEET NO. 9 OF 22 SHEETS STA. TO STA. FED. ROAD DIST. NO. 1 ILLIN


356 317


• 90/94/290


COMMUNICATIONS VAULT LOAD RATINGS COMPONENT ANSI TIER DESIGN TEST BOX 22 22,500 lbs. 37,750 lbs. COVER 22 22,500 lbs. 37,750 lbs.

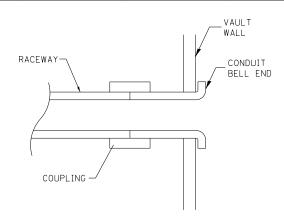


<u>DETAIL A</u>

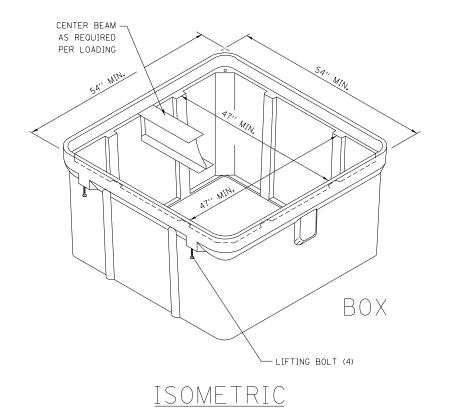


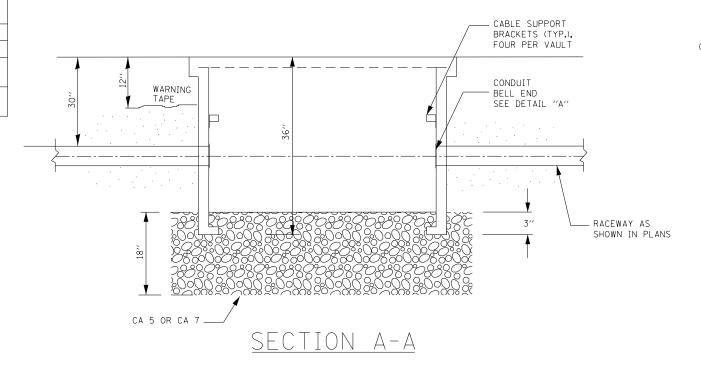

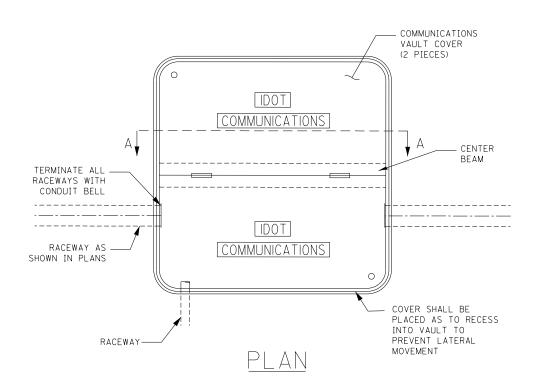

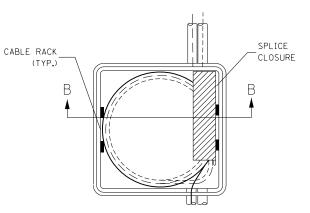

TOP VIEW

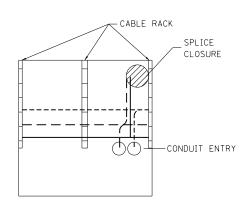


SECTION B-B

NOTES:

- 1. BOX SHALL HAVE AN OPEN BASE.
- 2. ALL OPENINGS IN STRUCTURE MUST BE MACHINED AT TIME OF FABRICATION OR PUNCH DRIVEN AT TIME OF PLACEMENT. IN ACCORDANCE WITH MANUFACTURER RECOMMENDATIONS.
- 3. FIELD PLACEMENT OF COMMUNICATIONS VAULT SHALL BE AS DIRECTED BY THE ENGINEER.
- 4. ALL DIMENSIONS ARE MINIMUM AND A LARGER SIZE HANDHOLE MAY BE USED, WITH THE APPROVAL OF THE ENGINEER, TO FACILITATE USING A MANUFACTURER'S STANDARD PRODUCT.

	USER NAME = BAWitort	DESIGNED - R. Tomsons	REVISED	Detail-10.dgn STATE OF ILLINOIS	DISTRICT 1 STANDARD DETAILS BE-705		F.A.I. RTE.	SECTION	COUNTY TOTAL SHEET NO.
,	PLOT SCALE = 100.0000 '/ in.	CHECKED -	REVISED -	DEPARTMENT OF TRANSPORTATION			_	2013-008R BE-705	COOK 356 318 CONTRACT NO. 60W29
	PLOT DATE = 10/28/2013	DATE - 03-22-10	REVISED -		SCALE: NONE	SHEET NO. 10 OF 22 SHEETS STA. TO STA.	FED. RO	D DIST. NO. 1 ILLINOIS FED	. AID PROJECT
							• 90/9	1/290	

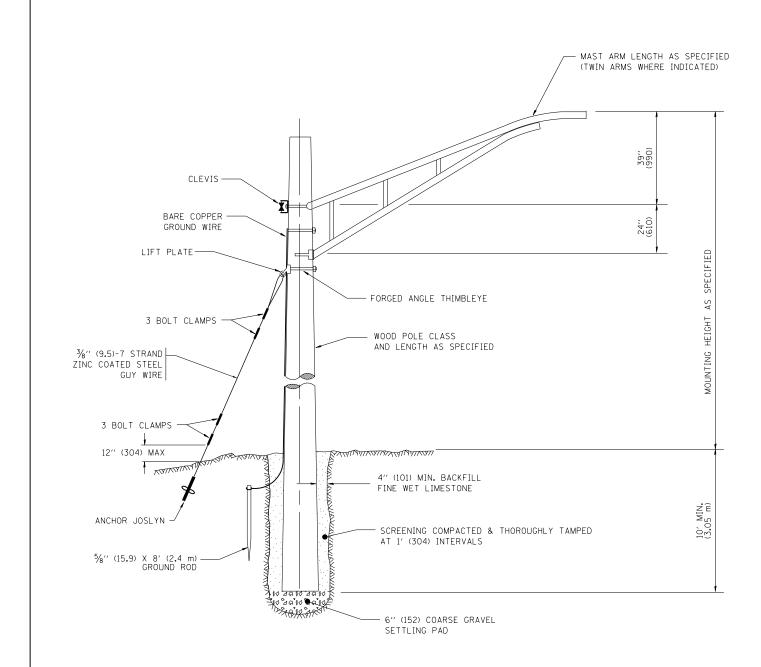

TEMPORARY LIGHT POLE DETAIL

MESSENGER TIED TO INSULATOR
WITH FACTORY FORMED CABLE TIE

GROUND CLAMP

AWG BARE COPPER
GROUND WIRE

WATERPROOF INSULATION
PIERCING TAP CONNECTOR

WATERPROOF FUSEHOLDER & FUSE
WATERPROOF FUSEHOLDER & AND SOLID NEUTRAL SLUG


TEMPORARY LIGHT POLE ATTACHMENT DETAIL


NOTES:

1. ALL DIMENSIONS IN INCHES (MILLIMETERS) UNLESS OTHERWISE INDICATED


FILE NAME =	USER NAME = BAWitort	DESIGNED -	REVISED - 08-08-03			DISTRICT 1 STANDARD DETAILS	F.A.I. RTF.	SECTION	COUNTY	TOTAL SHEET
		0067488 Circle\Phase_II\000_CAD\006_Road	・過 <u>に計画</u> と60W29_Contract\D160W29-SHT-D1 Detail-11.dgn			BE-800	•	2013-011R	COOK	356 319
	PLOT SCALE = 100.000 '/ in.	CHECKED -	REVISED -	DEPARTMENT OF TRANSPORTATION		DL-000		BE-800	CONTRACT	T NO. 60W29
	PLOT DATE = 10/28/2013	DATE -	REVISED -		SCALE: NONE	SHEET NO. 11 OF 22 SHEETS STA. TO STA.	FED. RO	DAD DIST. NO. 1 ILLINOIS FED. AID	D PROJECT	

• 90/94/290

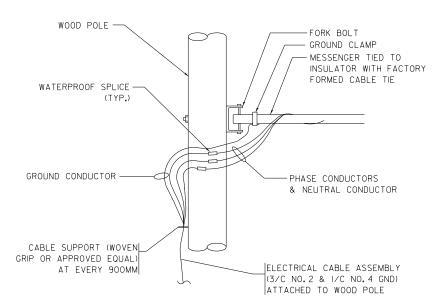

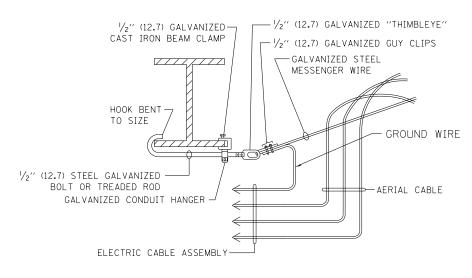

AERIAL CABLE ATTACHED TO STRUCTURE

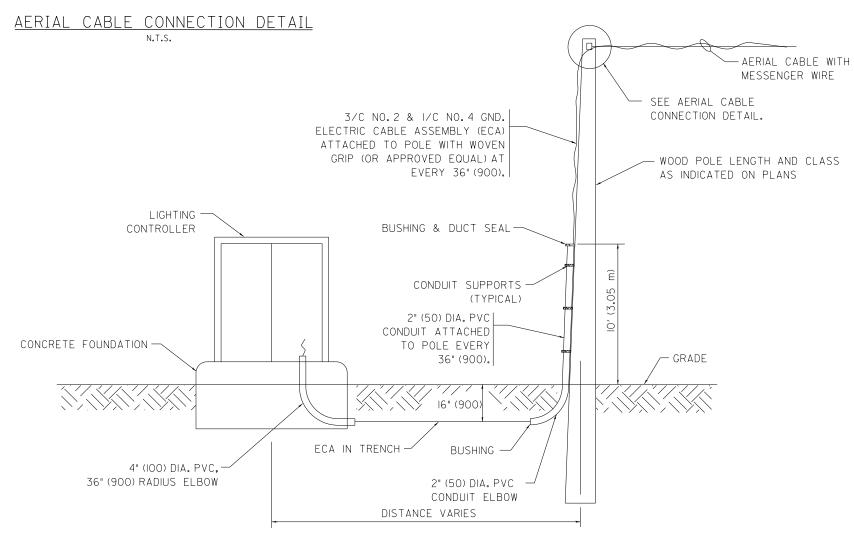

NOTES:


- 1. ALL DIMENSIONS IN INCHES (MILLIMETERS)
 UNLESS OTHERWISE INDICATED.
- SEE PROPOSED LIGHTING PLAN FOR CONDUIT, CABLE AND ROUTING.
- 3. THE CONTRACTOR SHALL PROVIDE INTERMEDIATE SUPPORTS TO MAINTAIN MINIMUM CLEARANCES. REFER TO AERIAL AERIAL CABLE ATTACHED TO STRUCTURE DETAIL.
- 4. COST OF SPLICES AND MOUNTING HARDWARE SHALL BE INCLUDED IN THE UNIT PRICE FOR AERIAL CABLE.

• 90/94/290

WOOD POLE TO LIGHTING CONTROLLER WIRING CONNECTION DETAIL

N.T.S

FILE NAME =	USER NAME = BAWitort	DESIGNED -	REVISED - 08-08-03			DISTRICT 1 STANDARD	D DETAILS	F.A.I. RTF	SECTION	COUNTY	TOTAL	SHEET
pw:\\388039-pwintl.aecomonline.local:PWAE0	OM00\Documents\01 Americas\Transportation\6	60D674788 Circle\Phase_II\000_CAD\006_Road	*	3 0 0			DETAILS		2013-011R	СООК	356	320
	PLOT SCALE = 100.000 '/ in.	CHECKED -	REVISED -	DEPARTMENT OF TRANSPORTATION		BE-801			BE-801	CONTRACT	NO. 6	0W29
	PLOT DATE = 10/28/2013	DATE -	REVISED -		SCALE: NONE	SHEET NO. 12 OF 22 SHEETS	STA. TO STA.	FED. ROAD D	IST. NO. 1 ILLINOIS FED. A	ID PROJECT		

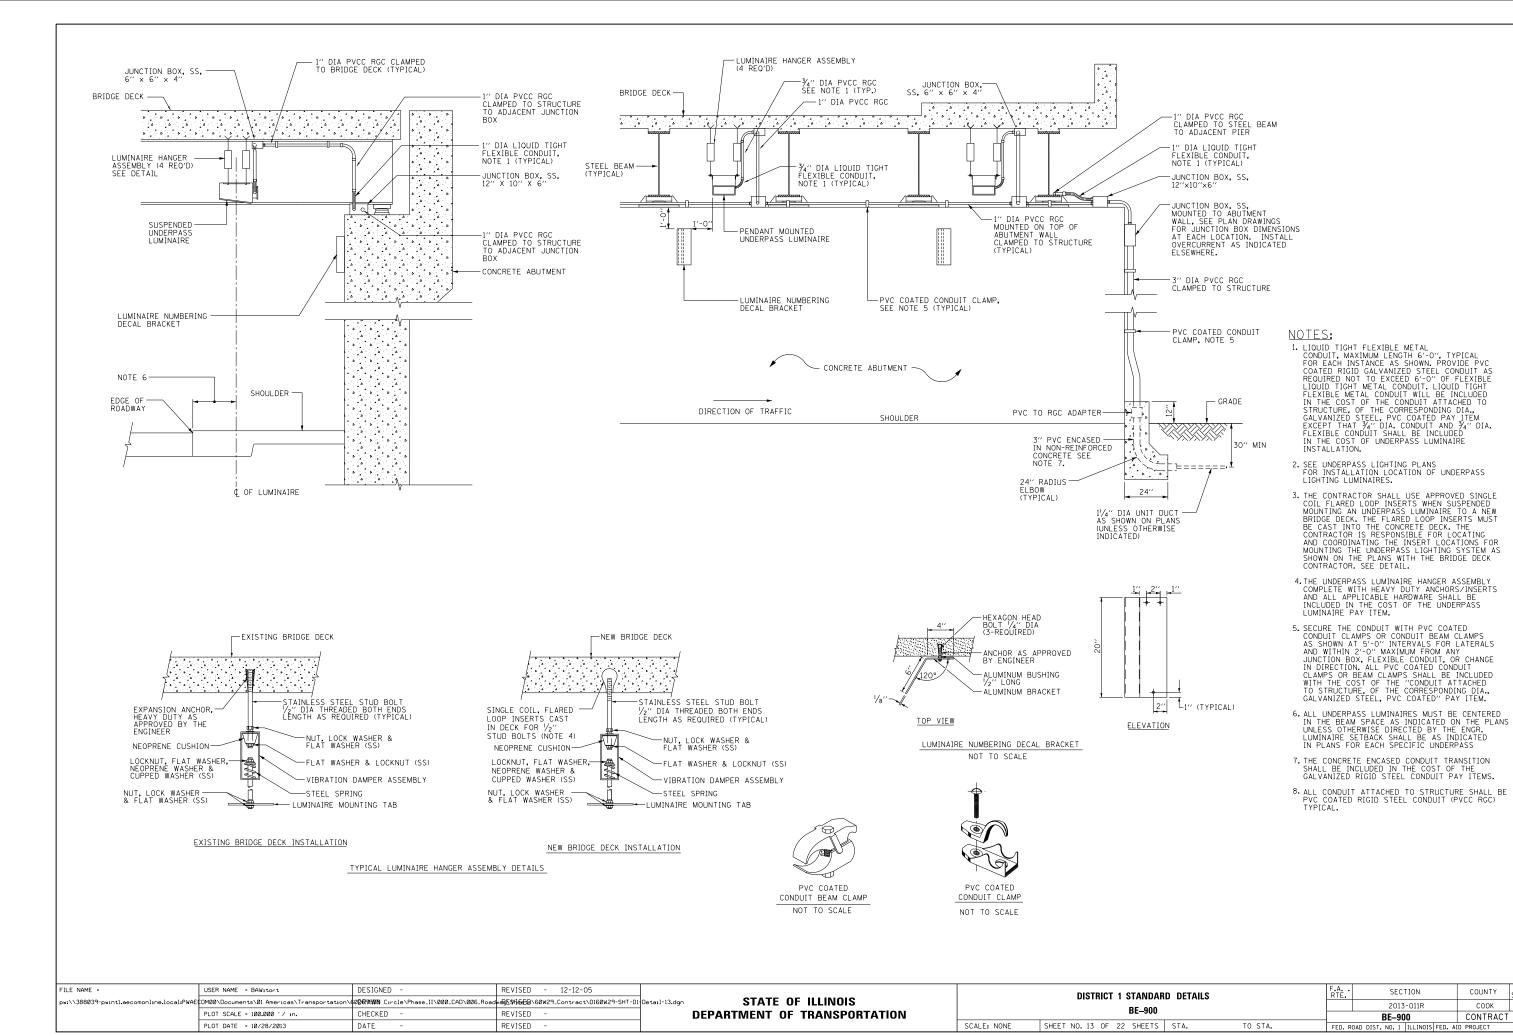

SECTION

2013-011R


BE-900

COUNTY


COOK

356 321

CONTRACT NO. 60W29

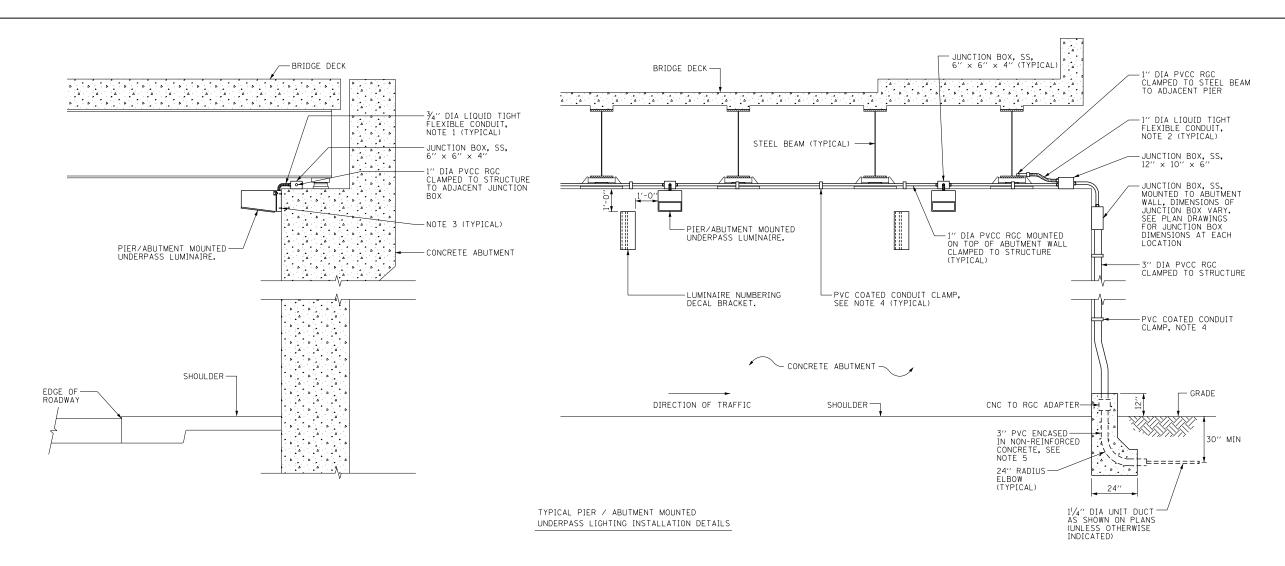

- 1. LIQUID TIGHT FLEXIBLE METAL
 CONDUIT, MAXIMUM LENGTH 6'-0", TYPICAL
 FOR EACH INSTANCE AS SHOWN, PROVIDE PVC
 COATED RIGID GALVANIZED STEEL CONDUIT AS
 REQUIRED NOT TO EXCEED 6'-0" OF FLEXIBLE
 LIQUID TIGHT METAL CONDUIT, LIQUID TIGHT
 FLEXIBLE METAL CONDUIT WILL BE INCLUDED
 IN THE COST OF THE CONDUIT ATTACHED TO
 STRUCTURE, OF THE CORRESPONDING DIA,
 GALVANIZED STEEL, PVC COATED PAY ITEM
 EXCEPT THAT THE COST OF THE 34" DIA,
 RIGID STEEL CONDUIT AND 34" DIA, FLEXIBLE
 CONDUIT SHALL BE INCLUDED IN THE LUMINAIRE
 INSTALLATION.
- 2. UNDERPASS LUMINAIRE MOUNTED TO FACE OF PIER OR ABUTMENT WALL. MOUNTING HEIGHT OF 1" BELOW THE TOP OF PIER OR ABUTMENT WALL TYPICAL FOR ALL PIER/ABUTMENT MOUNTED UNDERPASS LUMINAIRES UNLESS OTHERWISE NOTED.
- 3. EXPANSION ANCHOR, POWDER ACTUATED FASTENERS WILL NOT BE ALLOWED. EXPANSION ANCHOR MUST BE SIZED IN ACCORDANCE WITH MANUFACTURERS REQUIREMENTS.
- 4. SECURE THE CONDUIT WITH PVC COATED CONDUIT CLAMPS OR CONDUIT BEAM CLAMPS AS SHOWN AT 5'-O" INTERVALS FOR LATERALS AND WITHIN 2'-O" MAXIMUM FROM ANY JUNCTION BOX, FLEXIBLE CONDUIT, OR CHANGE IN DIRECTION. ALL PVC COATED CONDUIT CLAMPS OR BEAM CLAMPS SHALL BE INCLUDED WITH THE COST OF THE "CONDUIT ATTACHED TO STRUCTURE, OF THE CORRESPONDING DIA., GALVANIZED STEEL, PVC COATED" PAY ITEM.
- 5. THE CONCRETE ENCASED CONDUIT TRANSITION SHALL BE INCLUDED IN THE COST OF THE GALVANIZED RIGID STEEL CONDUIT PAY ITEMS.
- 6. ALL CONDUIT ATTACHED TO STRUCTURE SHALL BE PVC COATED RIGID STEEL CONDUIT (PVCC RGC) TYPICAL.

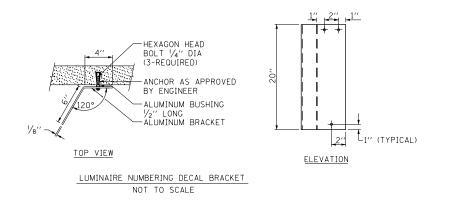

DESIGNED

CHECKED


DATE

USER NAME = BAWitort

PLOT SCALE = 100.000 '/ in.

PLOT DATE = 10/28/2013

FILE NAME =

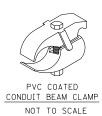



NOT TO SCALE

SCALE: NONE


REVISED - 01-25-05 ow:\\388039-pwintl.aecomonline.local:PWAE[DM00\Documents\01 Americas\Transportation\\$0B\$AWN Circle\Phase.]I\000_CAD\006.Road d€E\$H&ED\60W29.Contract\D160W29-SHT-D1|Detail-14.dgr

REVISED


REVISED

STATE OF ILLINOIS **DEPARTMENT OF TRANSPORTATION**

DISTRICT 1 STANDAR	D DETAILS		F.A.I. RTE.	SECTION	COUNTY	TOTAL SHEETS	SHEET NO.
BE-902		2013-011R	COOK	356	322		
DL-302				BE-902	CONTRACT	NO. 60	W29
SHEET NO. 14 OF 22 SHEETS	STA.	TO STA.	EED D	OAD DIST NO 1 THE INDIS EED A	IN PROJECT		

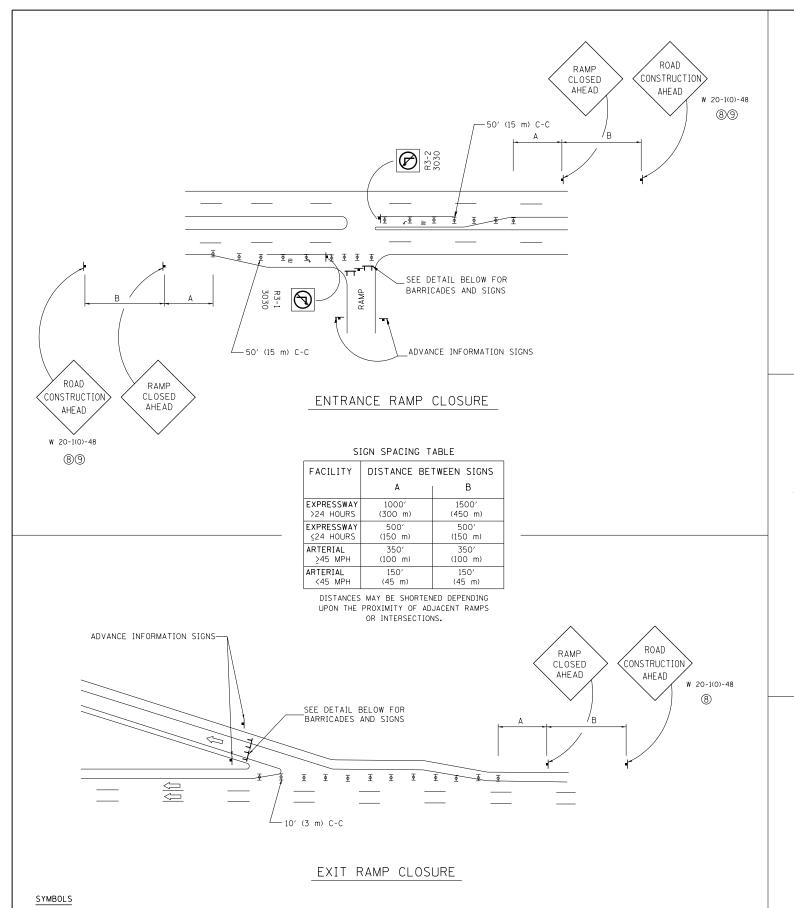


TYPE II BARRICADE, DRUM OR VERTICAL BARRICADE WITH STEADY BURN MONO-DIRECTIONAL LIGHT TYPE III BARRICADE WITH FLASHING LIGHT

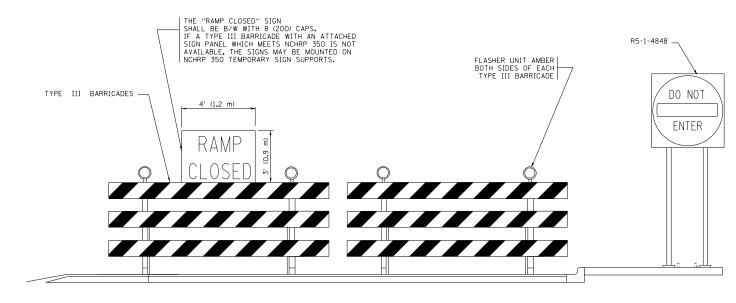

DETAIL FOR REQUIRED BARRICADES & SIGNS


RAMP CLOSURE ADVANCE WARNING SIGN

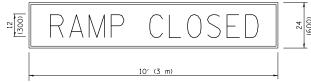

BLACK LEGEND ON ORANGE REFLECTORIZED BACKGROUND 1 (25) BORDER

THESE SIGNS ARE REQUIRED ON ALL THE EXIT GUIDE SIGNS FOR THE CLOSED EXIT RAMPS.

RAMP CLOSURE ADVANCE INFORMATION SIGN

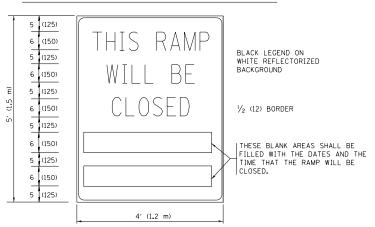

THESE SIGNS ARE REQUIRED ON BOTH SIDES OF THE RAMP, MINIMUM OF 1 WEEK IN ADVANCE OF THE CLOSURE.

GENERAL NOTES:

- (1) CONES MAY BE SUBSTITUTED FOR DRUMS OR TYPE II BARRICADES DURING DAY OPERATIONS, CONES SHALL BE
- 2 STEADY BURN LIGHTS WILL NOT BE REQUIRED FOR DAY OPERATIONS.
- 3 A FLAGGER SHALL BE POSITIONED AT EACH CLOSED RAMP THAT IS OPEN TO CONSTRUCTION VEHICLES.
- 4 ALL ROUTE MARKERS AND TRAILBLAZER ASSEMBLIES WHICH DIRECT MOTORISTS TO A CLOSED ENTRANCE RAMP SHALL BE COVERED.
- (5) THE SIGNING AND BARRICADING WHICH IS REQUIRED BY THIS DETAIL SHALL BE INCLUDED IN THE COST OF TRAFFIC CONTROL AND PROTECTION (EXPRESSWAYS).

- (6) AUTHORIZATION FROM THE DISTRICT'S BUREAU OF TRAFFIC IS REQUIRED FOR ALL RAMP CLOSURES.
- THE RAMP CLOSURE ADVANCE INFORMATION SIGNS SHALL BE ERECTED IF THE CLOSURE TIME EXCEEDS TWENTY- FOUR 24 HOURS, ADDITIONAL ADVANCE WARNING SIGNS ON EXIT GUIDE SIGNING WILL BE REQUIRED FOR EXIT RAMP CLOSURES THAT EXCEED TWENTY FOUR 24
- (8) ROAD CONSTRUCTION AHEAD SIGNS MAY BE OMITTED WHEN THIS DETAIL IS USED IN CONJUNCTION WITH OTHER TRAFFIC CONTROL THAT ALREADY INCLUDES A ROAD CONSTRUCTION AHEAD SIGN.
- (9) ARTERIAL ROAD CONSTRUCTION AHEAD SIGNS MAY BE OMITTED ON CLOSURES LESS THAN 24 HOURS IN DURATION.

ALL DIMENSIONS ARE IN INCHES (MILLIMETERS)
UNLESS OTHERWISE SHOWN.

FILE NAME =	USER NAME = BAWitort	DESIGNED - DWS	REVISED - DWS/JAF 12-02		DISTRICT 1 STANDARD DETAILS	F.A	SECTION	COUNTY	TOTAL SI	HEET NO.
pw:\\388039-pwintlaecomonline.local:PWAE	OM00\Documents\01 Americas\Transportation\	60087498 Circle\Phase_II\000_CAD\006_Road	#BE\$H&EB\60w29_CdAF+302√060w29-SHT-DI	3 011112 01 122111010	TO 00	•	2013-011R	COOK	356 3	323
	PLOT SCALE = 100.000 '/ in.	CHECKED -	REVISED - SPB 01-07	DEPARTMENT OF TRANSPORTATION	10-08		TC-08	CONTRACT	NO. 60W	N29
	PLOT DATE = 10/28/2013	DATE - 02-83	REVISED - SPB 12-09		SCALE: NONE SHEET NO. 15 OF 22 SHEETS STA. TO STA.	FED. RC	DAD DIST. NO. 1 JULINOIS FED.	AID PROJECT		

• 90/94/290

SINGLE LANE WEAVE MULTI-LANE WEAVE GENERAL NOTES 84-94-IW ① EXISTING CONFLICTING PAVEMENT MARKING LINES SHALL BE REMOVED. PAVEMENT MARKING REMOVAL SHALL NOT BE REQUIRED FOR SINGLE LANE WEAVES UNDER 24 HOURS IN DURATION. VERTICAL PANELS OR BARRICADES @ 200'(60 m)ON TANGENT 67 @ 100' (30 m) ON CURVE ② CONTINOUS REFLECTIVE TEMPORARY PAVEMENT MARKING TAPE SHALL BE PLACED THROUGHOUT THE TAPER AND FOR 300' (90 m) ALONG SIDE THE WORK AREA WHERE THE CLOSURE TIME IS GREATER THAN FOURTEEN DAYS. THE LEFT EDGE LINE SHALL BE YELLOW AND THE RIGHT EDGE LINE SHALL BE WHITE. FOR MULTI-LANE WEAVES LANE LINES SHALL BE 5 INCH, 10'-30' (3 m-9 m) SKIP DASH, WHITE. ③ PLASTIC DRUMS WITH STEADY BURN LIGHTS AT 50' (15 m) C-C SPACING IN TAPERS AND WI-6R0-6030 100' (30 m) C-C SPACING IN TANGENTS. ABOVE TYPE II BARRICADE (4) ALL SIGNS SHALL BE POST MOUNTED IF THE CLOSURE TIME EXCEEDS FOUR DAYS. \rightarrow (5) IF A TYPE III BARRICADE WITH AN ATTACHED SIGN PANEL WHICH MEETS NCHRP 350 IS WI-6R0-6030 NOT AVAILABLE, THE SIGNS MAY BE MOUNTED ON NCHRP 350 TEMPORARY SIGN SUPPORTS. ABOVE TYPE TYPE III BARRICADES MAY BE OMMITTED FOR SINGLE-LANE WEAVES UNDER 24-HOURS IN BARRICADE DURATION. W1-6 SIGNS WILL STILL BE REQUIRED. IF THE WIDTH OF OFFSET IS LESS THAN 6' THEN THE TYPE III BARRICADE WITH ATTACHED ARROW SIGN PANEL CAN BE М ELIMINATED IN THE TAPER AREAS. (6) WHEN THE LENGTH OF THE SHIFTED SEGMENT (DISTANCE BETWEEN WEAVE POINTS) IS LESS THAN 1500', DOUBLE REVERSE CURVE SIGNS (W24-1) SHOULD BE USED INSTEAD OF THE REVERSE CURVE (W1-4) SIGNS, ARROWS ON THE 4'X8' "ALL TRAFFIC" SIGNS SHALL BE (3)1 (7) THE NUMBER OF ARROWS ON THESE SIGNS SHALL MATCH THE NUMBER OF LANES OPEN TO TRAFFIC. 4'x 8' (1.2 m x 2.4 m); 1 (25) BORDER; 10 (250) CAPITAL ALL TRAFFIC LETTERS BACKGROUND SHEETING SHALL BE THE SAME 67 SYMBOLS 1 2 DIRECTION OF TRAFFIC WI-6RO-6030 ABOVE TYPE III BARRICADE WORK AREA SIGN ON PORTABLE OR PERMANENT SUPPORT TYPE II BARRICADE OR DRUM WITH MONO-DIRECTIONAL STEADY BURNING LIGHT SIGNING, BARRICADING, & PAVEMENT MARKING W1-4R-48 ACCORDING TO FREEWAY 67 STANDARD FOR A ONE LANE CLOSURE. W24-1-48 RIGHT LANE CLOSED SIGNING & BARRICADING ACCORDING TO W1-4R-48 FRFFWAY STANDARD FOR A ONE LANE CLOSURE ALL DIMENSIONS ARE IN INCHES (MILLIMETERS) UNLESS OTHERWISE SHOWN FILE NAME = USER NAME = BAWitort DESIGNED - DWS REVISED - JAF 01-03 COUNTY DISTRICT 1 STANDARD DETAILS STATE OF ILLINOIS ow:\\388039-pwintl.aecomonline.local:PWAECOM00\Documents\01 Americas\Transportation \\$@**DGY9WN** Circle\Phase_II\@@@_CAD\@@6_RoadkdRFSM&FD\6@W29_CdAFra@\$\@**6**@W29-SHT-DI+Detail-16.dan 2013-011R COOK 356 324 PLOT SCALE = 100.000 '/ in. CHECKED REVISED SPB 01-07 **DEPARTMENT OF TRANSPORTATION** CONTRACT NO. 60W29

PLOT DATE = 10/28/2013

DATE

02-87

REVISED -


SPB 12-09

SCALE: NONE

SHEET NO. 16 OF 22 SHEETS STA.

FED. ROAD DIST. NO. 1 IL • 90/94/290

TO STA.

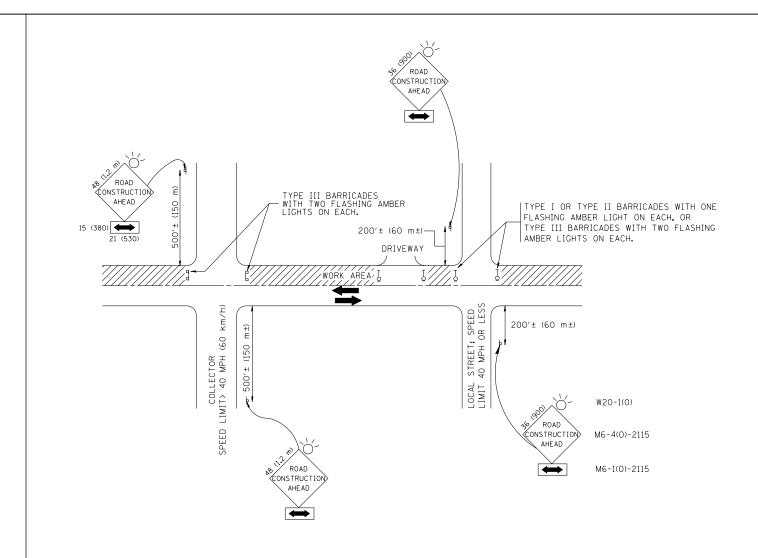

TRAFFIC CONTROL AND PROTECTION FOR SIDE ROADS, INTERSECTIONS, AND DRIVEWAYS

NOTES:

- A. FOR NO LANE RESTRICTION ON THE SIDE ROAD OR DRIVEWAYS
- 1. SIDE ROAD WITH A SPEED LIMIT OF 40 MPH (60 km/h) OR LESS AS SHOWN ON THE DRAWING AND AS DIRECTED BY THE ENGINEER:
- a) one **road construction ahead** sign 36 x 36 (900x900) With a flasher AND FLAG MOUNTED ON IT APPROXIMATELY 200' (60 m) IN ADVANCE OF THE MAIN ROUTE.
- b) THE CLOSED PORTION OF THE MAIN ROUTE SHALL BE PROTECTED BY BLOCKING WITH TYPE I, TYPE II OR TYPE III BARRICADES, 1/3 OF THE CROSS SECTION OF THE CLOSED PORTION.
- 2. SIDE ROAD WITH A SPEED LIMIT GREATER THAN 40 MPH (60 km/h) AS SHOWN ON THE DRAWING AND AS DIRECTED BY THE ENGINEER:
- a) ONE road construction ahead Sign 48 \times 48 (1.2 m \times 1.2 m) With A FLASHER MOUNTED ON IT APPROXIMATELY 500' (150 m) IN ADVANCE OF THE MAIN ROUTE.
- b) THE CLOSED PORTION OF THE MAIN ROUTE SHALL BE PROTECTED BY BLOCKING WITH TYPE III BARRICADES, 1/2 OF THE CROSS SECTION OF THE CLOSED PORTION.
- 3. WHEN THE SIDE ROAD LIES BETWEEN THE BEGINNING OF THE MAINLINE SIGNING AND THE WORK ZONE, A SINGLE HEADED ARROW (MG-1) SHALL BE USED IN LIEU OF THE DOUBLE HEADED ARROW (MG-4).

SCALE: NONE

- B. FOR A LANE CLOSURE ON A SIDE ROAD OR DRIVEWAY:
- USE APPLICABLE PORTIONS OF THE TYPICAL APPLICATION OF TRAFFIC CONTROL DEVICES (STD. 701501, STD. 701606 OR THE APPROPRIATE STANDARD). THE SPACING OF SIGNS AND BARRICADES SHALL BE ADJUSTED FOR FIELD CONDITIONS AS DIRECTED BY THE ENGINEER. THE DIRECTIONAL ARROW SHALL BE COVERED OR REMOVED WHEN NO LONGER CONSISTENT WITH THE SIDE ROAD LANE CLOSURE.
- C. ADVANCE WARNING SIGNS ARE TO BE OMITTED ON DRIVEWAY UNLESS OTHERWISE NOTED.
- D. THE TRAFFIC CONTROL AND PROTECTION FOR SIDE ROADS, INTERSECTIONS, AND DRIVEWAYS SHALL BE INCIDENTAL TO THE COST OF SPECIFIED TRAFFIC CONTROL STANDARDS OR ITEMS.

All dimensions are in millimeters (inches) unless otherwise shown.

COUNTY


356 325

CONTRACT NO. 60W29

FILE NAME =	USER NAME = BAWitort	DESIGNED - LHA	REVISED - J. OBERLE 10-18-95
pw:\\388039-pwintl.aecomonline.local:PWAE0	OM00\Documents\01 Americas\Transportation\6	0 067ANN Circle\Phase_II\000_CAD\006_Road	и - BE\$H&EB\60W29.£orн00ыSEB160Y2065+Y601 Detail-17.dgn
	PLOT SCALE = 100.000 '/ in.	CHECKED -	REVISED - A. HOUSEH 10-15-96
	PLOT DATE = 10/28/2013	DATE - 06-89	REVISED -T. RAMMACHER 01-06-00


STATE OF ILLINOIS **DEPARTMENT OF TRANSPORTATION**


	DISTRICT 1 STANDARD DETAILS TC-10					SECTION	COUNTY		
						• 2013-011R			
						TC-10	CONTRA		
	SHEET NO. 17 OF 22	SHEETS	STA.	TO STA.	FED. R	OAD DIST. NO. 1 ILLINOIS FED. A	ID PROJECT		

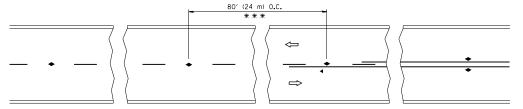


*** REDUCE TO 40' (12 m) O.C. ON CURVES WITH POSTED OR ADVISORY SPEED 45 M.P.H. (70 km/h) OR LESS.

TWO-LANE/TWO-WAY

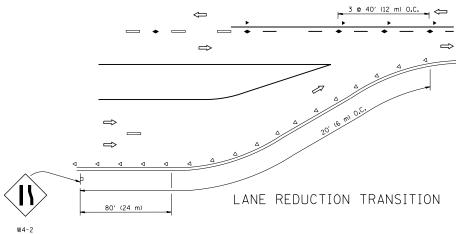


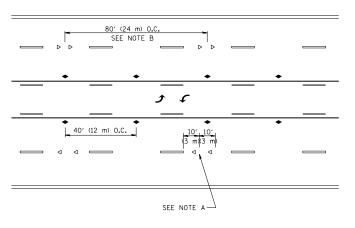

TWO-WAY LEFT TURN

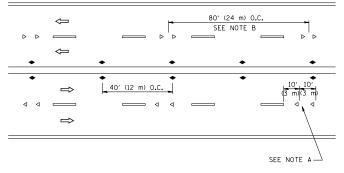

MULTI-LANE/UNDIVIDED

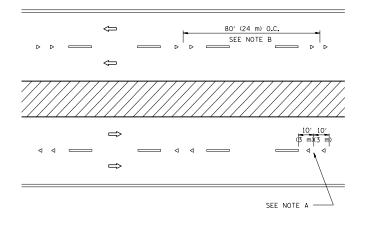

MULTI-LANE/DIVIDED

GENERAL NOTES

- MARKERS USED WITH DASHED LINES SHALL BE CENTERED IN THE GAP BETWEEN SEGMENTS.
- 2. MARKERS USED ADJACENT TO SOLID LINES SHALL BE OFFSET 2 TO 3 (50 TO 75) TOWARD TRAFFIC AS SHOWN.
- 3. MARKERS THROUGH TANGENTS LESS THAN 500' (150 m) IN LENGTH BETWEEN CURVES SHALL BE INSTALLED AT THE LESSER OF THE TWO CURVE SPACINGS.

LANE MARKER NOTES

A. USE DOUBLE LANE LINE MARKERS SPACED AS SHOWN.

B. REDUCE TO 40' (12 m) O.C. ON CURVES WHERE ADVISORY SPEEDS ARE 10 M.P.H (20 km/h) LOWER THAN POSTED SPEEDS.

SYMBOLS

---- YELLOW STRIPE

WHITE STRIPE

- ONE-WAY AMBER MARKER
- ONE-WAY CRYSTAL MARKER (₩/O)
- ◆ TWO-WAY AMBER MARKER

DESIGN NOTES


- 1. DOUBLE LANE LINE MARKERS SHALL BE USED UNLESS SPECIFIED OTHERWISE.
- 2. EXCEPT AS SHOWN ON THE LANE REDUCTION TRANSITION AND FREEWAY EXIT
 RAMP DETAIL, MARKERS ARE NOT TO BE SPECIFIED ON RIGHT EDGE LINES.
- 3. THE EXACT MARKER LIMITS, SPACING, AND COLOR SHALL BE INCLUDED IN THE PLANS WHEN STANDARD SPECIFICATIONS ARE NOT BEING USED.
- 4. MARKERS SHOULD NOT BE USED ALONGSIDE CURBS EXCEPT FOR EXTREMELY SHORT SECTIONS OF CURBS WHERE NOT MORE THAN TWO MARKERS WOULD BE


LEFT TURN


All dimensions are in inches (millimeters) unless otherwise shown.

FILE NAME = USER NAME = BAWitort DESIGNED -REVISED - T. RAMMACHER 09-19-94 SECTION COUNTY DISTRICT 1 STANDARD DETAILS STATE OF ILLINOIS pw:\\388039-pwintl.aecomonline.local:PWAE\$0M00\Documents\01 Americas\Transportation\\$0069988 Circle\Phase.II\000.CAD\006_Road 由近外任任的人60079.QRAMMACY服务的吸引-\$8年99 Detail-18.dgn СООК 2013-011R 356 326 PLOT SCALE = 100.000 '/ in. CHECKED REVISED -T. RAMMACHER 01-06-00 **DEPARTMENT OF TRANSPORTATION** CONTRACT NO. 60W29 TC-11 SCALE: NONE SHEET NO. 18 OF 22 SHEETS STA. TO STA. PLOT DATE = 10/28/2013 DATE REVISED - C. JUCIUS 09-09-09 FED. ROAD DIST. NO. 1 ILLINO

• 90/94/290

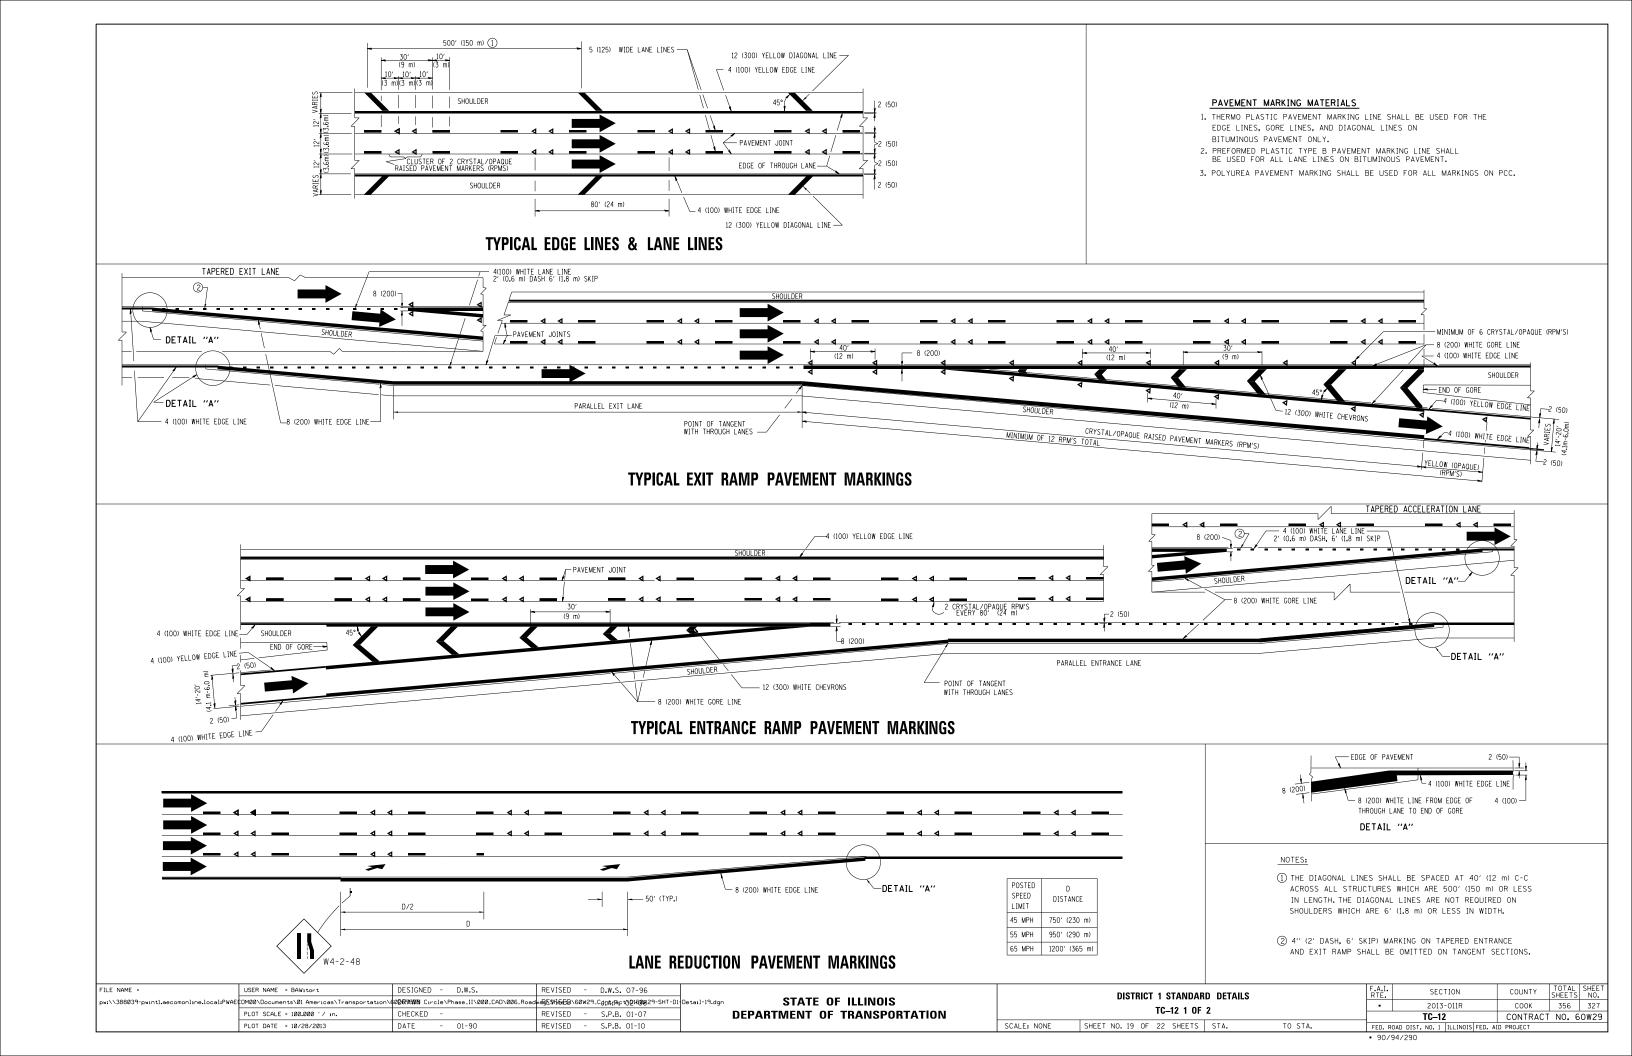


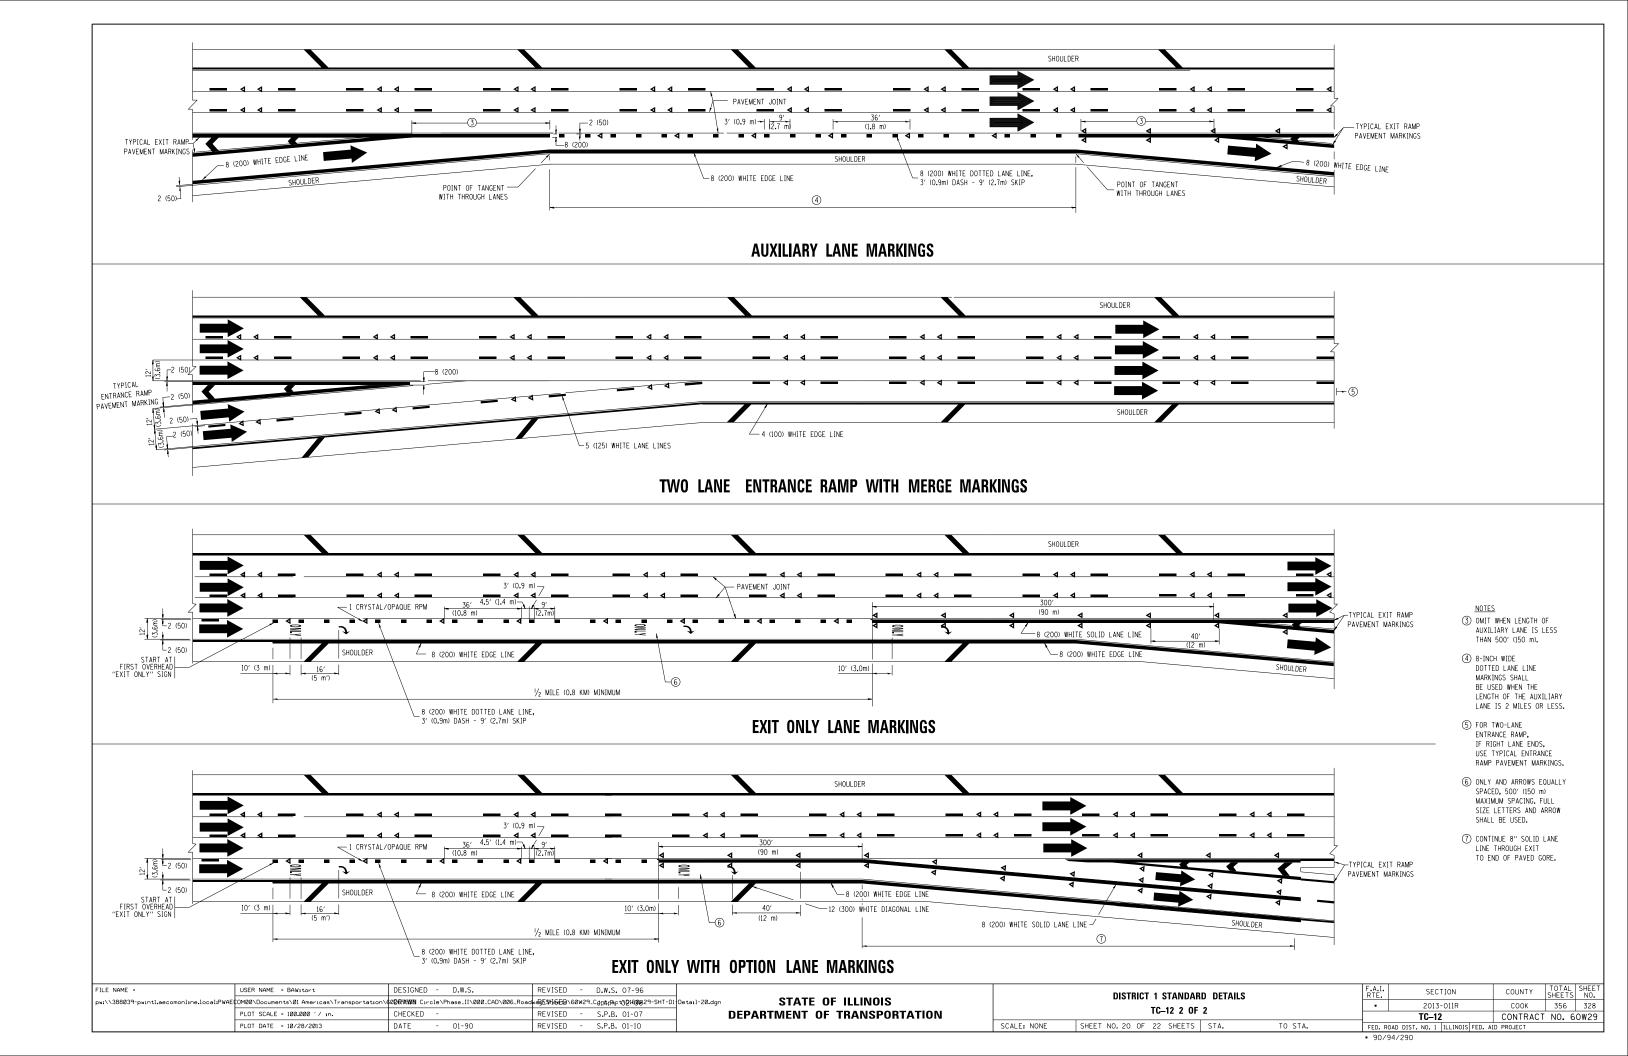


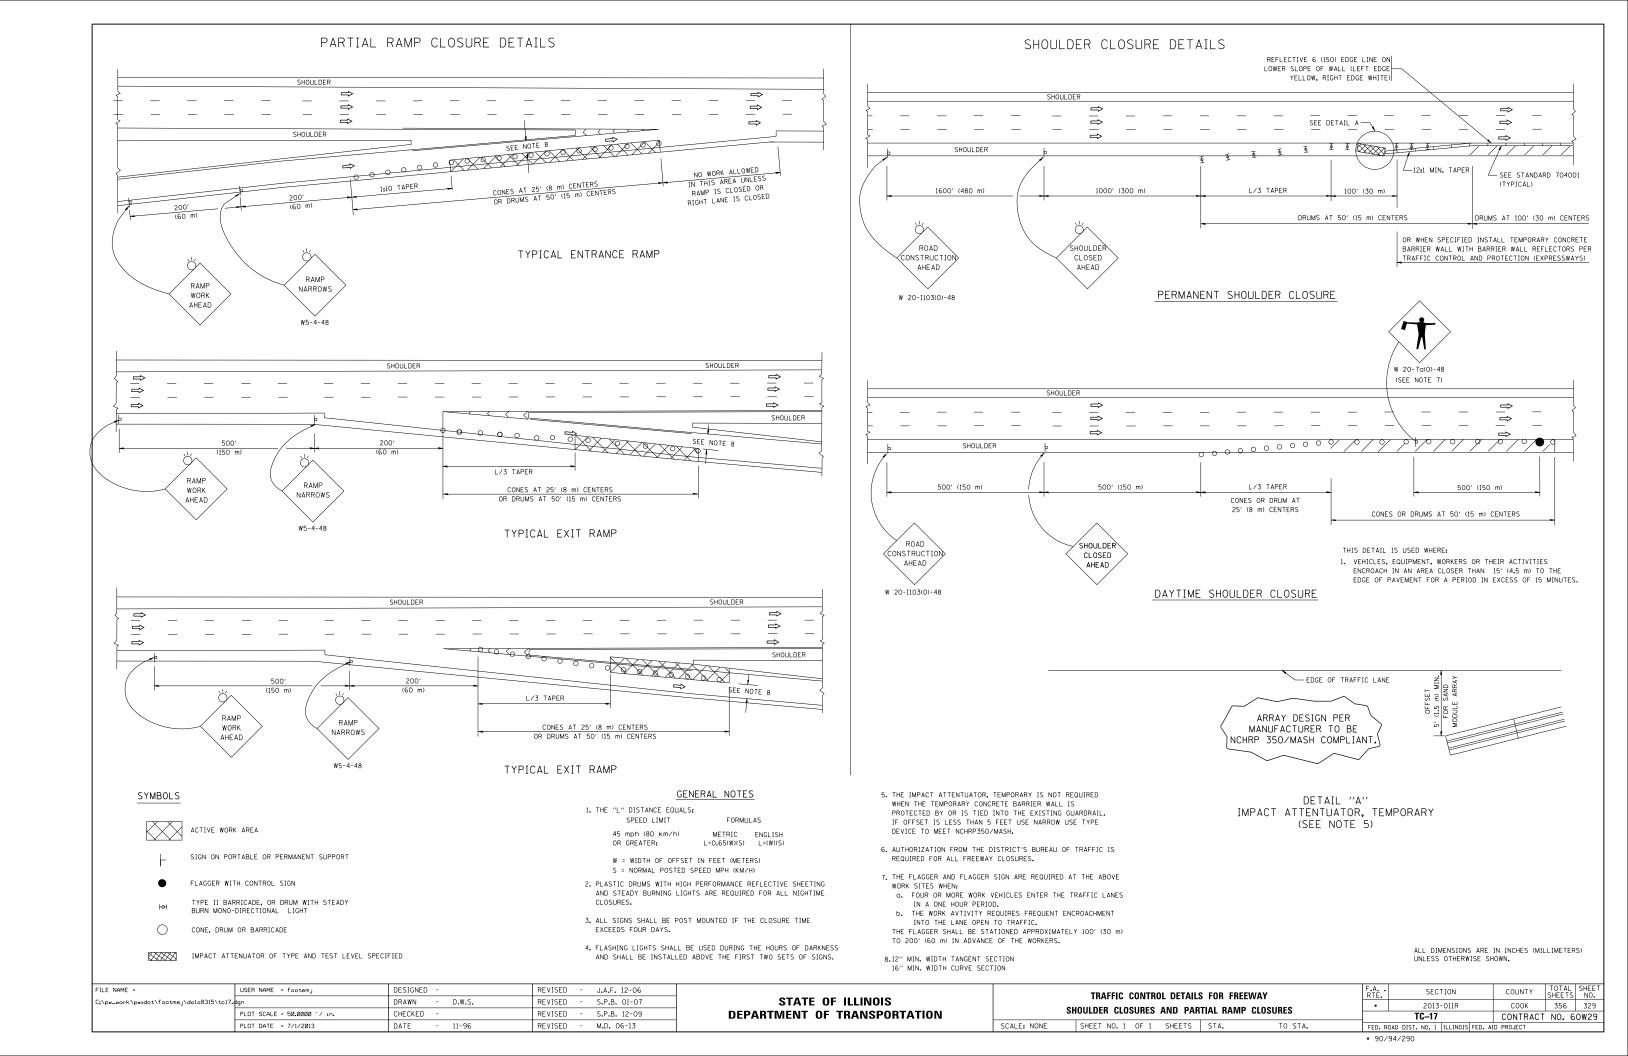

SIGNING FOR FLAGGING OPERATIONS AT WORK ZONE OPENINGS

WORK ZONE EXIT OPENING

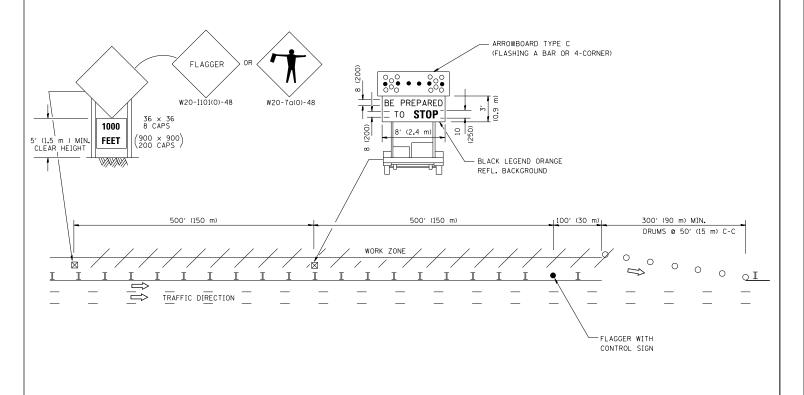

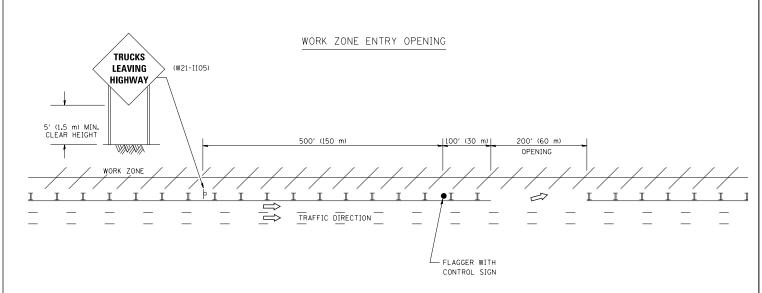


NOTES:

- 1. THE ARROWBOARD, THE FLAGGER AHEAD SIGN AND THE TRUCKS LEAVING HIGHWAY SIGN SHALL BE REMOVED OR TURNED AWAY FROM TRAFFIC AND THE EXIT AND ENTRY OPENINGS SHALL BE CLOSED WHEN THE FLAGGING OPERATION CEASES. NON OPERATING EQUIPMENT SHALL COMPLY WITH ARTICLE 701.11
- 2. WORK ZONE EXIT OPENINGS SHOULD BE A MINIMUM OF ONE HALF MILE APART.
- 3. EXITING THE WORK ZONE AT ANY PLACE OTHER THAN AT A WORK ZONE EXIT OPENING WILL BE PROHIBITED.
- 4. ALL VEHICLES SHALL ENTER THE WORK ZONE AT ENTRY OPENINGS, USING THEIR TURN SIGNALS TO WARN MOTORISTS

ALL DIMENSIONS ARE IN INCHES (MILLIMETERS)
UNLESS OTHERWISE SHOWN

FILE NAME =	USER NAME = BAWitort	DESIGNED -	REVISED -	J.A.F. 04-03				DISTRICT 1 STANDARD DETAILS	RTE.	SECTION	COUNTY	SHEETS NO.
pw:\\388039-pwintl.aecomonline.local:PWAE	OM00\Documents\01 Americas\Transportation\6	0 069A%N Circle\Phase_II\000_CAD\006_Road	₼ ₩ Б ₩ Б ₩ Б	9_CdrArFac t0@16@629-SHT-D1-	Detail-22.dgn	97 STATE OF ILLINOIS		TO 40		2013-011R	соок	356 330
	PLOT SCALE = 100.000 ' / in.	CHECKED -	REVISED -	S.P.B. 01-07		DEPARTMENT OF TRANSPORTATION	IC-18			TC-18	CONTRACT	NO. 60W29
	PLOT DATE = 10/28/2013	DATE -	REVISED -	S.P.B. 12-09			SCALE: NONE	SHEET NO. 22 OF 22 SHEETS STA. TO STA.	FED. ROAD		D PROJECT	

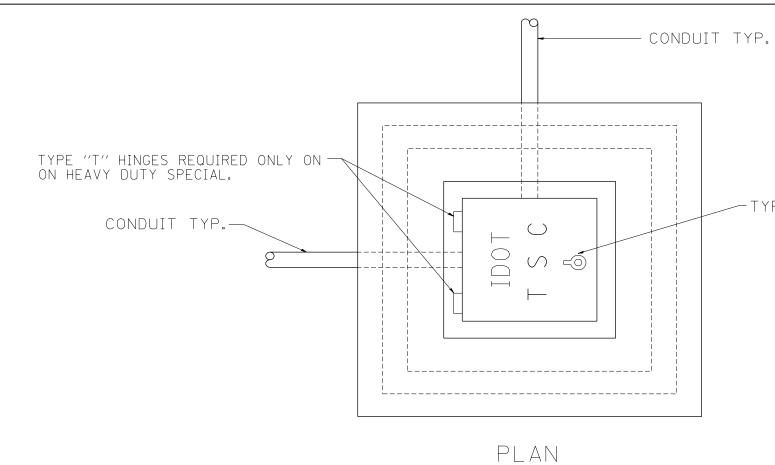

TYPE "G" HANDLE FOR BOTH HDHH AND HDHH SPECIAL

HEAVY DUTY HANDHOLE MINIMUM DIMENSIONS (UNHINGED)


A	28'' (711 mm)
В	22'' (559 mm)
C	8'' (200 mm)

(FRAME AND COVER 260 LBS. (118 Kg.) MIN.)

HEAVY DUTY HANDHOLE SPECIAL MINIMUM DIMENSIONS

А	31.5′′ (800 mm)
В	30.0" (762 mm)
С	10.0′′ (250 mm)

(FRAME AND COVER 405 LBS. (184 Kg. (405))

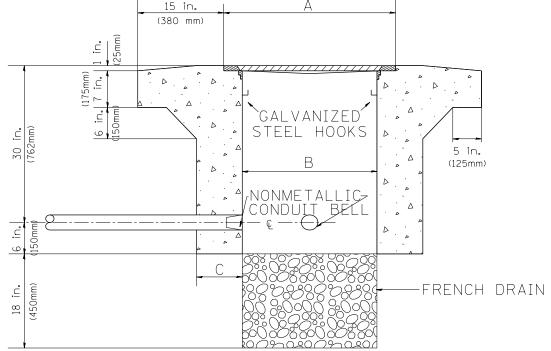

ELEVATION


PC CONCRETE - HEAVY DUTY HAND HOLE

STATE OF ILLINOIS
DEPARTMENT OF TRANSPORTATION
TRAFFIC SYSTEMS CENTER


IDOT TRAFFIC SYSTEMS CENTER STANDARD DRAWINGS

TY-1TSC-400#15

SCALE: NO SCALE SHEET 1 OF 1 SHEETS STA. TO STA.

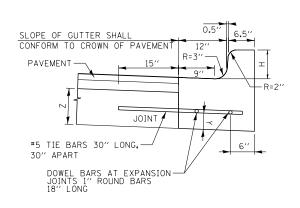

COMBINATION CURB AND GUTTER
TYPE B V.12 (CDOT)

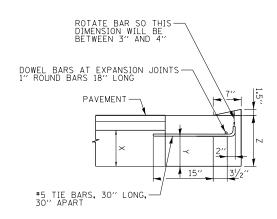

DOWEL BARS AT EXPANSION JOINTS I" ROUND BARS I" ROUND BARS IS OTHIS DIMENSION WILL BE BETWEEN 3" AND 4"

*5 TIE BARS, 30" LONG, 31/2"

DEPRESSED CURB

BARRIER CURB

CONCRETE CURB, TYPE B (SPECIAL) (CDOT)

DETAILS OF CONCRETE CURB, TYPE B (SPECIAL) (CDOT) AND COMBINATION CURB AND GUTTER TYPE B V.12 (CDOT)

NOTE

- H = VARIABLE, MINIMUM 3" AND NOT TO EXCEED 9" (SEE PLANS)
- X = THICKNESS OF PAVEMENT
- Y = ONE HALF THE THICKNESS OF CONCRETE PAVEMENT OR CONCRETE BASE
- Z = 10" OR THICKNESS OF PAVEMENT WHICHEVER IS GREATER

DEPRESSED CURB & GUTTER

DEPRESSED CURB AND GUTTER AND TRANSITIONS BETWEEN BARRIER CURB WILL BE PAID FOR UNDER THE ADJACENT CURB ITEM. DEPRESSED CURB AND MOUNTABLE GUTTER MUST MEET

JOINTS IN CURB, COMBINED CURB AND GUTTER

TRANSVERSE JOINTS OF A TYPE SIMILAR TO THAT USED IN THE ADJACENT PAVEMENT SHALL BE INSTALLED IN THE CURB, GUTTER AND COMBINED CURB & GUTTER IN PROLONGATION WITH THE JOINTS IN THE PAVEMENT. THE DETAILS OF THE TRANSVERSE JOINTS IN THE CURB, GUTTER AND COMBINED CURB & GUTTER SHALL BE APPROVED BY THE ENGINEER. CURB, GUTTER OR COMBINED CURB AND GUTTER IS CONSTRUCTED ADJACENT TO A FLEXIBLE BASE PAVEMENT, 1" THICK EXPANSION JOINTS COMPOSED OF BITUMINOUS PREFORMED JOINT FILLER SHALL BE INSTALLED IN THE CURB AND/OR GUTTER AT POINTS OF CURVATURE AND AT CONSTRUCTION JOINTS. CONTRACTION JOINTS SHALL ALSO BE PLACED BETWEEN THESE EXPANSION JOINTS AT DISTANCES NOT EXCEEDING 20 FEET. ALL TIE BARS SHALL BE DEFORMED - ALL DOWEL BARS SHALL BE SMOOTH. ALL TIE BARS AND DOWEL BARS TO BE EPOXY COATED.

JOINTS IN CURB, COMBINED CURB AND GUTTER


THE COST OF ALL JOINTS, INCLUDING LABOR, FURNISH AND PLACING OF STEEL, JOINT FILLER, SEALANT, AND ALL OTHER INCIDENTALS SHALL BE INCLUDED IN THE UNIT PRICE BID FOR CONCRETE CURB, TYPE B (SPECIAL) (CDOT), AND COMBINATION CURB AND GUTTER TYPE B V.12 (CDOT) ITEMS. SAWCUTTING AND FURNISHING AND INSTALLING CURB ANCHORS, DOWELS, AND TIE BARS SHALL ALSO BE INCIDENTAL TO THESE ITEMS.

Tran Systems


D160W29-sht-Detail-01.dgn	DESIGNED - JLV	REVISED -
USER NAME = BAWitort	DRAWN - YSK	REVISED -
PLOT SCALE = 20.0000 '/ in.	CHECKED - JMG	REVISED -
PLOT DATE = 10/28/2013	DATE - 10/30/2013	REVISED -

STATE OF ILLINOIS
DEPARTMENT OF TRANSPORTATION

				WAY DET			F.A.I. RTE.	S	ECTION		COUNTY	TOTAL SHEETS	SHEET NO.
ı	COMBINATION	CURB AND			, ,	CONCRETE CURB,	90/94/290	20	13-011R		COOK	356	332
ı			IALE R	(SPECIAL)							CONTRACT	NO. 6	0W29
ı	SCALE: NONE	SHEET 1	OF 5	SHEETS	STA.	TO STA.			ILLINOIS	FED. AII	D PROJECT		

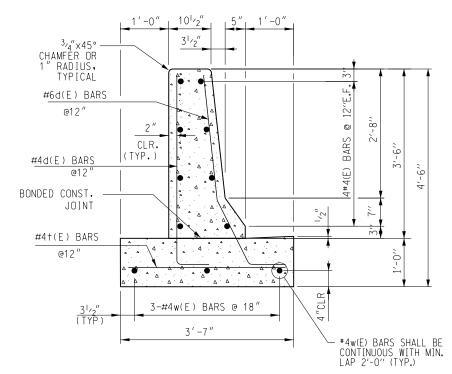


CONCRETE BARRIER WALL (SPECIAL)

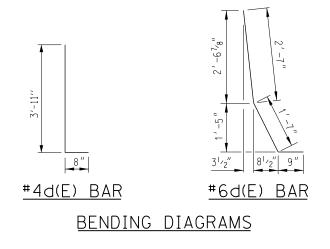

NOTES:

- 1. TOP SHOULDER EDGE OF BARRIER BASE GUTTER SHALL MATCH THE TOP OF SHOULDER ELEVATION.
- 2. 1" DEEP CONTRACTION JOINTS SHALL BE CONSTRUCTED IN BOTH THE REINFORCED CONCRETE BARRIER WALL AND BASE.
- 3. THE FORMING OF CONTRACTION JOINTS SHALL BE DONE WITH AN APPROVED FINISHING TOOL OR BY SAWING AT THE DISCRETION OF THE ENGINEER SUBJECT TO THE SATISFACTORY CONTROL OF CRACKING.
- 4. REINFORCING BARS DESIGNATED "(E)" SHALL BE EPOXY COATED.
- 5. REINFORCEMENT BENDING DETAILS SHALL BE IN ACCORDANCE WITH THE "MANUAL OF STANDARD PRACTICE FOR DETAILING REINFORCED CONCRETE STRUCTURES", ACI 315, LATEST EDITION.
- 6. REINFORCEMENT BAR BENDING DIMENSIONS ARE OUT TO OUT.
- 7. BARRIER SHALL BE USED WITH ALL NEW CONSTRUCTION, OR RECONSTRUCTION OF EXISTING BARRIERS.

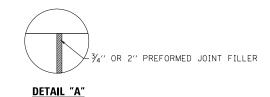


Tran Systems


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PLOT SCALE = 2.0000 '/ in.	CHECKED - JMG	REVISED -
PLOT DATE = 10/28/2013	DATE - 10/30/2013	REVISED -


STATE OF ILLINOIS
DEPARTMENT OF TRANSPORTATION


ROADWAY DETAILS CONCRETE BARRIER WALL (SPECIAL)									
SCALE: N.T.S.	SHEET 2	OF 5	SHEETS	STA.	TO STA.				


F.A.I. RTE.	SECTION	COUNTY	TOTAL SHEETS	SHEE NO.
90/94/290	2013-011R	COOK	356	333
		CONTRACT	NO. 6	0W29
	ILL INOIS FED. AT	D PROJECT		

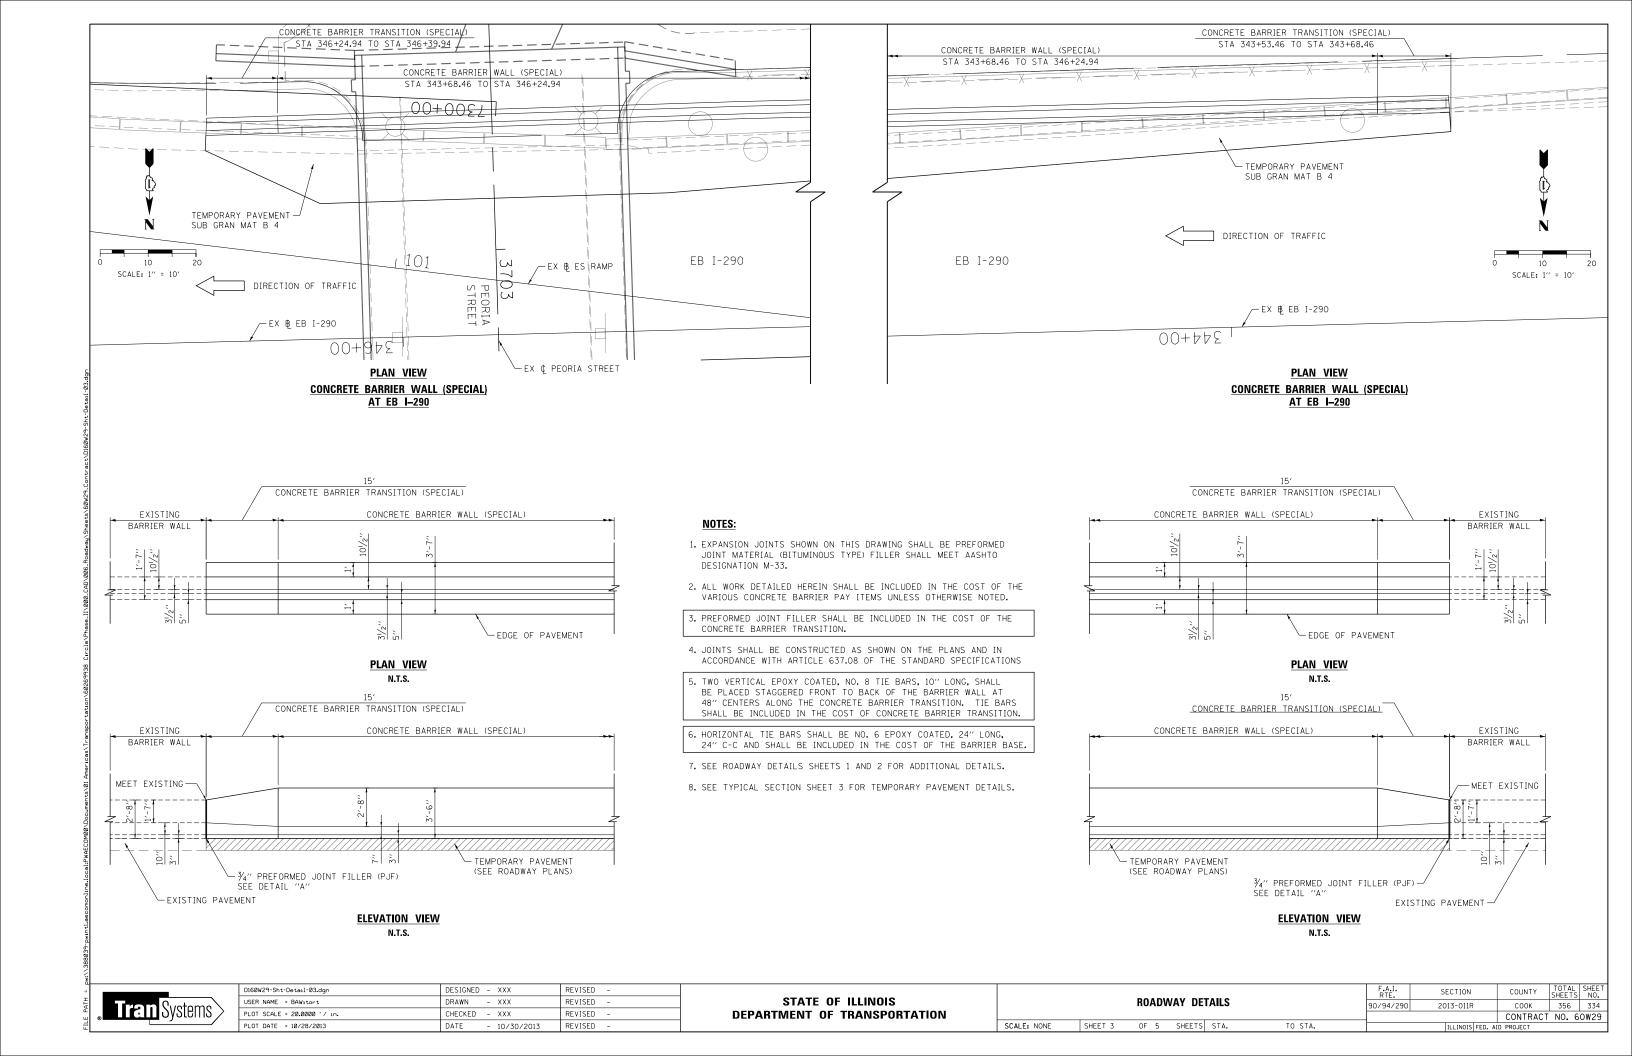

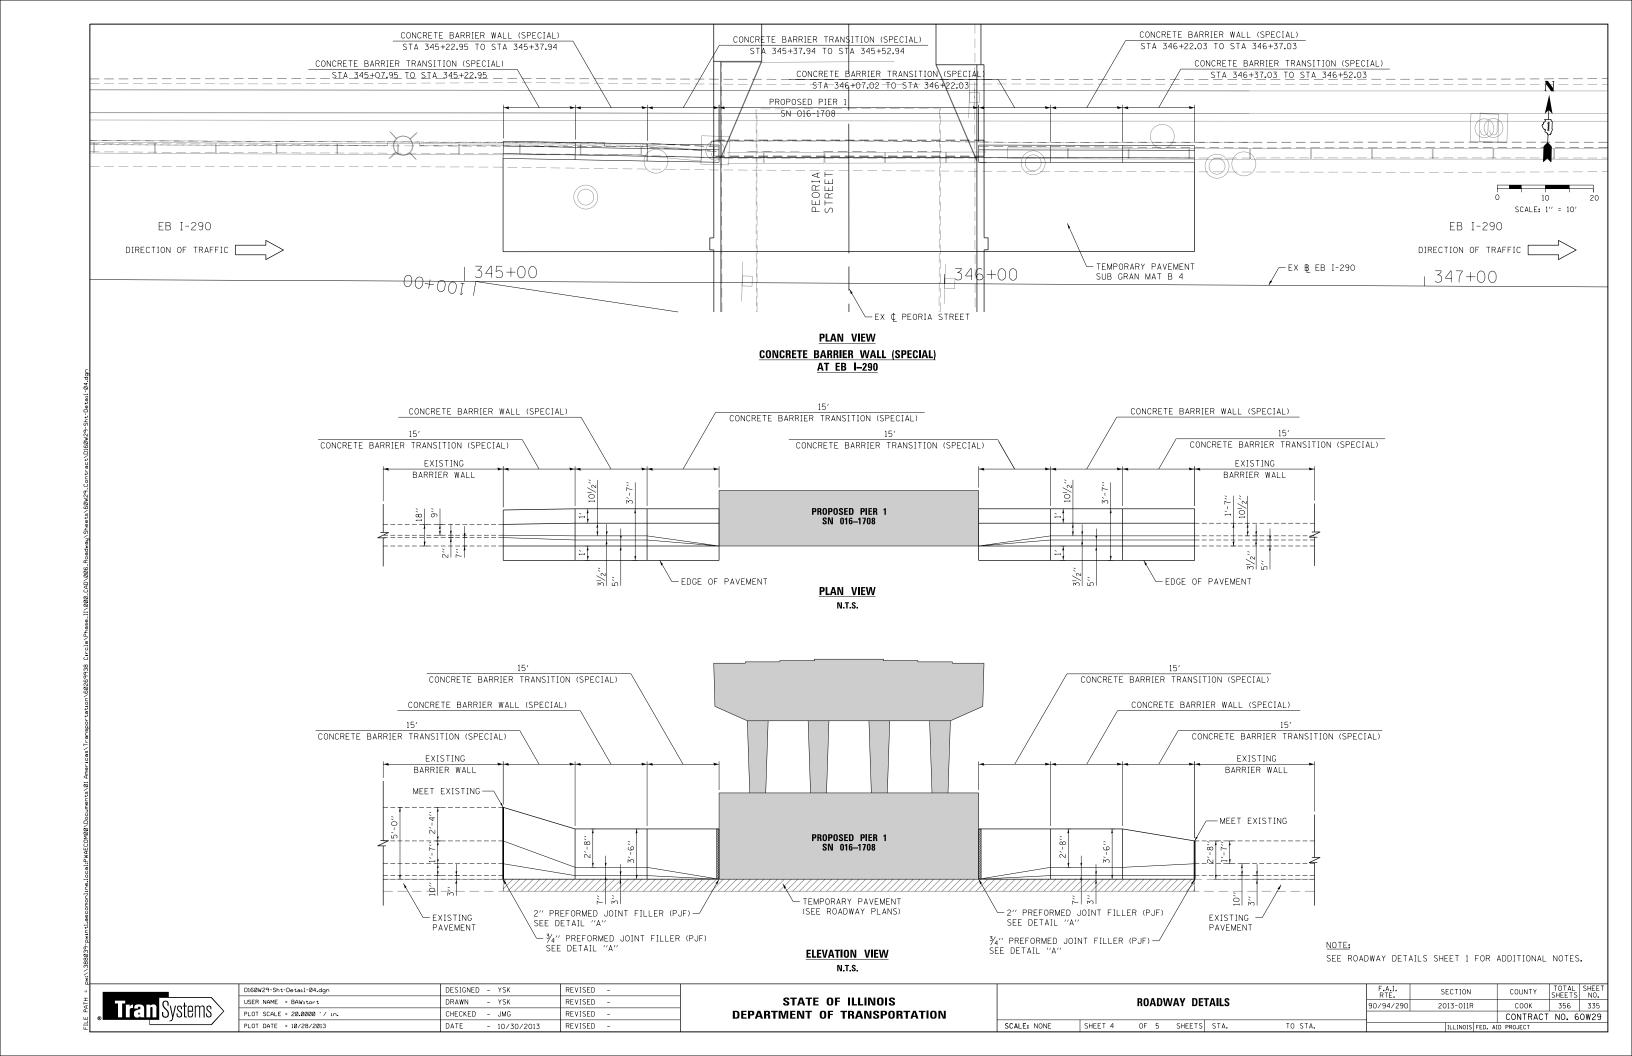

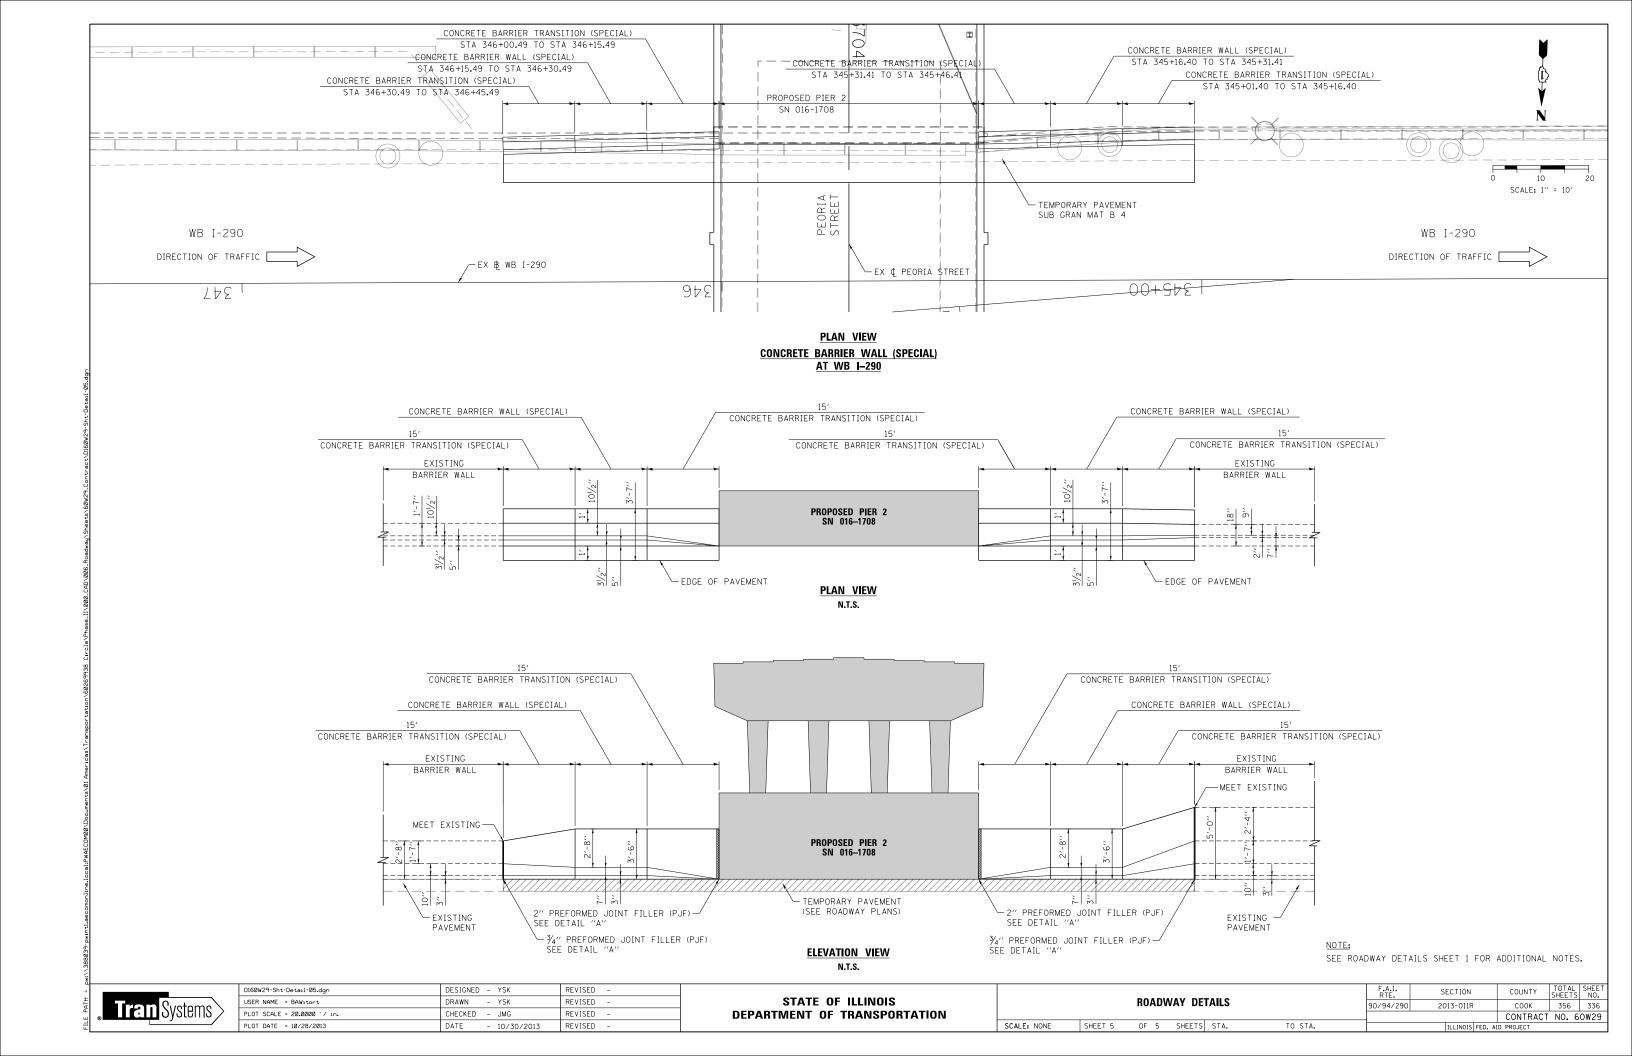

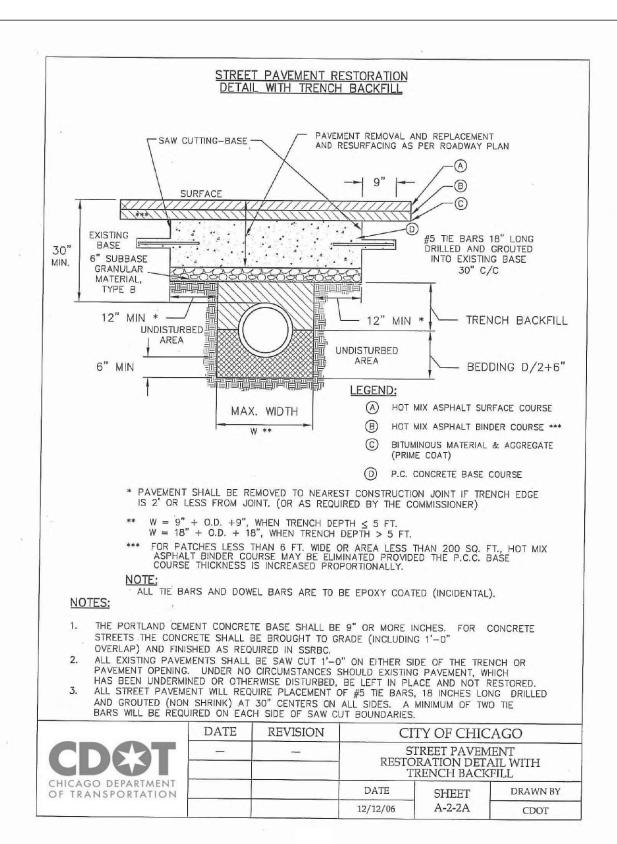


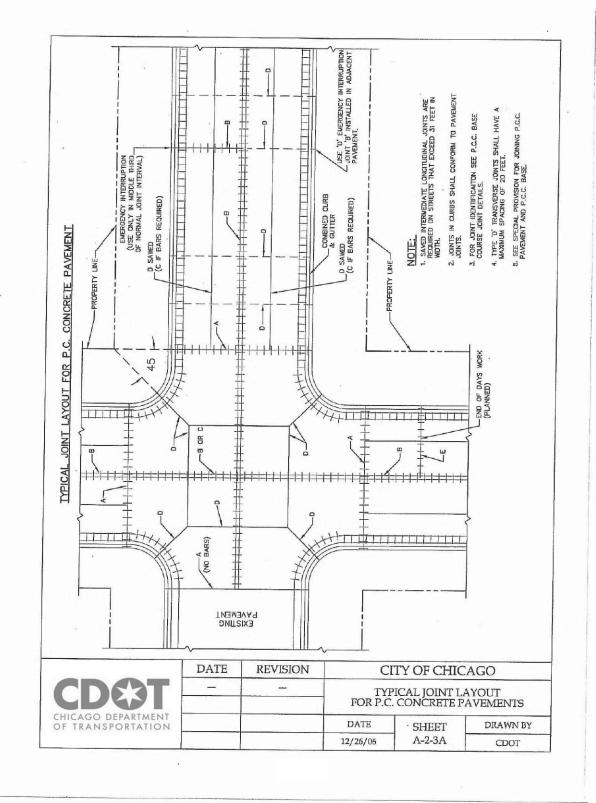

D160W29-Sht-CDOT-DETAIL-01.dgn	DESIGNED - CDOT	REVISED -
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PLOT SCALE = 2.0000 '/ in.	CHECKED - CDOT	REVISED -
PLOT DATE = 10/28/2013	DATE - 10/30/2013	REVISED -

	CHICAGO DEPARTMENT OF TRANSPORATION										
STAND	OARD CONS	TRUCTIO	N DETAILS A-2-	-2A & A–2–23A							
SCALE: NONE	SHEET 1	OF 4	SHEETS STA.	TO STA.							

F.A.I. RTE.	SECTION		COUNTY	TOTAL SHEETS	SHEET NO.
90/94/290	2013-011R		СООК	356	337
		CONTRACT	NO. 6	0W29	
	ILLINOIS	FED. A	ID PROJECT		

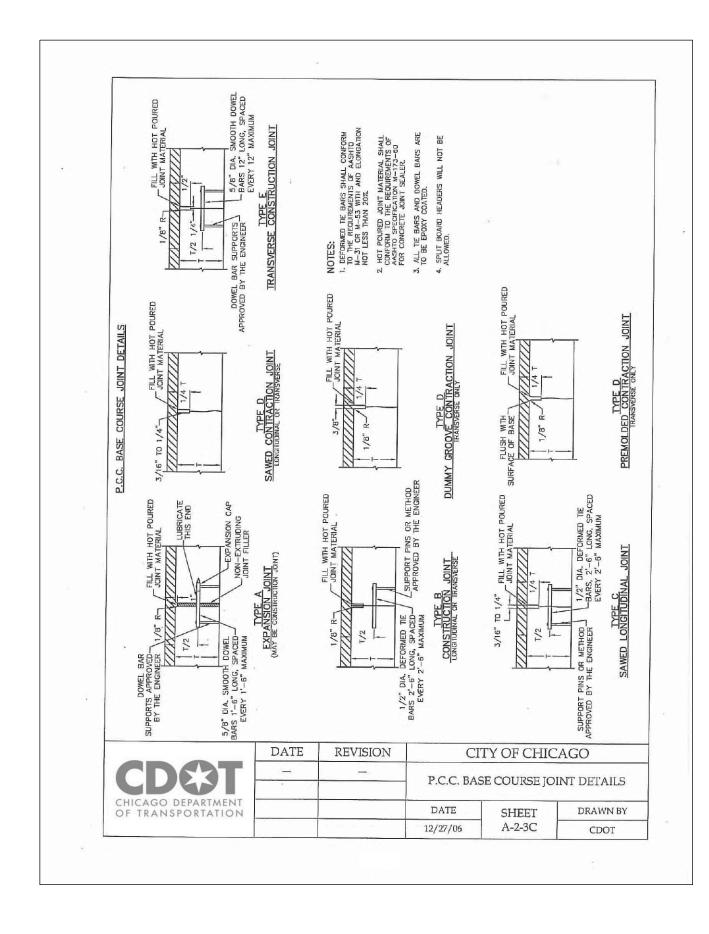

D160W29-Sht-CDOT-DETAIL-02.dgn	DESIGNED - CDOT REVISED -	
USER NAME = BAWitort	DRAWN - CDOT REVISED -	1
PLOT SCALE = 2.0000 '/ in.	CHECKED - CDOT REVISED -	1
PLOT DATE = 10/28/2013	DATE - 10/30/2013 REVISED -	

CHICAGO DEPARTMENT OF TRANSPORTATION STANDARD CONSTRUCTION DETAILS A-2-3C & A-2-12A SCALE: NONE SHEET 2 OF 4 SHEETS STA. TO STA.

F.A.I. SECTION COUNTY SHEETS NO. 90/94/290 2013-011R COOK 356 338 CONTRACT NO. 60W29 | ILLINOIS FED. AID PROJECT

DRAWN BY

CDOT

CITY OF CHICAGO
DETAILS OF STRUCTURE CASTING

ISOLATION BOX

SHEET


A-2-12A

DATE

12/21/06

DETAIL OF STRUCTURE CASTING ISOLATION BOX FOR P.C.C. PAVEMENT AND P.C.C. BASE COURSE

2-#4 DEFORMED TIE BARS 30" LONG AT A MID DEPTH (TYPICAL) SEE SPECIAL CONDITION BELOW.

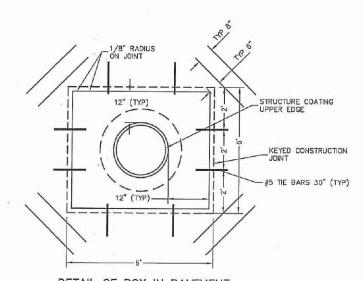

DETAIL OF BOX IN PAVEMENT

SPECIAL CONDITIONS:

DATE

CHICAGO DEPARTMENT


OF TRANSPORTATION

TIE BARS SHALL NOT BE INSTALLED AT ISOLATION BOX CORNERS WHERE EITHER SIDE OF THE BOX FORMING SAID CORNER IS A LONGITUDINAL OR TRAVERSE JOINT. MOREOVER, AT NO TIME SHALL A TIE BAR CROSS A JOINT (ALREADY FORMED OR PROPOSED) IN THE VICINITY OF THE ISOLATION BOX. IF THIS STUATION OCCURS, THE TIE BAR SHALL BE ADJUSTED PARALLEL TO THE AXIS OF THE BAR SO THAT THE END OF THE BAR IS NO CLOSER THAN 1 1/2" TO THE JOINT.

ONLY BY THE DIRECTION OR APPROVAL OF THE COMMISSIONER SHALL THE DISTANCE BETWEEN THE UPPER EXTERNAL CASTING EDGE AND THE EDGE OF STANDARD ISOLATION BOX, SHOWN AS 12", BE INCREASED SO THAT AN IMMOVABLE CONGITUDINAL JOINT AND (OR) TRAVERSE JOINT WILL THEN THENCE FORM (O) SIDE (S) OF THE BOX. THIS ADJUSTMENT WILL BE ALLOWED ONLY WHEN THE DISTANCE BETWEEN THE SIDE OF THE STANDARD ISOLATION BOX AND IMMOVABLE JOINT IS 18" OR LESS.

BACKFILL MATERIAL AROUND STRUCTURE WILL BE COMPACTED TO 95% MODIFIED PREATOR PRIOR TO THE PLACEMENT OF CONCRETE WITHIN THE ISOLATION BOX.

REVISION

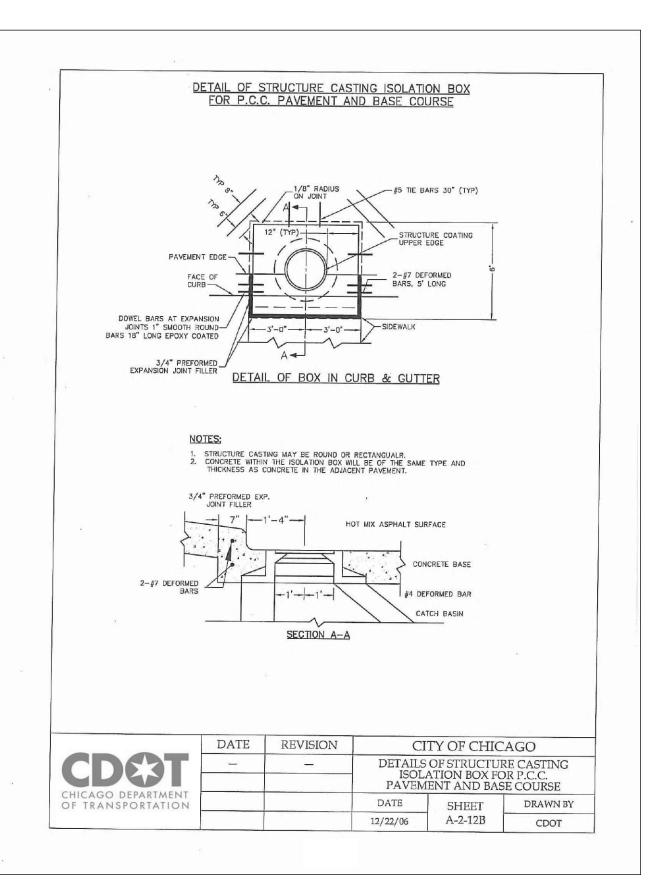


DETAILS OF PORTLAND CEMENT CONCRETE SIDEWALK CONSTRUCTION ADJACENT BUILDING, RETAINING ADJACENT BUILDING, RETAINING ADJACENT SIDEWALK ADJACENT	STRUCTURES STRUCTURES LEY OR UTILITY POLE STRAFFIC SIGNAL LIGHT STANDARD	FOR RAMP DETAILS FOR RAMP DET		SUEWALKS. SUEWAL	SECTION SECTION SESSONS REFER TO THE REPORT FILLER RE
	DATE	REVISION	CI	TY OF CHIC	CAGO
CDAT	<u> </u>	-		NCRETE SIDEV	
ADAI		1-1-2		DETAILS	
CHICAGO DEPARTMENT			T 4		
CHICAGO DEPARTMENT OF TRANSPORTATION			DATE	SHEET	DRAWN BY




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PLOT SCALE = 2.0000 '/ in.	CHECKED - CDOT REVISED -	
PLOT DATE = 10/28/2013	DATE - 10/30/2013 REVISED -	

_						PORTATION 2–12B & A–3–2
SCALE: NONE	SHEET	3	OF 4	SHEETS	STA.	TO STA.

F.A.I. RTE.	SECTIO	٧		COUNTY	TOTAL SHEETS	SHEE NO.
0/94/290	2013-011R			соок	356	339
				CONTRACT	NO. 6	0W2
	ILLINO	S FED.	AII	PROJECT		

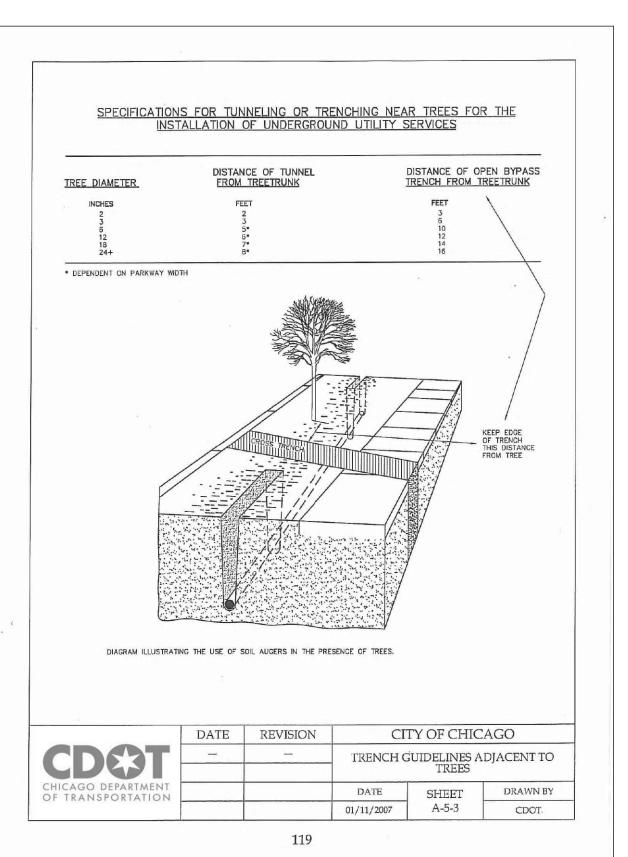

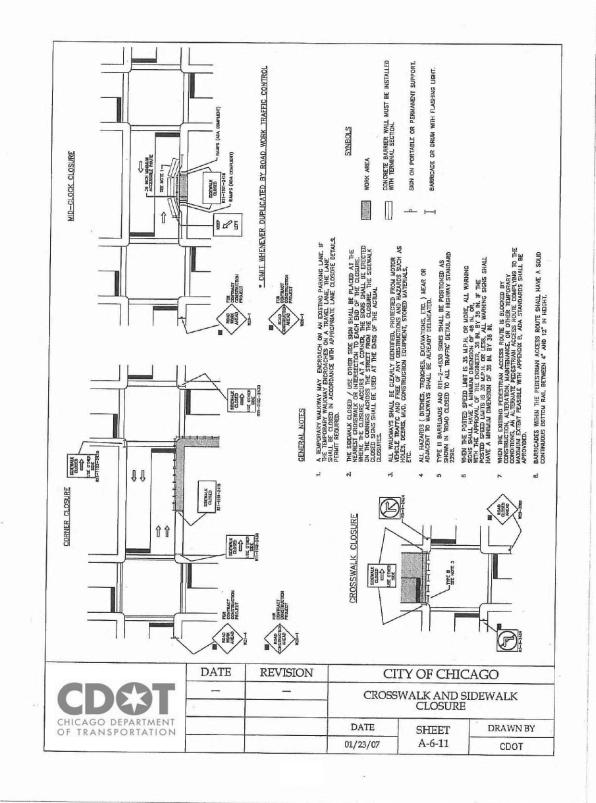




DI60W29-Sht-CDOT-DETAIL-04.dgn	DESIGNED - CDOT	REVISED -
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PLOT SCALE = 2.0000 '/ in.	CHECKED - CDOT	REVISED -
PLOT DATE = 10/28/2013	DATE - 10/30/2013	REVISED -

CHICAGO DEPARTMENT OF TRANSPORTATION										
STANDARD CONSTRUCTION DETAILS A-5-3 & A-6-11										
SCALE: NONE	SHEET	4	OF	4	SHEETS	STA.	TO STA.			

F.A.I. RTE.	SECTION			COUNTY	TOTAL SHEETS	SHEE NO
0/94/290	2013-011R			СООК	356	340
				CONTRACT	NO. 6	OW2
	ILLINOIS	FED.	AID	PROJECT		

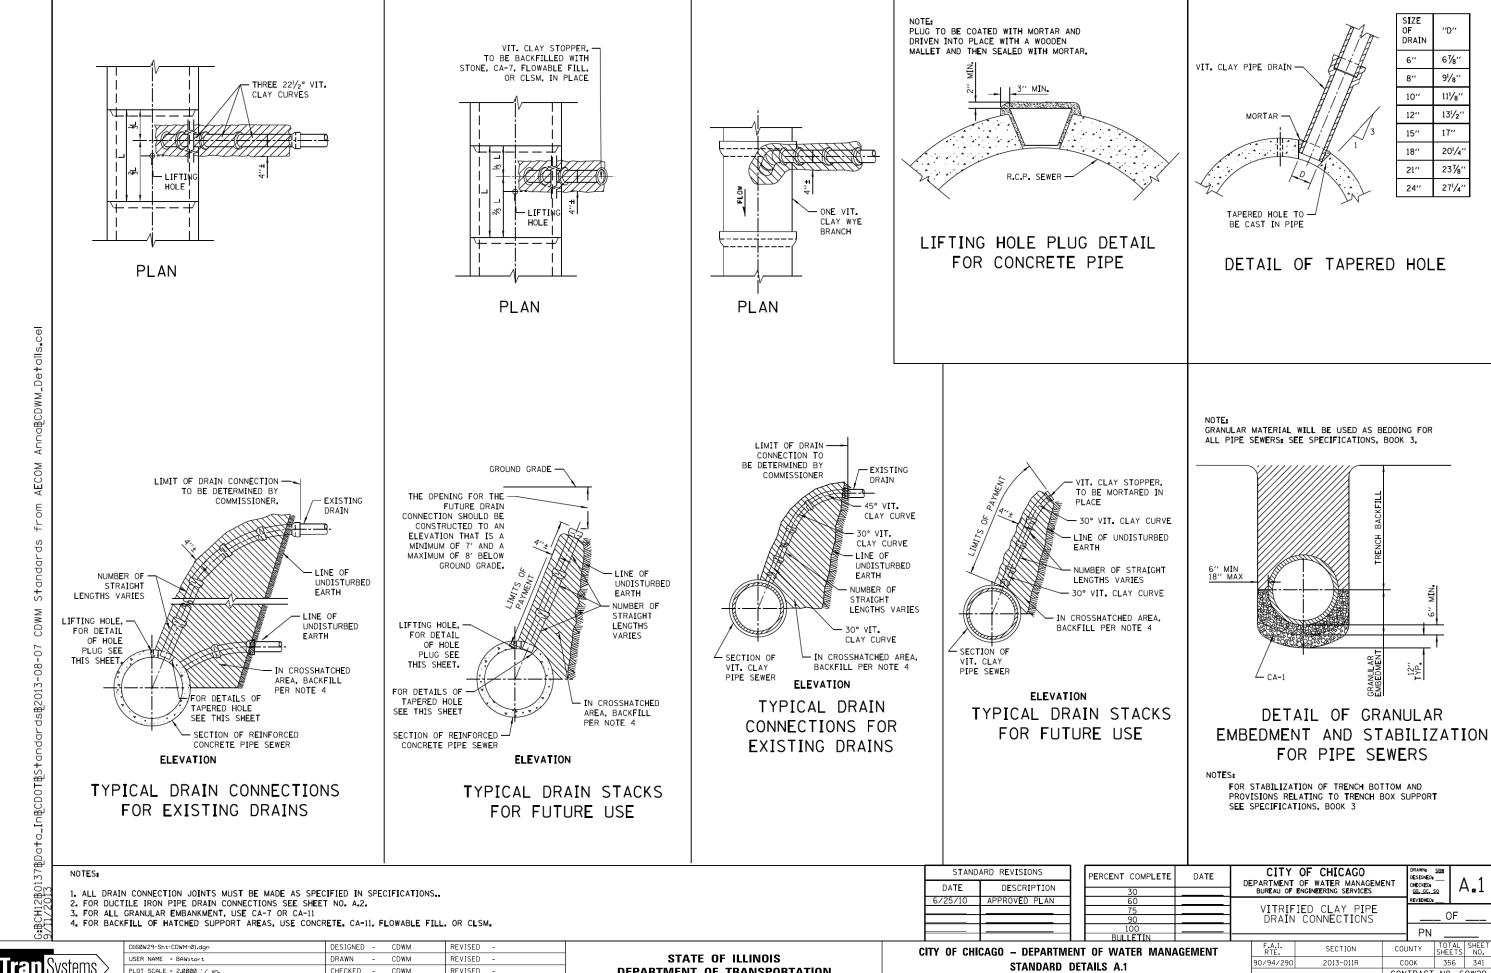

DEPARTMENT OF TRANSPORTATION

SCALE: NONE

SHEET 1 OF 6 SHEETS STA.

CONTRACT NO. 60W29

Tran Systems

LOT SCALE = 2.0000 '/ in.

PLOT DATE = 10/28/2013

CHECKED -


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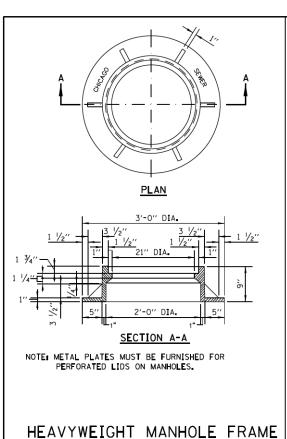
CDWM

- 10/30/2013

REVISED

REVISED



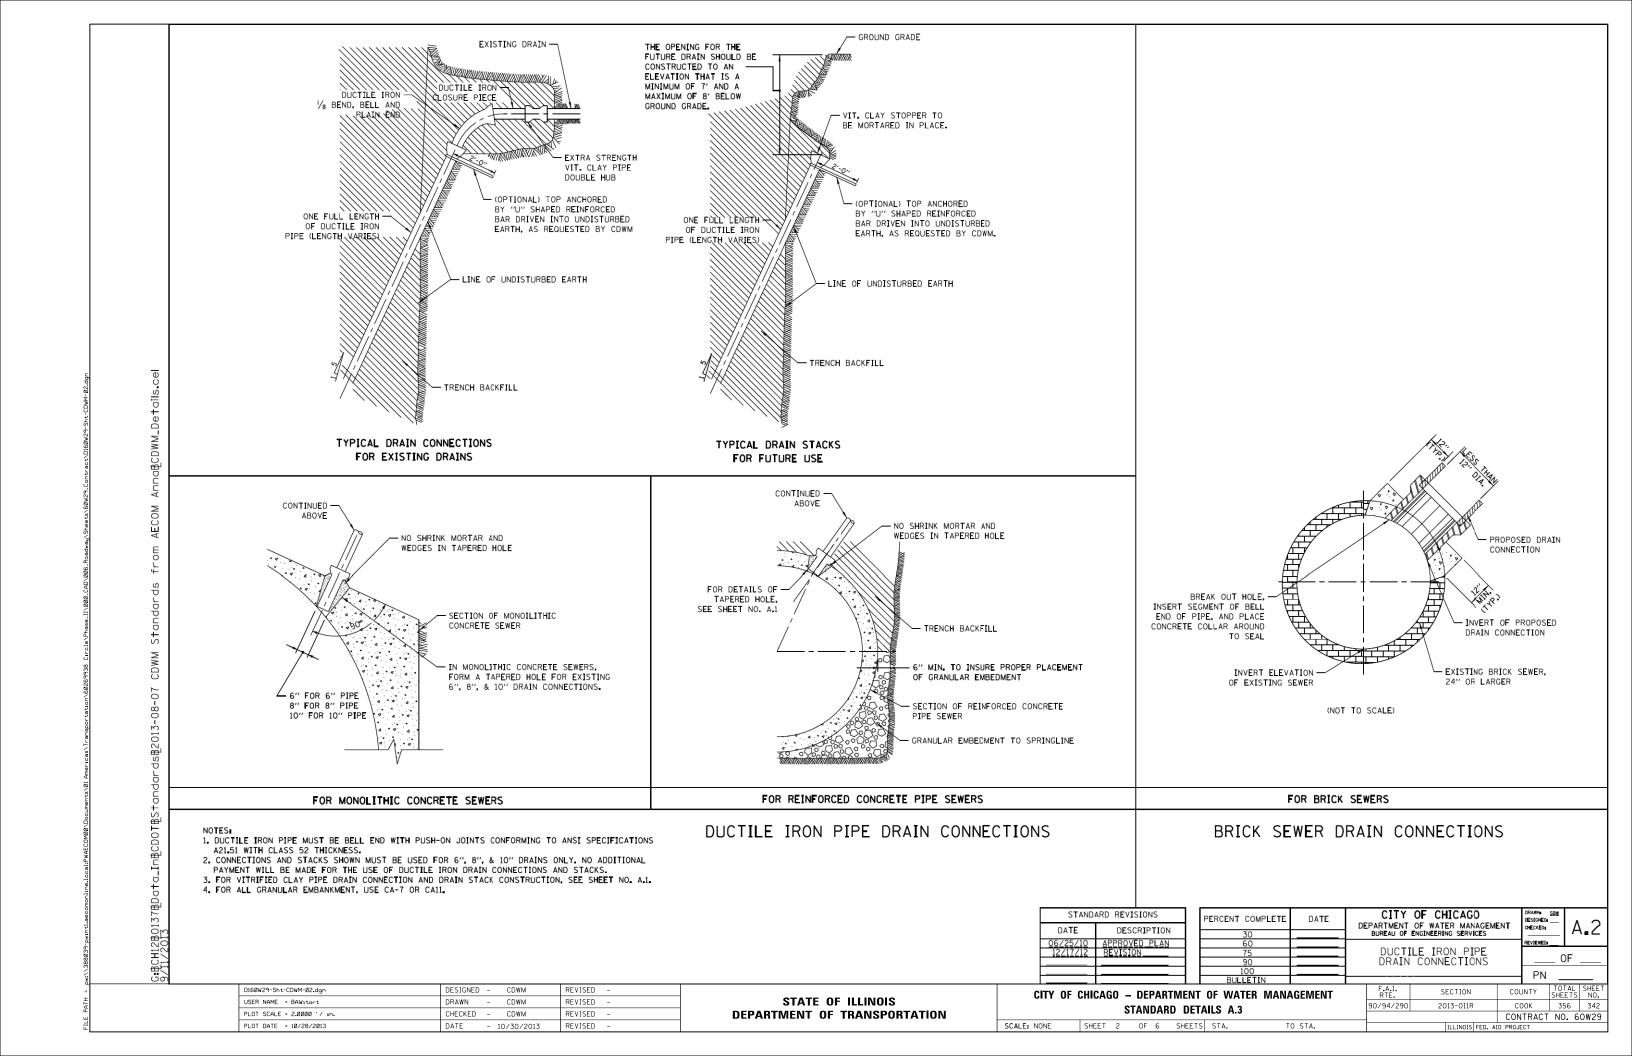

MATERIAL: CAST IRON


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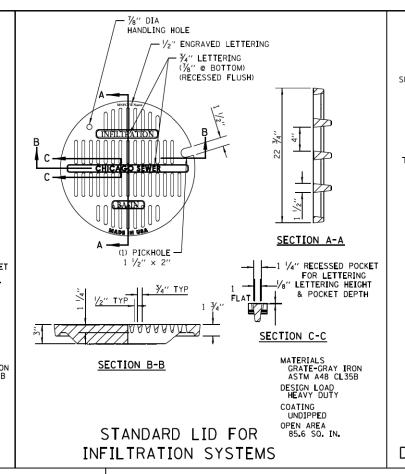
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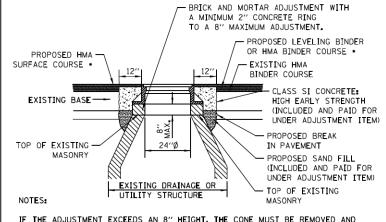
CDWM

ds#2013-08-07

3.#CH12#0137#Da+a_In#CDOT#S+ar





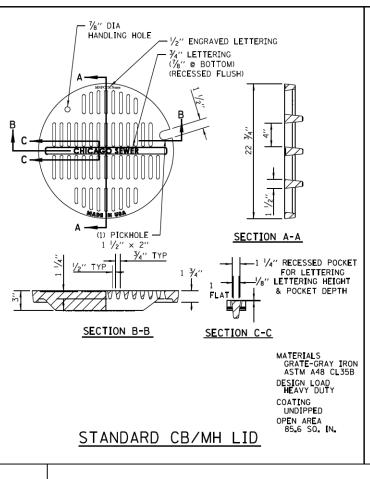


IF THE ADJUSTMENT EXCEEDS AN $8^{\prime\prime}$ HEIGHT, THE CONE MUST BE REMOVED AND THE BARREL SECTION MUST BE ADJUSTED.

THE CONTRACTOR IS REQUIRED TO REPLACE ANY BROKEN FRAMES AND LIDS OF SEWER STRUCTURES WITH STANDARD FRAMES AND LIDS OF THE DWM. IN ADJUSTMENT OR RECONSTRUCTION OF SEWER STRUCTURES, ANY NON-STANDARD FRAMES AND LIDS MUST BE REPLACED WITH STANDARD FRAMES AND LIDS. IN ADJUSTMENT OR RECONSTRUCTION OF INLETS, ANY NON-STANDARD INLETS (GUTTER BOXES) MUST BE REPLACED WITH DWM STANDARD INLETS.


THE FRAMES AND LIDS OF SEWER STRUCTURES TO BE ABANDONED, REMOVED, OR FILLED MUST BE SALVAGED AND THE DWM NOTIFIED FOR PICK UP.


MANHOLES, CATCH BASINS AND INLETS MUST BE PROTECTED FROM THE ENTRY OF ASPHALT/DEBRIS INTO THE SEWER SYSTEM DURING CONSTRUCTION. THE CONTRACTOR MUST MARK LOCATIONS OF ALL SEWER STRUCTURES ON THE SIDEWALK BEFORE STARTING PAVEMENT REMOVAL/REPLACEMENT, ADJUSTMENT OF FRAMES AND LIDS OF SEWER STRUCTURES MUST BE COMPLETED PRIOR TO STREET RESURFACING.

DETAIL OF TYPE I FRAME ADJUSTMENT

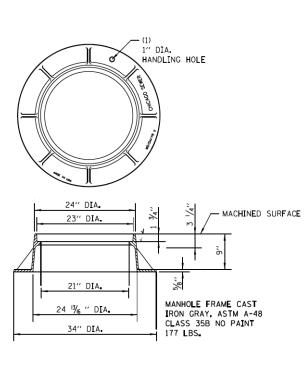




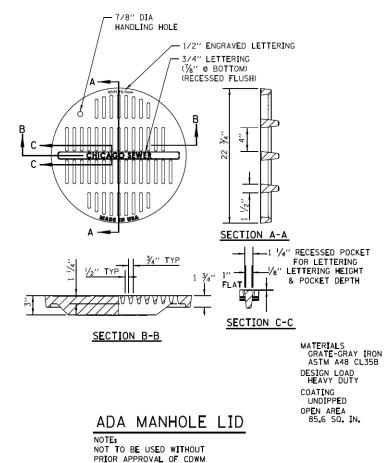

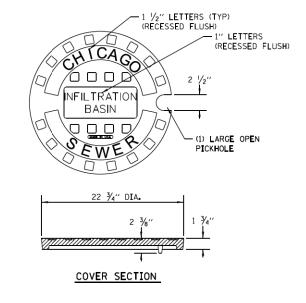

INFILTRATION SOLID LID FOR CATCH BASIN

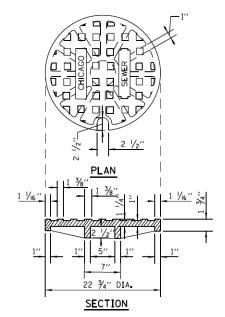

SOLID LID FOR MANHOLES

	STANDARD REVISIONS			PERCENT COMPLETE	DATE			CHICAGO	DRAWN SBW DESIGNED		
	DATE	DESCRIPTION		30				WATER MANAGEMENT NEERING SERVICES	CHECKED: GD, GC, SO	A . 3	
	12/17/12	REVISED		60					REVJEWED:	L	1
				75				NHOLE ND FRAMES)F	
				90 100			LIDS AN	ND FRAMES	<u> </u>		1
				BULLETIN					- PN _		
	CITY OF CUICAGO DEPARTMENT OF WATER MANAGEMENT						F.A.I.	SECTION	COUNTY	TOTAL S	HEE

STATE OF ILLINOIS
DEPARTMENT OF TRANSPORTATION

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STATE OF ILLINOIS
DEPARTMENT OF TRANSPORTATION

CITY OF CHICAGO - DEPARTMENT OF WATER MANAGEMENT STANDARD DETAILS A.5

SCALE: NONE SHEET 4 OF 6 SHEETS STA. TO STA.

F.A.I. SECTION COUNTY TOTAL SHEETS NO.
90/94/290 2013-011R COOK 356 344

CONTRACT NO. 60W29

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STATE OF ILLINOIS
DEPARTMENT OF TRANSPORTATION

CITY OF CHICAGO - DEPARTMENT OF WATER MANAGEMENT STANDARD DETAILS A.6

SCALE: NONE | SHEET | 5 OF | 6 SHEETS | STA. TO STA.

F.A.I. RTE. SECTION COUNTY TOTAL SHEETS NO.
90/94/290 2013-011R COOK 356 345

CONTRACT NO. 60W29

