	OF SHEETS COVER SHEET GENERAL NOTES 1-17-	14 LETTI	NG ITEM	<sup>069</sup> STATE
2 3-5 6-7	SUMMARY OF OUANTITIES TYPICAL SECTIONS			
8-9 10 11	SCHEDULE OF OUANTITIES ROADWAY PLAN KEYMAP ROADWAY PLAN - RAMP "T"/ ROADWAY "1			DEPARTMENT O
12	ROADWAY PLAN - CAMP JACKSON ROAD/ I (LOUISE TO BRIDGE) ROADWAY PLAN - CAMP JACKSON ROAD/ I			DIVISION
14 15	(CYNTHIA TO LENORA) GENERAL DETAILS PAVEMENT MARKING PLAN - RAMP "T"/ R			DIVISION
16 17	PAVEMENT MARKING PLAN - CAMP JACKSO (LOUISE TO PAVEMENT MARKING PLAN - CAMP JACKSO	N ROAD/ (L ROUTE 157 BRIDGE)		DDO
18	PAVEMENT MARKING PEAR - CAMP JACKSO (CYNTHIA TO PAVEMENT MARKING DETAILS			PRO
HIGHW/	AY STANDARDS			HIGHWA
000001-06 001006	STANDARD SYMBOLS, ABBREVIATIONS AND DECIMAL OF AN INCH AND OF A FOOT	PATTERNS		manvv
442201-03 482011-03	CLASS C AND D PATCHES HMA SHLD. STRIPS/SHLDS, WITH RESURF RESURFACING PROJECTS	ACING OR WIDENING AND		VARIOU
701006-05 701011-04	OFF-RD OPERATIONS, 2L, 2W, 15' (4.5 m) EDGE OFF-RD MOVING OPERATIONS, 2L, 2W, DA		IMENT	
701301-04 701311-03 701336-06 701400-07 701406-08	LANE CLOSURE, 2L, 2W, SHORT TIME OPE LANE CLOSURE, 2L, 2W MOVING OPERATI LANE CLOSURE, 2L, 2W, WORK AREAS IN APPROACH TO LANE CLOSURE, FREEWAY/ LANE CLOSURE, FREEWAY/EXPRESSWAY, D	ERATIONS ONS - DAY ONLY SERIES, FOR SPEEDS 2 45 MP EXPRESSWAY DAY OPERATIONS ONLY	н	VARIOUS DISTRICT
701456-03 701501-06 701502-06	PARTIAL EXIT RAMP CLOSURE FREEWAY/I URBAN LANE CLOSURE, 2L, 2W, UNDIVIDE URBAN LANE CLOSURE, 2L, 2W, WITH BID	0		<b>RESURFACING AT</b>
701901-03 780001-04 781001-03	TRAFFIC CONTROL DEVICES TYPICAL PAVEMENT MARKINGS TYPICAL APPLICATIONS RAISED REFLECT	IVE PAVEMENT MARKERS		IN THE
				ST. CLA
		2014 ADT:	FICATION: MINOR ARTERIAL 925	
		MU %: SU %:	1,1% 2,2%	C—98
		ROADWAY "H" FUNCTIONAL ( 2014 ADT; MU %: SU %:	CLASSIFICATION: INTERSTATE 4850 1.9%	END ATA
	ED EER		1.3% JACKSON ROAD ILDUISE TO BAID(	
AWARDED RESIDENT I		FUNCTIONAL CLASS 2014 ADT:	FICATION: PRINCIPAL ARTERIAL 8700	
AS BUILT (	HANGES WERE MADE	MU %: SU %:	1.5% 3.2%	BEGIN RAMP TT / ROADWAY 'N' SECTION STA 12+25 (BAMP T)
ON THE FO	LLOWING SHEETS		JACKSON ROAD (CYNTHIA TO LEN FICATION: PRINCIPAL ARTERIAL	VORA)
) 109' ) 10'	$\begin{array}{cccccccccccccccccccccccccccccccccccc$	2014 AD1: MU %: SU %:	7300 1.2% 4.1%	internet and
	100' 1'' = 50'			RESURFACING PROJECT AREAS
	50' 100' 1" = 40'		AOFESSIONAL ST	
	50' 100' 50' - 1" = 30'			
FULL SIZE PI	ANS HAVE BEEN PREPARED USING S		IUDINE DUNNELL TTI	
ENGINEERING	SCALES. REDUCED SIZED PLANS WI	- · · · · · · · · · · · · · · · · · · ·	062-060968	
LUMPHER T	O STANDARD SCALES. IN MAKING M PLANS, THE ABOVE SCALES MAY BE			S S S S S S S S S S S S S S S S S S S
			TE OF ILLINOIS	END "LOUISE TO BRIDGE' SECTION T
ON REDUCES			- K_1 1/2)	
ON REDUCEI J.U.L.I.E. JOINT UTILI	TY LOCATION INFORMATION FOR EXC	AVATION		
ON REDUCES		TOBIT	N BONNELL DATE ISE EXPIRES 11/30/2013	
ON REDUCES J.U.L.I.E. JOINT UTILI 1-800-892-C or 811	1123	TOBI LICEN SHEE	ISE EXPIRES <u>11/30/2013</u> T BANGE <u>1 - 18</u>	
DN REDUCES J.U.L.I.E. JOINT UTILI 1-800-892-6 or 811 PROJEC	T ENGINEER TIM P	TOBIT	ISE EXPIRES 11/30/2013 T RANGE 1 - 18	BEGIN TOUISE TO BRIDGE' SECTION STA. 142+12 RL ROUTE 1517 RESURFACING

STATE OF ILLINOIS DEPARTMENT OF TRANSPORTATION


**DIVISION OF HIGHWAYS** 

# PROPOSED HIGHWAY PLANS


VARIOUS ROUTES VARIOUS DISTRICT 8 RESURFACING 2014–1

**RESURFACING AT VARIOUS LOCATIONS** 

N THE METRO EAST ST. CLAIR COUNTY C-98-044-13

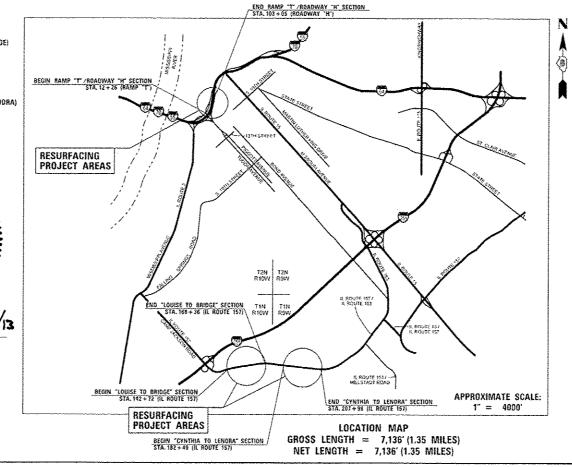



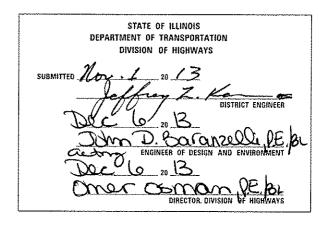

PRINTED BY THE AUTHORITY OF THE STATE OF ILLINOIS

> EDSI ENGINEERING DESIGN SOURCE, INC. 16141 SWINGLEY RIDGERD., SUITE 360 CUBSTERFIELD, MO 63017

## **GENERAL NOTES**

- 1. EXCESS BITUMIN REMOVAL SHALL BE PAID FOR ACCORDING TO ARTICLE 109.04 OF THE STANDARD SPECIFICATIONS.
- 2. MIXTURES FOR JOINTS, CRACKS, AND FLANGWAYS SHALL BE PAID FOR ACCORDING TO ARTICLE 109.04 OF THE STANDARD SPECIFICATIONS.
- 3. THE CONTRACTOR AND ENGINEER SHALL BE AWARE THAT NO SURVEY WAS PERFORMED FOR THIS PROJECT. THE STATIONING AND TOPO SHOWN IN THE PLANS WAS CREATED USING MICROFILM AND FIELD MEASUREMENTS MADE BY DESIGN PERSONNEL. BOTH SHALL BE ASSUMED TO BE APPROXIMATE.
- 4. THE CONTRACTOR SHALL VERIFY ALL DIMENSIONS AND CONDITIONS IN THE FIELD PRIOR TO CONSTRUCTION AND ORDERING MATERIALS.
- 5. THE NOMINAL THICKNESS FOR BINDER AND SURFACE COURSE IS SHOWN ON THE TYPICAL SECTIONS, STANDARDS, SCHEDULES, OR SPECIAL DETAILS. THE CONSTRUCTED THICKNESS OF THE BASE ITEMS SHALL NOT BE LESS THAN 90 PERCENT OF THE NOMINAL THICKNESS AT ANY LOCATION.
- 6. THE THICKNESS OF THE BITUMINOUS MIXTURE SHOWN ON THE PLANS IS THE NOMINAL THICKNESS. DEVIATIONS FROM THE NOMINAL THICKNESS WILL BE PERMITTED WHEN SUCH DEVIATIONS OCCUR DUE TO IRREGULARITIES IN THE EXISTING SURFACE OR BASE ON WHICH THE BITUMINOUS MIXTURE IS PLACED.
- 7. ALL PATCHING ON THIS PROJECT SHALL BE COMPLETED PRIOR TO BITUMINOUS SURFACE REMOVAL.
- 8. THE CONTRACTOR IS TO USE FULL LANE WIDTH (12 FT WIDE) DURING BITUMINOUS SURFACE REMOVAL.
- 9. THE USE OF VIBRATORY ROLLERS IS PROHIBITED IN RESIDENTIAL AREAS. THIS DOES NOT RELIEVE THE CONTRACTOR OF DENSITY REQUIREMENTS FOR THE BITUMINOUS PAVEMENTS AS SPECIFIED IN THE APPROPRIATE SECTIONS OF THE STANDARD SPECIFICATIONS.
- 10. HIGH EARLY STRENGTH CONCRETE MIX SHALL BE USED FOR ALL PCC PATCHING.
- 11. THE CONTRACTOR SHALL BE AWARE THAT THERE ARE MANHOLES AND VALVES LOCATED WITHIN THE RESURFACING LIMITS. CARE SHALL BE TAKEN IN THESE LOCATIONS DURING MILLING OPERATIONS.
- 12. THE PROPOSED STEEL BEAM GUARDRAIL AND TRAFFIC BARRIER TERMINAL ITEMS INCLUDED IN THE PLANS SHALL COMPLY WITH THE DETAILS IN THE PLANS AND MANUFACTURER'S DETAILS IN ORDER TO MATCH THE EXISTING GUARDRAIL ELEMENTS THAT WERE ERECTED PRIOR TO JANUARY 1, 2007.
- 13. ALL AREAS DISTURBED FOR ANY REASON SHALL BE PERMANENTLY SEEDED, AS DIRECTED BY THE ENGINEER. ALL AREAS DISTURBED BY THE CONTRACTOR OUTSIDE THE PROPOSED CONSTRUCTION LIMITS SHALL BE SEEDED AT THE CONTRACTOR'S EXPENSE.
- 14. THE ILLINOIS DEPARTMENT OF TRANSPORTATION STRONGLY ENCOURAGES THE PRIME CONTRACTOR AND THEIR APPROVED SUB-CONTRACTORS TO HIRE MINORITY, WOMEN, AND DISADVANTAGED INDIVIDUALS FROM ITS FEDERALLY FUNDED HIGHWAY CONSTRUCTION CAREERS TRAINING PROGRAM (HCCTP) TO HELP MEET WORKFORCE AND TRAINEE GOALS. THIS PROGRAM IS TRAINING MINORITIES, WOMEN, AND DISADVANTAGED INDIVIDUALS IN HIGHWAY CONSTRUCTION-RELATED SKILLS, E.G. MATH FOR THE TRADES, JOB READINESS, TECHNICAL SKILLS COURSEWORK (CARPENTRY, CONCRETE FLATWORK, BLUEPRINT READING, SITE PLANS, SITE WORK, TOOLS USE, ETC.) AND OSHA 10-HOUR CERTIFICATION, TO PREPARE THEM FOR A CAREER IN THE HIGHWAY CONSTRUCTION TRADES. GRADUATES ARE WELL-TRAINED AND READY TO BECOME PRODUCTIVE ENTRY-LEVEL CONSTRUCTION WORKERS. PLEASE CONTACT THE DISTRICT 8 EEO OFFICE AT 618-346-3360 AND/OR THE HCCTP COORDINATOR AT 618-874-6528 TO LEARN MORE ABOUT THE PROGRAM AND FOR ASSISTANCE IN MEETING WORKFORCE AND TRAINEE GOALS.
- 15. THE PAVEMENT MARKING SHOWN ON THE PLAN IS APPROXIMATE. THE LOCATION OF THE PROPOSED PAVEMENT MARKINGS SHALL MATCH EXISTING FIELD CONDITIONS, OR BE PLACED AS DIRECTED BY THE ENGINEER.
- 16. ALL TRAFFIC CONTROL DEVICES SHALL BE SKID-MOUNTED.

USER NAME = thornell

HODEL NAME = Default

PLOT DATE = 18/29/2013

PLOT SCALE = 20.0000 '/ in

FILE NAME =

76042\_l-sht-general notes.de

17. THE FOLLOWING MIXTURE REQUIREMENTS ARE APPLICABLE FOR THIS PROJECT:

MIXTURE USE	SURFACE	LEVEL BINDER	PATCHING	INCIDENTAL SURFACE	SHOULDERS
AC/PG	PG 64-22	PG 64-22	PG 64-22	PG 64-22	PG 64-22
DESIGN AIR VOIDS	4.0% @ Ndes≍70	4.0% @ Ndes=70	4.0% @ Ndes=70	4.0% @ Ndes=70	**2.0% Ø Ndes=30
MIX COMPOSITION			anase		NMAS 3/4"
(GRADATION MIXTURE)	<b>L</b> 9.5	L 9.5 FG	IL 19,0 FG		L 19.0
FRICTION AGG	MIXTURE "D"	MIXTURE "C"	MIXTURE "B"	MIXTURE "C"	

\*\* TOP LIFT SHOULDERS - DESIGN THIS MIX AT 2.0% VOIDS AND ADD ASPHALT TO REDUCE VOIDS TO 1.5%

REVISED -

REVISED -

REVISED

- 10/29/13 REVISED

DESIGNED - TTB

DRAWN - TTB

CHECKED - JAH

DATE

### **GENERAL NOTES (CON'T.)**

18. NO OVERNIGHT LANE CLOSURES WILL BE ALLOWED.

- 19. ALL CONSTRUCTION SIGNS SHALL BE FLUORESCENT ORANGE (48" X 48").
- 20. FLAGGERS SHALL BE PRESENT DURING ALL CLOSURE HOURS, INCLUDING LUNCH HOUR, AND NO ADDITIONAL COMPENSATION SHALL BE ALLOWED.
- 21. EXCAVATION ADJACENT TO THE EDGE OF PAVEMENT SHALL BE PROTECTED WITH EXTENDED LEG BARRICADES WITH APPROPRIATE LIGHTS.
- 22. "UNEVEN LANE" SIGNS SHALL BE PLACED ON MILLED ROADWAY LANES THAT ARE NOT ABLE TO BE RESURFACED PRIOR TO OPENING THE LANES TO TRAFFIC. THE CONTRACTOR SHALL ALSO PROVIDE TEMPORARY SIGNAGE, IF NECESSARY, TO ENSURE THAT THE MAXIMUM SPEED LIMIT THROUGH SUCH AREAS IS 40 MILES PER HOUR. IF MILLING OPERATIONS CAUSE UNEVEN LANES IN THE VICINITY OF CURRENTLY-DESIGNATED PASSING ZONES. THE CONTRACTOR SHALL ALSO PROVIDE APPROPRIATE TEMPORARY PAVEMENT MARKINGS AND/OR TEMPORARY SIGNAGE, IN ORDER TO RESTRICT MOTORISTS FROM ATTEMPTING PASSING MOVEMENTS.

23. ILLINOIS STATE LAW REQUIRES A 48-HOUR NOTICE TO BE GIVEN TO ALL UTILITIES BEFORE DIGGING. FIELD MARKING OF FACILITIES MAY BE OBTAINED BY CONTACTING J.U.LI.E. (1-800-892-0123 OR 811) OR FOR NON-MEMBERS. THE UTILITY COMPANY DIRECTLY. AGENCIES KNOWN TO HAVE FACILITIES WITHIN THE PROJECT AREA ARE AS FOLLOWS:

	ABOVE GROUND	BELOW	
AMEREN ILLINOIS. GAS & ELECTRIC	v	V OILOUND	
• AT&T ILLINOIS, COMMUNICATIONS	÷		
	Å	Å	
<ul> <li>VILLAGE OF CASEYVILLE, WATER &amp; SANITARY SEWER</li> </ul>		• X ·	
CHARTER COMMUNICATIONS, CABLE TV	X	Х	1.
<ul> <li>CITY OF EAST ST. LOUIS, LIGHTING</li> </ul>	X	X	
<ul> <li>CITY OF FAIRVIEW HEIGHTS, SANITARY SEWER</li> </ul>		X	
<ul> <li>ILLINOIS AMERICAN WATER COMPANY, WATER</li> </ul>		х .	
<ul> <li>LACLEDE PIPELINE COMPANY, PIPELINE</li> </ul>		х	
<ul> <li>MEDIACOM, CABLE TV</li> </ul>	X	· X	
. CITY OF O'FALLON, WATER & SANITARY SEWER		Х	
<ul> <li>MCLEOD TELECOMMUNICATIONS SERVICES, COMMUNICATIONS</li> </ul>		X	

MEMBERS OF J.U.L.I.E. (800)-892-0123 ARE INDICATED BY . NON-J.U.L.I.E. MEMBERS MUST BE NOTIFIED INDIVIDUALLY.

STATE OF ILLINOIS DEPARTMENT OF TRANSPORTATION

# **RATES OF APPLICATION**

CRUSHED STONE (WITH FINES): AGGREGATE SHOULDERS

BITUMINOUS CONCRETE: SURFACE. BINDER, LEVEL BINDER

AGGREGATE (PRIME COAT): BRICK, PCC, & BITUM BASE

BITUMINOUS MATERIALS (PRIME COAT): BRICK, PCC, & BITUM BASE

SEEDING AREAS: NITROGEN FERTILIZER NUTRIENT PHOSPHORUS FERTILIZER NUTRIENT POTASSIUM FERTILIZER NUTRIENT

MULCH: METHOD 1 & 2; STRAW MULCH 2.05 TON/CU YD

112 LBS/SQ YD/INCH

0.0015 TON/SQ YD

0.0003129 TON/SO YD

2 TONS/ACRE

# **COMMITMENTS**

NONE

3		F.A.I. RTE	SECTION	COUNTY	TOTAL	SHEET NO.
		VAR.	VARIOUS	ST. CLAIR	18	2
				CONTRACT	NO. 7	6G42
ra.	TO STA.	FED. R	DAD DIST. NO. 8 ILLINDIS FED. AT	D PROJECT		

10600300 AGGR 10600637 LEVE	JMINOUS MATERIALS (PRIME CO REGATE (PRIME COAT) ELING BINDER (MACHINE METHO		UNIT TON TON	URBAN TOTAL QUANTITY 9 42	RAMP "T" / ROADWAY "H" 2 9	CONSTRUCTION CODE ROADWAY 0005 CAMP JACKSON ROAD / IL ROUTE 157 (LOUISE TO BRIDGE) 4	CAMP JACKSON ROAD / IL ROUTE 157 (CYNTHIA TO LENORA) 3	
NO. 0600200 BITU 0600300 AGGR 0600637 LEVE	JMINOUS MATERIALS (PRIME CO REGATE (PRIME COAT)	)AT )	TON	TOTAL QUANTITY 9	ROADWAY "H" 2	CAMP JACKSON ROAD / IL ROUTE 157 (LOUISE TO BRIDGE)	IL ROUTE 157 (CYNTHIA TO LENORA)	
NO. 0600200 BITU 0600300 AGGR 0600637 LEVE	JMINOUS MATERIALS (PRIME CO REGATE (PRIME COAT)	)AT )	TON	TOTAL QUANTITY 9	ROADWAY "H" 2	IL ROUTE 157 (LOUISE TO BRIDGE)	IL ROUTE 157 (CYNTHIA TO LENORA)	
10600300 AGGR 10600637 LEVE	REGATE (PRIME COAT)					4	3	
10600637 LEVE		D), IL-9.5FG, N70	TON	42	9			
0600637 LEVE		DD), IL-9.5FG, N70		42	3	10		
······	ELING BINDER (MACHINE METHO	D), IL-9.5FG, N70				19	14	
			TON	856	139	431	286	
*****************								
40600982 HOT-I	MIX ASPHALT SURFACE REMOVA	L - BUTT JOINT	SQ YD	997	158	457	382	
40600990 TEMP	PORARY RAMP		SQ YD	578	158	245	175	
40603340 HOT-I	-MIX ASPHALT SURFACE COURSE	, MIX "D", N70	TON	1,712	278	861	573	
· · · · · · · · · · · · · · · · · · ·								
40800050 INCI	IDENTAL HOT-MIX ASPHALT SUR	FACING	TON	42		21	21	
44000153 H0T-I	MIX ASPHALT SURFACE REMOVA	L, 1"	SQ YD	20, 059		11, 717	8, 342	
44000155 HOT-I	MIX ASPHALT SURFACE REMOVA	L, 1 1/2"	SQ YD	5,435	5, 435			
44200120 PAVE	EMENT PATCHING, TYPE II, 10	INCH	SQ YD	25	25			
44200124 PAVE	EMENT PATCHING, TYPE III, 1	O INCH	SQ YD	195	· · · · · · · · · · · · · · · · · · ·	115	80	
44200126 PAVE	MENT PATCHING, TYPE IV, 10	INCH	SQ YD	622	131	94	397	
·····	······································				······································			
14300200 STRII	IP REFLECTIVE CRACK CONTROL	TREATMENT	FOOT	14, 272	4,046	5, 128	5, 098	
8102100 AGGR	REGATE WEDGE SHOULDER, TYPE	В	TON	121		61	60	

	E : shtrquan-summeru-Bi.dgn	USER NAME : thonnail	DESIGNED - TTB	REVISED -	STATE OF ILLINOIS DEPARTMENT OF TRANSPORTATION	[		F.A.I. RTE.	SECTION	COUNTY	TOTAL	SHEET NO.	
29/20		MODEL NAME = Defoult PLOT SCALE = 20.0000 '/ in.	DRAWN - TTB CHECKED - JAH	REVISED - REVISED -			SUMMARY OF QUA	VAR.	VARIOUS	ST. CLAIR	18 F NO. 7F	3 5G42	
AFILE.		PLOT DATE * 18/29/2813	DATE - 10/29/13	3 REVISED -		SCALE: NONE	SHEET NO. 1 OF 3 SHEETS	STA. TO STA.	FED. ROA	AD DIST. NO. B ILLINDIS FED. 1	NO PROJECT		

	SUMMARY OF QUANTITIES (	CON'T.)		· · · · · · · · · · · · · · · · · · ·	100 % STATE	······
				· · · · · · · · · · · · · · · · · · ·	ROADWAY 0005	· · · · · · · · · · · · · · · · · · ·
CODE NO.	ITEM	UNIT	URBAN TOTAL QUANTITY	RAMP "T" / ROADWAY "H"	CAMP JACKSON ROAD / IL ROUTE 157 (LOUISE TO BRIDGE)	CAMP JACKSON RO IL ROUTE 157 (CYNTHIA TO LENORA)
48203100	HOT-MIX ASPHALT SHOULDERS	TON	717	288	215	214
				· · · · · · · · · · · · · · · · · · ·		
67000400	ENGINEER'S FIELD OFFICE, TYPE A	CAL MO	2	0.30	0.68	1.02
				· · ·		
67100100	MOBILIZATION	L SUM	<b>I</b>	0.15	0.34	0.51
70100600	TRAFFIC CONTROL AND PROTECTION, STANDARD 701336	L SUM	1			1
70100700	TRAFFIC CONTROL AND PROTECTION, STANDARD 701406	L SUM	1	1		
			· · · · · · · · · · · · · · · · · · ·			
70100825	TRAFFIC CONTROL AND PROTECTION, STANDARD 701456	LSUM	1	1		
70102620	TRAFFIC CONTROL AND PROTECTION, STANDARD 701501	L SUM	1	-	· · · · · · · · · · · · · · · · · · ·	1
70102622	TRAFFIC CONTROL AND PROTECTION, STANDARD 701502	L SUM	1		1	
70103815	TRAFFIC CONTROL SURVEILLANCE	CAL DA	45	15	15	15
					-	
70300100	SHORT TERM PAVEMENT MARKING	FOOT	21,764	3, 251	11,855	6, 658
				***		
70300210	TEMPORARY PAVEMENT MARKING LETTERS AND SYMBOLS	SQ FT	210	· · · · · · · · · · · · · · · · · · ·	210	
70300000	TEMPORARY PAVEMENT MARKING - LINE 4"					
10300220	ILWICHANT FAVENENT WARKING 7 LINE 4	FOOT	21,086	2, 615	11,813	6,658
70300250	TEMPORARY PAVEMENT MARKING - LINE 8"	FOOT	636	636		
					· · · · · · · · · · · · · · · · · · ·	
70300260	TEMPORARY PAVEMENT MARKING - LINE 12"	FOOT	42		42	· · · · · · · · · · · · · · · · · · ·

	FILE NAME = 76642.1-sht-quan-summary-92.dgn	USER NAME = thonnell	DESIGNED - TTB	REVISED -						
ŵ	10042-11-BKE-COBH-BURNOFG-D2-0GH	HODEL NAME = Default	ORAWN - TTB	REVISED -	STATE OF ILLINOIS	SUMMARY OF (				
ć		PLDY SCALE * 20.0000 '/ in.	CHECKED - JAH	REVISED -	DEPARTMENT OF TRANSPORTATION					
1	PLOT DATE × 10/29/2013		DATE - 10/29/13	REVISED -		SCALE: NONE	SHEET NO. 2 OF 3 SHEETS S			
1	FILE+									


NTITIES		F.A.I. RTE.	SECTION	COUNTY	TOTAL	SHEET
		VAR.	VARIOUS	ST. CLAIR	18	4
				CONTRACT	NO. 7	6642
STA,	TO STA,	FED. ROAD	DIST. NO. 8 ILLINOIS FED	AND PROJECT		

# SUMMARY OF QUANTITIES (CON'T.)

		-			100% STATE	· · ·
		·		······································	ROADWAY 0005	
CODE NO.	ITEM	UNIT	URBAN TOTAL QUANTITY	RAMP "T" / ROADWAY "H"	CAMP JACKSON ROAD / IL ROUTE 157 (LOUISE TO BRIDGE)	CAMP JACKSON ROAD IL ROUTE 157 (CYNTHIA TO LENORA)
70301000	WORK ZONE PAVEMENT MARKING REMOVAL	SQ FT	15,409	2, 591	8, 379	4, 439
78000100	THERMOPLASTIC PAVEMENT MARKING - LETTERS AND SYMBOLS	SQ FT	210	· · · · · · · · · · · · · · · · · · ·	210	
						· · ·
78000200	THERMOPLASTIC PAVEMENT MARKING - LINE 4"	FOOT	21,086	2,615	11, 813	6,658
78000500	THERMOPLASTIC PAVEMENT MARKING - LINE 8"	FOOT	636	636		
		-				
78000600	THERMOPLASTIC PAVEMENT MARKING - LINE 12"	FOOT	42	······································	42	······································
78100100	RAISED REFLECTIVE PAVEMENT MARKER	EACH	198	29	128	41
					••••••••••••••••••••••••••••••••••••••	
78300200	RAISED REFLECTIVE PAVEMENT MARKER REMOVAL	EACH	198	29	128	41

ITEM ¥ SPECIALTY

53	FILE NAME = 78042.1-sht-quan-sunmary-83.dgn	USER NAME : (bonnel) MOTEL NAME : Default	DESIGNED - TTB DRAWN - TTB	REVISED -	STATE OF ILLINOIS DEPARTMENT OF TRANSPORTATION					CUMMARY OF OUANTITIES					
29/2		PLOT SCALE = 28.0000 '/ 10.	CHECKED - JAH	REVISED -			SUMMARY OF QUANTITIES					VARIOUS	ST. CLAIR CONTRACT	18	5 6G42
9.2	FILE	PLOT DATE = 18/29/2813	DATE - 10/29/13	REVISED -		SCALE: NONE	SHEET NO. 3	OF 3 SHEE	TS STA.	TO STA.	FED. ROAD	DIST. NO. 8 ILLINOIS FED. A		110. 1	3042

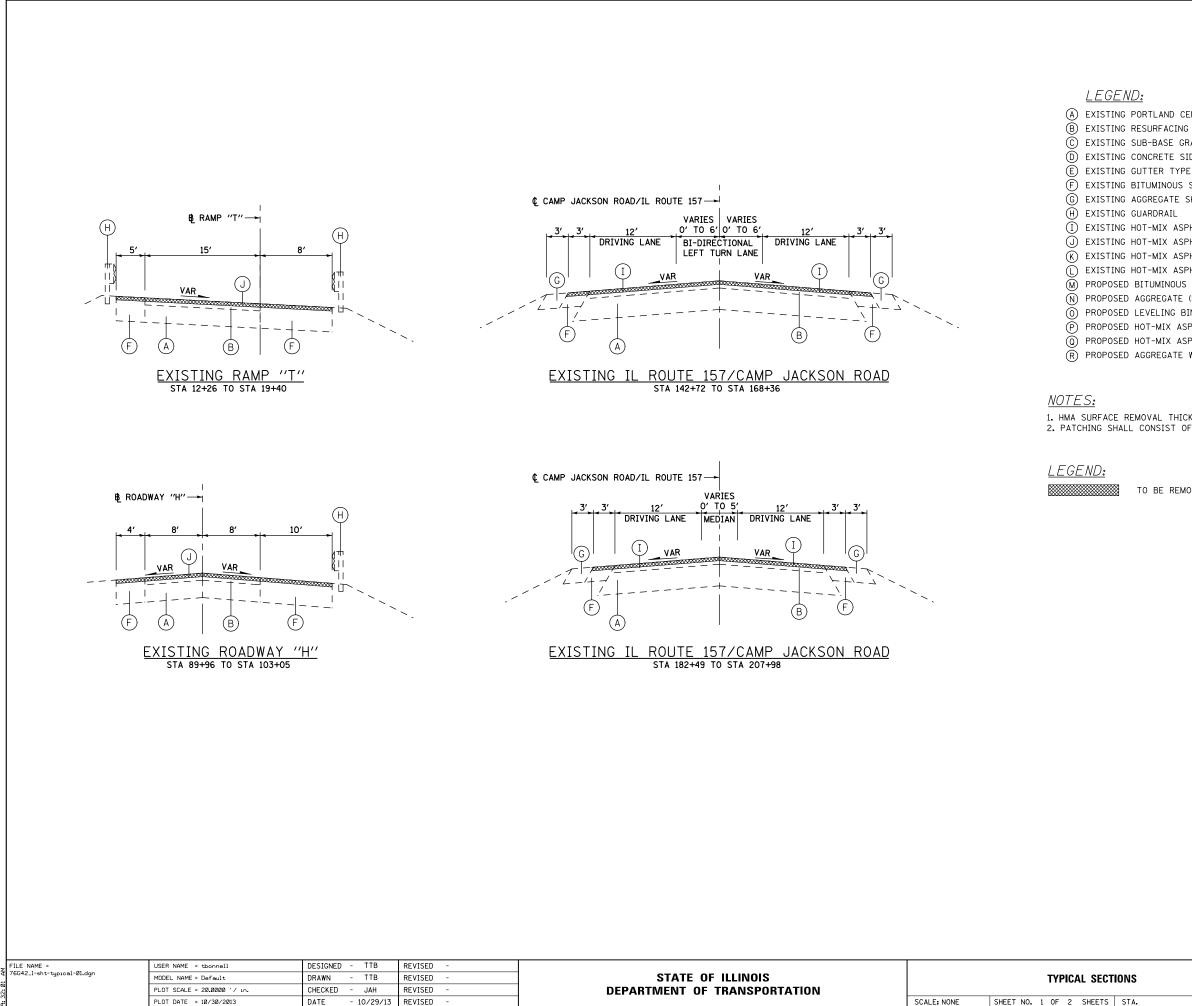


(A) EXISTING PORTLAND CEMENT CONCRETE PAVEMENT © EXISTING SUB-BASE GRANULAR MATERIAL (D) EXISTING CONCRETE SIDEWALK (E) EXISTING GUTTER TYPE A (F) EXISTING BITUMINOUS SHOULDER G EXISTING AGGREGATE SHOULDER (] EXISTING HOT-MIX ASPHALT SURFACE REMOVAL - 1" (J) EXISTING HOT-MIX ASPHALT SURFACE REMOVAL - 1 1/2" (K) EXISTING HOT-MIX ASPHALT SURFACE REMOVAL - 1 3/4" (L) EXISTING HOT-MIX ASPHALT SURFACE REMOVAL - 2 1/4" M PROPOSED BITUMINOUS MATERIALS (PRIME COAT) N PROPOSED AGGREGATE (PRIME COAT) (0) PROPOSED LEVELING BINDER (MACHINE METHOD), N70, 3/4" PROPOSED HOT-MIX ASPHALT SURFACE COURSE - 1 1/2" PROPOSED HOT-MIX ASPHALT SHOULDER, 2 1/4" (R) PROPOSED AGGREGATE WEDGE SHOULDER, TYPE B

1. HMA SURFACE REMOVAL THICKNESS IS THE REMOVAL DEPTH AT THE BASELINE. 2. PATCHING SHALL CONSIST OF CLASS C OR CLASS D PATCHES.

TO BE REMOVED

IONS		F.A.I. RTE.	SECTION	COUNTY	TOTAL SHEETS	SHEET NO.
		VAR.	VARIOUS	ST. CLAIR	18	6
		_		CONTRACT	NO. 7	6G42
STA.	TO STA.	FED. R	OAD DIST. NO. 8 ILLINOIS FED. AI	D PROJECT		

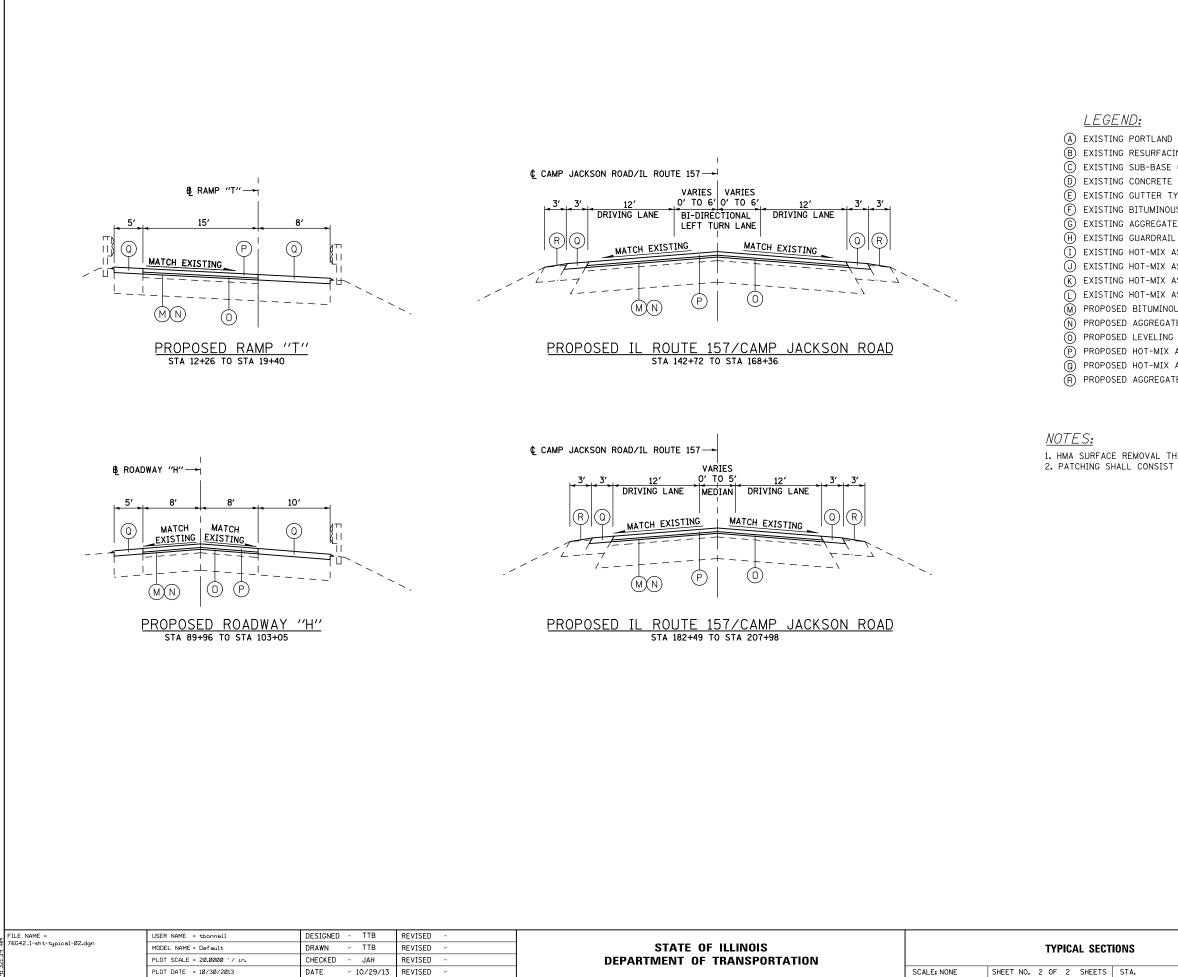

DATE

REVISED

```
(A) EXISTING PORTLAND CEMENT CONCRETE PAVEMENT
(B) EXISTING RESURFACING
C EXISTING SUB-BASE GRANULAR MATERIAL
D EXISTING CONCRETE SIDEWALK
E EXISTING GUTTER TYPE A
(F) EXISTING BITUMINOUS SHOULDER
(G) EXISTING AGGREGATE SHOULDER
(I) EXISTING HOT-MIX ASPHALT SURFACE REMOVAL - 1"
(J) EXISTING HOT-MIX ASPHALT SURFACE REMOVAL - 1 1/2"
(K) EXISTING HOT-MIX ASPHALT SURFACE REMOVAL - 1 3/4"
() EXISTING HOT-MIX ASPHALT SURFACE REMOVAL - 2 1/4"
(M) PROPOSED BITUMINOUS MATERIALS (PRIME COAT)
(N) PROPOSED AGGREGATE (PRIME COAT)
() PROPOSED LEVELING BINDER (MACHINE METHOD), N70, 3/4"
P PROPOSED HOT-MIX ASPHALT SURFACE COURSE - 1 1/2"

    PROPOSED HOT-MIX ASPHALT SHOULDER, 2 1/4"

R PROPOSED AGGREGATE WEDGE SHOULDER, TYPE B
```

1. HMA SURFACE REMOVAL THICKNESS IS THE REMOVAL DEPTH AT THE BASELINE. 2. PATCHING SHALL CONSIST OF CLASS C OR CLASS D PATCHES.

IONS		F.A.I. RTE.	SECTION	COUNTY	TOTAL SHEETS	SHEET NO.
		VAR.	VARIOUS	ST. CLAIR	18	7
		_		CONTRACT	NO. 7	6G42
STA.	TO STA.	FED. R	DAD DIST. NO. 8 ILLINOIS FED. AI	D PROJECT		

			REMOVAL	SCHEDULE			
			HOT-MIX ASPHALT SURFACE REMOVAL, 1"	HOT-MIX ASPHALT SURFACE REMOVAL, 1 1/2"	HOT-MIX ASPHALT SURFACE REMOVAL - BUTT JOINT	TEMPORARY RAMP	RAISED REFLECTIVE PAVEMENT MARKER REMOVAL
STATION	то	STATION	SQ YD	SQ YD	SQ YD	SQ YD	EACH
RAMP "T"							
12+26		12+51			78	78	
12+26		19+40					10
12+51		19+40		1,774			
ROADWAY "H"							
89+96		102+80		3,661			
89+96		103+05					19
102+80		103+05			80	80	
RAMP "	'T''/F	ROADWAY "H" TOTAL		5,435	158	158	29
CAMP JACKSON ROAD	)/IL	ROUTE 157 (LOUISE 1	O BRIDGE)				
142+72		142+97			142	142	
142+72		168+36					128
142+97		168+11	11,717				
168+11		168+36			103	103	
"LO	UISE	E TO BRIDGE'' TOTAL	11,717		245	245	128
CAMP JACKSON ROAD		ROUTE 157 (CYNTHIA	TO LENORA)				
182+49		182+74			86	86	
182+49		207+98					41
182+74		207+73	8,342				
207+73		207+98			89	89	
"CYN	THIA	TO LENORA" TOTAL	8,342		175	175	41
		TOTAL	20,059	5,435	578	578	198

			RESURF	ACING SCHEDUL	E	-	
			BITUMINOUS MATERIALS (PRIMECOAT)	AGGREGATE (PRIME COAT)	LEVELING BINDER (MACHINE METHOD), IL-9.5FG, N70	HOT-MIX ASPHALT SURFACE COURSE, MIX "D", N70	STRIP REFLECTIVE CRACK CONTROL TREATMENT
STATION	TO	STATION	TON	TON	TON	TON	FOOT
RAMP "T"							
12+26		19+40	0.36	1.7	48	96	1,428
ROADWAY "H"							
89+96		103+05	0.68	3.3	91	182	2,618
RAMP "T	'/R0/	DWAY "H" TOTAL	1.04	5	139	278	4,046
CAMP JACKSON	ROAD	) / IL ROUTE 157 (L	OUISE TO BRIDG	E)			
142+72		168+36	3.21	15.4	431	861	5,128
"LOU	JISE T	O BRIDGE'' TOTAL	3.21	16	431	861	5,128
CAMP JACKSON	ROAD	) / IL ROUTE 157 (C	YNTHIA TO LENC	DRA)			
182+49		207+98	2.13	10.2	286	573	5,098
"CYNT	HIA TC	D LENORA'' TOTAL	2.13	11	286	573	5,098
		TOTAL	6.4	32	856	1,712	14,272

			SIDE	EROAD SCH	EDULE			
STATION	SIDE	ROAD NAME	EXISTING SURFACE	LENGTH (FOOT)	WIDTH (FOOT)	BITUMINOUS MATERIALS (PRIME COAT) TON	HOT-MIX ASPHALT SURFACE REMOVAL - BUTT JOINT SQ YD	INCIDENTAL HMA SURFACING TON
		OAD / IL ROUTE 157 (LO			(			
144+68	LT	LOUISE AVENUE	BITUMINOUS	39	7.5	0.010	32.5	1.1
149+57	LT	LYNN STREET	BITUMINOUS	52	7.5	0.014	43.3	1.5
153+87	LT	JEROME LANE	BITUMINOUS	102	7.5	0.027	85.0	3.0
161+14	LT	DORIS AVENUE	BITUMINOUS	61	7.5	0.016	50.8	1.8
			"LOUI	SE TO BRID	GE'' TOTAL	0.07	212	8
CAMP JAC	KSON R	OAD / IL ROUTE 157 (CY	NTHIA TO LENC	RA)				
190+98	RT	DELANO DRIVE	BITUMINOUS	58	7.5	0.015	48.3	1.7
192+39	LT	CYNTHIA DRIVE	BITUMINOUS	54	7.5	0.014	45.0	1.6
194+99	LT	HELEN COURT	BITUMINOUS	61	7.5	0.016	50.8	1.8
204+45	LT	DELORES DRIVE	BITUMINOUS	75	7.5	0.020	62.5	2.2
	1	l	CYNTH	A TO LENO	RA'' TOTAL	0.06	207	7
					TOTAL	0.1	418.7	15

				SHOULDER SCI	HEDULE	<b></b>	
				BITUMINOUS MATERIALS (PRIME COAT)	AGGREGATE (PRIME COAT)	AGGREGATE WEDGE SHOULDERS, TYPE B	HOT-MIX ASPHALT SHOULDERS
STATION	TO	STATION	SIDE	TON	TON	TON	TON
RAMP "T"							
12+26		14+72	LT	0.05	0.3		20
12+26		19+40	RT	0.17	0.8		70
ROADWAY"	H						
89+96		103+05	RT	0.39	1.9		156
97+05		103+05	LT	0.10	0.5		42
		ROADWAY "H		0.71	4		288
	SON F		<u> </u>	OUISE TO BRIDG	· ·		
142+72		168+36	LT	0.27	1.4	31	108
142+72		168+36	RT	0.27	1.4	30	107
		E TO BRIDGI		0.53	3	61	215
CAMP JACK	SON F	ROAD / IL ROU	JTE 157 (C	YNTHIA TO LENG	DRA)		
182+49		207+98	LT	0.27	1.4	30	107
182+49		207+98	RT	0.27	1.4	30	107
"C		A TO LENOR	A'' TOTAL	0.53	3	60	214
			TOTAL	18	10	121	717

4 М 1 3	FILE NAME = 76G42_1-sht-guan-schedule-01.dqn	USER NAME = tbonnell	DESIGNED - TTB	REVISED -				
31		MODEL NAME = Default	DRAWN - TTB	REVISED -	STATE OF ILLINOIS		SCHEDULE OF QUA	AN I
380		PLOT SCALE = 20.0000 ' / in.	CHECKED – JAH	REVISED -	DEPARTMENT OF TRANSPORTATION			
9:07		PLOT DATE = 10/30/2013	DATE - 10/29/13	REVISED -		SCALE: NONE	SHEET NO. 1 OF 2 SHEETS	ST/
	\$FILE\$							


TION P JAC							
P JAC			EXISTING	LENGTH	WIDTH	BITUMINOUS MATERIALS (PRIME COAT)	INCIDENTAL HMA SURFACING
	SIDE	TYPE	SURFACE	(FOOT)	(FOOT)	TON	TON
+04		OAD / IL ROUTE		,			
	LT	PRIVATE	BITUMINOUS	31	3	0.003	0.36
+62	LT	COMMERCIAL	BITUMINOUS	63	3	0.007	0.74
+65 +48	RT RT	COMMERCIAL COMMERCIAL	BITUMINCUS	51 32	3	0.005	0.60
+68	LT	COMMERCIAL	BITUMINOUS	63	3	0.003	0.74
+86	RT	COMMERCIAL	GRAVEL	39	3	0.004	0.46
+54	LT	FIELD	GRAVEL	44	3	0.005	0.51
+38	RT	COMMERCIAL	BITUMINOUS	45	3	0.005	0.53
+20	LT	PRIVATE	BITUMINOUS	42	3	0.004	0.49
+46	RT	COMMERCIAL	BITUMINOUS	45	3	0.005	0.53
+54	LT	PRIVATE	GRAVEL	33	3	0.003	0.39
+60	LT	PRIVATE	GRAVEL	41	3	0.004	0.48
+22	RT	COMMERCIAL	BITUMINOUS	41	3	0.004	0.48
+46	RT	FIELD	GRAVEL	27	3	0.003	0.32
+85	LT	COMMERCIAL	CONCRETE	48	3	0.005	0.56
+72	RT	COMMERCIAL	GRAVEL	65	3	0.007	0.76
+23	LT	COMMERCIAL	CONCRETE	44	3	0.005	0.51
+79	LT	COMMERCIAL	BITUMINOUS	52	3	0.005	0.61
+48	LT	COMMERCIAL	BITUMINOUS	45	3	0.005	0.53
+79 +95	RT LT		BITUMINCUS	49 54	3	0.005	0.57
+95 +11	RT	COMMERCIAL COMMERCIAL	BITUMINCUS	54 52	3	0.006	0.63
+95	LT	COMMERCIAL	BITUMINCUS	52 47	3	0.005	0.55
+95	RT	COMMERCIAL	BITUMINOUS	47	3	0.005	0.53
+74	LT	COMMERCIAL	BITUMINOUS	49	3	0.005	0.57
				SE TO BRIDO		0.12	13.4
		OAD / IL ROUTE				· · · · · · · · · · · · · · · · · · ·	
+96	RT	COMMERCIAL	BITUMINOUS	55	3	0.006	0.64
+67	RT	COMMERCIAL	BITUMINOUS	50	3	0.005	0.58
+29	RT	COMMERCIAL	BITUMINOUS	44	3	0.005	0.51
+12			BITUMINOUS	35	3	0.004	0.41
+77 +49	RT RT		BITUMINCUS	47 55	3	0.005	0.55
+49 +86	LT	COMMERCIAL COMMERCIAL	BITUMINCUS	85	3	0.006	0.64
+53	RT	COMMERCIAL	BITUMINOUS	62	3	0.009	0.99
+97	LT	PRIVATE	BITUMINOUS	40	3	0.000	0.72
+34	RT	COMMERCIAL	BITUMINOUS	54	3	0.004	0.63
+61	RT	COMMERCIAL	BITUMINOUS	47	3	0.005	0.55
+39	RT	COMMERCIAL	BITUMINOUS	48	3	0.005	0.56
+02	RT	PRIVATE	BITUMINOUS	26	3	0.003	0.30
+92	LT	PRIVATE	GRAVEL	21	3	0.002	0.25
+03	RT	PRIVATE	BITUMINOUS	17	3	0.002	0.20
+01	RT	PRIVATE	BITUMINOUS	17	3	0.002	0.20
+42	RT	COMMERCIAL	BITUMINOUS	40	3	0.004	0.47
+95	RT	PRIVATE	GRAVEL	20	3	0.002	0.23
+29	RT	PRIVATE	GRAVEL	21	3	0.002	0.25
+08	RT		BITUMINOUS	45	3	0.005	0.53
+08	RT		GRAVEL	16	3	0.002	0.19
+81	RT		CONCRETE	30	3	0.003	0.35
+86 +67	RT RT	COMMERCIAL COMMERCIAL	CONCRETE	59 200	3	0.006	0.69
	RT	COMMERCIAL	CONCRETE	46	3	0.005	0.54
+29	1.51	2 0EI (01/1E	55.15NETE		~	0.000	
+29							

ANTITIES		F.A.I. RTE.	SECTION	COUNTY	TOTAL SHEETS	SHEET NO.
		VAR.	VARIOUS	ST. CLAIR	18	8
				CONTRACT	NO. 7	6G42
STA.	TO STA.	FED. RC	DAD DIST. NO. 8 ILLINOIS FED. AI	ID PROJECT		


		PATC			
			PAVEMENT PATCHING,	PAVEMENT PATCHING,	PAVEMENT PATCHING,
	LENGTH	WIDTH		TYPE III, 10 INCH	
LOCATION	(FOOT)	(FOOT)	SQ YD	SQ YD	SQ YD
RAMP "T"	-				
13+30	35	8			31.1
13+44	60	8			53.3
14+20, LT.	6	8	5.3		
14+20, RT.	6	8	5.3		
ROADWAY "H"					
95+56, LT.	6	8	5.3		
95+56, RT.	6	8	5.3		
102+87	35	7.5			29.2
RAMP "T" / RO	DADWAY "H"	SUBTOTAL	21.3		113.6
ANTIC	IPATED FAIL	JRES (15%)	3.2		17.0
RAMP "T	' / ROADWAY	"H" TOTAL	25		131
CAMP JACKSON	ROAD / IL RO	UTE 157 (LC	UISE TO BRIDGE		
150+90, LT.	15	12		20.0	
150+90, RT.	15	12		20.0	
161+27	30	6		20.0	
162+61, LT.	15	12		20.0	
162+61, RT.	15	12		20.0	
167+29	75	6			50.0
167+56	20	14			31.1
"LOUISE	TO BRIDGE''	SUBTOTAL		100.0	81.1
				15.0	12.2
					94
	JISE TO BRID		NTHIA TO LENOR	115	94
		· · ·	NTHIA TO LENOR	(A)	00.7
182+74 182+84	50	12			66.7 93.3
188+59	70 30	12 12			40.0
197+64 200+51	40 30	12 6		20.0	53.3
200+51 203+44, LT.	12	12		16.0	
203+44, LT. 203+44, RT.	12	12		16.0	
203+44, KT. 203+75	50	6		10.0	33.3
207+78	40	13			57.8
207+92	12	13		17.3	57.0
	FO LENORA''			69.3	344.4
	IPATED FAIL			10.4	51.7
"CYNT	HIA TO LENC	RA" TOTAL		80	397
		TOTAL	25	195	622


			PAVEMENT MAR	KING SCHEDULE				
	ТҮРЕ		RAISED REFLECTIVE PAVEMENT MARKERS					
LOCATION		LETTERS & SYMBOLS	4''	LINE	8" LINE	12" LINE	TWO WAY AMBER	WHITE OPAQUE
		SQ FT	WHITE (FT)	YELLOW (FT)	WHITE (FT)	YELLOW (FT)	EA	EA
RAMP "T"				-				
12+26 TO 19+40	SKIP DASH				48			
(SEE PLAN SHEET)	SINGLE SOLID		764		84			10
ROADWAY "H"								
89+96 TO 103+05	SKIP DASH				87			
(SEE PLAN SHEET)	SINGLE SOLID		1,308	543	417			19
DAMD IIT	//ROADWAY "H" TOTAL		0.070	5.40				
			2,072	543	636			29
CAMP JACKSON ROAD / IL R	· · · · · · · · · · · · · · · · · · ·	RIDGE)						
142+72 TO 168+36	SKIP DASH		10	1,189			128	
(SEE PLAN SHEET)	SINGLE SOLID		5,114	4,754				
	DOUBLE SOLID			746				
	DIAGONAL					42		
	LETTERS & SYMBOLS	210						
"LOU	ISE TO BRIDGE" TOTAL	210	5.124	6.689		42	128	
CAMP JACKSON ROAD / IL R	OUTE 157 (CYNTHIA TO		.,	.,,,,,,,,,,,,,,,,,,,,,,,,,,,,,,,,,,,,,,	1			
182+49 TO 207+98	SKIP DASH	·		589			41	
(SEE PLAN SHEET)	SINGLE SOLID		5,100	497				
	DOUBLE SOLID			472				
"OVNTH	IIA TO LENORA" TOTAL		5,100	1,558			41	
CINI	TOTALS	210	12,296	8,790	636	42	169	29


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4:31 4:31	MODEL NAME = Default PLOT SCALE = 20.0000 '/ in.	CHECKED - JAH	REVISED - REVISED -	DEPARTMENT OF TRANSPORTATION				VAR.	VARIOUS	ST. CLAIR	
200 200 200	PLOT DATE = 10/30/2013	DATE - 10/29/13	REVISED -	SC		SHEET NO. 2 OF 2 SHEETS STA.	TO STA.	FED. ROAD DIST. NO. 8 ILLINOIS FED. AID PROJECT			

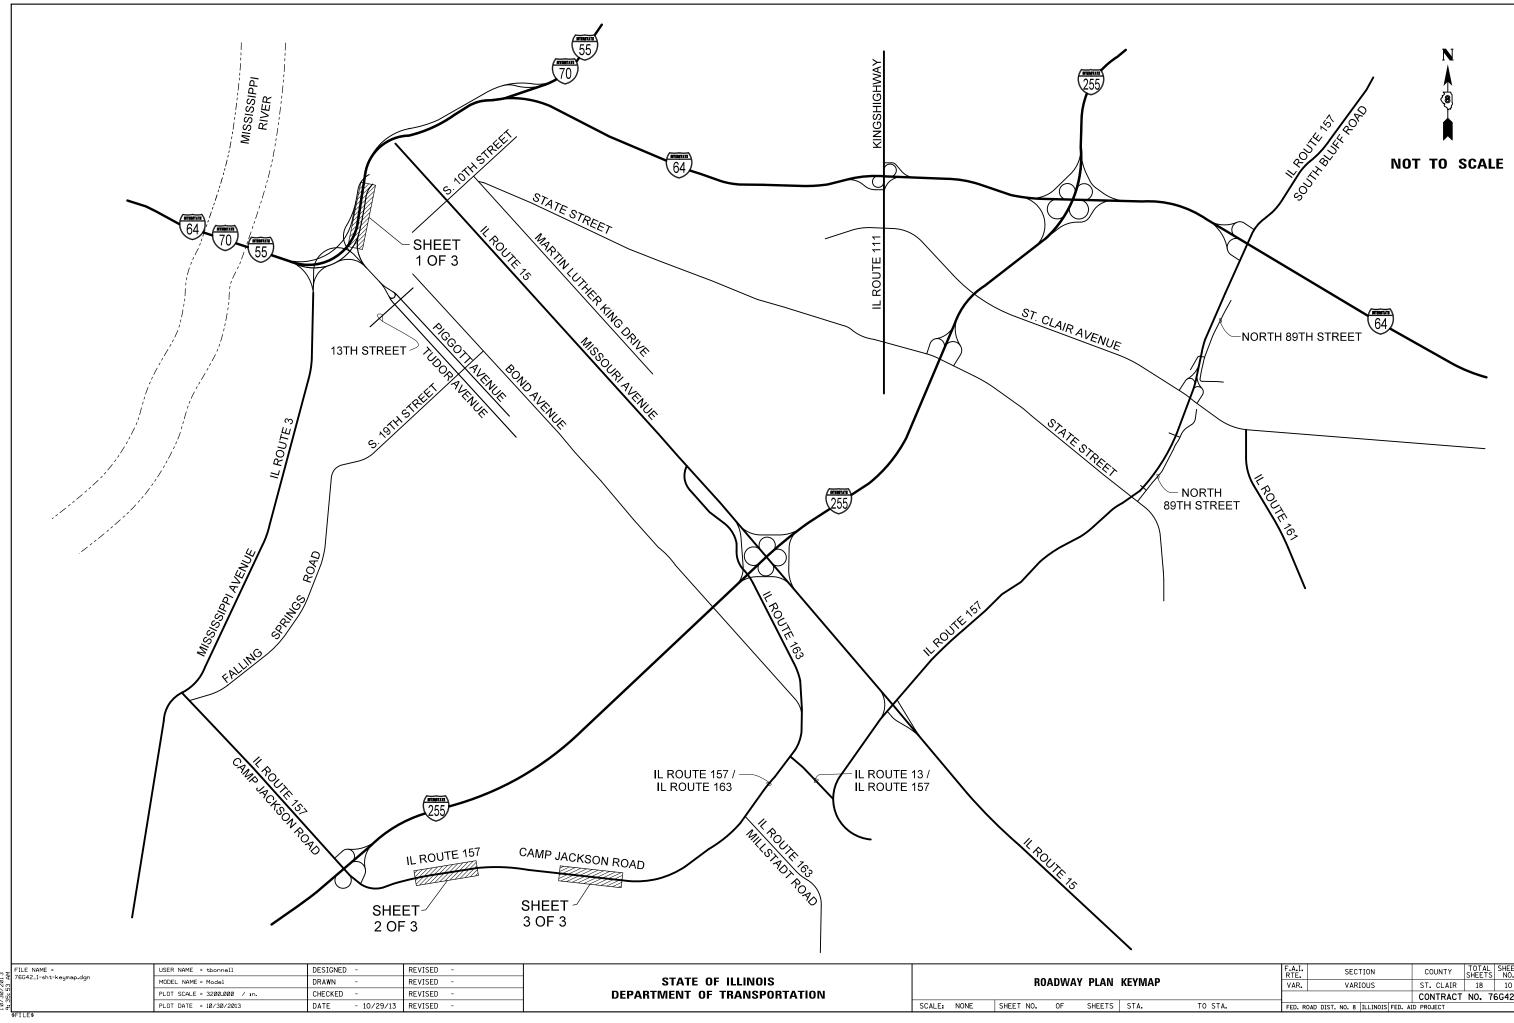



КЕҮМАР			SECTION	COUNTY	TOTAL SHEETS	SHEET NO.					
			VARIOUS	ST. CLAIR	18	10					
				CONTRACT	NO. 7	6G42					
STA.	TO STA.	FED. RO	FED. ROAD DIST. NO. 8 ILLINOIS FED. AID PROJECT								

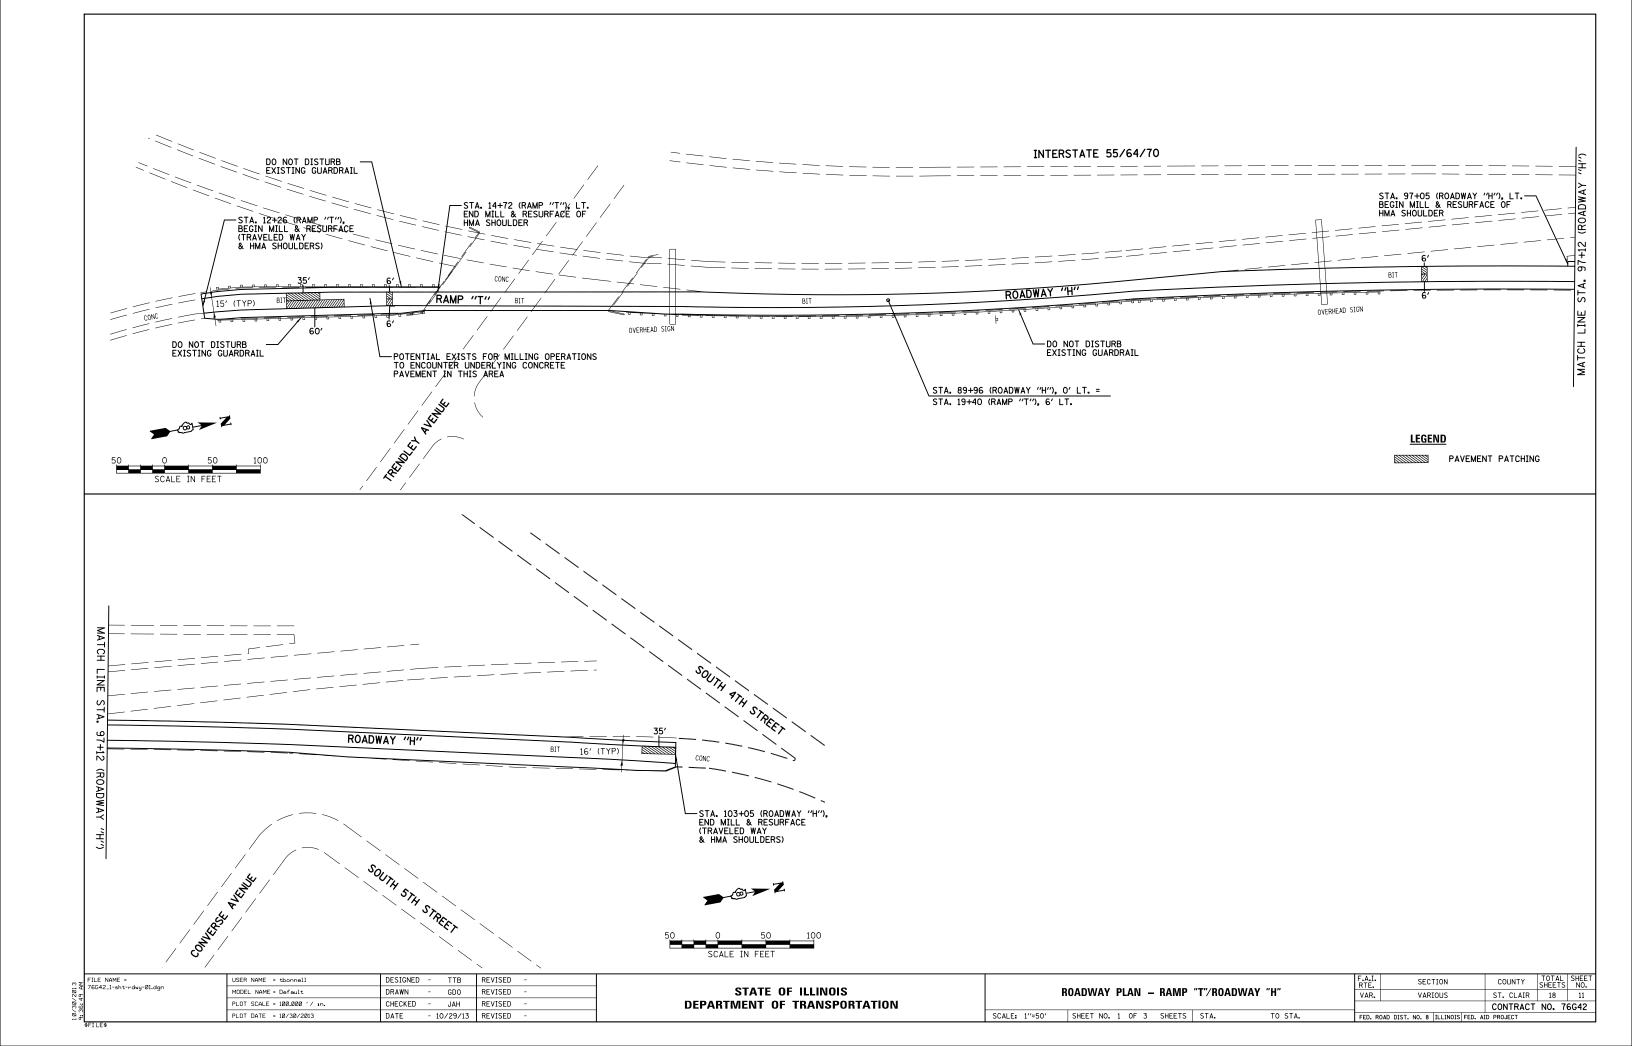


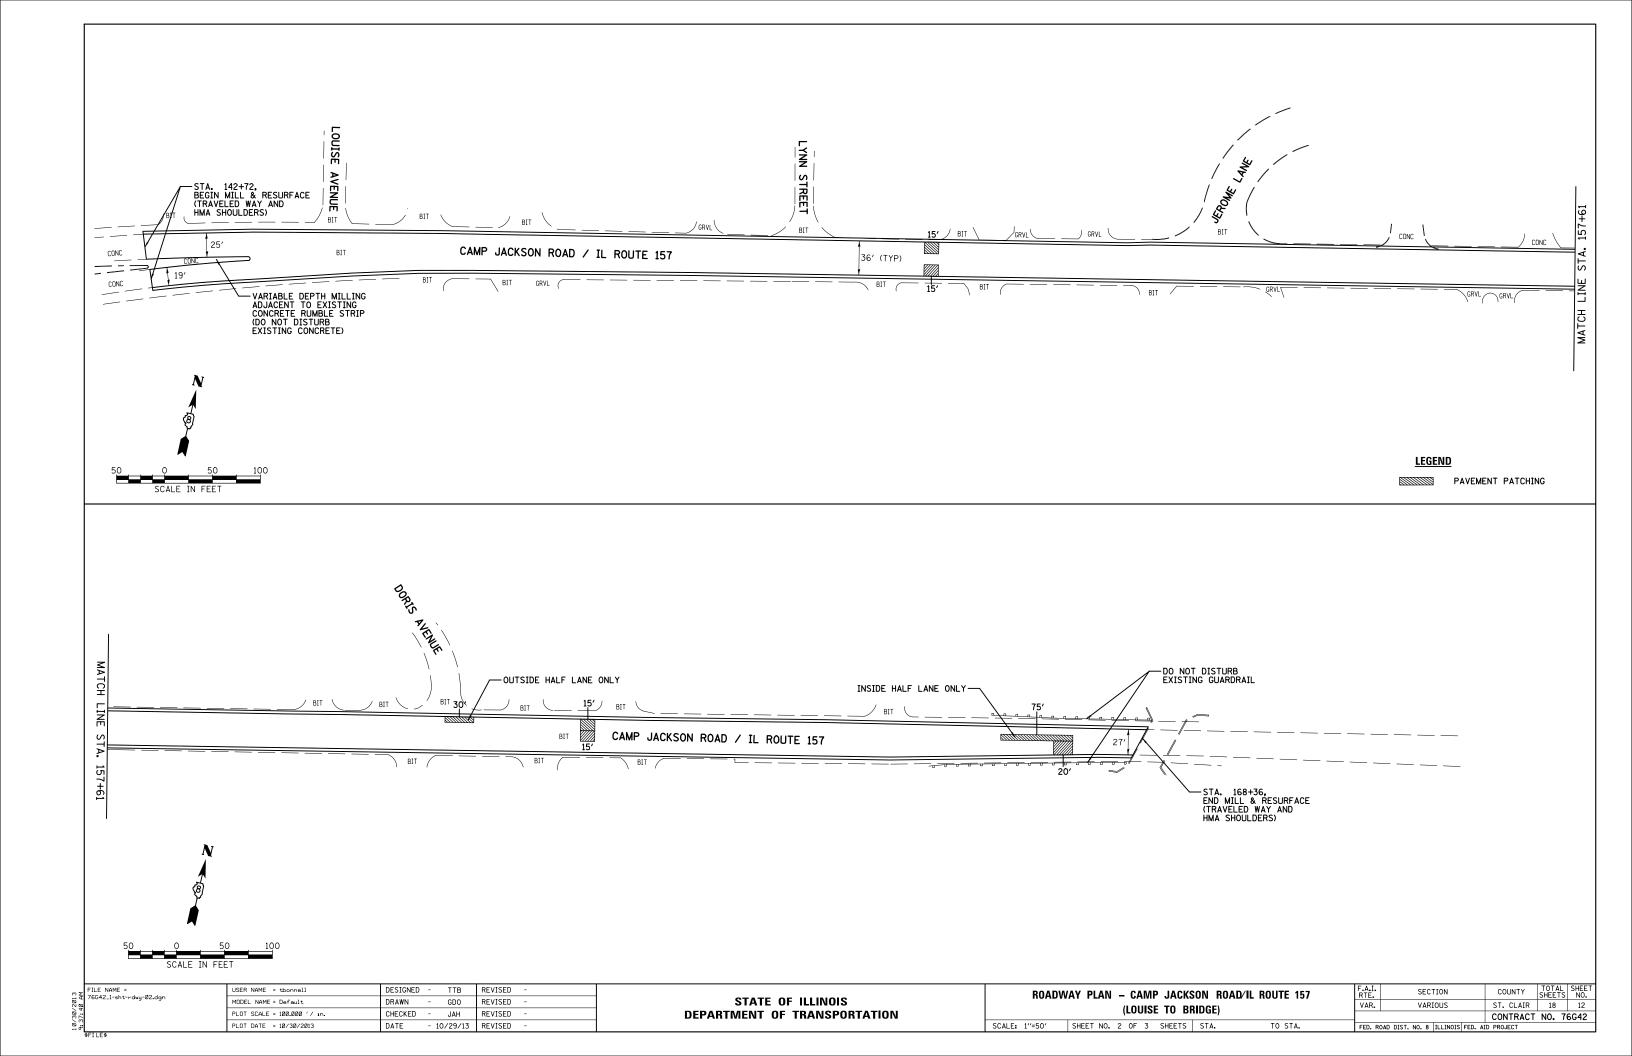


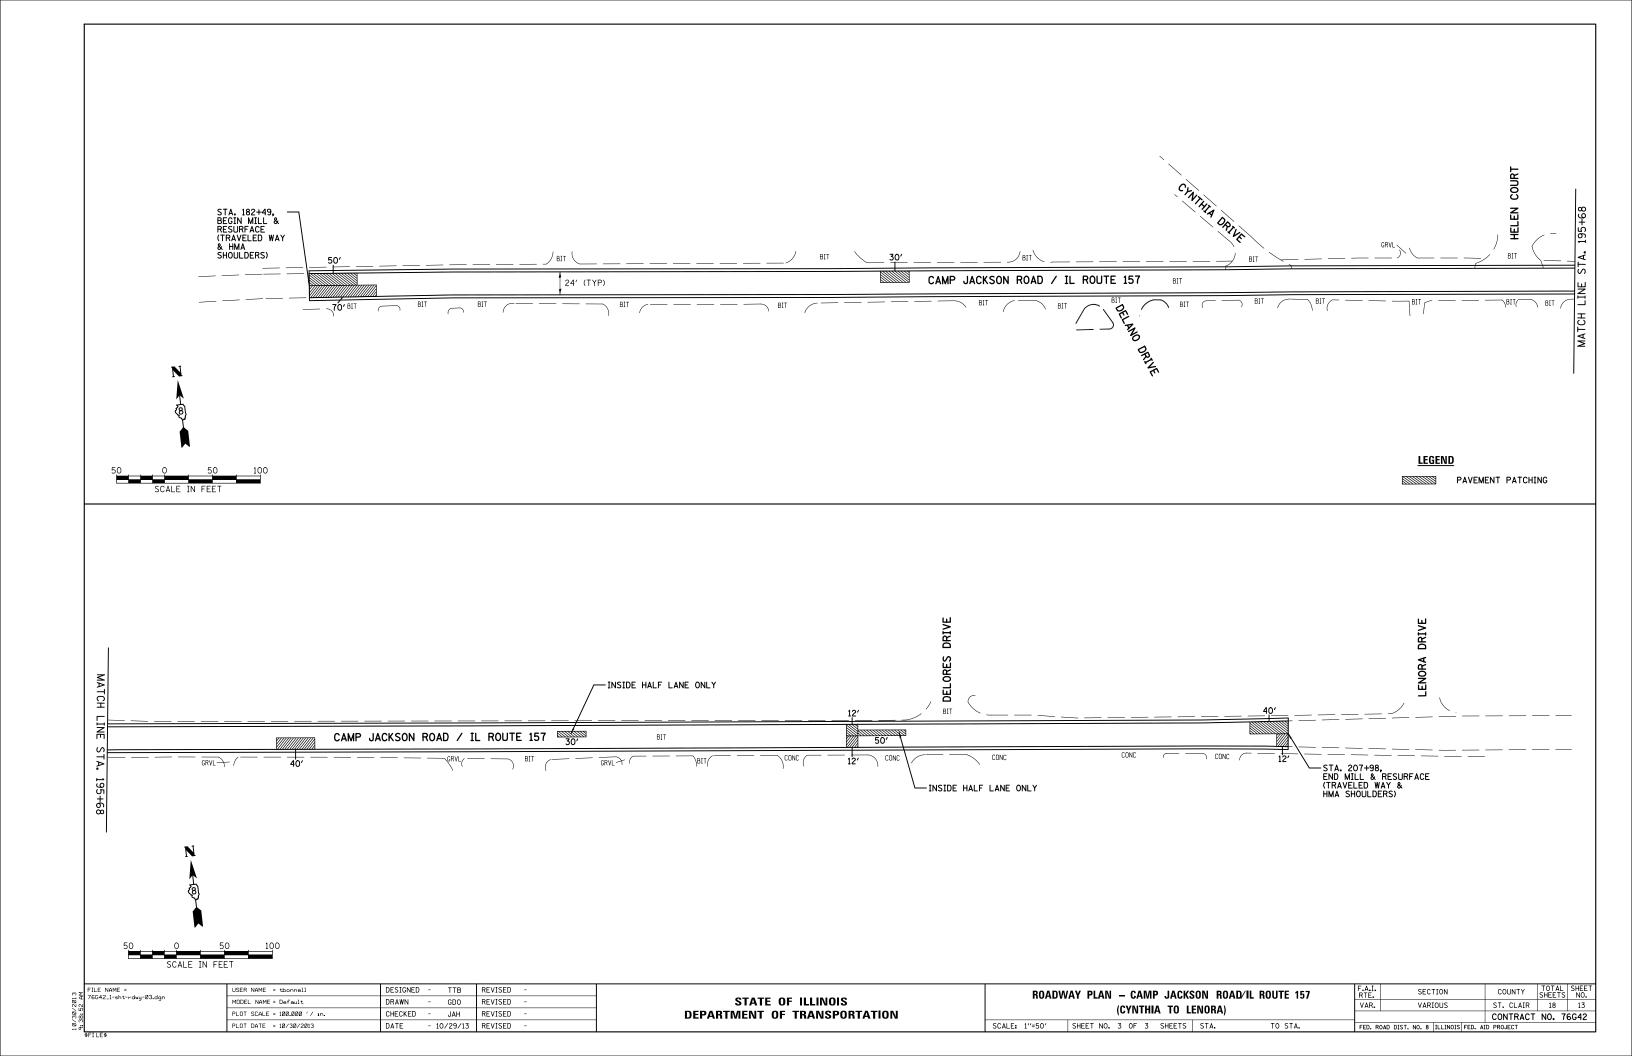

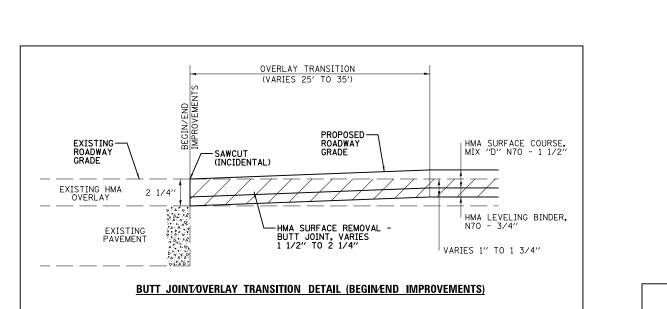


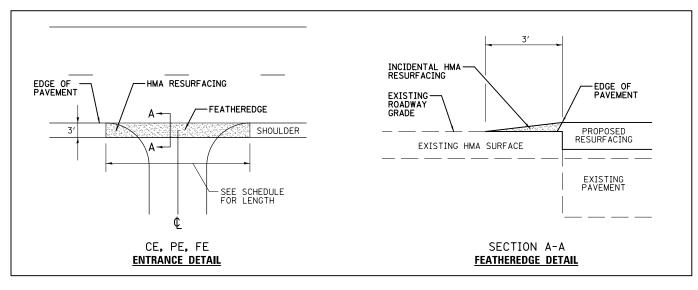

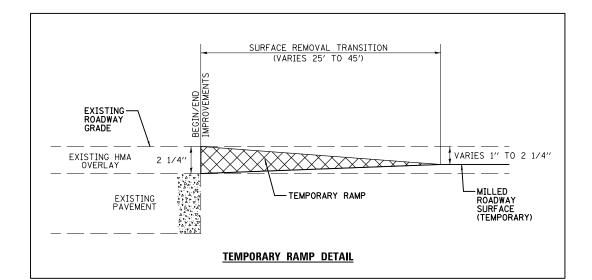


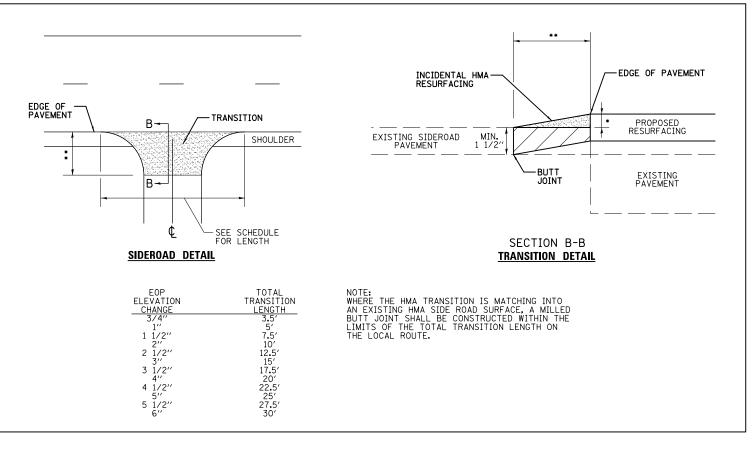


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201	t 76G42_1-sht-GEN-DETAIL.dgn α	MODEL NAME = Default	DRAWN -	REVISED -	STATE OF ILLINOIS		GENERAL DETAILS	VAR.	VARIOUS	ST. CLAI	18 14	÷	
196	5) 5	PLOT SCALE = 100.000 '/ in.	CHECKED -	REVISED -	DEPARTMENT OF TRANSPORTATION							T NO. 76G42	2
10/	۳ ۲	PLOT DATE = 10/30/2013	DATE - 10/29/1	.3 REVISED -		SCALE: NONE	SHEET NO. 1 OF 1 SHEETS S	TA. TO STA.	FED. ROAD D	IST. NO. 8 ILLINOIS FED.			_
	\$FILE\$												_

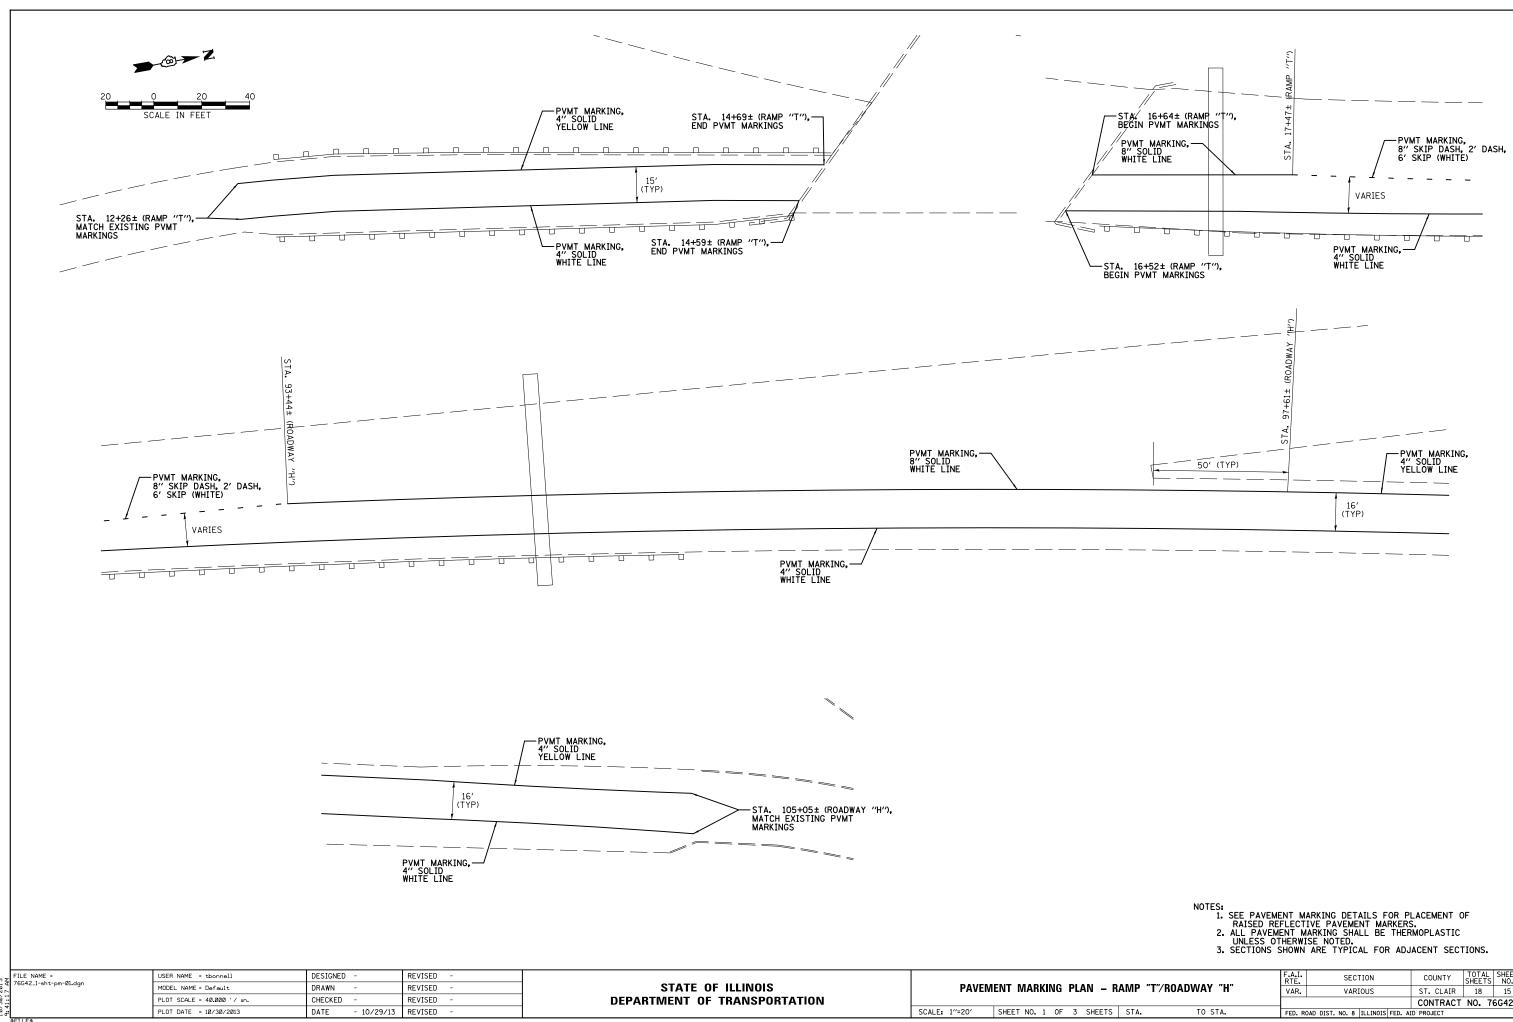

AMP "T"/ROADWAY "H"		F.A.I RTE					CC	DUNTY		TOTAL SHEETS	SHEET NO.			
		VAR. VARIOUS			ST.	CLAIR		18	15	1				
									CO	NTRAC	Т	NO. 7	6G42	1
STA.	TO STA.	FED.	R0/	AD DIST.	NO. 8	ILLIN	OIS FE	D. AI	D PRO	JECT				1
														-

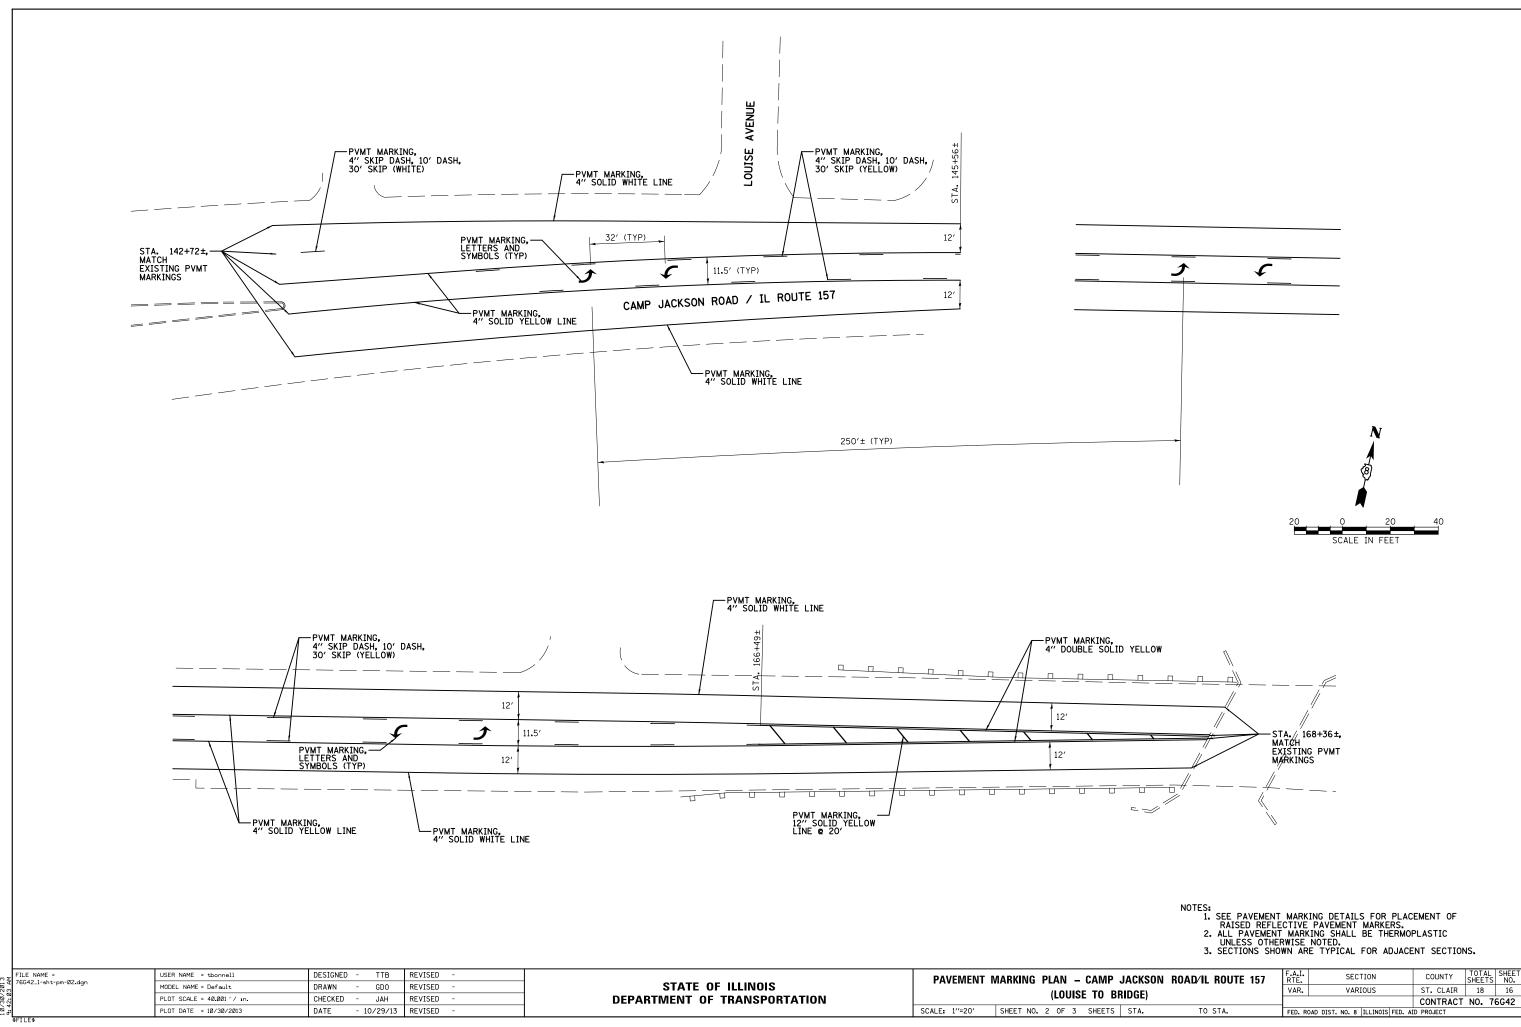


ACKSON	ROAD/IL ROUTE 157	RTE.	SECTION	COUNTY	SHEETS	NO.
DGE)		VAR.	VARIOUS	ST. CLAIR	18	16
				CONTRACT	NO. 7	6G42
STA.	TO STA.	FED, F	OAD DIST. NO. 8 ILLINOIS FED. A	ID PROJECT		

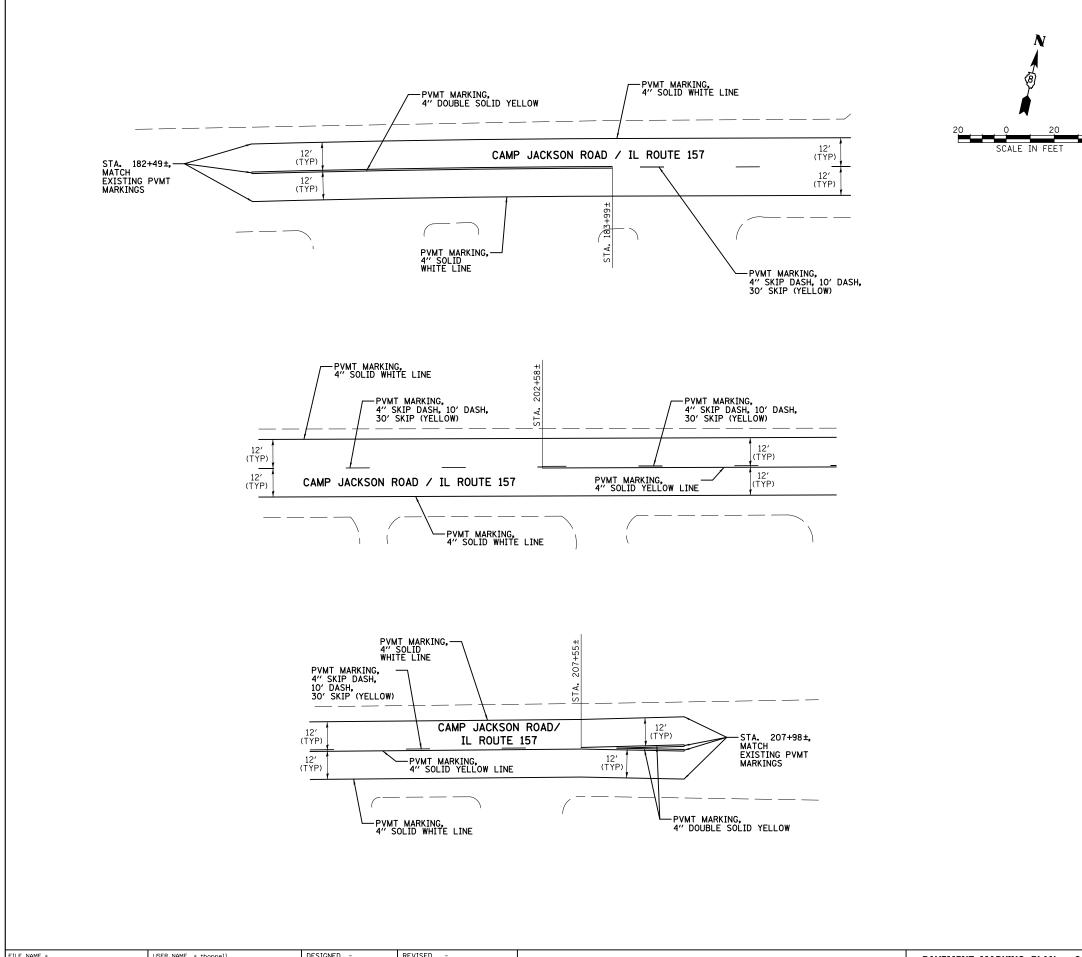

FILE NAME =	USER NAME = tbonnell	DESIGNED -	REVISED -	STATE OF ILLINOIS PAVEMENT MARK DEPARTMENT OF TRANSPORTATION	PAVEMENT MARKING PLAN – CAMP JACKSON ROAD/IL ROUTE 157					COUNTY TOTAL SHEET
2 ₹ 76G42_1-sht-pm-03.dgn	MODEL NAME = Default	DRAWN -	REVISED -		(CYNTHIA TO LENORA)			VARIOUS	ST. CLAIR 18 17	
PLOT SCALE = 40.000 // In.         CHECKED         -         REVISED         -           PLOT DATE = 10/30/2013         DATE         - 10/29/13         REVISED         -	PLOT SCALE = 40.000 ' / in.	CHECKED -	REVISED -						CONTRACT NO. 76G42	
	REVISED -		SCALE: 1''=20'	SHEET NO. 3 OF 3 SHEETS STA. TO STA.	FED. ROAD	DIST. NO. 8 ILLINOIS FED.	AID PROJECT			
\$FILE\$										

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- NOTES: 1. SEE PAVEMENT MARKING DETAILS FOR PLACEMENT OF RAISED REFLECTIVE PAVEMENT MARKERS. 2. ALL PAVEMENT MARKING SHALL BE THERMOPLASTIC UNLESS OTHERWISE NOTED. 3. SECTIONS SHOWN ARE TYPICAL FOR ADJACENT SECTIONS.

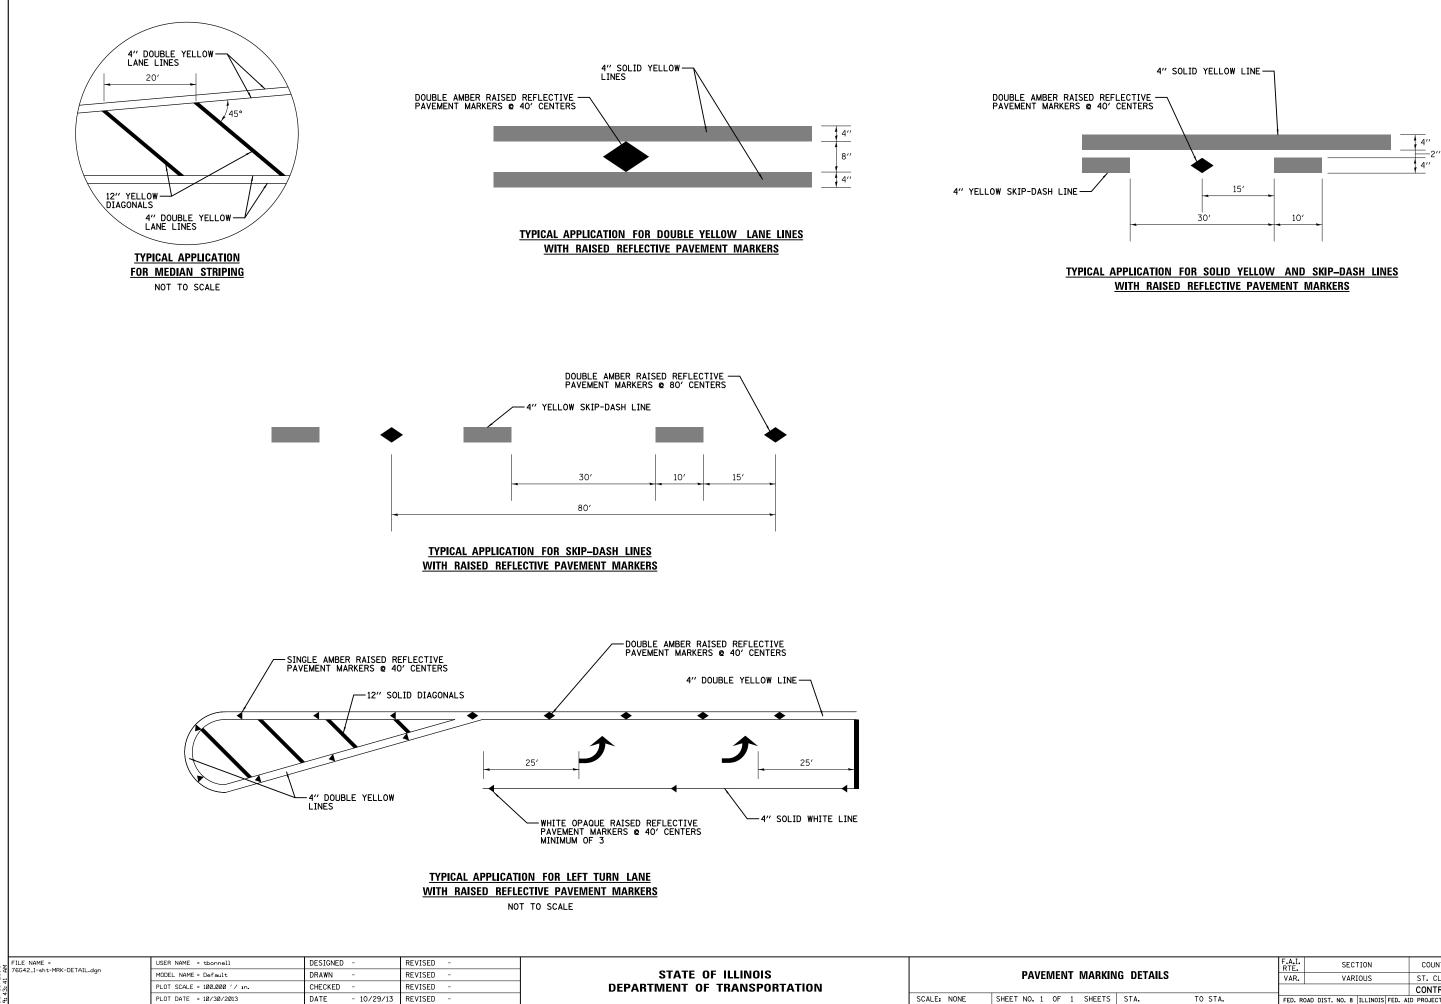

		F.A.I. RTE.	SECTION	COUNTY	TOTAL SHEETS	SHEET NO.
G DETAILS			VARIOUS	ST. CLAIR	18	18
				CONTRACT	NO. 7	6G42
STA.	TO STA.	FED. RC	AD DIST. NO. 8 ILLINOIS FED. AI	D PROJECT		