0

01-17-2025 LETTING ITEM 094

### **STATE OF ILLINOIS DEPARTMENT OF TRANSPORTATION**

MCHENRY 0079 24-00013-00-RS FED. ROAD DIST, NO 1 CONTRACT NO. 61L00

FOR INDEX OF SHEETS, SEE SHEET NO. 2 FOR HIGHWAY STANDARDS, SEE SHEET NO. 2

**W WONDER LAKE ROAD - MINOR COLLECTOR** 

TRAFFIC DATA ADT:

**2023 TRAFFIC** 625 VPD

**W WONDER LAKE ROAD** 

**DESIGN DESIGNATION** 

W WONDER LAKE ROAD


**SPEED LIMIT 45 MPH** 

**45 MPH** 

**DESIGN SPEED** 


# PLAN FOR PROPOSED FEDERAL AID HIGHWAY TR 0079 (W WONDER LAKE ROAD)

FROM THOMPSON ROAD TO WHITE OAKS ROAD **ROAD RESURFACING IMPROVEMENTS SECTION 24-00013-00-RS** PROJECT 5QVP (130) **MCHENRY COUNTY** C-91-040-25

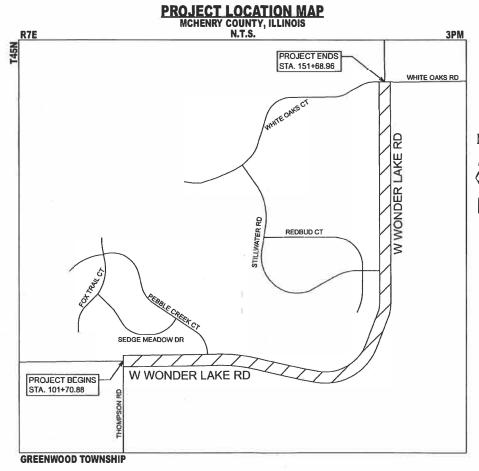

PROJECT LENGTH **GROSS LENGTH = 4998 FT. = 0.947 MILE NET LENGTH = 4998 FT. = 0.947 MILE** 



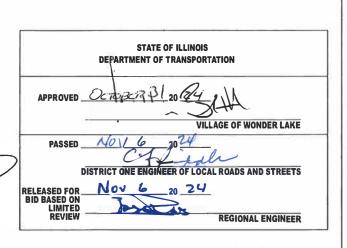

STRZALKA

PRINTED BY THE AUTHORITY OF THE STATE OF ILLINOIS

**ENGINEERING SCALES. REDUCED SIZED PLANS WILL NOT** CONFORM TO STANDARD SCALES. IN MAKING MEASUREMENTS ON REDUCED PLANS, THE ABOVE SCALES MAY BE USED.

J.U.L.I.E.

 $\bigcirc$ 

JOINT UTILITY LOCATION INFORMATION FOR EXCAVATION 1-800-892-0123

**PROJECT ENGINEER: B. BELGRAVE PROJECT MANAGER: J. STRZALKA** 

**CONTRACT NO. 61L00** 

#### **INDEX OF SHEETS**

COVER SHEET

INDEX OF SHEETS, STATE STANDARDS, DISTRICT ONE DETAILS AND GENERAL NOTES

SUMMARY OF QUANTITIES

6 - 7 TYPICAL SECTIONS

RESURFACING PLAN

10 - 12 CONSTRUCTION DETAIL

IDOT DISTRICT 1 DETAILS

#### **DISTRICT ONE DETAILS**

STANDARD NO.	LIST OF DESCRIPTION
BD-24	CURB OR CURB AND GUTTER REMOVAL AND REPLACEMENT
BD-32	BUTT JOINT AND HMA TAPER DETAIL
TC-10	TRAFFIC CONTROL AND PROTECTION FOR
	SIDE ROADS, INTERSECTIONS, AND DRIVEWAYS
TC-13	DISTRICT ONE TYPICAL PAVEMENT MARKINGS
TC-16	SHORT TERM PAVEDMENT MARKING LETTERS AND SYMBOLS
TC-22	ARTERIAL ROAD INFORMATION SIGN

#### **STATE STANDARDS**

STANDARD NO.	LIST OF DESCRIPTION
000001-08	STANDARD SYMBOLS, ABBREVIATIONS AND PATTERNS
424001-12	PERPENDICULAR CURB RAMPS FOR SIDEWALKS
424021-07	DEPRESSED CORNER FOR SIDEWALKS
442201-03	CLASS C&D PATCHES
604051-04	FRAME AND GRATE TYPE 11
606001-08	CONCRETE CURB TYPE B AND COMBINATION CONCRETE CURB AND GUTTER
701001-02	OFF-RD OPERATIONS, 2L, 2W, MORE THAN 15'
701201-05	LANE CLOSURE, 2L, 2W, DAY ONLY, 45MPH OR MORE
701301-04	LANE CLOSURE, 2L, 2W, SHORT TIME OPERATIONS
701306-04	LANE CLOSURE, 2L, 2W, SLOW MOVING OPERATIONS, DAY ONLY, 45MPH OR MORE
701311-03	LANE CLOSURE, 2L, 2W, MOVING OPERATIONS, DAY ONLY
701701-10	URBAN LANE CLOSURE MULTILANE INTERSECTION
701801-06	SIDEWALK, CORNER OR CROSSWALK CLOSURE
701901-10	TRAFFIC CONTROL DEVICES
781001-04	TYPICAL APPLICATIONS RAISED REFLECTIVE PAVEMENT MARKERS

#### **GENERAL NOTES**

- 1. ALL REFERENCES TO STANDARD SPECIFICATIONS IN THESE GENERAL NOTES SHALL BE INTERPRETED TO MEAN THE "STANDARD SPECIFICATIONS FOR ROAD AND BRIDGE CONSTRUCTION" ADOPTED BY THE ILLINOIS DEPARTMENT OF TRANSPORTATION, JANUARY 1, 2022, ALL WORK TO BE COMPLETED IN ACCORDANCE WITH THE STANDARD SPECIFICATIONS, AND THE SUPPLEMENTAL SPECIFICATIONS AND RECURRING SPECIAL PROVISIONS ADOPTED JANUARY 1, 2025.
- 2. IT IS THE CONTRACTOR'S RESPONSIBILITY TO ASCERTAIN EXISTING FIELD CONDITIONS PRIOR TO BIDDING ON THE PROJECT.
- 3. BEFORE STARTING ANY EXCAVATION, THE CONTRACTOR SHALL CALL "JULIE" (JOINT UTILITY LOCATION INFORMATION FOR EXCAVATION) AT (800) 892-0123 FOR FIELD LOCATIONS OF BURIED UTILITIES (48 HOURS NOTIFICATION IS REQUIRED).
- 4. THE CONTRACTOR WILL NOT BE ALLOWED TO SET UP A YARD OR FIELD OFFICE ON MUNICIPAL PROPERTY WITHOUT WRITTEN PERMISSION FROM THE ENGINEER
- 5. THE CONTRACTOR SHALL BE RESPONSIBLE FOR SWEEPING AND CLEANING STREETS OF ANY DEBRIS AND MATERIAL THAT HAS ACCUMULATED AS A RESULT OF THE CONSTRUCTION ACTIVITY, A MECHANICAL SWEEPER, MECHANICALLY DRIVEN AIR AND HANDWORK WITH SHOVEL AND BROOM SHALL BE UTILIZED TO PROVIDE A CLEAN STREET FOR THE MOTORING PUBLIC. WITHIN 24  $\hbox{HOURS OF PLACING PRIME COAT AND THE LAYING OF HMA, THE CONTRACTOR SHALL SWEEP THE PAVEMENT AND REMOVE \\$ STANDING WATER, EARTH, WEEDS, LEAVES, DIRT, CONSTRUCTION DEBRIS, AND ALL LOOSE MATERIAL.
- 6. THE CONTRACTOR SHALL PROVIDE POSITIVE DRAINAGE AND TEMPORARY DRAINAGE OUTLETS WITHIN THE WORK ZONE AT ALL TIMES, SHOULD ANY EXCAVATED AREA BECOME INUDATED WITH WATER DURING CONSTRUCTION, THE CONTRACTOR WILL BE REQUIRED TO REMOVE AND REPLACE AND LAYERS OF THE WORK ZONE IMPACTED. IMPACTED AREAS REQUIRING REMEDIATION WILL BE DETERMINED AT THE SOLE DISCRETION OF THE ENGINEER.
- 7. ABANDONED UNDERGROUND UTILITIES THAT CONFLICT WITH CONSTRUCTION SHALL BE DISPOSED OF OUTSIDE VILLAGE PROPERTY ACCORDING TO ARTICLE 202.03 OF THE STANDARD SPECIFICATIONS AND AS DIRECTED BY THE ENGINEER.
- 8. PER VILLAGE ORDINANCE 15.08, NO CONSTRUCTION WORK REQUIRING THE USE OF POWER TOOLS OR POWER MACHINERY OF ANY KIND SHALL BE UNDERTAKEN BEFORE 7:00 A.M. OR AFTER 8:00 P.M., MONDAY THROUGH FRIDAY, AND BEFORE 8:00 A.M. OR AFTER 8:00 P.M., SATURDAY AND SUNDAY.
- 9. PHOSPHORUS FERTILIZER HAS BEEN INTENTIONALLY OMITTED FROM THE CONTRACT DUE TO PROXIMITY OF EXISTING WETLANDS/BODIES OF WATER A PHOSPHORUS-FREE FERTILIZER SHALL BE USED (MIDDLE NUMBER SHOULD EQUAL 0).
- 10. THE CONTRACTOR SHALL DELIVER 80 TONS OF MILLINGS TO THE VILLAGE PUBLIC WORKS FACILITY AT 4200 THOMPSON ROAD PUBLIC WORKS CREWS WILL SPREAD AND STOCKPILE THE DUMPED MATERIALS.
- 11. CONTRACTOR SHALL TAKE PRECAUTION BY PRESERVING EXISTING TREES WITHIN THE RIGHT OF WAY. IF ANY DAMAGE OCCURS, TREES SHALL BE REPLACED IN KIND PER ARTICLE 201.07 REPAIR OR REPLACEMENT OF EXISTING PLANT MATERIAL REQUIREMENTS STATED HEREIN.

#### UTILITIES

- 1. THE CONTRACTOR SHALL BE RESPONSIBLE FOR CONTACTING THE OWNERS OF ALL UTILITIES PRIOR TO CONSTRUCTION TO DETERMINE THE LOCATION OF ALL UTILITY EQUIPMENT. THE CONTRACTOR SHALL COOPERATE WITH ALL UTILITY OWNERS IN ACCORDANCE WITH THE STANDARD SPECIFICATIONS IF UTILITY RELOCATION, ADJUSTMENT, OR PROTECTION IS NECESSARY.
- 2. THE CONTRACTOR SHALL BE RESPONSIBLE FOR THE PROTECTION OF ALL UNDERGROUND AND SURFACE UTILITIES EVEN THOUGH THEY MIGHT NOT BE SHOWN ON THE PLANS. ANY UTILITY PROPERTY DAMAGED DURING CONSTRUCTION SHALL BE REPAIRED OR REPLACED TO THE SATISFACTION OF THE OWNER.

- 3. THE CONTRACTOR SHALL USE ALL NECESSARY PRECAUTIONS AND PROTECTION MEASURES REQUIRED TO MAINTAIN EXISTING UTILITIES, SEWERS, AND APPURTENANCES THAT MUST BE KEPT IN OPERATION.
- 4. ANY LOOSE MATERIAL DEPOSITED IN THE FLOWLINE OF CULVERTS OR DITCHES, WHICH OBSTRUCTS THE NATURAL FLOW OF WATER SHALL BE REMOVED AT THE CLOSE OF EACH WORKING DAY. PRIOR TO ACCEPTANCE OF THE IMPROVEMENT, ALL DRAINAGE APPURTENANCES SHALL BE FREE OF DIRT AND DEBRIS.
- 5. THE INDISCRIMINATE USE OF FIRE HYDRANTS OR EXISTING STREAMS, CREEKS, WETLANDS OR PONDS IS STRICTLY PROHIBITED. THE CONTRACTOR SHALL PROVIDE A WATER TRUCK AND DRIVER AS REQUIRED TO OBTAIN AND TRANSPORT THIS WATER. THE CONTRACTOR SHALL BE RESPONSIBLE FOR OBTAINING THIS WATER FROM AN APPROVED SOURCE. IF THIS WATER IS FROM A SOURCE OTHER THAN HIS YARD, WRITTEN APPROVAL FROM THE AGENCY HAVING JURISDICTION FOR THE SOURCE OF THE WATER MUST BE RECEIVED BY THE ENGIEER PRIOR TO USE OF THE WATER.

#### PAVING

- 1. LONGITUNDINAL CONSTRUCTION JOINTS WILL NOT BE PERMITTED.
- 2. TRANSVERSE CONSTRUCTION JOINTS WILL BE ALLOWED DURING PAVING PROVIDED THE CONTRACTOR COMPLETE A SAWCUT AT LEAST SIX INCHES INTO THE ADJACENT MAT AT THE START OF PAVING THE FOLLOWING DAY.
- 3. CONSTRUCTION JOINTS THAT SIT OVERNIGHT WILL REQUIRE CRACK ROUTING AND SEALING UPON COMPLETION OF SURFACE COURSE CONSTRUCTION, JOINT SEALANT SHALL MEET THE REQUIREMENTS OF ARTICLE 1050,02 OF THE STANDARD SPECIFICATIONS

#### SIGNING AND STRIPING

- 1. SIGNS SHALL NOT BE MOVED OR COVERED UNTIL PROGRESS OF WORK NECESSITATES IT.
- 2. THE CONTRACTOR WILL BE REQUIRED TO TEMPORARILY RESET ALL SUCH SIGNS THAT INTERFERE WITH HIS CONSTRUCTION OPERATIONS, ALL SUCH SIGNS MUST BE MAINTAINED STRAIGHT AND CLEAN FOR THE DURATION OF THE TEMPORARY SETTING AND MUST BE RE-ERECTED AT A TEMPORARY LOCATION IN A WORKMANLIKE MANNER AND BE VISIBLE TO THE TRAFFIC FOR WHICH IT IS INTENDED.
- 3. SEE IDOT DISTRICT ONE DETAILS AND PLAN SHEETS FOR PAVEMENT MARKING DETAILS.
- 4. GRINDING OF PAVEMENT MARKINGS ON NEWLY CONSTRUCTED HOT-MIX ASPHALT PAVEMENT WILL NOT BE PERMITTED.
- 5. THE CONTRACTOR SHALL BE RESPONSIBLE FOR POSTING 'FRESH OIL' SIGNS (48"X48" MINIMUM) AS NEEDED FOR THE PROJECT. THE CONTRACTOR SHALL INSTALL AND MAINTAIN TEMPORARY SIGNS IN THE PARKWAY TWENTY-FOUR (24) HOURS PRIOR TO STARTING WORK, THE CONTRACTOR SHALL REMOVE THE SIGNS AND REINSTALL THEMAS NEEDED.
- 6. IN ACCORDANCE WITH THE IDOT DROP OFF POLICY AT INSTANCES IN WHICH THERE IS A GREATER THAN 1.5 INCH HEIGHT DIFFERENCE IN VERTICAL MILLED FACE, OR WHEN THERE IS A GREATER THAN 2.5 INCH LIFT DIFFERENCE, UNEVEN LANE SIGNS (W8-11) WILL BE REQUIRED

#### CONSTRUCTION LAYOUT

NONE

COMMITMENTS

SCALE:

sht-quantities.dgn	
hta\2022\2202827\CAD\Sheets\2202827.01	
:om\hrg\Dat	

				CONSTRUCTION CODE
CODE NO .	ITEM	UNIT	TOTAL QUANT I TY	STU 80% FEDERAL 20% STATE 0005
20101100	TREE TRUNK PROTECTION	EACH	1	1
21101615	TOPSOIL FURNISH AND PLACE, 4"	SQ YD	84	84
25000210	SEEDING, CLASS 2A	ACRE	0.25	0.25
25100630	EROSION CONTROL BLANKET	SQ YD	148	148
	Eliosisti Collinos Servines	34 15	140	140
28000400	PERIMETER EROSION BARRIER	FOOT	125	125
35101600	AGGREGATE BASE COURSE, TYPE B 4"	SQ YD	301	301
40600290	BITUMINOUS MATERIALS (TACK COAT)	POUND	14,396	14,396
40600370	LONGITUDINAL JOINT SEALANT	FOOT	10,826	10,826
40600400	WATURE FOR CRACKS, JOINTS, AND ELANGEWAYS	TON	15	15
40600400	MIXTURE FOR CRACKS, JOINTS, AND FLANGEWAYS	TON	15	15
40600982	HOT-MIX ASPHALT SURFACE REMOVAL - BUTT JOINT	SQ YD	131	131
40603200	POLYMERIZED HOT-MIX ASPHALT BINDER COURSE, IL-4.75, N50	TON	1,195	1,195
40604060	HOT-MIX ASPHALT SURFACE COURSE, IL-9.5, MIX "D", N50	TON	2,137	2,137
40800050	INCIDENTAL HOT-MIX ASPHALT SURFACING	TON	4	4
42400200	PORTLAND CEMENT CONCRETE CIDEWALK & INCL	CO. FT.	2 707	2.707
42400200	PORTLAND CEMENT CONCRETE SIDEWALK 5 INCH	SQ FT	2,707	2,707
42400800	DETECTABLE WARNINGS	SQ FT	387	387
44000159	HOT-MIX ASPHALT SURFACE REMOVAL, 2 1/2"	SQ YD	21,327	21,327
44000200	DRIVEWAY PAVEMENT REMOVAL	SQ YD	215	215
	SIDEWALK REMOVAL	SQ FT	ı I	2,707

\* SPECIALTY ITEM

HRGreen.	HRGreen.com Illinois Professional Design Firm # 184-001322

USER NAME = benjamin.belgrave DESIGNED -	JJS	REVISED -	XX/XX/XXXX
DRAWN -	BJB	REVISED -	XX/XX/XXXX
PLOT SCALE = 0.16666633 ' / in.		REVISED -	XX/XX/XXXX
PLOT DATE = 10/29/2024 DATE -		REVISED -	XX/XX/XXXX

STATE OF ILLINOIS	
DEPARTMENT OF TRANSPORTATION	

SCALE:

SUMMARY OF QUANTITIES WEST WONDER LAKE ROAD							
SHEET	1	OF	3	SHEETS	STA.	TO STA.	

\* SPECIALTY ITEM

CODE

HRGreen.com Illinois Professional Design Firm # 184-001322

USER NAME = benjamin belgrave	DESIGNED - JJS	REVISED - XX/XX/XXXX
	DRAWN - BJB	REVISED - XX/XX/XXXX
PLOT SCALE = 0.16666633 '/ln.	CHECKED -	REVISED - XX/XX/XXXX
PLOT DATE = 10/29/2024	DATE -	REVISED - XX/XX/XXXX

SCALE:

CONSTRUCTION CODE STU

\* SPECIALTY ITEM

HRGreen.com


USER NAME = benjamin.belgrave	DESIGNED - JJS	REVISED - XX/XX/XXXX
	DRAWN - BJB	REVISED - XX/XX/XXXX
PLOT SCALE = 0.16666633 ' / in.	CHECKED -	REVISED - XX/XX/XXXX
PLOT DATE = 10/29/2024	DATE -	REVISED - XX/XX/XXXX

STATE OF ILLINOIS	
DEPARTMENT OF TRANSPORTATION	

SCALE:

SUMMARY OF QUANTITIES							F.A.U. RTE.	SECTION
	WEST WONDER LAKE ROAD						0079	24-00013-00-RS
TIEUT TIONDEN EARE NOAD								
SHEET	3	OF	3	SHEETS	STA.	TO STA.		ILLINOIS

COUNTY MCHENRY 18 5 CONTRACT NO. 61L00

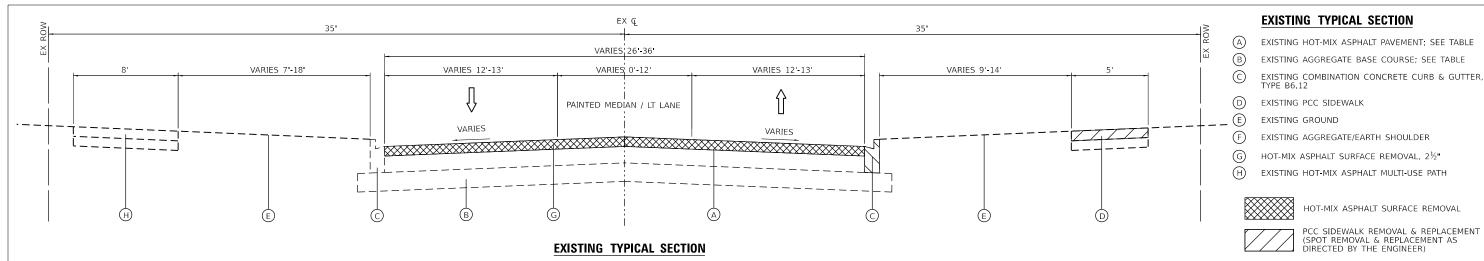

W WONDER LAKE RD (THOMPSON RD TO 650' SOUTH OF WHITE OAKS RD)

#### EX & PR Q 2 VARIES, 26'-36' 3 VARIES 7-18 VARIES 12'-13' VARIES 0'-12' VARIES 12'-13' VARIES 9'-14' PAINTED MEDIAN / LT LANE 1.5%-2.0% 1 5%-2.0%

#### PROPOSED TYPICAL SECTION

W WONDER LAKE RD (THOMPSON RD TO 650' SOUTH OF WHITE OAKS RD)

(B)

(A)

HOT-MIX ASPHALT MIXTURE REQUIREMENTS		
MIXTURE TYPE	AIR VOIDS	QMP
INCIDENTAL HMA SURFACING (DRIVEWAYS)		
HMA SURFACE COURSE, MIX "D", N50; (IL-9.5mm); 2"	4.0% @ 50 GYR.	LR 1030-2
HMA DRIVEWAY PAVEMENT 3"		
HMA SURFACE COURSE, MIX "D", N50; (IL-9.5mm); 3"	4.0% @ 50 GYR.	LR 1030-2
RESURFACING		
HMA SURFACE COURSE, MIX "D", IL-9.5, N50; 1 3/4"	4.0% @ 50 GYR.	LR 1030-2
POLYMERIZED HMA BINDER COURSE, IL-4.75, N50; 1"	3.5% @ 50 GYR.	LR 1030-2
PATCHING		
CLASS D PATCHES, 9" (HMA BINDER IL-19.0mm)	4.0% @ 70 GYR.	LR 1030-2
QMP DESIGNATION: QUALITY CONTROL/QUALITY ASSURANCE (QC/QA)	PER LR 1030-2	

THE UNIT WEIGHT TO CALCULATE ALL HMA SURFACE MIXTURE QUANTITIES IS 112 LBS/SQ YD/IN

THE "AC TYPE" FOR POLYMERIZED HMA MIXES SHALL BE "SBS/SBR PG 76-22" AND FOR NON-POLYMERIZED HMA THE "AC TYPE" SHALL BE "PG 64-22" UNLESS MODIFIED BY RECLAIMED MATERIAL SPECIFICATIONS.

PATCHING LOCATIONS TO BE DETERMINED BY THE ENGINEER AFTER MILLING OPERATIONS.

LONGITUDINAL JOINT SEALANT SHALL BE PLACED OVER THE POLY HMA BC IL-4.75 N50.

HRGreen.	HRGreen.com Illinois Professional Design Firm # 184-001322	
		ı

USER NAME = benjamin belgrave	DESIGNED - JJS	REVISED - XX/XX/XXXX
	DRAWN - BJB	REVISED - XX/XX/XXXX
PLOT SCALE = 0.16666633 ' / In.	CHECKED -	REVISED - XX/XX/XXXX
PLOT DATE = 10/29/2024	DATE -	REVISED - XX/XX/XXXX

STATE OF ILLINOIS	
DEPARTMENT OF TRANSPORTATION	

SCALE: N.T.S.

ı	EXISTING & PROPOSED TYPICAL SECTIONS WEST WONDER LAKE ROAD						F.A.U. RTE.	S	CTIC	N		COUNTY	TOTAL SHEETS	SHEET NO.			
								0079	24-00	013-0	0-RS		MCHENRY	18	6		
	HEST HONDER EARL ROAD												CONTRAC	T NO.	61L00		
	SHEET	1	OF	2	SHEETS	STA.		TO STA.				ILI	LINOIS	FED. AII	D PROJECT		

IL-9.5, N50; 1¾"

EXISTING PAVEMENT THICKNESS TABLE							
LOCATION	THICKNESS						
WEST WONDER LAKE ROAD	)						
НМА	±11"						
GRANULAR BASE	±6"-12"						

**EXISTING TYPICAL SECTION** 

HOT-MIX ASPHALT SURFACE REMOVAL, 2½"

NOTES: IT IS THE CONTRACTOR'S RESPONSIBILITY TO DETERMINE THE CURB AND GUTTER TYPE.

PATCHING LOCATIONS TO BE MARKED BY THE ENGINEER AFTER MILLING OPERATIONS.

HOT-MIX ASPHALT SURFACE COURSE, MIX 'D',

POLYMERIZED HOT-MIX ASPHALT BINDER COURSE, IL-4.75, N50; 1"

AGGREGATE SHOULDERS, TYPE B (9% MAX SLOPE) (CA-6 CRUSHED GRAVEL OR CRUSHED STONE)

PAVEMENT MARKING, LINE 4" (SEE RESURFACING PLAN)

PROPOSED TYPICAL SECTION


HOT-MIX ASPHALT SURFACE REMOVAL

PCC SIDEWALK REMOVAL & REPLACEMENT (SPOT REMOVAL & REPLACEMENT AS DIRECTED BY THE ENGINEER)


REPLACEMENT GREATER THAN 10 FEET

COMBINATION CURB AND GUTTER REMOVAL AND REPLACEMENT LESS THAN OR EQUAL TO 10 FEET COMBINATION CURB AND GUTTER REMOVAL AND

TYPE B6.12

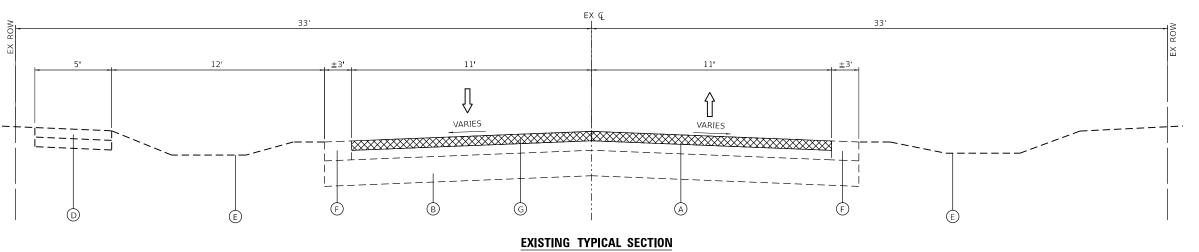

W WONDER LAKE RD (650' SOUTH OF WHITE OAKS RD TO WHITE OAKS RD)

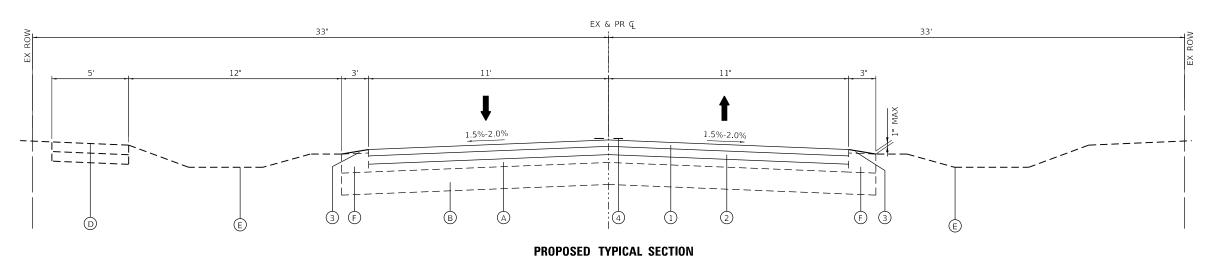

W WONDER LAKE RD (650' SOUTH OF WHITE OAKS RD TO WHITE OAKS RD)

#### EXISTING TYPICAL SECTION

- EXISTING HOT-MIX ASPHALT PAVEMENT; SEE TABLE
- B EXISTING AGGREGATE BASE COURSE; SEE TABLE
- © EXISTING COMBINATION CONCRETE CURB & GUTTER,
- (D) EXISTING PCC SIDEWALK
- E EXISTING GROUND
- F) EXISTING AGGREGATE/EARTH SHOULDER
- G HOT-MIX ASPHALT SURFACE REMOVAL, 21/2"
- (H) EXISTING HOT-MIX ASPHALT MULTI-USE PATH



HOT-MIX ASPHALT SURFACE REMOVAL



PCC SIDEWALK REMOVAL & REPLACEMENT (SPOT REMOVAL & REPLACEMENT AS DIRECTED BY THE ENGINEER)



COMBINATION CURB AND GUTTER REMOVAL AND REPLACEMENT LESS THAN OR EQUAL TO 10 FEET COMBINATION CURB AND GUTTER REMOVAL AND REPLACEMENT GREATER THAN 10 FEET

OTES:

IT IS THE CONTRACTOR'S RESPONSIBILITY TO DETERMINE THE CURB AND GUTTER TYPE.

PATCHING LOCATIONS TO BE MARKED BY THE ENGINEER AFTER MILLING OPERATIONS.


#### PROPOSED TYPICAL SECTION


- 1 HOT-MIX ASPHALT SURFACE COURSE, MIX 'D', IL-9.5, N50; 1<sup>3</sup>/<sub>4</sub>"
- POLYMERIZED HOT-MIX ASPHALT BINDER COURSE, IL-4.75, N50; 1"
- 3) AGGREGATE SHOULDERS, TYPE B (9% MAX SLOPE) (CA-6 CRUSHED GRAVEL OR CRUSHED STONE)
- PAVEMENT MARKING, LINE 4" (SEE RESURFACING PLAN)


#### EXISTING PAVEMENT THICKNESS TABLE

LOCATION	THICKNESS						
WEST WONDER LAKE ROA	D						
НМА	±6"						
GRANULAR BASE	±6"						


SCALE: N.T.S.

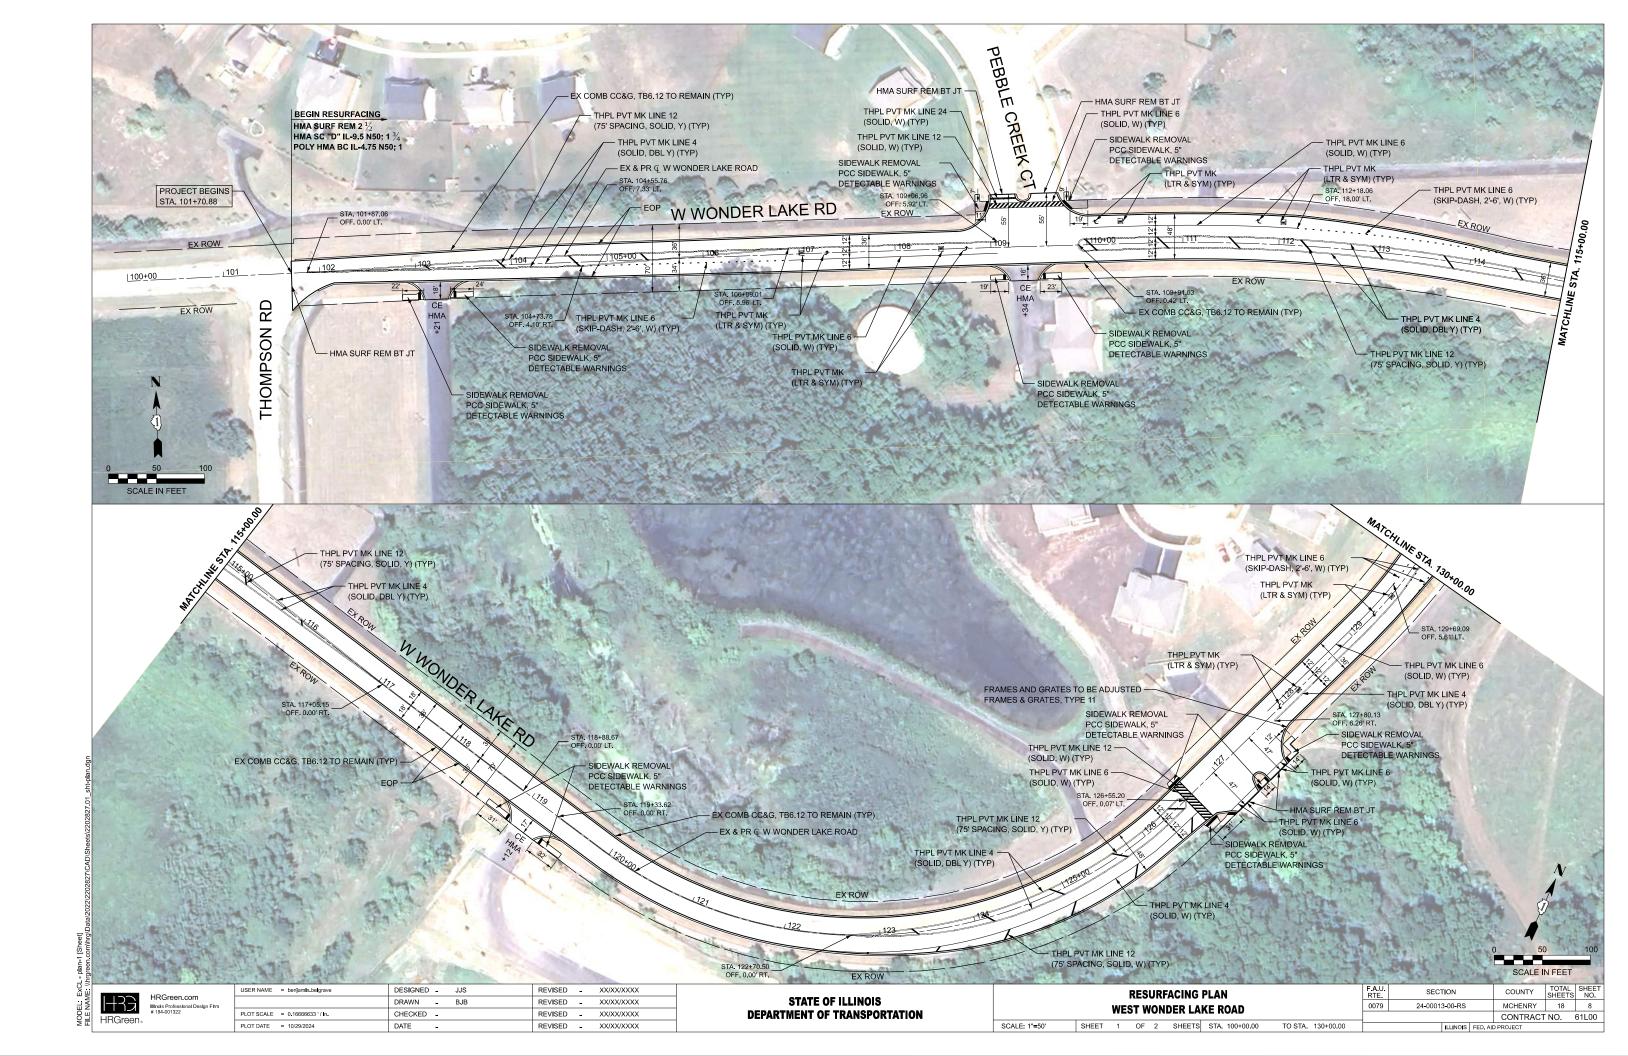

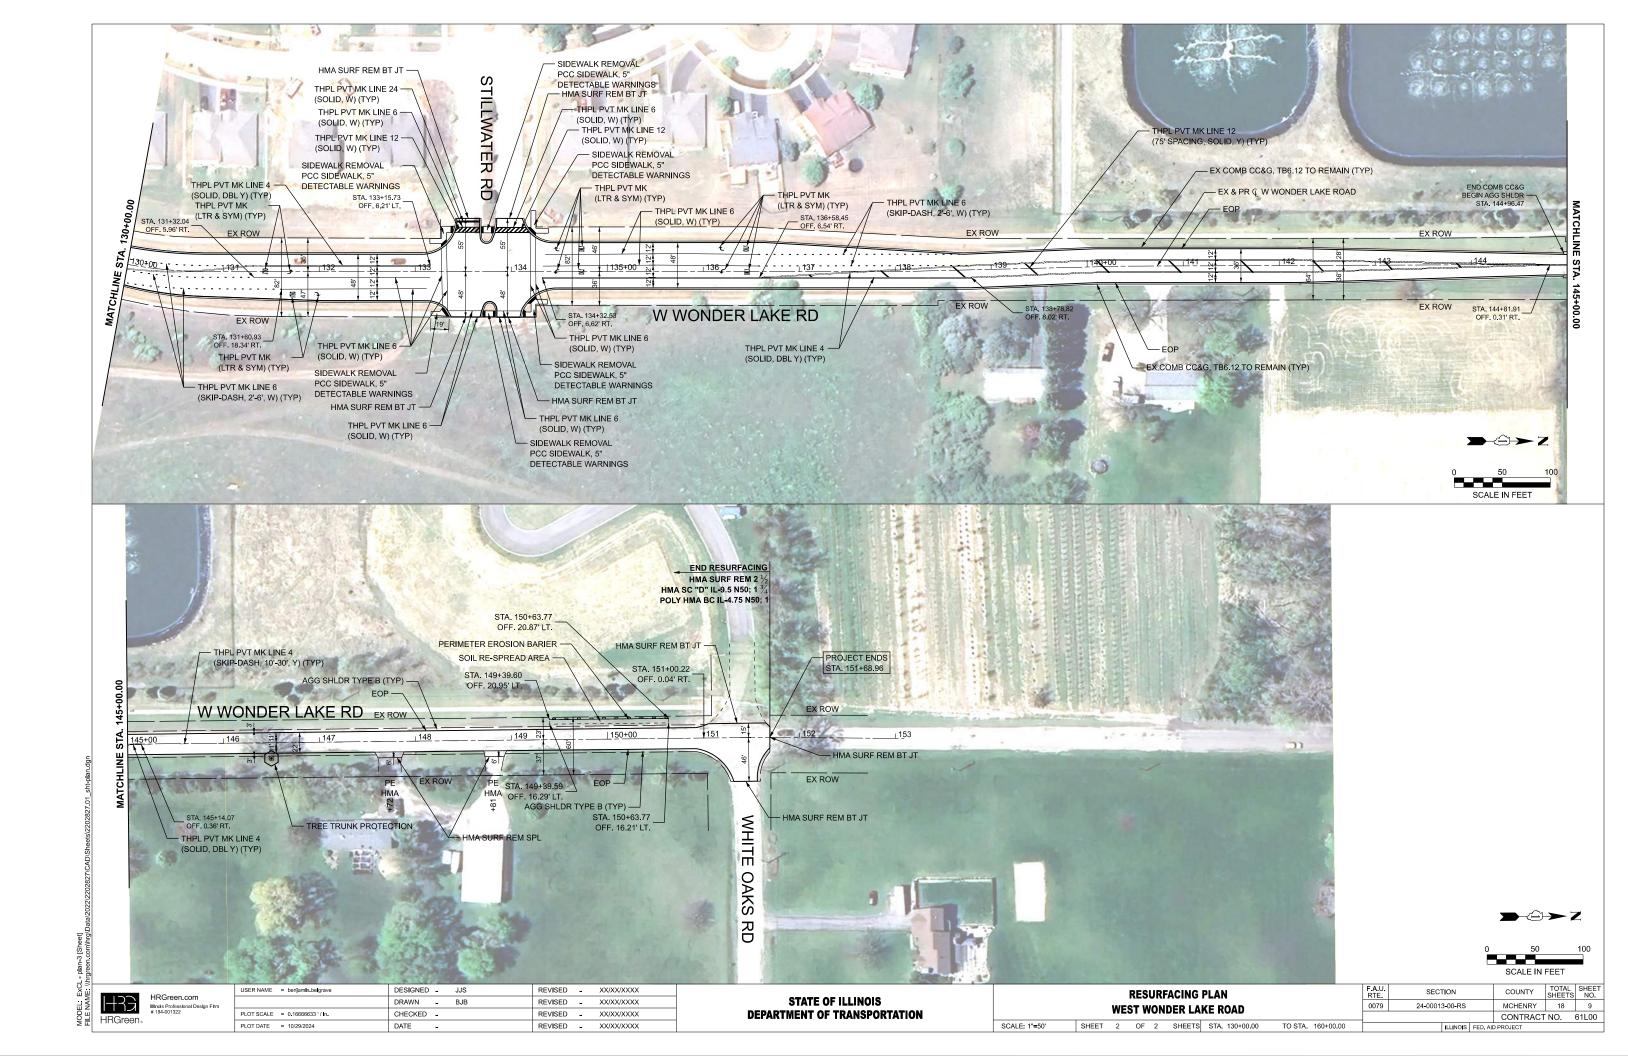


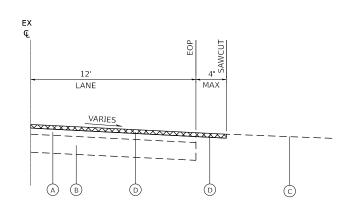

VARIES MAX PER R.E. LANE ALUMED | EXISTING / REMOVAL DETAIL

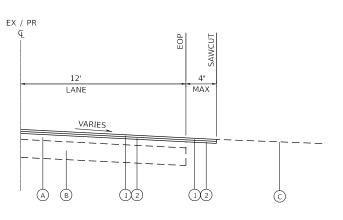

EXISTING / REMOVAL DETAIL

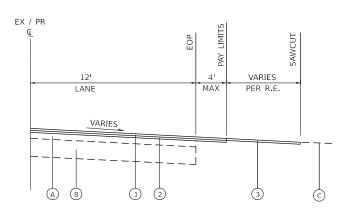

PROPOSED / RESURFACING DETAIL

PROPOSED / RESURFACING DETAIL

#### CASE I

#### <u>CASE II</u>

#### **DRIVEWAY RESURFACING DETAILS**

#### **EXISTING LEGEND**

- (A) EXISTING HOT-MIX ASPHALT PAVEMENT; 6"
- B EXISTING AGGREGATE BASE COURSE; 12"
- EXISTING DRIVEWAY PAVEMENT
- HOT-MIX ASPHALT SURFACE REMOVAL,  $2\frac{1}{2}$ " (SEE RESURFACING PLANS)
- E HOT-MIX ASPHALT SURFACE REMOVAL, SPECIAL (PER SQ YD)

#### PROPOSED LEGEND

- PROPOSED RESURFACING; HMA SURFACE COURSE (SEE HMA MIX TABLE)
- 2 PROPOSED RESURFACING; HMA BINDER COURSE (SEE HMA MIX TABLE)
- 3 INCIDENTAL HOT-MIX ASPHALT SURFACING (PER TON)

HRGreen.


USER NAME = benjamin belgrave	DESIGNED - JJS	REVISED - XX/XX/XXXX
	DRAWN - BJB	REVISED - XX/XX/XXXX
PLOT SCALE = 0.16666633 ' / In.	CHECKED -	REVISED - XX/XX/XXXX
PLOT DATE = 10/29/2024	DATE -	REVISED - XX/XX/XXXX

STATE OF ILLINOIS **DEPARTMENT OF TRANSPORTATION** 

		-			UCTION IDER LA	DETAIL KE ROAD	
SCALE: N.T.S.	SHEET	1	OF	3	SHEETS	STA.	TO STA.

COUNTY TOTAL SHEET NO.

MCHENRY 18 10 SECTION 0079 24-00013-00-RS CONTRACT NO. 61L00

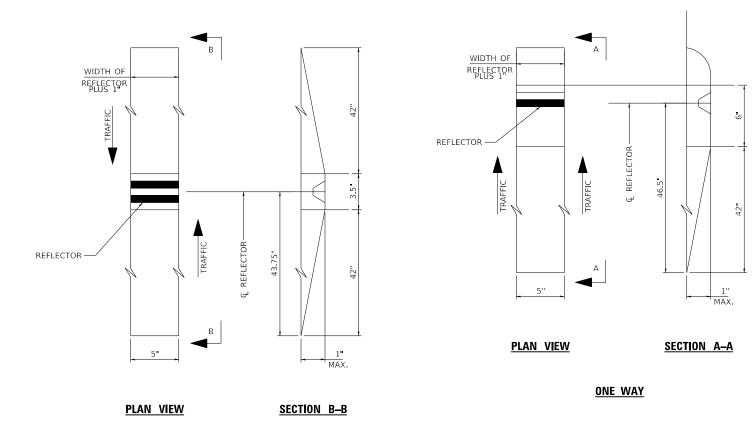

TWO WAY

RECESSED REFLECTIVE MARKERS

#### **INSTALLATION NOTES:**

- SAWCUT IN DIMENSIONS SHOWN.
- 2. SAWCUT AREAS TO BE DRY AND FREE OR MATERIAL THAT ADVERSELY AFFECTS THE ADHESIVE BAND.
- 3. INSTALL THE REFLECTOR WITH AN APPROVED TWO-COMPONENT EPOXY ADHESIVE. EPOXY SHOULD NOT OBSCURE OR BLOCK THE LENS.
- 4. INSTALL TOP OF REFLECTOR  $\frac{1}{2}$  TO  $\frac{1}{4}$  INCH BELOW THE PAVEMENT SURFACE.

#### **GENERAL NOTES:**

- 1. INSTALLATION SHALL CONFORM TO IDOT HIGHWAY STANDARD 781001-04 (OR LATEST) FOR MARKER PLACEMENT.
- 2. IDOT STANDARD 781001-04 SHALL BE MODIFIED TO REFLECT IN RECESSED PAVEMENT MARKERS INSTEAD OF RAISED PAVEMENT MARKERS.

FILE NAME: \\hrgreen.com\

HRGreen.com
||Illnots Professional Design|
| HRGreen.o


USER NAME = benjamin belgrave	DESIGNED - JJS	REVISED - XX/XX/XXXX
	DRAWN - BJB	REVISED - XX/XX/XXXX
PLOT SCALE = 0.16666633 '/ In.	CHECKED -	REVISED - XX/XX/XXXX
PLOT DATE = 10/29/2024	DATE -	REVISED - XX/XX/XXXX

STATE OF ILLINOIS	
DEPARTMENT OF TRANSPORTATION	

SCALE: N.T.S.

					F.A.U. RTE. 0079	SEC <sup>-</sup> 24 <b>-</b> 0001			COUNTY	TOTAL SHEETS 18	SHEET NO.				
	WEST WONDER LAKE ROAD								CONTRACT	61L00					
	SHEET	2	OF	3	SHEETS	STA.	TO STA.		ILLINOIS FED. AID PROJECT						

HRGreen.com Illinois Professional Design Firm # 184-001322 HRGreen.

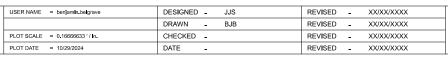


STATE OF ILLINOIS **DEPARTMENT OF TRANSPORTATION** 

CON	F.A.U. RTE.	SECTION	COUNTY		SHEET NO.					
WEST	0079	24-00013-00-RS	MCHENRY	18	12					
WEST			CONTRACT	NO.	61L00					
SCALE: N.T.S. SHEET 3 (	OF 3 SHEETS	STA	TO STA.	HUNDIS EED AID PROJECT						

INSTALL 6" OF WOOD
CHIPS IN AREAS WHERE
EQUIPMENT OPERATES,
PROTECT TRUNK WITH
PLANKING TO REDUCE
SCARRING BY EQUIPMENT.
REMOVE PLANKING,
MATTING, AND MULCH AS
SOON AS OPERATIONS
ARE FINISHED. 2" X 4" PLANKING LOOSELY WIRED AROUND TREE TEMPORARY FENCING 6" OF WOOD CHIPS (TYP.)

TYP. TREE TRUNK PROTECTION DETAIL

SCALE: NTS

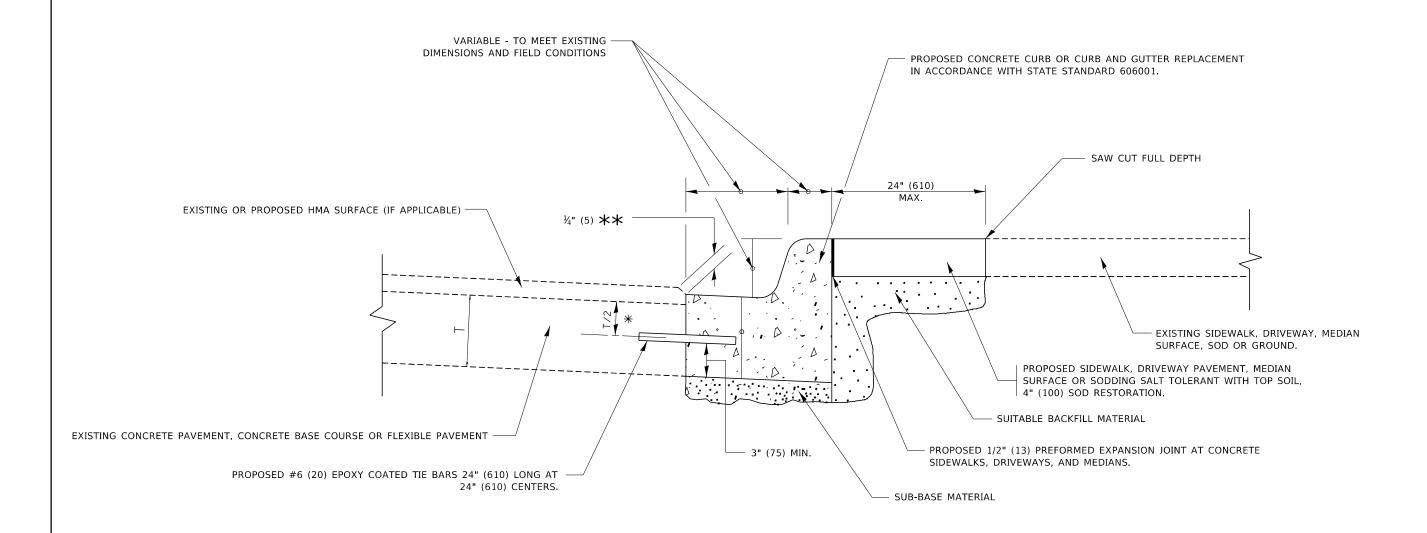

- 💥 3" (75) MINIMUM FROM TOP AND BOTTOM OF THE CONCRETE PAVEMENT OR BASE COURSE.
- \*\* IF THE FINAL SURFACE OF THE PAVEMENT IS CONCRETE, THE GUTTER IS TO BE FLUSH WITH THE PAVEMENT.

## **CURB OR CURB AND GUTTER REMOVAL AND REPLACEMENT**

ALL DIMENSIONS ARE IN INCHES (MILLIMETERS) UNLESS OTHERWISE SHOWN.


USER NAME = footemj	DESIGNED	-	A. HOUSEH	REVISED	-	A. ABBAS 03-21-97
	DRAWN	-		REVISED	-	M. GOMEZ 01-22-01
PLOT SCALE = 50.0000 */ in.	CHECKED	-		REVISED	-	R. BORO 12-15-09
PLOT DATE = 7/11/2019	DATE		03-11-94	REVISED	-	K. SMITH 07-11-19

STATE OF ILLINOIS
DEPARTMENT OF TRANSPORTATION

 CURB OR CURB AND GUTTER
 F.A.U. RTE.
 SECTION RTE.


 REMOVAL AND REPLACEMENT
 0079
 24-00013-00

 SHEET 1
 OF 1
 SHEETS STA.
 TO STA.
 BD600-06 (BD-2)

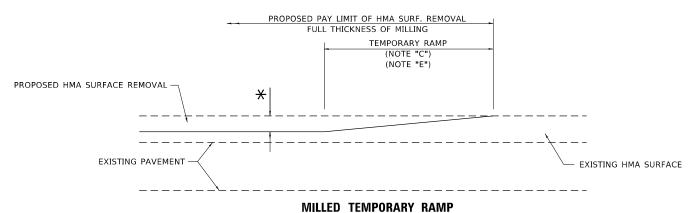

(FOR BUTT JOINT AND HMA TAPER SEE DETAIL BELOW)

#### OPTION 1

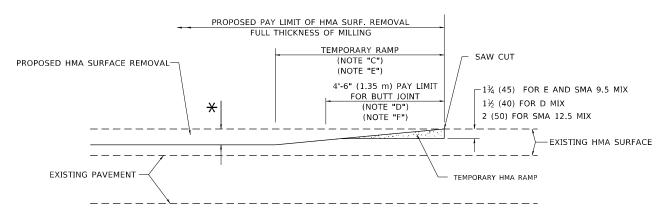


#### HMA CONSTRUCTED TEMPORARY RAMP

(FOR BUTT JOINT AND HMA TAPER SEE DETAIL BELOW)


#### OPTION 2


### TYPICAL TEMPORARY RAMP

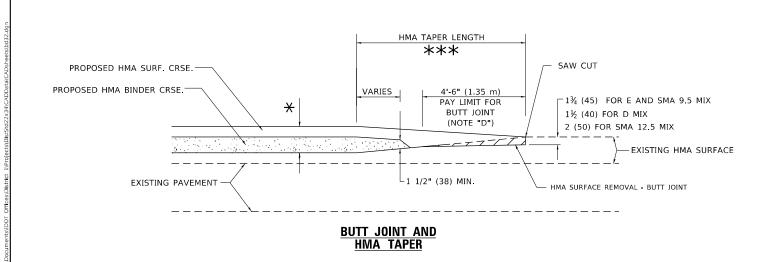

# TYPICAL BUTT JOINT AND HMA TAPER FOR MILLING AND RESURFACING

### STATE OF ILLINOIS DEPARTMENT OF TRANSPORTATION

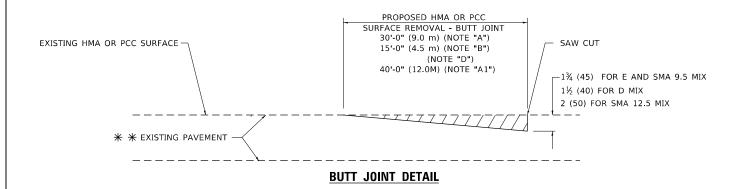

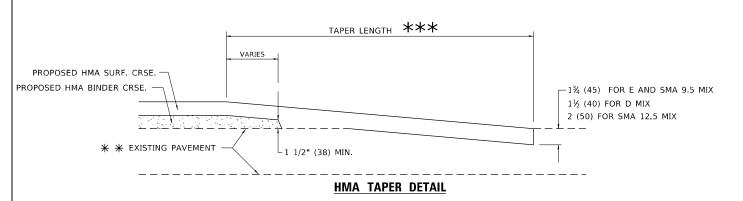

# TYPICAL BUTT JOINT AND HMA TAPER FOR RESURFACING ONLY

\*\* PC CONCRETE, HMA OR HMA RESURFACED PAVEMENT.


#### **GENERAL NOTES**

- A. MAINLINE ARTERIAL ROADWAYS AND MAJOR SIDE ROADS.
- A1. INTERSTATES
- B. MINOR SIDE ROADS.
- C. THE TEMP. RAMP SHALL BE CONSTRUCTED IMMEDIATELY UPON REMOVAL OF THE EXISTING HMA SURFACE.
- D. THE BUTT JOINT SHALL BE CONSTRUCTED IMMEDIATELY PRIOR TO PLACING THE PROPOSED HMA COURSES.
- E. TAPER THE TEMP. RAMP AT A RATE OF 3' 4" (1.02m) PER 1 INCH (25 mm) OF MILLING THICKNESS.
  - igstar SEE TYPICAL SECTIONS FOR MILLING THICKNESS.
- F. SEE ARTICLE 406.08 AND 406.14 OF THE STANDARD SPECIFICATIONS FOR "HMA AND/OR PCC SURFACE REMOVAL, BUTT JOINT".
- \*\*\* 20'-0" (6.1 m) PER 1 (25) RESURFACING (NOTE "A") 10'-0" (3.0 m) PER 1 (25) RESURFACING (NOTE "B")

#### **BASIS OF PAYMENT**

- THE BUTT JOINT WILL BE PAID FOR AT THE CONTRACT UNIT PRICE PER SQUARE YARD (SQUARE METER) FOR "HOT-MIX ASPHALT SURFACE REMOVAL - BUTT JOINT" OR FOR "PORTLAND CEMENT CONCRETE SURFACE REMOVAL- BUTT JOINT"
- THE TEMPORARY RAMP AND SAW CUT SHALL BE INCLUDED IN THE UNIT COST FOR HMA OR PCC SURFACE REMOVAL-BUTT JOINT

ALL DIMENSIONS ARE IN INCHES (MILLIMETERS) UNLESS OTHERWISE SHOWN.

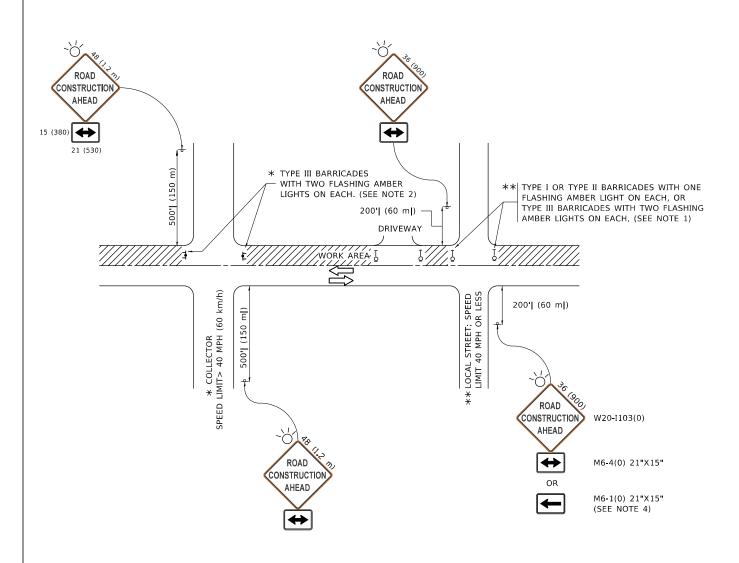

#### NOTES:

- 1. SIDE ROAD WITH A SPEED LIMIT OF 40 MPH (60 km/h) OR LESS AS SHOWN ON THE DRAWING AND AS DIRECTED BY THE ENGINEER:
- a) ONE "ROAD CONSTRUCTION AHEAD" SIGN 36 x 36 (900x900) WITH A FLASHER MOUNTED ON IT APPROXIMATELY 200' (60 m) IN ADVANCE OF THE MAIN ROUTE.
- b) THE CLOSED PORTION OF THE MAIN ROUTE SHALL BE PROTECTED BY BLOCKING WITH TYPE I, TYPE II OR TYPE III BARRICADES, 1/3 OF THE CROSS SECTION OF THE CLOSED PORTION.
- 2. SIDE ROAD WITH A SPEED LIMIT GREATER THAN 40 MPH (60 km/h) AS SHOWN ON THE DRAWING AND AS DIRECTED BY THE ENGINEER:
  - a) ONE "ROAD CONSTRUCTION AHEAD" SIGN 48 x 48 (1.2 m x 1.2 m) WITH A FLASHER MOUNTED ON IT APPROXIMATELY 500' (150 m) IN ADVANCE OF THE MAIN ROUTE.
- THE CLOSED PORTION OF THE MAIN ROUTE SHALL BE PROTECTED BY
  b) BLOCKING WITH TYPE III BARRICADES, 1/2 OF THE CROSS SECTION
  OF THE CLOSED PORTION.
- 3. CONES MAY BE SUBSTITUTED FOR BARRICADES OR DRUMS AT HALF THE SPACING DURING DAY OPERATIONS. CONES SHALL BE A MINIMUM OF 28 (710) IN HEIGHT
- WHEN THE SIDE ROAD LIES BETWEEN THE BEGINNING OF THE MAINLINE
  4. SIGNING AND THE WORK ZONE, A SINGLE HEADED ARROW (M6-1) SHALL
  BE USED IN LIEU OF THE DOUBLE HEADED ARROW (M6-4).

- WHEN WORK IS BEING PERFORMED ON A SIDE ROAD OR DRIVEWAY, FOLLOW THE APPLICABLE STANDARD(S). THE DIRECTIONAL ARROW (M6-1 OR M6-4) SHALL BE COVERED OR REMOVED WHEN NO LONGER CONSISTENT WITH THE TRAFFIC CONTROL SET-UP.
- 6. ADVANCE WARNING SIGNS ARE TO BE OMITTED ON DRIVEWAYS UNLESS OTHERWISE SPECIFIED IN THE PLANS OR BY THE ENGINEER
- THE TRAFFIC CONTROL AND PROTECTION FOR SIDE ROADS, INTERSECTIONS, AND DRIVEWAYS SHALL BE INCLUDED IN THE COST OF SPECIFIED TRAFFIC CONTROL STANDARDS OR ITEMS.


All dimensions are in inches (millimeters) unless otherwise shown.

STATE OF ILLINOIS
DEPARTMENT OF TRANSPORTATION

TRAFFIC CONTROL AND PROTECTION FOR SIDE ROADS, INTERSECTIONS, AND DRIVEWAYS

| SHEET 1 OF 1 SHEETS STA. TO STA

3/4/2019 10:27:

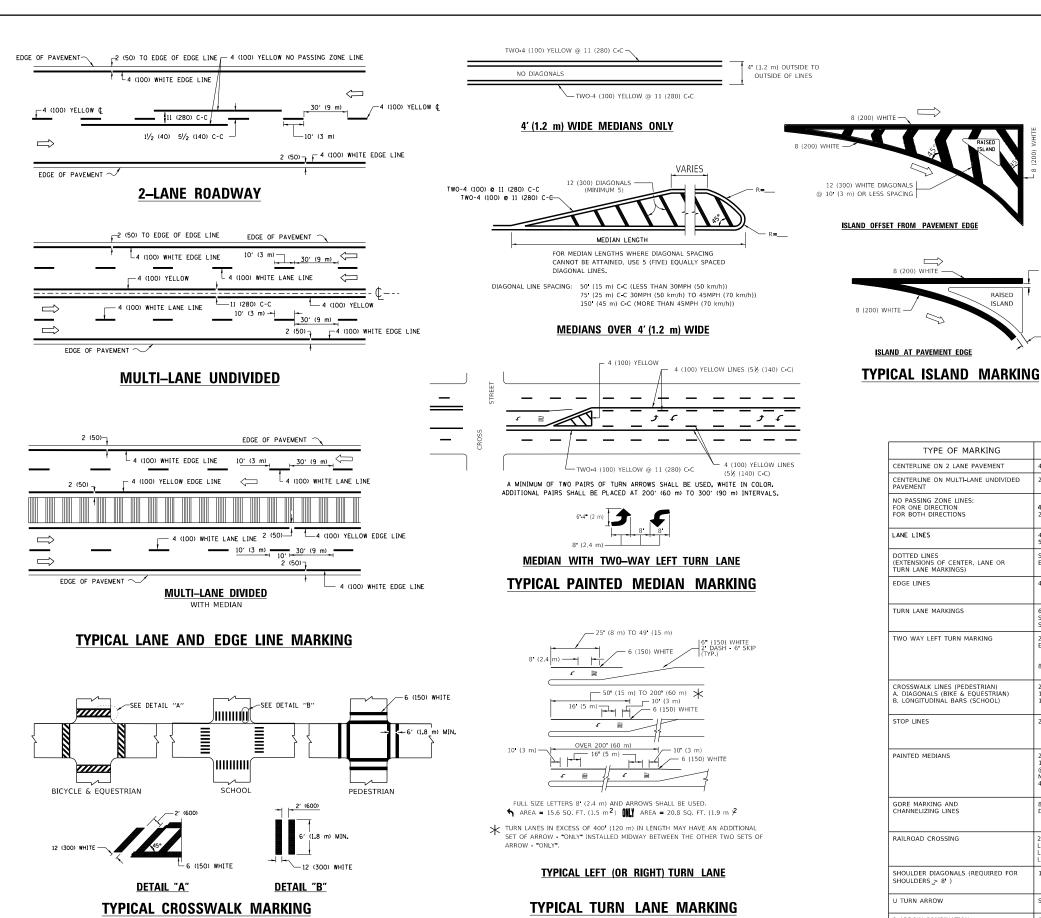

665 50 **COMBINATION** LEFT AND U-TURN 32 R (810) LANE REDUCTION TRANSITION \* LANE REDUCTION ARROWS REQUIRED AT SPEEDS OF 45 MPH OR GREATER OR WHEN SPECIFIED IN PLANS. **U\_TURN** WIDTH OF LINE PATTERN SPACING / REMARKS

D(FT)

SPEED LIMIT

TYPE OF MARKING	WIDTH OF LINE	PATTERN	COLOR	SPACING / REMARKS
CENTERLINE ON 2 LANE PAVEMENT	4 (100)	SKIP-DASH	YELLOW	10' (3 m) LINE WITH 30' (9 m) SPACE
CENTERLINE ON MULTI-LANE UNDIVIDED PAVEMENT	2 @ 4 (100)	SOLID	YELLOW	11 (280) C-C
NO PASSING ZONE LINES: FOR ONE DIRECTION FOR BOTH DIRECTIONS	4 (100) 2 @ 4 (100)	SOLID SOLID	YELLOW YELLOW	5½ (140) C-C FROM SKIP-DASH CENTERLINE 11 (280) C-C OMIT SKIP-DASH CENTERLINE BETWEEN
LANE LINES	4 (100) 5 (125) ON FREEWAYS	SKIP-DASH SKIP-DASH	WHITE WHITE	10' (3 m) LINE WITH 30' (9 m) SPACE
DOTTED LINES (EXTENSIONS OF CENTER, LANE OR TURN LANE MARKINGS)	SAME AS LINE BEING EXTENDED	SKIP-DASH	SAME AS LINE BEING EXTENDED	2' (600) LINE WITH 6' (1.8 m) SPACE
EDGE LINES	4 (100)	SOLID	YELLOW-LEFT WHITE-RIGHT	OUTLINE MEDIANS IN YELLOW
TURN LANE MARKINGS	6 (150) LINE; FULL SIZE LETTERS & SYMBOLS (8' (2.4m))	SOLID	WHITE	SEE TYPICAL TURN LANE MARKING DETAIL
TWO WAY LEFT TURN MARKING	2 @ 4 (100) EACH DIRECTION 8' (2.4m) LEFT ARROW	SKIP-DASH AND SOLID IN PAIRS	YELLOW	10' (3 m) LINE WITH 30' (9 m) SPACE FOR SKIP-DASH; 5½ (140) C-C BETWEEN SOLID LINE AND SKIP-DASH LINE SEE TYPICAL TWO-WAY LEFT TURN MARKING DETAIL
CROSSWALK LINES (PEDESTRIAN) A. DIAGONALS (BIKE & EQUESTRIAN) B. LONGITUDINAL BARS (SCHOOL)	2 @ 6 (150) 12 (300) @ 45° 12 (300) @ 90°	SOLID SOLID SOLID	WHITE WHITE WHITE	NOT LESS THAN 6' (1.8 m) APART 2' (600) APART 2' (600) APART SEE TYPICAL CROSSWALK MARKING DETAILS.
STOP LINES	24 (600)	SOLID	WHITE	PLACE 4* (1.2 m) IN ADVANCE OF AND PARALLEL TO CROSSWALK, IF PRESENT, OTHERWISE, TAJACE AT DESIRED STOPPING POINT. PARALLEL TO CROSSROAD CENTERLINE, WHERE POSSIBLE
PAINTED MEDIANS	2 @ 4 (100) WITH 12 (300) DIAGONALS @ 45° NO DIAGONALS USED FOR 4' (1.2 m) WIDE MEDIANS	SOLID	YELLOW: TWO WAY TRAFFIC WHITE: ONE WAY TRAFFIC	11 (280) C-C FOR THE DOUBLE LINE SEE TYPICAL PAINTED MEDIAN MARKING.
GORE MARKING AND CHANNELIZING LINES	8 (200) WITH 12 (300) DIAGONALS @ 45°	SOLID	WHITE	DIAGONALS: 15' (4,5 m) C-C (LESS THAN 30MPH (50 km/h)) 20' (6 m) C-C 30MPH (50 km/h) TO 45MPH (70 km/h)) 30' (9 m) C-C (OVER 45MPH (70 km/h))
RAILROAD CROSSING	24 (600) TRANSVERSE LINES; "RR" IS 6 (1.8 m) LETTERS; 16 (400) LINE FOR "X"	SOLID	WHITE	SEE STATE STANDARD 780001 AREA OF: "R"=3.6 SQ. FT. (0.33 m PEACH "X"=54.0 SQ. FT. (5.0 m PE
SHOULDER DIAGONALS (REQUIRED FOR SHOULDERS > 8')	12 (300) @ 45°	SOLID	WHITE - RIGHT YELLOW - LEFT	50' (15 m) C-C (LESS THAN 30MPH (50 km/h)) 75' (25 m) C-C (30 MPH (50 km/h) TO 45MPH (70 km/h)) 150' (45 m) C-C (OVER 45MPH (70 km/h))
U TURN ARROW	SEE DETAIL	SOLID	WHITE	16.3 SF
2 ARROW COMBINATION LEFT AND U TURN	SEE DETAIL	SOLID	WHITE	30.4 SF

FOR FURTHER DETAILS ON PAVEMENT MARKING REFER TO STANDARD SPECIFICATIONS FOR ROAD AND BRIDGE CONSTRUCTION AND STATE STANDARD 780001.

SCALE: NONE

8 (200) WHITE -

RAISED

All dimensions are in inches (millimeters) unless otherwise shown.

REVISED - C. JUCIUS 09-09-09 REVISED - C. JUCIUS 07-01-13 REVISED - C. JUCIUS 12-21-15 REVISED - C. JUCIUS 04-12-16

STATE OF ILLINOIS **DEPARTMENT OF TRANSPORTATION** 

SECTION DISTRICT ONE 24-00013-00-RS MCHENRY 18 16 TYPICAL PAVEMENT MARKINGS TC-13 CONTRACT NO. 61L00 OF 2 SHEETS STA

\* MARKINGS SHALL BE INSTALLED PARALLEL TO THE CENTERLINE OF THE ROAD WHICH IT CROSSES

DESIGNED - EVERS


DRAWN

DATE

CHECKED -


USER NAME = footemj

LOT DATE = 3/4/2019

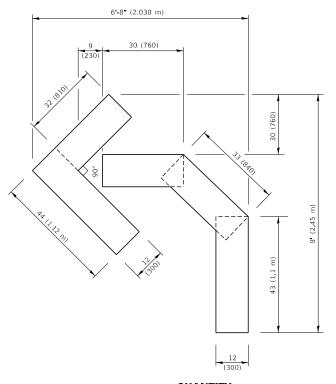

#### QUANTITY

4 (100) LINE = 45.5 ft. (13.9 m) 15.2 sq. ft. (1.41 sq. m)

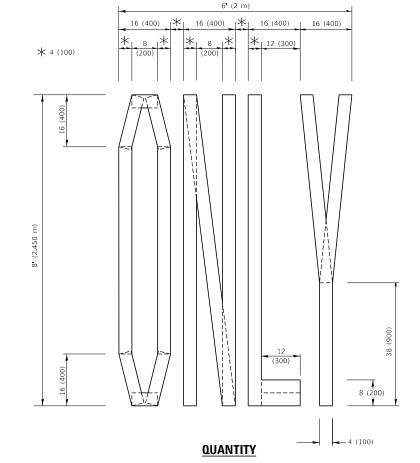

4 (100) LINE = 64.1 ft. (19.5 m) 21.4 sq. ft. (1.99 sq. m)

DESIGNED -

DRAWN -


CHECKED -

DATE - 09-18-94

USER NAME = footemj

PLOT DATE = 3/4/2019

PLOT SCALE = 50.0068 ' / in.

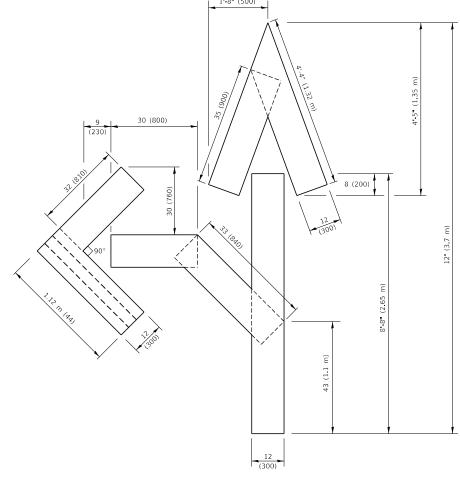


#### QUANTITY

4 (100) LINE = 82.5 ft. (25.1 m) 27.5 sq. ft. (2.53 sq. m)

#### NOTE:

ALL QUANTITIES OF PLACEMENT ARE REPRESENTED IN LINEAR FEET OF 4" LINES TO MATCH THE 4" TEMPORARY TAPE PAY ITEM AND REPRESENTS THE TOTAL QUANTITY OF 4" TAPE REQUIRED.

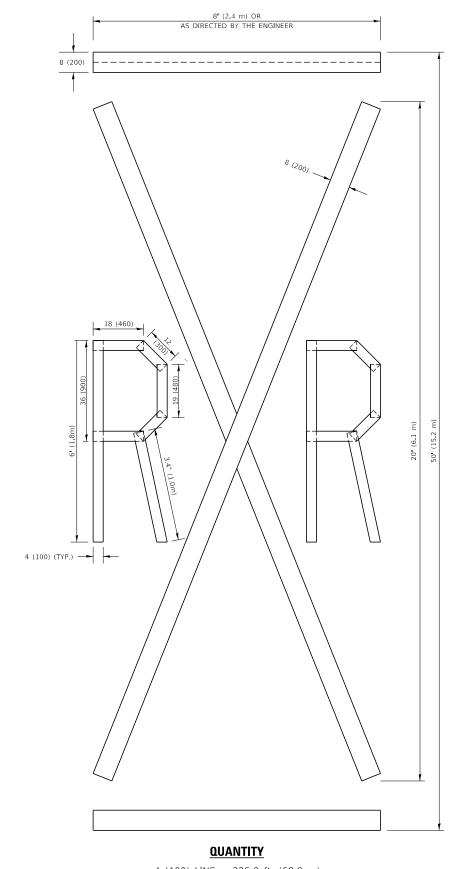

4 (100) LINE = 225.9 ft. (68.9 m) 75.3 sq. ft. (6.99 sq. m)

> All dimensions are in inches (millimeters) unless otherwise shown.


REVISED - T. RAMMACHER 03-02-98 REVISED - E. GOMEZ 08-28-00 REVISED - E. GOMEZ 08-28-00

REVISED - A. SCHUETZE 09-15-16

STATE OF ILLINOIS **DEPARTMENT OF TRANSPORTATION** 

SHORT TERM PAVEMENT MARKING LETTERS AND SYMBOLS SCALE: NONE SHEET 1 OF 1 SHEETS STA.

A.U. RTE	SEC <sup>-</sup>	ПОИ	COUNTY	TOTAL SHEETS	SHE		
0079	24-000	13-00-RS	;		MCHENRY	18	17
	TC-16		CONTRACT	NO.	51L00		
		DUDINOIS	EED	Λ	D PROJECT		

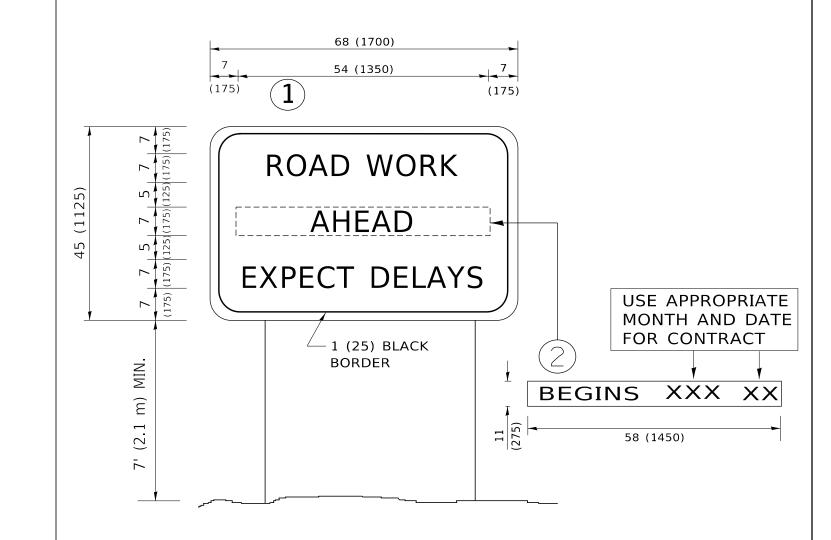

#### NOTES:

- 1. USE BLACK LETTERING ON ORANGE BACKGROUND.
- 2. ERECT SIGNS IN ADVANCE OF THE LOCATION FOR THE "ROAD CONSTRUCTION AHEAD" SIGN AT LOCATIONS AS DIRECTED BY THE ENGINEER.
- 3. ERECT SIGN 1 WITH INSTALLED PANEL 2 ONE WEEK PRIOR TO THE START OF CONSTRUCTION.
- 4. REMOVE PANEL(2)SOON AFTER THE START OF CONSTRUCTION.
- 5. SEE SPECIAL PROVISION FOR "TEMPORARY INFORMATION SIGNING" FOR ADDITIONAL INFORMATION.
- 6. ONE SIGN ASSEMBLY EQUALS 25.70 SQ. FT. (2.3 SQ. M.)
- 7. SHALL BE PAID FOR AS TEMPORARY INFORMATION SIGNING.

ALL DIMENSIONS ARE IN INCHES (MILLIMETERS) UNLESS OTHERWISE SHOWN.

USER NAME = footemj	DESIGNED -	REVISED - R. MIRS 09-15-97	·			ΔΙ	RTERIAL F	ROAD.		F.A.U. RTF	SECTION	COUNTY
	DRAWN -	REVISED - R. MIRS 12-11-97	STATE OF ILLINOIS							0079	24-00013-00-RS	MCHENRY
PLOT SCALE = 50.0000 / in	CHECKED -	REVISED -T. RAMMACHER 02-02-99	DEPARTMENT OF TRANSPORTATION	INFORMATION SIGN							TC-22	CONTRAC
PLOT DATE = 3/4/2019	DATE -	REVISED - C. JUCIUS 01-31-07		SCALE: NONE	SHEET 1	OF	1 SHEET	S STA.	TO STA.		ILLINOIS FED.	AID PROJECT