LAKE IN THE HILLS

BOLINGBROOK'S CLOW

INTERNATIONAL

LOCATION MAP

BO007 TOTAL SHEETS: 55

### **Kimley»Horn**

4201 WINFIELD ROAD SUITE 600 WARRENVILLE, IL 60555 TEL (630) 487-5550


## VILLAGE OF BOLINGBROOK BOLINGBROOK'S CLOW INTERNATIONAL AIRPORT (1C5) BOLINGBROOK, WILL COUNTY, ILLINOIS

### CONSTRUCT REPLACEMENT PARALLEL TAXIWAY AND REPLACE AIRPORT ROTATING BEACON

ILLINOIS PROJECT NO. 1C5-4718


CONTRACT NO. BO007 SBG PROJECT NUMBER: N/A ISSUED FOR BID 11/22/2024




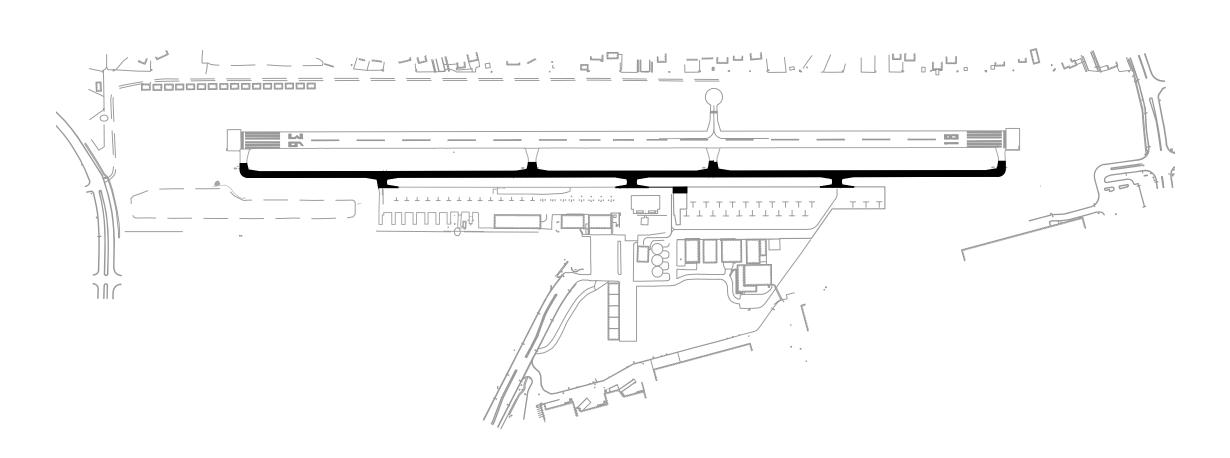




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LAKE MICHIGAN
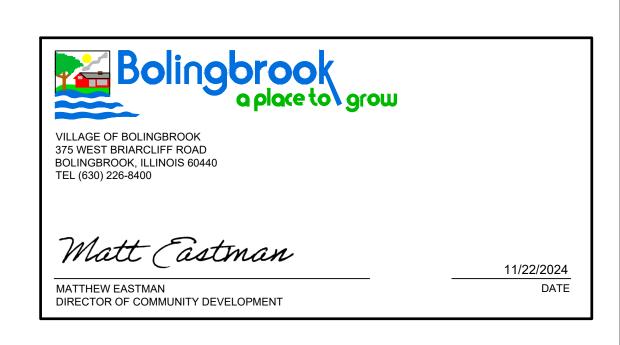
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ELECTRICAL DETAILS

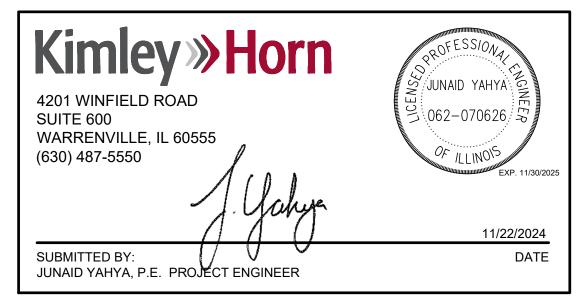EL-503

BASE BID								
NO.	ITEM	DESCRIPTION	UNIT	QUANTITY	FIELD QUANTIT			
1	AR101510	AIRPORT ROTATING BEACON	EACH	1				
2	AR101900	BEACON REMOVAL	EACH	1				
3	AR109210	VAULT MODIFICATIONS	LUMP SUM	1				
4	AR110949	ADJUST CABLE MARKERS	EACH	8				
5	AR125100	ELEVATED RETROREFLECTIVE MARKER	EACH	78				
6	AR125912	REMOVE RETROREFLECTIVE MARKER	EACH	40				
7	AR150520	MOBILIZATION	LUMP SUM	1				
8	AR150530	TRAFFIC MAINTENANCE	LUMP SUM	1				
9	AR150540	HAUL ROUTE	LUMP SUM	1				
10	AR152410	UNCLASSIFIED EXCAVATION	CUBIC YARD	7580.0				
11	AR152515	SUBGRADE UNDERCUT	CUBIC YARD	920.0				
12	AR154606	GRANULAR DRAINAGE SUBBASE - 6"	SQUARE YARD	11920.0				
13	AR156510	SILT FENCE	LINEAR FOOT	5800.0				
14	AR156513	SEPARATION FABRIC	SQUARE YARD	11920.0				
15	AR156520	INLET PROTECTION	EACH	25				
16	AR401614	BIT. SURF. CSE METHOD II, SUPERPAVE	TON	2480.0				
17	AR401650	BITUMINOUS PAVEMENT MILLING	SY	150.0				
18	AR401660	SAW AND SEAL BIT. JOINTS	LINEAR FOOT	1050.0				
19	AR401900	REMOVE BITUMINOUS PAVEMENT	SQUARE YARD	10000.0				
20	AR602510	BITUMINOUS PRIME COAT	GALLONS	775				
21	AR603510	BITUMINOUS TACK COAT	GALLONS	1330				
22	AR620520	PAVEMENT MARKING - WATERBORNE	SQUARE FOOT	3100.0				
23	AR701412	12" RCP, CLASS III	LINEAR FOOT	187.0				
24	AR701418	18" RCP, CLASS III	LINEAR FOOT	82.0				
25	AR701424	24" RCP, CLASS III	LINEAR FOOT	113.0				
26	AR701900	REMOVE PIPE	LINEAR FOOT	424.0				
27	AR705506	6" PERFORATED UNDERDRAIN	LINEAR FOOT	3425.0				
28	AR705548	8" NON PERFORATED UNDERDRAIN	LINEAR FOOT	256.0				
29	AR705640	UNDERDRAIN CLEANOUT	EACH	22				
30	AR751411	INLET - TYPE A	EACH	7				
31	AR751540	MANHOLE 4'	EACH	1				
32	AR751906	REMOVE CATCH BASIN	EACH	10				
33	AR751940	ADJUST INLET	EACH	2				
34	AR801714	PROVIDE AND INSTALL NEW H-20 LOAD RATED CONCRETE HANDHOLE	EACH	1				
35	AR801715	NEW CONCRETE ENCASED 1-2" SCH 40 PVC WITH (2) CU #8 AWG AND (1) #8 CU AWG GND	LINEAR FOOT	35.0				
36	AR801716	CRUSHED AGG. BASE COURSE - VARIABLE DEPTH	CUBIC YARD	2430.0				
37	AR901510	SEEDING	ACRE	7.16				
38	AR905510	TOPSOILING (FROM ON SITE)	CUBIC YARD	2330.0				
39	AR908510	MULCHING	ACRE	7.16				
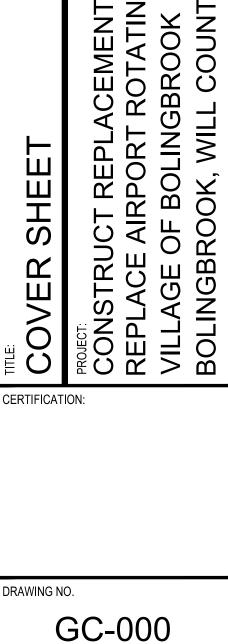
### <u>LEGEND</u>

LEGEND			
ROFA	RUNWAY OBJECT FREE AREA	$\triangle$ $\bullet$	FOUND SURVEY MONUMENT
RSA	RUNWAY SAFETY AREA	× 656.15	SPOT ELEVATION
TOFA	TAXIWAY OBJECT FREE AREA	E	EXISTING ELECTRICAL HANDHOLE
——TSA——	TAXIWAY SAFETY AREA	E	EXISTING ELECTRICAL MANHOLE
	PROPOSED STORM SEWER PIPE	$\boxtimes$	EXISTING ELECTRICAL CABINET
ST	EXISTING STORM SEWER PIPE	#	EXISTING ELECTRICAL DUCT MARKER
657	EXISTING CONTOUR	T	EXISTING COMMUNICATIONS/TELEPHONE PEDESTAL
657	PROPOSED CONTOUR	T	EXISTING COMMUNICATIONS/TELEPHONE MANHOLE
	BITUMINOUS PAVEMENT SAWING	$\otimes$	EXISTING NATURAL GAS VALVE
	LIMITS OF GRADING	S	EXISTING SANITARY SEWER MANHOLE
SF	SILT FENCE	$\bigcirc$	EXISTING WATER MANHOLE
S	EXISTING SANITARY SEWER LINE	$\bigcup$	EXISTING UTILITY
s	PROPOSED SANITARY SEWER LINE	D	EXISTING STORM SEWER INLET
——т—	EXISTING TELEPHONE LINE		PROPOSED STORM SEWER INLET
WTR	EXISTING WATER LINE	*	EXISTING AIRCRAFT TIE DOWN
w	PROPOSED WATER LINE	•	PROPOSED AIRCRAFT TIE DOWN
X	EXISTING CHAIN LINK FENCE	•	EXISTING RETROREFLECTIVE MARKER
	EXISTING WROUGHT IRON FENCE	•	PROPOSED RETROREFLECTIVE MARKER
—— COMM ——	EXISTING COMMUNICATIONS CABLE	<b>®</b> BL-X	BORING LOCATION
——СОМ——	PROPOSED COMMUNICATIONS CABLE		INLET PROTECTION
G	EXISTING NATURAL GAS LINE	BMX	CLIDVEV DENOUMARY
——GAS——	PROPOSED NATURAL GAS SLEEVE		SURVEY BENCHMARK
E	EXISTING POWER CONDUIT	- <b>CP</b> ×	CONTROL POINT
——ELEC——	PROPOSED ELECTRICAL CONDUIT	∑ ∀	EXISTING HYDRANT AND VALVE
- <b> ─</b> - UD —	PROPOSED UNDERDRAIN	<b>②</b> •	PROPOSED WATERMAIN STRUCTURE

ABBREVI <i>A</i>	ATIONS
AC	ADVISORY CIRCULAR
AOA	AIR OPERATIONS AREA
APPROX	APPROXIMATELY
BM	BENCHMARK
CB	CATCH BASIN
CL	CENTERLINE
COMM	COMMUNICATIONS
CY	CUBIC YARD
E	EAST
EA	EACH
EG	EXISTING GROUND
EL	ELEVATION
EX	EXISTING
FAA	FEDERAL AVIATION ADMINISTRATION
	FINISHED FLOOR ELEVATION
FG	FINISHED GRADE
	FLOWLINE
	FOREIGN OBJECT DEBRIS
FT	FEET
GAL	GALLON
GB	GRADE BREAK
IDOT	ILLINOIS DEPARTMENT OF TRANSPORTATION
INV LF	INVERT LINEAR FOOT
LP	LOW POINT
LS	LUMP SUM
LT	LEFT
MAX	MAXIMUM
MIN	MINIMUM
MH	MANHOLE
N	NORTH
NE	NORTHEAST
NO	NUMBER
NW	NORTHWEST
NTS	NOT TO SCALE
OC	ON-CENTER
OFA	OBJECT FREE AREA
PC	POINT OF CURVATURE
POC	POINT ON CURVE
PR	PROPOSED
PT -	POINT OF TANGENCY
R	RADIUS
RCP	REINFORCED CONCRETE PIPE
RSA	RUNWAY SAFETY AREA
RT C	RIGHT
S SE	SOUTH
SOQ	SOUTHEAST SUMMARY OF QUANTITIES
STA	STATION
SW	SOUTHWEST
SY	SQUARE YARD
TOFA	TAXILANE/TAXIWAY OBJECT FREE AREA
TSA	TAXILANE/TAXIWAY SAFETY AREA
TW	TAXIWAY
TYP	TYPICAL
UNO	UNLESS NOTED OTHERWISE
VAR	VARIES
W	WEST

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> SCALE: NONE DATE: 11/22/2024 CHECKED BY: JY DESCRIPTION 0 11/22/2024 ISSUED FOR BID

ABBREVIATIONS TAXIWAY AND 

CERTIFICATION: JUNAID YAHYA DRAWING NO.

GC-101 PROJECT NUMBER:

168001005

### ACCESS AND SAFETY NOTES:

### I. ACCESS AND VEHICLE PARKING:

- ACCESS POINT AND HAUL ROUTE FOR ALL CONTRACTOR PERSONNEL, VEHICLES AND EQUIPMENT ARE AS SHOWN ON THE CONSTRUCTION SAFETY AND PHASING PLAN. IT SHALL BE THE CONTRACTOR'S RESPONSIBILITY TO OBTAIN PERMITS AND COORDINATE OFF SITE HAUL ROUTES WITH THE APPROPRIATE OWNER WHO HAS JURISDICTION OVER THE AFFECTED ROUTE. ON-SITE HAUL ROUTES SHALL BE MAINTAINED BY THE CONTRACTOR AND SHALL BE RESTORED TO THEIR ORIGINAL CONDITION UPON COMPLETION OF BEING USED AS A HAUL ROUTE. HAUL ROUTES ARE TO REMAIN CLEAN AND PASSABLE AT ALL TIMES.
- B. CONTRACTOR SHALL FURNISH AND INSTALL A PROFESSIONALLY PAINTED SIGN MEETING OWNER APPROVAL AT THE CONSTRUCTION ENTRANCE TO DIRECT MATERIAL SUPPLIERS AND EMPLOYEES TO THE CONSTRUCTION SITE. THE SIGN SHALL READ "CONSTRUCTION VEHICLES ONLY NO VENDORS ALLOWED".
- C. ALL CONTRACTOR VEHICLES AND PERSONNEL SHALL REMAIN WITHIN THE DESIGNATED CONSTRUCTION LIMITS OR HAUL ROUTES. NO CONTRACTOR VEHICLES WILL BE ALLOWED ON OTHER AIRFIELD OPERATIONS AREAS.
- THE LIMITS OF CONSTRUCTION, MATERIAL STORAGE AREAS, EQUIPMENT STORAGE AREA, PARKING AREA AND OTHER AREAS DEFINED AS REQUIRED FOR THE CONTRACTOR'S EXCLUSIVE USE DURING CONSTRUCTION SHALL BE MARKED BY THE CONTRACTOR. TEMPORARY BARRICADES, FLAGGING AND FLASHING WARNING LIGHTS WILL BE REQUIRED AT CRITICAL ACCESS POINTS. TYPE OF MARKING AND WARNING DEVICES SHALL BE APPROVED BY THE ENGINEER AND AIRPORT MANAGER.
- E. ALL ACCESS GATES SHALL BE KEPT CLOSED DURING CONTRACTOR'S WORK HOURS. THE CONTRACTOR SHALL CLOSE AND LOCK ACCESS GATE AT THE COMPLETION OF EACH WORK DAY. AIRPORT MANAGER WILL PROVIDE LOCK AND KEYS FOR ACCESS GATE.
- AT THE COMPLETION OF EACH WORKDAY OR WHEN NOT IN USE, CONSTRUCTION EQUIPMENT SHALL BE STORED IN THE CONTRACTOR'S STAGING AREA AND/OR DESIGNATED EQUIPMENT STAGING AREAS. CLOSED AREAS OF APRON PAVEMENT MAY BE USED FOR TEMPORARY STAGING OF EQUIPMENT WITH THE APPROVAL OF THE AIRPORT MANAGER.

### II. COORDINATION AND COMMUNICATION DURING CONSTRUCTION:

- CONTRACTOR SHALL ADVISE AND THEN VERIFY WITH RESIDENT ENGINEER 72 HOURS IN ADVANCE AS TO THE NEED FOR NOTICES TO AIR MISSIONS (NOTAMS). NO RUNWAY, TAXIWAY OR APRON SHALL BE CLOSED WITHOUT APPROVAL FROM THE AIRPORT MANAGER AND THE RESIDENT ENGINEER.
- B. CONTRACTOR SHALL APPOINT A CONSTRUCTION SUPERINTENDENT, SUBJECT TO THE APPROVAL OF THE AIRPORT MANAGER, WHO SHALL BE PRESENT ON THE CONSTRUCTION SITE AT ALL TIMES DURING WORKING HOURS WHILE JOB IS IN PROGRESS. THE SUPERINTENDENT SHALL BE DESIGNATED THE RESPONSIBLE CONTRACTOR'S REPRESENTATIVE WHO SHALL BE AVAILABLE ON A 24-HOUR BASIS.
- PRIOR TO CONSTRUCTION IN THE RESPECTIVE WORK AREAS, THE CONTRACTOR SHALL CORDON OFF THE WORK AREA AS SHOWN ON DRAWINGS PH-101 THROUGH PH-103 BY USING LOW PROFILE BARRICADES. CONTRACTOR SHALL MAINTAIN, MOVE AND REMOVE BARRICADES (AS DIRECTED BY THE ENGINEER) TO DELINEATE AREAS CLOSED TO AIRCRAFT TRAFFIC.
- D. PRIOR TO COMMENCEMENT OF CONSTRUCTION, CONTRACTOR SHALL SUBMIT TO AIRPORT MANAGER THE NAME AND TELEPHONE NUMBER OF THE INDIVIDUAL(S) WHO WILL BE ON CALL 24 HOURS PER DAY FOR EMERGENCY MAINTENANCE OF AIRPORT HAZARD LIGHTING & BARRICADES.
- E. THE CONTRACTOR SHALL HAVE ON-SITE AT ALL TIMES DURING WORKING HOURS, AN AIRPORT RADIO TO CONTINUOUSLY MONITOR AIRCRAFT TRAFFIC ON AND AROUND THE AIRPORT. THE COMMON TRAFFIC ADVISORY FREQUENCY IS 122.90. IT IS THE RESPONSIBILITY OF THE CONTRACTOR TO MONITOR AND GIVE WAY TO ALL AIRCRAFT TRAFFIC.

### III. TRAFFIC CONTROL:

- A. ALL CONSTRUCTION EQUIPMENT AND VEHICLES SHALL BE MARKED WITH COMPANY PAINTED DESIGNS, INSIGNIAS OR OTHER COMPANY MARKINGS, WHICH ARE CLEARLY VISIBLE. CONTRACTOR SHALL PROVIDE EACH VEHICLE WITH A FLAG ON A STAFF ATTACHED TO THE VEHICLE SO THAT THE FLAG WILL BE READILY VISIBLE. THE FLAG SHOULD BE AT LEAST 3 FOOT SQUARE, AND HAVE A CHECKERED PATTERN OF INTERNATIONAL ORANGE AND WHITE. ALL VEHICLES ON THE AIRFIELD SHALL BE LIT WITH A BEACON AND FLASHERS.
- B. CONSTRUCTION EQUIPMENT SHALL HAVE AUTOMATIC SIGNALING DEVICES TO SOUND AN ALARM WHEN MOVING IN REVERSE.
- C. ONLY RUBBER TIRED VEHICLES WILL BE ALLOWED ON PAVEMENT.
- D. NO PEDESTRIAN TRAFFIC OUTSIDE THE CONSTRUCTION WORK SITE WILL BE PERMITTED.
- E. ANY DAMAGE TO AIRPORT ROADS, AIRFIELD PAVEMENT, PARKING AREAS, STORAGE AREAS OR TURF AREAS DUE TO CONSTRUCTION EQUIPMENT OR CONSTRUCTION TRAFFIC SHALL BE REPAIRED TO ORIGINAL CONDITION TO THE SATISFACTION OF, AND AT NO EXPENSE TO THE OWNER.
- F. ANY WORKERS AND/OR EQUIPMENT NOT IN COMPLIANCE WITH CONSTRUCTION SAFETY AND PHASING PLAN SHALL IMMEDIATELY BE REMOVED FROM THE WORK AREA AND THEY WILL NOT BE PERMITTED TO WORK ON THE SITE THROUGHOUT THE REMAINDER OF THE PROJECT.

### IV. EQUIPMENT AND STOCKPILE HEIGHT:

- A. THE MAXIMUM ALLOWABLE HEIGHT OF CONSTRUCTION EQUIPMENT OPERATING IN THE AOA SHALL BE IN CONFORMANCE WITH THE FAA FORM 7460 DEVELOPED FOR THIS PROJECT. EQUIPMENT MUST NOT PENETRATE THE ROFA OF ANY ACTIVE RUNWAY, OR TOFA OF ANY ACTIVE TAXIWAY, AS DEFINED IN FAA AC 150/5300-13, (CURRENT EDITION). ANY DEVIATIONS FROM THE APPROVED FAA FORM 7460 MUST BE APPROVED BY THE AIRPORT AND RESUBMITTED TO THE FAA. ADDITIONAL FAA SUBMITTAL SHALL HAVE NO IMPACT ON THE CONSTRUCTION SCHEDULE.
- B. CONTRACTOR SHALL NOT STOCKPILE CONSTRUCTION MATERIALS, SPOILS, DEBRIS OR REFUSE IN ANY AREA WHERE SUCH STOCKPILES WOULD PENETRATE APPROACH SURFACES. STOCKPILING OF MATERIAL WITHIN THE SAFETY AREA AND THE OBJECT FREE AREA OF AN ACTIVE RUNWAY OR TAXIWAY IS PROHIBITED.
- C. ALL STOCKPILES ADJACENT TO ACTIVE RUNWAY SAFETY AREAS OR OBSTACLE FREE ZONES SHALL BE IDENTIFIED WITH AN ORANGE & WHITE CONSTRUCTION FLAG AND A 360 DEGREE RED OBSTRUCTION LIGHT PLACED AT THE HIGHEST POINT OF THE STOCKPILE.
- D. STOCKPILED MATERIAL SHALL BE CONTAINED IN A MANNER TO PREVENT MOVEMENT AND/OR DUST RESULTING FROM AIRCRAFT PROPELLER WASH OR WIND CONDITIONS. IN ADDITION, STOCKPILED MATERIAL SHALL HAVE SILT FENCE PLACED AROUND IT TO PREVENT FOD FROM MOVING ONTO THE AIRFIELD PAVEMENTS OR POLLUTING WATERCOURSES.

### V. EXCAVATION AND TRENCHES:

- A. ALL BARRICADES LOCATED WITHIN OR ADJACENT TO AREAS OF AIRCRAFT OPERATION SHALL BE LOW PROFILE TYPE AS DETAILED ON SHEET PH-501.
- B. OPEN TRENCHES AND EXCAVATIONS AT THE CONSTRUCTION SITE SHALL BE PROMINENTLY MARKED WITH ORANGE BARRICADES WITH FLASHING RED LIGHTS ACCEPTABLE TO THE AIRPORT MANAGER.
- C. ALL CONSTRUCTION AREAS THAT POSE A HAZARD TO OPERATING AIRCRAFT SHALL BE PROPERLY MARKED WITH LOW-PROFILE BARRICADES.
- D. LOW PROFILE BARRICADES SHALL BE KEPT OUTSIDE THE LIMITS OF ANY ACTIVE RUNWAY SAFETY AREA OR TAXIWAY OBJECT FREE AREA.

### VI. OTHER SAFETY REQUIREMENTS:

- A. CONTRACTOR SHALL MAINTAIN SAFETY PRACTICES THAT CONFORM TO OCCUPATIONAL SAFETY AND HEALTH ADMINISTRATION (OSHA) REGULATIONS.
- B. WASTE AND LOOSE MATERIALS CAPABLE OF CAUSING DAMAGE TO AIRCRAFT SHALL NOT BE LEFT WITHIN ACTIVE AIRCRAFT MOVEMENT AREAS. MATERIAL DROPPED WITHIN THESE AREAS SHALL BE CLEANED UP IMMEDIATELY TO THE SATISFACTION OF THE AIRPORT MANAGER OR THE ENGINEER.
- C. ALL TRASH RECEPTACLES SHALL BE PROPERLY COVERED TO PREVENT FOD.
- D. THE CONTRACTOR SHALL CONTROL BLOWING DUST FROM ANY HAUL ROUTE OR WORK AREA REGARDLESS OF SOURCE.
- E. THE CONTRACTOR SHALL BE REQUIRED TO USE A WATER TRUCK AND A SWEEPER DURING ALL CONSTRUCTION ACTIVITIES AND AS DIRECTED BY THE AIRPORT MANAGER. COST FOR THE DUST CONTROL AND SWEEPING WILL NOT BE PAID FOR SEPARATELY, BUT WILL BE CONSIDERED INCIDENTAL TO THE CONTRACT.
- F. THE CONTRACTOR MUST ATTEND A MANDATORY SAFETY TRAINING MEETING LED BY THE AIRPORT STAFF PRIOR TO THE START OF CONSTRUCTION.
- G. PRIOR TO THE COMPLETION OF EACH WORK DAY, ALL AIRFIELD PAVEMENT SURFACES WITHIN AND ADJACENT TO THE WORK AREA AND THOSE USED AS HAUL ROUTES SHALL BE SWEPT CLEAN.

### VII. CONTRACTOR SAFETY PLAN SUBMITTALS:

- F. CONTRACTOR SHALL FURNISH A SAFETY PLAN COMPLIANCE DOCUMENT (SPCD) THAT PROVIDES DETAILED INFORMATION REGARDING COMPLIANCE WITH THE PROJECT'S CONSTRUCTION SAFETY AND PHASING PLAN IN CONJUNCTION WITH HIS/HER PROJECT SCHEDULE. CONTRACTOR SHALL PROVIDE SPCD 10 DAYS PRIOR TO THE PRE-CONSTRUCTION MEETING. INFORMATION SHALL INCLUDE BUT NOT BE LIMITED TO THE FOLLOWING ITEMS:
  - 19. PROPOSED ACCESS POINTS, STAGING AREA AND HAUL ROUTES.
  - 20. ANY TEMPORARY MARKINGS TO BE USED.
  - 21. THE LOCATION AND TYPE OF BARRICADES OR OTHER TRAFFIC CONTROL DEVICES.
  - 22. AREAS TO WHICH CONSTRUCTION OPERATIONS WILL BE LIMITED, ALONG WITH PROPOSED MEASURES TO MINIMIZE THE POSSIBILITY OF CONTRACTOR EQUIPMENT AND/OR WORKERS ACCIDENTALLY ENTERING ANY AOA.
  - 23. ANY REQUESTED TEMPORARY AMENDMENTS TO THE AIRPORT SECURITY PLAN FOR SPECIAL CONDITION OR MODIFICATIONS.
- B. CONTRACTOR SPCD SHALL COMPLY WITH ALL REQUIREMENTS INDICATED IN THESE DRAWINGS, SPECIFICATIONS AND SPECIAL PROVISIONS, AND FAA ADVISORY CIRCULAR (AC) 150/5370-2, OPERATIONAL SAFETY ON AIRPORTS DURING CONSTRUCTION, (CURRENT EDITION).

### **GENERAL NOTES:**

- 1. IT IS THE RESPONSIBILITY OF THE CONTRACTOR TO SUBMIT, OBTAIN AND PAY FOR ALL APPLICABLE PERMITS, FEES AND LICENSES FOR CONSTRUCTION AND EQUIPMENT.
- 2. TRAFFIC MAINTENANCE, INCLUDING BUT NOT LIMITED TO, BARRICADES, TAXIWAY CLOSURE MARKERS, ETC SHALL NOT BE PAID FOR SEPARATELY BUT SHALL BE CONSIDERED INCIDENTAL TO THE CONTRACT.
- THE CONTRACTOR SHALL BE RESPONSIBLE FOR MAINTAINING CONSTANT COORDINATION BETWEEN THE SUBCONTRACTORS AND THE ENGINEER. ALL CONSTRUCTION ACTIVITIES PLANNED BY THE CONTRACTOR SHALL BE REVIEWED AND APPROVED BY THE ENGINEER AND OWNER.
- 4. LIMITS OF WORK SHALL BE VERIFIED IN THE FIELD BY THE CONTRACTOR AND APPROVED BY THE ENGINEER PRIOR TO BEGINNING WORK.
- 5. THERE SHALL BE NO PERMANENT WASTE SITES ON AIRPORT PROPERTY. ANY TEMPORARY WASTE AREA WILL BE APPROVED BY THE ENGINEER AND SHALL BE KEPT IN A NEAT CONDITION. THE OWNER MAY DIRECT THE CONTRACTOR TO REMOVE WASTE IF NOT PROPERLY MAINTAINED.
- PRIOR TO COMPLETION OF THE PROJECT THE CONTRACTOR SHALL RESTORE ALL DAMAGED AREAS (NOT DESIGNATED FOR CONSTRUCTION) TO THEIR PRE-CONSTRUCTION CONDITION.
- 7. LOCATING, FLAGGING, AND PROTECTING ALL EXISTING UTILITIES DURING THE DURATION OF THE CONSTRUCTION PROJECT IS THE RESPONSIBILITY OF THE CONTRACTOR. THE LOCATIONS OF THE EXISTING UTILITIES ON THE CONTRACT DRAWINGS WERE OBTAINED FROM EXISTING RECORDS AND NO GUARANTEE OF ACCURACY OR SUFFICIENCY FOR THIS INFORMATION IS ASSUMED BY THE OWNER OR ENGINEER. ANY DAMAGE TO ANY EXISTING UTILITIES WILL BE REPAIRED OR REPLACED BY THE CONTRACTOR TO THE SATISFACTION OF AND AT NO EXPENSE TO THE AIRPORT MANAGER.
- 8. THE CONSTRUCTION COVERED BY THE PLANS SHALL CONFORM TO ALL APPLICABLE STANDARDS AND SPECIFICATIONS OF THE FAA AND IDOT.
- 9. ALL WORKMANSHIP AND MATERIALS SHALL BE SUBJECT TO INSPECTION AND APPROVAL OF THE ENGINEER
- 0. CONTRACTOR SHALL EXAMINE THE FINISHED SURFACE, GRADES, TOPSOIL QUALITY, AND TOPSOIL DEPTH PRIOR TO LANDSCAPING. NO WORK SHALL BE CONDUCTED UNTIL UNSATISFACTORY CONDITIONS HAVE BEEN CORRECTED. CONTRACTOR SHALL VERIFY LIMITS OF WORK WITH THE ENGINEER BEFORE STARTING.
- 11. CONTRACTOR SHALL IMPORT AND/OR PROVIDE SALVAGED TOPSOIL MEETING THE REQUIREMENTS OF THE ILLINOIS DEPARTMENT OF TRANSPORTATION SPECIFICATIONS.
- 12. THE CONTRACTOR SHALL FURNISH AND PLACE A MINIMUM OF 4.00 INCHES OF TOPSOIL, WITH THE LOWER PORTION BLENDED INTO EXISTING SOILS.
- 13. PROPOSED ELEVATIONS INDICATED ARE FOR TOP OF FINAL GRADE, PAVEMENT, OR STRUCTURE UNLESS INDICATED OTHERWISE.
- 14. ELEVATIONS DENOTED AS "MATCH" ARE INTENDED TO MEET EXISTING GRADE ELEVATIONS. CONTRACTOR SHALL VERIFY ELEVATIONS AT TIE-INS AND MATCH POINTS PRIOR TO BEGINNING CONSTRUCTION AND VERIFY WITH THE ENGINEER.
- 15. ADEQUATE DRAINAGE SHALL BE MAINTAINED AT ALL TIMES DURING CONSTRUCTION. ANY DRAINAGE FEATURE OR STRUCTURE DISTURBED DURING CONSTRUCTION SHALL BE RESTORED TO EXISTING CONDITIONS OR BETTER SUBJECT TO THE APPROVAL OF THE AIRPORT MANAGER. ANY REWORK OR ADDITIONAL WORK REQUIRED BECAUSE OF THE CONTRACTOR'S FAILURE TO MAINTAIN ADEQUATE DRAINAGE WILL BE AT THE CONTRACTOR'S EXPENSE.
- 16. THE CONTRACTOR SHALL REMOVE STANDING WATER FROM THE PROJECT WORK LIMITS AS NECESSARY TO PROTECT SUBGRADE, SUBBASE, AND/OR BASE COURSE TO NEW PAVEMENT, SURROUNDING PAVEMENT-TO-REMAIN, OR OTHER COMPLETED WORKS.
- 17. CONNECTION TO EXISTING WATER, SEWER, AND STORM MAINS SHALL BE CONSTRUCTED IN ACCORDANCE WITH ALL REQUIREMENTS OF ASSOCIATED UTILITY COMPANIES AND AGENCIES.
- 18. CONTRACTOR IS RESPONSIBLE FOR COORDINATING AND PAYING ALL UTILITY CONNECTION FEES AND OBTAINING ALL PERMITS REQUIRED FOR THE UTILITY CONSTRUCTION AND CONNECTIONS. THIS INCLUDES ALL FEES ASSOCIATED WITH CONNECTION CHARGES AND METERS.
- 19. THE CONTRACTOR SHALL NOTE THAT OTHER CONTRACTORS MAY BE WORKING IN THE VICINITY OF THE PROJECT AND MAY REQUIRE ACCESS TO THEIR WORK AREAS. THE CONTRACTOR SHALL NOT DIRECTLY COMMUNICATE WITH THE CONTRACTORS ON OTHER PROJECTS UNLESS AUTHORIZED TO DO SO. COOPERATION OF THE CONTRACTOR WITH ADJACENT PROJECTS IS EXPECTED.



4201 WINFIELD ROAD SUITE 600 WARRENVILLE, IL 60555 TEL (630) 487-5550

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CCESS, SAFETY AND GENERAL NOTES

DINSTRUCT REPLACEMENT PARALLEL TAXIWAY AN EPLACE AIRPORT ROTATING BEACON

OIS

CERTIFICATION:

OF ESSION

JUNAID YAHYA

OF ILLINO'S

EXP. 11/3

11/22/2024

DRAWING NO.

GC-102

LEGEND



PROJECT AREA

SURVEY MONUMENT

### NOTES

- 1. THE SURVEY WAS BASED ON THE NORTH AMERICAN DATUM OF 1983 (NAD83) HORIZONTALLY AND THE NORTH AMERICAN VERTICAL DATUM (NAVD88) VERTICALLY. COORDINATES WERE GENERATED IN ILLINOIS STATE PLANE, EAST ZONE IN UNITS OF U.S. SURVEY FOOT.
- 2. THE CONTRACTOR IS RESPONSIBLE FOR ALL CONSTRUCTION SURVEYING. ANY DEVIATIONS FROM THE EXISTING GRADES AS SHOWN ON THE PLANS SHALL BE IMMEDIATELY REPORTED TO THE ENGINEER. THE CONTRACTOR SHALL PROVIDE THE ENGINEER THEIR EXISTING GROUND SURVEY PRIOR TO STARTING THE EARTHWORK.



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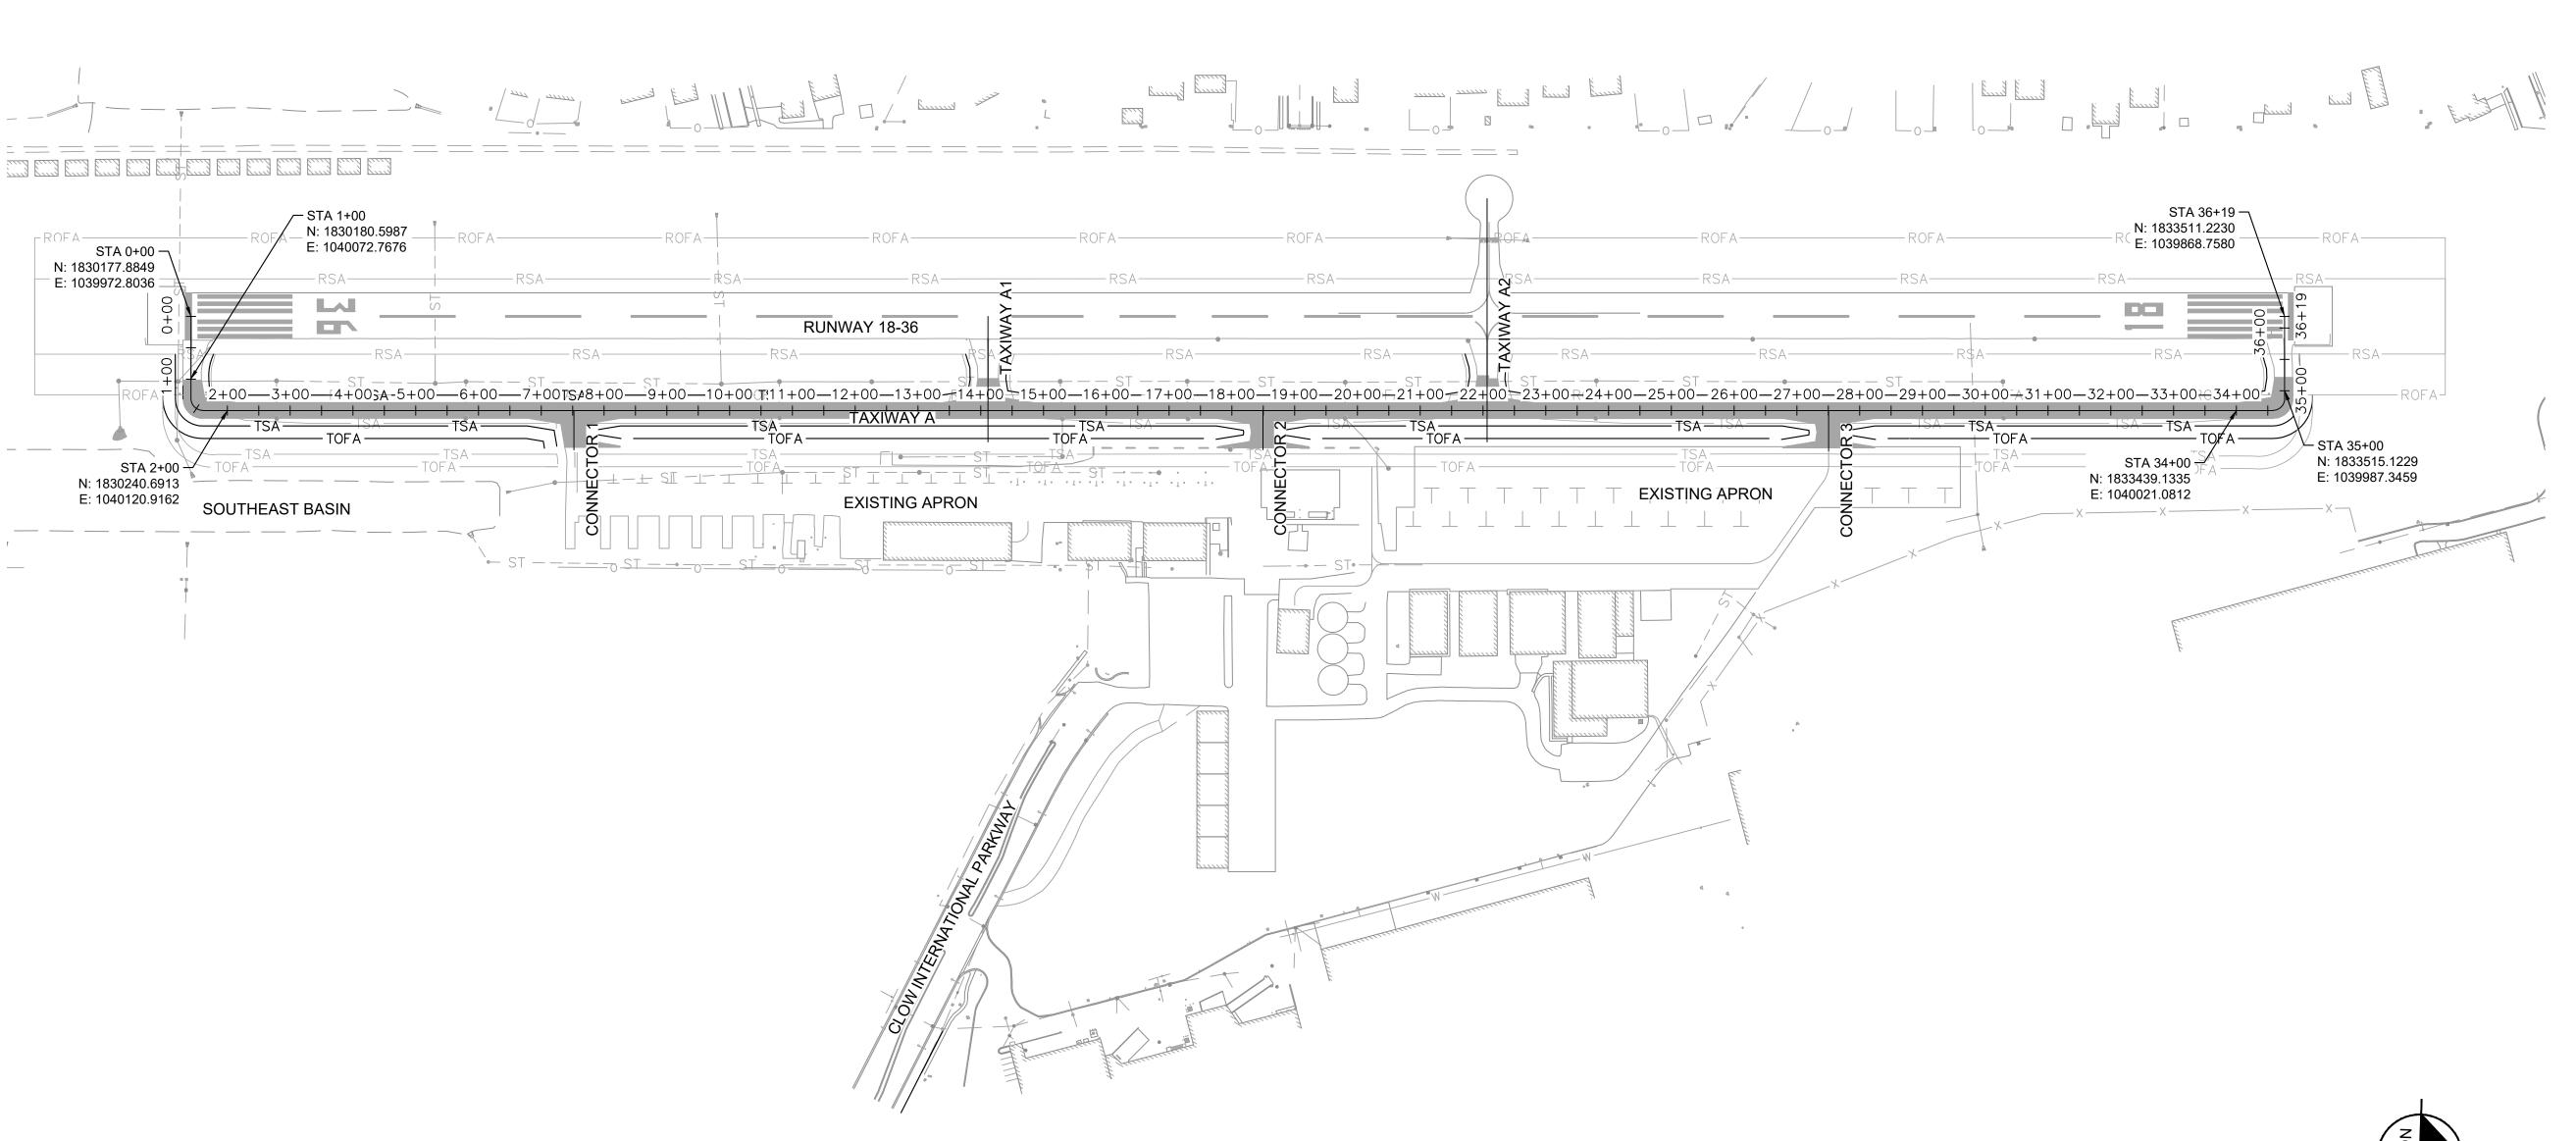
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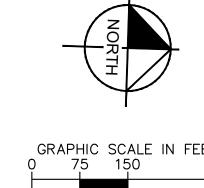
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AND P -AXIWAY NTROL

CERTIFICATION: DRÁWING NO.

GC-103








### AIRSPACE CRITICAL LOCATIONS (7460)

	FAA TEMPORARY 7460-1 POINT TABLE								
POINT#	DESCRIPTION	NORTHING	EASTING	MAX STRUCTURE HEIGHT	ELEVATION	OVERALL OBJECT HEIGHT	LATITUDE	LONGITUDE	ASN
1	CONTRACTOR EQUIPMENT	1830151.84	1040065.08	25'	655'	680'	N41° 41' 28.52"	W88° 07' 44.31"	2024-AGL-12957-NRA
2	CONTRACTOR EQUIPMENT	1830155.95	1040196.83	25'	646'	671'	N41° 41' 28.56"	W88° 07' 42.57"	2024-AGL-12958-NRA
3	CONTRACTOR EQUIPMENT	1833546.27	1040091.00	25'	670'	695'	N41° 42' 02.06"	W88° 07' 43.86"	2024-AGL-12959-NRA
4	CONTRACTOR EQUIPMENT	1833542.17	1039959.69	25'	673'	698'	N41° 42' 02.02"	W88° 07' 45.59"	2024-AGL-12960-NRA
5	CONTRACTOR EQUIPMENT	1831094.91	1040253.44	60'	658'	718'	N41° 41' 37.84"	W88° 07' 41.80"	2024-AGL-12961-NRA
6	CONTRACTOR EQUIPMENT	1831097.62	1040340.13	60'	658'	718'	N41° 41' 37.86"	W88° 07' 40.65"	2024-AGL-12962-NRA
7	CONTRACTOR EQUIPMENT	1831226.54	1040336.10	60'	659'	719'	N41° 41' 39.13"	W88° 07' 40.70"	2024-AGL-12963-NRA
8	CONTRACTOR EQUIPMENT	1831224.00	1040249.41	60'	659'	719'	N41° 41' 39.11"	W88° 07' 41.84"	2024-AGL-12964-NRA

	FAA PERMANENT 7460-1 POINT TABLE								
POINT #	DESCRIPTION	NORTHING	EASTING	MAX STRUCTURE HEIGHT	ELEVATION	OVERALL OBJECT HEIGHT	LATITUDE	LONGITUDE	ASN
9	ROTATING BEACON	1831198.04	1040314.09	38'	659'	697'	N41° 41' 38.85"	W88° 07' 40.99"	2024-AGL-15888-NRA

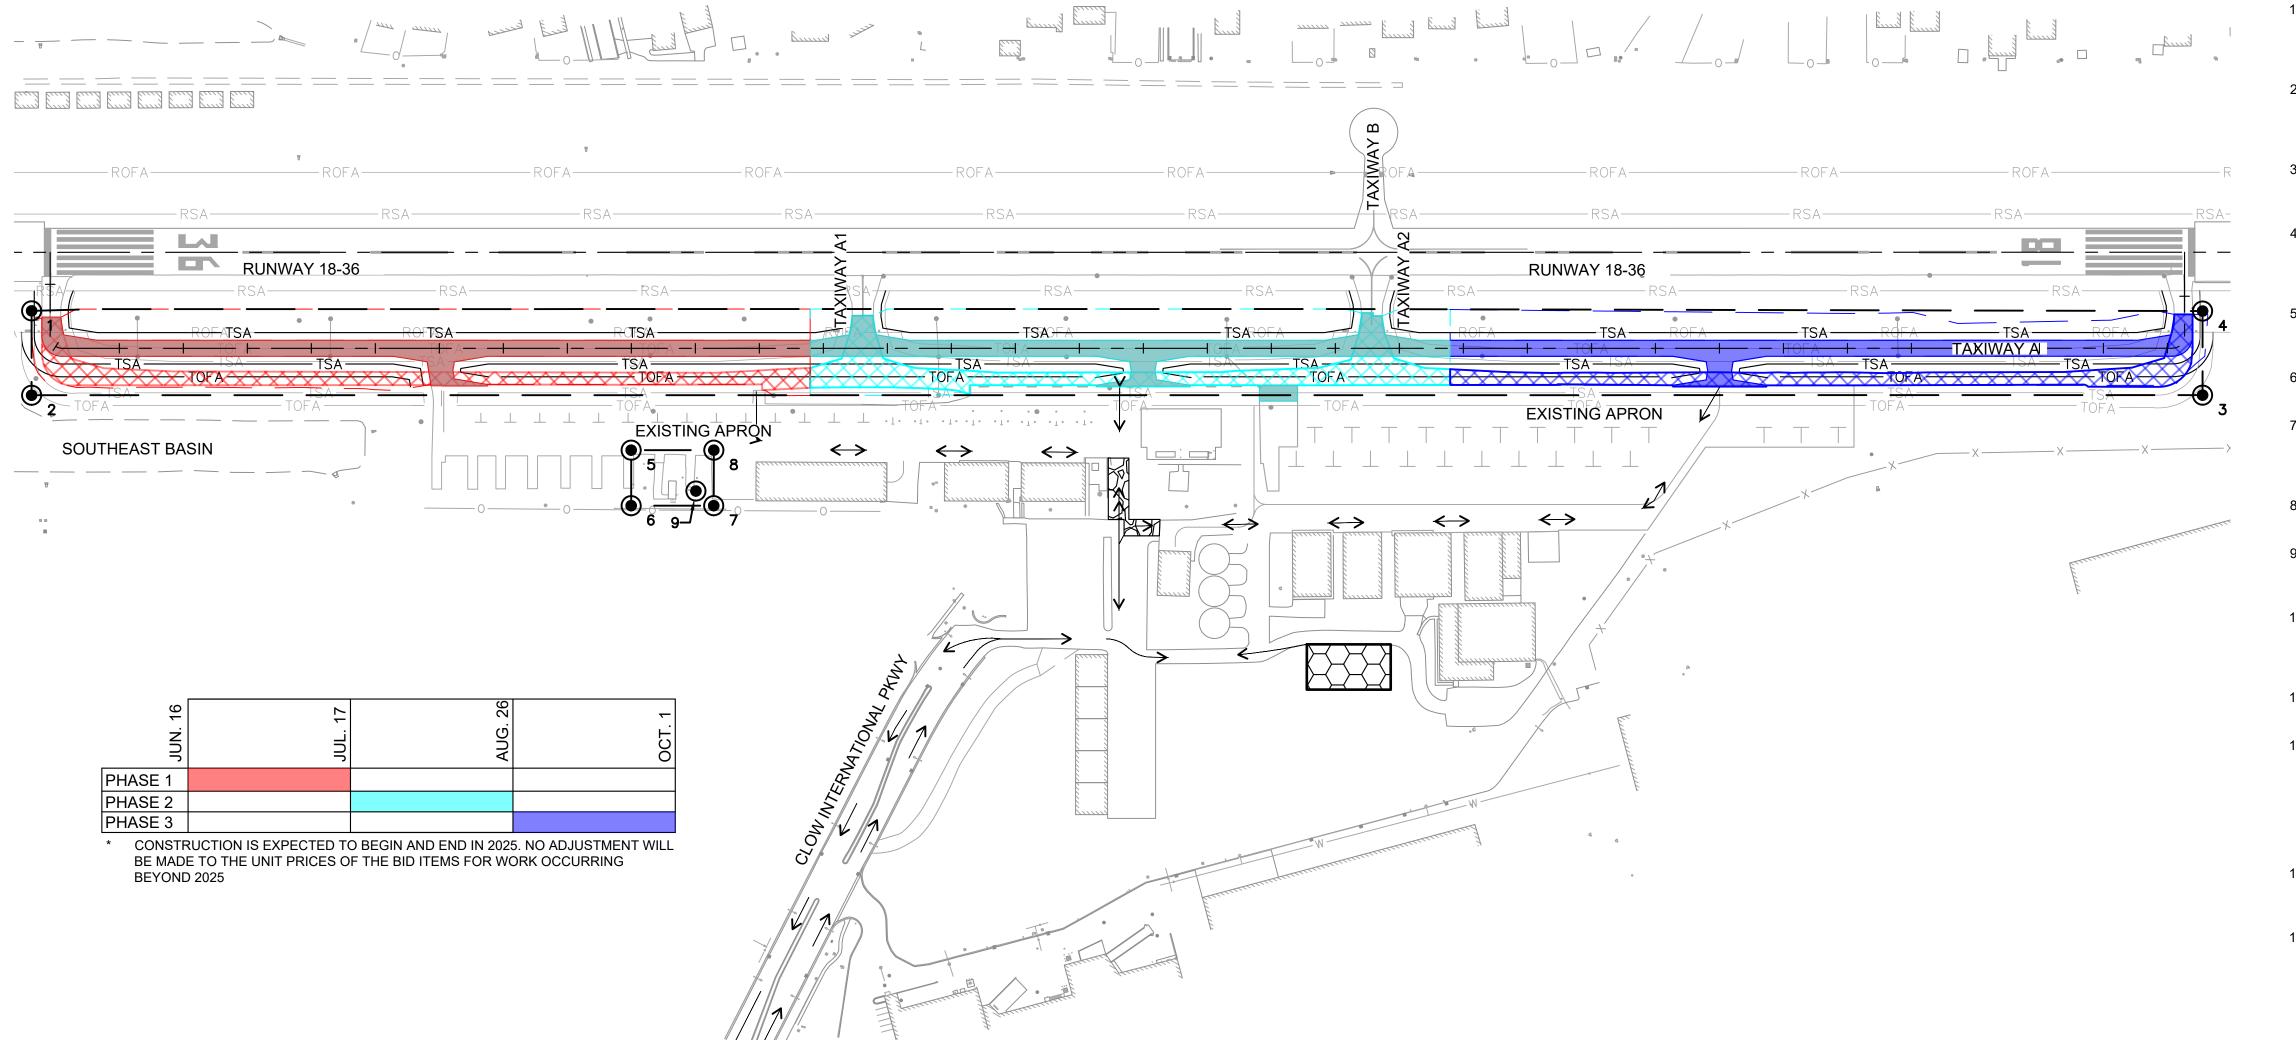



PHASE 1



PHASE 1 DEMO LIMITS



PHASE 2



PHASE 2 DEMO LIMITS

PHASE 3 DEMO LIMITS



PHASE 3



CONTRACTOR STAGING, CONCRETE WASHOUT, AND MATERIALS STORAGE AREA



CONSTRUCTION ENTRANCE, SEE DETAIL 2/PH-501






AIRSPACE EVALUATION LIMITS



AIRSPACE CRITICAL LOCATIONS

### **GENERAL NOTES**

- THE CONTRACTOR SHALL PROVIDE A CONSTRUCTION SCHEDULE TO THE AIRPORT AND RESIDENT ENGINEER FOR APPROVAL IN ACCORDANCE WITH THESE PHASING PLANS. SPECIFICATIONS, AND GENERAL PROVISIONS.
- PRIOR TO IMPLEMENTATION OF THIS PLAN, THE AIRPORT WILL ANALYZE ALL CONSTRUCTION ACTIVITY AND/OR OTHER SPECIALIZED ACTIVITY ON THE AIRPORT AND DETERMINE THE LIMITATIONS TO BE IMPOSED.
- SUBSTANTIAL COMPLETION OF WORK SHALL INCLUDE ALL WORK REQUIRED TO OPEN TAXIWAY, TAXILANE, APRONS AND HANGARS TO OPERATIONAL USE BY AIRCRAFT.
- WORK WITHIN ACTIVE TAXIWAY SAFETY AND/OR OBJECT FREE AREAS SHALL BE PERFORMED IN ACCORDANCE WITH THE PHASING PLANS AND SHALL BE COORDINATED WITH THE
- THE CONTRACTOR SHALL COORDINATE WITH THE AIRPORT AND RESIDENT ENGINEER ON EXCESS TOPSOIL STOCKPILE
- THE CONTRACTOR SHALL BE AWARE AND YIELD TO ALL ACTIVE AIRCRAFT OPERATIONS DURING CONSTRUCTION.
- THE CONTRACTOR SHALL ACCESS EACH WORK AREA BY THE HAUL ROUTES SHOWN ON THE PLANS. ANY DEVIATION TO THE HAUL ROUTES MUST BE APPROVED BY THE AIRPORT AND RESIDENT ENGINEER.
- THE CONTRACTOR SHALL MAINTAIN ACCESS TO SERVICE ROADS AND AIRPORT TENANT AREAS AT ALL TIMES.
- THE CONTRACTOR SHALL UTILIZE THE AIRPORT ENTRANCE AT CLOW INTERNATIONAL PARKWAY TO GAIN ACCESS TO THE
- 10. THE USE OF OFF-ROAD TRUCKS ARE NOT PERMITTED ON THE AIRPORT SERVICE DRIVES OR OTHER ROADWAYS. THE CONTRACTOR CAN ONLY UTILIZE TRUCKING EQUIPMENT SUITABLE FOR OVER-THE-ROAD USE.
- 11. THE CONTRACTOR SHALL LIMIT TRUCK TRAFFIC BACKING UP ON CLOW INTERNATIONAL PARKWAY.
- 12. THE EXISTING AND PROPOSED STRUCTURAL PAVEMENT SECTION WAS DESIGNED EXCLUSIVELY FOR USE BY SMALL AIRCRAFT. THE CONTRACTOR SHALL TAKE THE NECESSARY PRECAUTIONS TO PROTECT THE PAVEMENT AND SUBGRADE FROM DAMAGE, WHICH MAY INCLUDE, BUT NOT BE LIMITED TO, USE OF TRACKED EQUIPMENT, AT NO ADDITIONAL COST TO THE CONTRACT.
- 13. THE CONTRACTOR SHALL CONDUCT POWER VACUUM CLEANING IMMEDIATELY FOLLOWING ANY ACCESS ONTO OR CROSSING OF THE PAVEMENT BY CONSTRUCTION TRAFFIC.
- 14. NOTICE OF PROPOSED CONSTRUCTION WAS SUBMITTED ON AUGUST 19, 2024 TO THE FAA OBSTRUCTION EVALUATION/ AIRPORT AIRSPACE ANALYSIS (OE/AAA), PROJECT NUMBER: BOLI-629620934-24

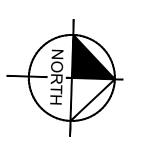

SHEET IN COLOR



Kimley» Horn


4201 WINFIELD ROAD SUITE 600 WARRENVILLE, IL 60555 TEL (630) 487-5550


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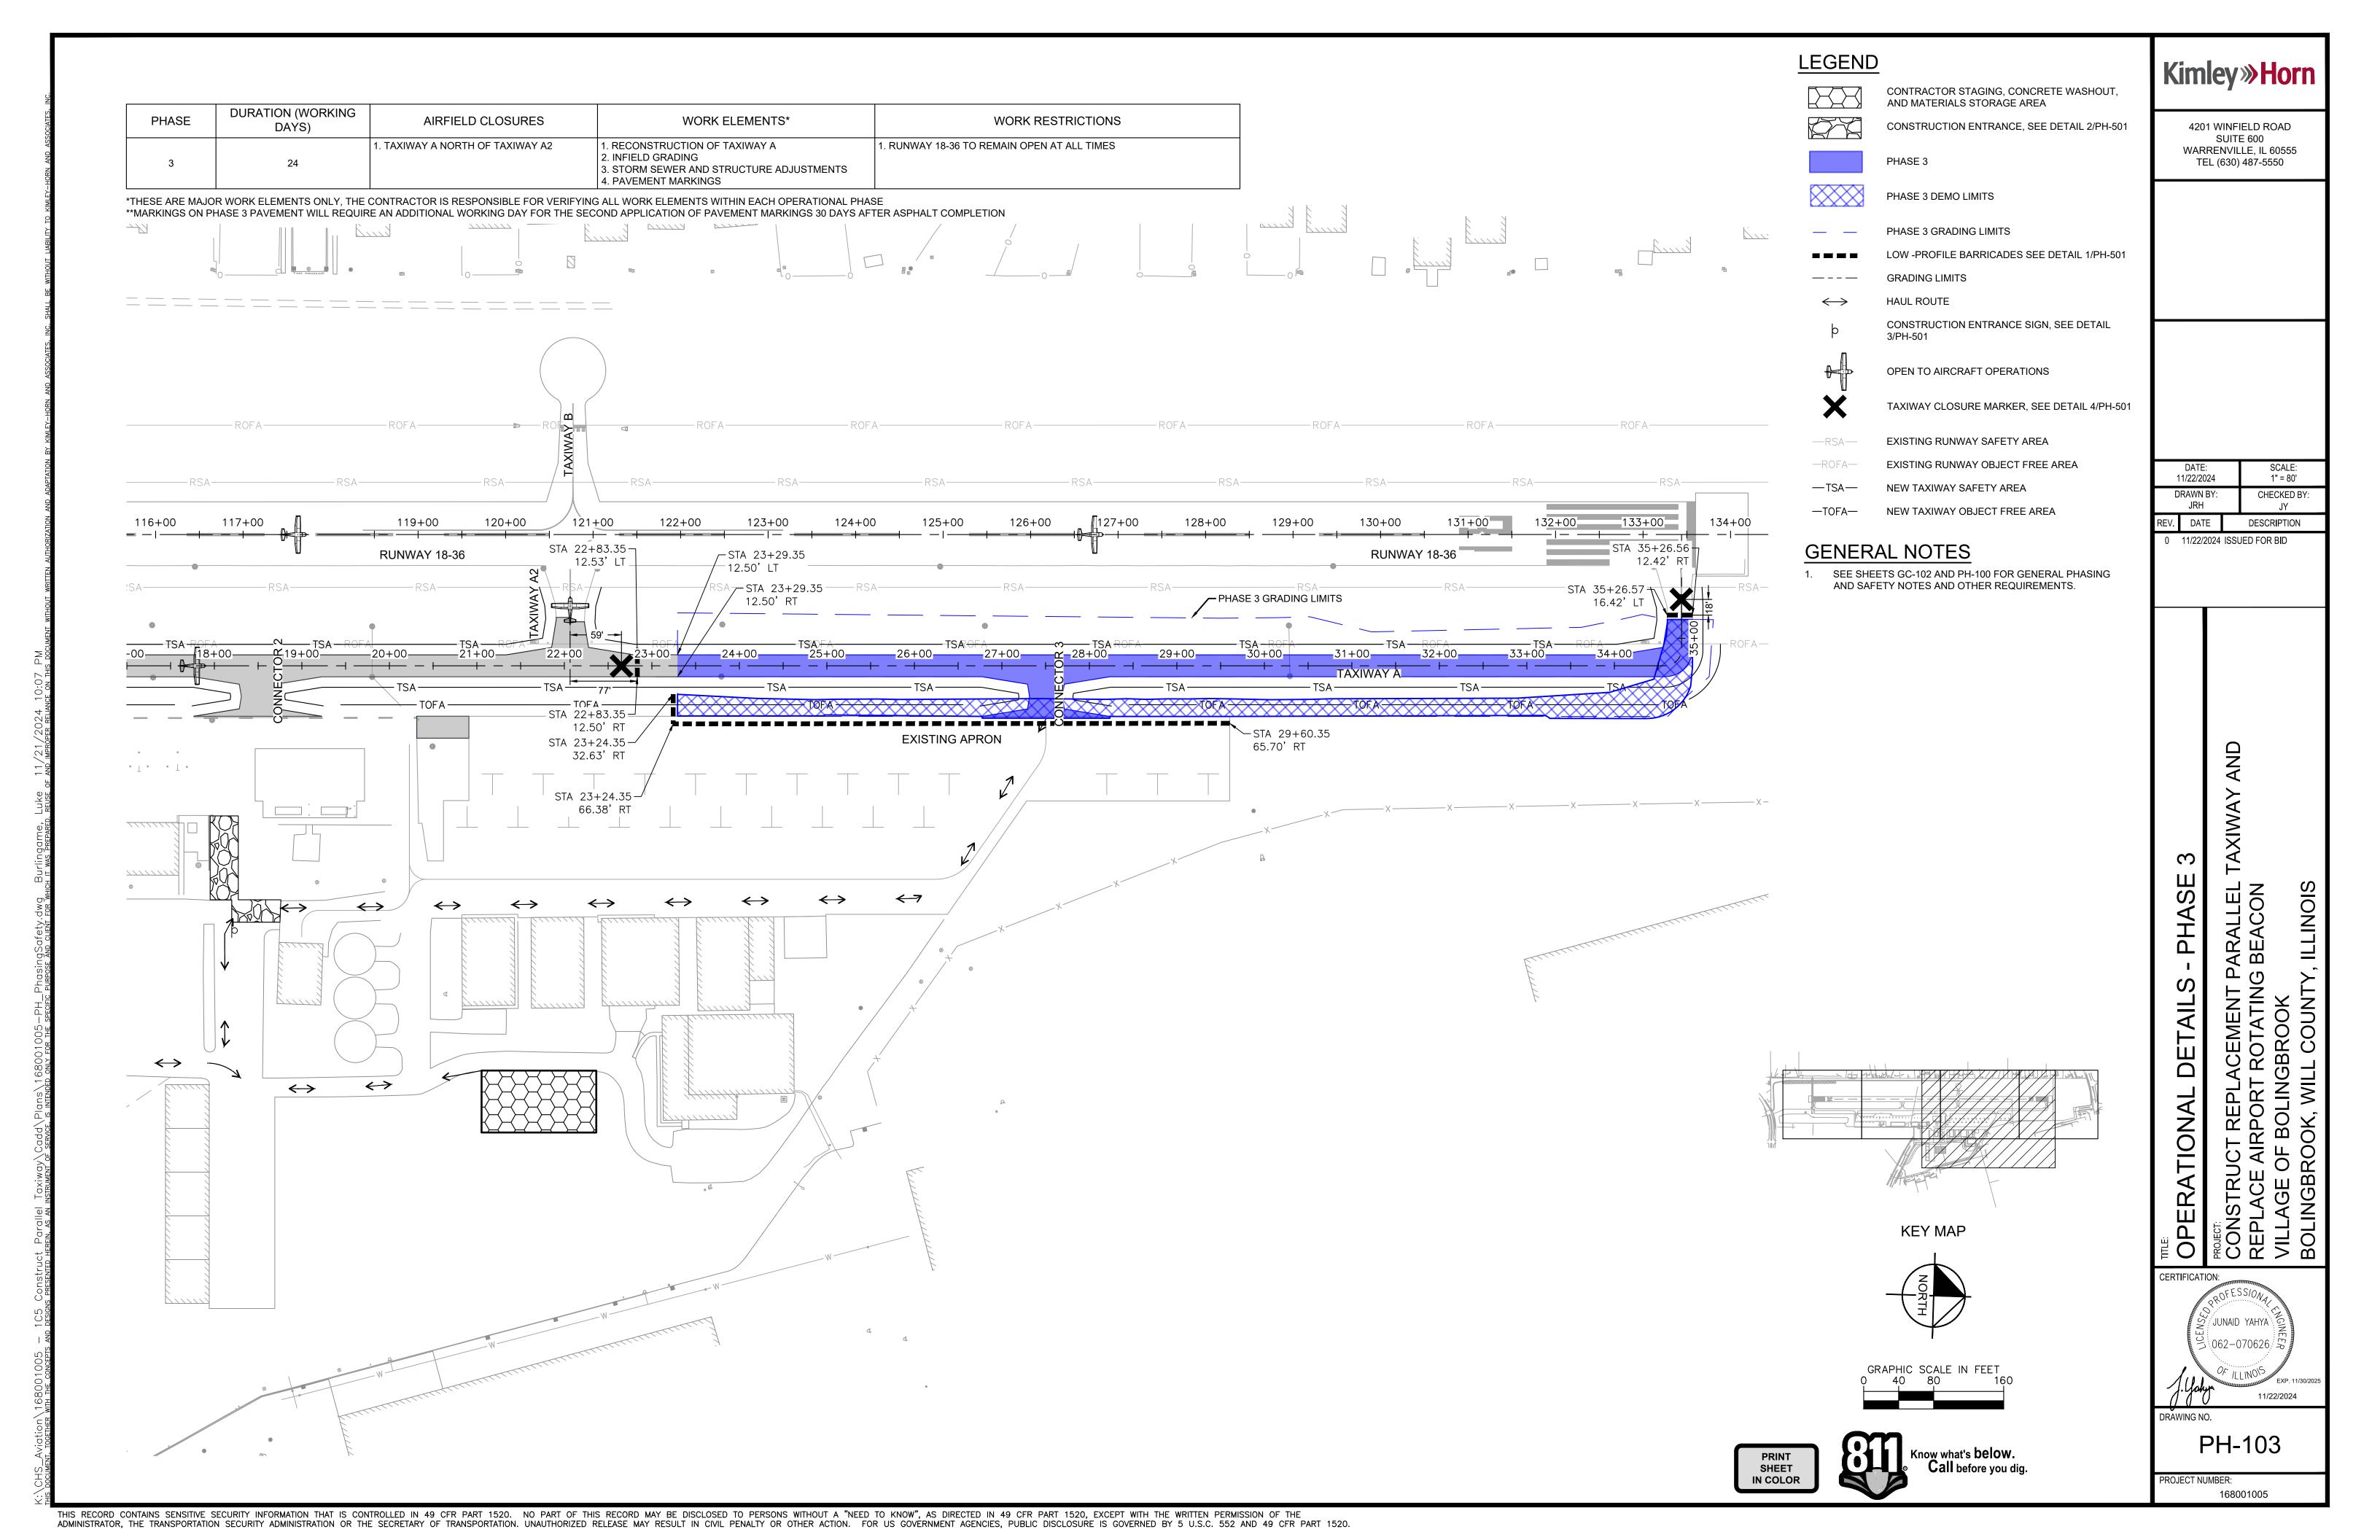
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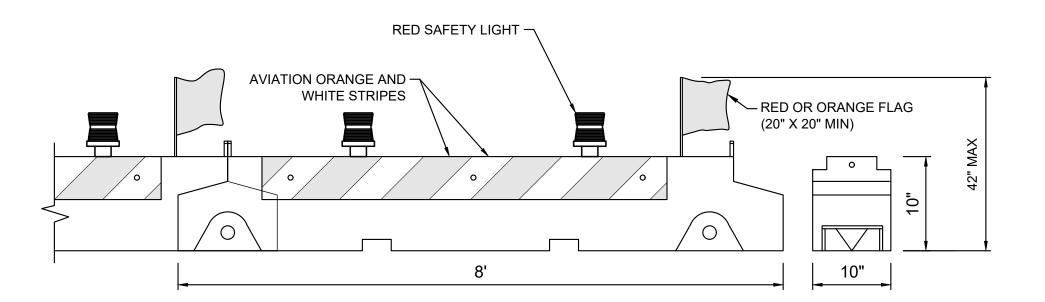
CERTIFICATION: JUNAID YAHYA 5 062-070626 5 11/22/2024 DRAWING NO.

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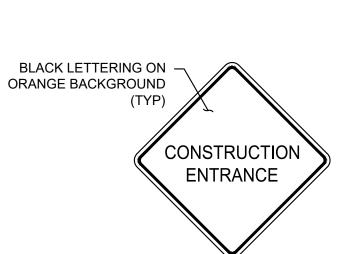




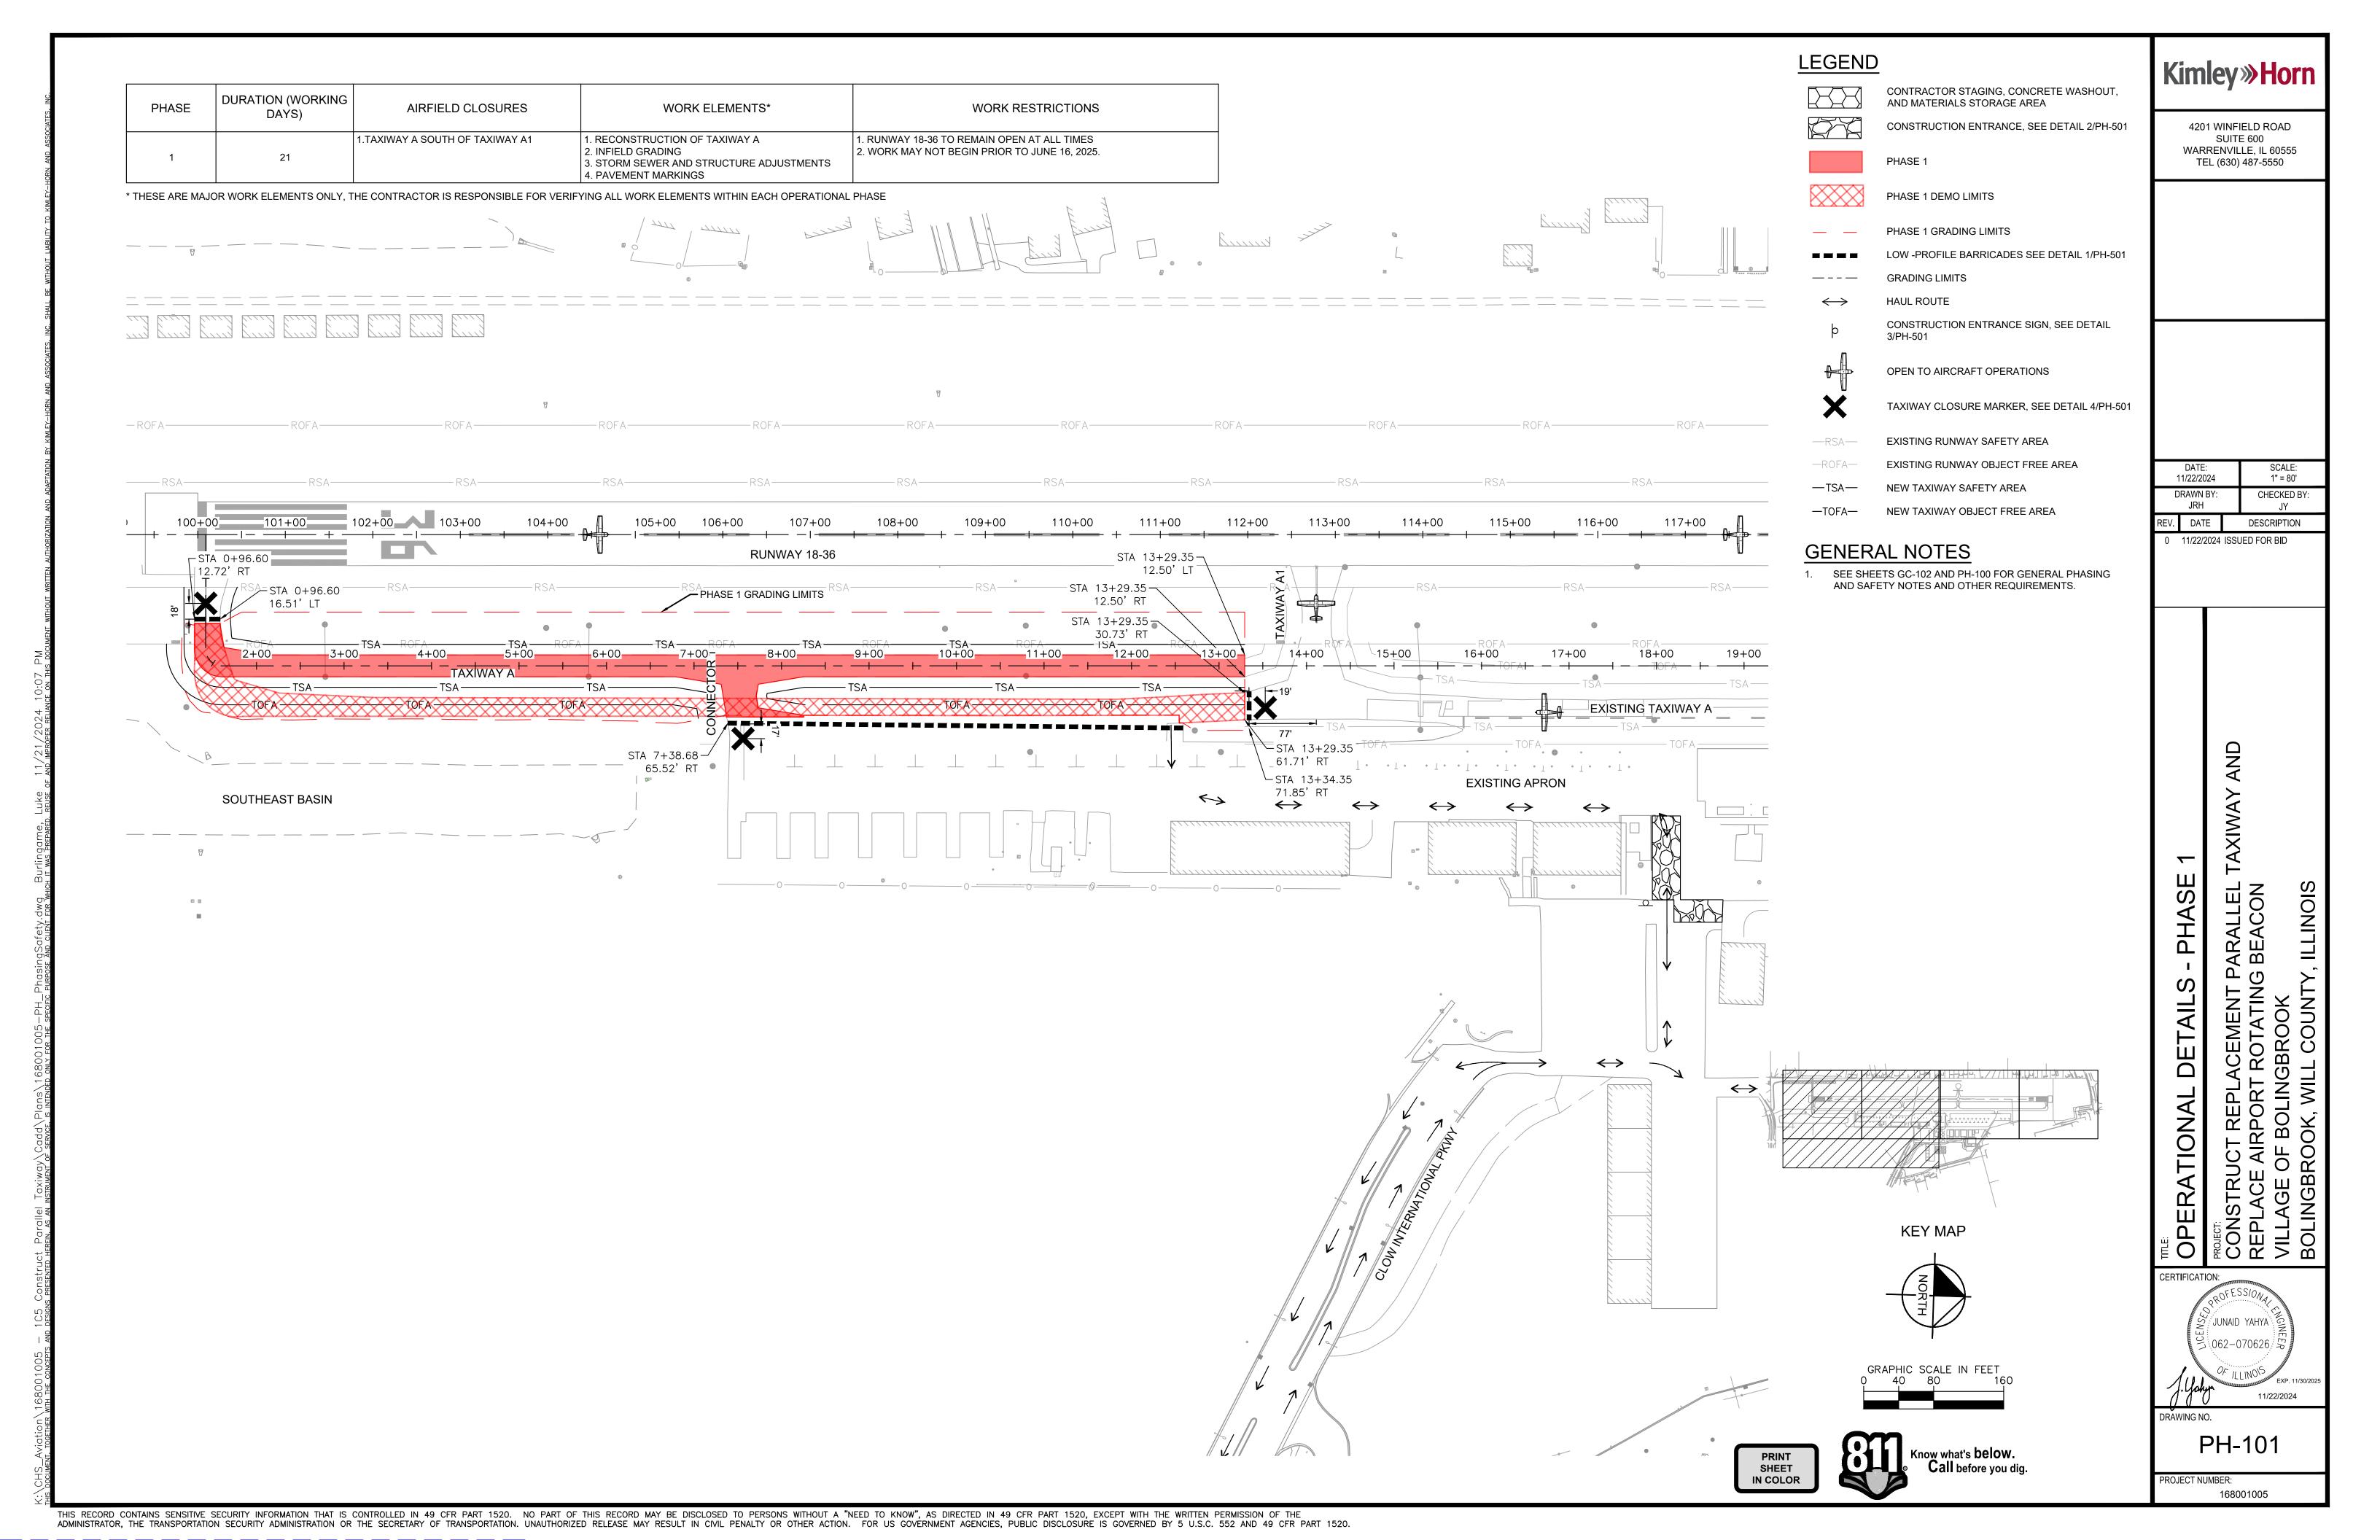


### BARRICADE NOTES:

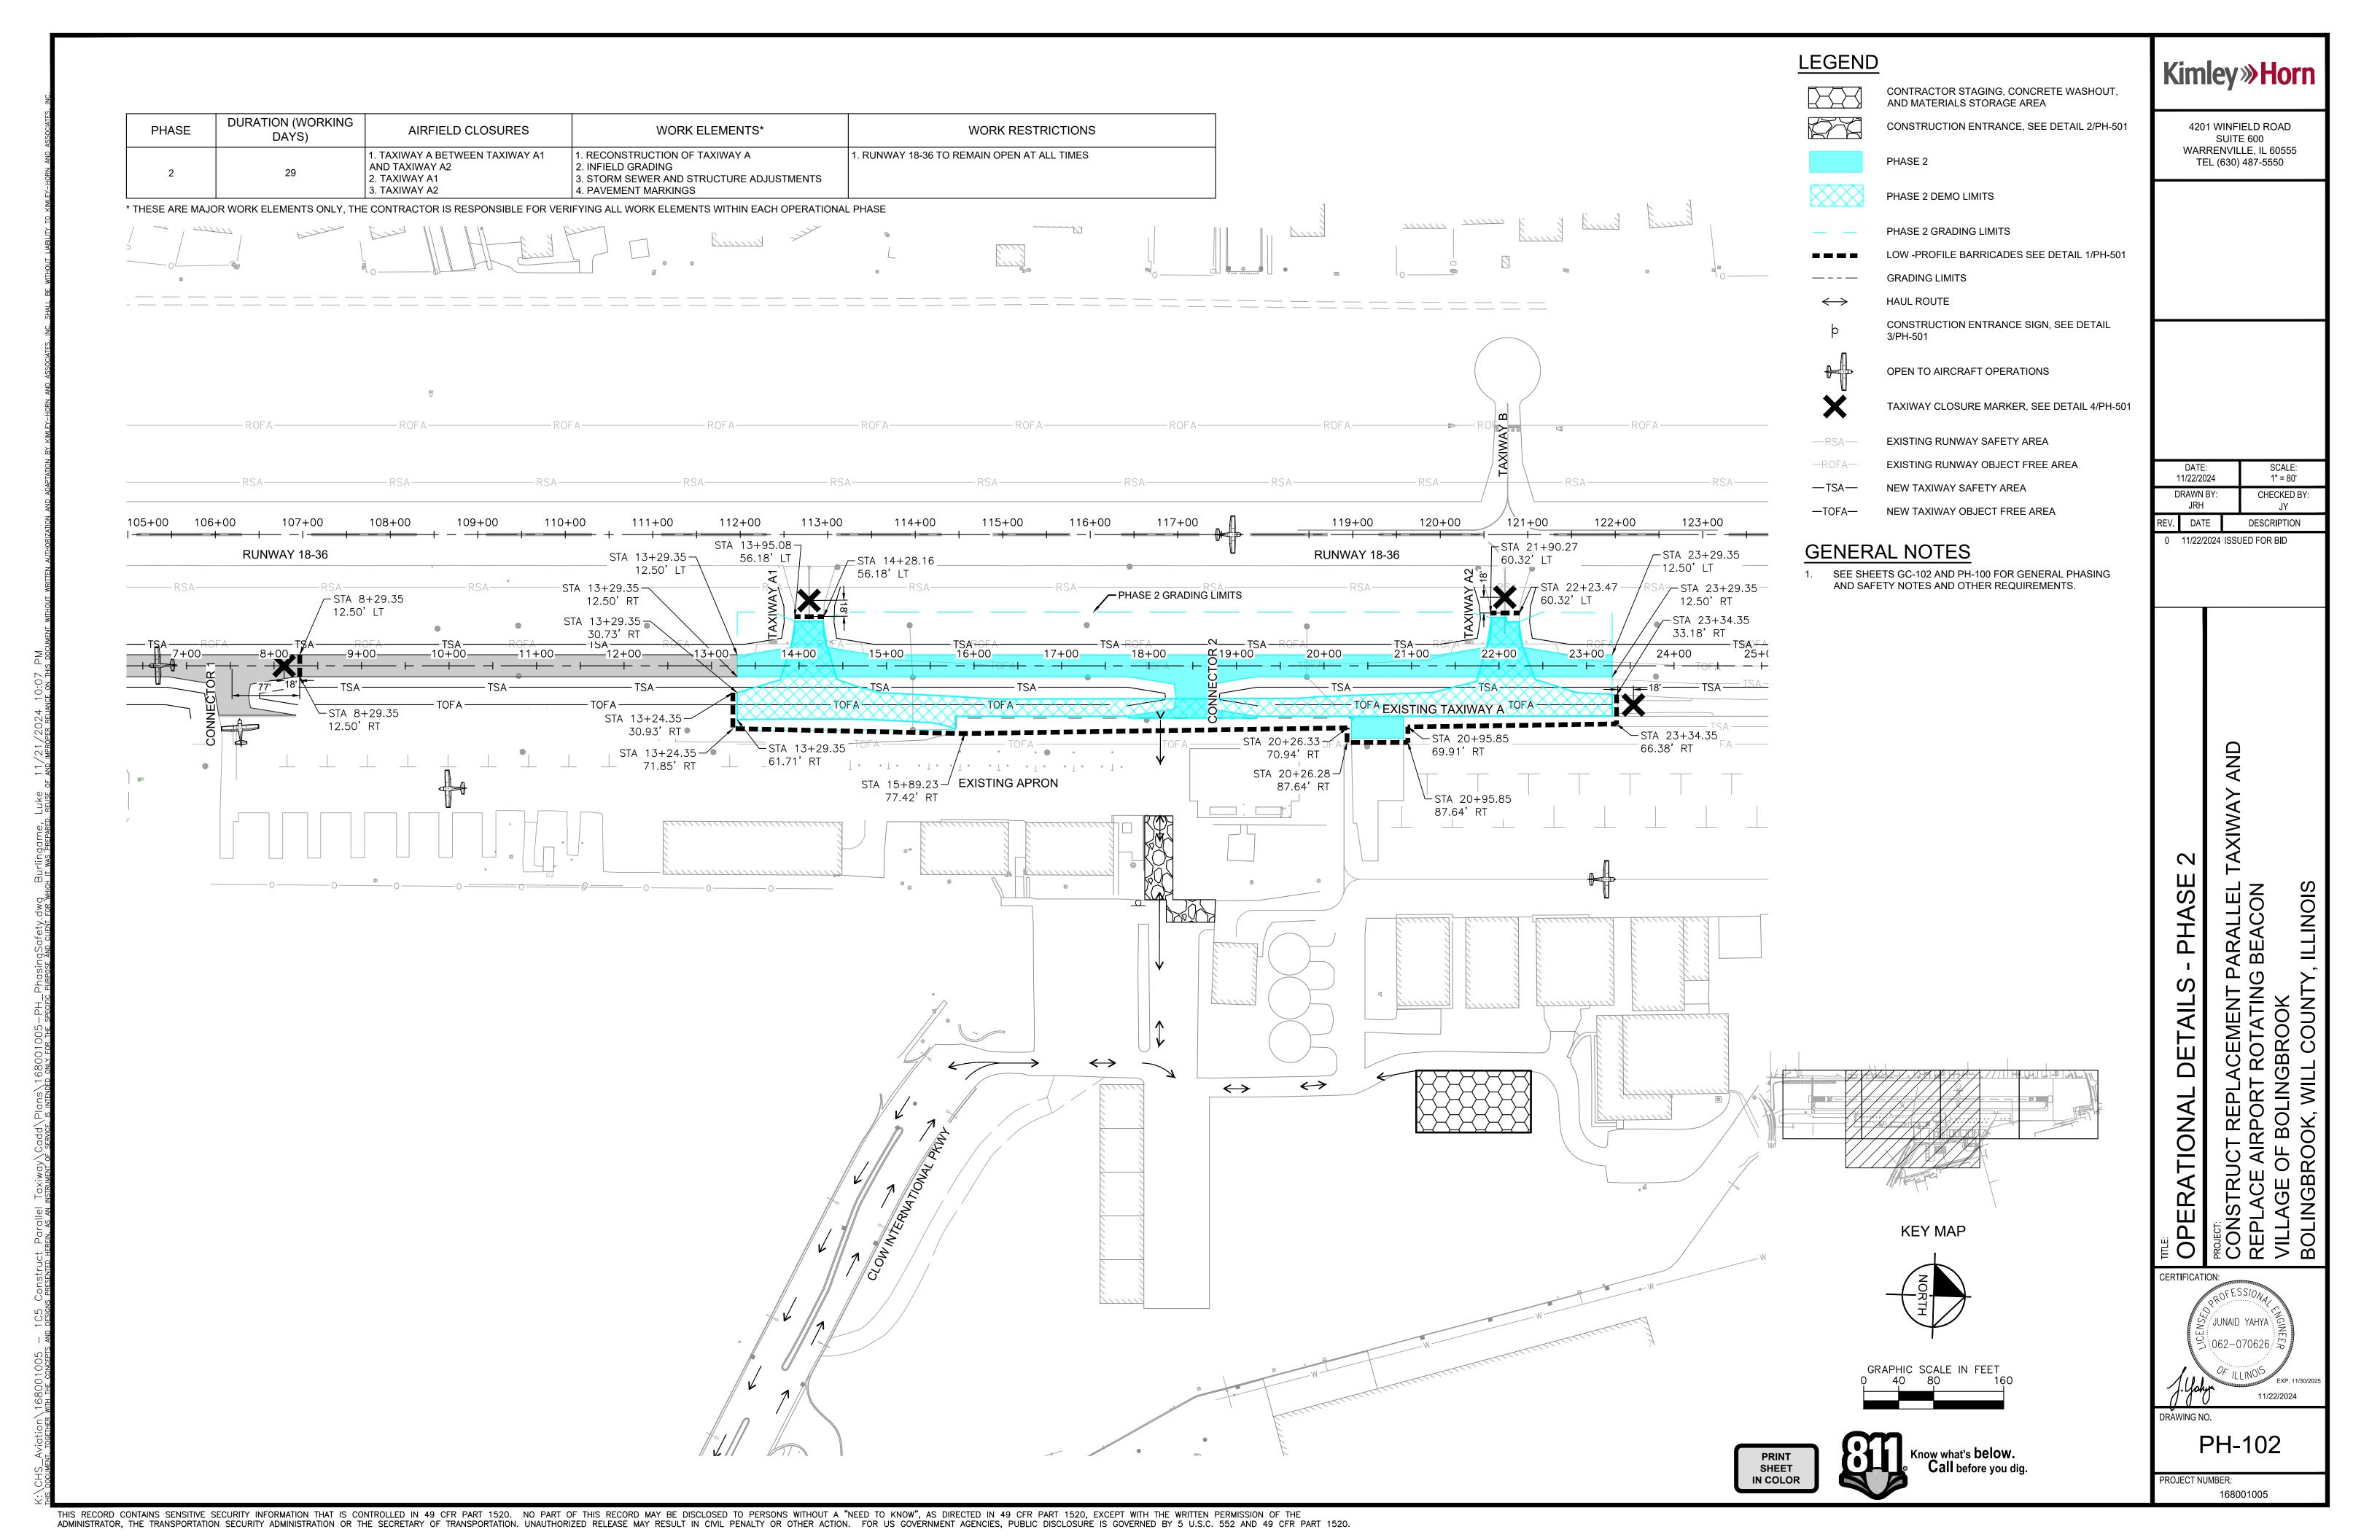- 1. THE CONTRACTOR SHALL FURNISH AND MAINTAIN PORTABLE LOW PROFILE CONSTRUCTION BARRICADES ON THIS PROJECT. IT SHALL BE THE CONTRACTOR'S RESPONSIBILITY TO MAINTAIN THE BARRICADES IN WORKING ORDER THROUGHOUT THE PROJECT. MAINTENANCE WILL LIKELY INCLUDE, BUT IS NOT LIMITED TO: REPLACEMENT LAMPS, FLAGS, BARRICADES ETC. BARRICADES SHALL BE INSPECTED FOR SATISFACTORY OPERATION EVERY TWO (2) HOURS DURING WORKING HOURS. NO SEPARATE PAYMENT WILL BE MADE FOR SUPPLYING, MAINTAINING AND MOVING BARRICADES BUT SHALL BE CONSIDERED INCIDENTAL TO PAY ITEM AR150530 "TRAFFIC MAINTENANCE".
- 2. AT PROJECT COMPLETION, ALL BARRICADES SHALL BE REMOVED FROM THE AIRPORT PROPERTY AND SHALL REMAIN THE PROPERTY OF THE CONTRACTOR.
- 3. LOW PROFILE CONSTRUCTION BARRICADES:
- A. SHALL BE MULTI-BARRIER MODEL No. AR-10X96, LO PRO MODEL No. AB96, NAC MODEL No. GD9670, OR APPROVED EQUAL
- B. SHALL HAVE AT LEAST TWO (2) OMNI-DIRECTIONAL LOW INTENSITY FLASHING RED LIGHT ATTACHED TO EACH BARRICADE. LAMPS SHALL ALTERNATE PER FAA AC 70/7460-1 AND IDOT REQUIREMENTS.
- C. THE FINAL LOCATION FOR THE BARRICADES SHALL BE ESTABLISHED IN THE FIELD WITH CONCURRENCE FROM THE RESIDENT ENGINEER.
- D. SHALL HAVE AT LEAST TWO (2) ORANGE OR RED FLAGS (FOR CLARITY, ORIENTATION IN DETAIL ABOVE SHOWN FOR GENERAL PURPOSE AND DOES NOT REFLECT ACTUAL FLAG PLACEMENT).
- E. SHALL BE SECURED TO THE PAVEMENT BY FILLING WITH WATER OR SAND BAGS. SAND BAGS SHALL BE THE SAME COLOR AS THE BARRICADES.
- F. BARRICADES SECURED BY WATER OR SAND SHALL BE CHECKED ON A DAILY BASIS FOR LEAKS.
- G. SHALL BE POSITIONED END TO END OR INTERLOCKED WITH NO GAP.




### **CONSTRUCTION ENTRANCE SIGN NOTES:**

- 1. CONTRACTOR SHALL BE RESPONSIBLE FOR MAINTAINING PROPER POSITIONING OF ALL SIGNS.
- 2. NO SEPARATE PAYMENT WILL BE MADE FOR SUPPLYING, MAINTAINING, OR MOVING SIGNS BUT SHALL BE CONSIDERED INCIDENTAL TO ITEM AR150530, TRAFFIC MAINTENANCE.

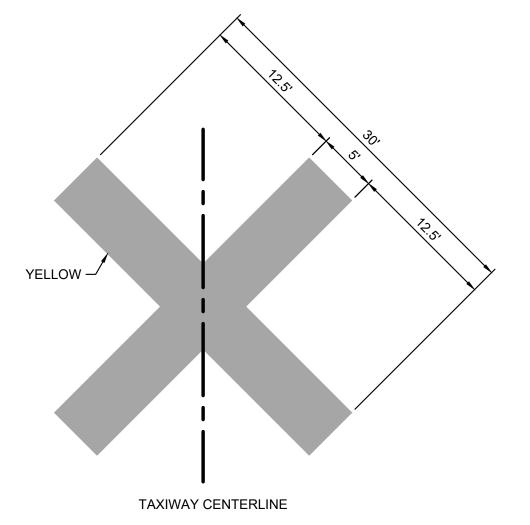

### NOTES:


- 1. TAXIWAY CLOSURE MARKERS SHALL BE CONSTRUCTED OF AN EASILY REMOVABLE MATERIAL, SUCH AS PLYWOOD OR FABRIC, AND HELD IN PLACE WITH SAND BAGS PAINTED YELLOW. TAXIWAY CLOSURE MARKERS SHALL BE YELLOW IN COLOR.
- 2. THE CONTRACTOR SHALL PLACE TAXIWAY CLOSURE MARKERS ON THE CENTERLINE OF THE TAXIWAY TO BE CLOSED AS SHOWN ON PLANS OR AS DIRECTED BY RESIDENT ENGINEER.
- 3. TAXIWAY CLOSURE MARKERS SHALL BE CONSIDERED INCIDENTAL TO ITEM AR150530, TRAFFIC MAINTENANCE.

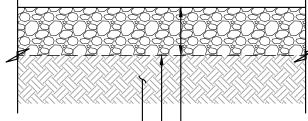

└ 12" CRUSHED AGGREGATE BASE COURSE (CA-1) L TEMPORARY GEOTEXTILE FABRIC - EXISTING SUBGRADE

### **CONSTRUCTION ENTRANCE NOTES:**

- 1. TOPSOIL SHALL BE STRIPPED 12" AND STOCKPILED ON SITE AT LOCATION APPROVED BY THE RESIDENT ENGINEER.
- 2. TIRES ON CONSTRUCTION EQUIPMENT SHALL BE CLEANED TO REMOVE SEDIMENT PRIOR TO ENTERING PAVED AREAS AND AREAS STABILIZED WITH CRUSHED STONE.
- 3. CONSTRUCTION ENTRANCE SHALL BE MAINTAINED AND GRADED TO PREVENT RUTTING AND ACCUMULATION OF SEDIMENT ON PAVED AREAS. PERIODIC TOP DRESSING WITH ADDITIONAL STONE MAY BE REQUIRED AS CONDITIONS DEMAND.
- 4. TEMPORARY SEDIMENT TRAPS SHALL BE UTILIZED TO PREVENT SEDIMENT FROM LEAVING THE CONSTRUCTION SITE.
- 5. CONSTRUCTION ENTRANCE AND SITE RESTORATION SHALL BE PAID FOR UNDER PAY ITEM AR150540, "HAUL ROUTE".

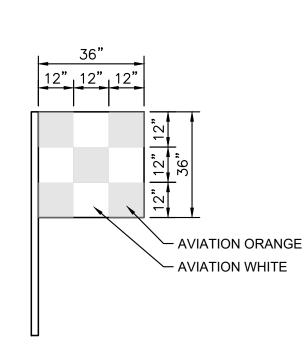

### VEHICLE AND EQUIPMENT FLAG NOTES:

- 1. ALL CONSTRUCTION MECHANIZED EQUIPMENT AUTHORIZED WITHIN THE MOVEMENT AREA OR RELATED SAFETY AREAS SHALL BE MARKED WITH A 3'X3' ORANGE AND WHITE CHECKERED FLAG WITH EACH BOX BEING 1 'SQUARE.
- 2. THE FLAG SHALL BE LOCATED ON THE UPPERMOST PORTION OF THE VEHICLE/MOTORIZED EQUIPMENT, OR BE ESCORTED BY A VEHICLE SO EQUIPPED.
- 3. VEHICLE AND EQUIPMENT FLAGS SHALL BE CONSIDERED INCIDENTAL AR150520, MOBILIZATION.



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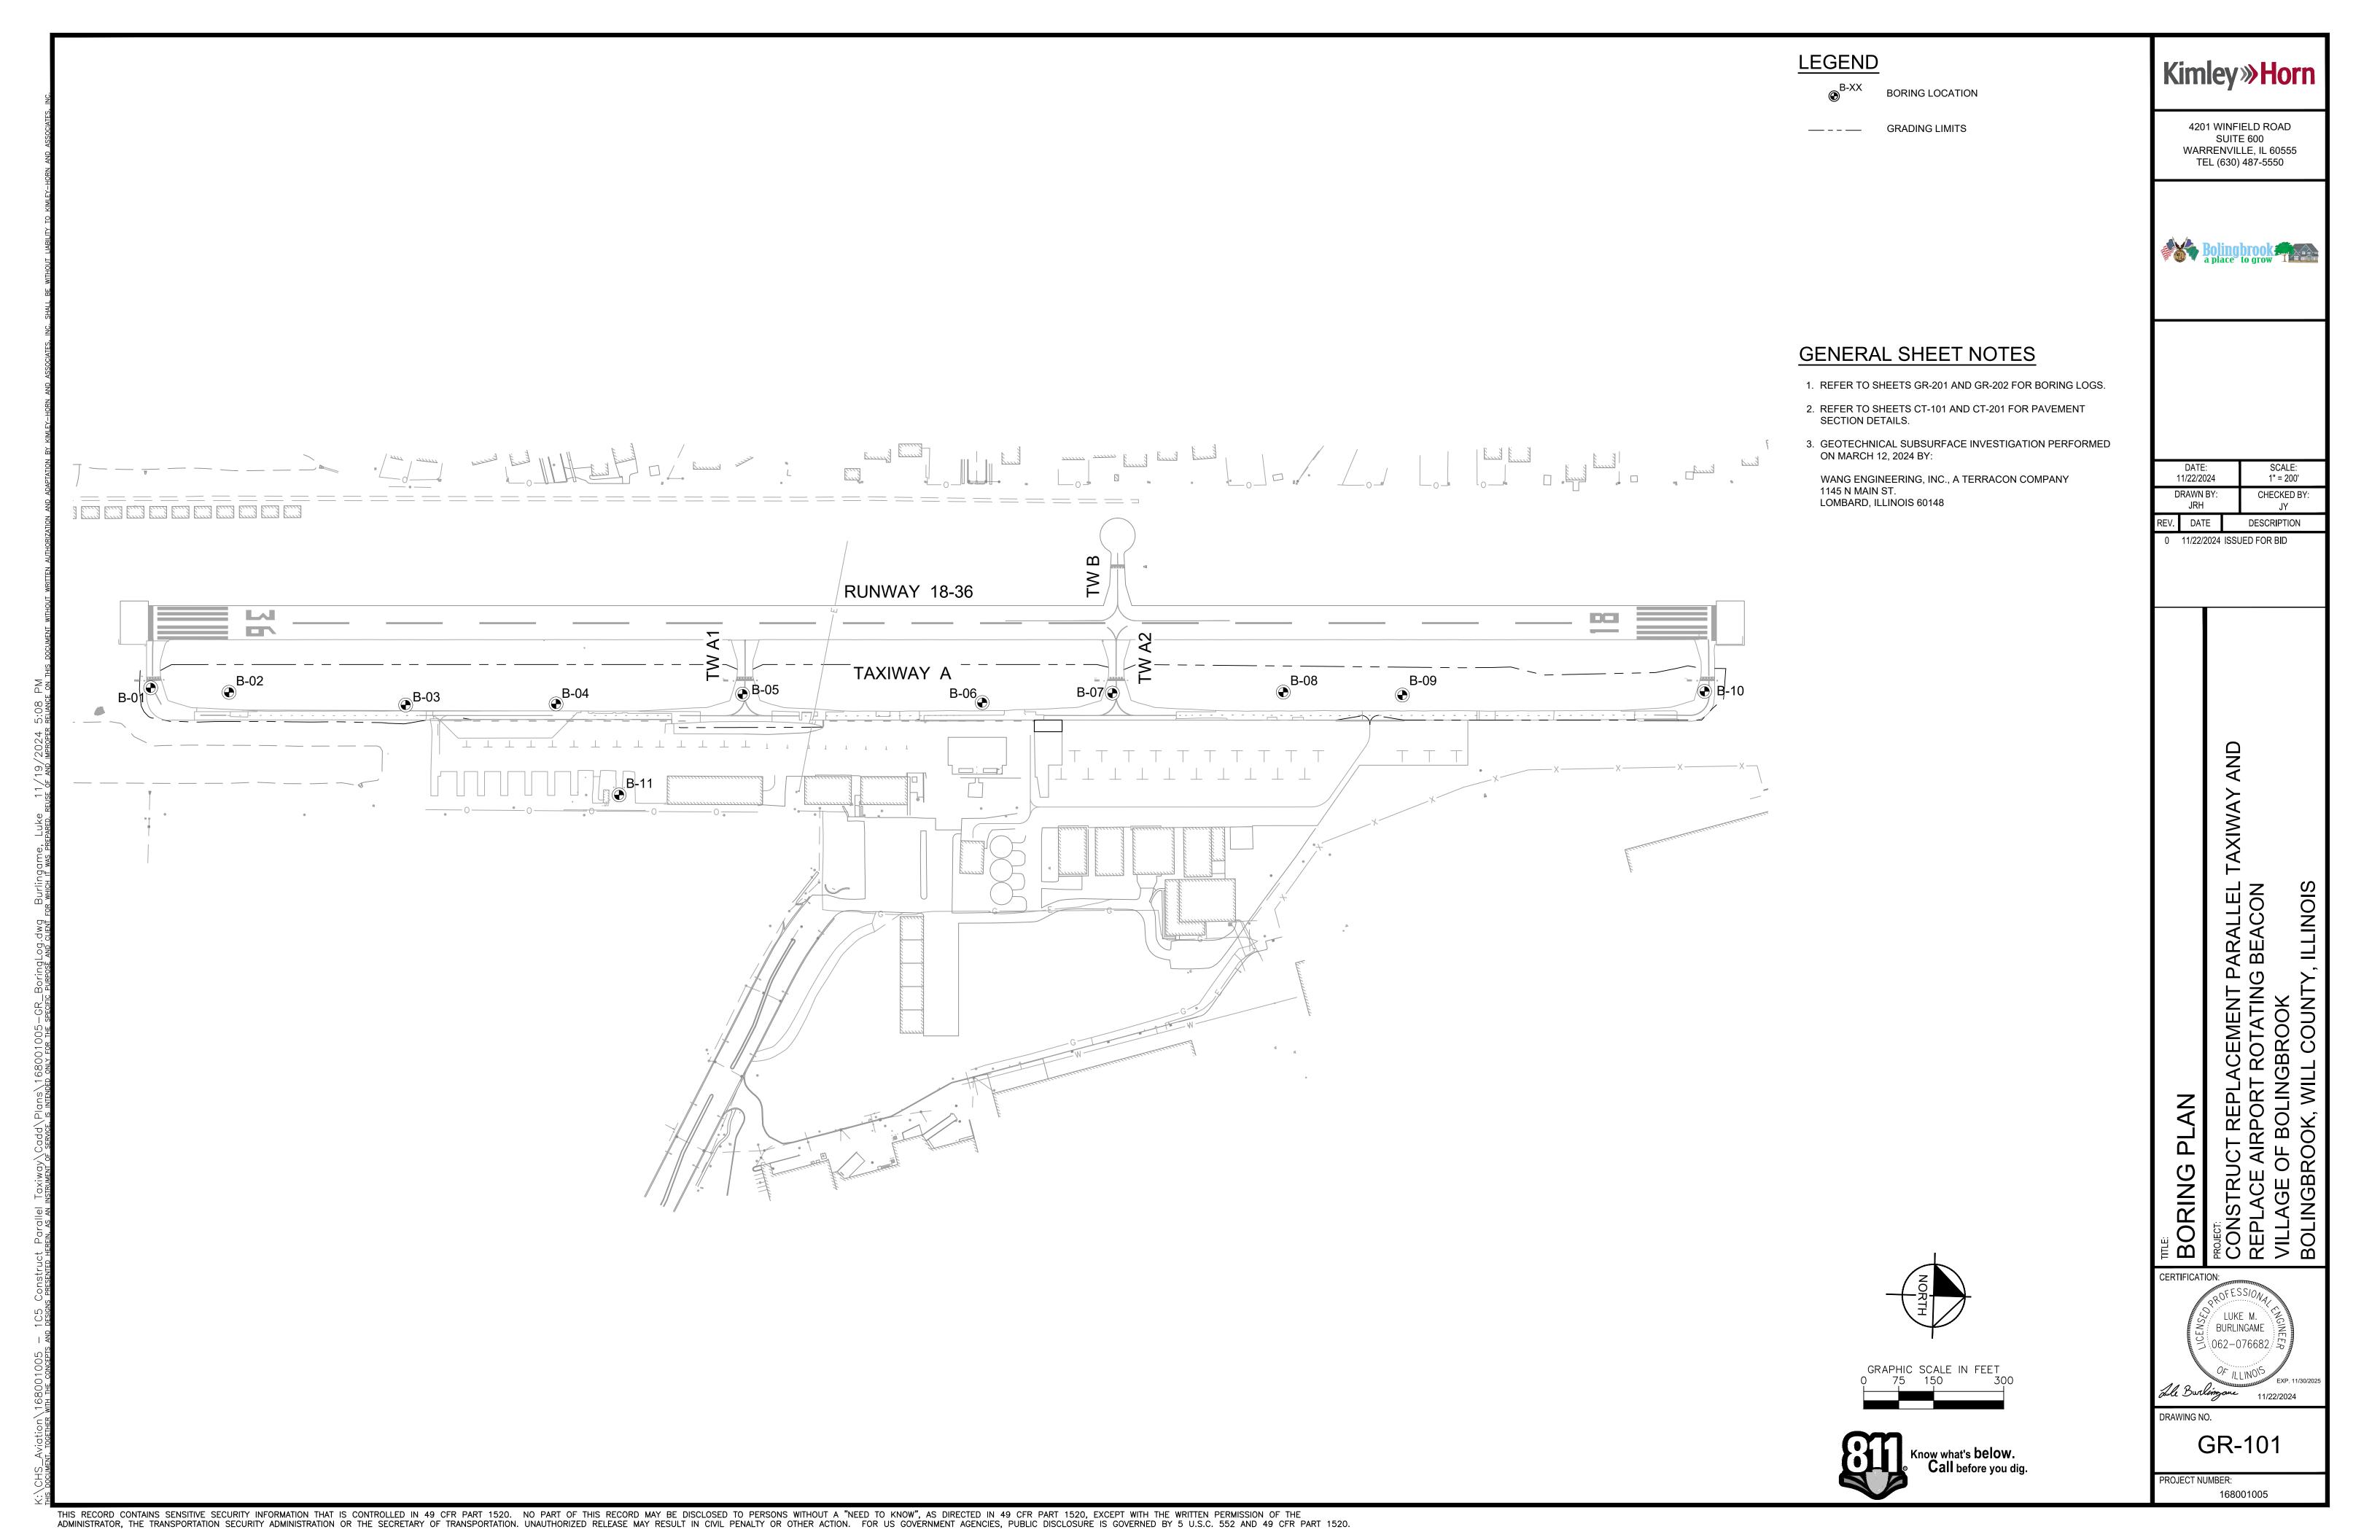
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11/22/2024 DRAWING NO. PH-501

JUNAID YAHYA

う 062-070626 ら





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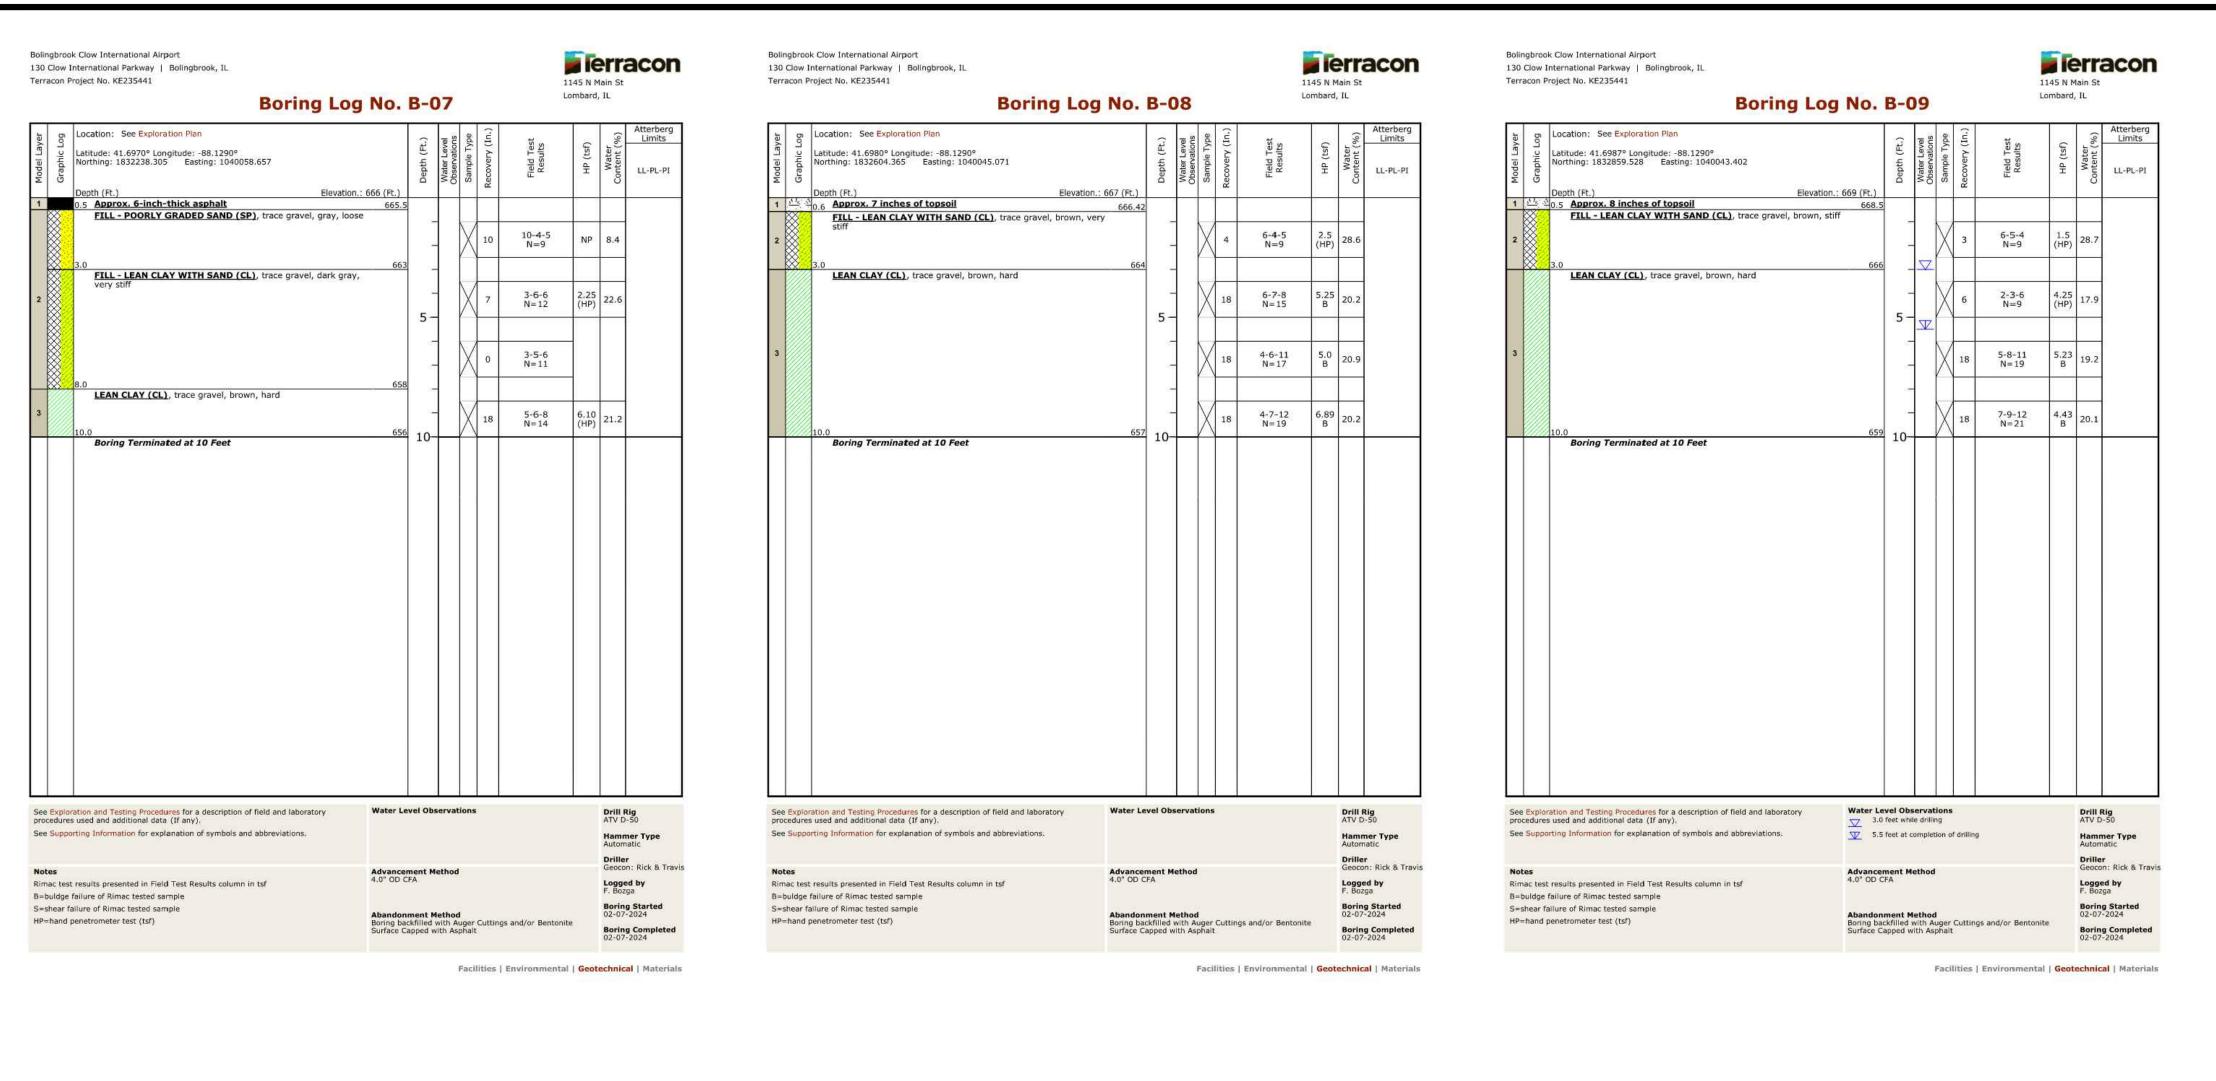
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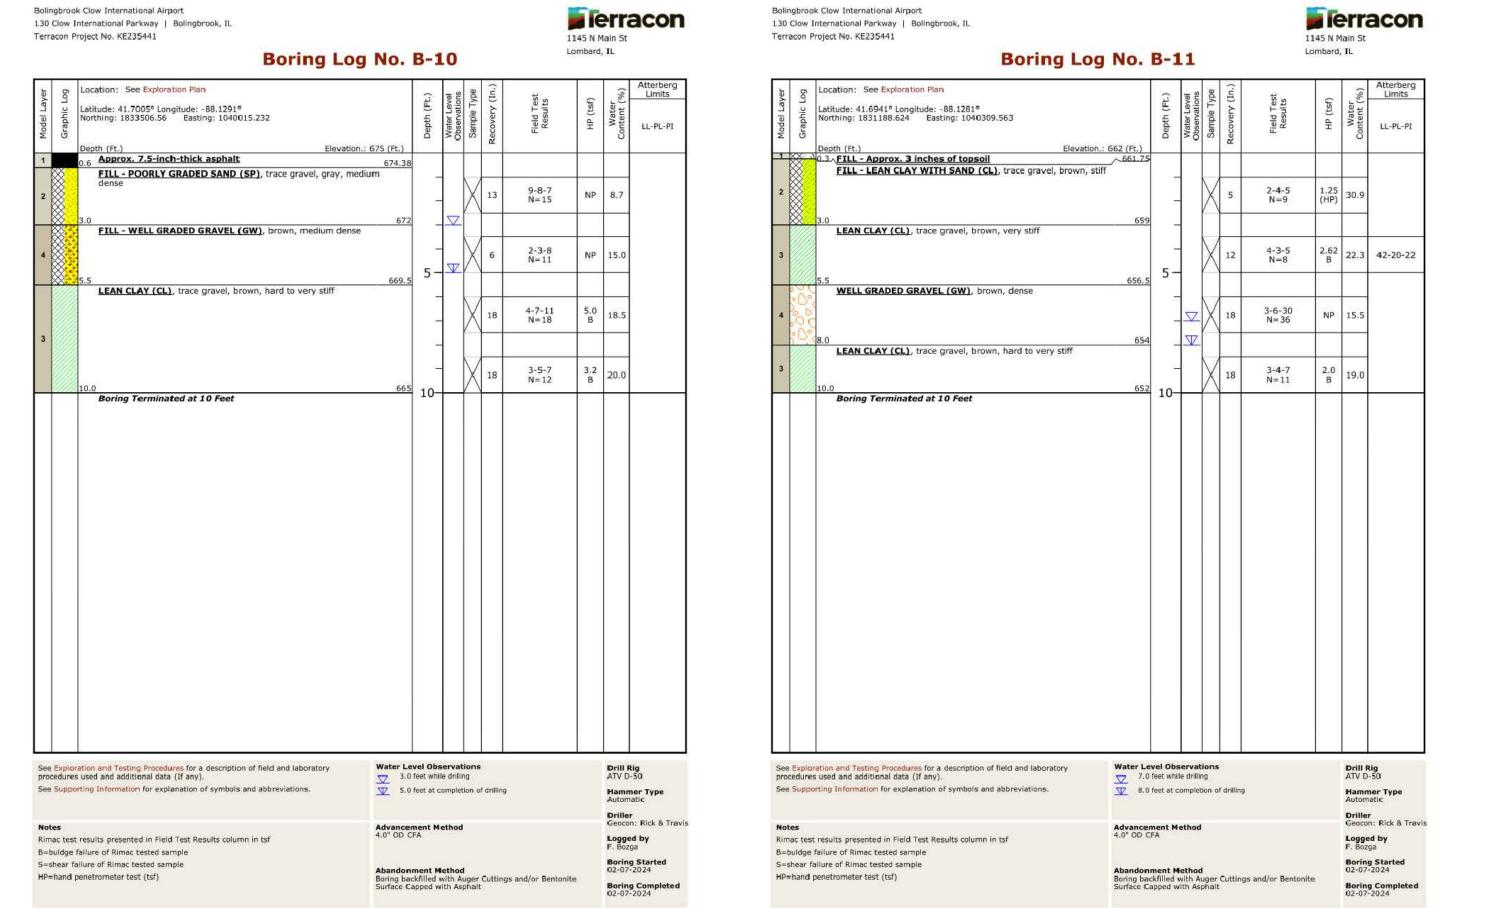
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CERTIFICATION: OROFESSION LUKE M. BURLINGAME ら062-076682 宏 Le Burlingone 11/22/2024

DRAWING NO.

GR-201





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BOLINGBROOK, WILL COUNTY, II 9

SHEET IN COLOR

Facilities | Environmental | Gentechnical | Materials

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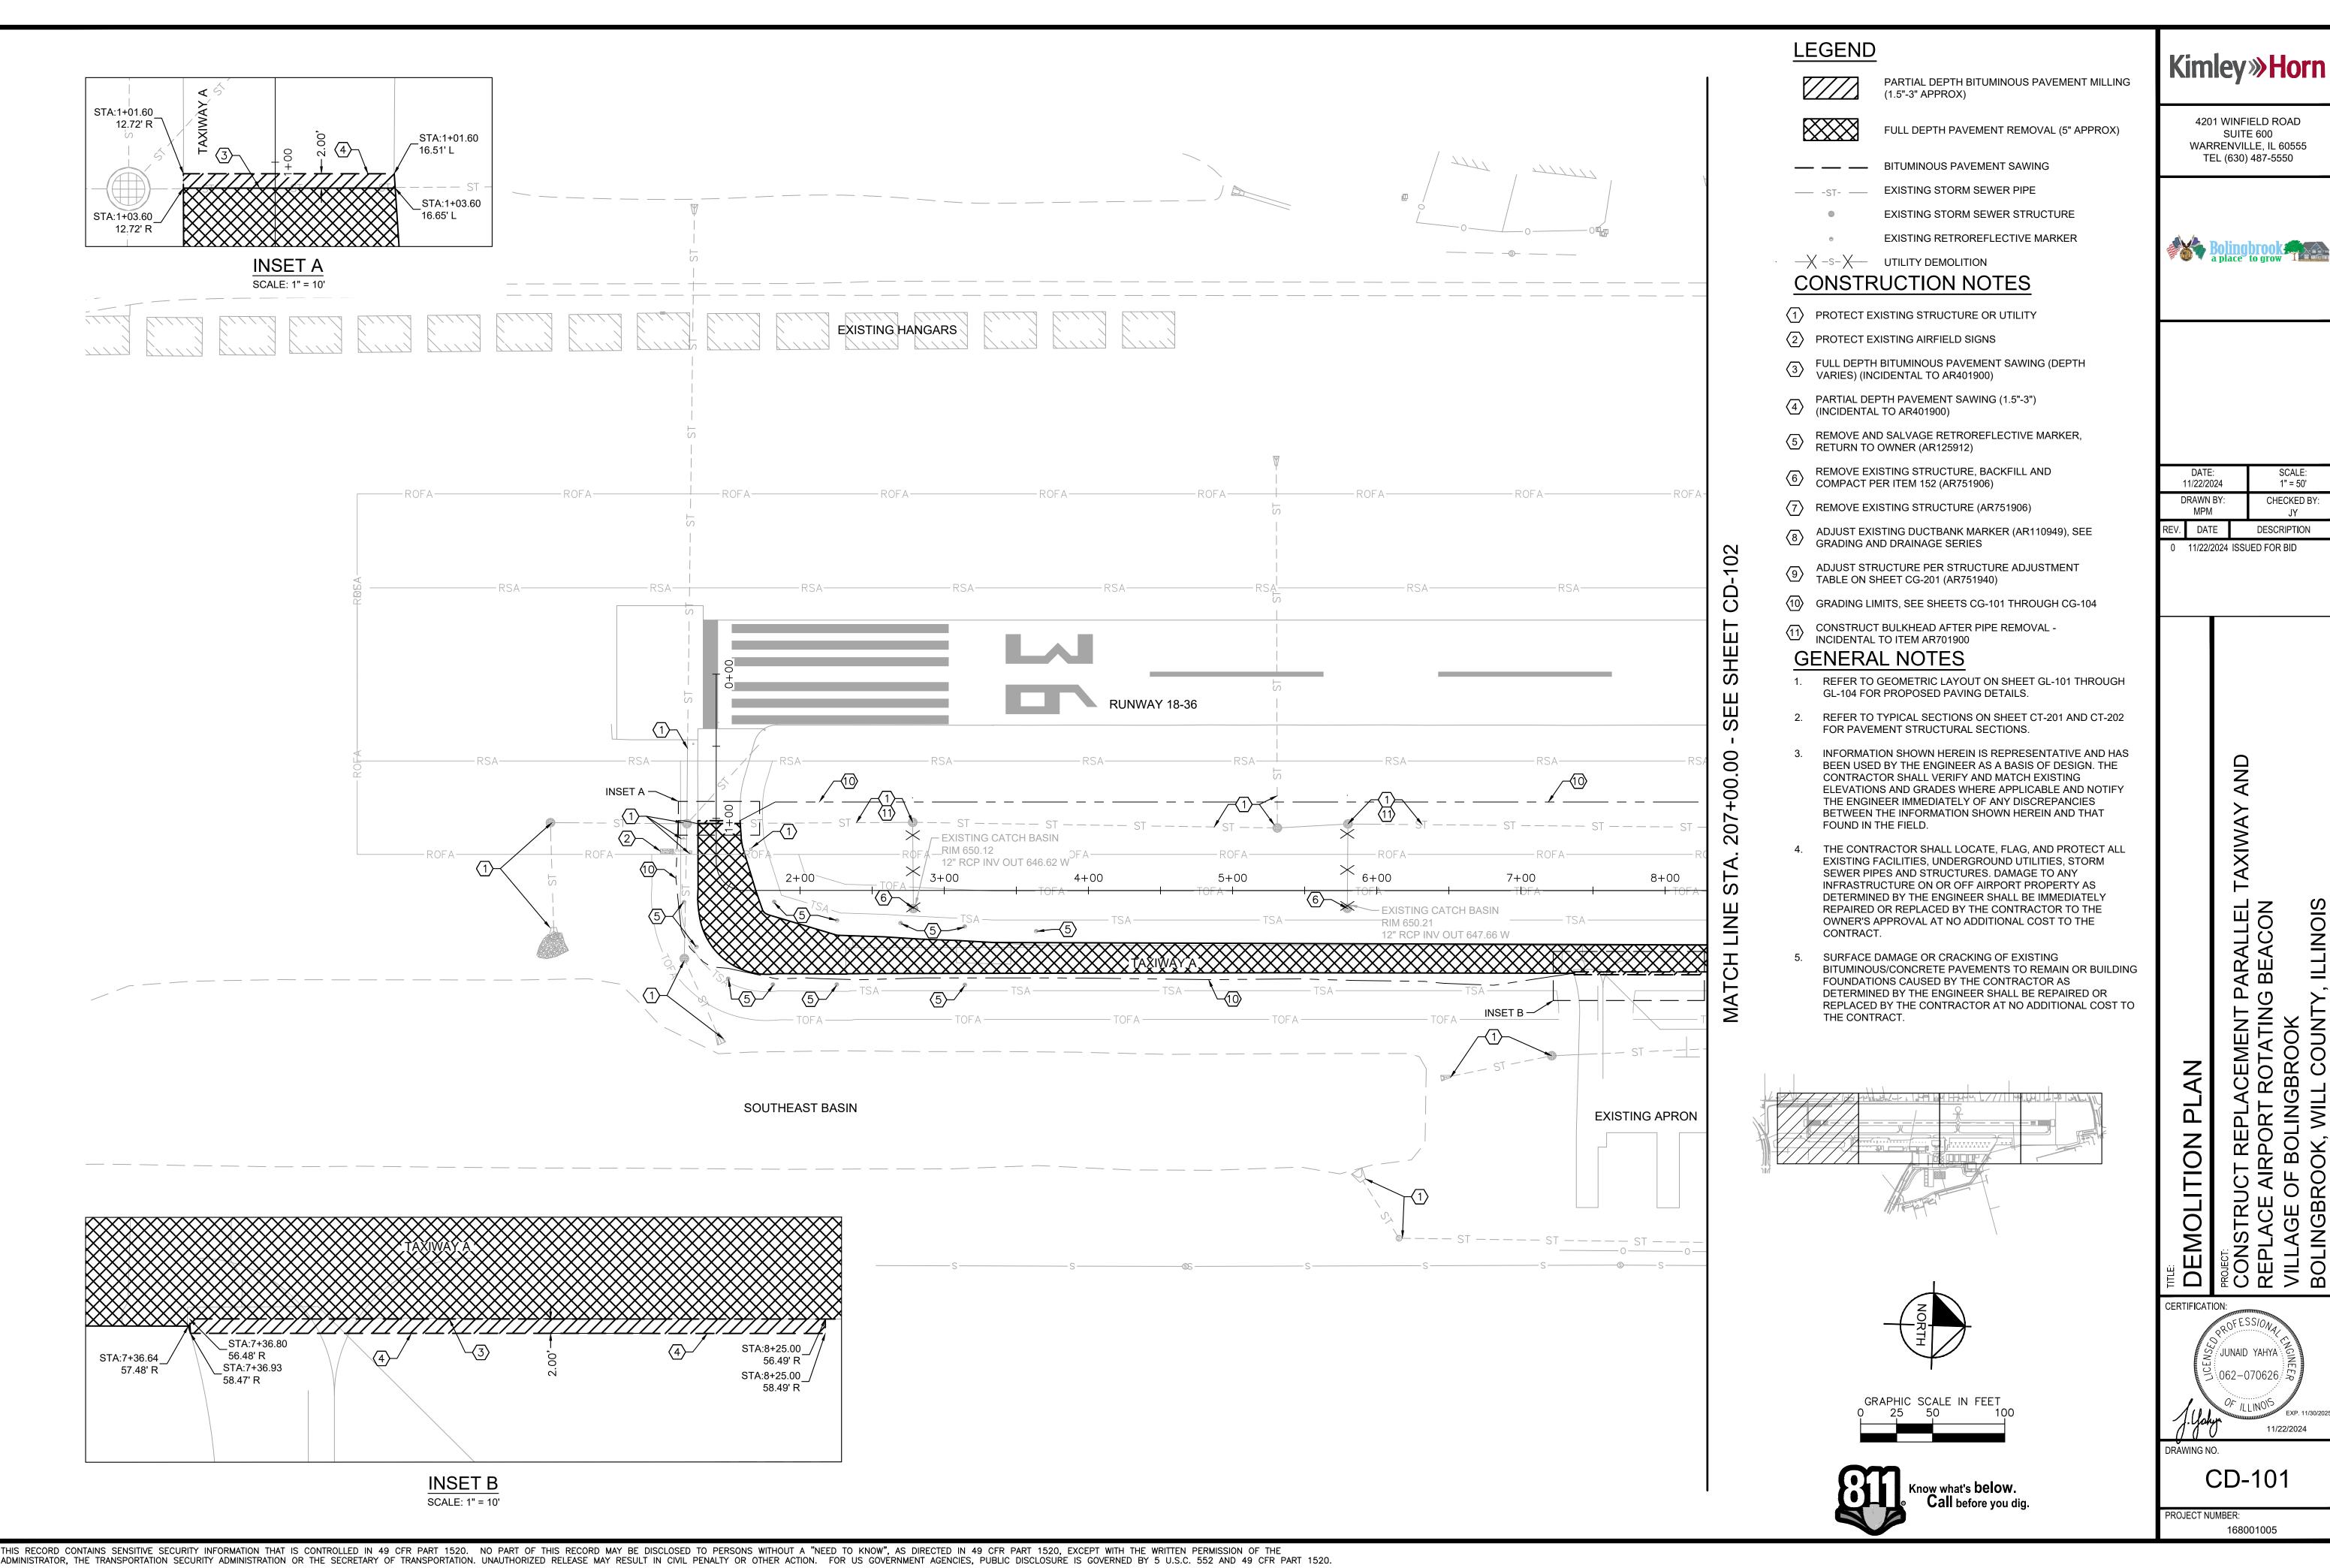
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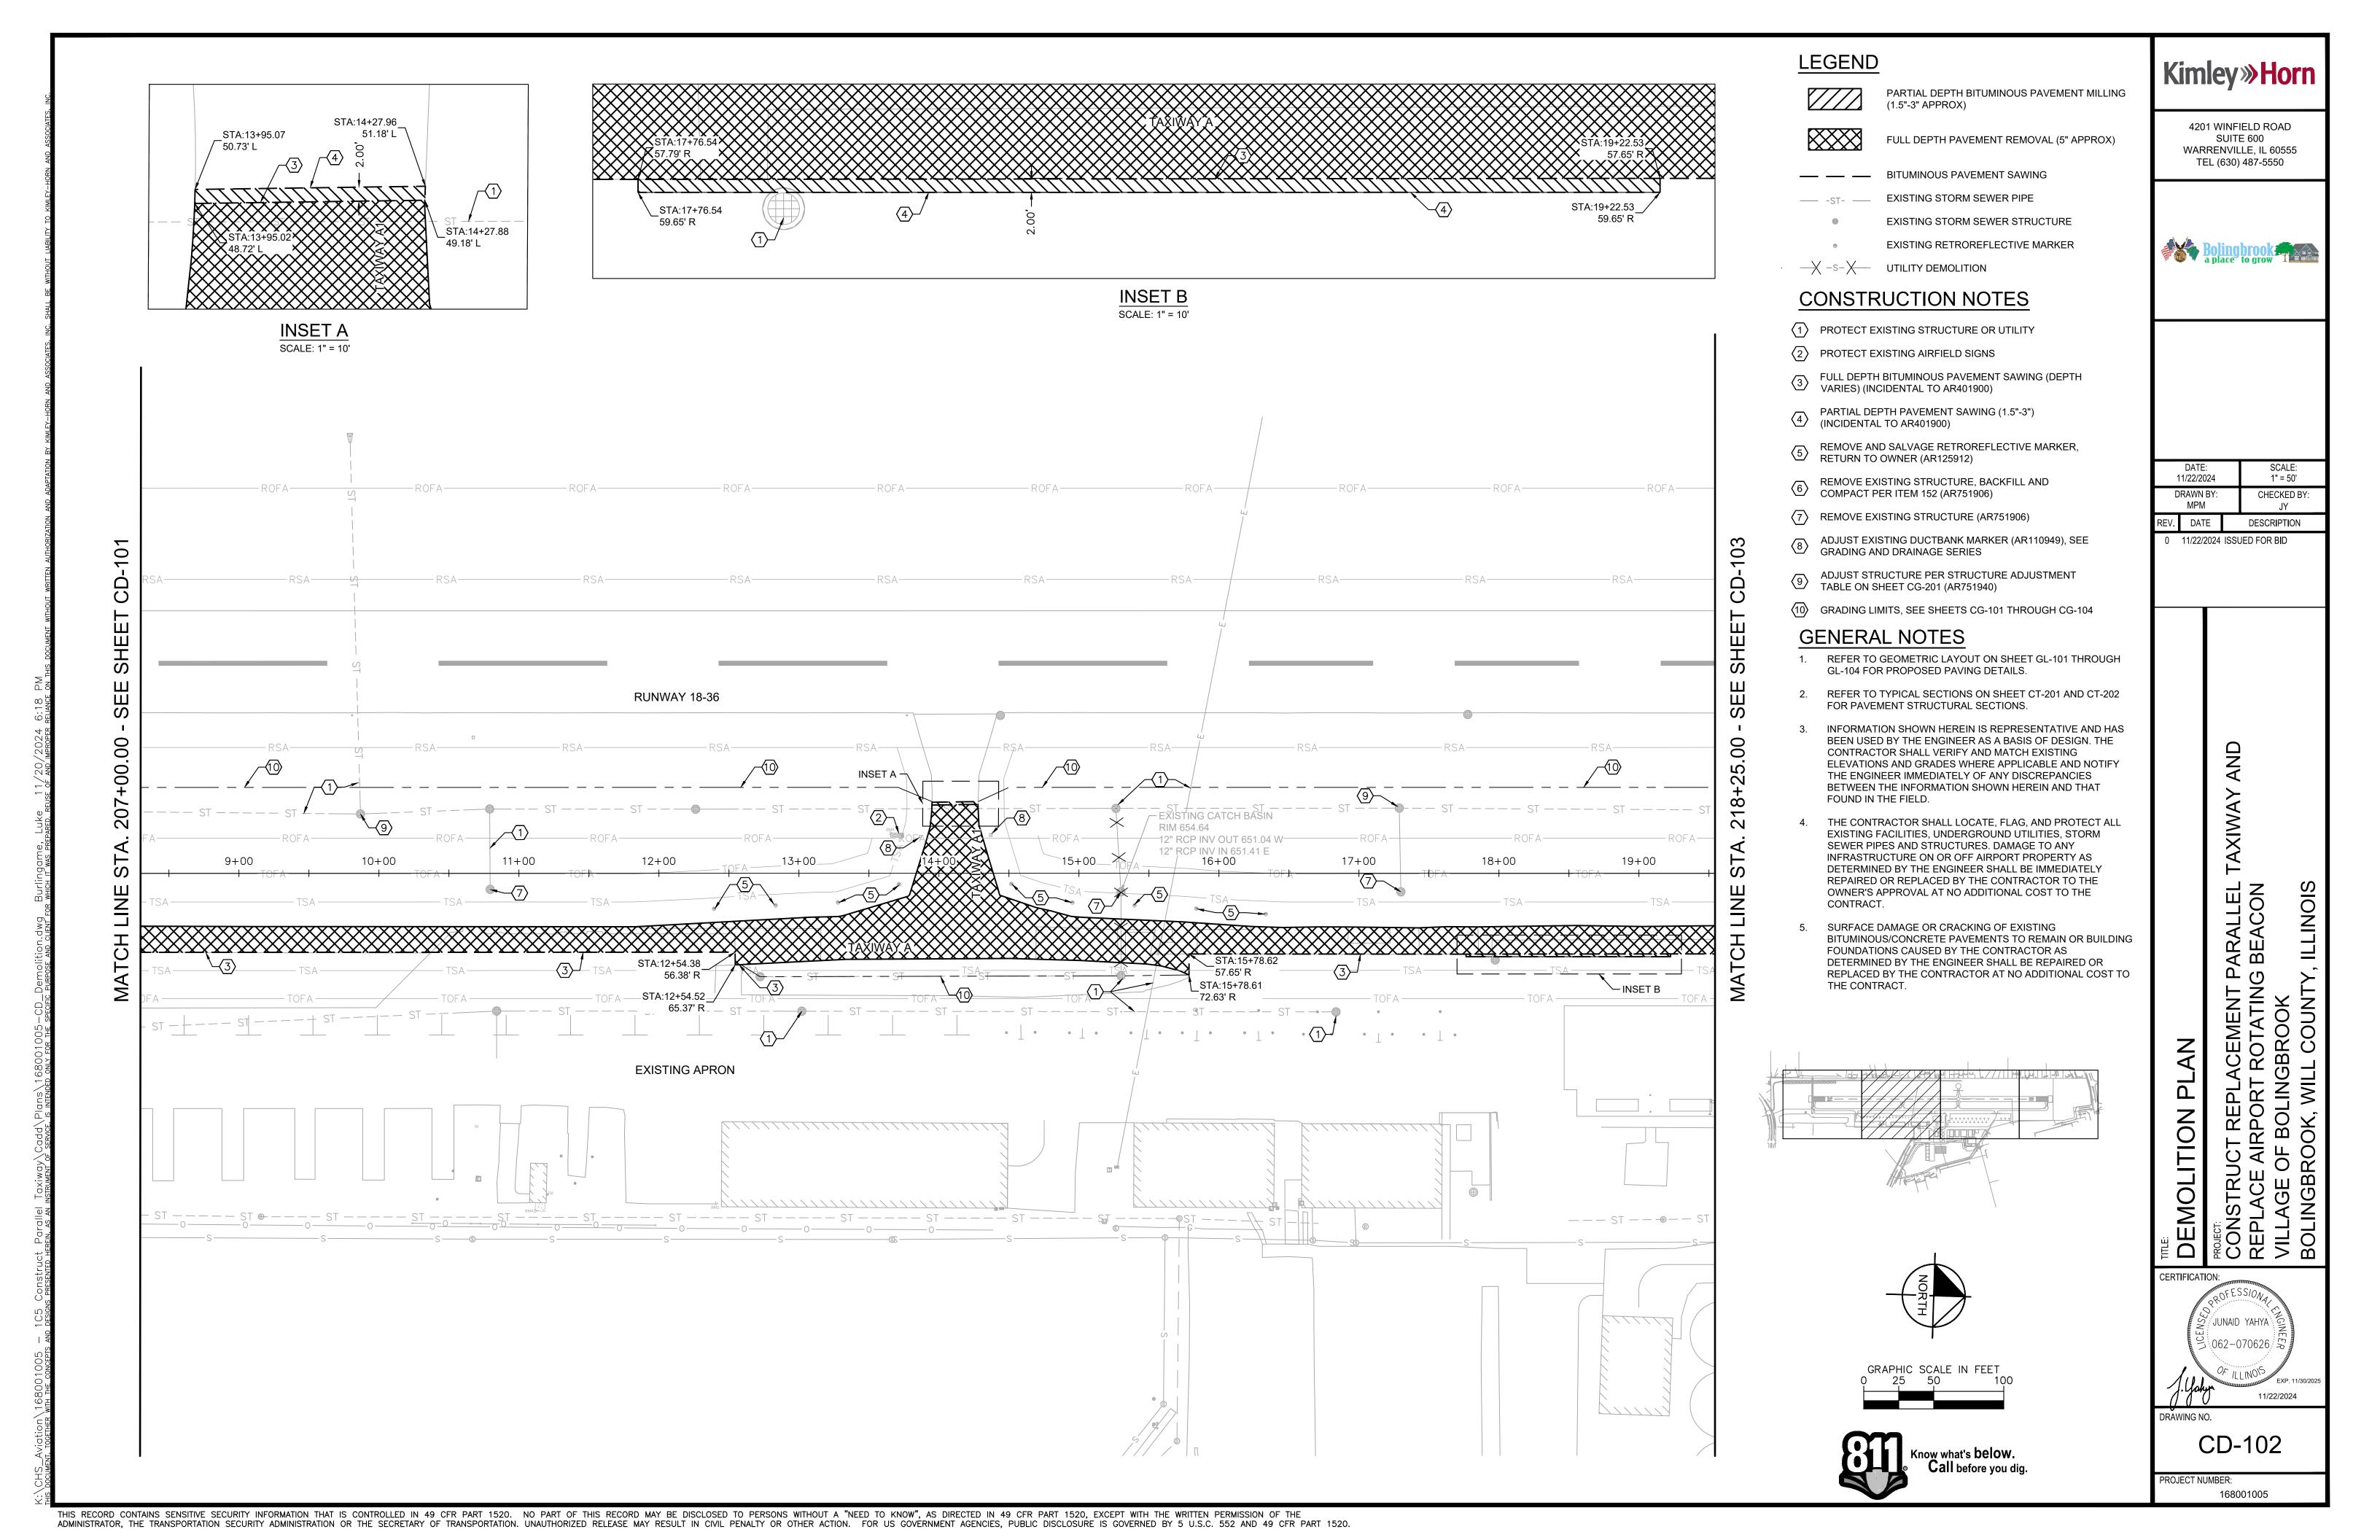
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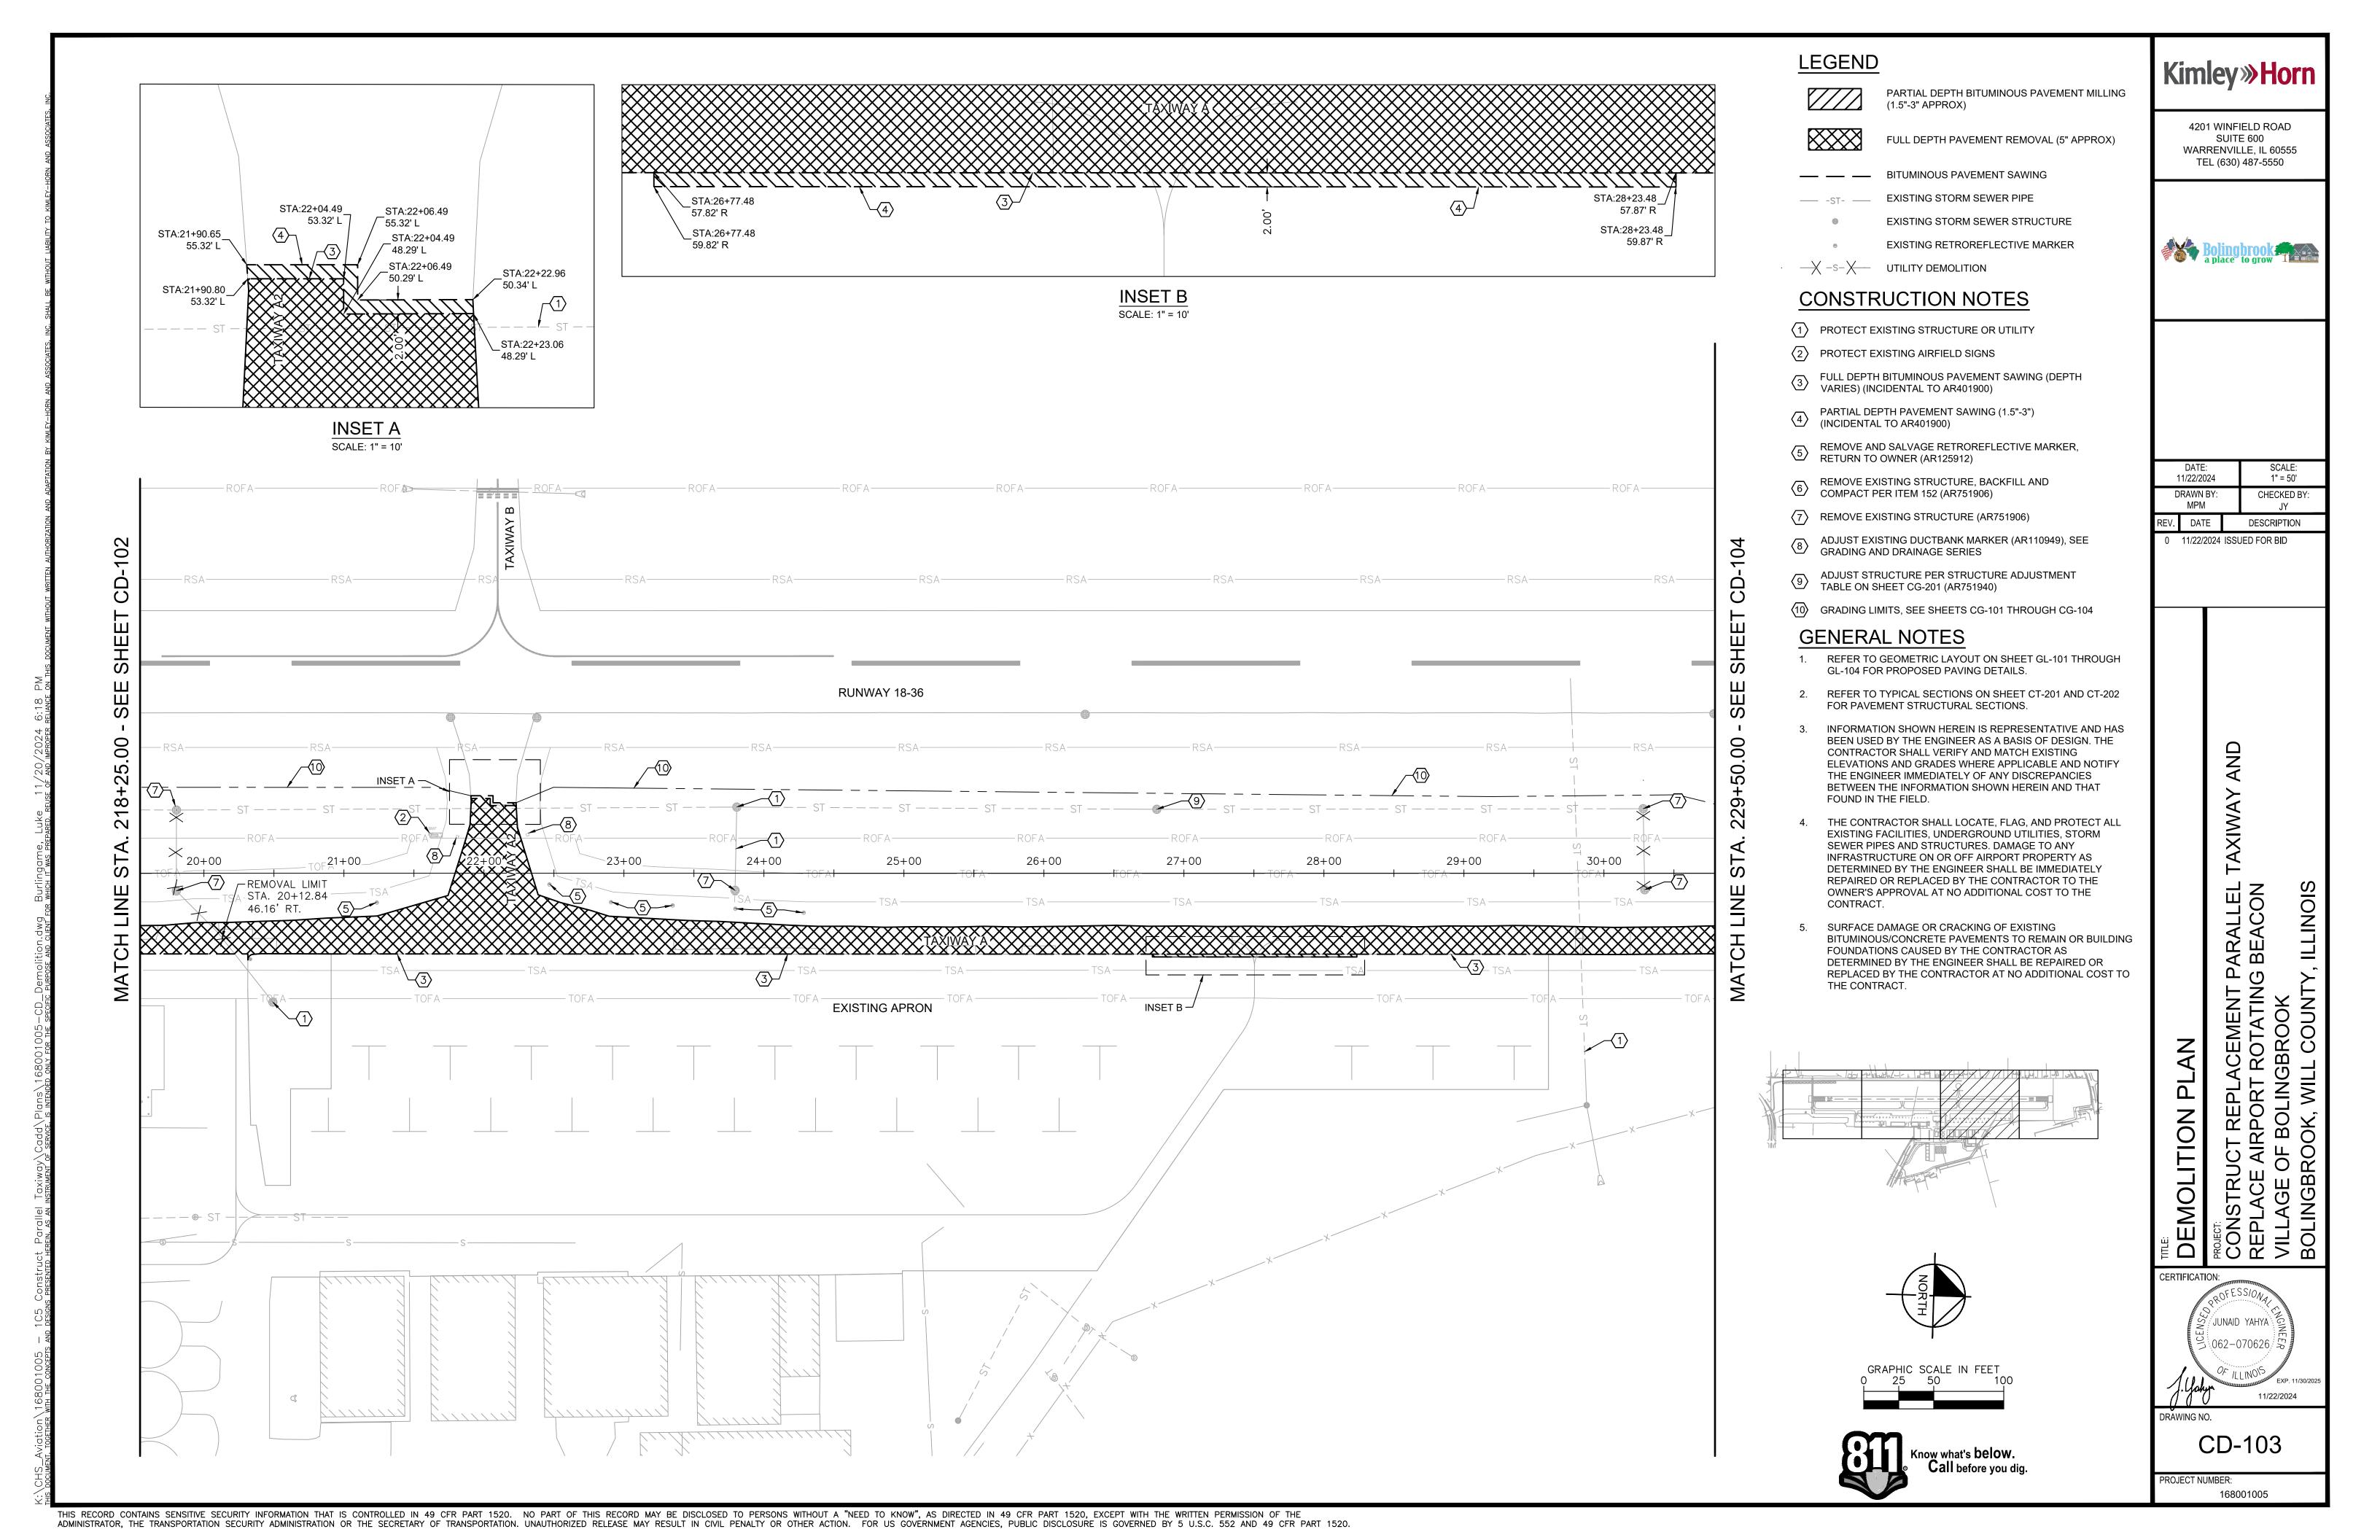
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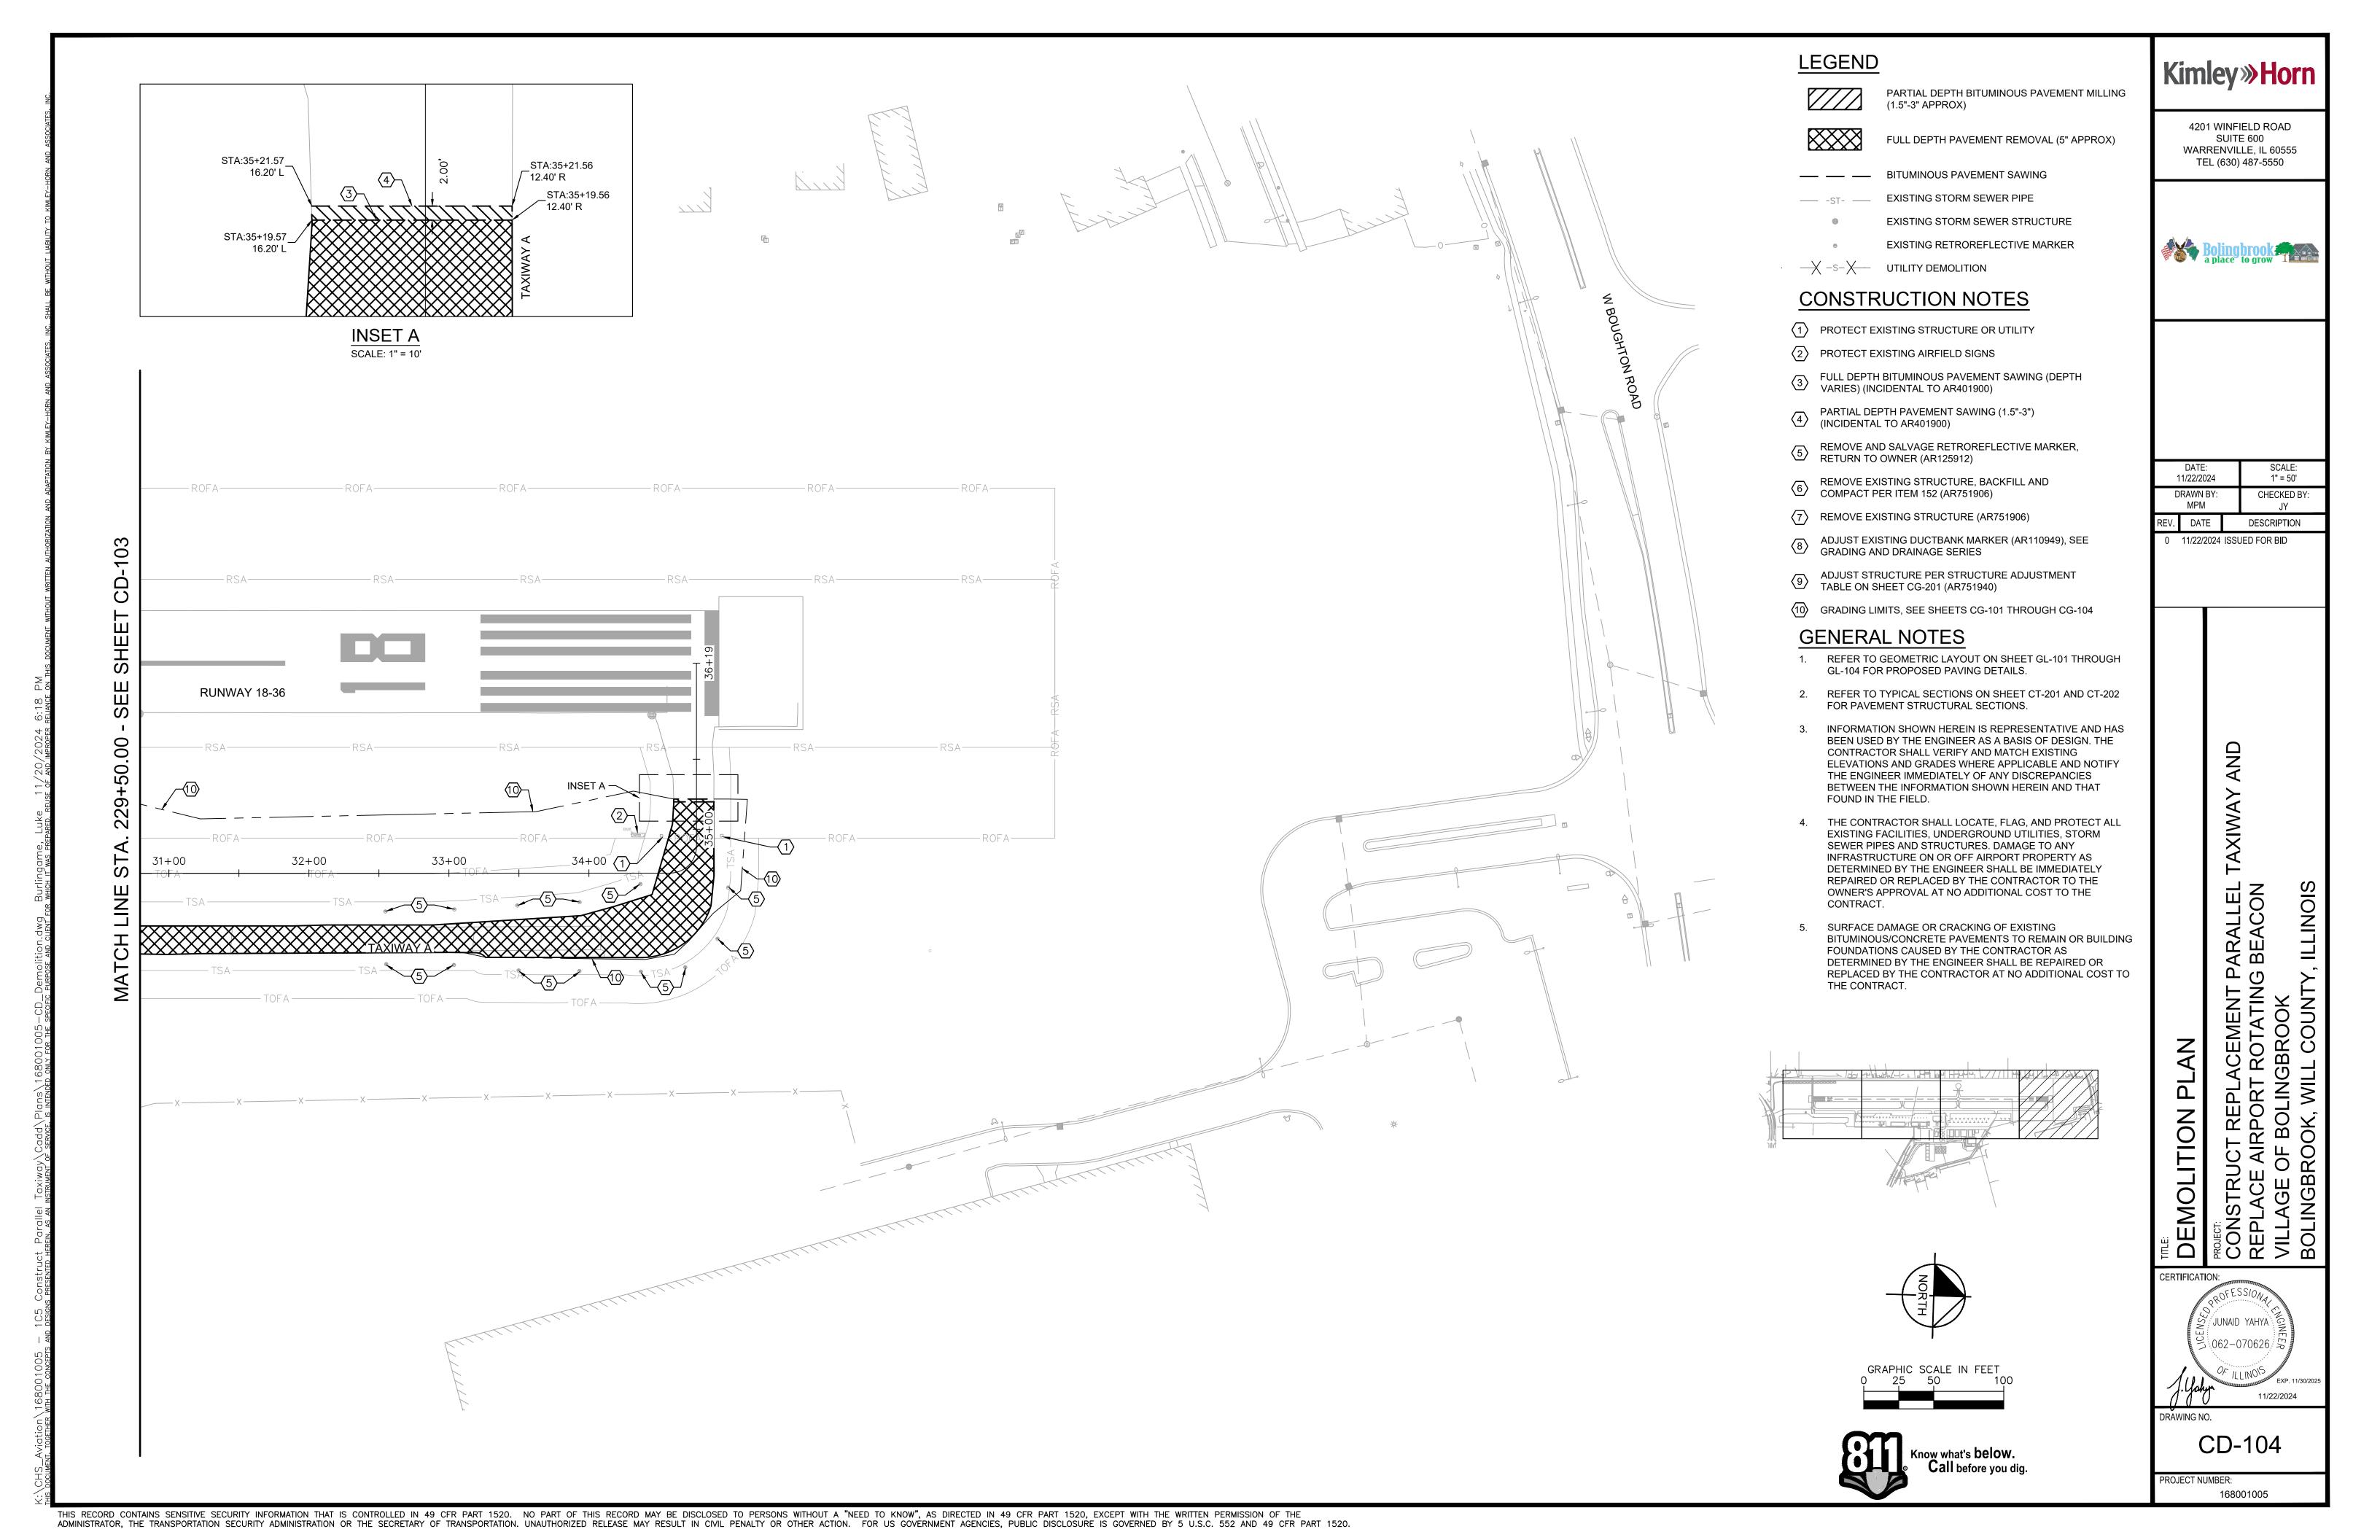
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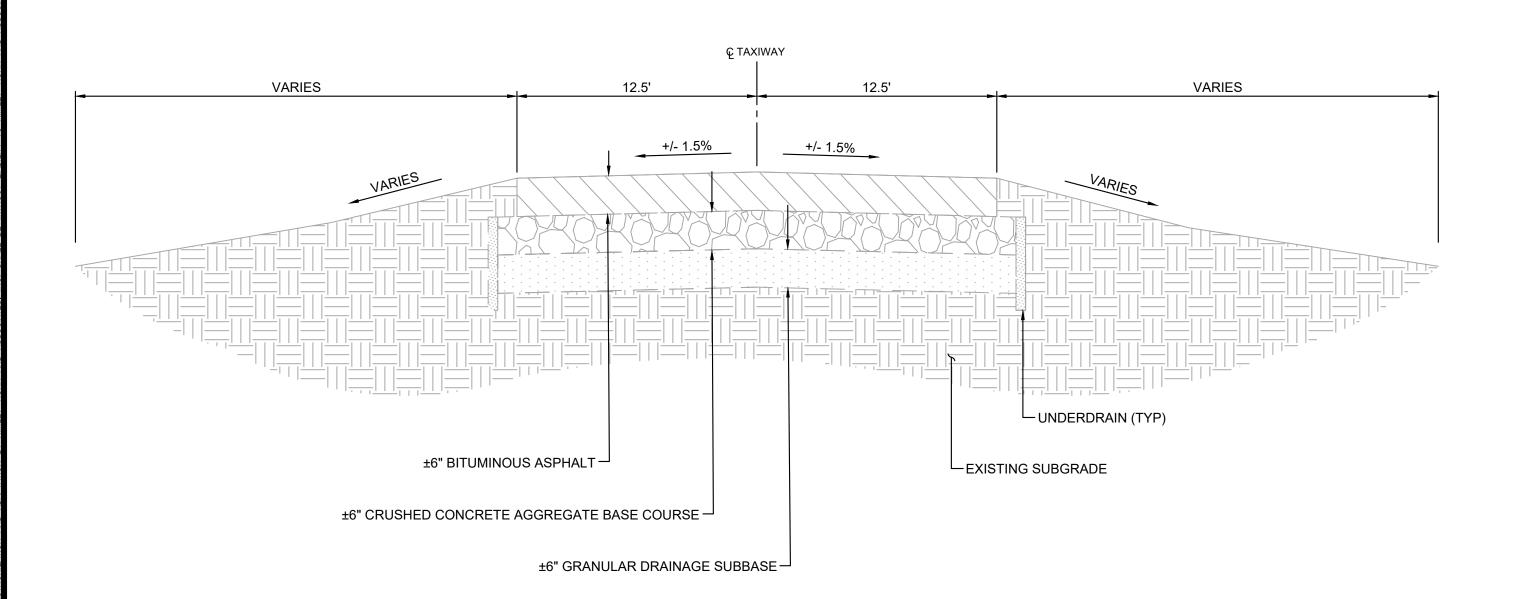













1 EXISTING TAXIWAY CONNECTORS TYPICAL SECTION
CT-201 NOTE: INCLUDES RUNWAY END CONNECTORS
NTS

# VARIES 1%-2% VARIES 1%-2% VARIES 1%-2% Las BITUMINOUS ASPHALT Let AGGREGATE BASE COURSE Let GRANULAR DRAINAGE SUBBASE EXISTING SUBGRADE

2 EXISTING APRON TYPICAL SECTION
CT-201 NTS

### GENERAL SHEET NOTES

- REFER TO BORING LOGS ON SHEETS GR-201 THROUGH GR-202 FOR EXISTING PAVEMENT INFORMATION.
- 2. EXISTING TYPICAL SECTIONS ARE APPROXIMATE AND SHOWN AS SUPPLEMENTAL INFORMATION ONLY. PAVEMENT DEPTHS WERE COMPILED BASED ON THE BEST AVAILABLE RECORDS AND MAY VARY DUE TO INCONSISTENT PAVEMENT THICKNESS.
- 3. EXPOSED SUBGRADE AND BASE MATERIAL SHALL BE KEPT MOIST, COMPACTED AND TREATED WITH A DUST PALLIATIVE TO MINIMIZE FOD.
- 4. THE CONTRACTOR SHALL BE RESPONSIBLE FOR ALL DEWATERING AT NO ADDITIONAL COST TO THE CONTRACT. ANY REWORK OR ADDITIONAL WORK REQUIRED BECAUSE OF THE CONTRACTOR'S FAILURE TO MAINTAIN ADEQUATE DRAINAGE WILL BE AT THE CONTRACTOR'S EXPENSE.
- 5. THE CONTRACTOR SHALL LOCATE, FLAG, AND PROTECT ALL EXISTING FACULTIES, UNDERGROUND UTILITIES, STORM SEWER PIPES AND STRUCTURES. DAMAGE TO ANY INFRASTRUCTURE ON OR OFF AIRPORT PROPERTY AS DETERMINED BY THE ENGINEER SHALL BE IMMEDIATELY REPAIRED OR REPLACED BY THE CONTRACTOR TO THE OWNER'S APPROVAL AT NO ADDITIONAL COST TO THE CONTRACT.
- 6. SURFACE DAMAGE OR CRACKING OF EXISTING
  BITUMINOUS/CONCRETE PAVEMENTS TO REMAIN OR
  BUILDING FOUNDATIONS TO REMAIN CAUSED BY THE
  CONTRACTOR AS DETERMINED BY THE ENGINEER SHALL
  BE REPAIRED OR REPLACED BY THE CONTRACTOR AT NO
  ADDITIONAL COST TO THE CONTRACT.

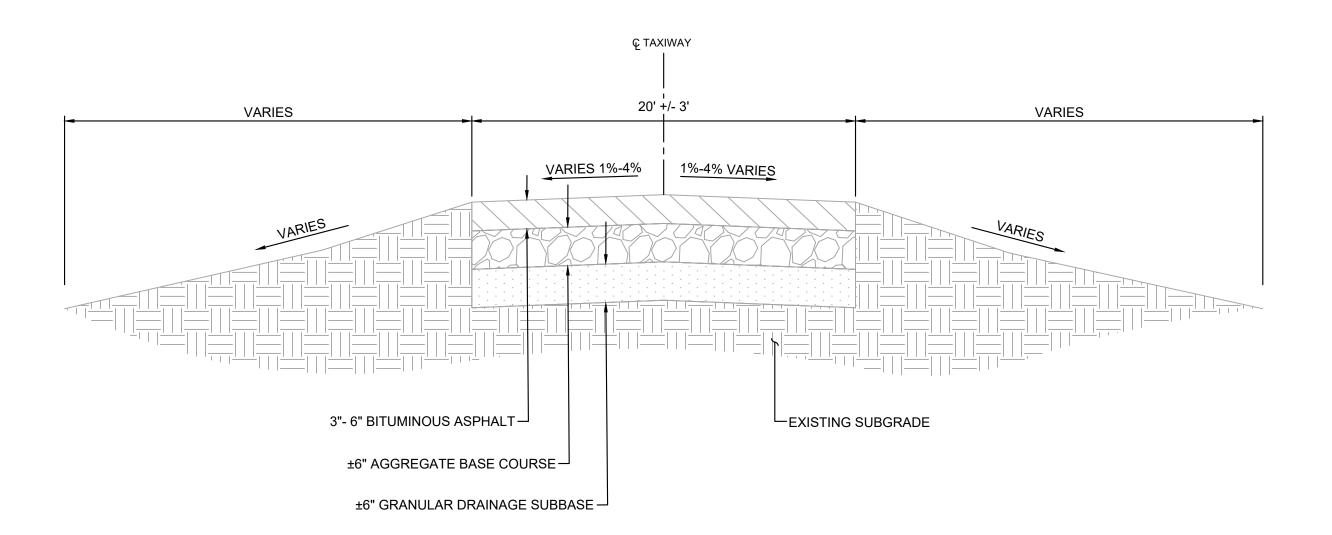

3 EXISTING TAXIWAY A TYPICAL SECTION
CT-201 NTS



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DATE: SCALE:
11/22/2024 NTS

DRAWN BY: CHECKED BY:
MPM JY

EV. DATE DESCRIPTION

DATE DESCRIPTION

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JCT REPLACEMENT PARALLEL TAXIWAY AN AIRPORT ROTATING BEACON

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COF LUKE M.

BURLINGAME


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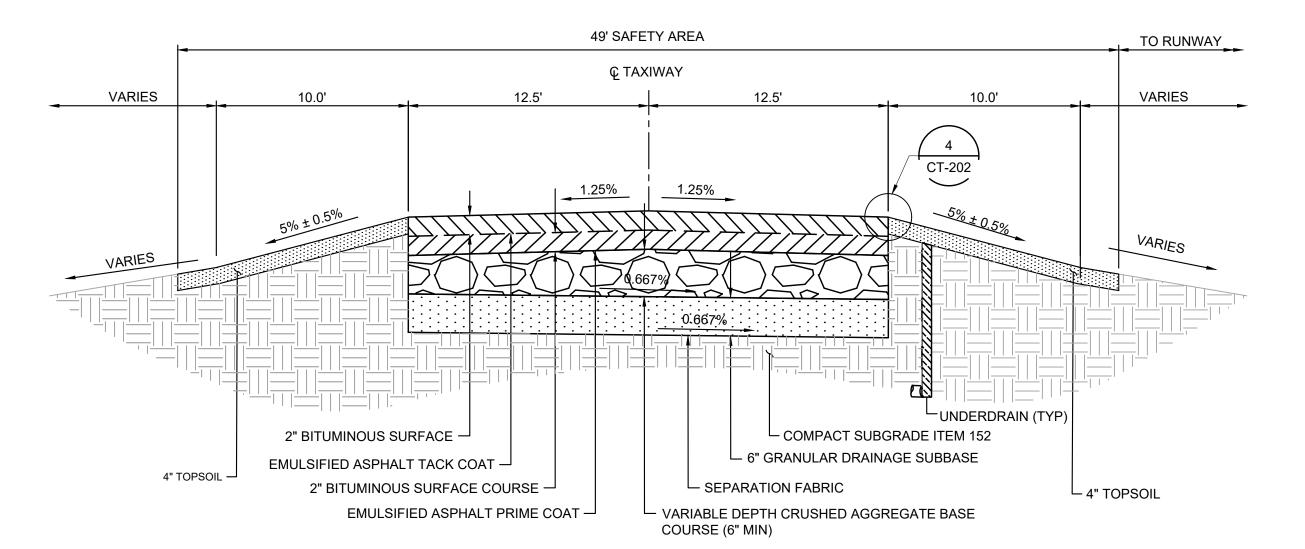
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CT-201




ASPHALT PAVEMENT TRANSITION WEDGE (LONGITUDINAL)

CT-202 NTS
TW A: STA. 1+03.60 TO STA. 1+13.60
TW A1: STA. 31+00.81 TO STA. 31+10.81
TW A2: STA. 40+96.68 TO STA. 41+11.71
TW A: STA. 35+09.56 TO STA. 35+19.56



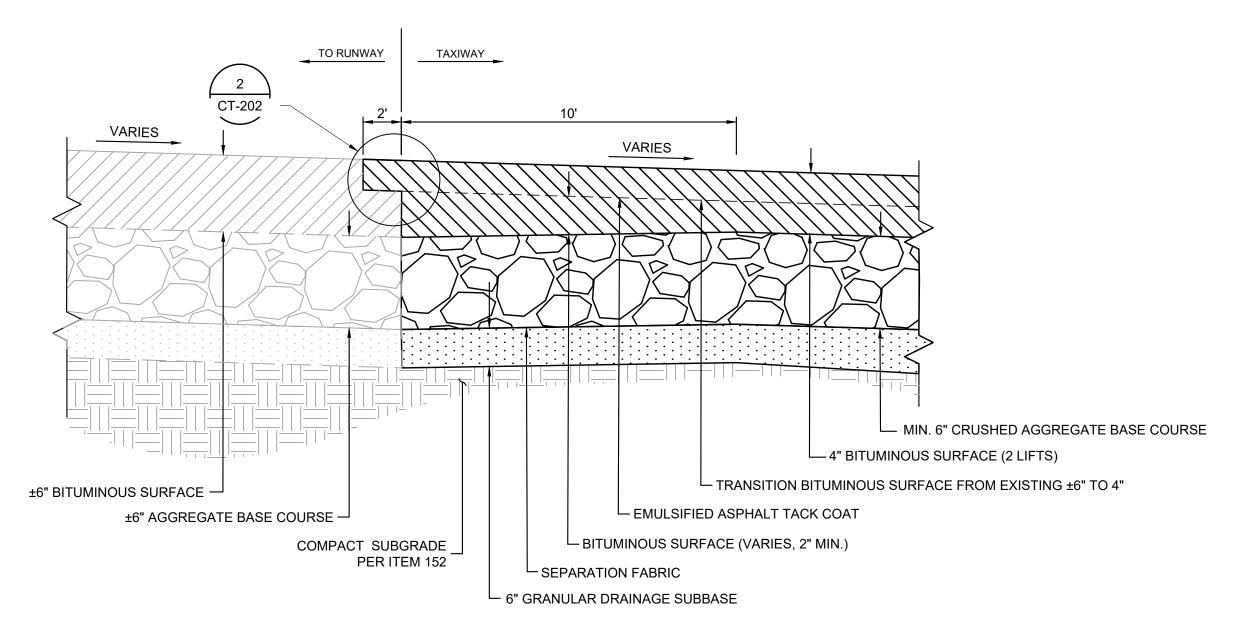

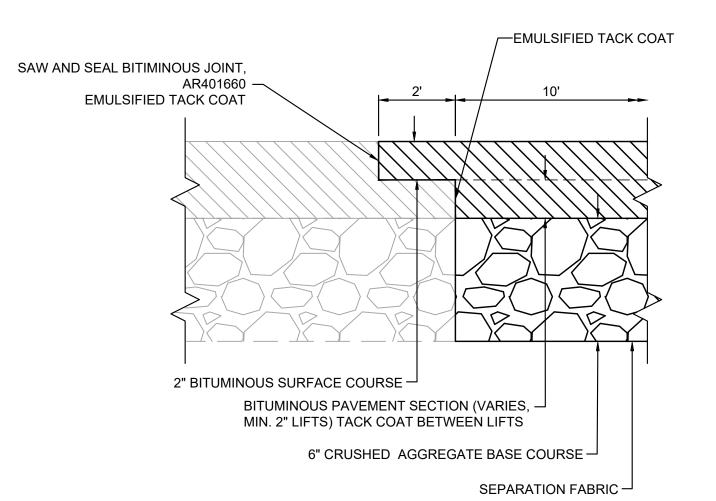

> EXISTING TO PROPOSED ASPHALT PAVEMENT TRANSITION

CT-202 NTS
TW A: STA. 1+01.60 TO STA. 1+03.60
TW A1: STA. 30+98.81 TO STA. 31+00.81
TW A2: STA. 40+94.68 TO STA. 41+01.71
TW A: STA. 35+19.56 TO STA. 35+21.56

### **GENERAL SHEET NOTES**

- REFER TO BORING LOGS FOR EXISTING PAVEMENT INFORMATION.
- 2. EXISTING TYPICAL SECTIONS ARE APPROXIMATE AND SHOWN AS SUPPLEMENTAL INFORMATION ONLY. PAVEMENT DEPTHS WERE COMPILED BASED ON THE BEST AVAILABLE RECORDS AND MAY VARY DUE TO INCONSISTENT PAVEMENT THICKNESSES AND/OR GUIDANCE.
- 3. EXPOSED SUBGRADE AND BASE MATERIAL SHALL BE KEPT MOIST, COMPACTED AND TREATED WITH A DUST PALLIATIVE TO MINIMIZE FOD.
- 4. THE CONTRACTOR SHALL BE RESPONSIBLE FOR ALL DEWATERING AT NO ADDITIONAL COST TO THE CONTRACT ANY REWORK OR ADDITIONAL WORK REQUIRED BECAUSE OF THE CONTRACTOR'S FAILURE TO MAINTAIN ADEQUATE DRAINAGE WILL BE AT THE CONTRACTOR'S EXPENSE.
- 5. THE CONTRACTOR SHALL LOCATE, FLAG, AND PROTECT ALL EXISTING FACULTIES, UNDERGROUND UTILITIES, STORM SEWER PIPES AND STRUCTURES. DAMAGE TO ANY INFRASTRUCTURE ON OR OFF AIRPORT PROPERTY AS DETERMINED BY THE ENGINEER SHALL BE IMMEDIATELY REPAIRED OR REPLACED BY THE CONTRACTOR TO THE OWNER'S APPROVAL AT NO ADDITIONAL COST TO THE CONTRACT.
- 6. SURFACE DAMAGE OR CRACKING OF EXISTING
  BITUMINOUS/CONCRETE PAVEMENTS TO REMAIN OR
  BUILDING FOUNDATIONS CAUSED BY THE CONTRACTOR AS
  DETERMINED BY THE ENGINEER SHALL BE REPAIRED OR
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  TO THE CONTRACT.



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PROPOSED TYPICAL SECTIONS
PROJECT:
CONSTRUCT REPLACEMENT PARALLEL TAX
REPLACE AIRPORT ROTATING BEACON

CERTIFICATION:

LUKE M.

BURLINGAME


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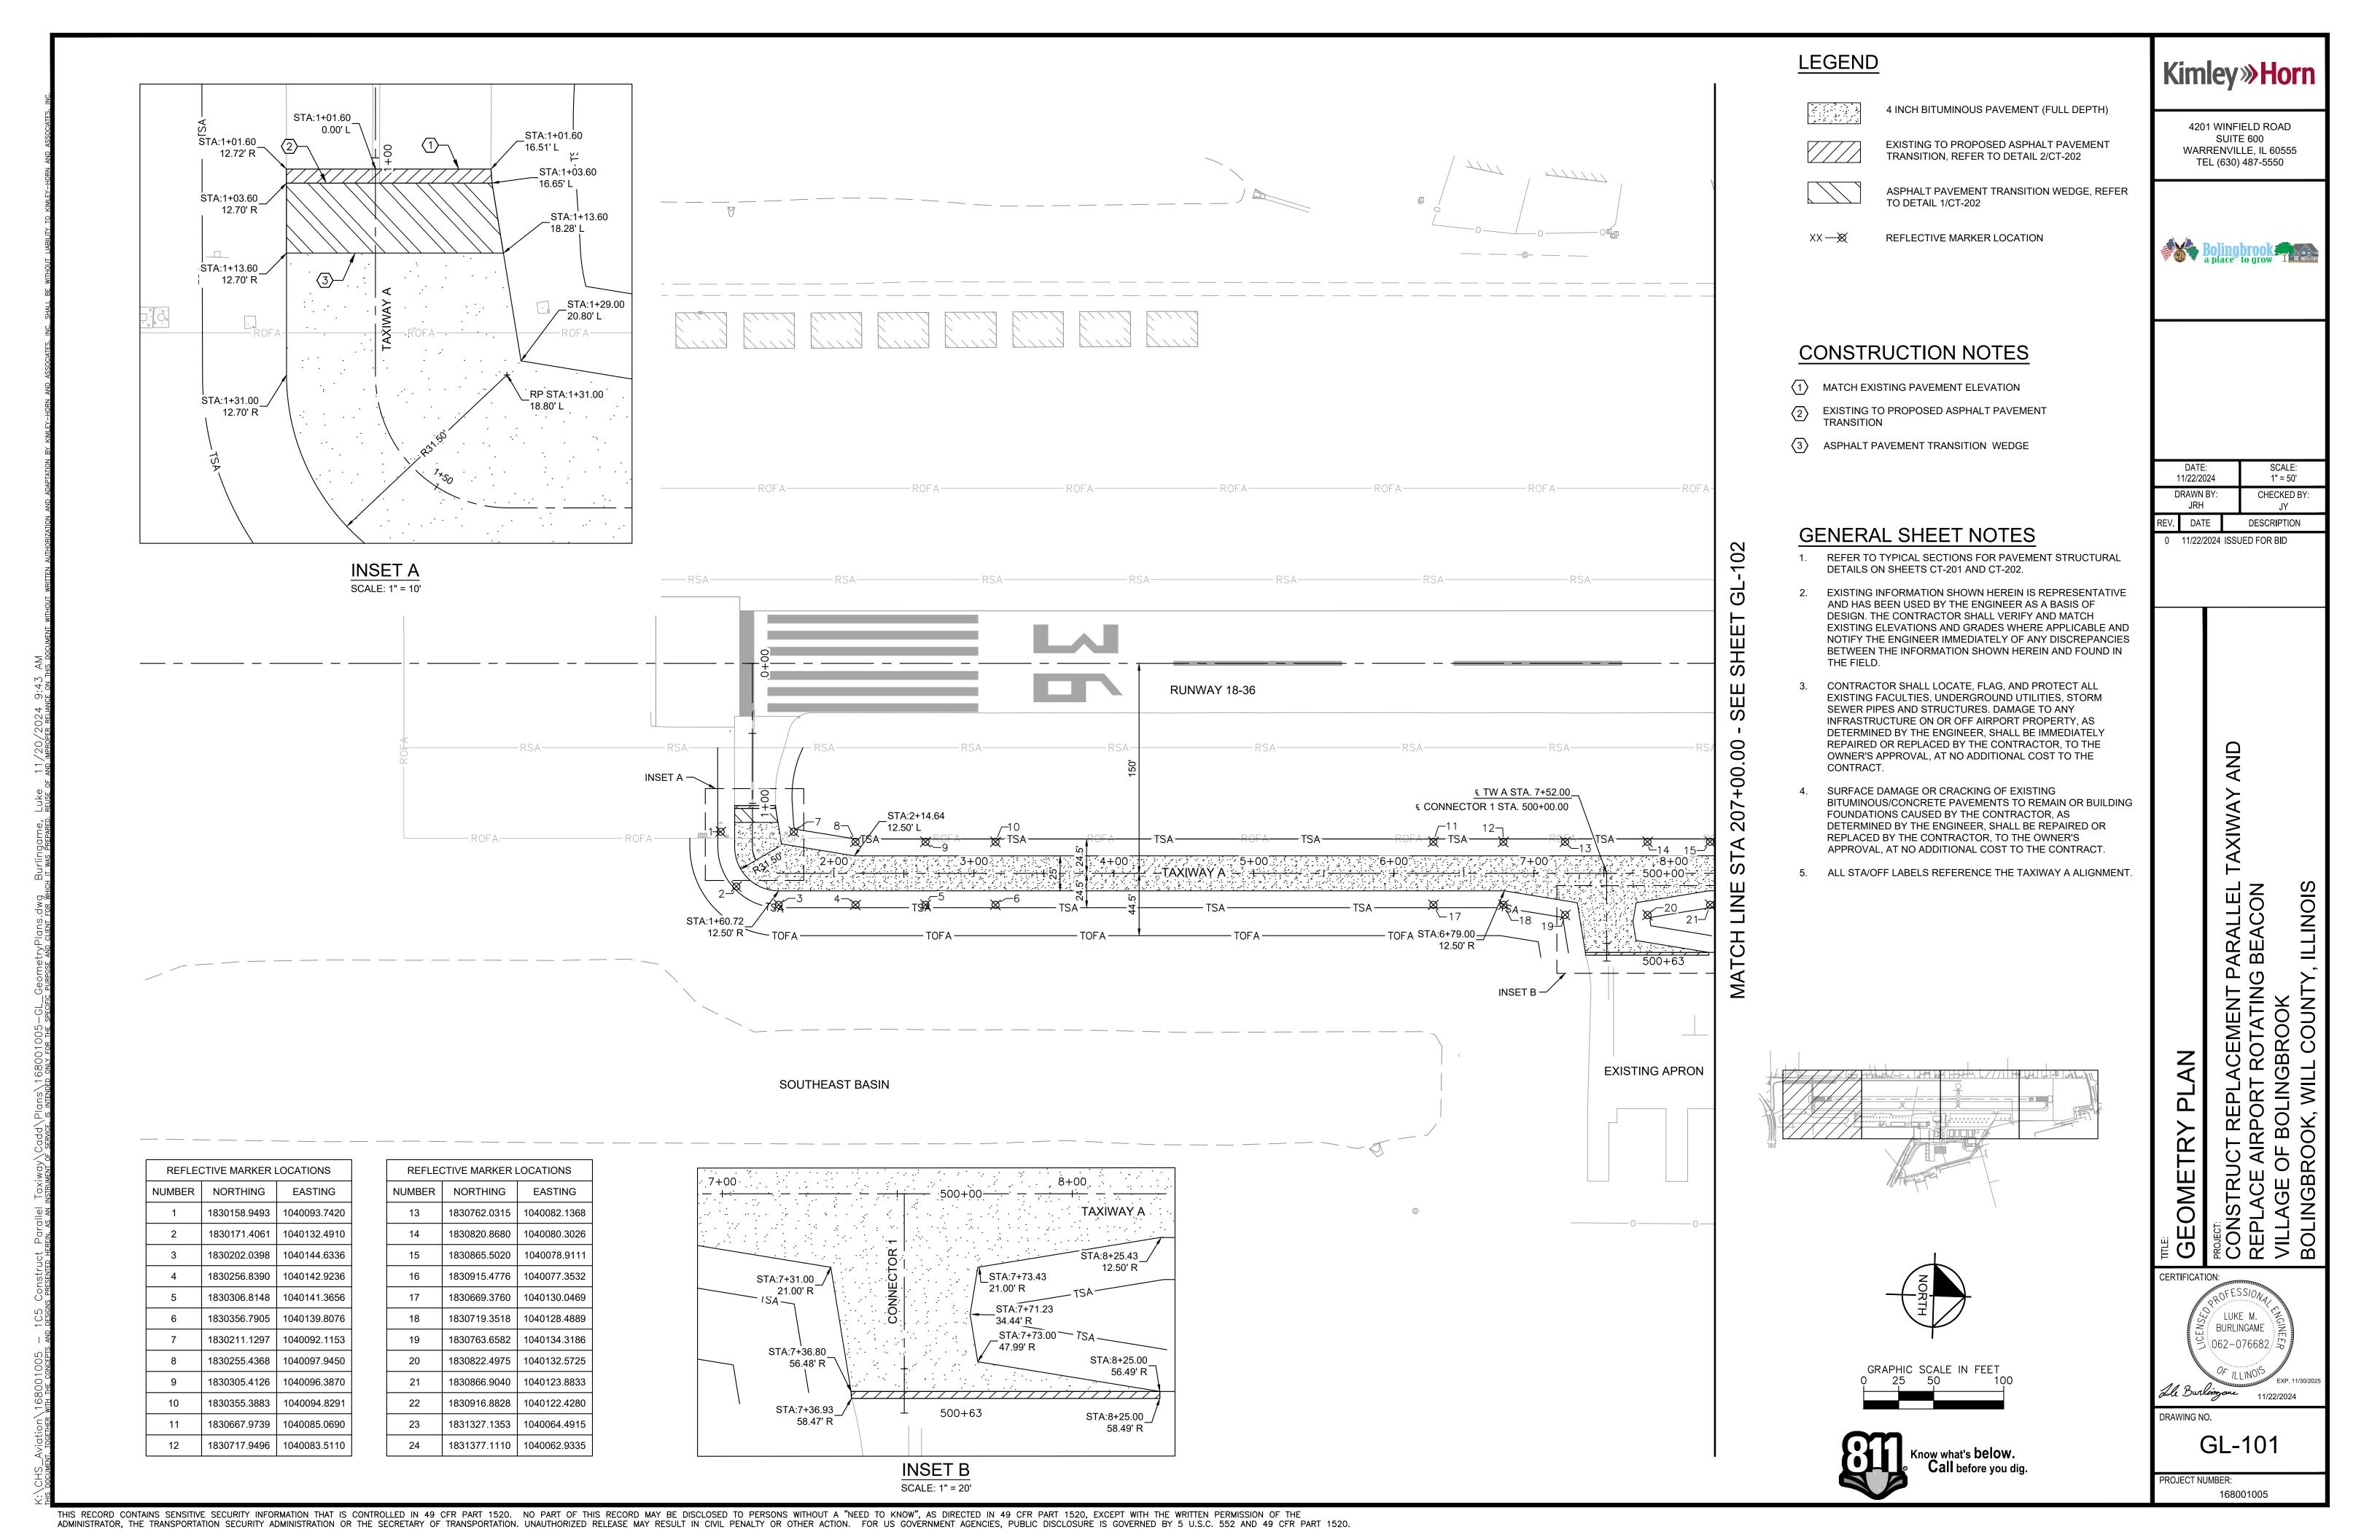
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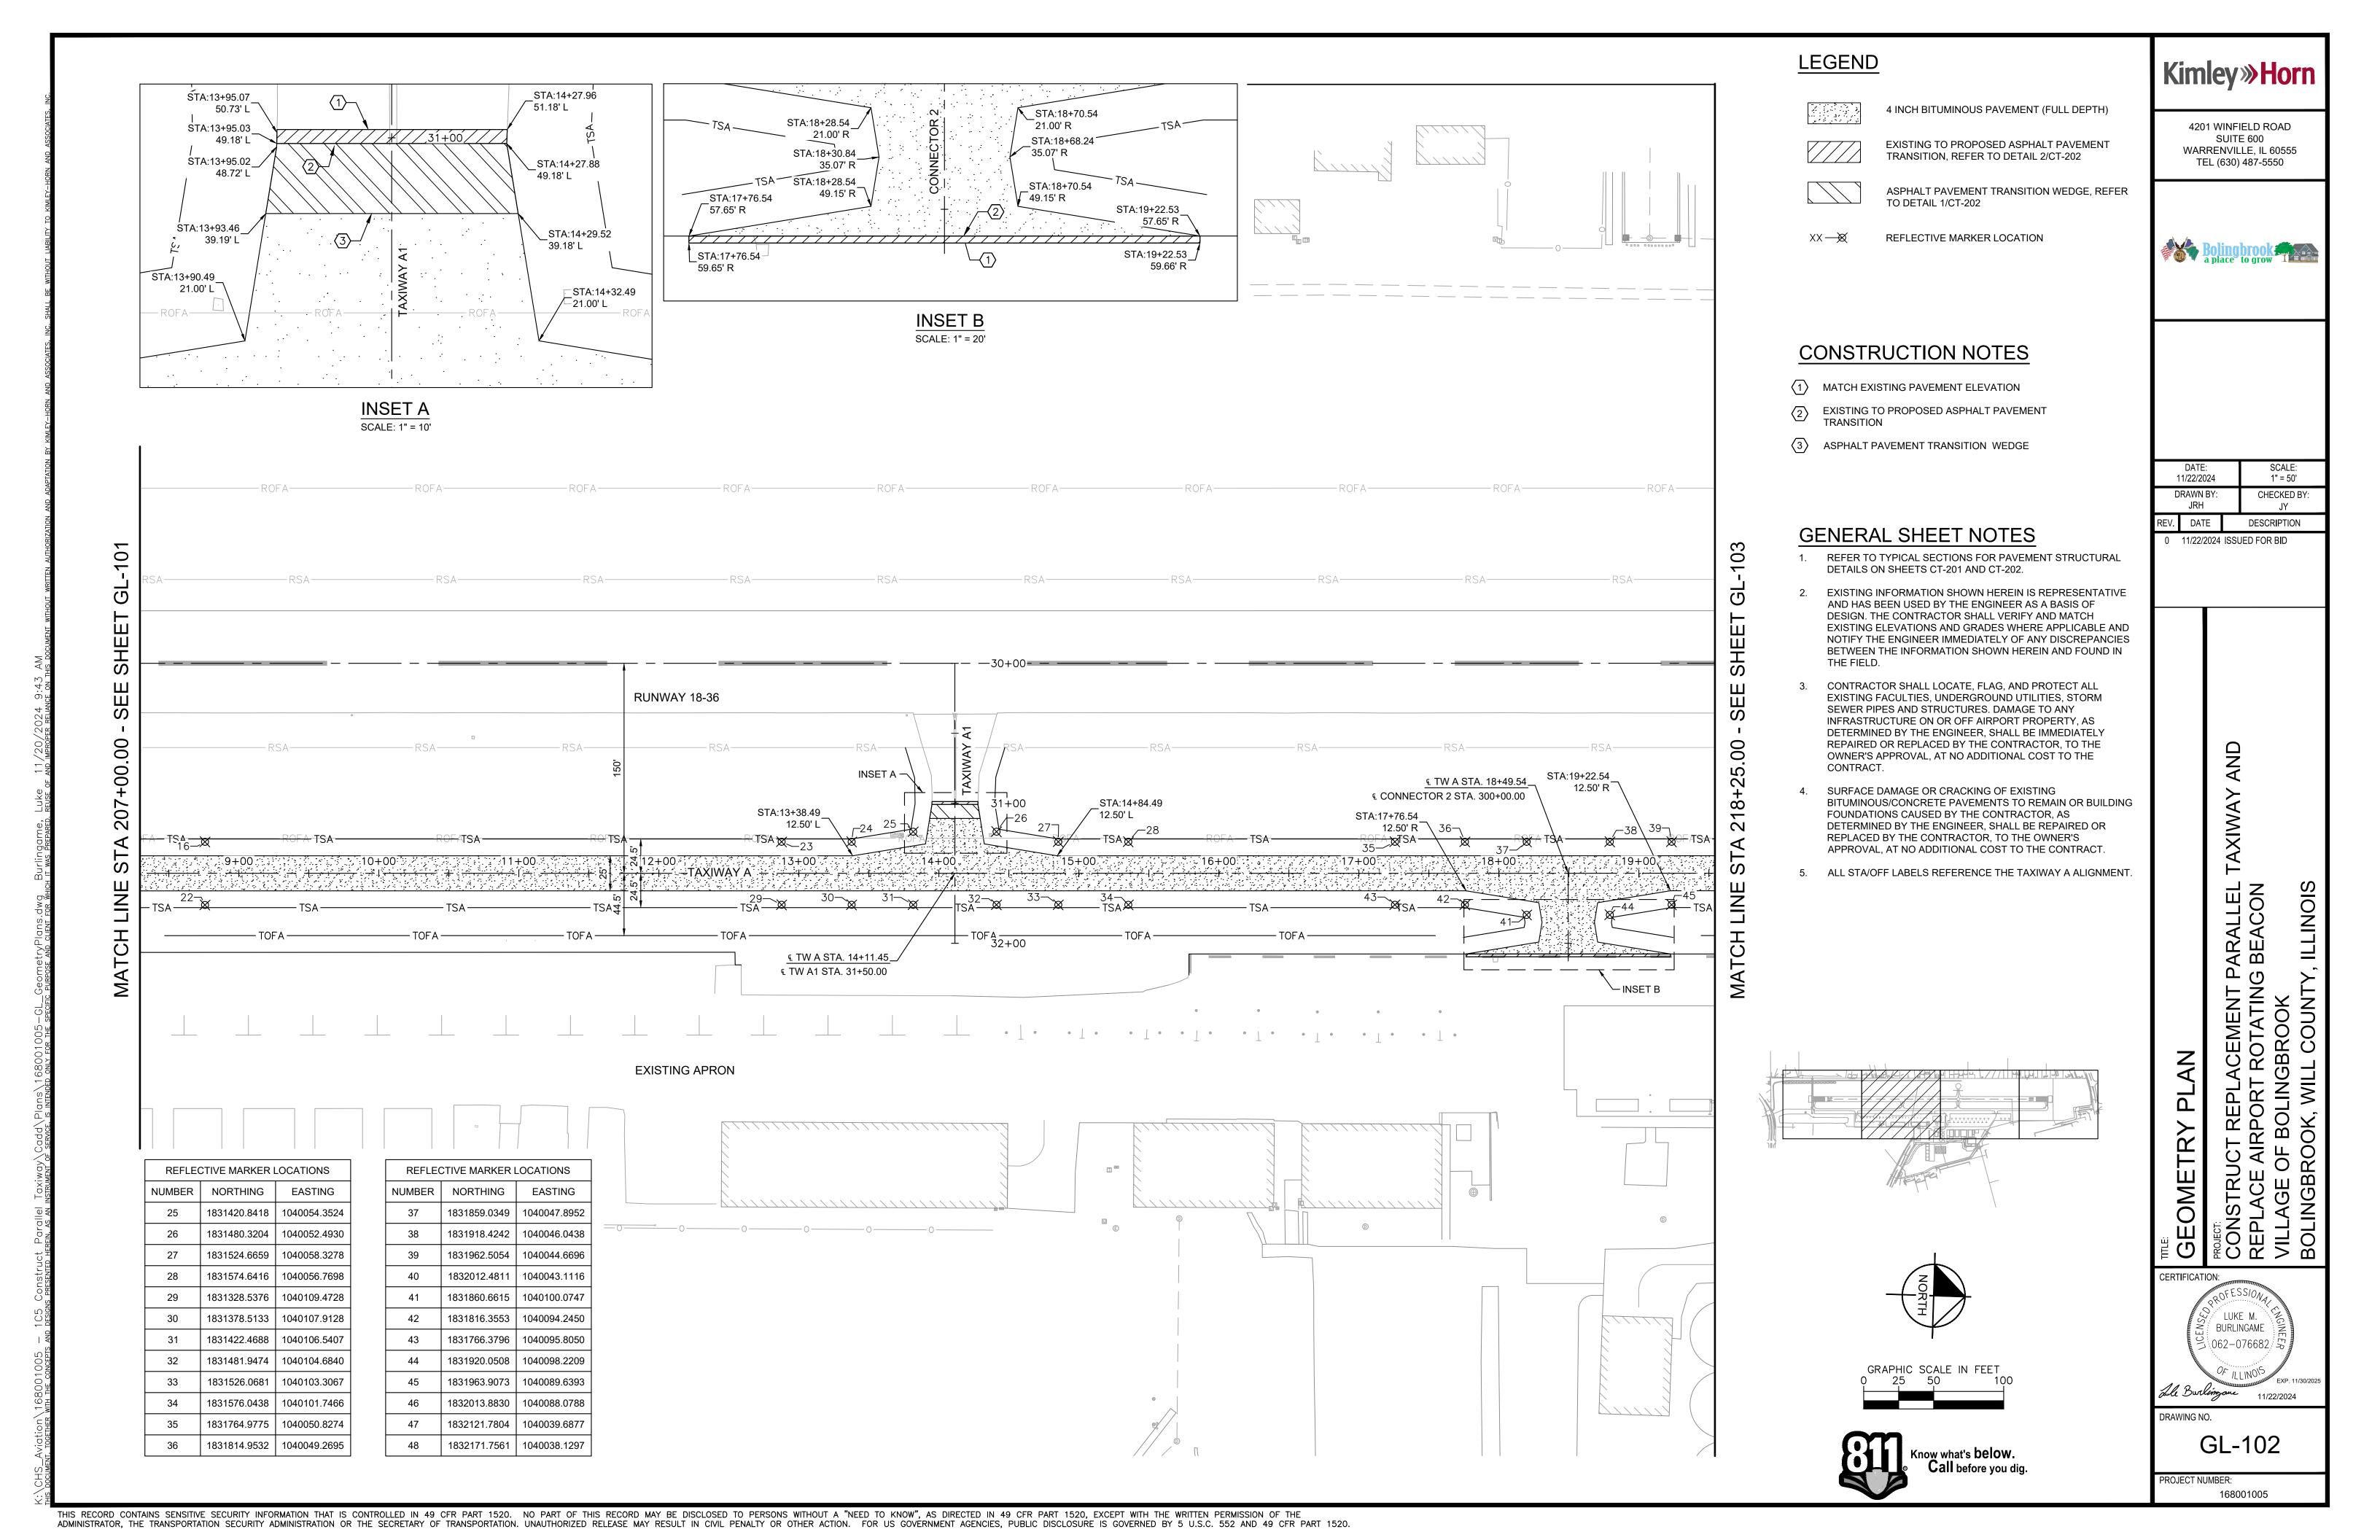
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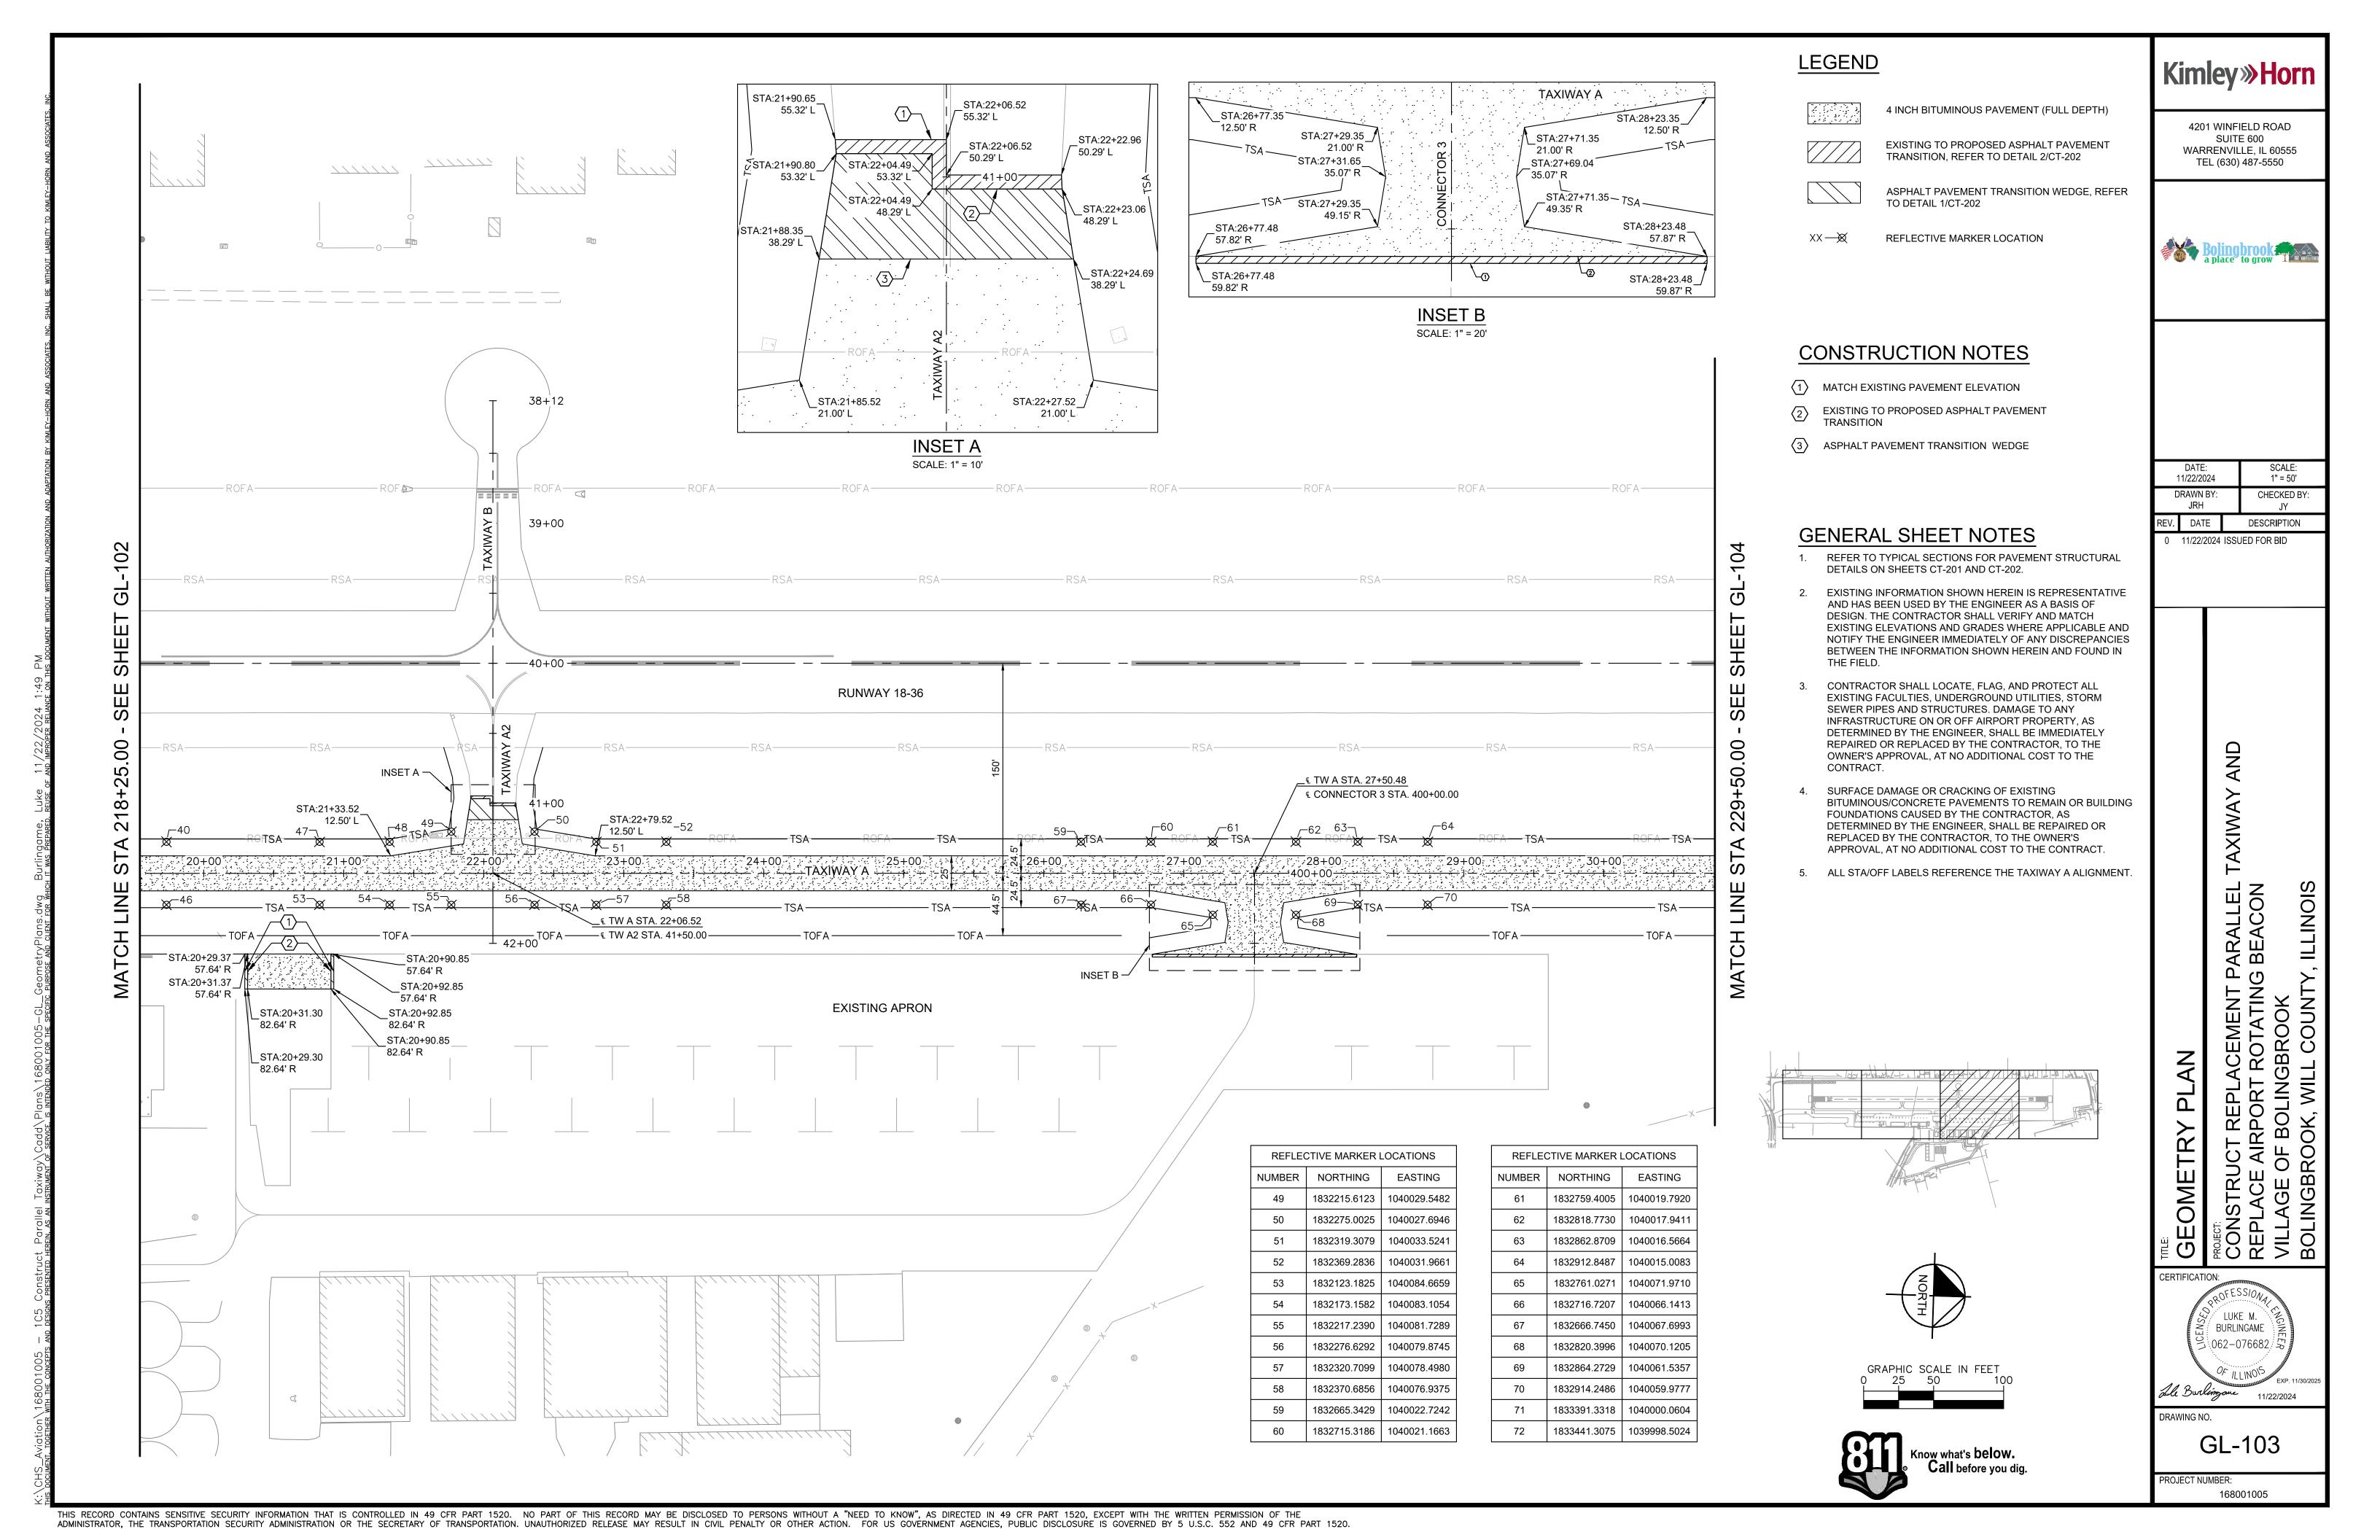
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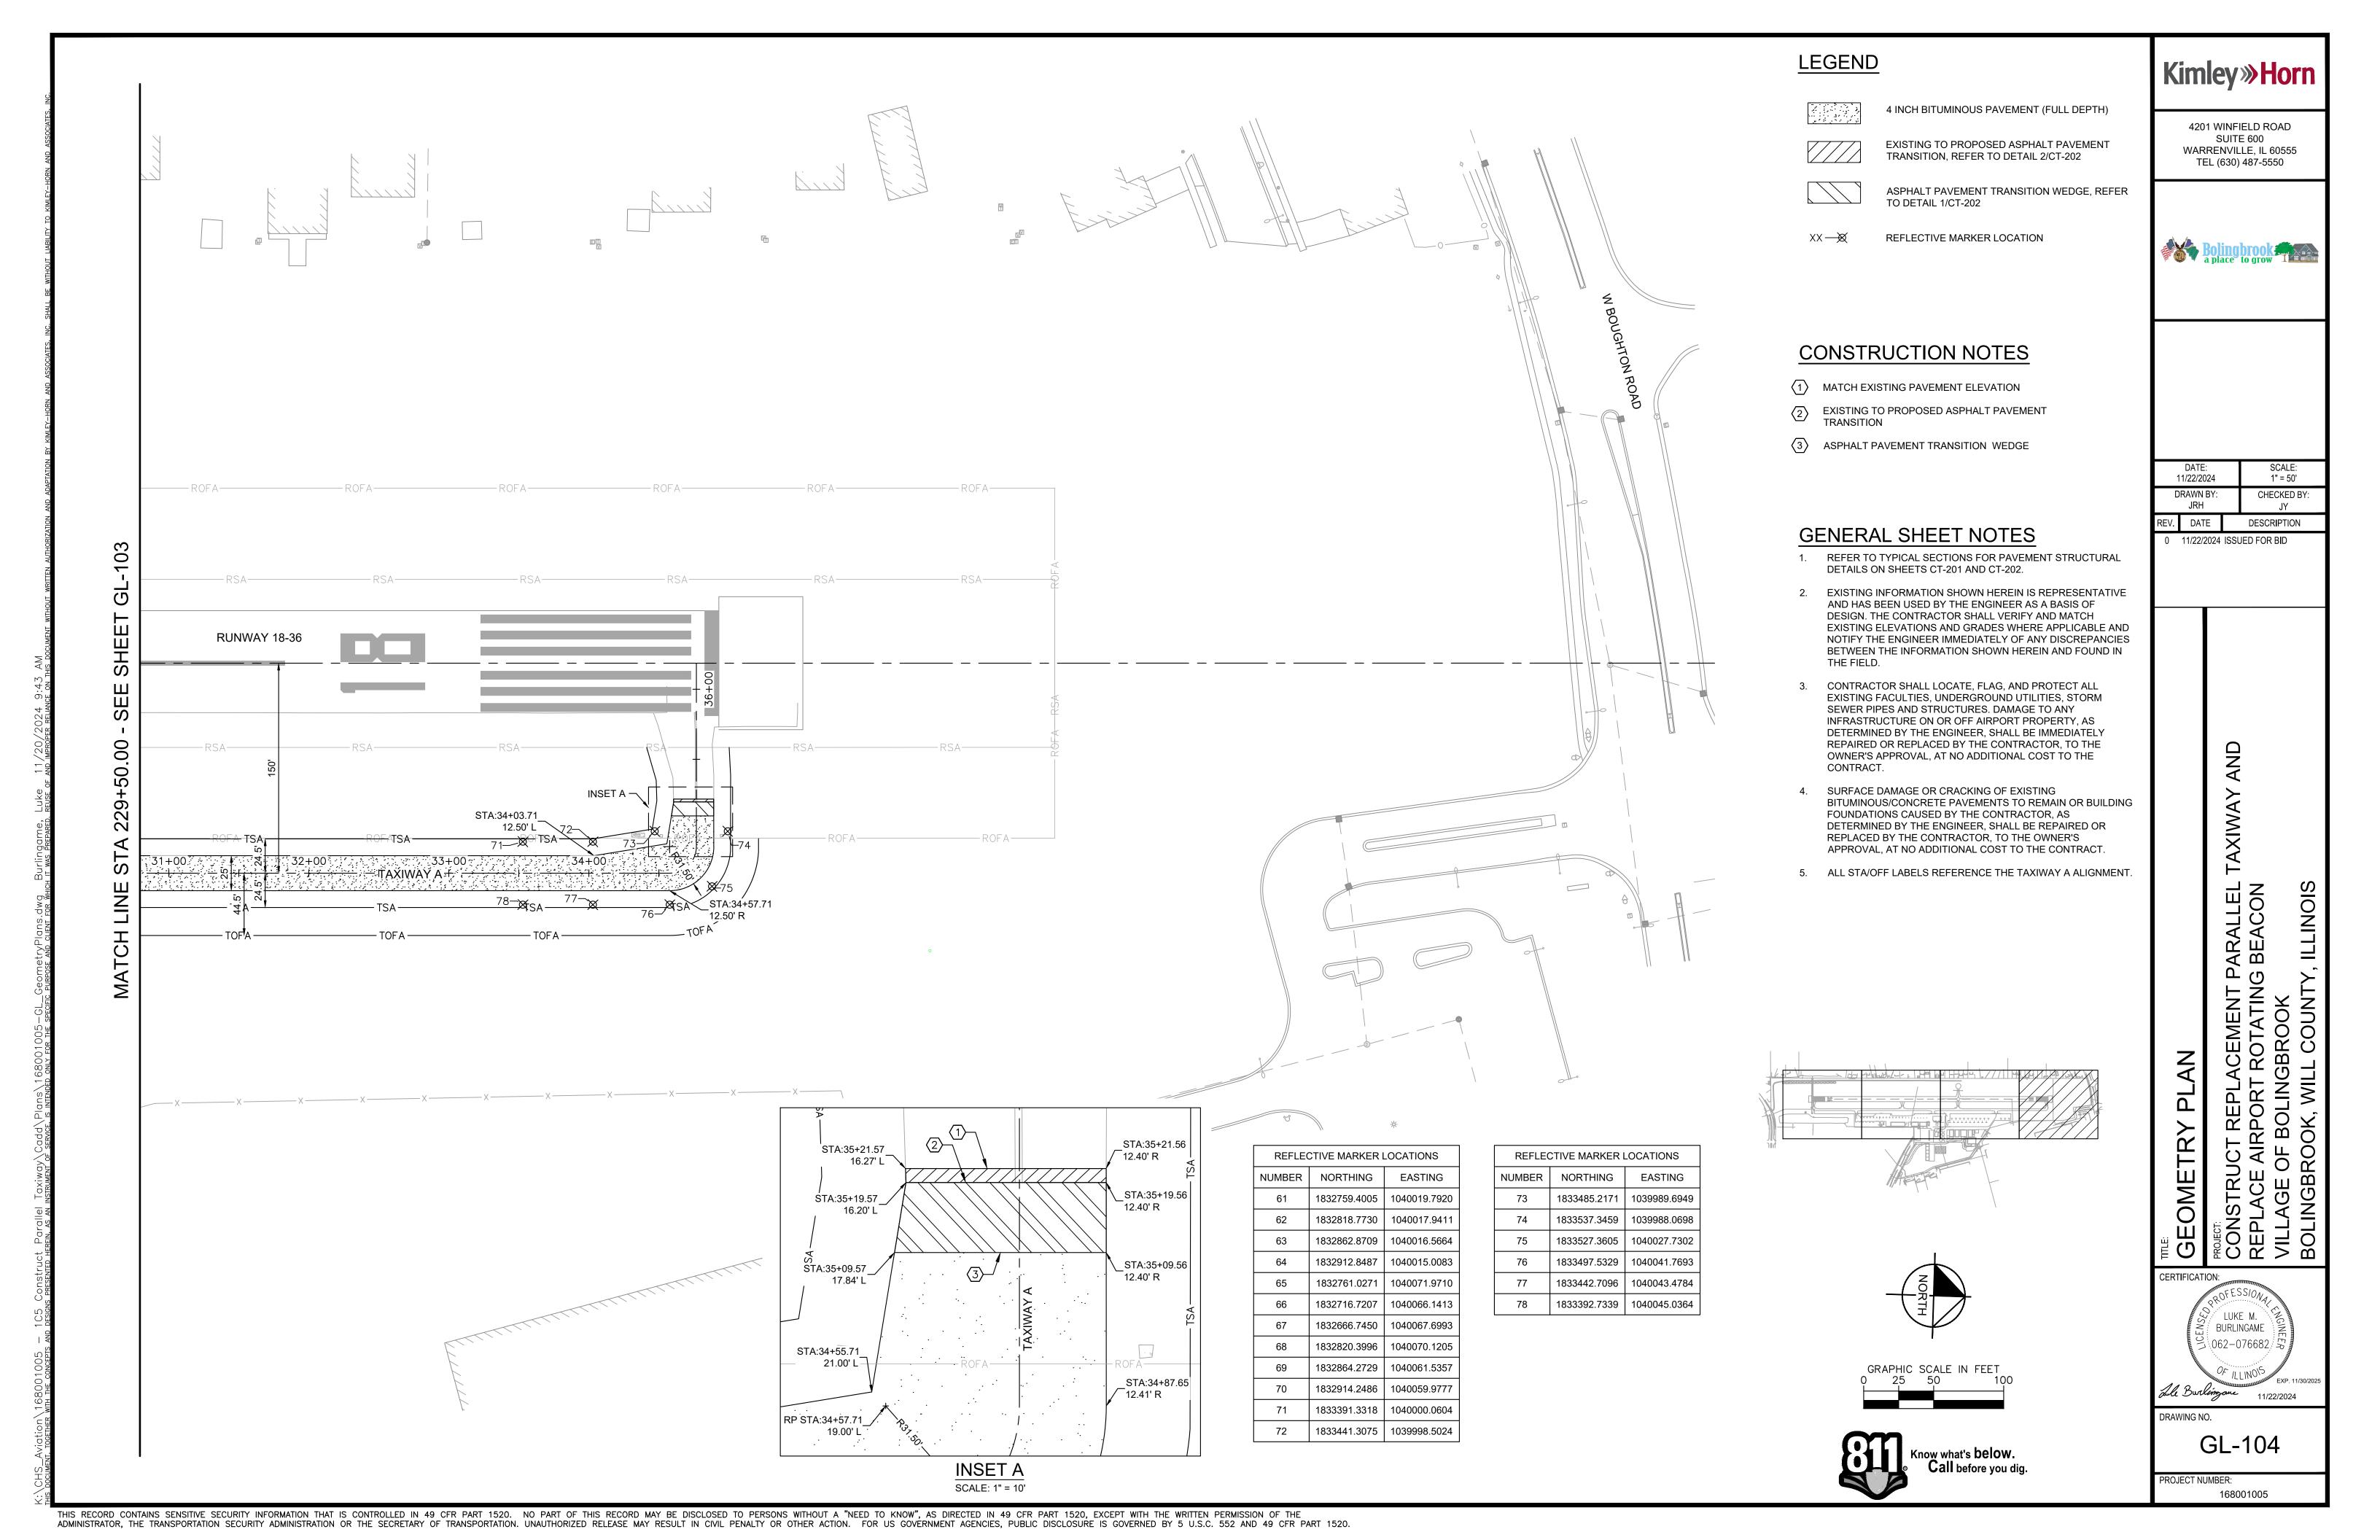












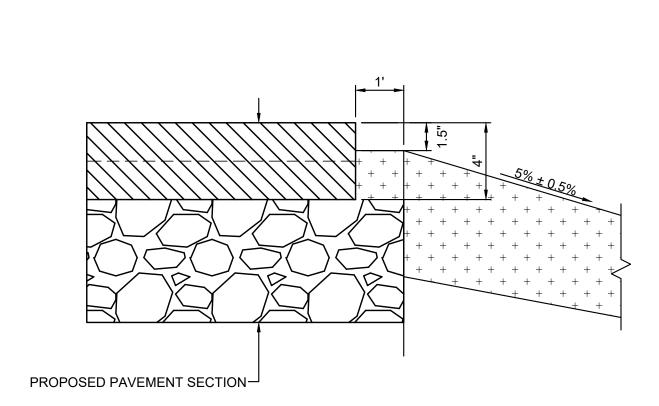

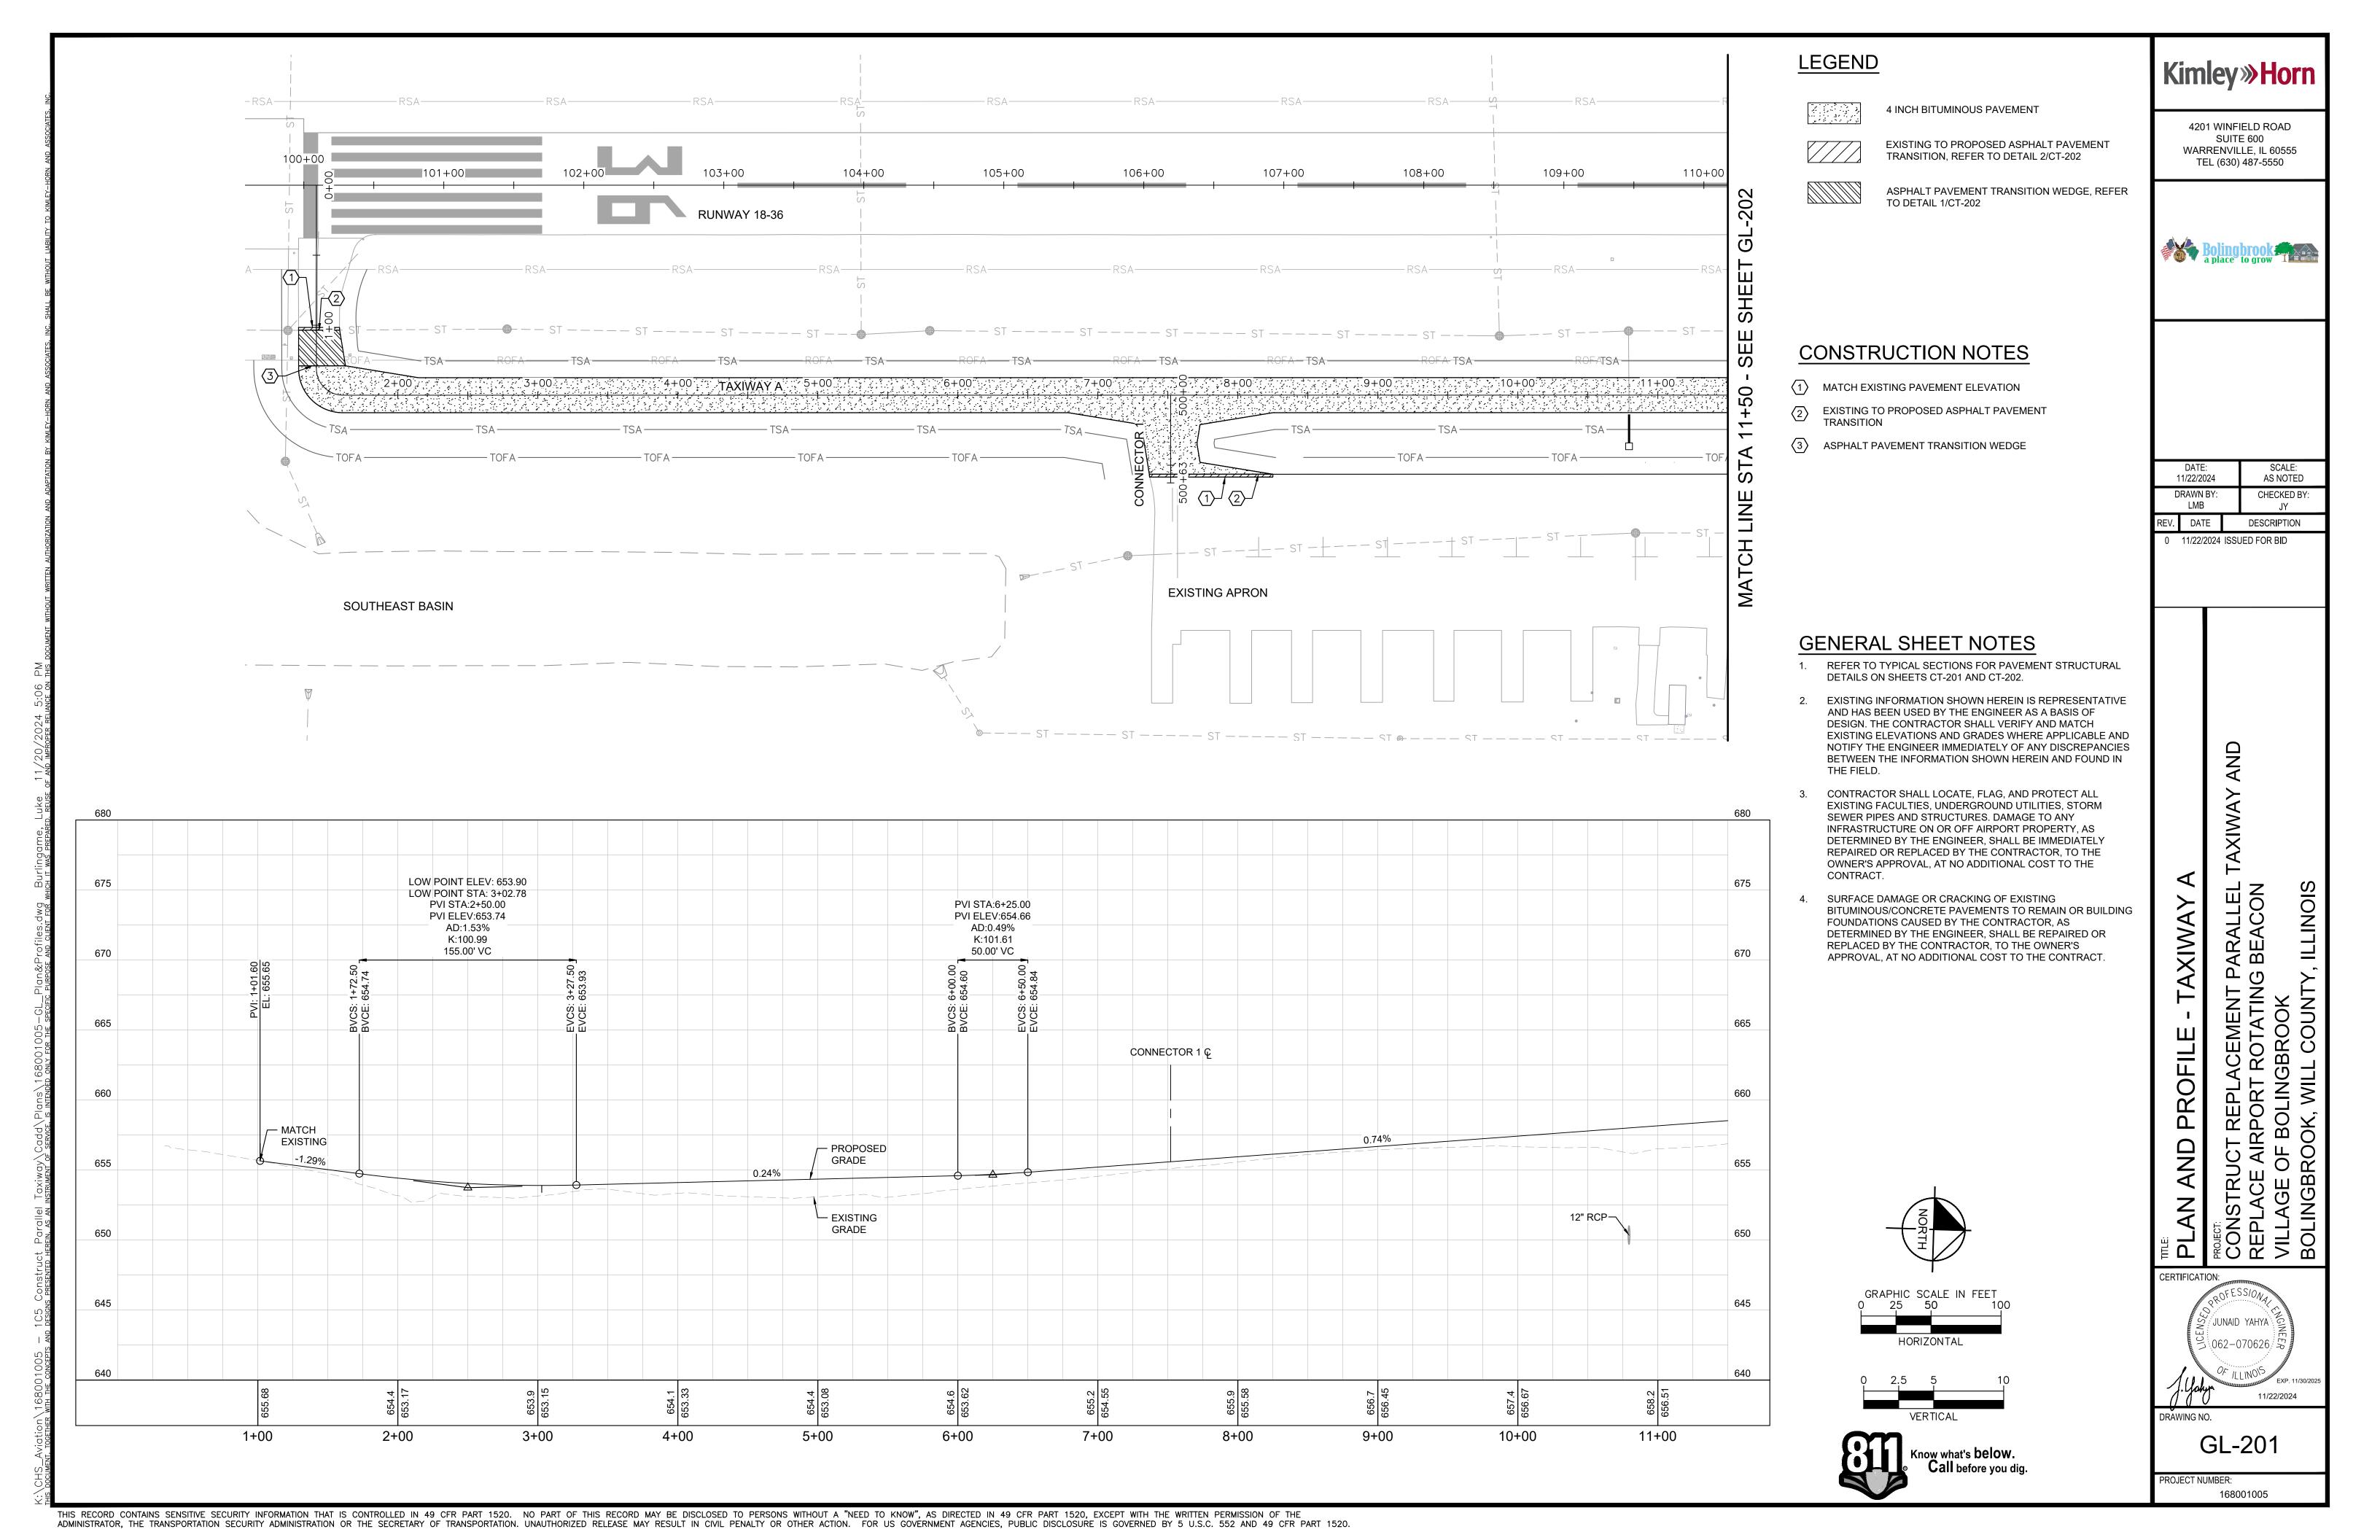

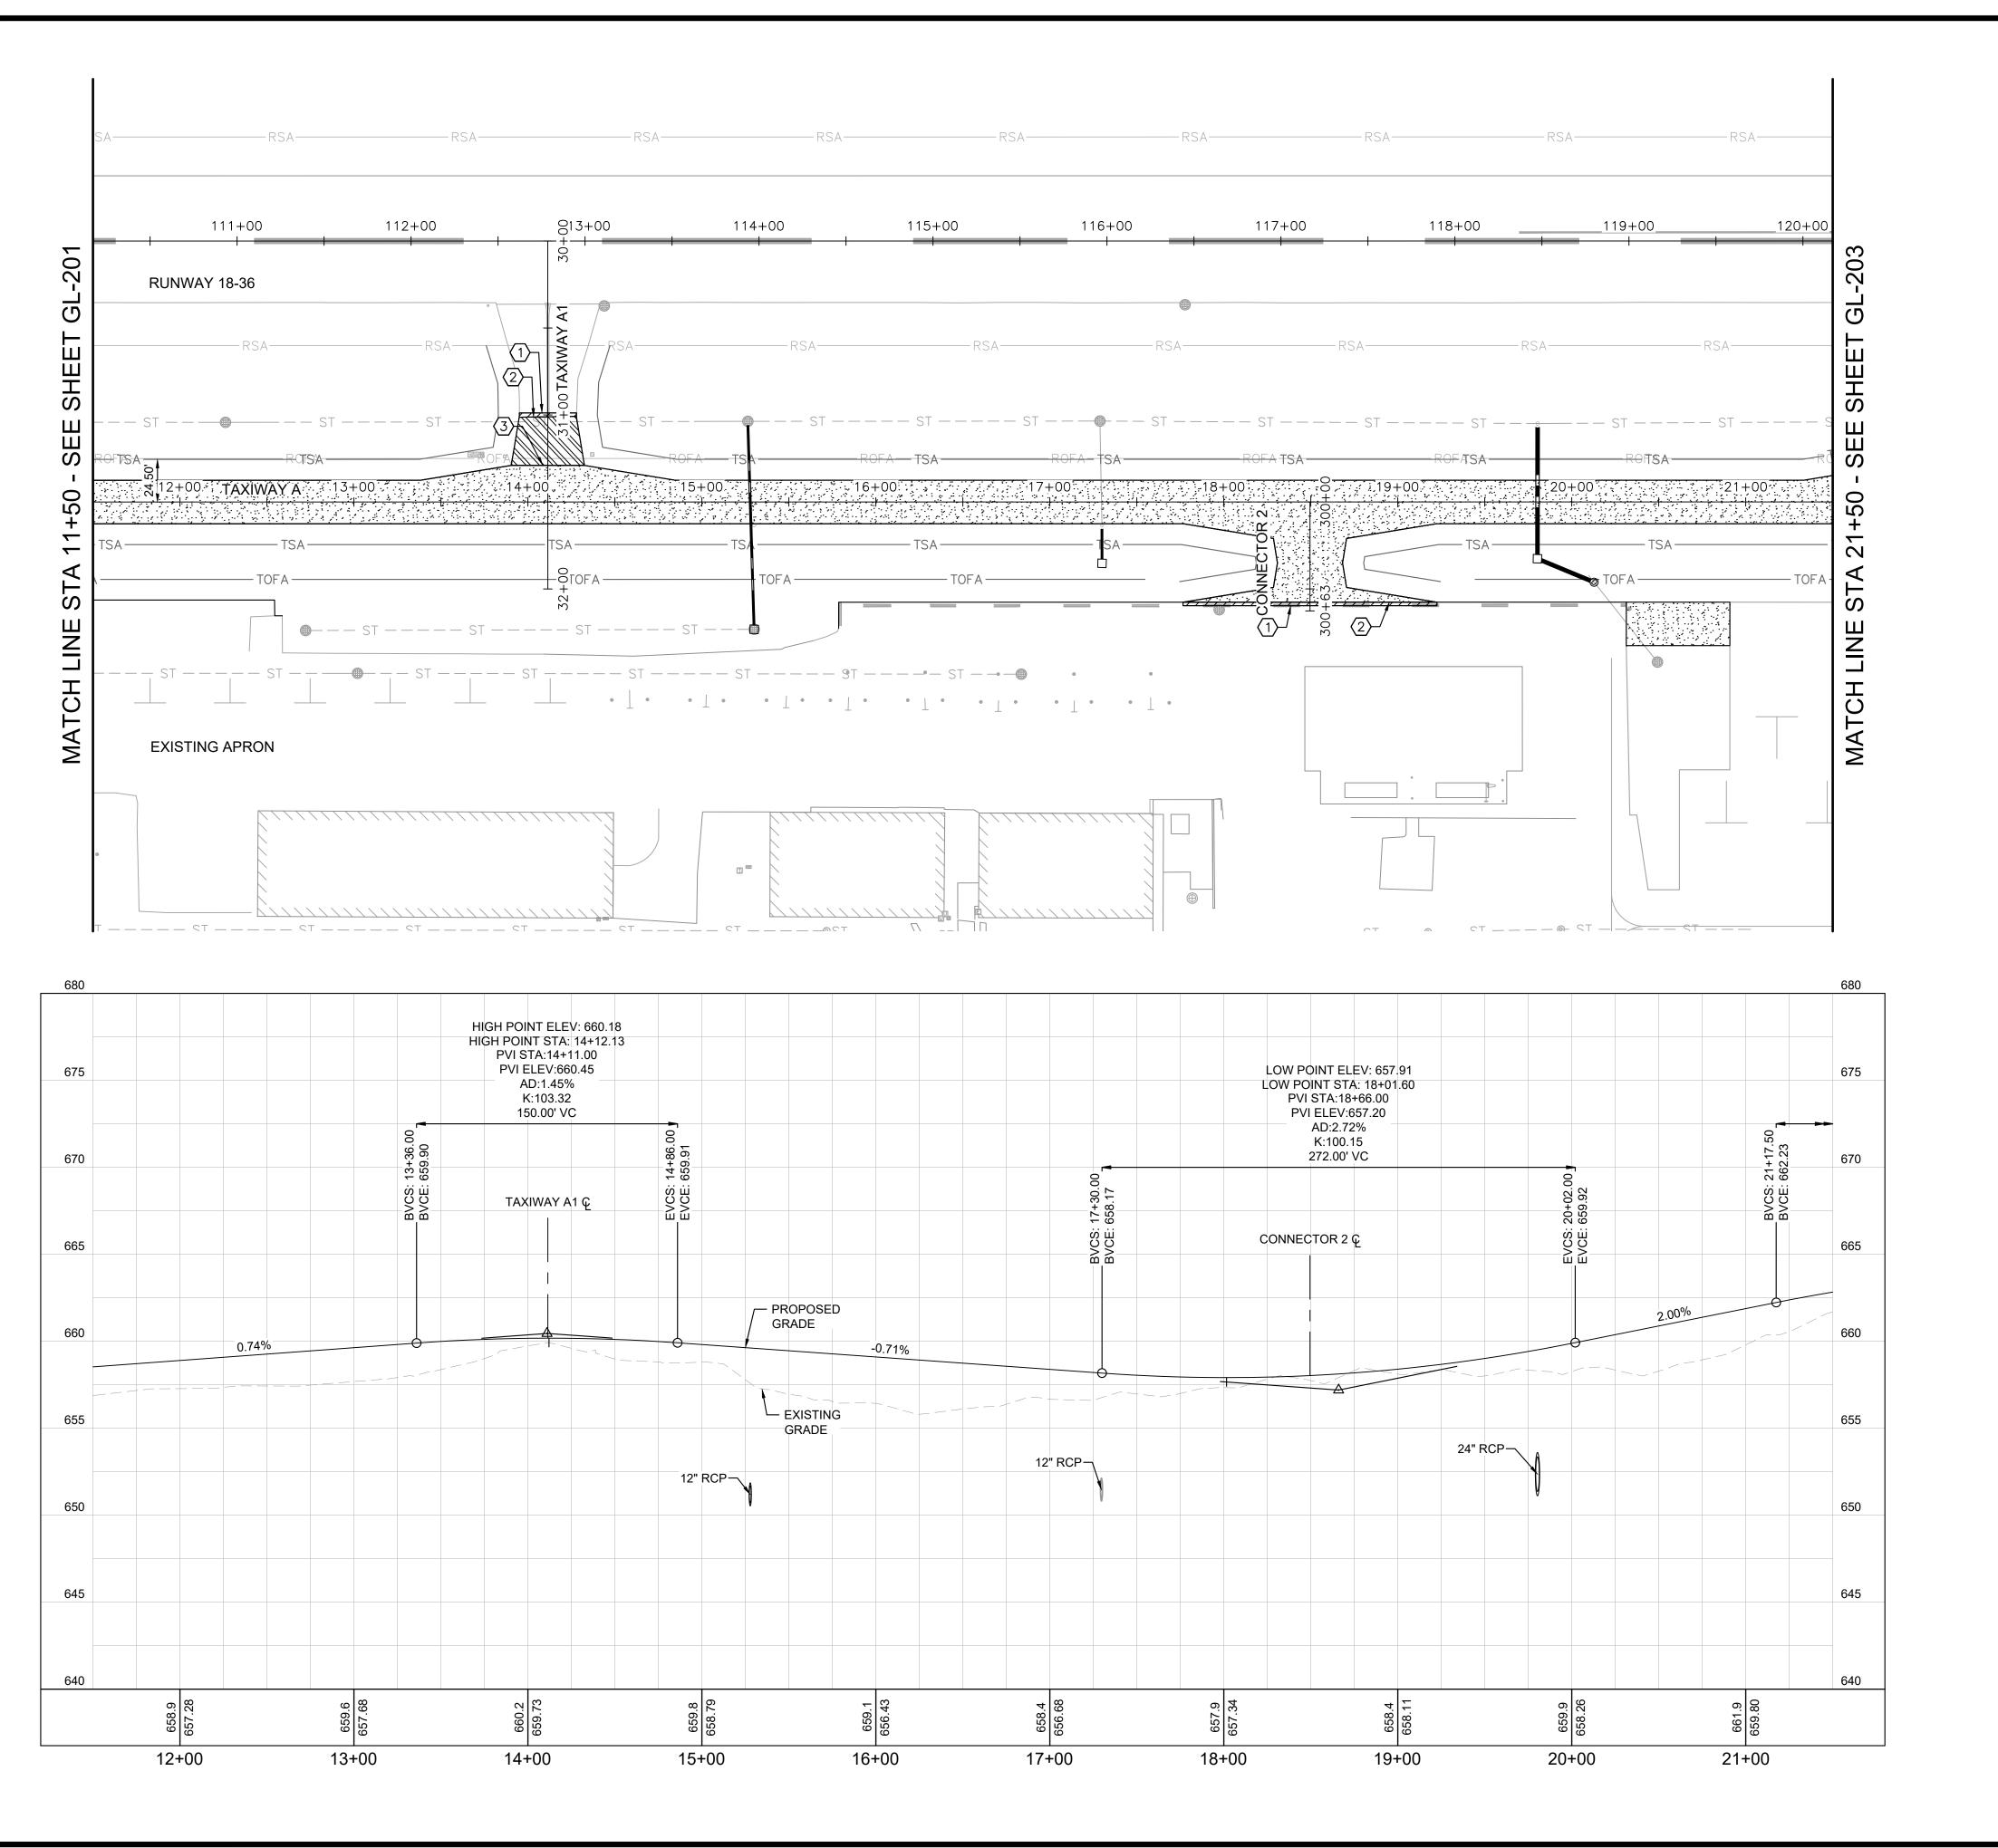


### LEGEND



4 INCH BITUMINOUS PAVEMENT



EXISTING TO PROPOSED ASPHALT PAVEMENT

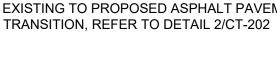

ASPHALT PAVEMENT TRANSITION WEDGE, REFER TO DETAIL 1/CT-202

### CONSTRUCTION NOTES

- (1) MATCH EXISTING PAVEMENT ELEVATION
- EXISTING TO PROPOSED ASPHALT PAVEMENT TRANSITION
- 3 ASPHALT PAVEMENT TRANSITION WEDGE

1	DATE: 1/22/2024	SCALE: AS NOTED	
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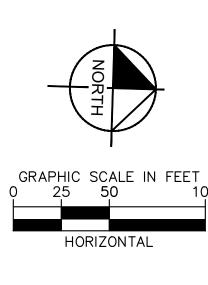
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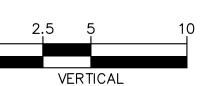
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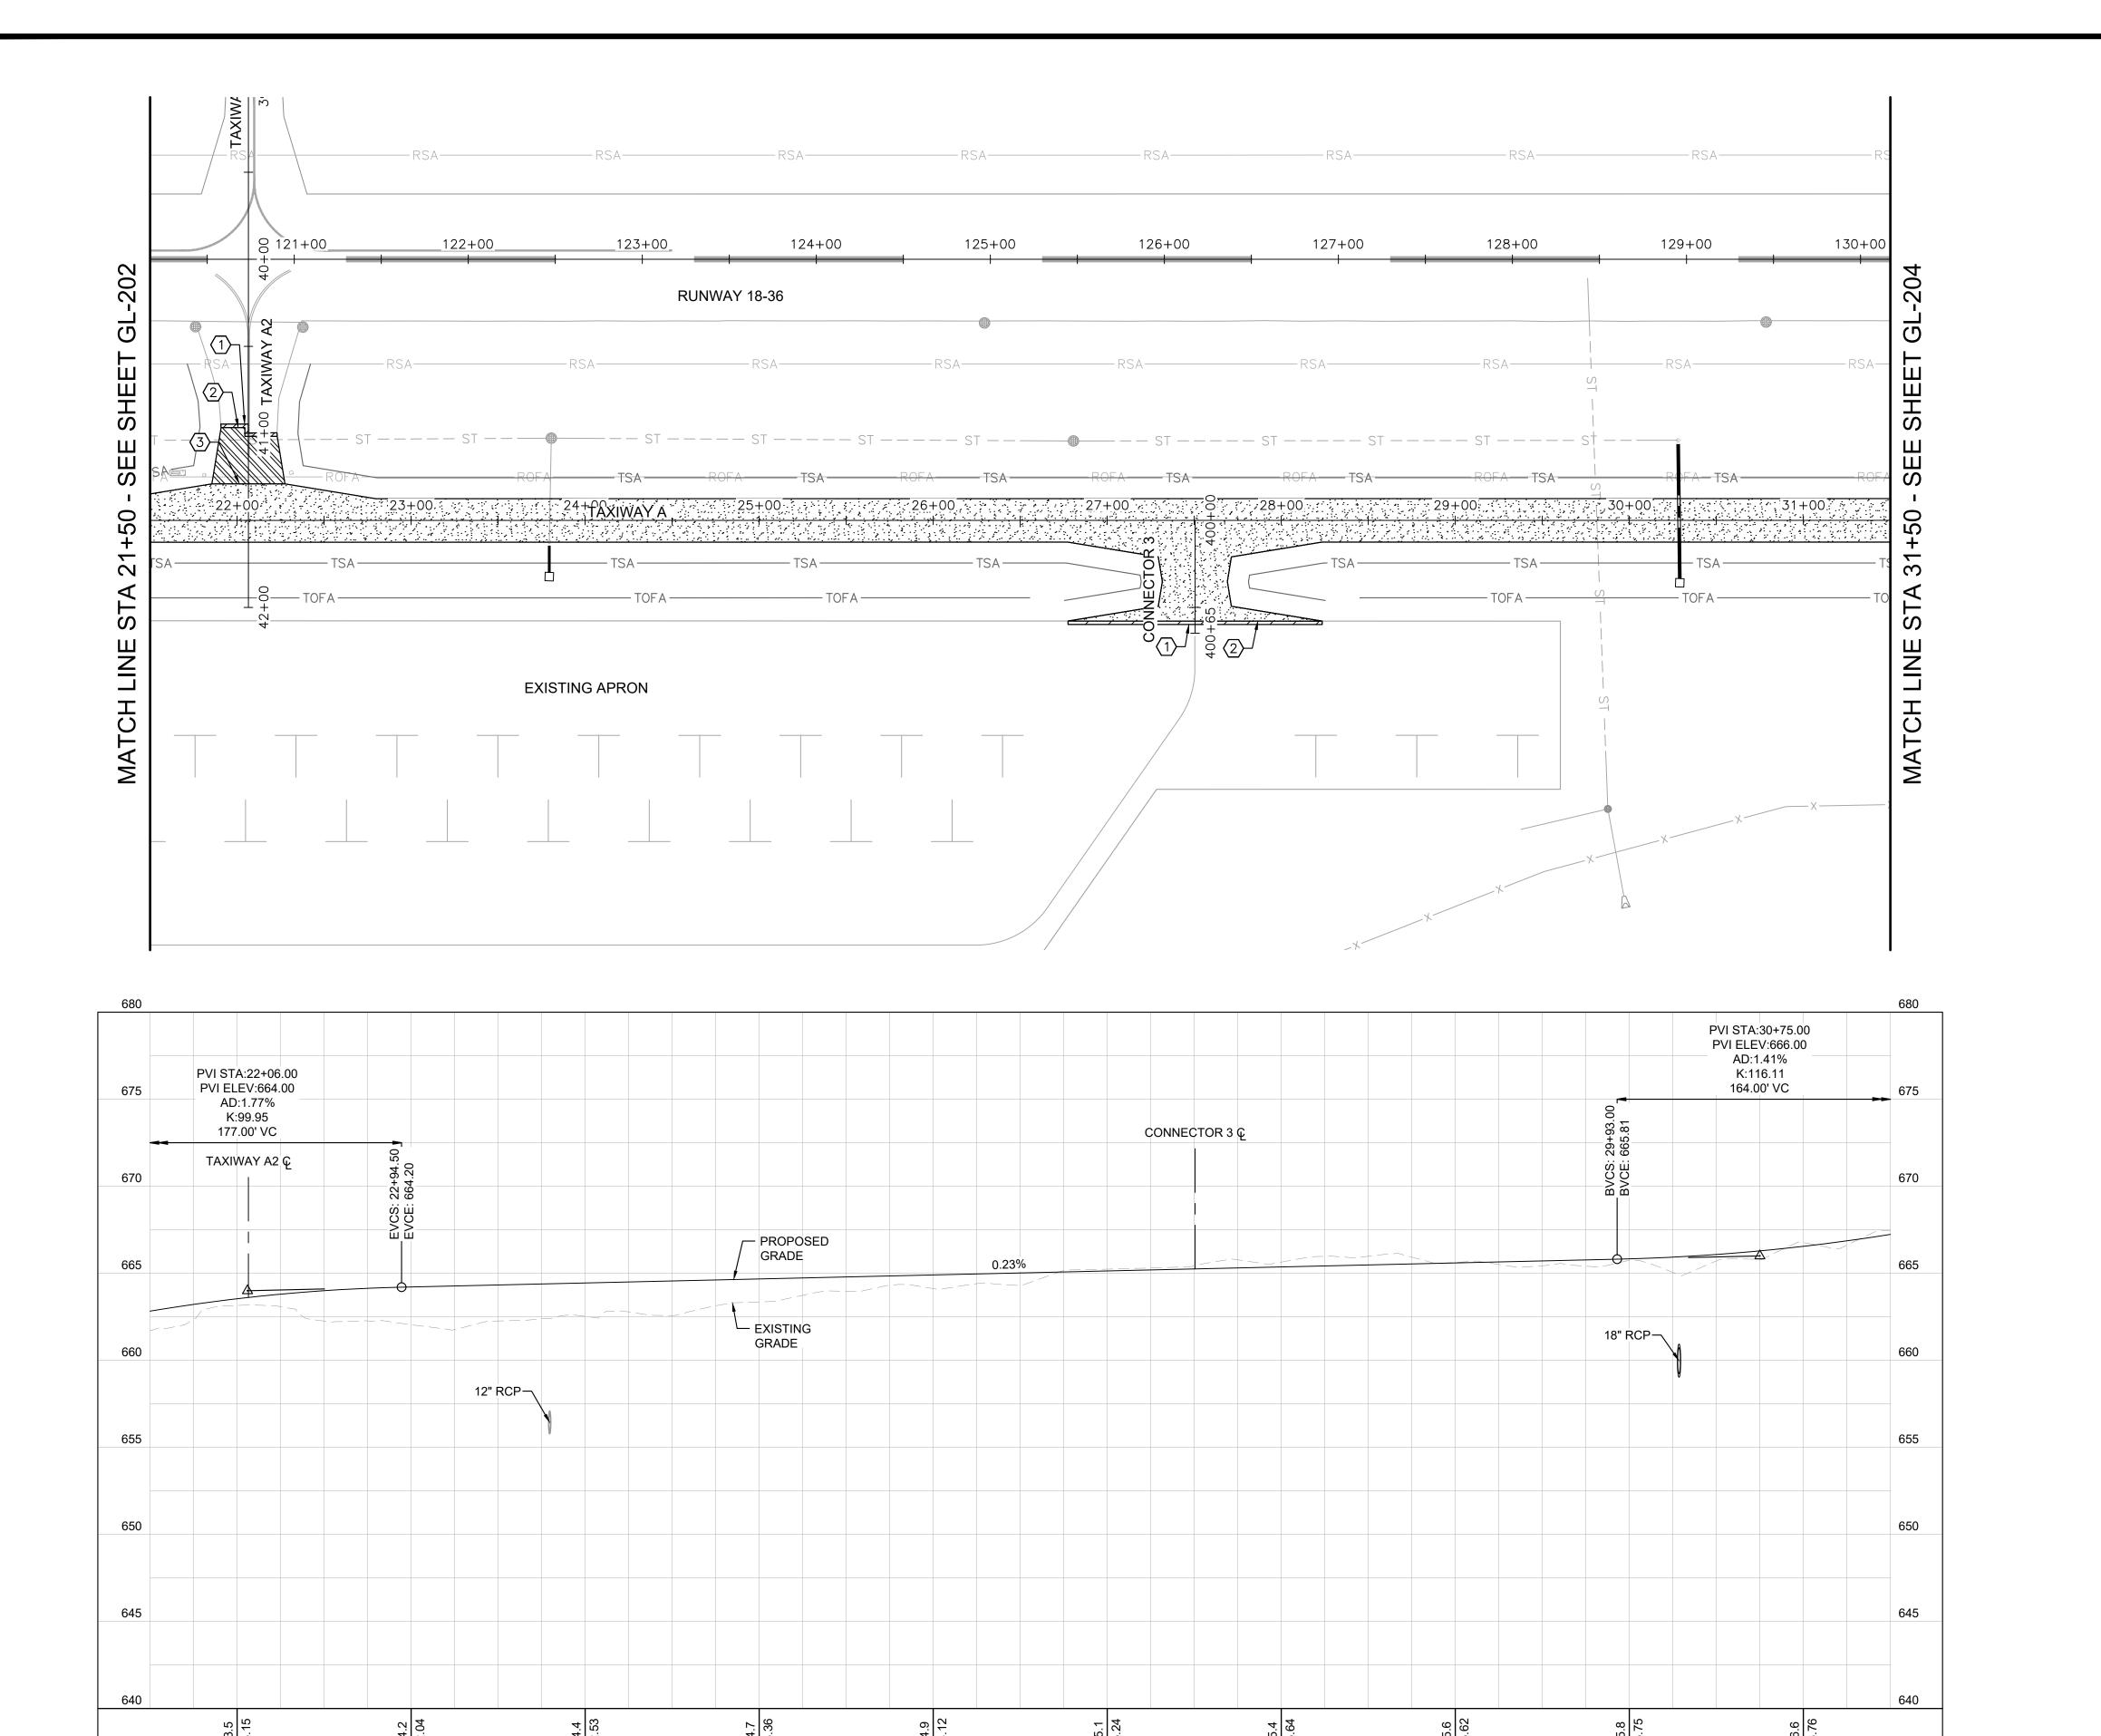
CONSTRUCT REPLACEMENT PAF
REPLACE AIRPORT ROTATING BI
VILLAGE OF BOLINGBROOK
BOLINGBROOK, WILL COUNTY, II CERTIFICATION: JUNAID YAHYA う 062-070626 テ 11/22/2024 DRÁWING NO. GL-202

168001005

PROJECT NUMBER:

ILLINOIS

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### LEGEND



4 INCH BITUMINOUS PAVEMENT



EXISTING TO PROPOSED ASPHALT PAVEMENT



ASPHALT PAVEMENT TRANSITION WEDGE, REFER TO DETAIL 1/CT-202





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### CONSTRUCTION NOTES

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- EXISTING TO PROPOSED ASPHALT PAVEMENT TRANSITION
- (3) ASPHALT PAVEMENT TRANSITION WEDGE

1	DATE: 1/22/2024	SCALE: AS NOTED	
D	RAWN BY: LMB	CHECKED BY: JY	
REV. DATE			DESCRIPTION

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GRAPHIC SCALE IN FEET O 25 50 10

HORIZONTAL

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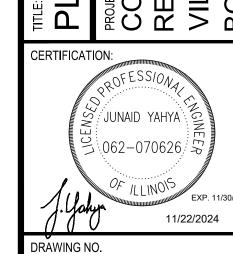
30+00

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GL-203

PROJECT NUMBER: 168001005

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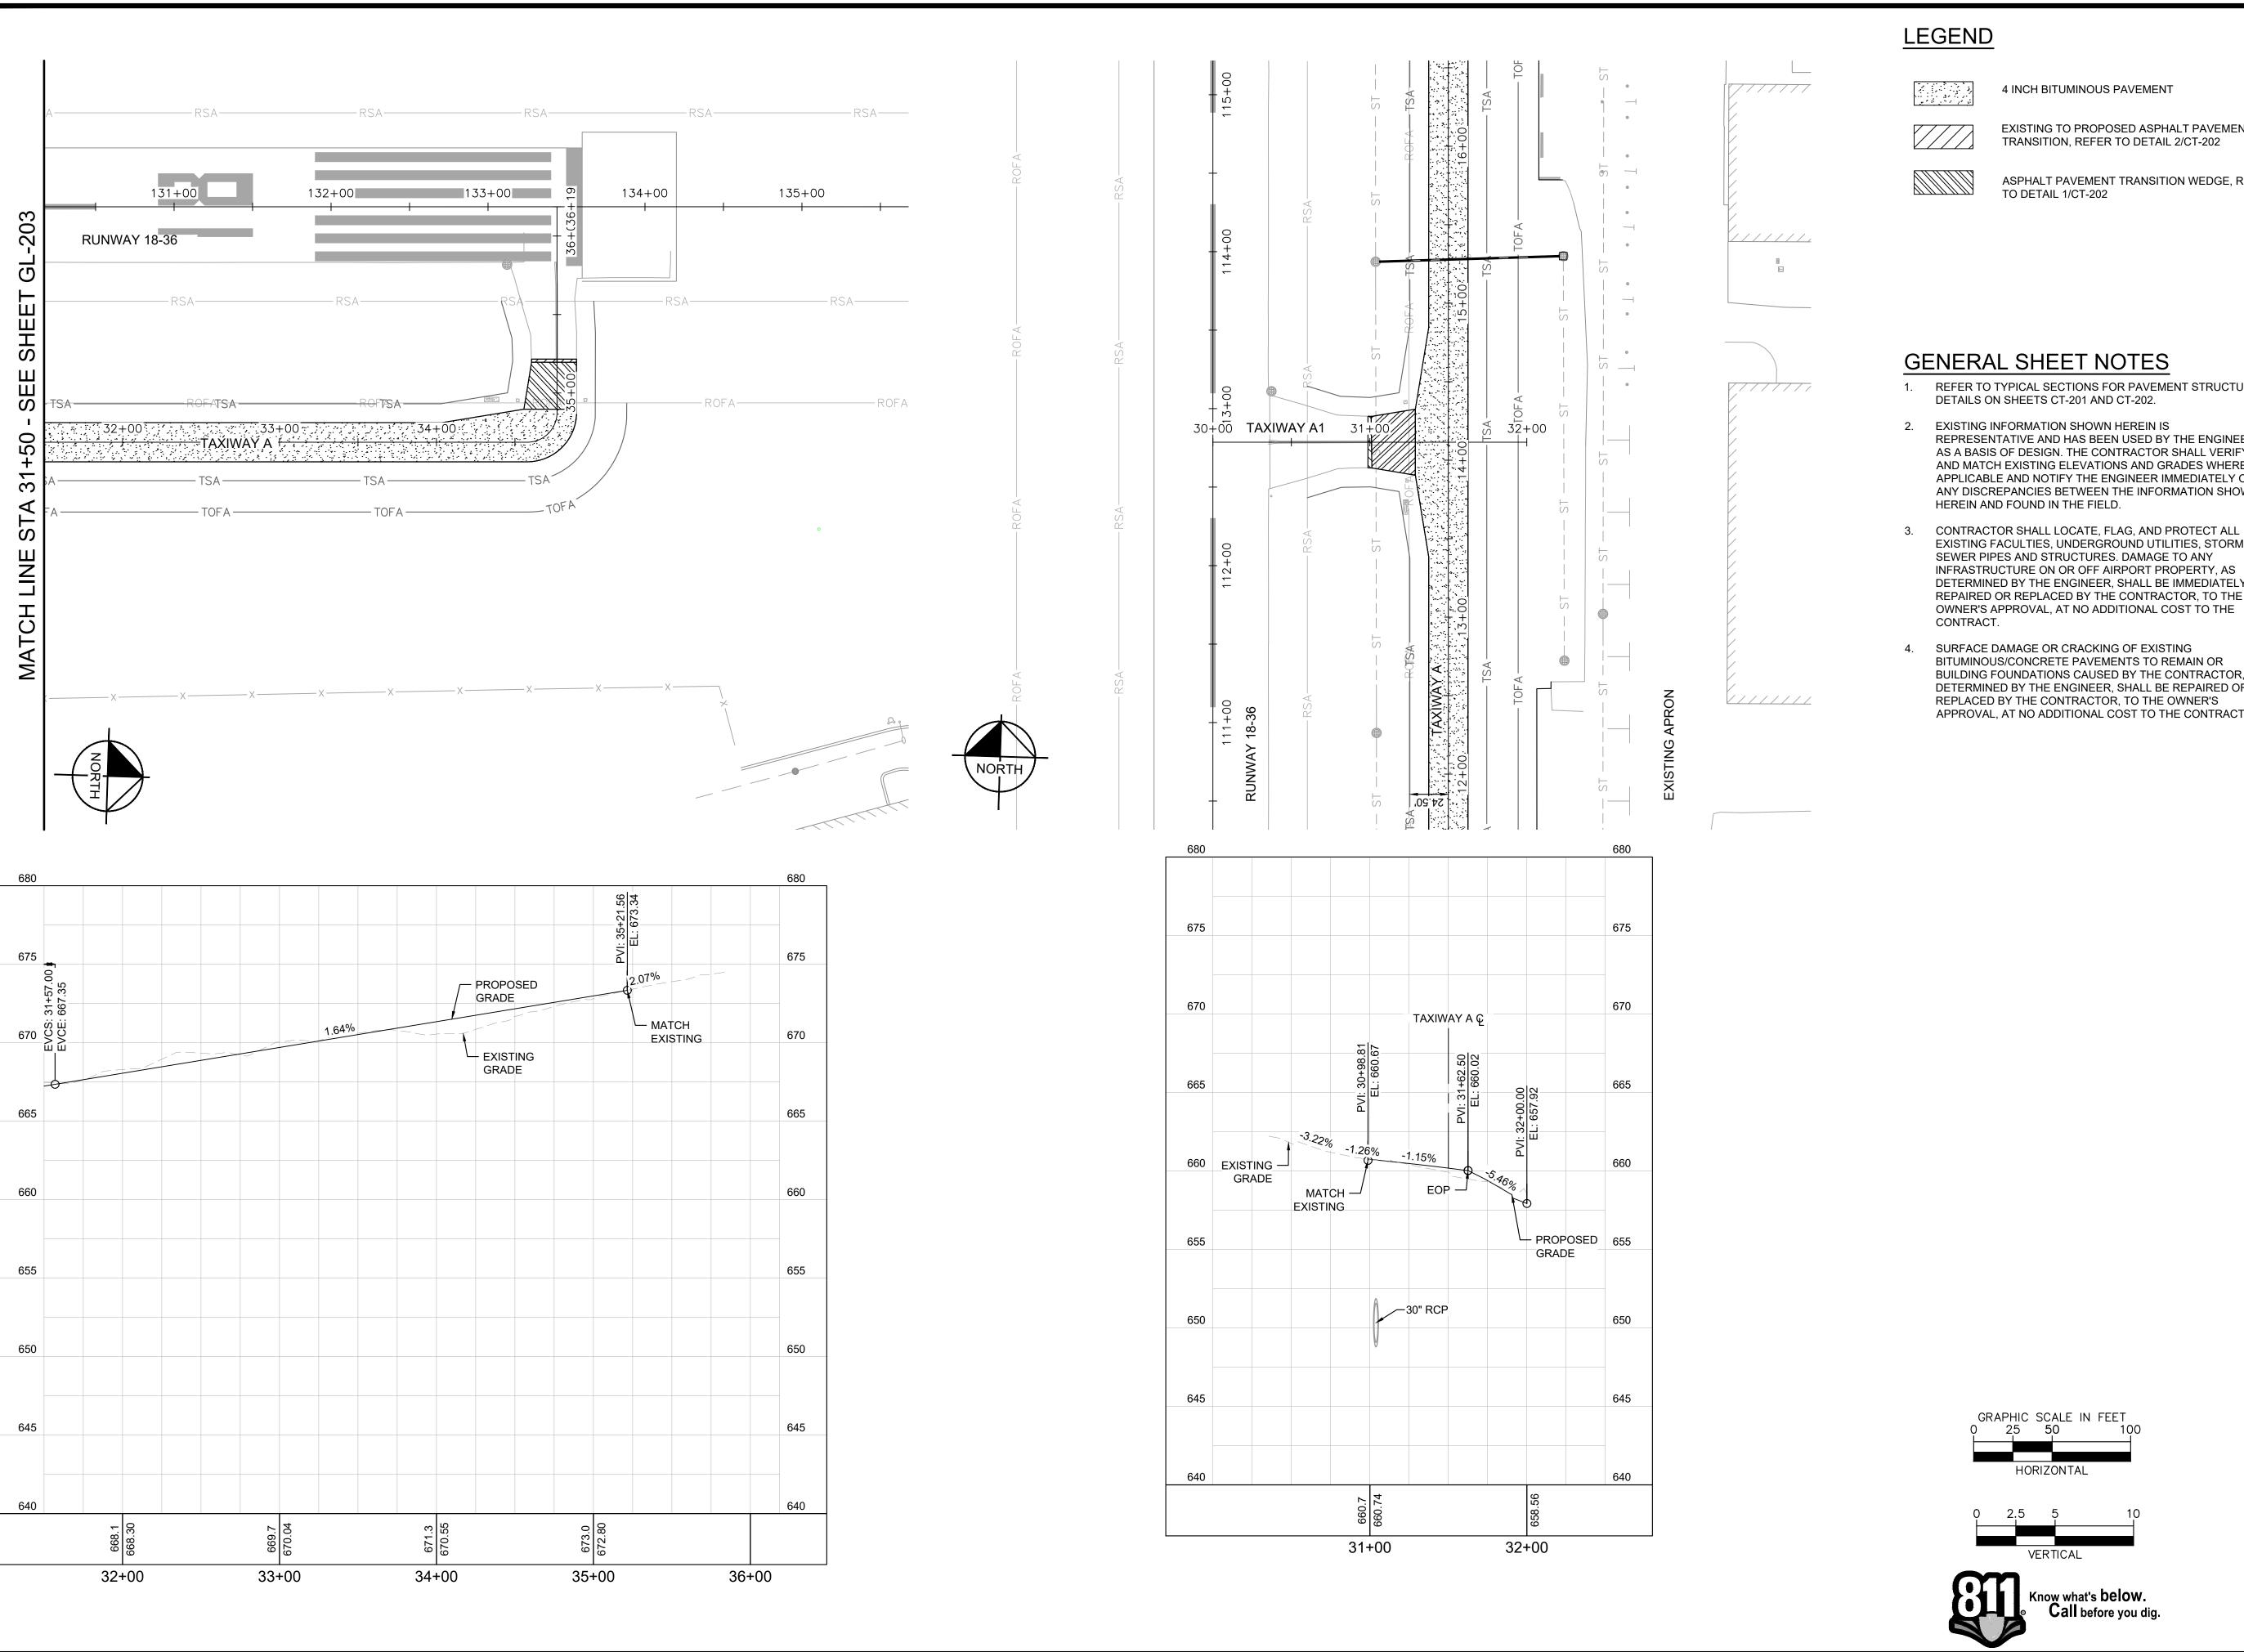
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4 INCH BITUMINOUS PAVEMENT

EXISTING TO PROPOSED ASPHALT PAVEMENT TRANSITION, REFER TO DETAIL 2/CT-202

ASPHALT PAVEMENT TRANSITION WEDGE, REFER TO DETAIL 1/CT-202



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### GENERAL SHEET NOTES

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HORIZONTAL

VERTICAL

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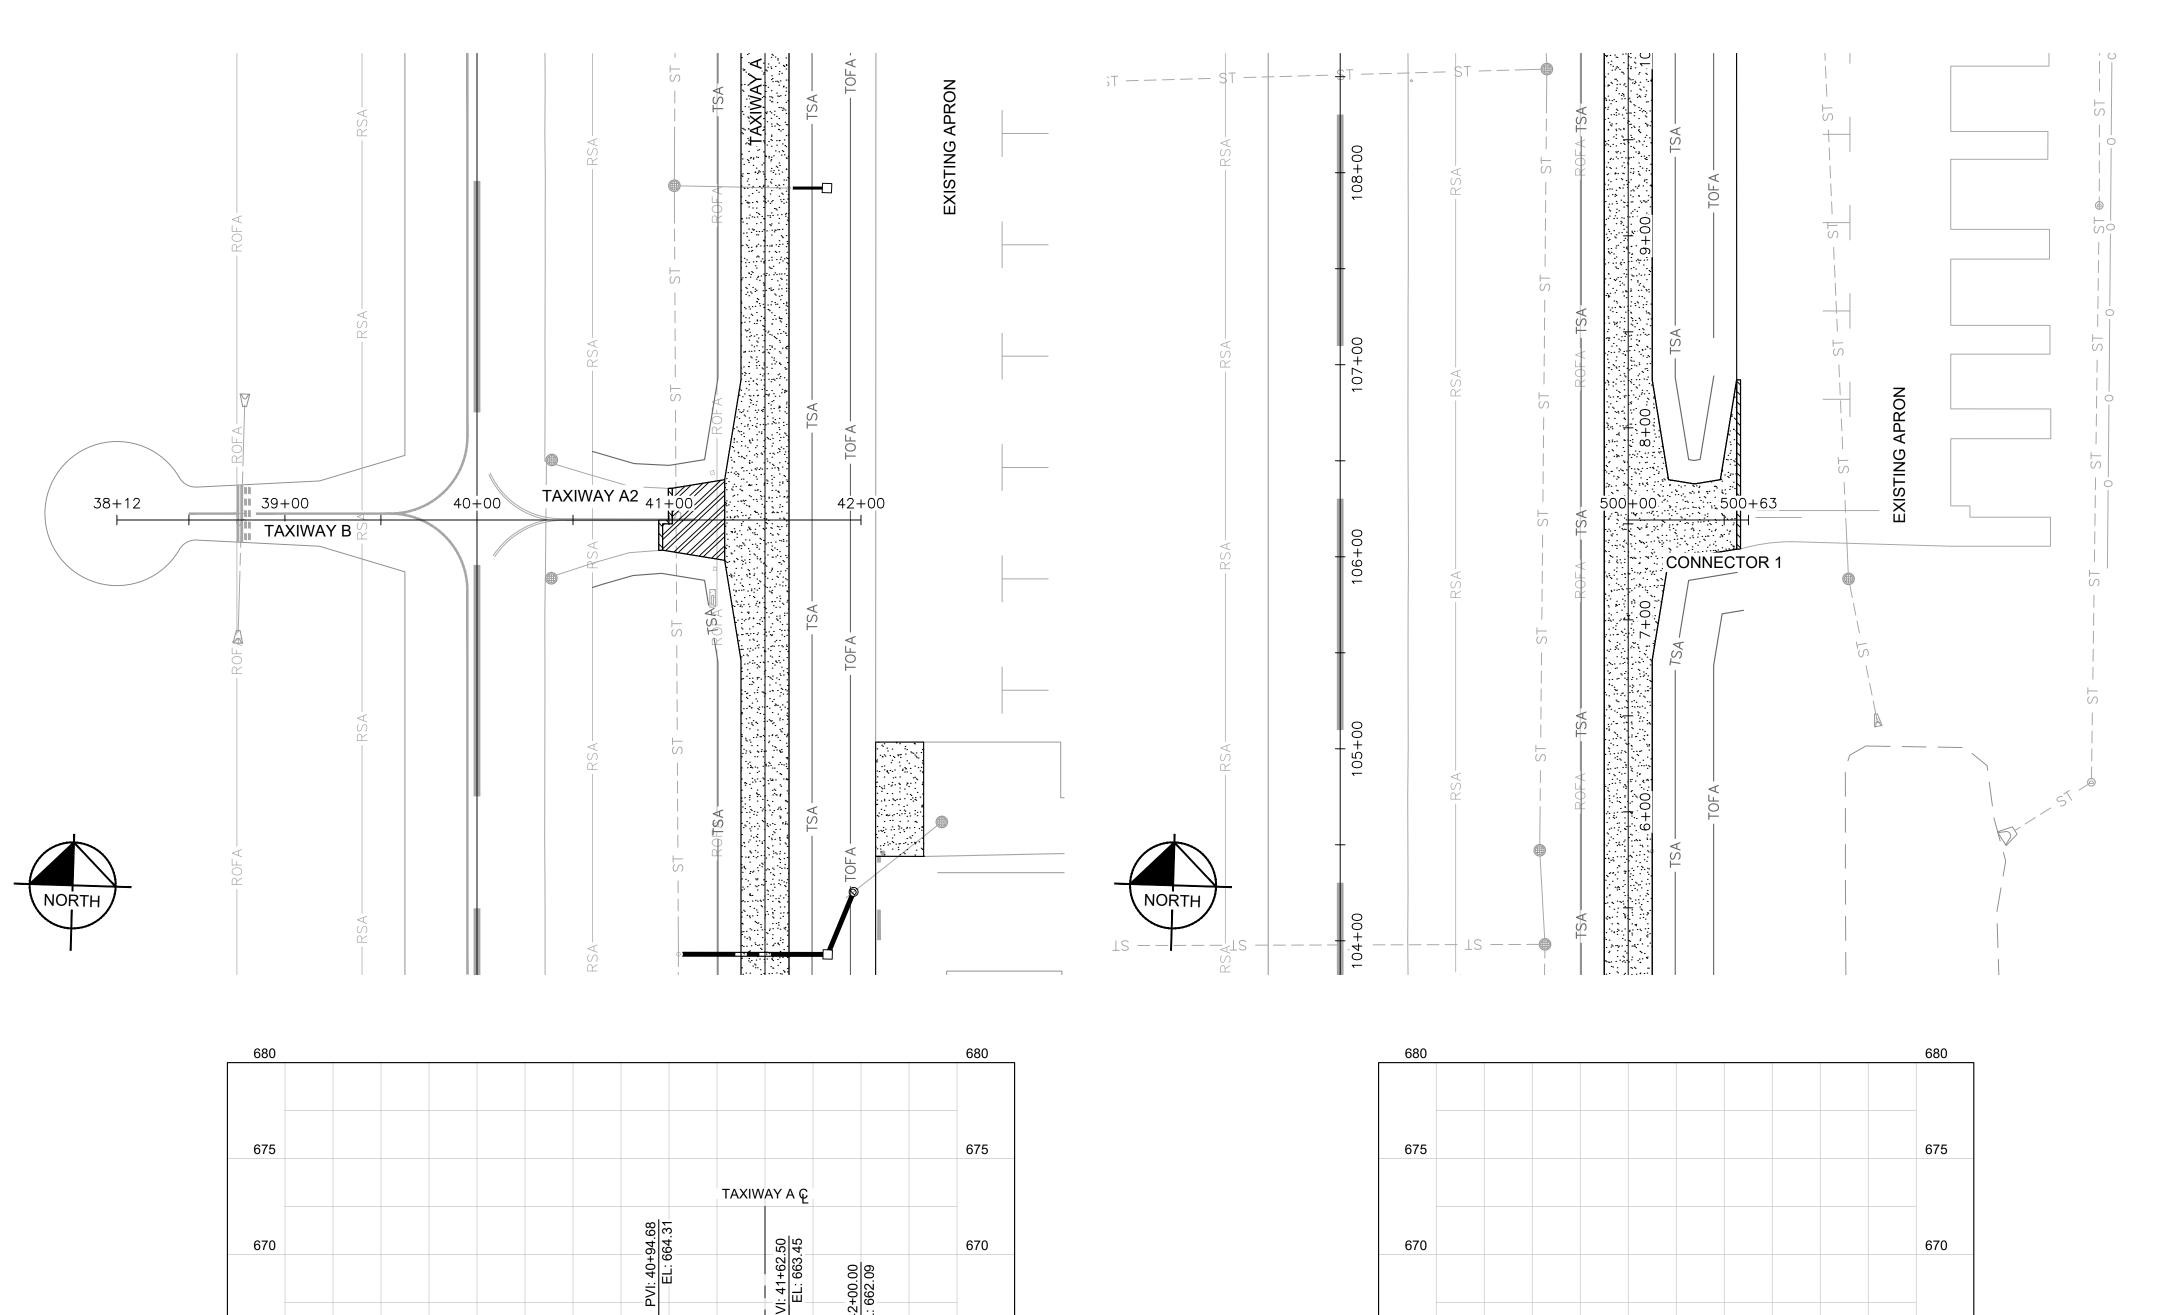
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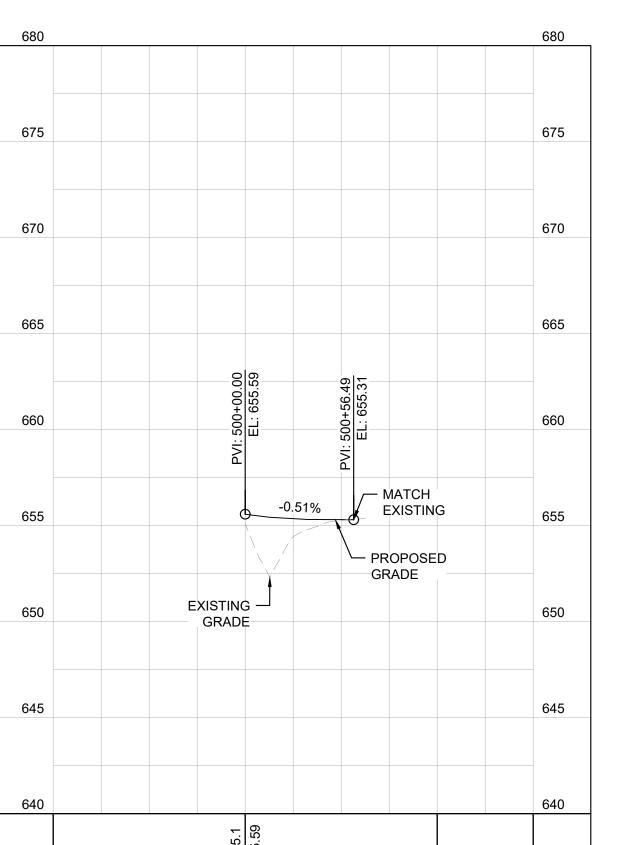
CERTIFICATION: JUNAID YAHYA ら 062-070626 ら 11/22/2024 DRAWING NO.

**GL-204** 

PROJECT NUMBER: 168001005

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500+00

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### LEGEND



4 INCH BITUMINOUS PAVEMENT



EXISTING TO PROPOSED ASPHALT PAVEMENT TRANSITION, REFER TO DETAIL 2/CT-202



ASPHALT PAVEMENT TRANSITION WEDGE, REFER TO DETAIL 1/CT-202



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CERTIFICATION: JUNAID YAHYA 5 062-070626 5 11/22/2024 DRÁWING NO.

GL-205

PROJECT NUMBER: 168001005

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Know what's below.
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42+00

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645

640

42+50

-1.83%

PROPOSED -

41+00

GRADE

EXISTING

EXISTING -GRADE

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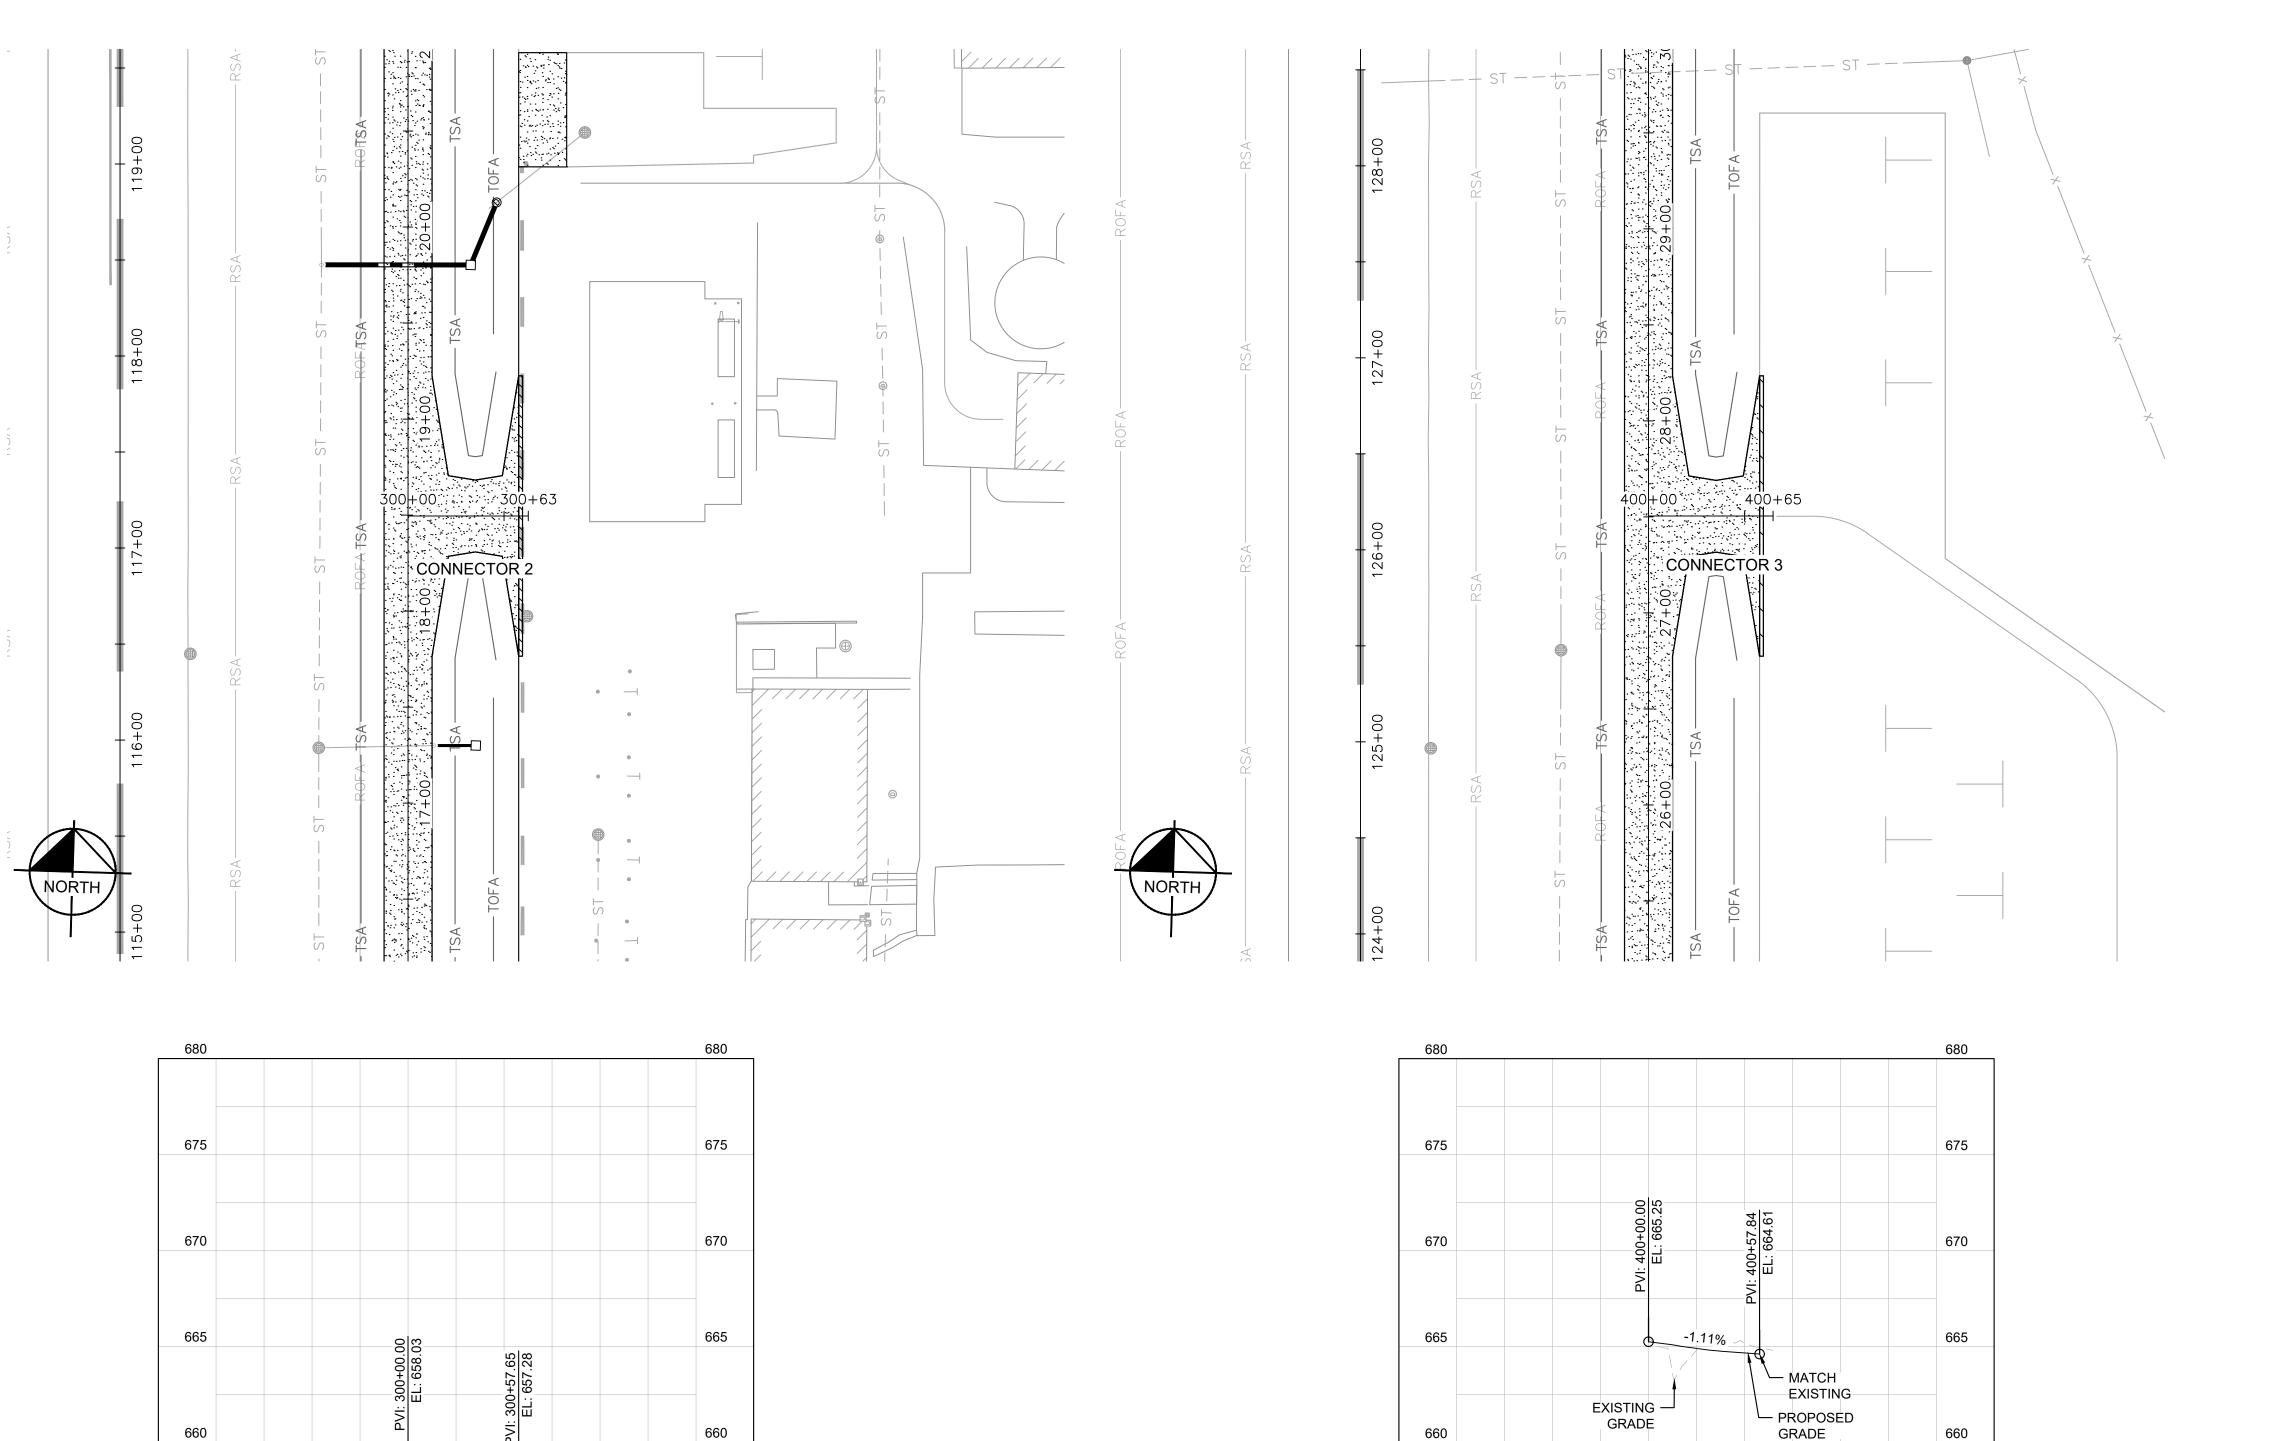
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### LEGEND



4 INCH BITUMINOUS PAVEMENT



EXISTING TO PROPOSED ASPHALT PAVEMENT TRANSITION, REFER TO DETAIL 2/CT-202




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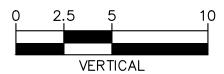


TO DETAIL 1/CT-202

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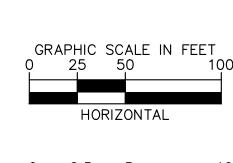
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DESCRIPTION

GL-206

PROJECT NUMBER: 168001005

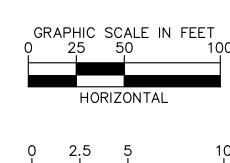

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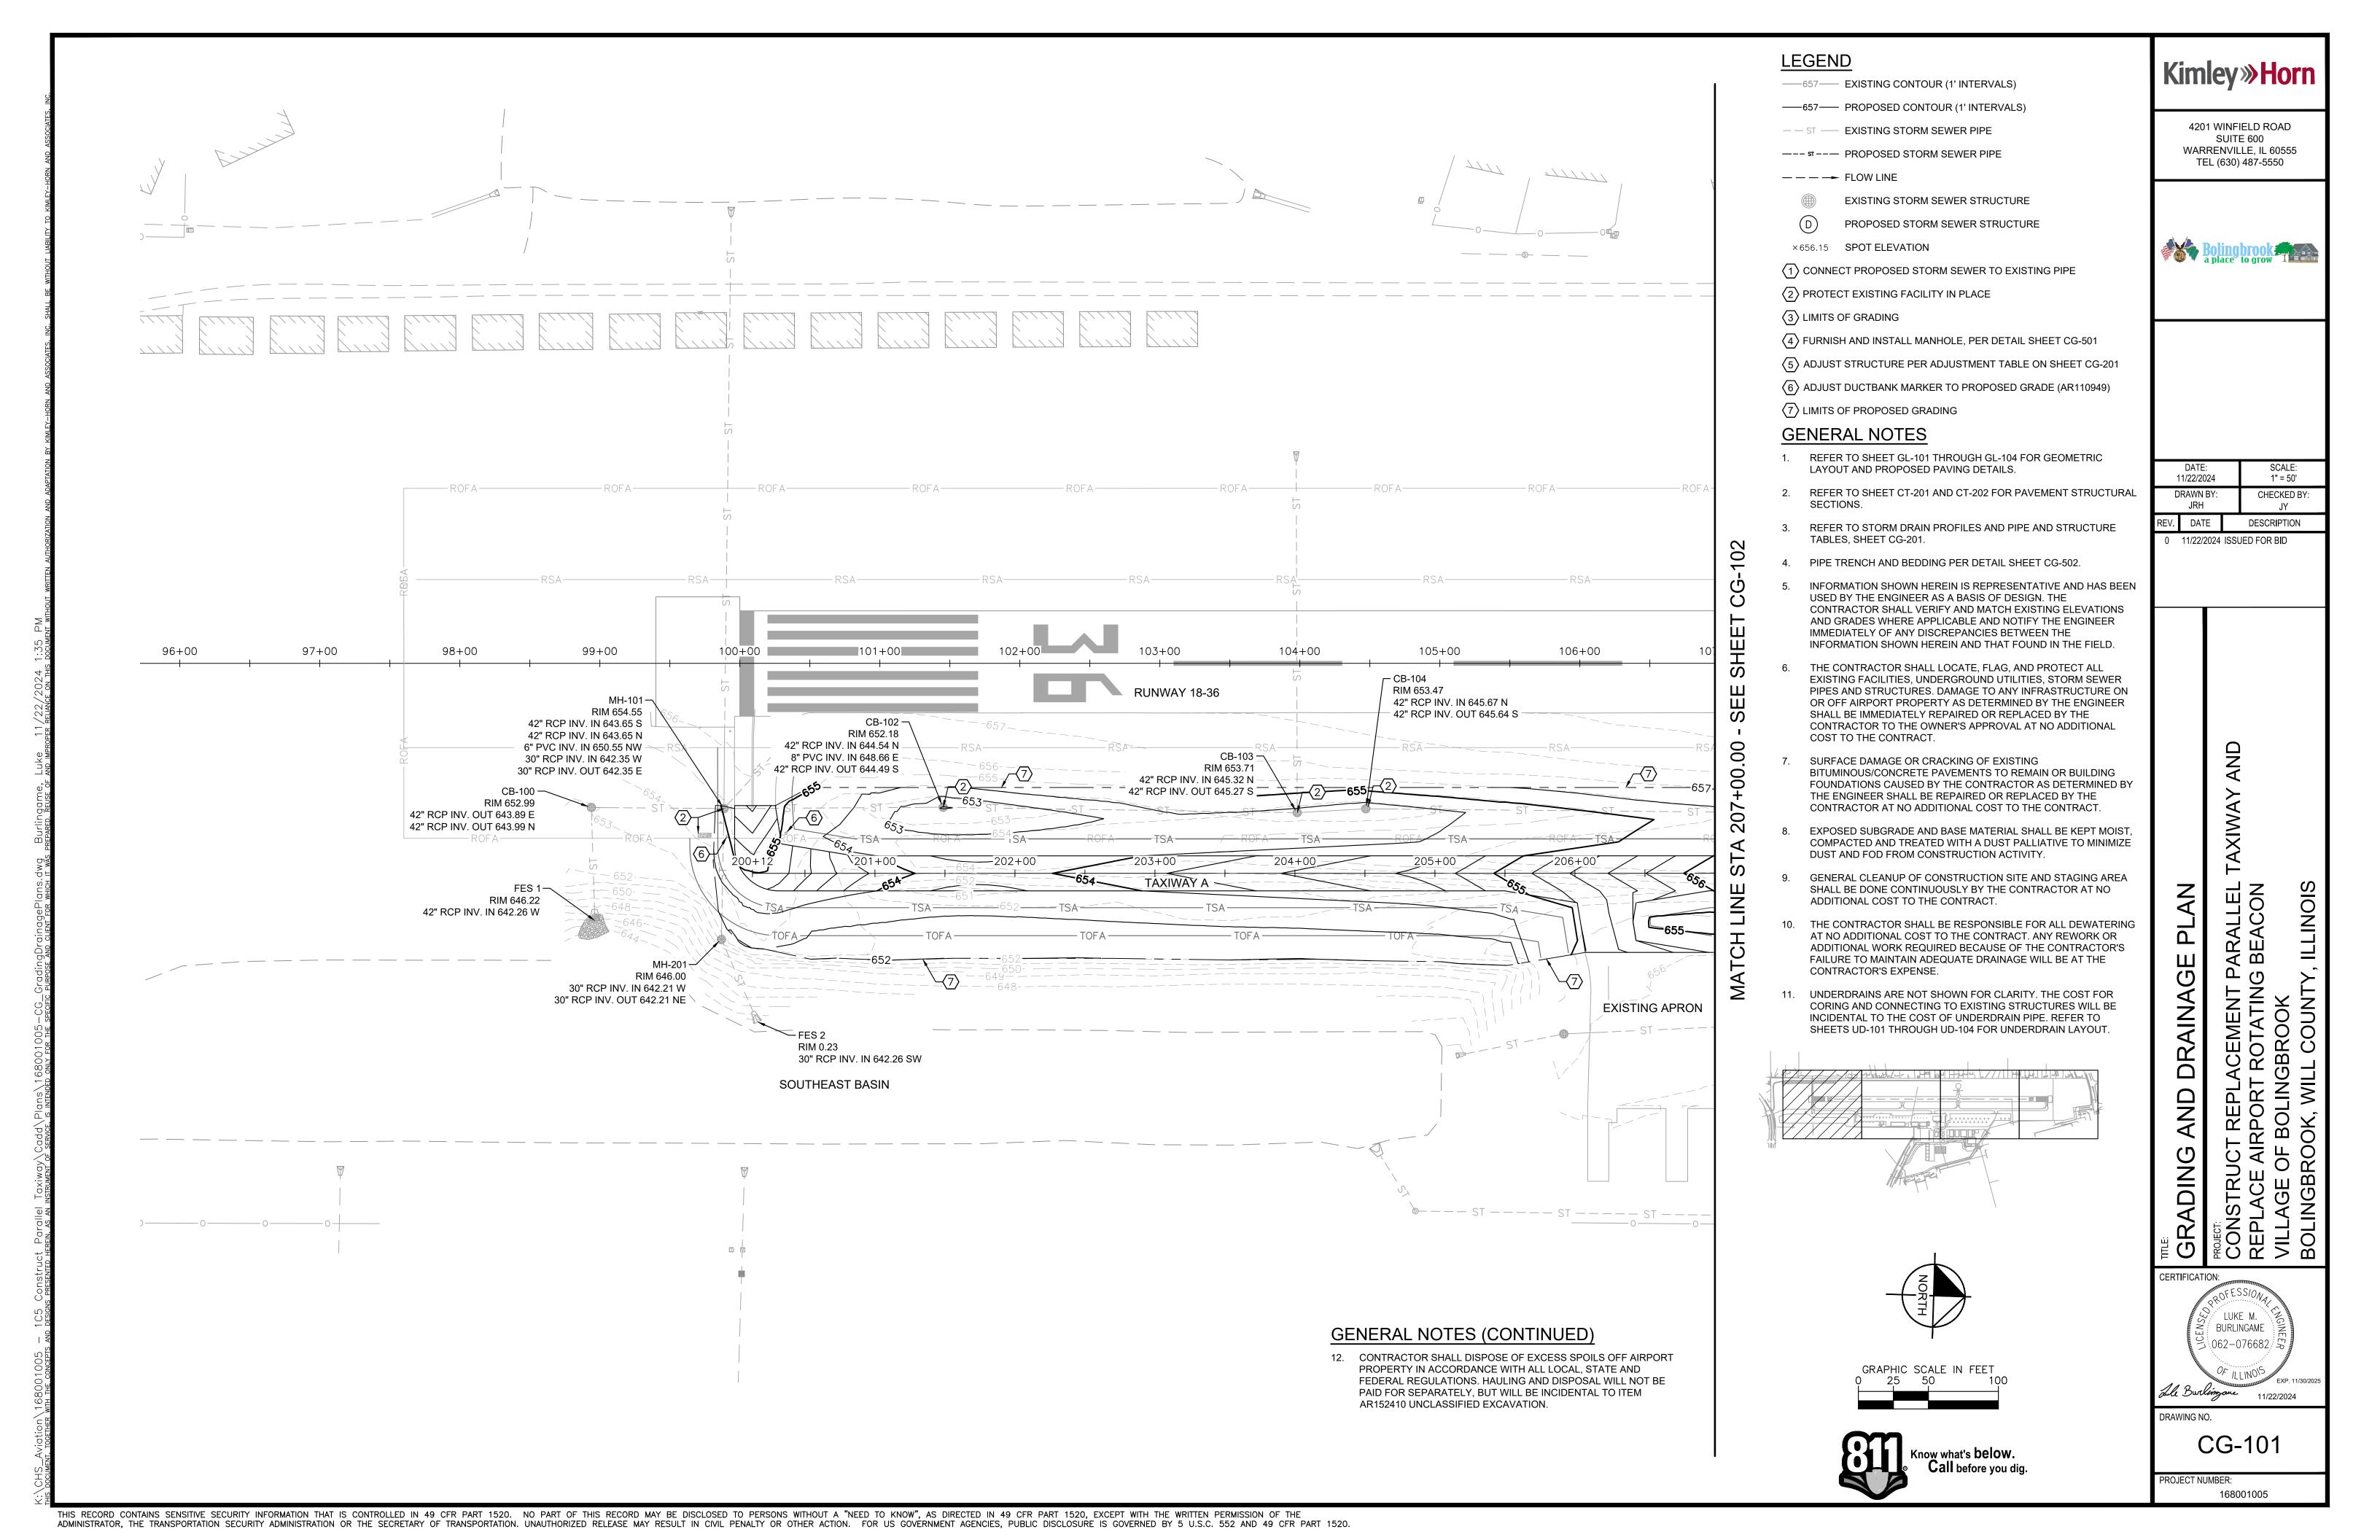
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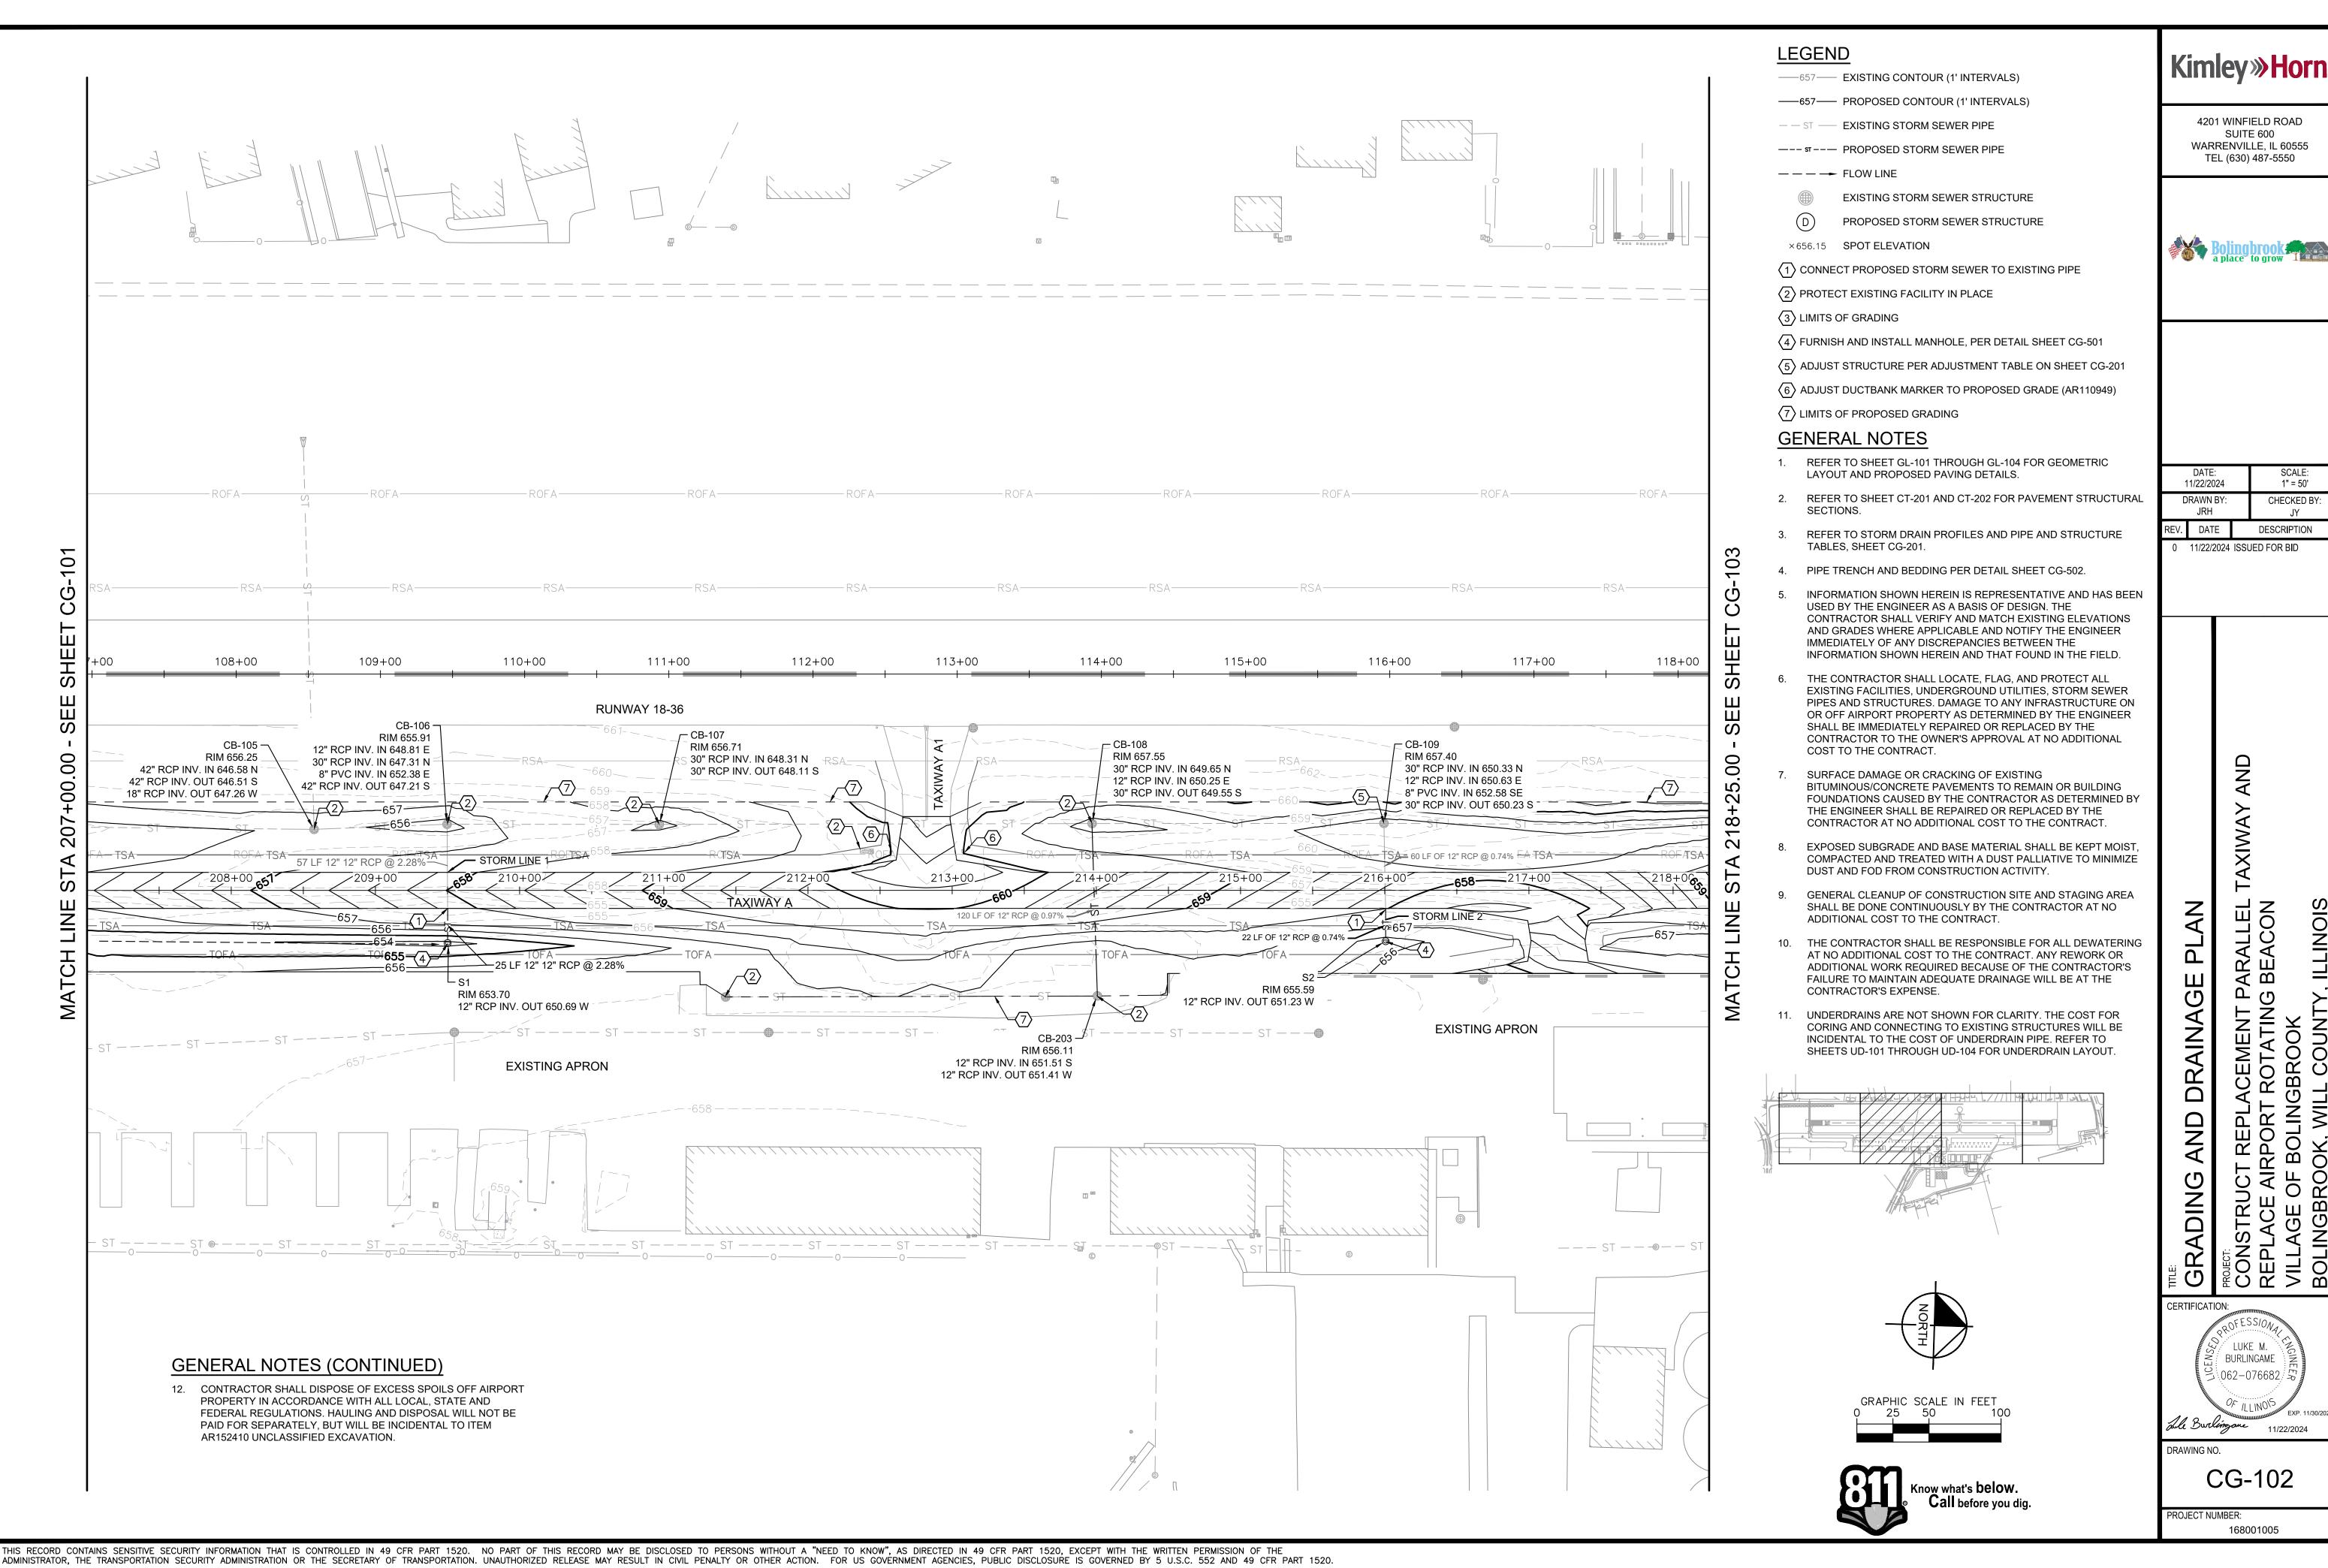
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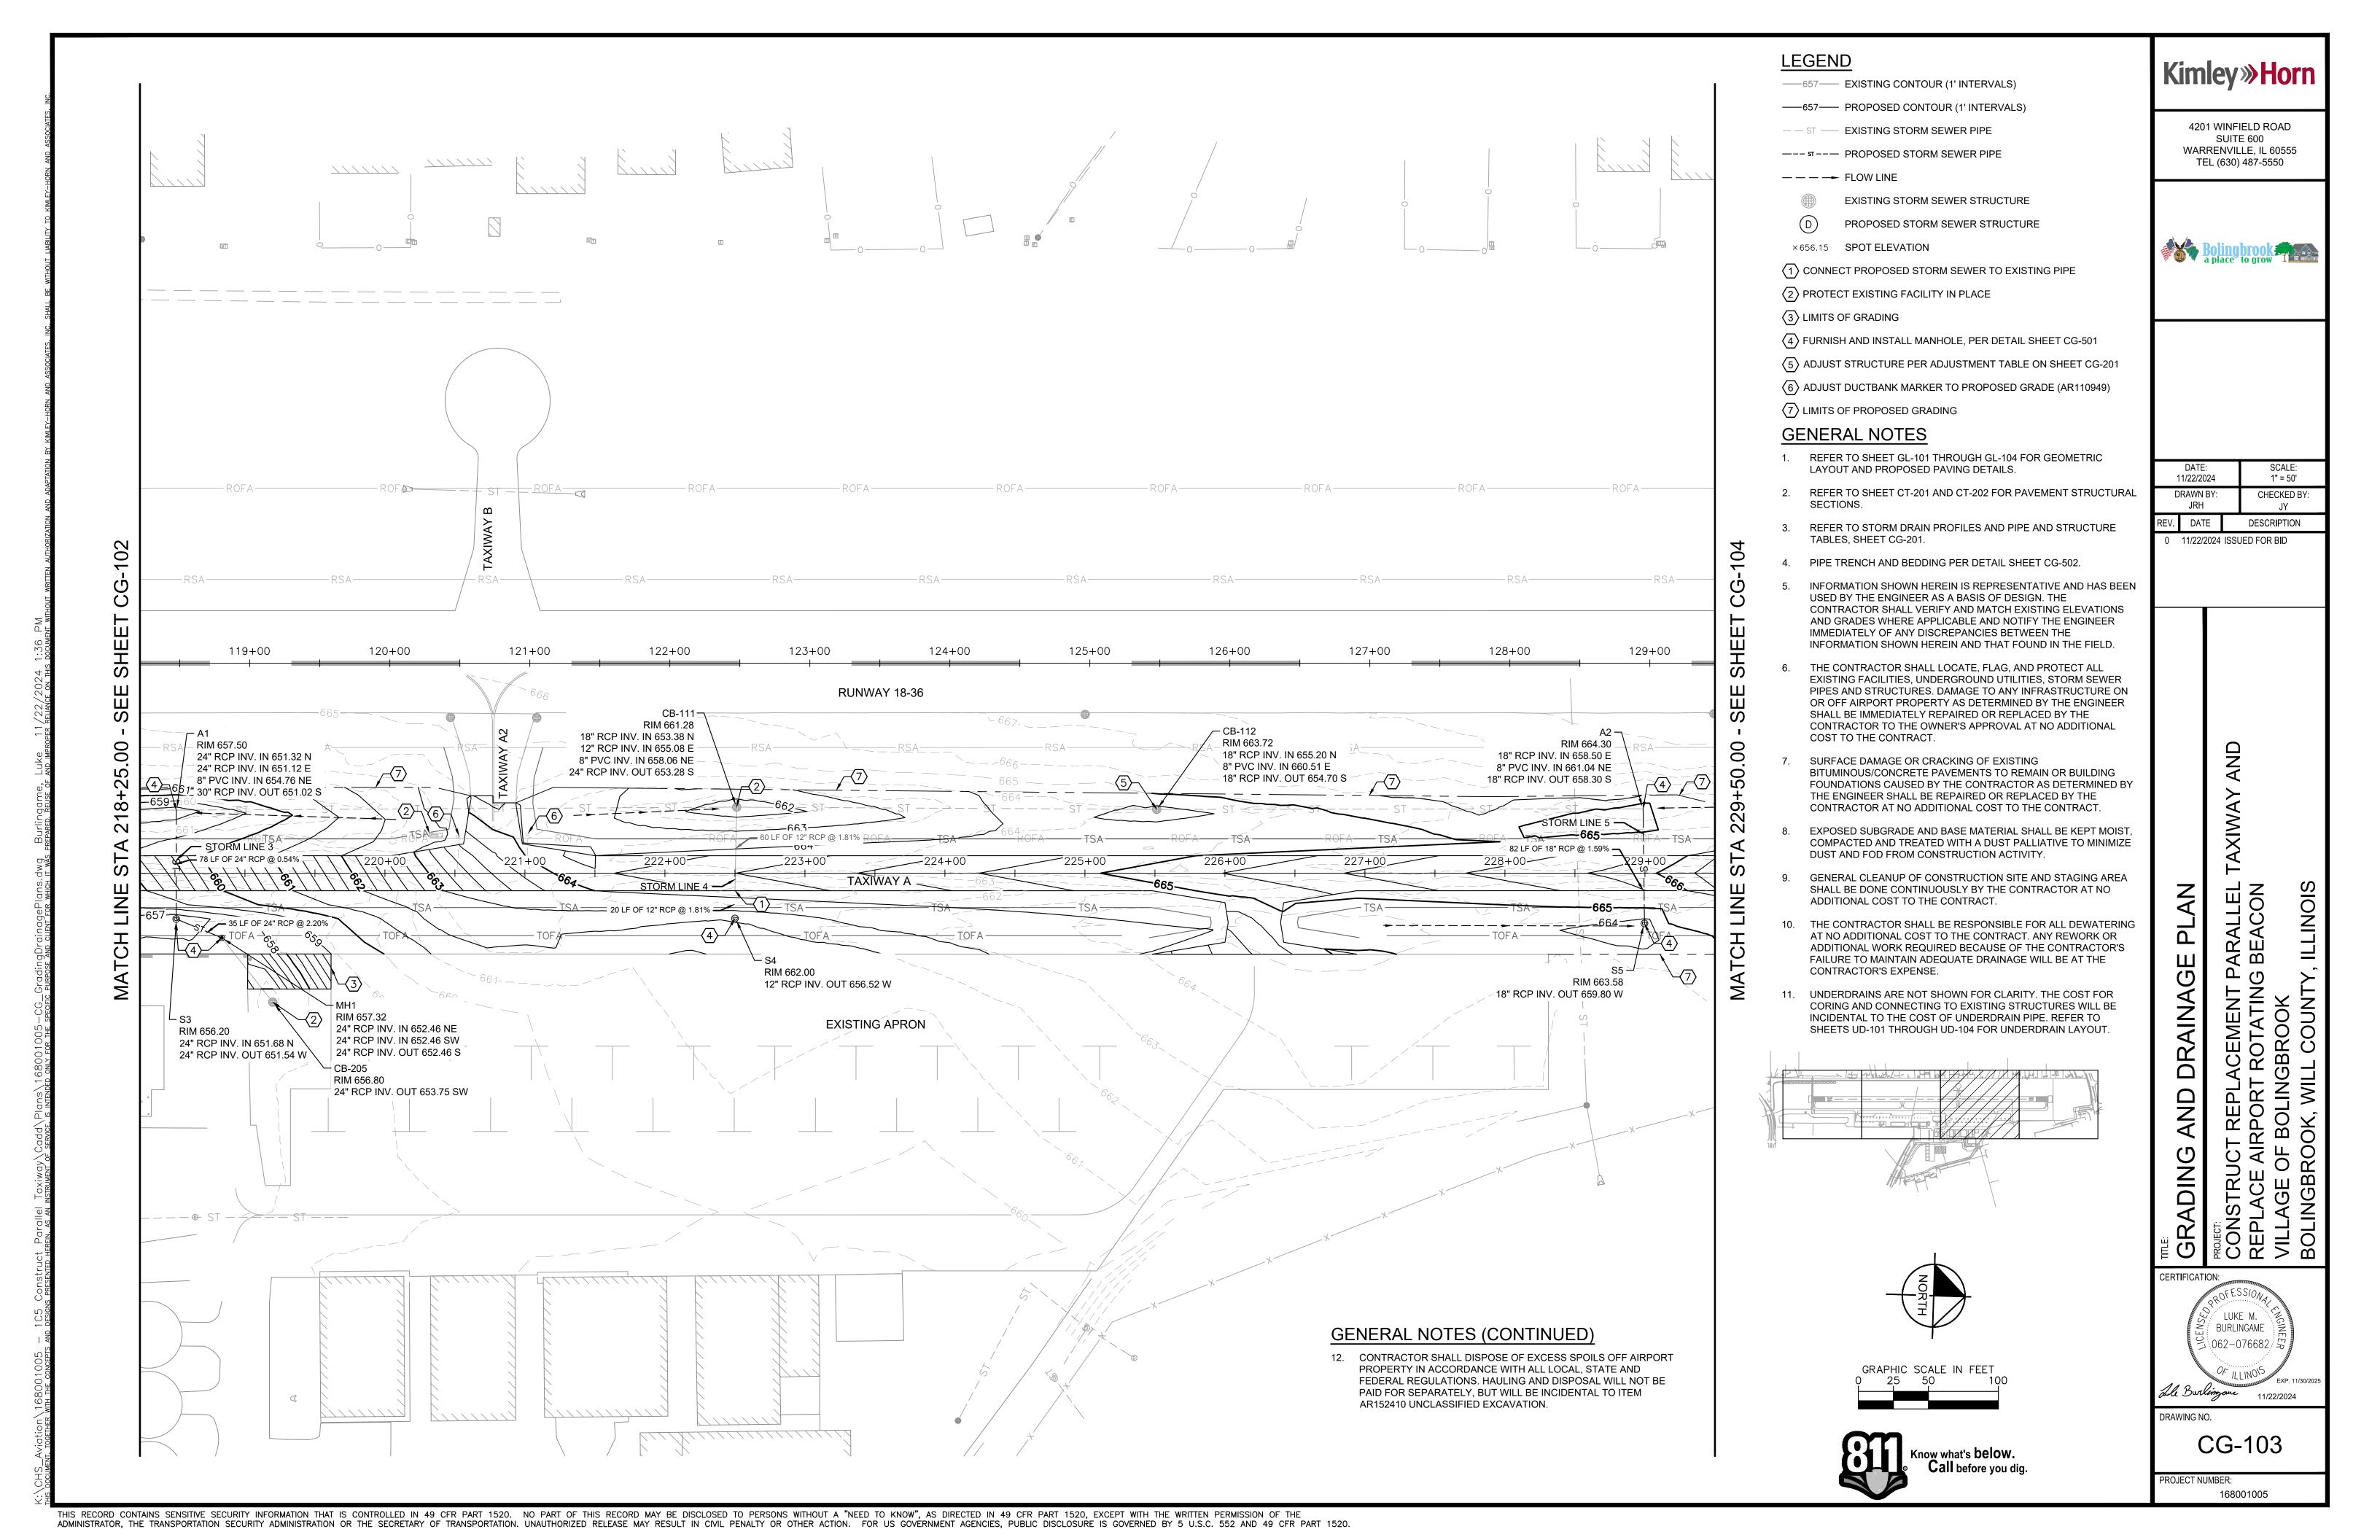
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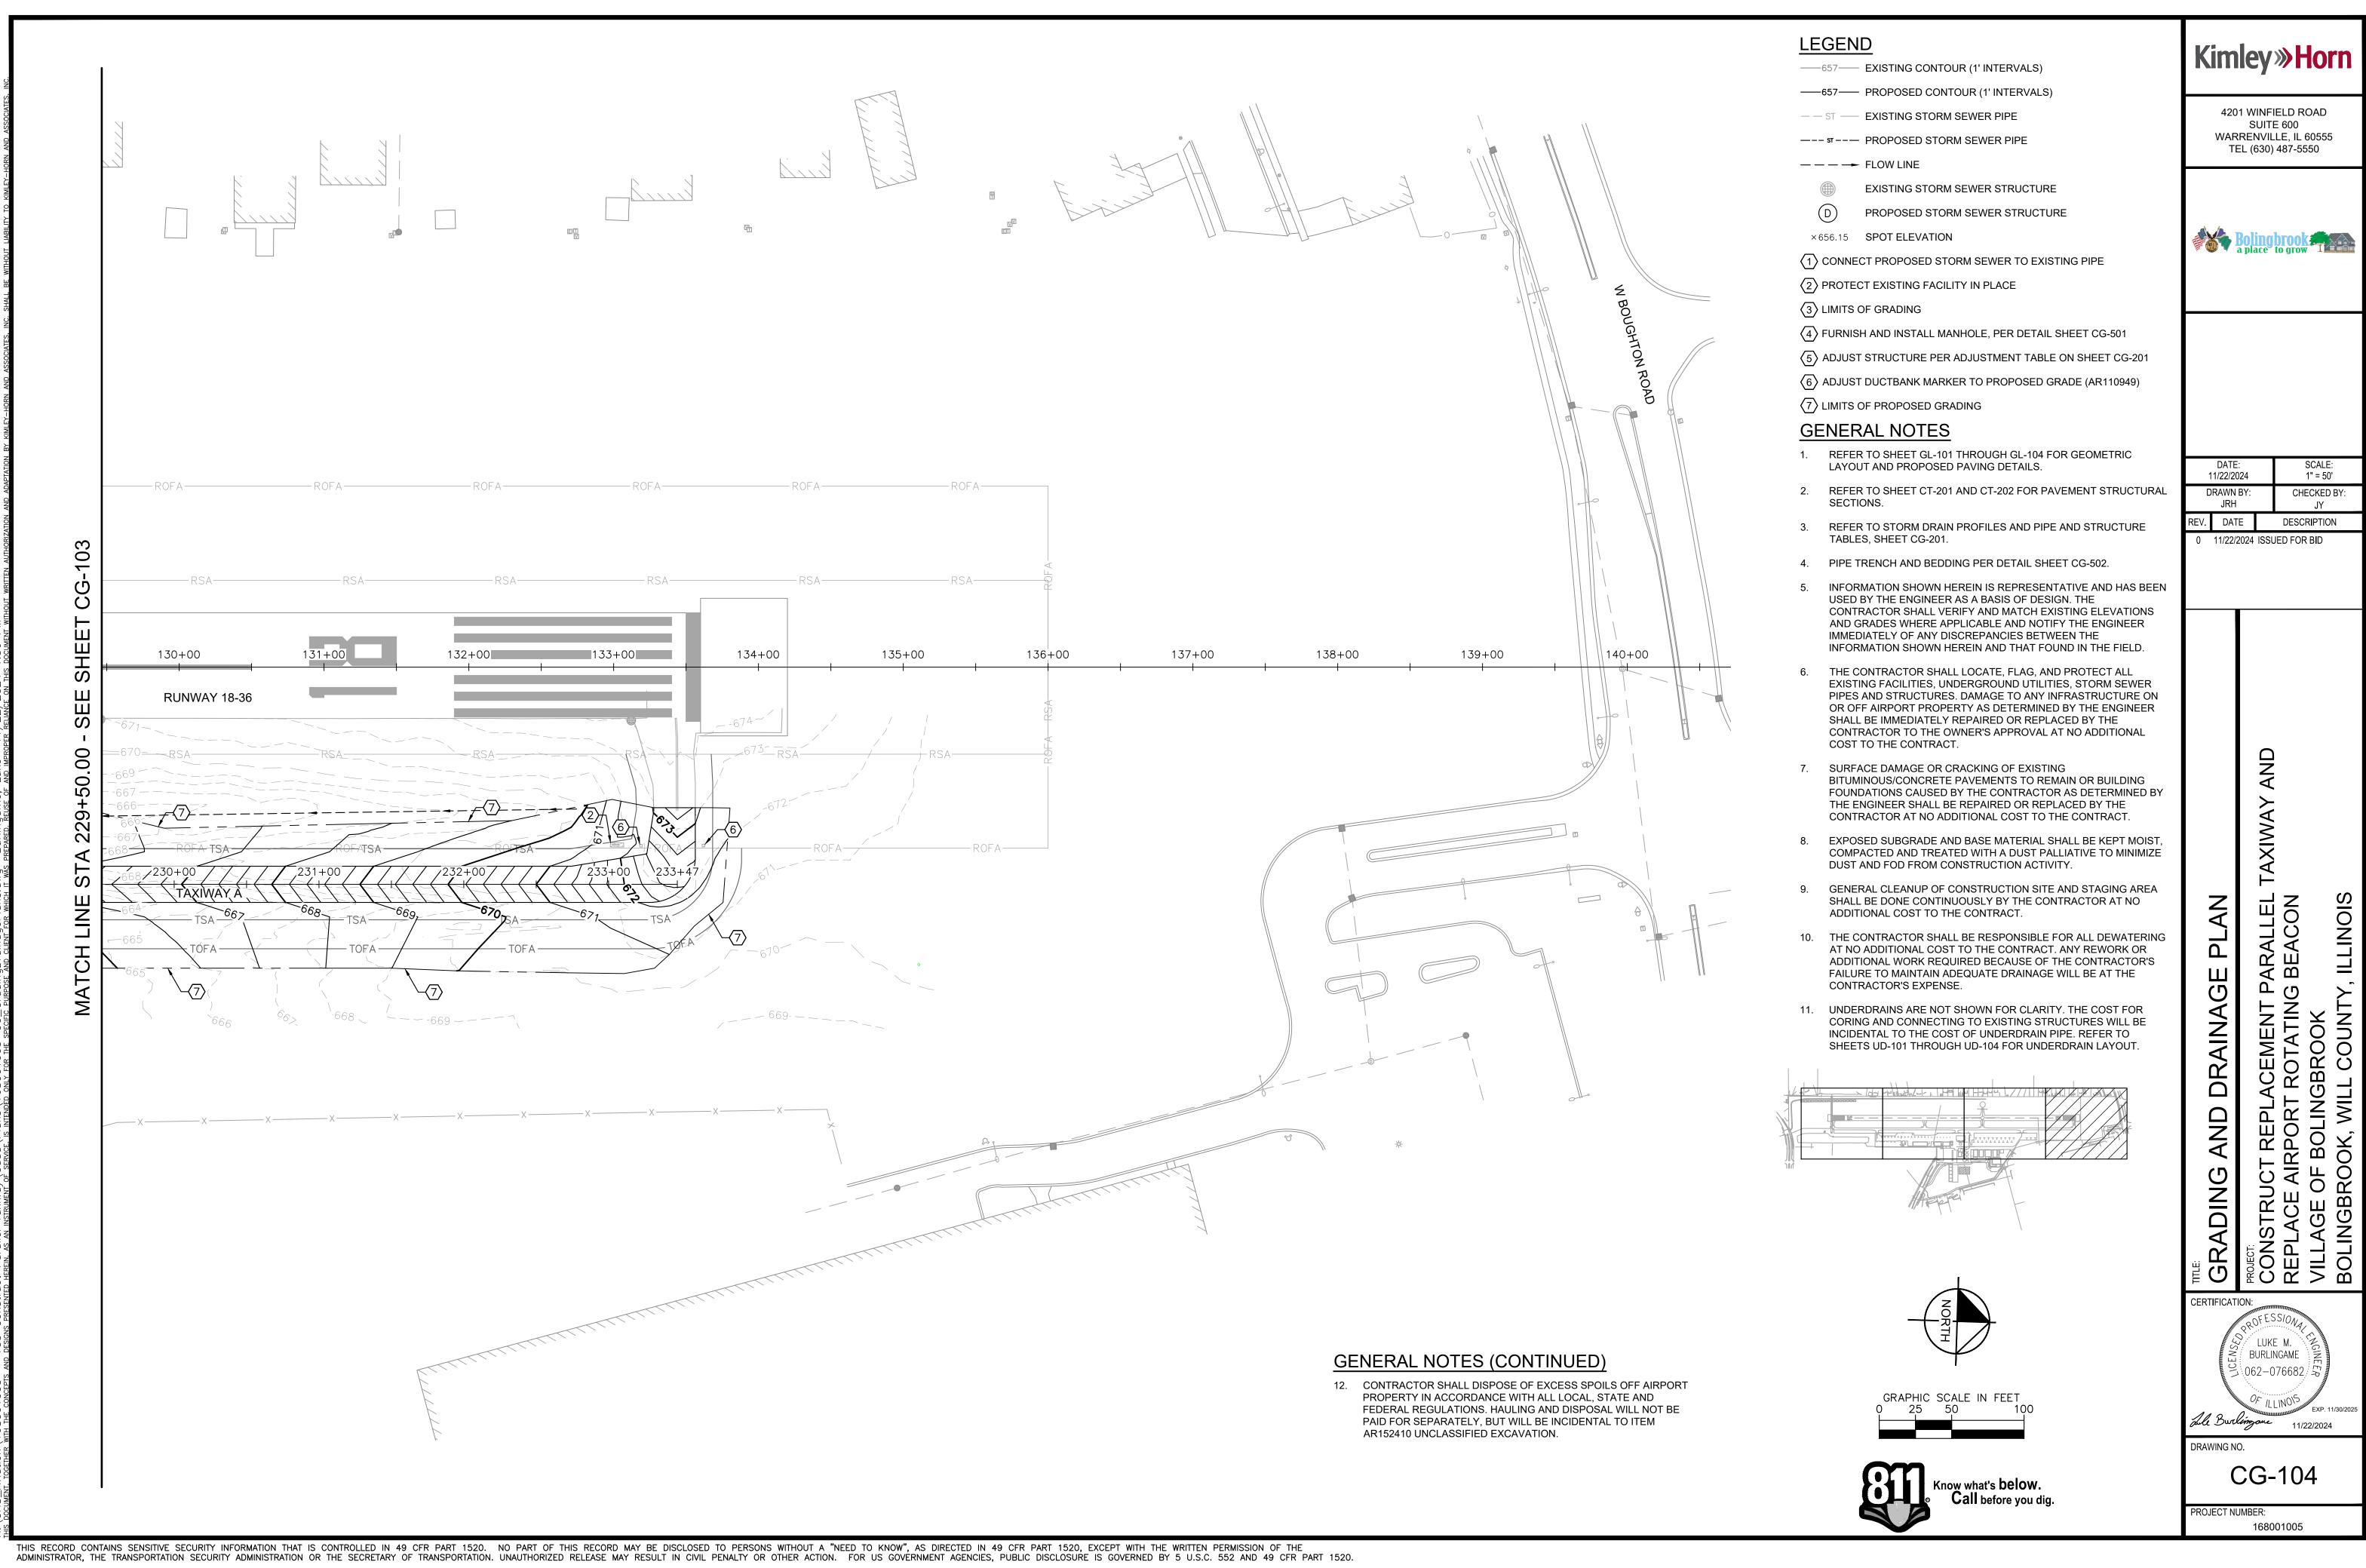
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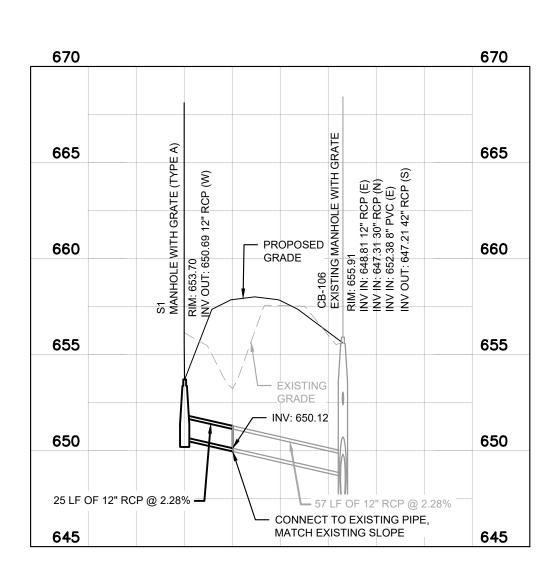















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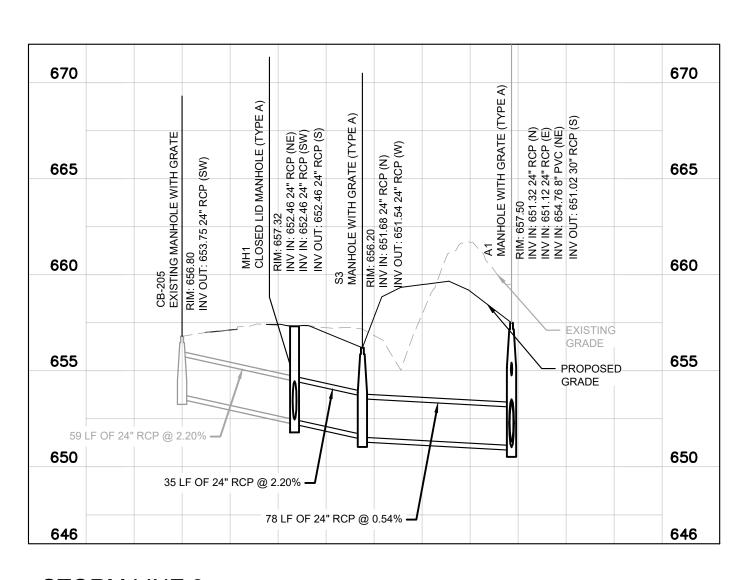
STORM LINE 2

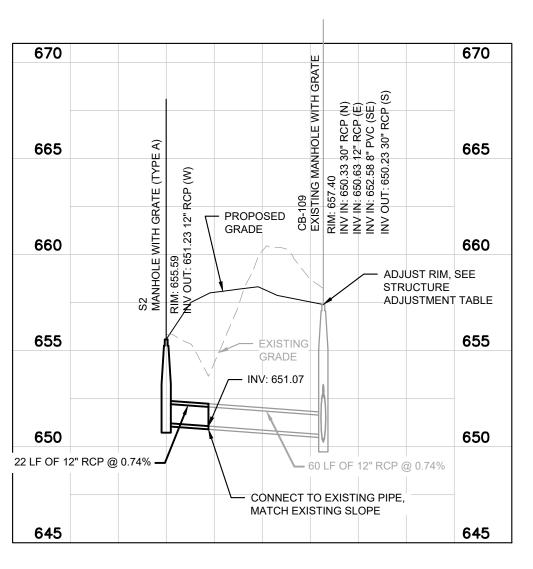


STORM LINE 4

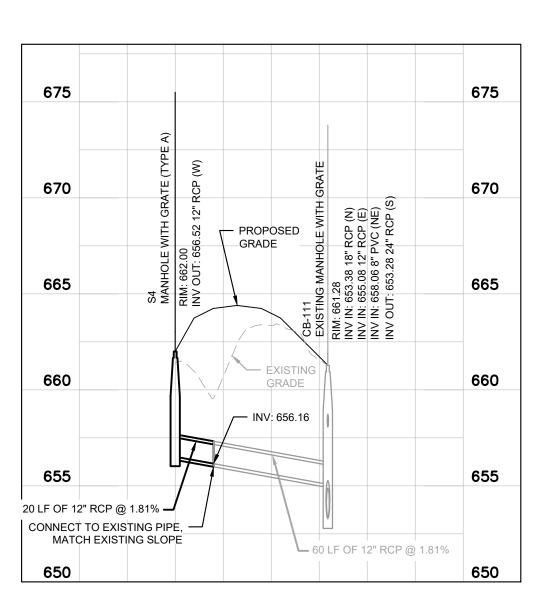

STORM LINE REPLACEMENT

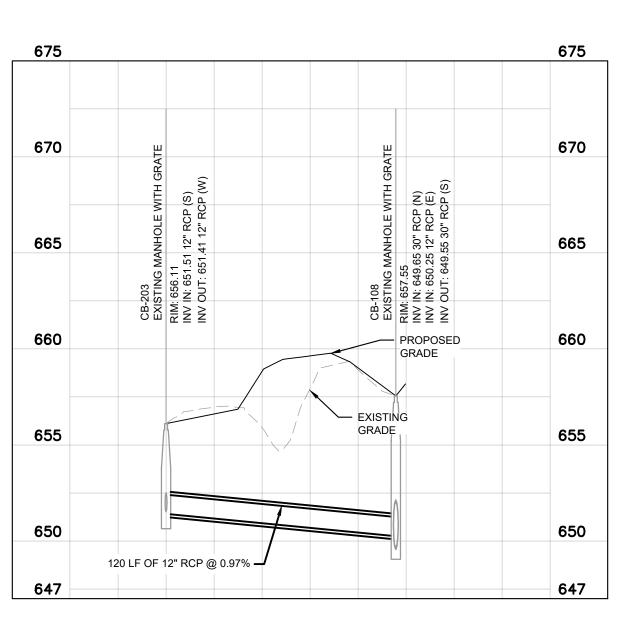


STORM LINE 3

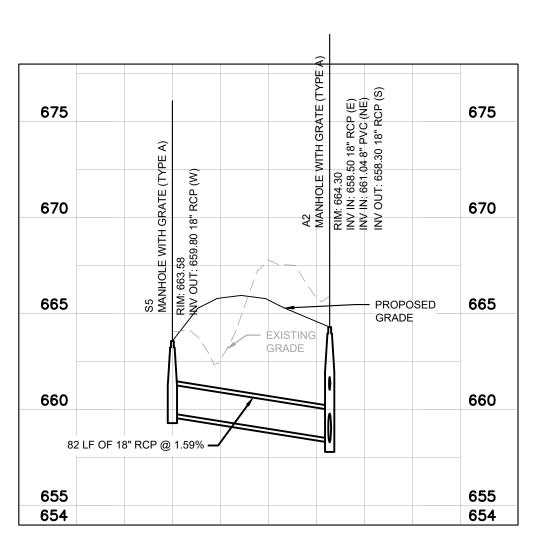

STORM LINE 5

STRUCTURE NAME	DETAILS	N/E:	PIPES IN	PIPES OUT
A1 (PROPOSED)	MANHOLE WITH GRATE (TYPE A) RIM: 657.50 INV IN: 651.32 INV IN: 651.12 INV IN: 654.76 INV OUT: 651.02	N: 1832018.7680 E: 1040020.3150	FROM CB-111, 24" RCP INV IN: 651.32 @ 0.49% FROM S3, 24" RCP INV IN: 651.12 @ 0.54% FROM CLEAN OUT 12, 8" PVC INV IN: 654.76 @ 5.00%	TO CB-109, 30" RCP INV OUT: 651.02 @ 0.27%
A2 (PROPOSED)	MANHOLE WITH GRATE (TYPE A) RIM: 664.30 INV IN: 658.50 INV IN: 661.04 INV OUT: 658.30	N: 1833065.9199 E: 1039986.7070	FROM S5, 18" RCP INV IN: 658.50 @ 1.59% FROM CLEAN OUT 20, 8" PVC INV IN: 661.04 @ 1.00%	TO CB-112, 18" RCP INV OUT: 658.30 @ 0.89%
CB-106 (EXISTING)	EXISTING MANHOLE WITH GRATE RIM: 655.91 INV IN: 648.81 INV IN: 647.31 INV IN: 652.38 INV OUT: 647.21	N: 1831117.9098 E: 1040047.6339	FROM S1 & CB-106 CONNECTION, 12" RCP INV IN: 648.81 @ 2.28% FROM CB-107, 30" RCP INV IN: 647.31 @ 0.54% FROM CLEAN OUT 6, 8" PVC INV IN: 652.38 @ 4.02%	TO CB-105, 42" RCP INV OUT: 647.21 @ 0.68%
CB-109 (EXISTING)	EXISTING MANHOLE WITH GRATE RIM: 657.40 INV IN: 650.33 INV IN: 650.63 INV IN: 652.58 INV OUT: 650.23	N: 1831767.2995 E: 1040026.7469	FROM A1, 30" RCP INV IN: 650.33 @ 0.27% FROM S2 & CB-109 CONNECTION, 12" RCP INV IN: 650.63 @ 0.74% FROM CLEAN OUT 10, 8" PVC INV IN: 652.58 @ 4.37%	TO CB-108, 30" RCP INV OUT: 650.23 @ 0.29%
CB-111 (EXISTING)	EXISTING MANHOLE WITH GRATE RIM: 661.28 INV IN: 653.38 INV IN: 655.08 INV IN: 658.06 INV OUT: 653.28	N: 1832418.7252 E: 1040005.6940	FROM CB-112, 18" RCP INV IN: 653.38 @ 0.44% FROM S4 & CB-111 CONNECTION, 12" RCP INV IN: 655.08 @ 1.81% FROM CLEAN OUT 15, 8" PVC INV IN: 658.06 @ 4.29%	TO A1, 24" RCP INV OUT: 653.28 @ 0.49%
CB-205 (EXISTING)	EXISTING MANHOLE WITH GRATE RIM: 656.80 INV OUT: 653.75	N: 1832091.9038 E: 1040155.2797		TO MH1, 24" RCP INV OUT: 653.75 @ 2.20%
MH1 (PROPOSED)	CLOSED LID MANHOLE (TYPE A) RIM: 657.32 INV IN: 652.46 INV IN: 652.46 INV OUT: 652.46	N: 1832054.0929 E: 1040110.4977	FROM CB-205, 24" RCP INV IN: 652.46 @ 2.20% FROM 175, 24" RCP INV IN: 652.46 @ -2.20%	TO S3, 24" RCP INV OUT: 652.46 @ 2.20%
S1 (PROPOSED)	MANHOLE WITH GRATE (TYPE A) RIM: 653.70 INV OUT: 650.69	N: 1831120.8408 E: 1040130.0082		TO S1 & CB-106 CONNECTION, 12" RCP INV OUT: 650.69 @ 2.28%
S2 (PROPOSED)	MANHOLE WITH GRATE (TYPE A) RIM: 655.59 INV OUT: 651.23	N: 1831771.0476 E: 1040108.4596		TO S2 & CB-109 CONNECTION, 12" RCP INV OUT: 651.23 @ 0.74%
S3 (PROPOSED)	MANHOLE WITH GRATE (TYPE A) RIM: 656.20 INV IN: 651.68 INV OUT: 651.54	N: 1832021.1059 E: 1040098.0151	FROM MH1, 24" RCP INV IN: 651.68 @ 2.20%	TO A1, 24" RCP INV OUT: 651.54 @ 0.54%
S4 (PROPOSED)	MANHOLE WITH GRATE (TYPE A) RIM: 662.00 INV OUT: 656.52	N: 1832420.0181 E: 1040085.2141		TO S4 & CB-111 CONNECTION, 12" RCP INV OUT: 656.52 @ 1.81%
S5 (PROPOSED)	MANHOLE WITH GRATE (TYPE A) RIM: 663.58 INV OUT: 659.80	N: 1833069.4248 E: 1040068.5122		TO A2, 18" RCP INV OUT: 659.80 @ 1.59%

STRUCTURE ADJUSTMENT TABLE							
STRUCTURE NAME	STRUCTURE DETAILS	EXISTING RIM ELEVATION	ADJUSTMENT	NOTES			
CB-112	EXISTING MANHOLE WITH GRATE PROPOSED RIM: 663.724	658.233'	-0.833'	REMOVE EXISTING 28" ADJUSTMENT RING, INSTALL 18" ADJUSTMENT RING			
CB-109	EXISTING MANHOLE WITH GRATE PROPOSED RIM: 657.400	664.224'	-0.500'	REMOVE EXISTING 6" ADJUSTMENT RING			

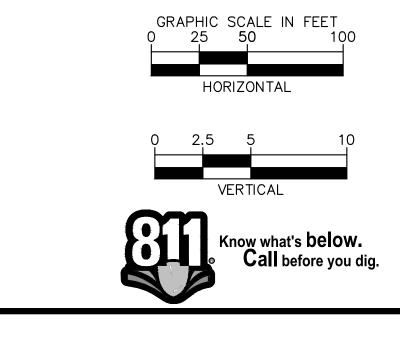



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SCALE: AS NOTED DATE: 11/22/2024 CHECKED BY: REV. DATE DESCRIPTION 0 11/22/2024 ISSUED FOR BID

TAXIWAY AND CERTIFICATION: LUKE M. S BURLINGAME

CG-201

当 062-076682 岩

PROJECT NUMBER: 168001005

DRAWING NO.

EPLACEMENT PA ORT ROTATING I LINGBROOK

Drain Tile & Sump Pump Connection at House

01-03-20

-PVC Elbow (typ)

Revisions

DRAWING NO. CG-501

PROJECT NUMBER:

ale Burlingone

**CERTIFICATION:** 

LUKE M.

BURLINGAME

4 .062–076682 5

168001005

Storm Sewer Standards 1

Sheet 5

# Bolingbrook aplace to V grow

### Storm Sewer Notes

All storm sewers shall be constructed in accordance with the "Standard Specifications For Water and Sewer Main Construction" in Illinois and the VIllage of Bolingbrook Development Code. The storm water drainage system shall be separate and independant of the sanitary sewer

All overland drainage, downspouts, footing drains, and sump pumps shall be made to drain to the rear yard drainage system.

### Materials & Installation

Unless otherwise noted on the plans, all storm sewers shall be reinforced concrete pipe, ASTM C 76, with gasketed joints conforming to ASTM C 443. The class of pipe will be determined by the plans. The rear yard storm sewer shall be PVC SDR 26 or ADS N-12, soil tight with bell and socket joints (not strap type), or approved equal.

Manholes, catch basins, and inlet bottoms shall be precast concrete sectional units or monolithic concrete. Manholes and catch basins shall be four (4') feet in diameter unless otherwise noted in the plans. Manhole joints shall be sealed with bituminous mastic. Not more than two (2) precast adjusting rings shall be used to adjust frame elevations.

### All storm sewers shall be installed on a type 'A' bedding, one quarter $(\frac{1}{4})$ inch to three quarters

 $(\frac{3}{4})$  inch in size, with a maximum thickness equal to one quarter  $(\frac{1}{4})$  of the outside diameter of the sewer pipe but not less than four (4") inches. Blocking of any kind for grade is not permitted. Bedding and initial backfill material shall be CA-7. Type 'A' bedding shall be compacted to ninety (90%) percent of the standard proctor density. The bedding for ADS N-12 pipe shall be in conformance with the manufacturer's recommendations.

All PVC or HDPE storm sewer or rear yard drains shall be tested deflection and obstructions in the pipe by use of mandrel. The mandrel shall be set at 95 percent of the pipes internal

Steps shall be gray iron conforming to the requirements of article 710.17 of the Standard Specifications. They shall be embedded into the wall a minimum of four (4") inches and shall not extend beyond the outside edge of the wall. If plastic polymer steps are used, they shall be constructed in conformance with I.D.O.T. Standards.

Construction shall be in accordance with I.D.O.T. "Standard Specifications for Road and Bridge Construction."

Adjusting rings shall be precast concrete and used on storm, sanitary, and valve vault structures. Two (2") inch adjusting rings can be used on adjustments less than three (3") inches. The maximum adjustment allowed will be twelve (12") inches, and a maximum of two (2) rings will be allowed. A continuous layer of non-hardening, preformed, butyl-mastic material (RUB-R-NEK, EZ-STICK or equal) will be applied to each joint, adjusting ring, and frame to prevent infiltration. After the castings are adjusted, the space around them shall be filled with

### Interior joints shall be 'dressed-up' with hydraulic cement or portland cement for strength and a

In paved areas, provide compacted CA-7 crushed stone aggregate around the structure to

### All frame and grates in curblines shall have concrete fillet.

The last 10' of stormsewer installed before entering a pond shall have it's stone bedding and stone backfill replaced with compacted clay.

### Frames & Grates

All manhole lids shall be machined surfaced and non-rocking in design. The enclosed lids shall have the words "Village of Bolingbrook" and "Storm" embossed on the lid. The joint between the concrete section and the frame shall be sealed with a mastic compound.

Behive grates shall be used in grassy areas.

Compacted CA-7 aggregate shall be used under all pavements, curbs, gutters, and within two (2') feet of any proposed curb and gutters. Backfill will be mechanically compacted. Backfill trenches with excavated material and mechanically compact unless otherwise noted.

All trenching shall conform to O.S.H.A. regulations and specifications. The angle of repose shall be calculated by O.S.H.A. for sloping excavations in variuos types of soil.


If encountered, remove unsuitable materials and replace with aggregate material as approved by the Village Engineer.

### **Detention Ponds**

The detention area shall be respread with six (6") inches of topsoil, and covered with seed (IDOT type 1 lawn mixture) and excelcior blanket or knittet straw matt. The detention area will not be approved until the turf of grass has taken to the degree that the Village Engineer, or his designee, deems acceptable.


### Retention Ponds


The retention areashall be respread with six (6") inches of topsoil, and covered with seed (IDOT typy 1 lawn mixture) and excelcior blanket or knitted straw mat. The retention area will not be approved until the turf of grass has taken to the degree that the Village Engineer. or his designee, deems acceptable.

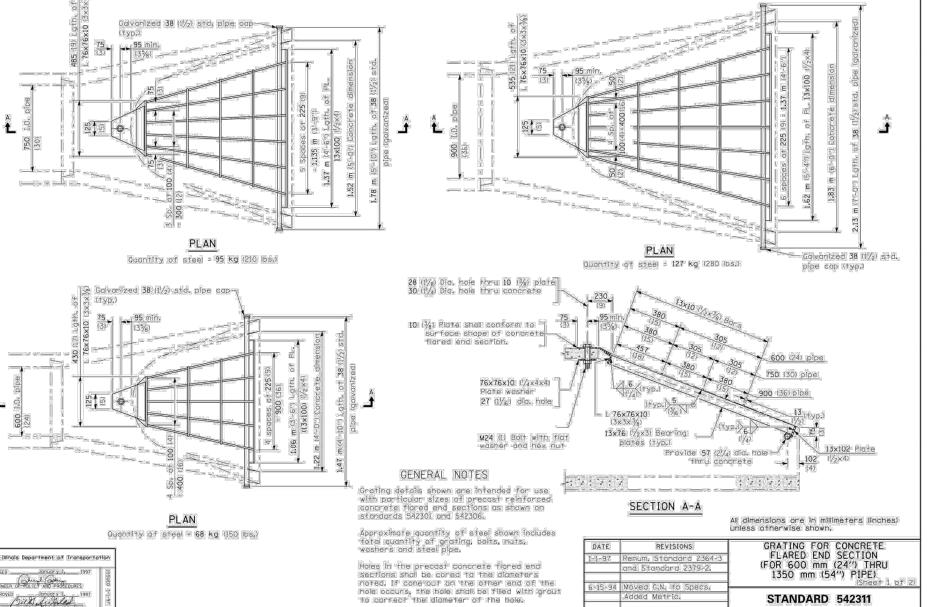

Weephole With Minimum of

a 1' x 1' Piece of Fabric Affixed With Bitumindus Mastic.

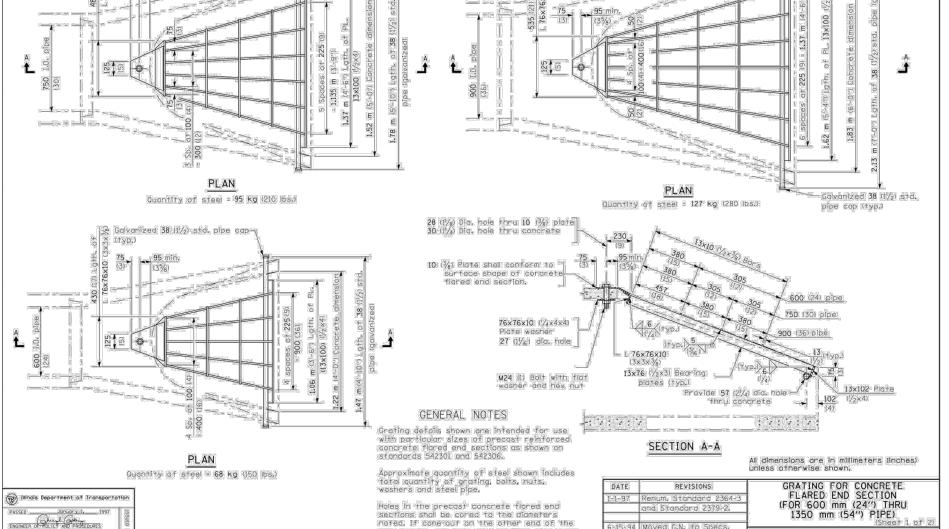

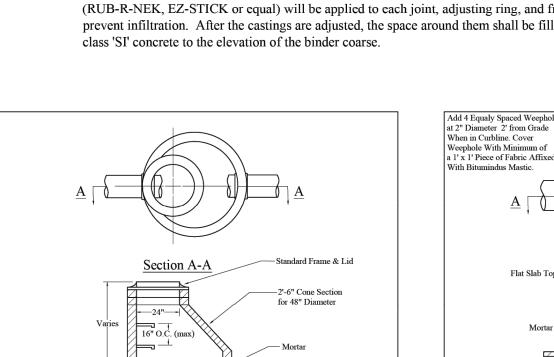

Apply a continuous layer of non-hardening, preformed, butyl mastic material (Rub R Nek, E-Z Stick or equal) to each joint. adjusting ring and frame to prevent infiltration. In paved areas, the adjusting ring and frame are to be set in mortar. Interior joints are to be 'dressed up' with hydraulic cement or portland cement for strength and a water tight bond.

Precast Reinforced Concrete

Revisions

11-24-97 PI

03-19-14 L0

01-03-20 LC


Bottom With Integral Sidewall

In paved areas, provide compacted CA-7 crushed stone aggregate around the catch basin to subgrade elevation. Adjusting rings which are 3" or thinner shall be made of a composite rubber material (East Jordan or equal). The maximum adjustment allowed will be twelve (12") inches, two (2) rings maximum.

Catch Basin Type 'A'


When in Curbline. Cover Weephole With Minimum of a 1' x 1' Piece of Fabric Affixed ith Bitumindus Mastic Flat Slab Top-Apply a continuous layer of non-hardening, preformed, butyl mastic material (Rub R Nek, E-Z Stick or equal) to each joint. adjusting ring and frame to prevent infiltration. In paved areas, the adjusting ring and frame are to be set in mortar. Interior joints are to be 'dressed up' with hydraulic cement or portland cement for strength and a water tight bond.


The catch basin shall be constructed with a flat slab top having a two (2') foot In paved areas, provide compacted CA-7 crushed stone aggregate around the catch basin to subgrade elevation. Adjusting rings which are 3" or thinner shall be made of a composite rubber material (East Jordan or equal).. The maximum adjustment allowed will be twelve (12") inches, two (2) rings maximum The bottom of the catch basin will consist of a precast reinforced concrete slab. An alternate to this will be a precast reinforced concrete basin. Revisions 11-21-97 PD 03-07-06 LC Catch Basin Type 'B' 03-19-14 LC 01-03-20 LC

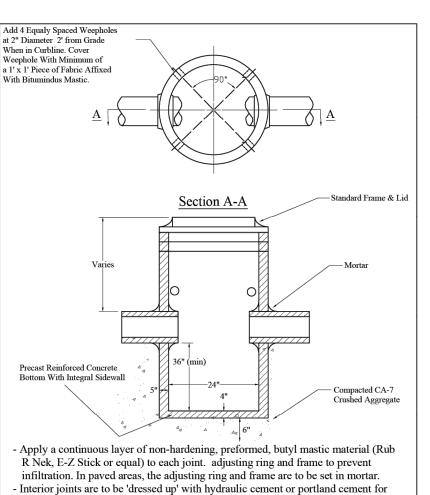


strength and a water tight bond. In paved areas, provide compacted CA-7 crushed stone aggregate around the catch basin to subgrade elevation. Adjusting rings which are 3" or thinner shall be made of a composite rubber material (East Jordan or equal). The maximum adjustment allowed will be twelve (12") inches, two (2) rings maximum.

Revisions Catch Basin Type 'C' 03-07-06 L0 03-19-14 L 01-03-20 L

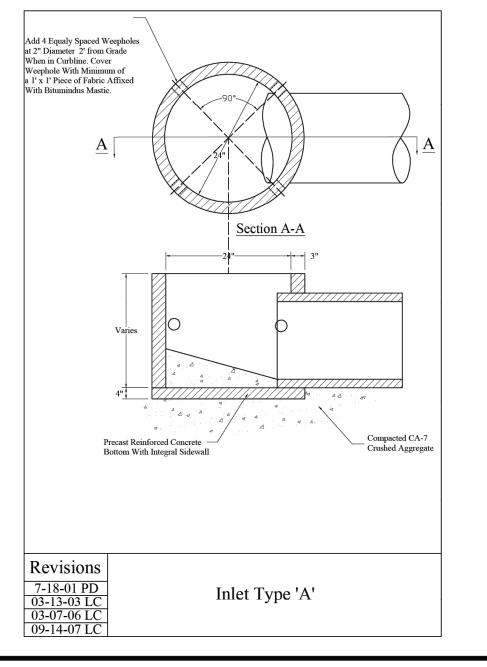

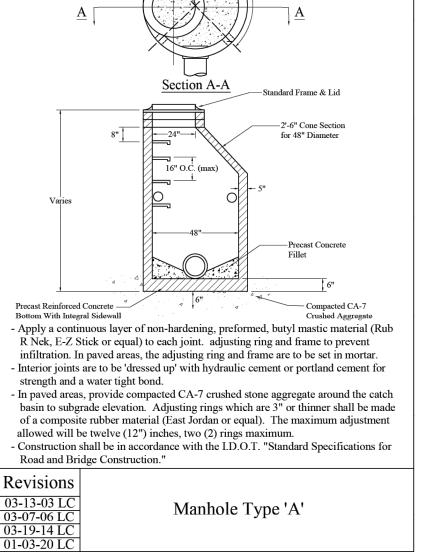

Manhole Type 'A'

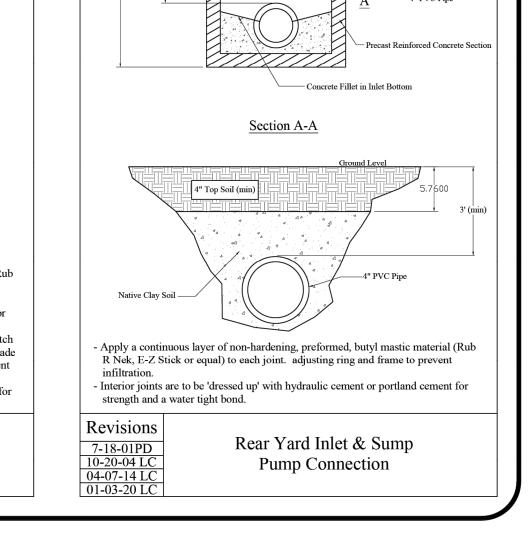



# Bolingbrook aplace to I grow


### Storm Sewer Standards 2


Sheet 6


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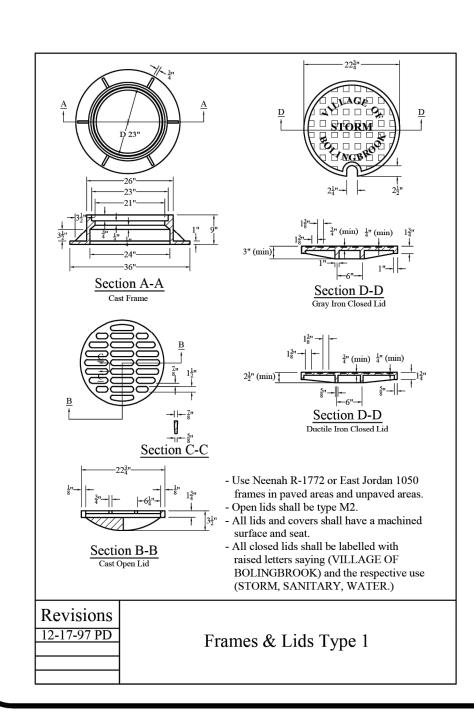


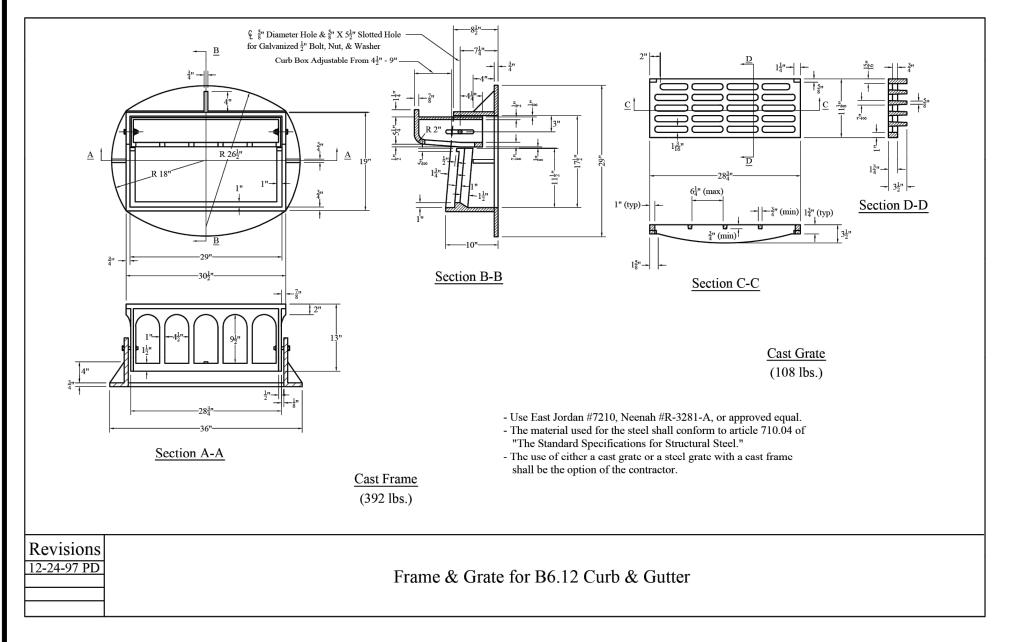


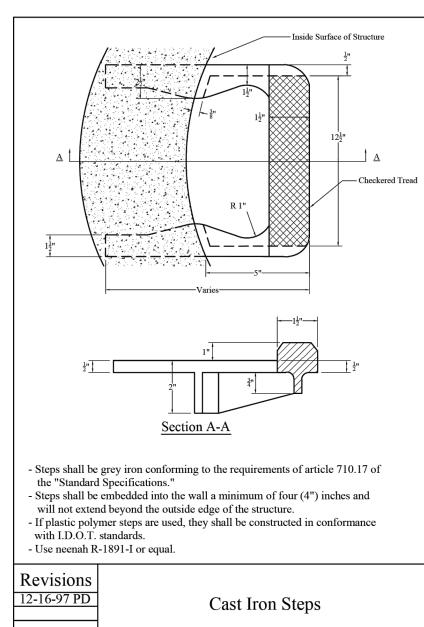


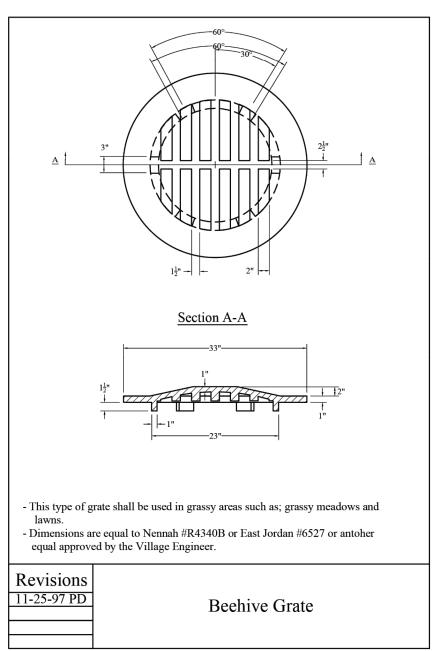


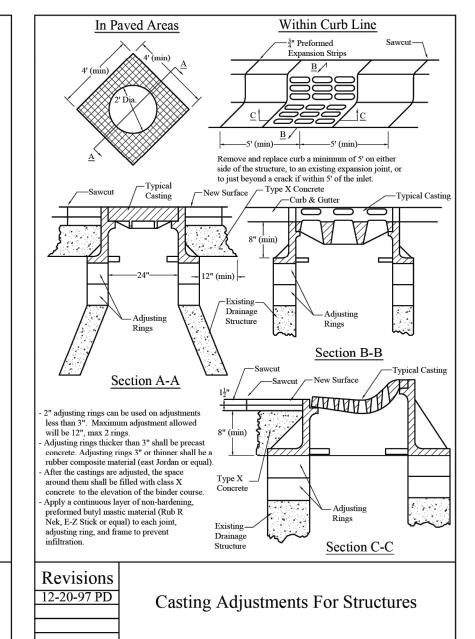

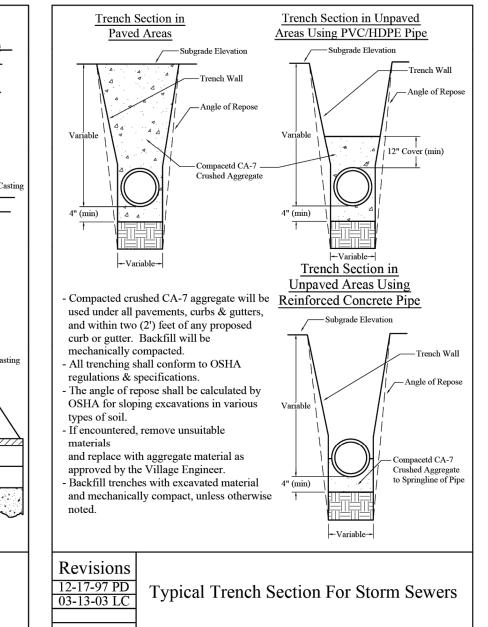

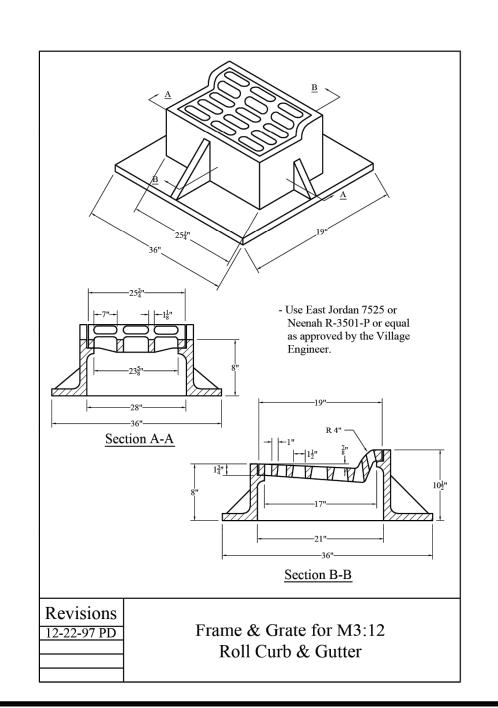

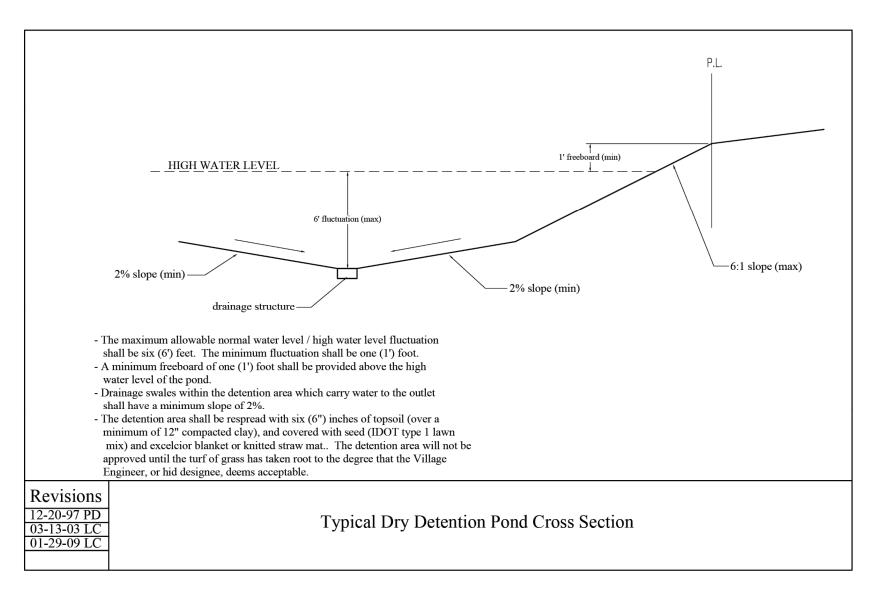

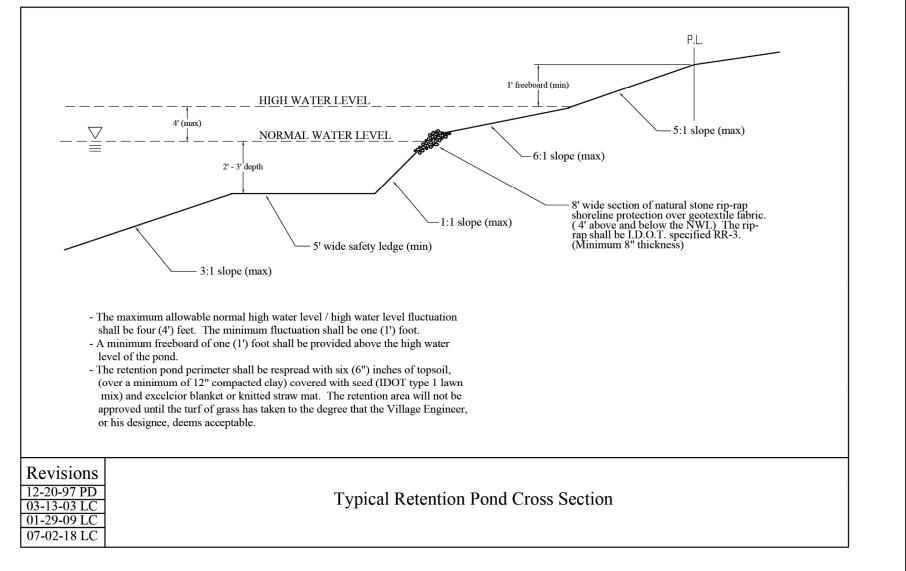



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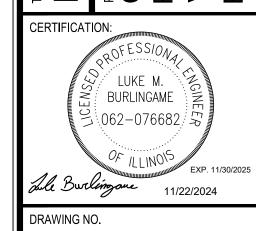
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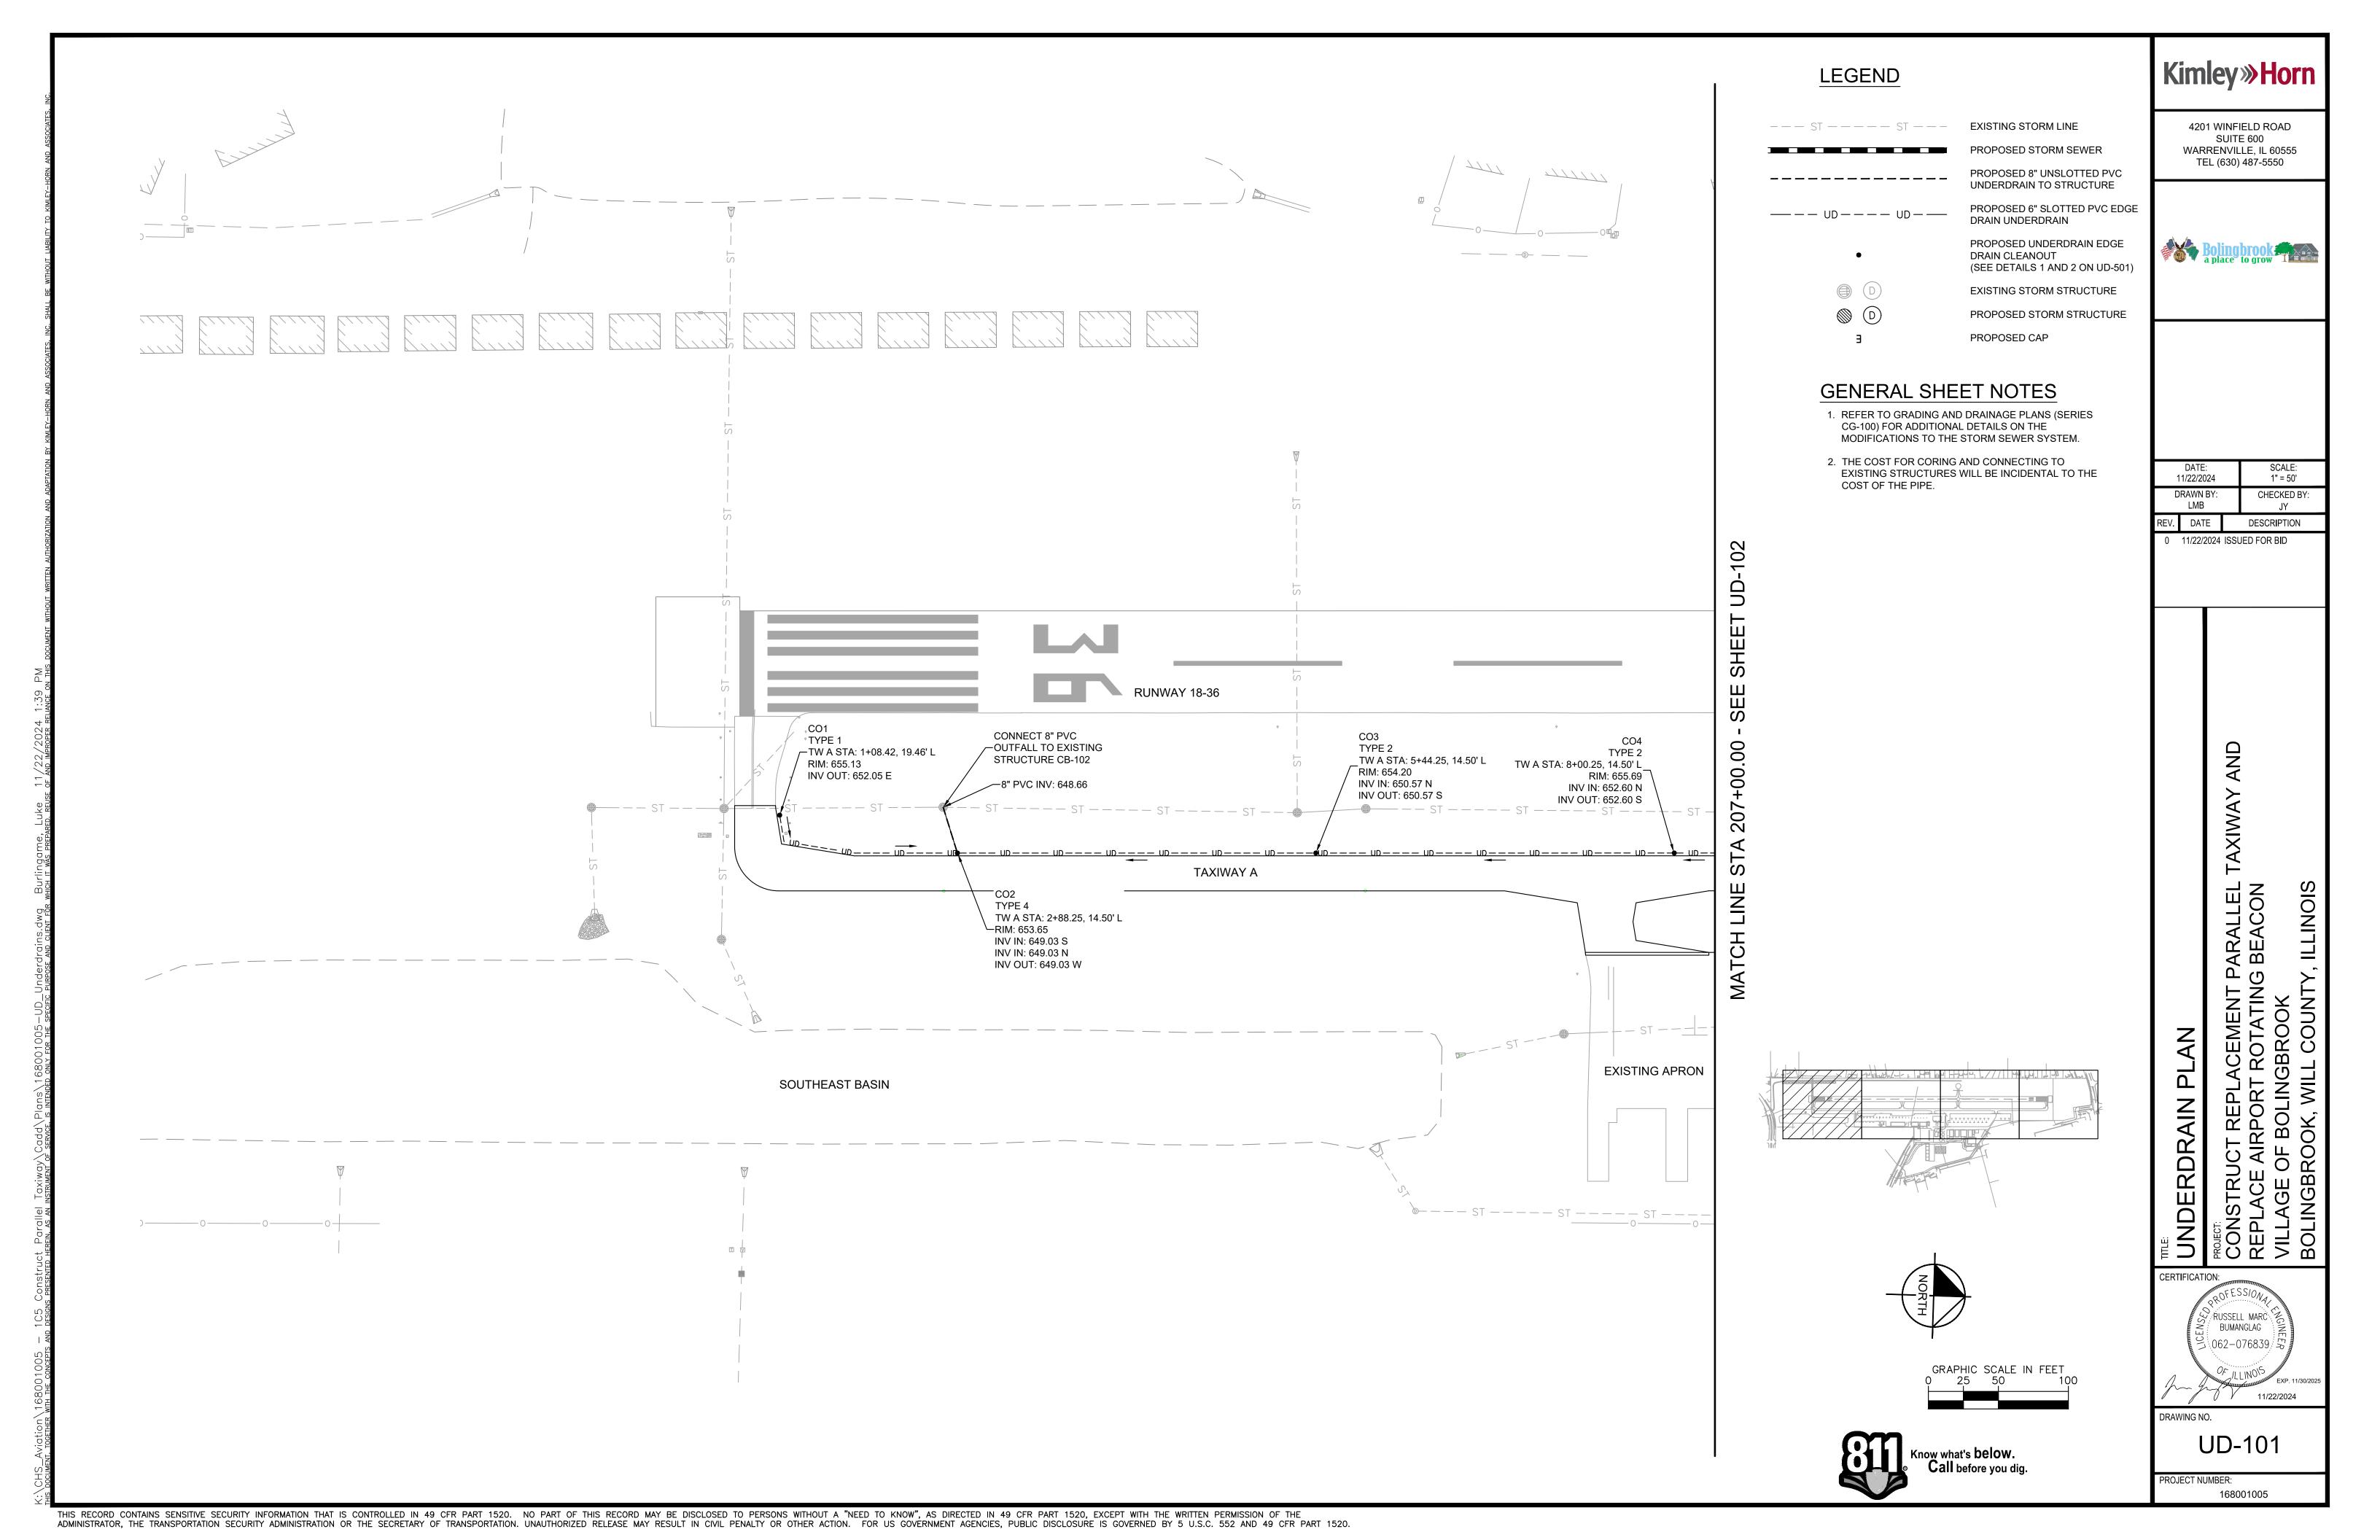
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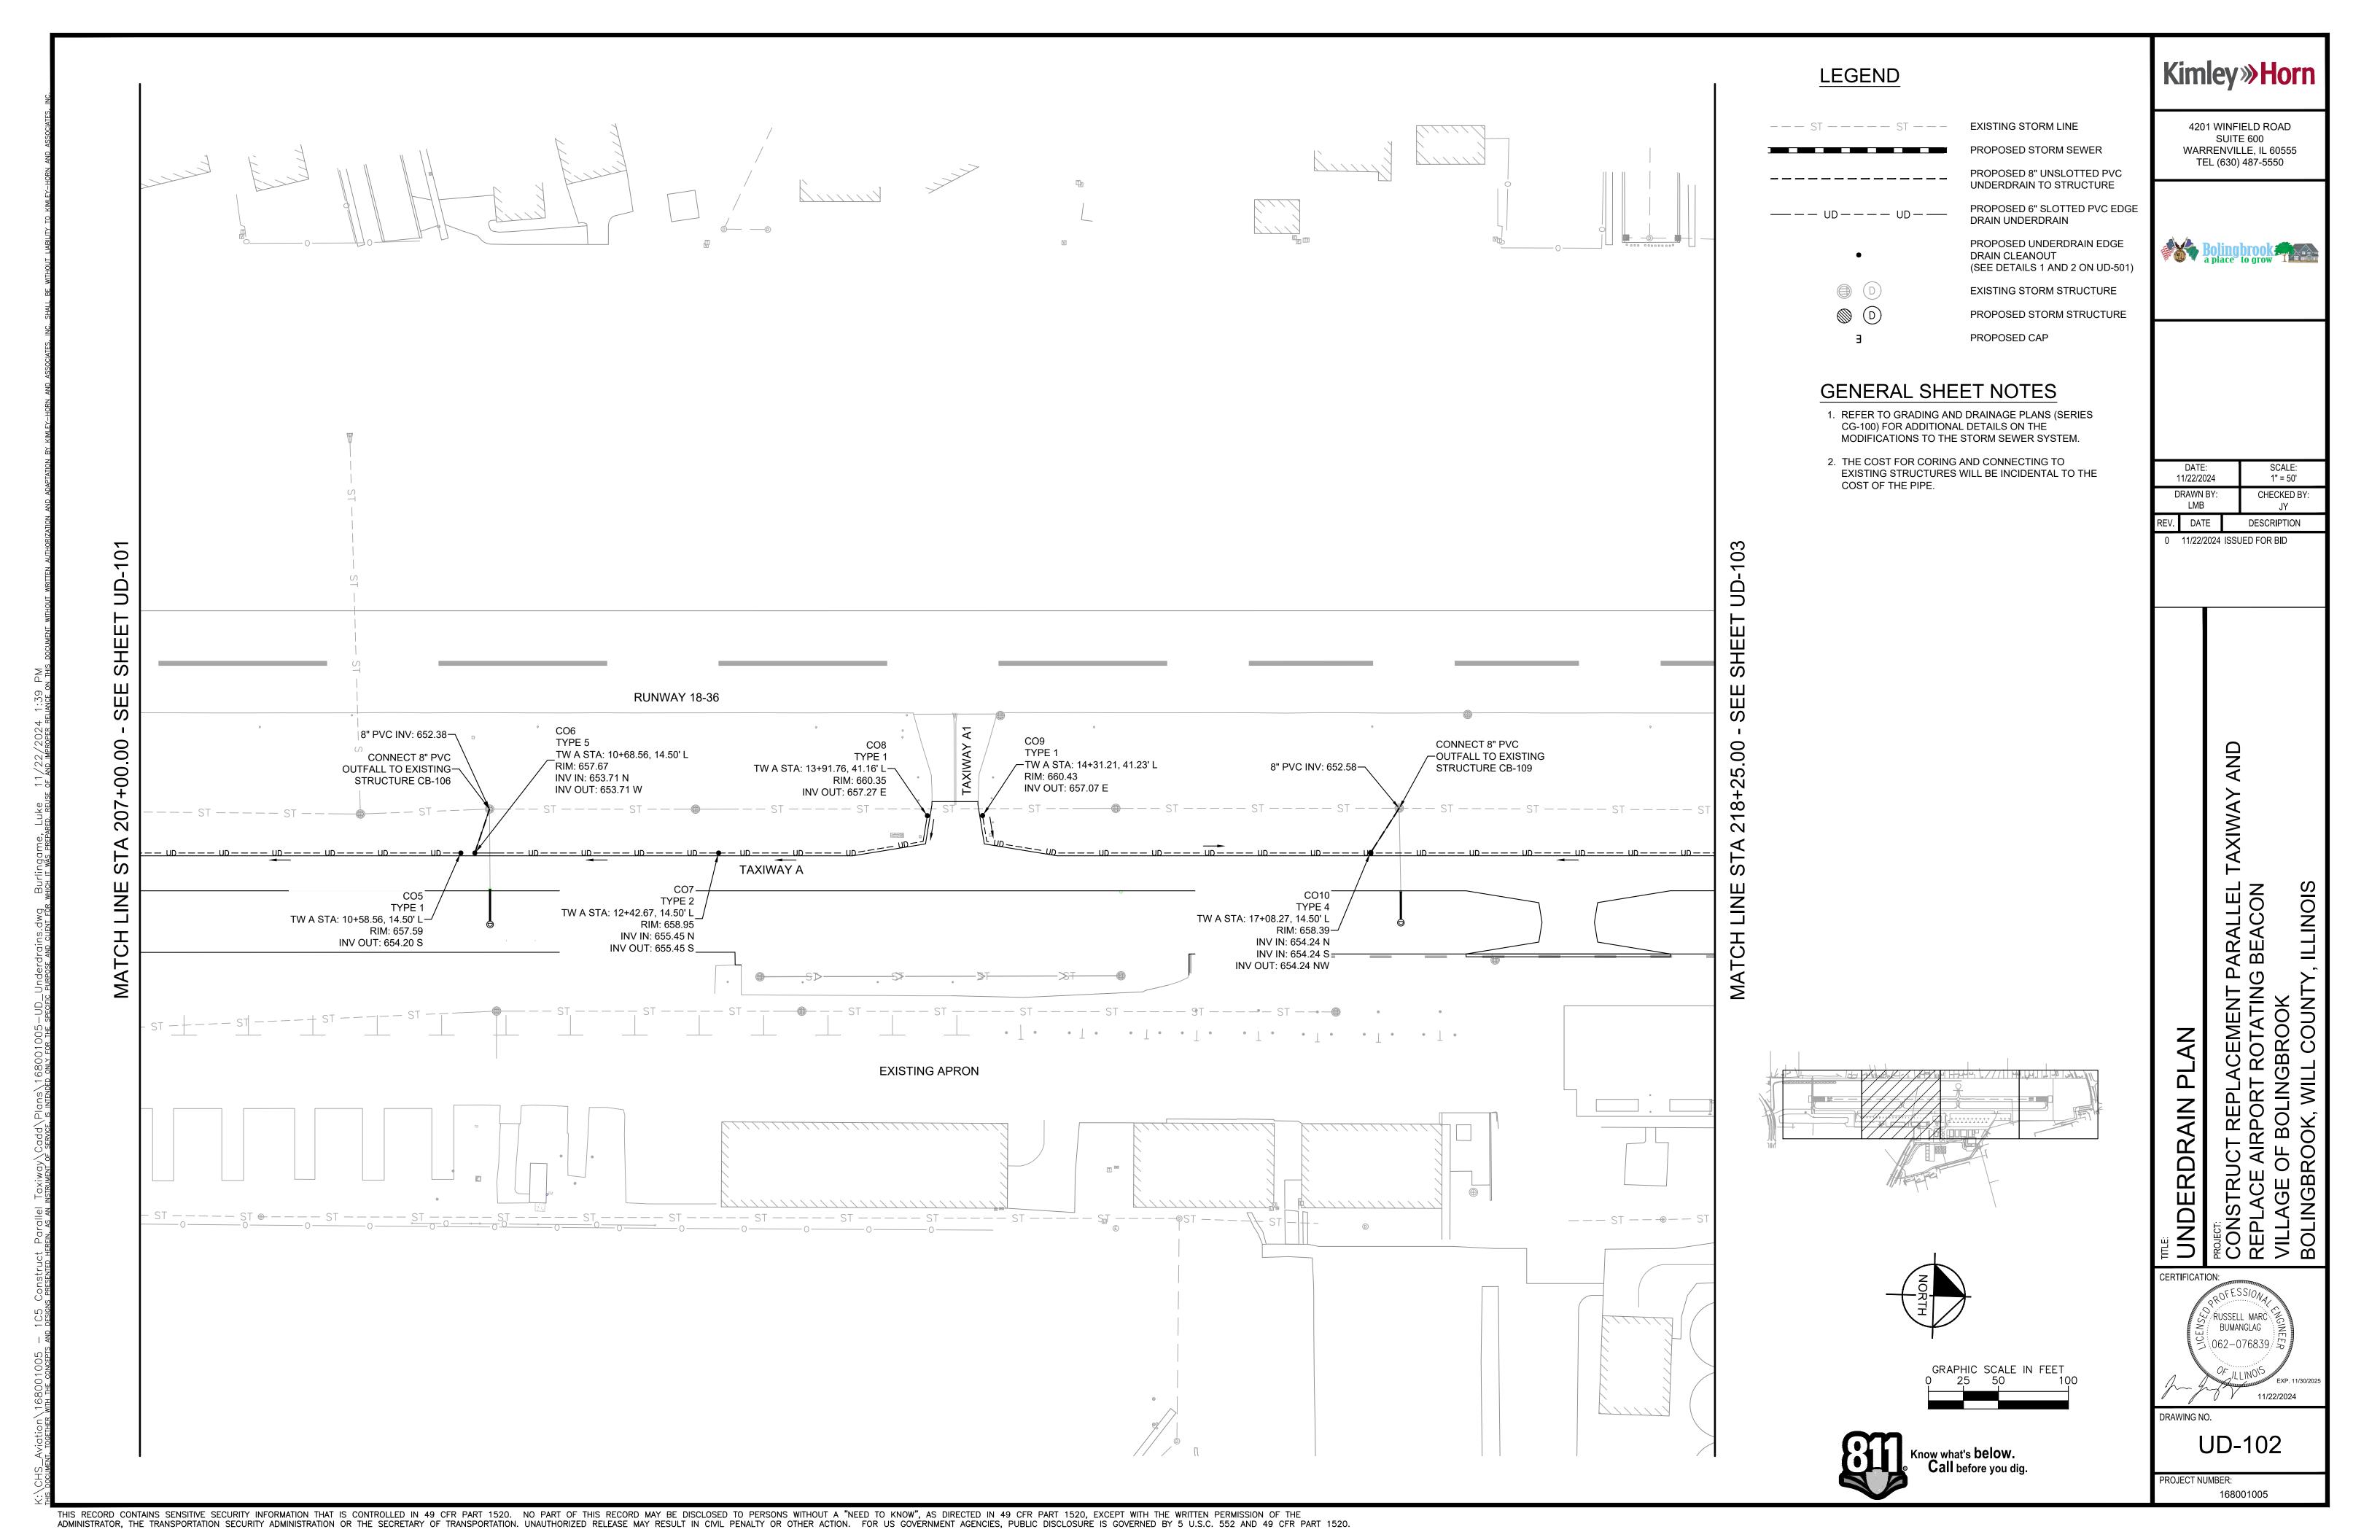
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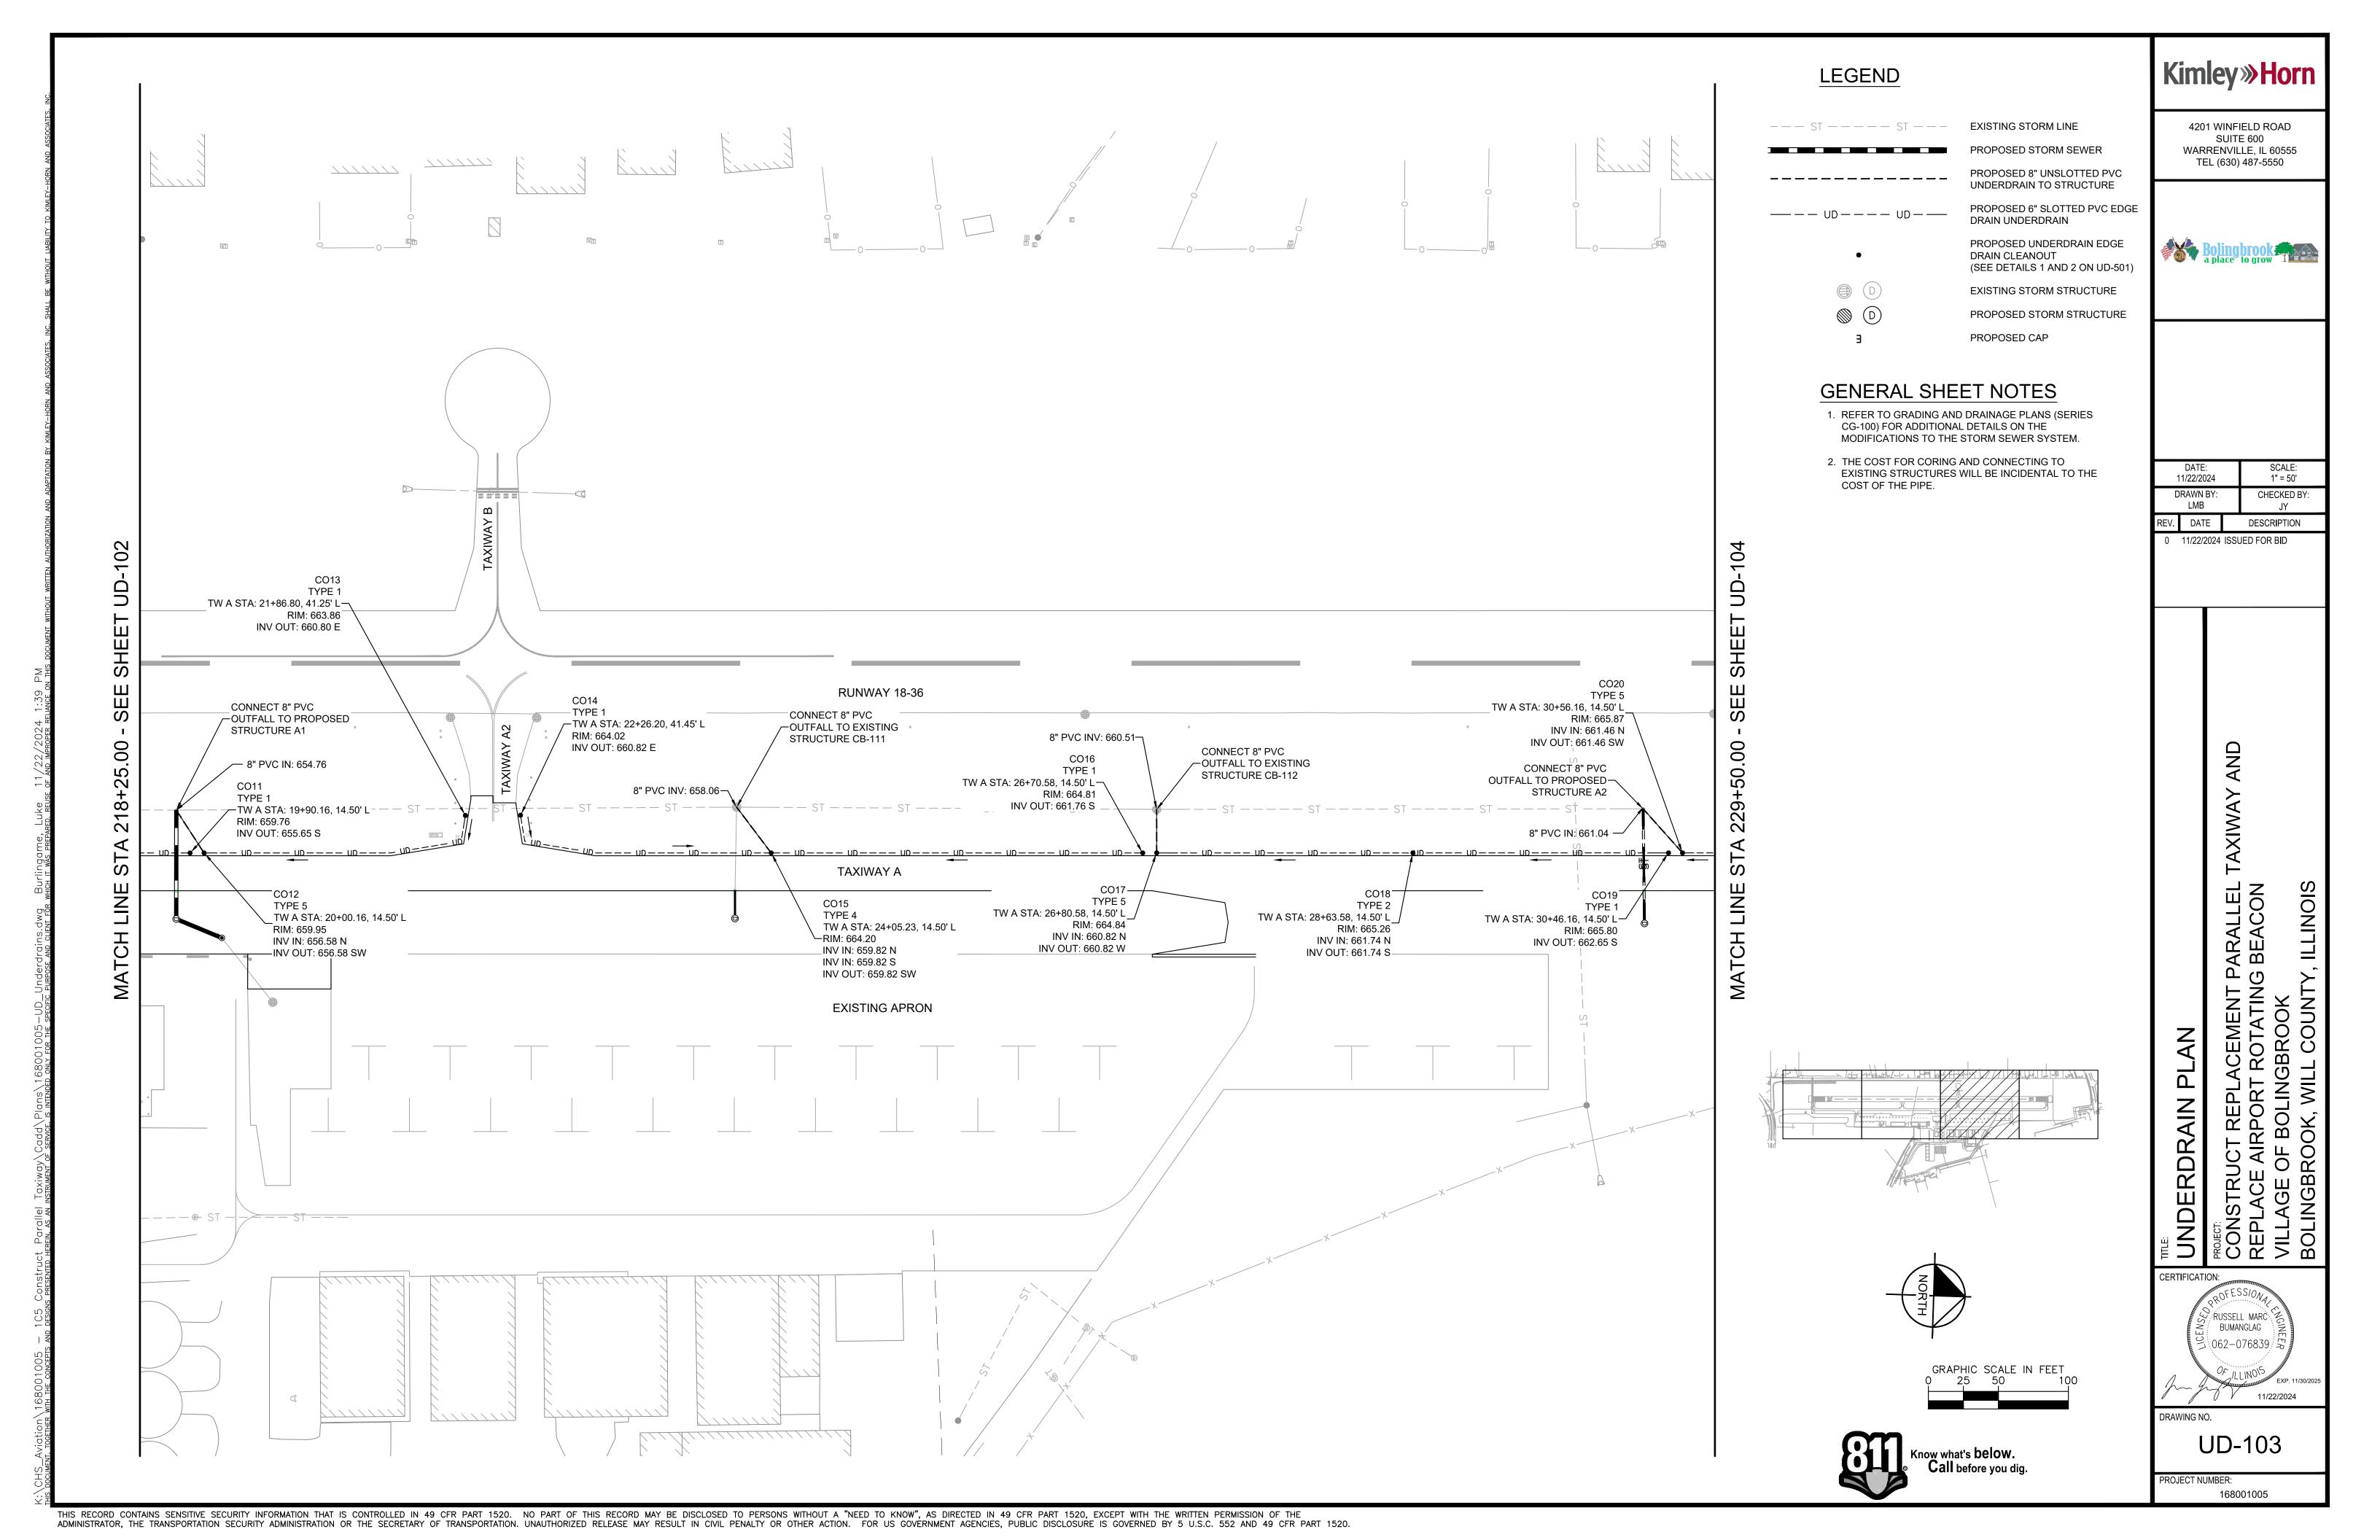
PROJECT:
CONSTRUCT REPLACE
REPLACE AIRPORT RO
VILLAGE OF BOLINGBR





CG-502







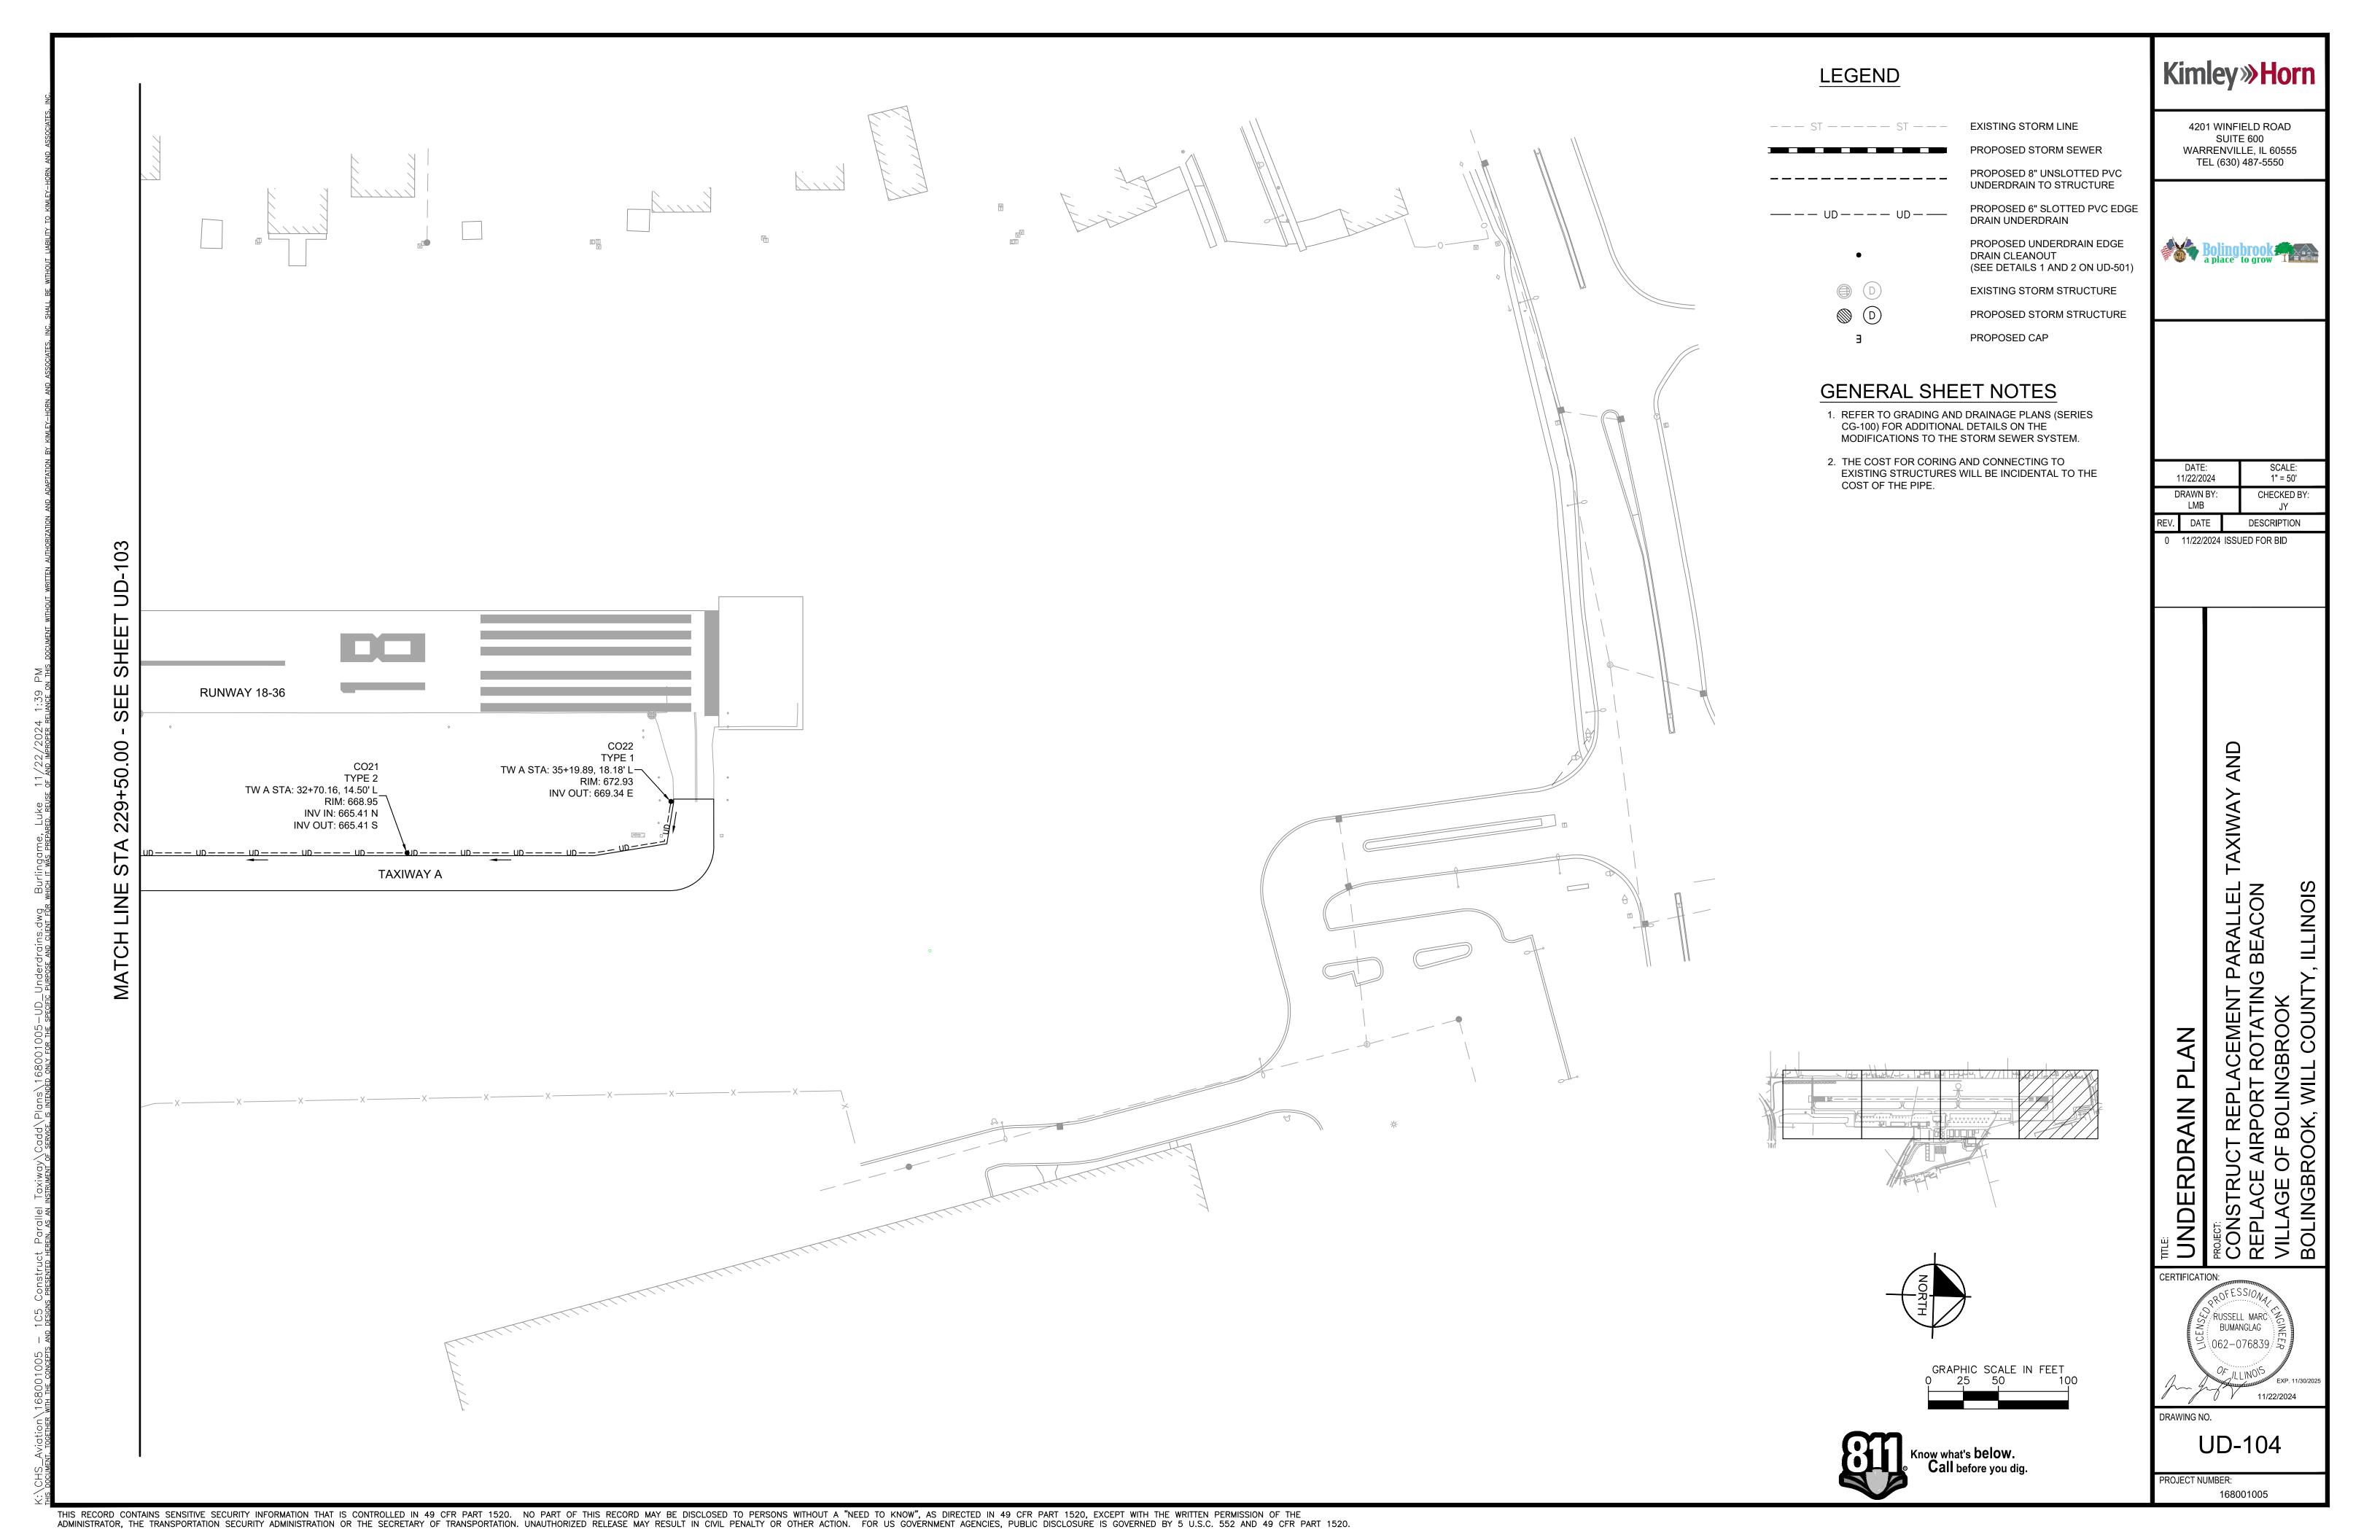

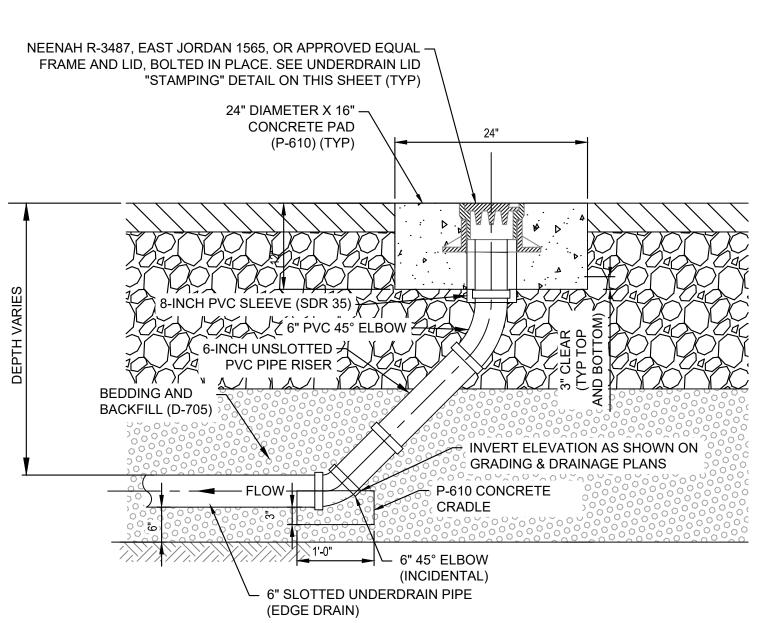



(P-610) (TYP)

8-INCH PVC SLEEVE (SDR 35)

6-PVC 45° ELBOW

CAP FOR END
CLEANOUT IF

BEDDING AND
BACKFILL (D-705)

BACKFILL (D-705)

FLOW

P-610 CONCRETE
CRADLE

INVERT ELEVATION AS SHOWN ON GRADING & DRAINAGE PLANS

(EDGE DRAIN)

LONGITUDINAL UNDERDRAIN

**CLEANOUT DETAIL - TYPE 2** 

NEENAH R-3487, EAST JORDAN 1565, OR APPROVED EQUAL -


FRAME AND LID, BOLTED IN PLACE. SEE UNDERDRAIN LID

"STAMPING" DETAIL ON THIS SHEET (TYP)

24" DIAMETER X 16" —

UD-501 NTS

CONCRETE PAD

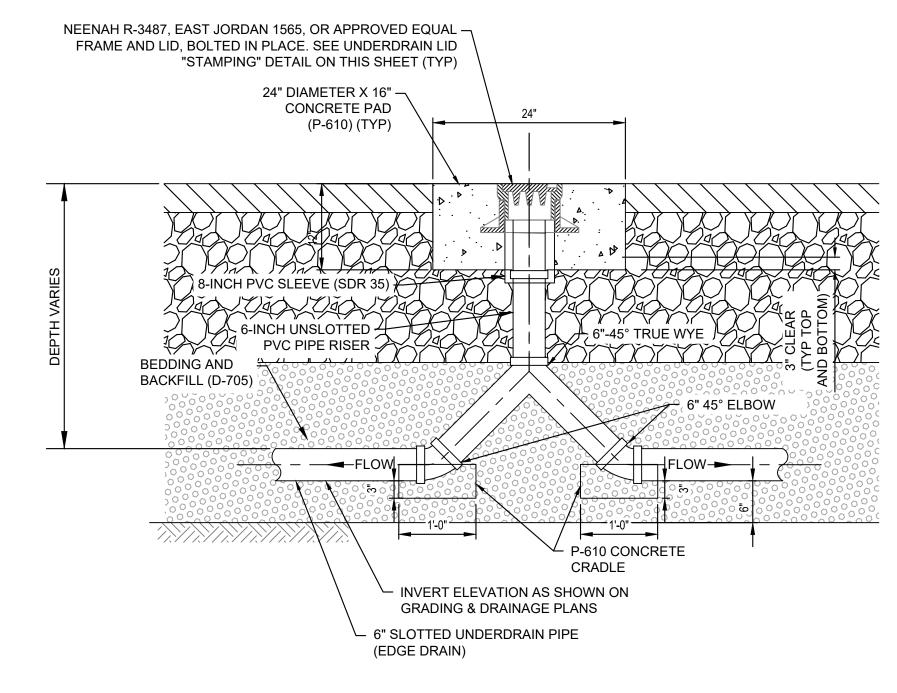


LONGITUDINAL UNDERDRAIN
CLEANOUT DETAIL - TYPE 3
UD-501 NTS

LONGITUDINAL UNDERDRAIN

CLEANOUT DETAIL - TYPE 1


UD-501 NTS

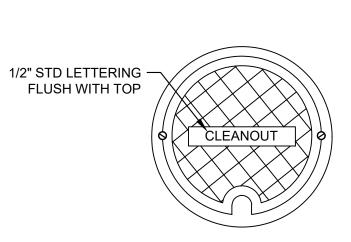



### NOTES:

1. ALL UNDERDRAIN CLEANOUT LIDS SHALL BE STAMPED "CLEANOUT" WITH 1/2" LETTERS.

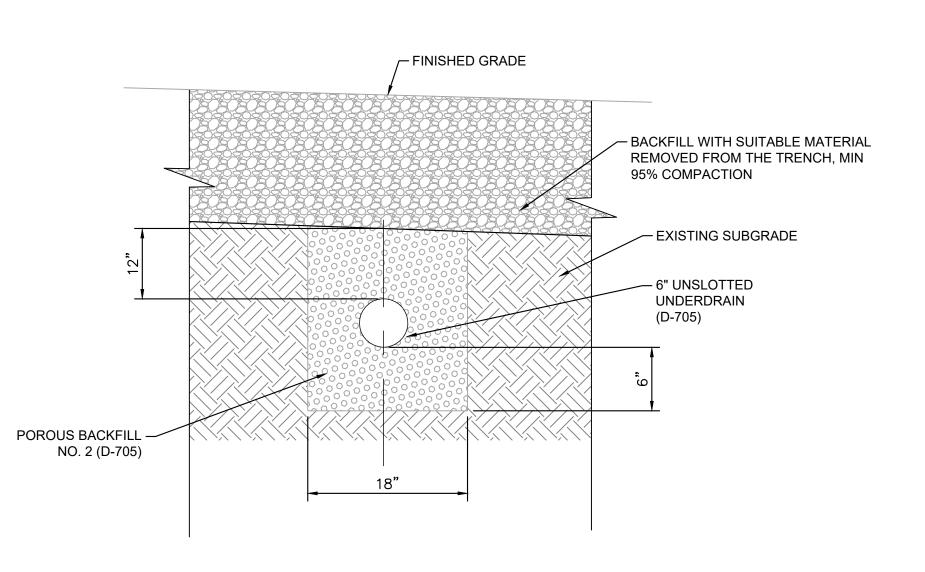

# 6" UNSLOTTED PVC TRENCH DETAIL UD-501 NTS


### NOTES:

- WIDTH OF UNDERDRAIN INSTALLATION TRENCH MAY VARY DUE TO OSHA REQUIREMENTS, SITE CONDITIONS, AND INSTALLATION METHOD, CONTRACTOR SHALL ADJUST TRENCH WIDTH ACCORDINGLY.
- 2. PVC OUTLET PIPES SHALL BE INSTALLED AT A MINIMUM SLOPE OF 0.3%.



4201 WINFIELD ROAD SUITE 600 WARRENVILLE, IL 60555 TEL (630) 487-5550



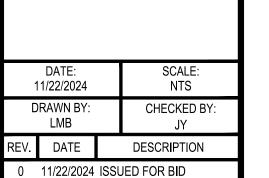

I DE I AILS
PLACEMENT PARALLEL TAXIWAY AND
RT ROTATING BFACON

PROJECT:
CONSTRUCT REPLACEM
REPLACE AIRPORT ROT,
VILLAGE OF BOLINGBRC

CERTIFICATION:

RUSSELL MARC GINEFE

BUMANGLAG

BUMANGLAG


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EXP. 11/30/2024

DRAWING NO.

UD-501


PROJECT NUMBER: 168001005

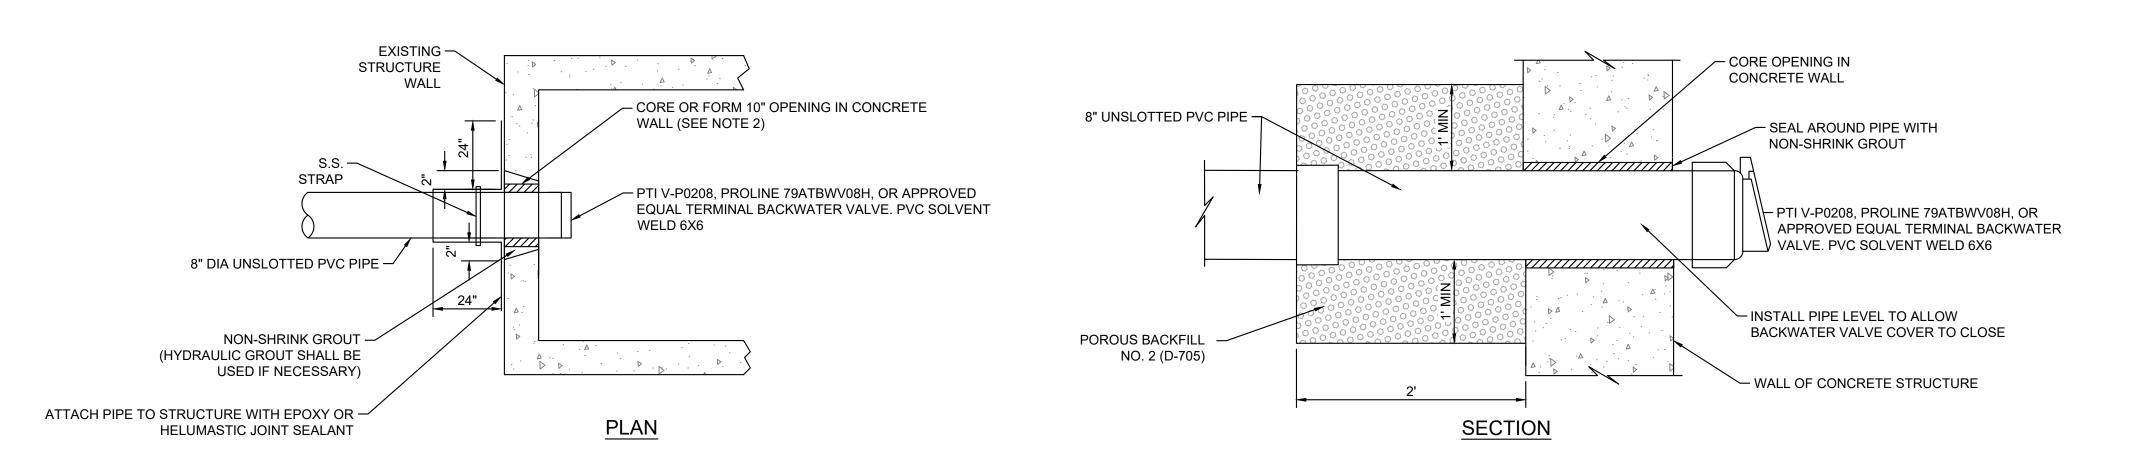

UNDERDRAIN OUTLET CONNECTION TO STRUCTURE DETAIL UD-502 NTS

### NOTES:


- 1. BACKWATER VALVE TO BE INCIDENTAL TO PIPE (D-705-5.3)
- 2. FOR 2" DIA UNSLOTTED PVC PIPE USED IN ELECTRICAL STRUCTURE OUTLETS, CORE SHALL BE 4" IN DIA AND BACKWATER VALVE SHALL BE EXCLUDED
- 3. FOR 6" DIA UNSLOTTED PVC PIPE USED IN HYDRANT STRUCTURE OUTLETS, CORE SHALL BE 10" IN DIA AND BACKWATER VALVE SHALL BE EXCLUDED.

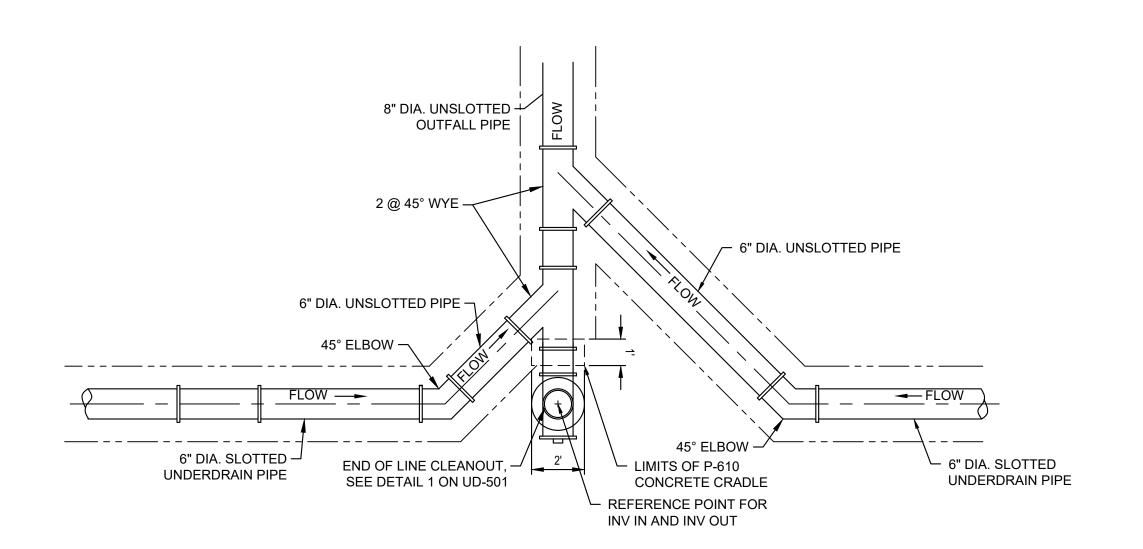


PLAN VIEW UNDERDRAIN CLEANOUT OUTFALL DETAIL - TYPE 4 UD-502 NTS

### NOTES:

- 1. DETAIL REFLECTS A 90 DEGREE ANGLE. FIELD CONDITIONS MAY WARRANT A DIFFERENT ANGLE DURING CONSTRUCTION.
- 2. FOR CLARITY IN THIS DETAIL, CONCRETE CRADLE HAS NOT BEEN SHOWN. THIS SHALL BE INSTALLED FOR TYPE 4 CLEANOUTS WHERE FITTINGS CONNECT TO SLOTTED UNDERDRAIN PIPES.

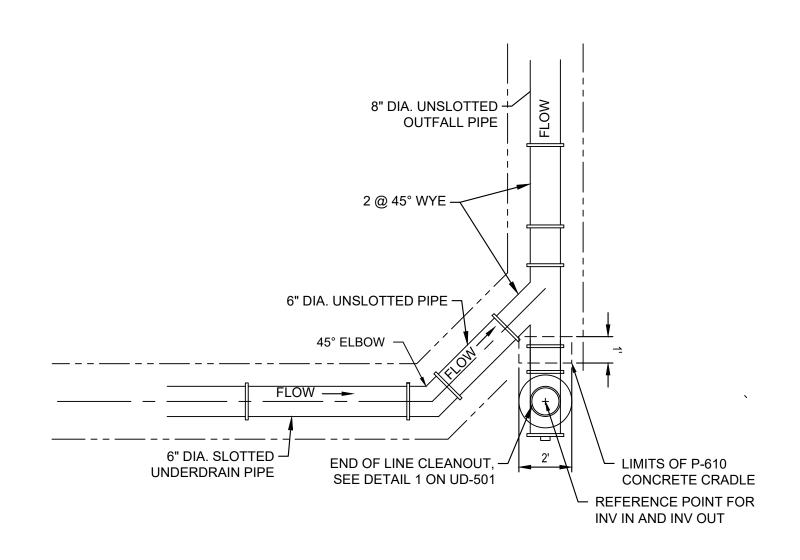

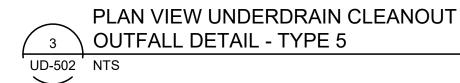

- 1. DETAIL REFLECTS A 90 DEGREE ANGLE. FIELD CONDITIONS MAY WARRANT A
- DIFFERENT ANGLE DURING CONSTRUCTION.
- 2. FOR CLARITY IN THIS DETAIL, THE P-610 CONCRETE CRADLE HAS NOT BEEN SHOWN. THIS SHALL BE INSTALLED FOR TYPE 4 CLEANOUTS WHERE FITTINGS CONNECT TO PERFORATED UNDERDRAIN PIPES.



4201 WINFIELD ROAD SUITE 600 WARRENVILLE, IL 60555 TEL (630) 487-5550



DATE: 11/22/2024 SCALE: NTS DRAWN BY: CHECKED BY: REV. DATE DESCRIPTION

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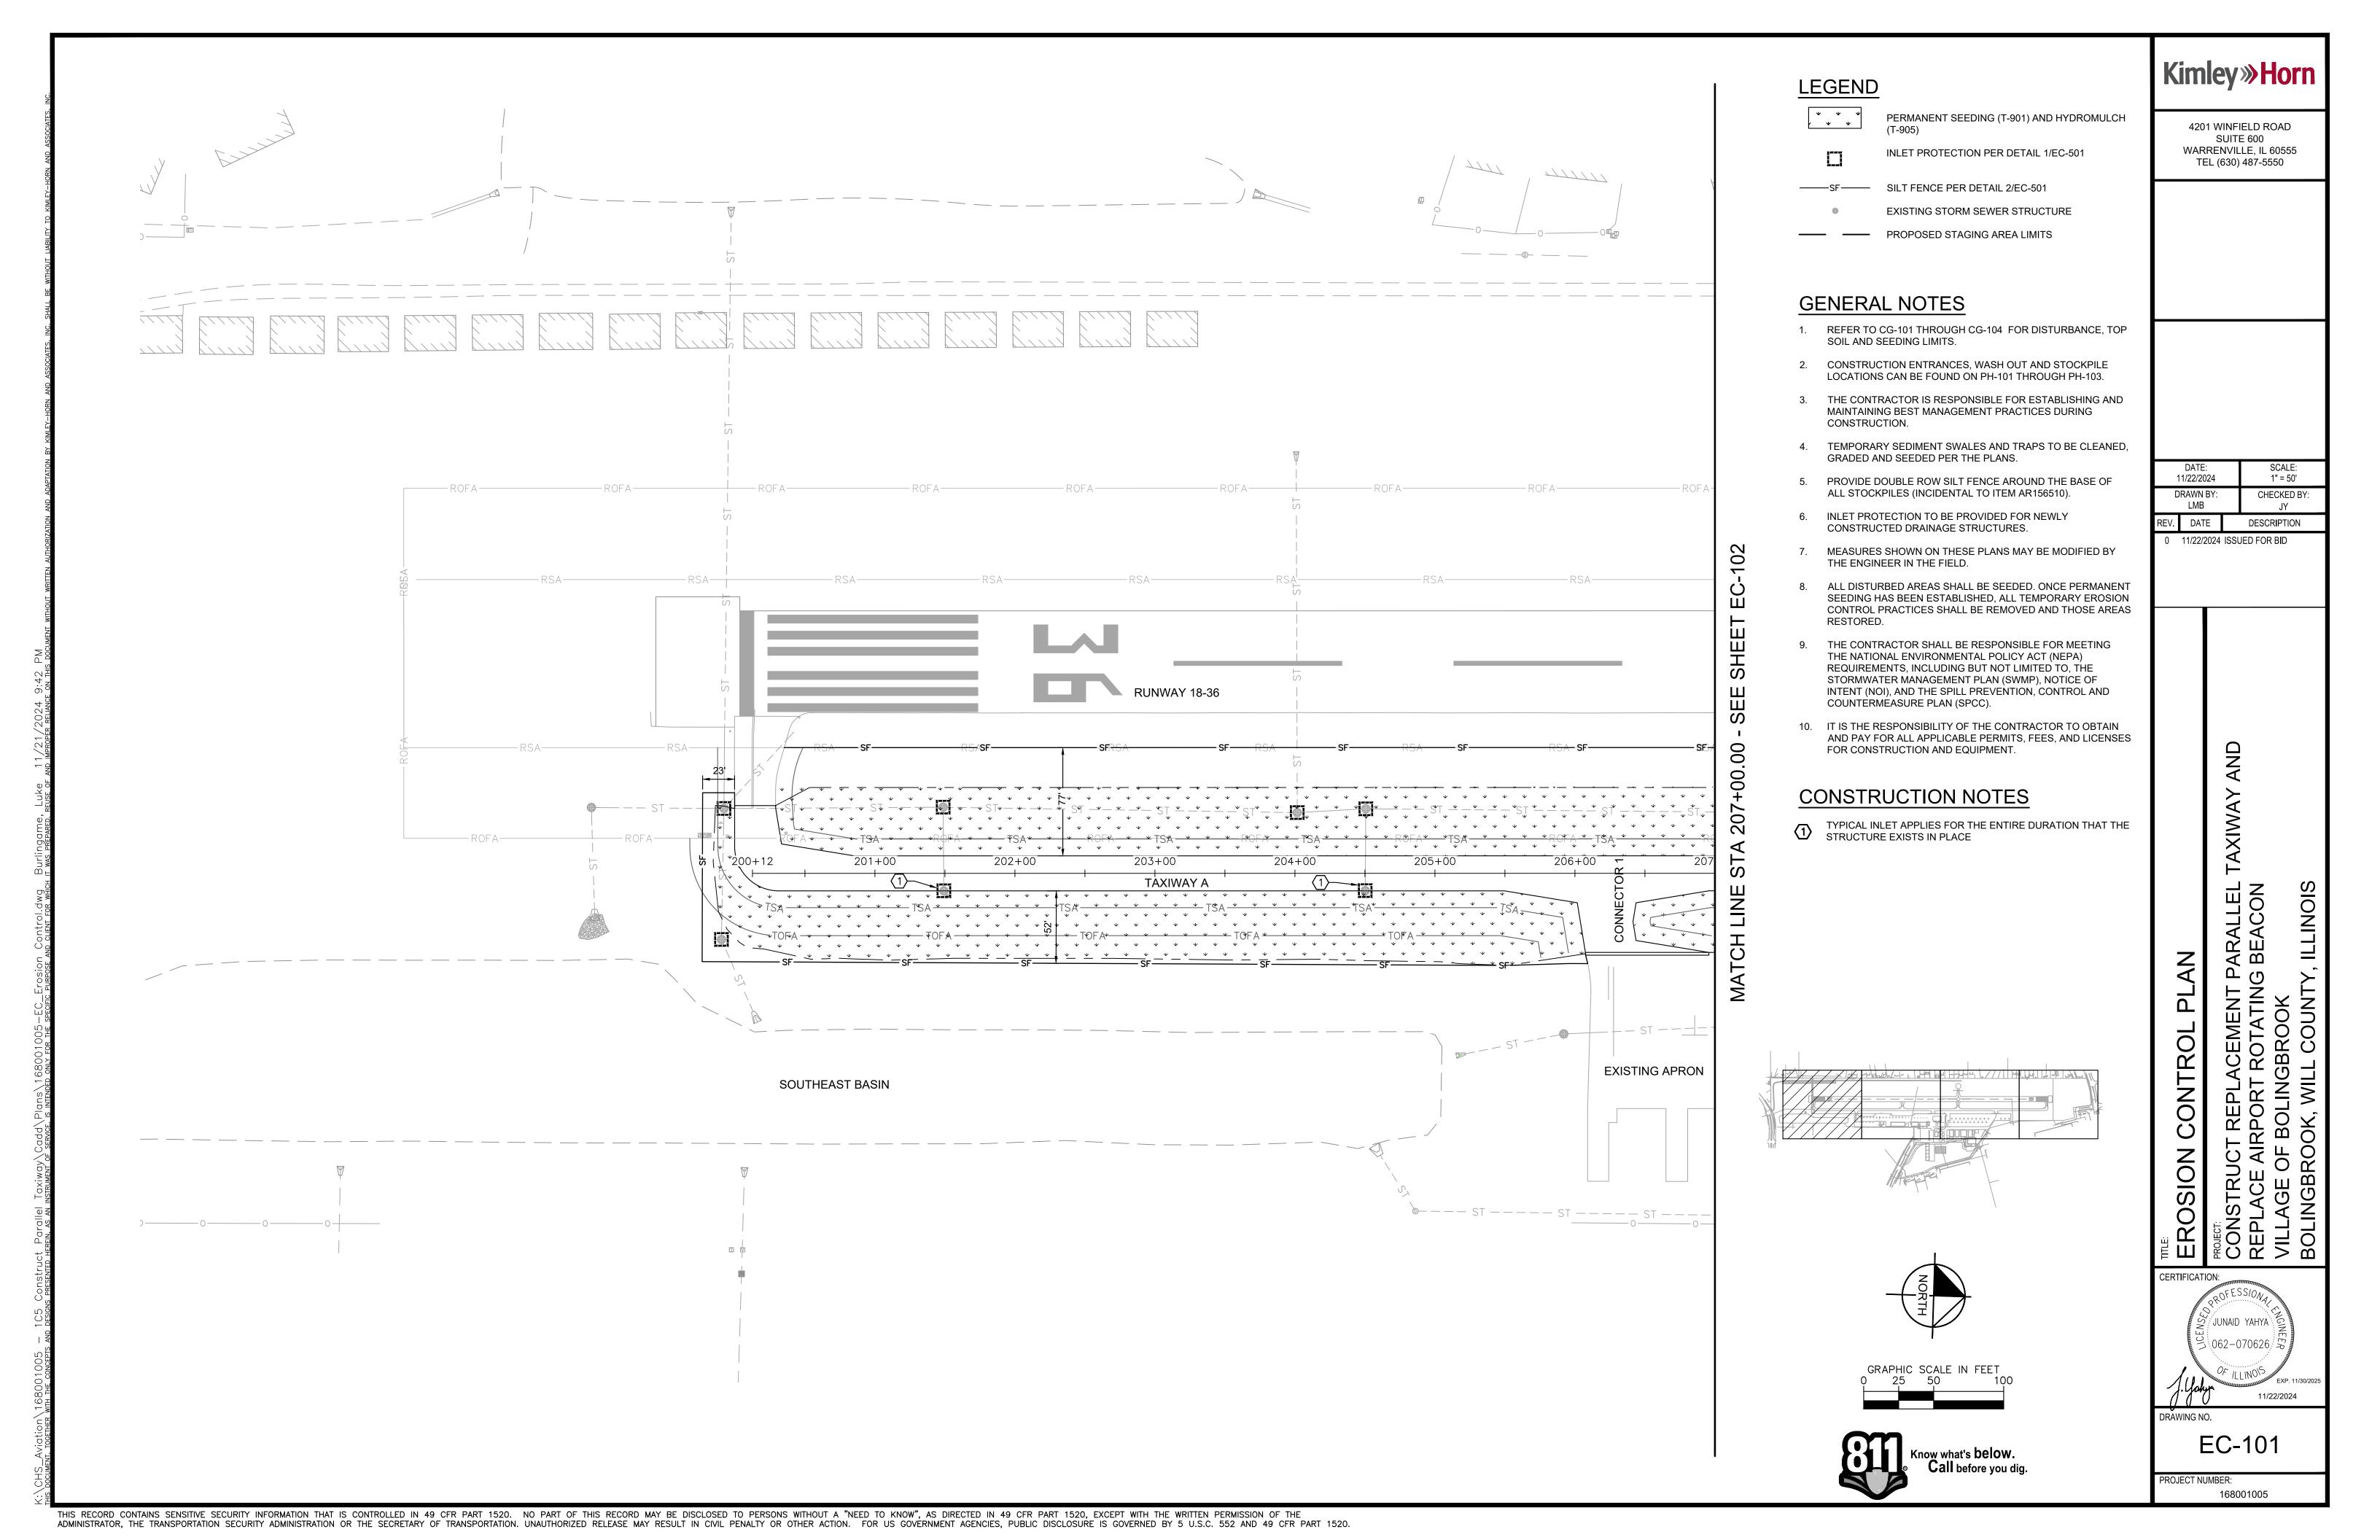
-AXIWAY


CERTIFICATION: RUSSELL MARC BUMANGLAG ら 062-076839 *与* 11/22/2024


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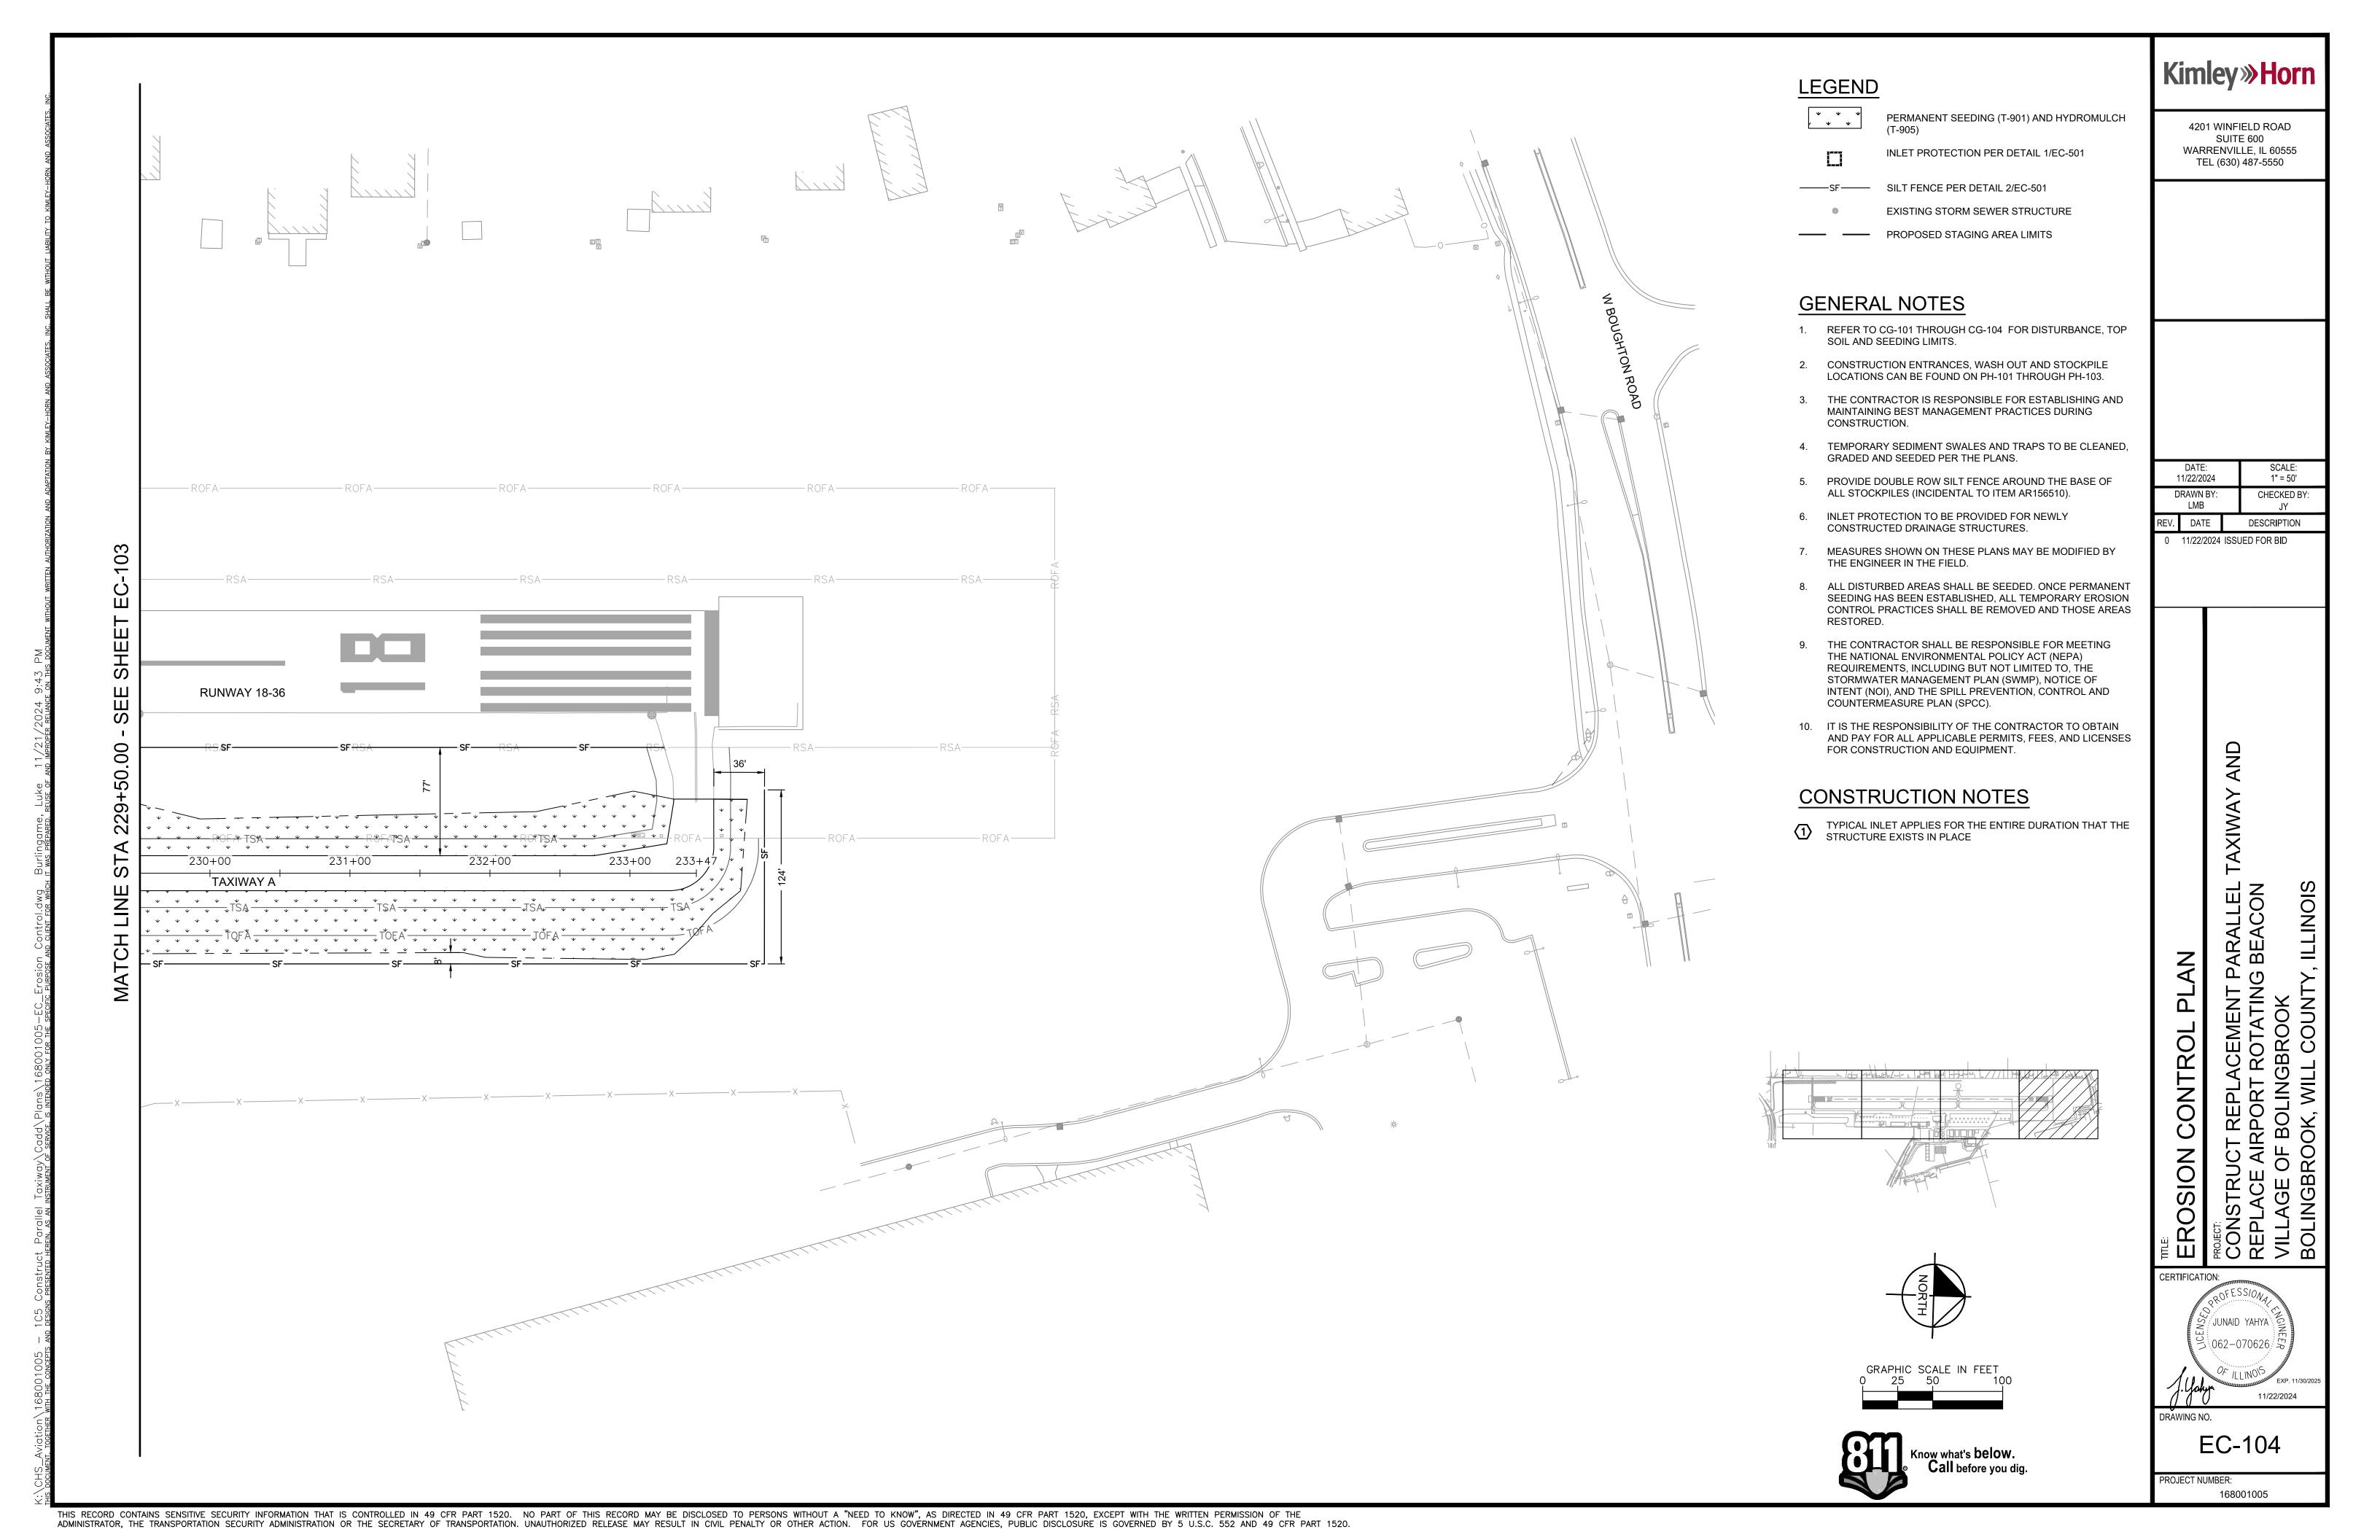
UD-502 PROJECT NUMBER:

168001005





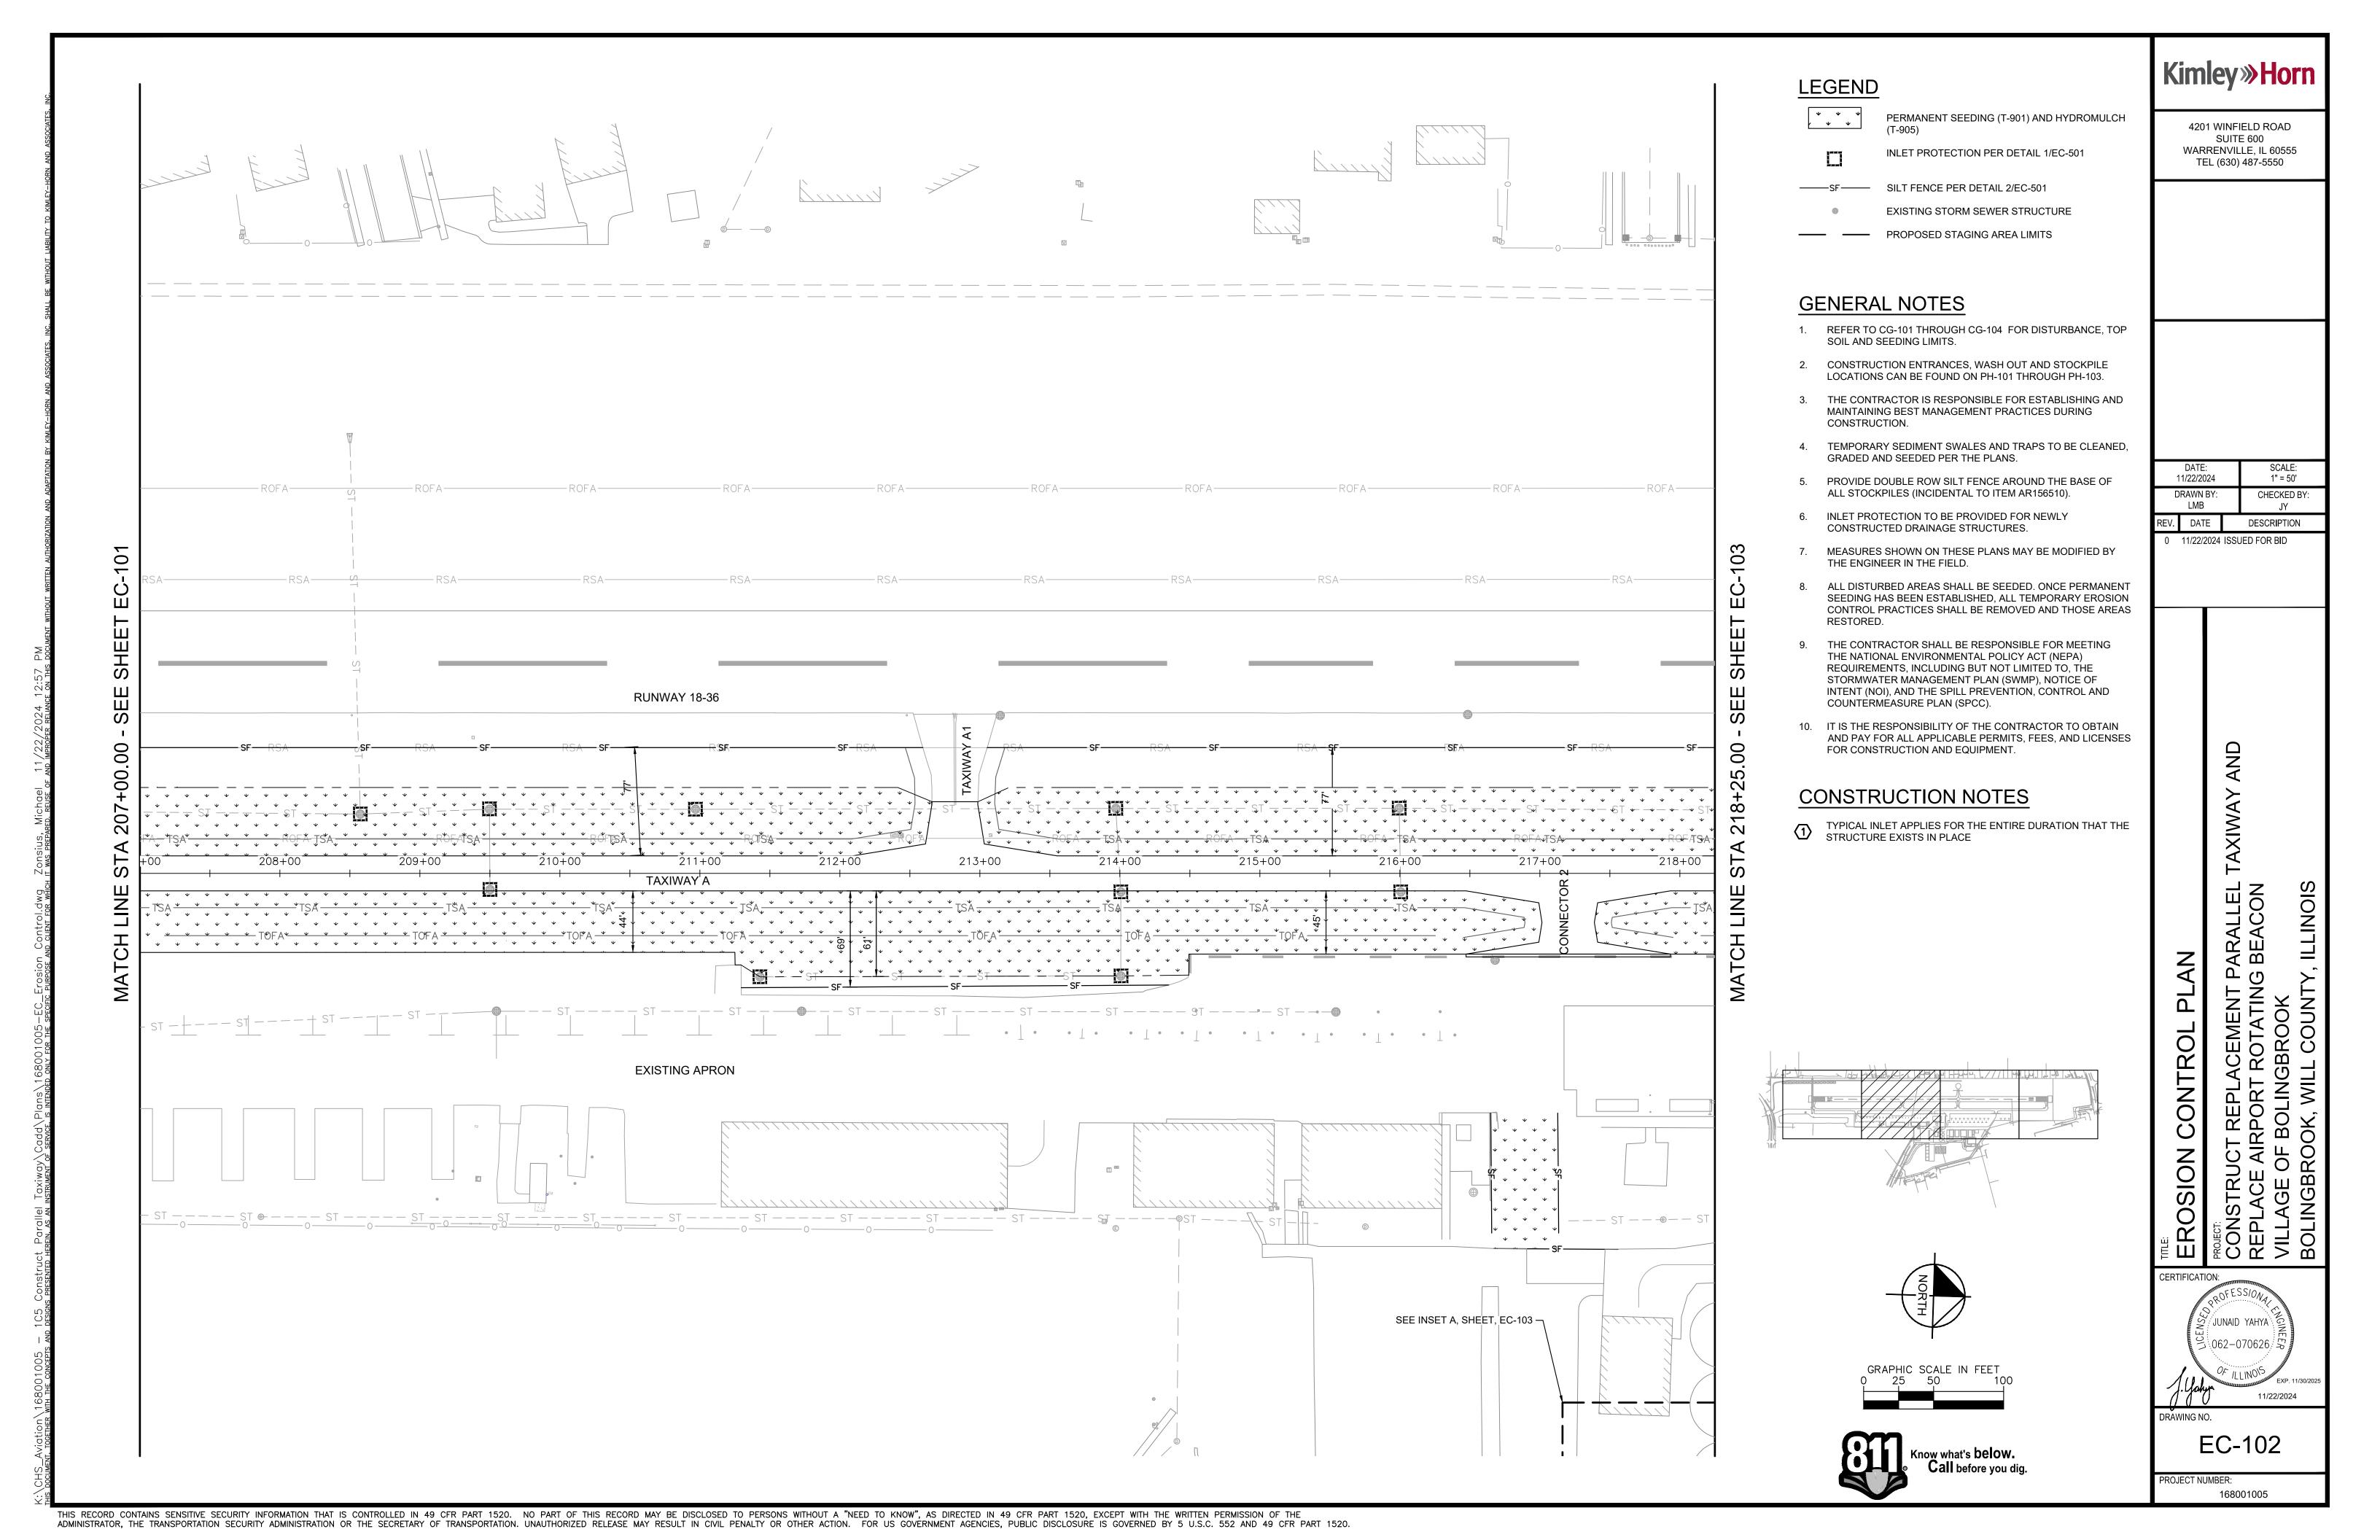

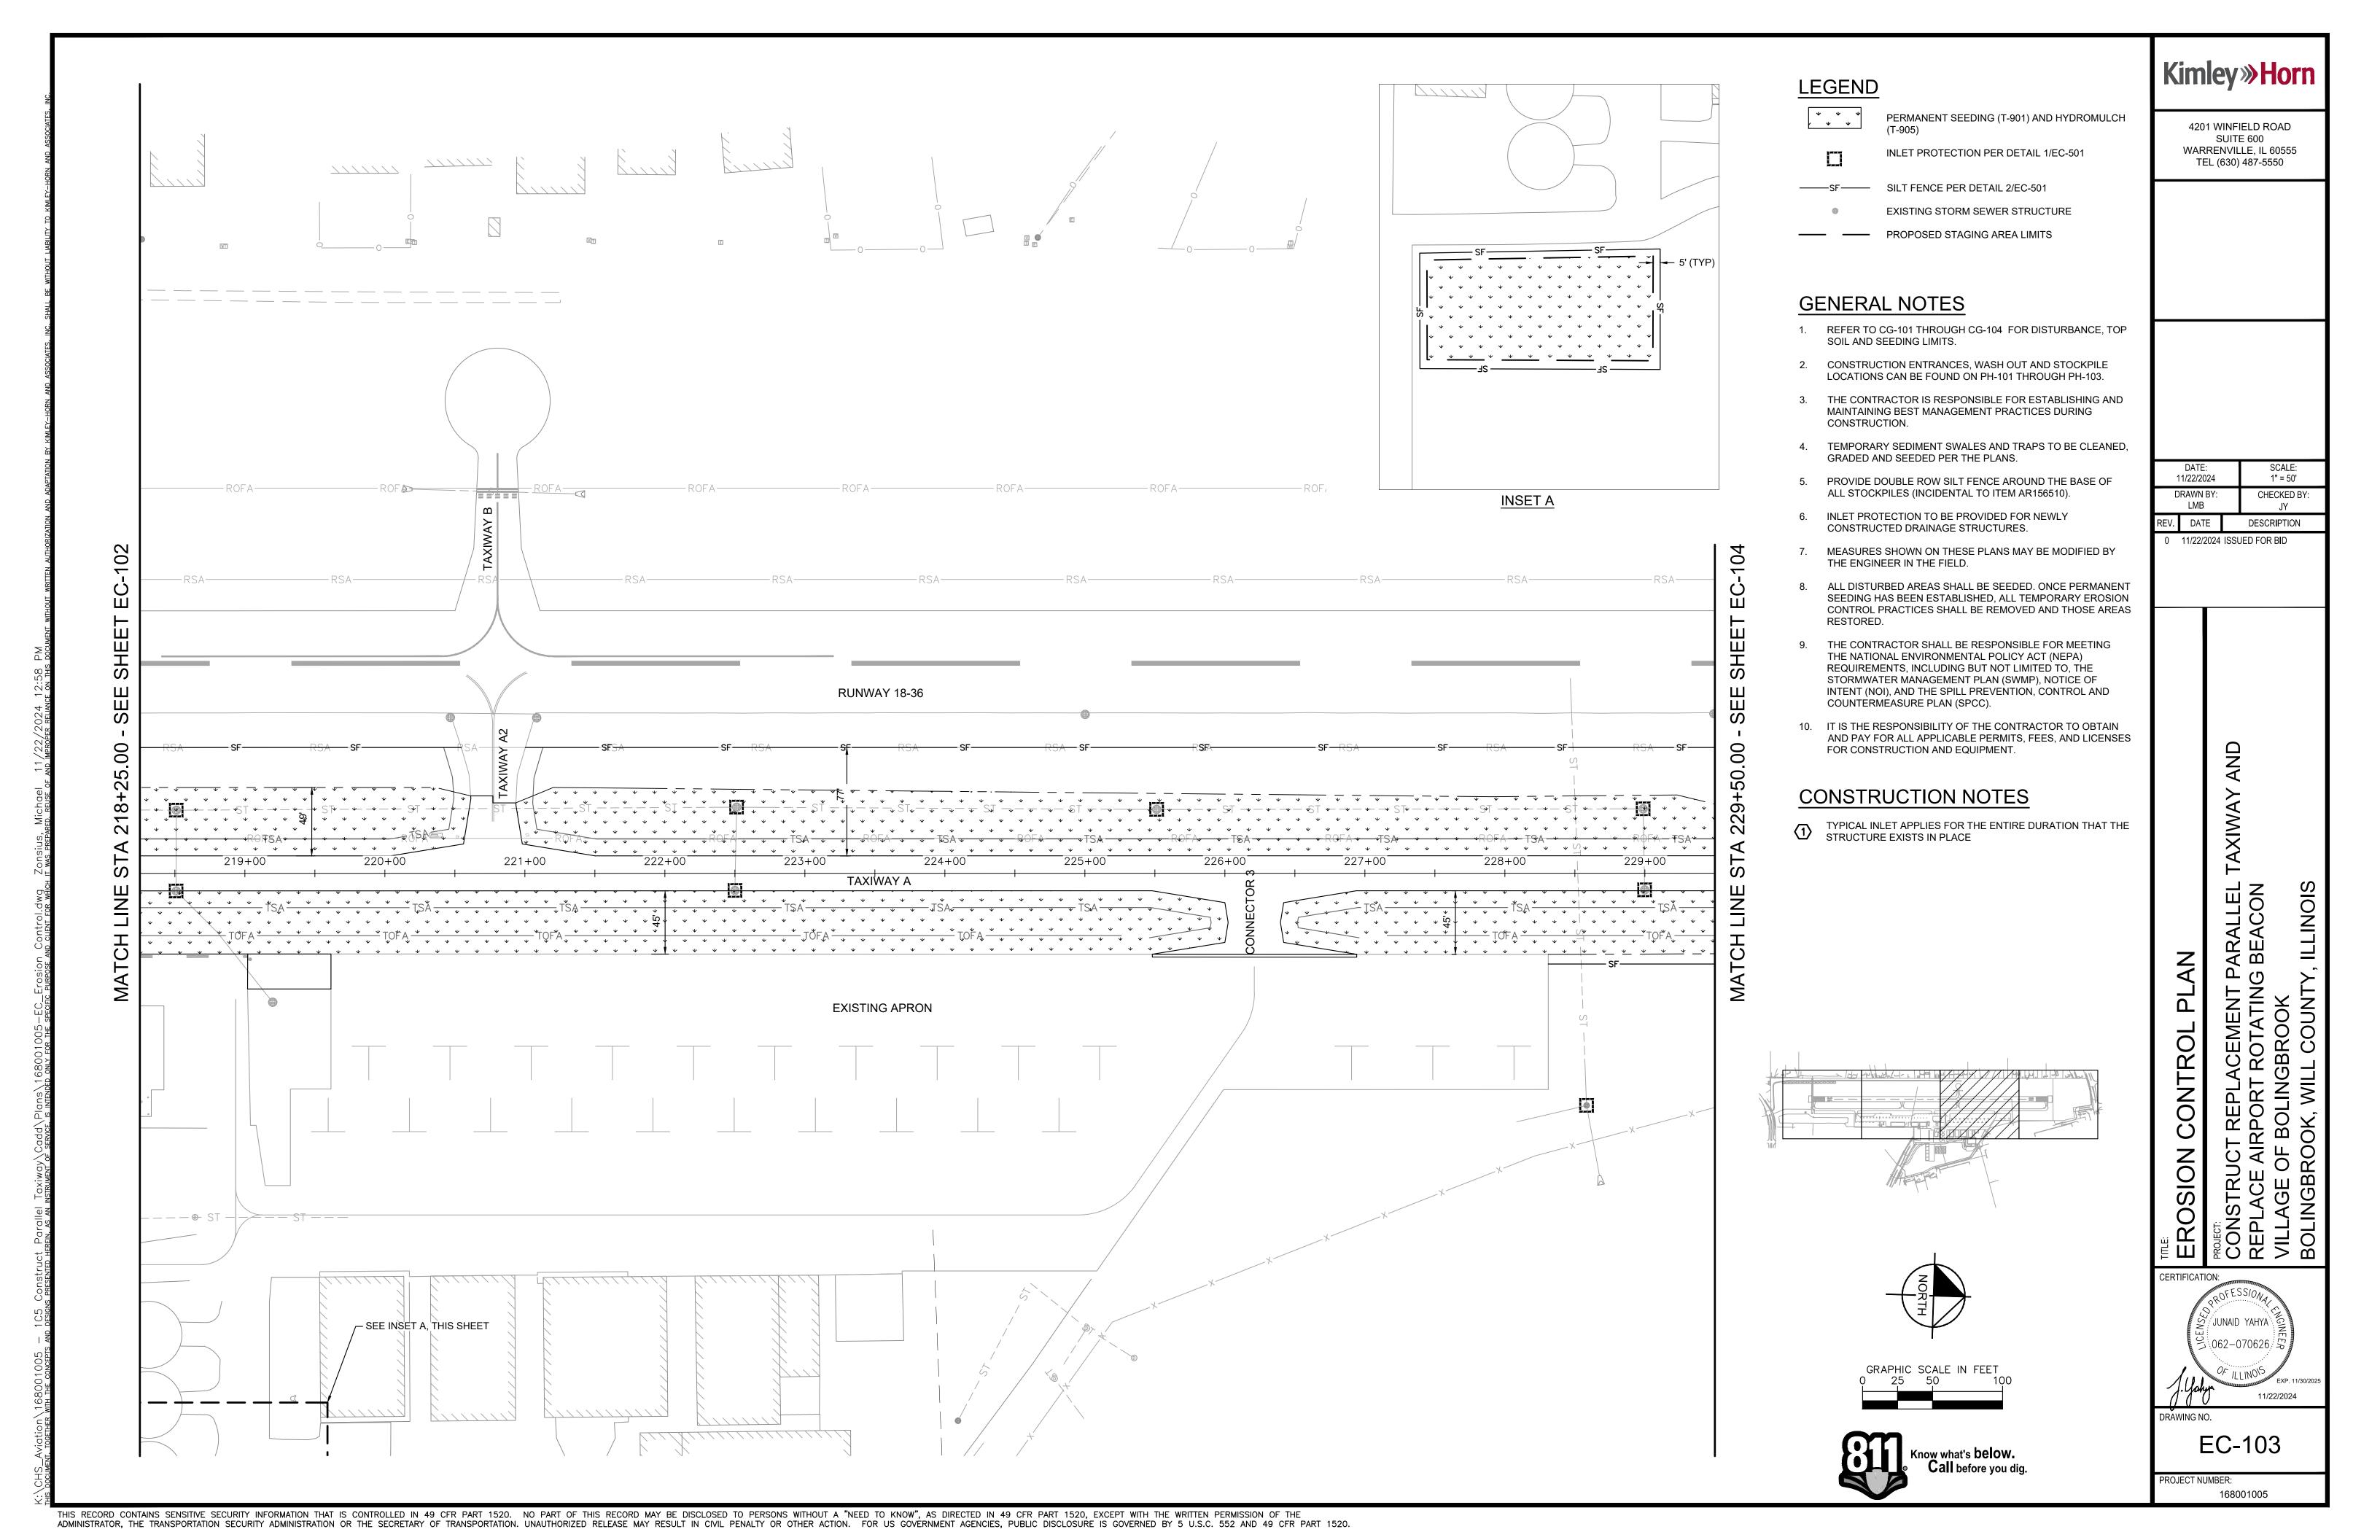

### STORMWATER POLLUTION PREVENTION PLAN

THIS PLAN HAS BEEN PREPARED TO ESTABLISH AND IMPLEMENT TEMPORARY EROSION CONTROL SYSTEMS WITHIN THE PROJECT TO PROVIDE A STORM WATER POLLUTION PREVENTION PLAN TO COMPLY WITH NPDES REQUIREMENTS.

### SITE DESCRIPTION:

THE SITE CONSISTS OF AN EXISTING AIRCRAFT TAXIWAY AREA MADE OF HMA PAVEMENT AND GRASS INFIELD

- 1. ESTIMATED AREA OF DISTURBANCE = 9.46 ACRES
- 2. SEQUENCE OF CONSTRUCTION ACTIVITIES MAY BE AS FOLLOWS:
- INSTALL PERIMETER EROSION BARRIER AND INLET PROTECTION
- CONSTRUCT CONCRETE WASHOUTS AT CONSTRUCTION ENTRANCES AND STAGING AREAS
- COMMENCE SITE APPROVAL/EXCAVATION FOR TAXIWAY
- STOCKPILE AND SCREEN EXCAVATED SOIL FOR POTENTIAL CONTAMINATION WITHIN TAXIWAY
  CONSTRUCTION AREAS.
- CONSTRUCT ASSOCIATED WORK WITHIN TAXIWAY CONSTRUCTION AREA
- PLACE FINAL EROSION CONTROL AND SEEDING MEASURES
- REMOVE CONTAMINATED SOILS FROM SITE
- RESTORE STAGING AREA TO ITS ORIGINAL STATE
- REMOVE PERIMETER EROSION BARRIERS, CONCRETE WASHOUT AREAS AND ANY ADDITIONAL
- TEMPORARY EROSION CONTROL MEASURES WITHIN THE PROJECT SITE

### STORM WATER POLLUTION PREVENTION NOTES:

### GENERAL:

- 1. THE CONTRACTOR SHALL IMPLEMENT ALL PROVISIONS OF THE CONTRACT DOCUMENTS TO ASSURE THAT STORM WATER POLLUTION PREVENTION ITEMS ARE CONSTRUCTED AND MAINTAINED IN A TIMELY MANNER. SEDIMENTATION MUST NOT BE TRANSPORTED OFF THE CONSTRUCTION SITE. PERMANENT DRAINAGE FEATURES AND VEGETATIVE MEASURES SHALL BE PROVIDED AS SOON AS POSSIBLE.
- 2. THE MAINTENANCE AND RELOCATION OF ALL STORM WATER POLLUTION PREVENTION MEASURES ARE INCIDENTAL TO THE ASSOCIATE PAY ITEM.

### POLLUTION PREVENTION MEASURES:

1. THE CONTRACTOR SHALL BE REQUIRED TO IMPLEMENT AND MAINTAIN STORM WATER POLLUTION PREVENTION PRACTICES AND MEASURES PRIOR TO STRIPPING OF EXISTING VEGETATION WHENEVER POSSIBLE AND AS CONSTRUCTION PERMITS IN OTHER AREAS.

# FRAME OPENING SIZE TO MATCH INLET OPENING. BAG TO BE PLACED OVER INLET OPENING GRATE LIFT STRAPS COMMERCIALLY AVAILABLE WOVEN FABRIC SILT BAG SECURED TO CASTING INSERT OR FRAME DUMPING STRAPS STRAPS


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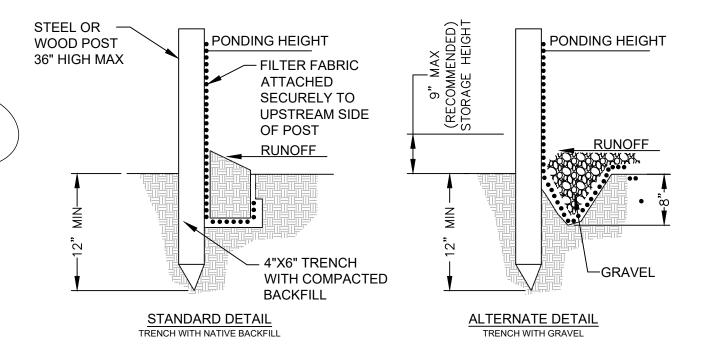
BUILT IN FIELD




### GENERAL NOTES FOR SOIL EROSION AND SEDIMENT CONTROL:

- SEDIMENT CONTROL MEASURES SHALL BE INSTALLED PRIOR TO THE COMMENCEMENT OF HYDROLOGIC DISTURBANCE OF UPLAND AREAS.
- 2. SOIL DISTURBANCE SHALL BE CONDUCTED IN SUCH A MANNER AS TO MINIMIZE EROSION. SOIL STABILIZATION MEASURES SHALL CONSIDER THE TIME OF YEAR, SITE CONDITIONS, AND THE USE OF TEMPORARY OR PERMANENT MEASURES.
- 3. WATER PUMPED OR DISCHARGED FROM THE SITE DURING CONSTRUCTION DEWATERING SHALL BE FILTERED BY AN APPROVED MEANS.
- 4. ALL DISTURBED AREAS SHALL BE STABILIZED WITH TEMPORARY OR PERMANENT EROSION CONTROL MEASURES WITHIN 7 CALENDAR DAYS OF DISTURBANCE.
- 5. EMBANKMENTS WITH SLOPES GREATER THAN OR EQUAL TO 3:1 SHALL BE STABILIZED WITH SOD, MAT OR BLANKET WITH SEEDING.
- 6. EROSION CONTROL BLANKET SHALL BE REQUIRED ON ALL DISTURBED AREAS.
- 7. ALL FUNCTIONING STORM SEWERS WITHIN THE CONSTRUCTION SITE SHOULD BE PROTECTED BY EROSION CONTROL MEASURES.
- 8. THE CONTRACTOR SHALL PROVIDE AREAS TO WASHOUT PAVING EQUIPMENT AND FINISHING TOOLS. ALL WASTE WATER AND EXCESS PAVEMENT MATERIALS SHALL BE CONTAINED BY AN APPROVED CONCRETE WASHOUT FACILITY.
- 9. ALL PERMANENT AND TEMPORARY EROSION CONTROL MEASURES SHOULD BE MAINTAINED TO THE APPROVAL OF THE ENGINEER AND AIRPORT MANAGER.
- 10. SOIL STOCKPILES SHOULD BE LIMITED TO LOCATIONS SHOWN IN THE PLANS AND SHALL NOT ENCROACH ON TAXIWAY OR RUNWAY SAFETY AREAS OR OBJECT FREE ZONES.
- 11. EROSION CONTROL MEASURES SHOWN IN THESE PLANS ARE THE MINIMUM REQUIRED BY THE CONTRACTOR. ADDITIONAL EROSION CONTROL MEASURES MAY BE REQUIRED DURING CONSTRUCTION ACTIVITIES AND MUST BE PROVIDED AS DIRECTED AND APPROVED BY THE ENGINEER.
- 12. THE CONTRACTOR SHALL INSPECT ADJACENT STREETS DAILY AND CLEAN ANY SOIL AND DEBRIS WHEN NECESSARY.



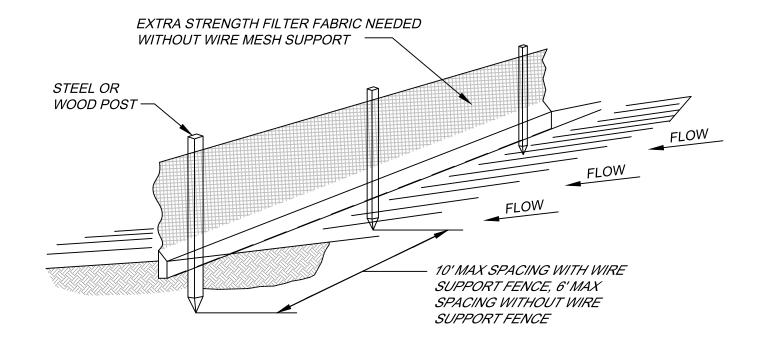

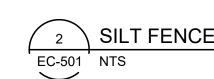

## STANDARD INLET EROSION PROTECTION NOTES:

- 1. CATCH BASIN SEDIMENT TRAPS SHALL BE INSTALLED AND FUNCTIONAL PRIOR TO THE COMMENCEMENT OF ANY DEMOLITION WORK
- 2. THE STRUCTURE SHALL BE INSPECTED WEEKLY AND AFTER EACH STORM EVENT AND REPAIRS MADE AS NEEDED OR AS DIRECTED BY THE ENGINEER.
- 3. CONSTRUCTION OPERATIONS SHALL BE CARRIED OUT IN SUCH A MANNER THAT EROSION AND WATER POLLUTION SHALL BE MINIMIZED.

4. THE TRAP SHALL BE EMPTIED WHEN THE CAPACITY OF THE TRAP

THE ENGINEER.5. THE DRAIN INLET PROTECTION SHALL BE REMOVED AFTER THE

HAS REDUCED TO APPROXIMATELY 50% OR WHEN DIRECTED BY


- REMAINING DRAINAGE AREA HAS BEEN PROPERLY STABILIZED.6. STANDARD INLET EROSION PROTECTION (SAND BAG) SHALL BE PAID FOR UNDER PAY ITEM AR156520.
- 7. STANDARD INLET EROSION PROTECTION SHALL MEET THE REQUIREMENTS SET FORTH IN SPECIFICATION C-102.

# SILT FENCE NOTES:

- 1. THE SILT FENCE SHALL BE INSPECTED WEEKLY AND AFTER EACH STORM EVENT AND REPAIRS MADE AS NEEDED OR AS DIRECTED BY THE ENGINEER.
- 2. PREASSEMBLED SILT FENCING AS MANUFACTURED FOR THIS PURPOSE SHALL BE ACCEPTABLE IN LIEU OF A FIELD CONSTRUCTED SILT FENCE UPON APPROVAL BY THE ENGINEER.
- FILTER CLOTH SHALL HAVE APPROVED BACKING OR A BUILT IN REINFORCED STRUCTURE, AS RECOMMENDED BY THE MANUFACTURER TO SUPPORT THE FILTER CLOTH.
- 4. SILT FENCE SHALL BE CONSTRUCTED AT LOCATIONS AS SHOWN ON PLANS OR WHERE DIRECTED BY THE ENGINEER.
- 5. THE CONTRACTOR SHALL MAINTAIN THE SILT FENCES DURING THE LIFE OF THE CONTRACT. SILT ACCUMULATIONS SHALL BE CHECKED WEEKLY AND REMOVED BY THE CONTRACTOR AS DEFINED BELOW. THE FENCES SHALL REMAIN IN PLACE UNTIL SUCH TIME THAT A SUFFICIENT STAND OF GRASS HAS BEEN ESTABLISHED TO PREVENT FURTHER SOIL EROSION AS APPROVED BY THE ENGINEER. REMOVE SEDIMENTATION FROM BEHIND SILT FENCES WHEN IT REACHED 1/3 THE HEIGHT OF THE FENCE, ONCE THIS STAND OF GRASS HAS BEEN ACHIEVED TO SATISFACTION OF THE DESIGNER. THE CONTRACTOR SHALL REMOVE AND DISPOSE OF THE SILT FENCE OFF AIRPORT PROPERTY.
- 6. INSTALLATION AND REMOVAL OF SILT FENCE SHALL BE PAID FOR UNDER PAY ITEM AR156510.
- 7. INSTALLATION AND REMOVAL OF SILT FENCE SHALL MEET THE REQUIREMENTS SET FORTH IN C-102.

### MAINTENANCE AND RESTORATION REQUIREMENTS

- 1. SWEEP ALL AFFECTED PAVEMENTS DAILY OR AS DIRECTED BY THE OWNER OR DESIGNER TO REMOVE ACCUMULATED CONSTRUCTION WASTE PRODUCTS.
- 2. INSPECT ALL EROSION CONTROLS WEEKLY AND WITHIN 24 HOURS AFTER A STORM EVENT AND RECORD IN AN INSPECTION LOG BOOK.
- 3. STABILIZE ALL DISTURBED AREA WITHIN 5 DAYS OF FINAL GRADING.
- 4. REMOVE SEDIMENT FROM STORM DRAINAGE SYSTEM AFTER STABILIZATION AND PRIOR TO FINAL ACCEPTANCE.
- REMOVE TEMPORARY EROSION AND SEDIMENT CONTROLS AT THE COMPLETION OF CONSTRUCTION.

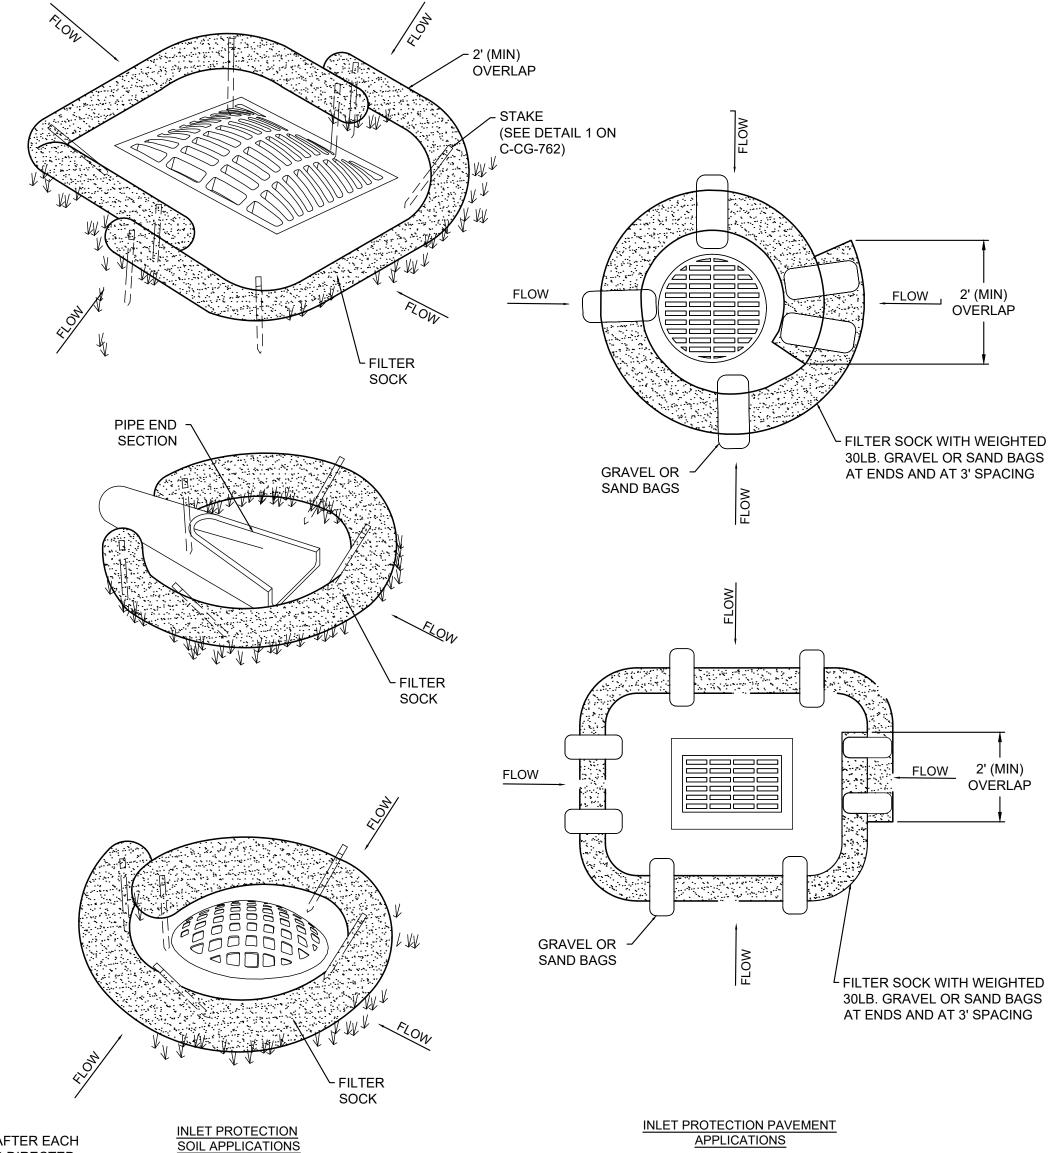

TEMPORARY INLET
PROTECTION, FILTER SOCK

BC-501 NTS

Kimley»Horn

4201 WINFIELD ROAD SUITE 600 WARRENVILLE, IL 60555 TEL (630) 487-5550

DATE: SCALE: NTS

11/22/2024 NTS

DRAWN BY: CHECKED BY: JY

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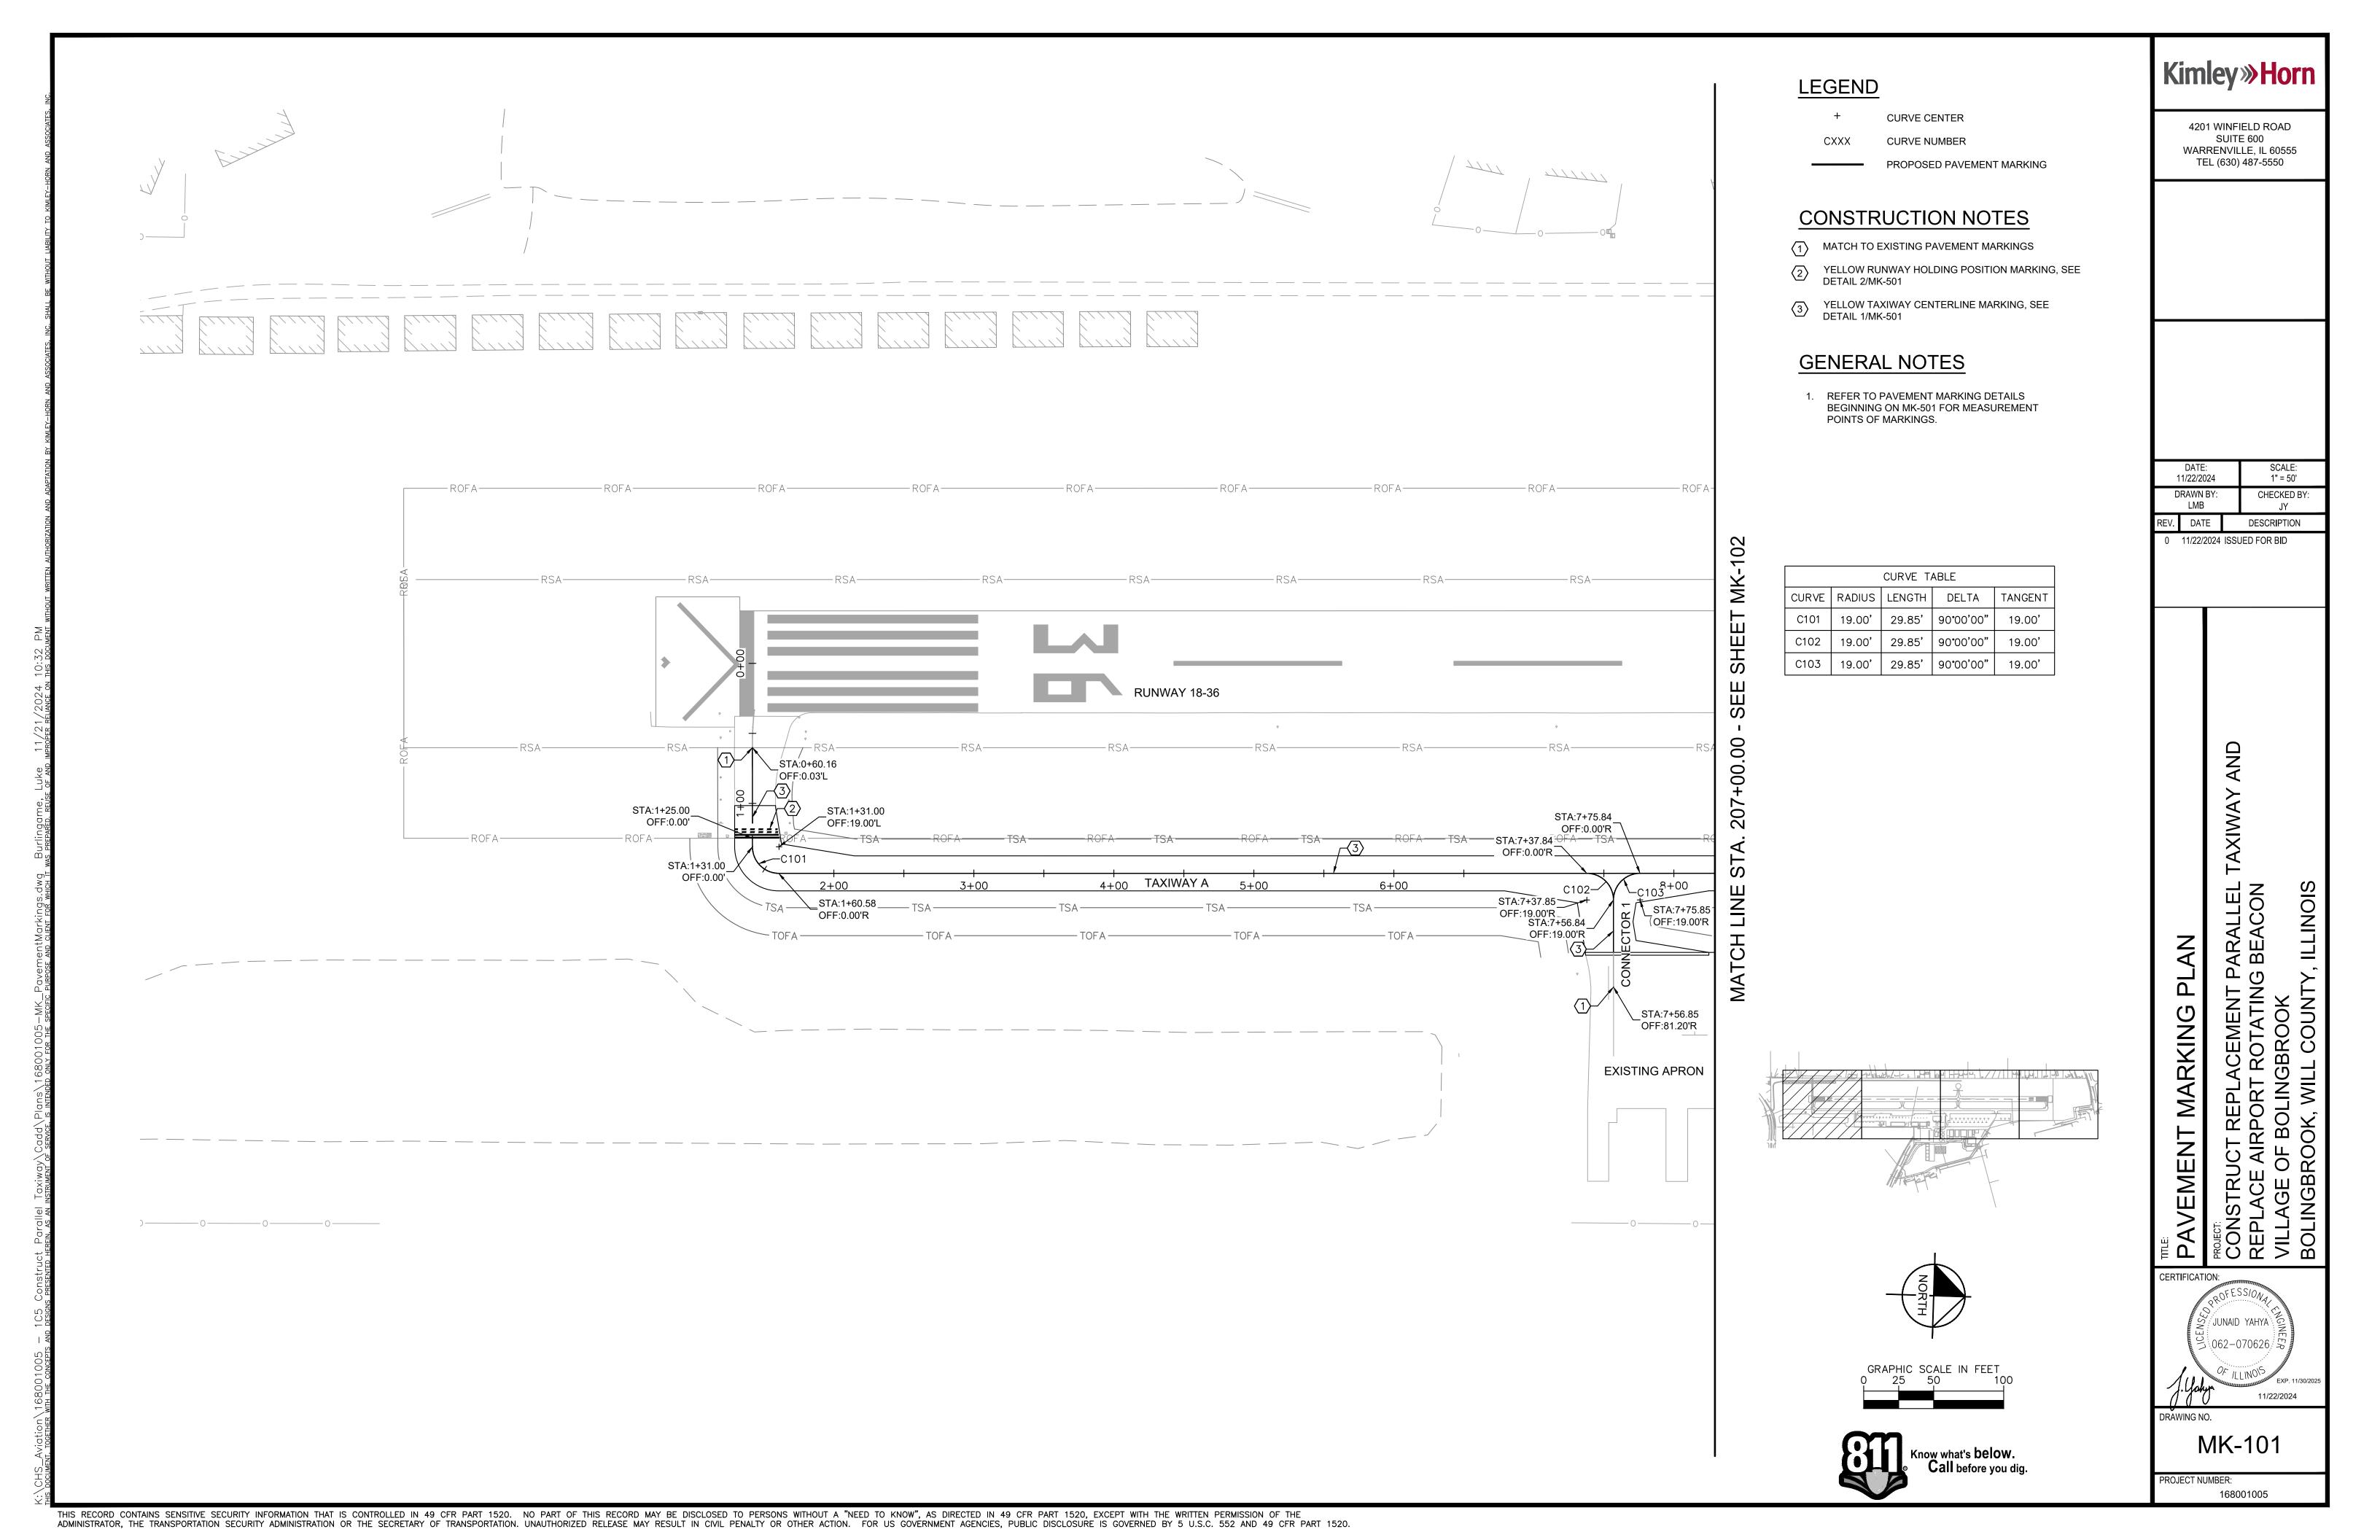
CERTIFICATION:


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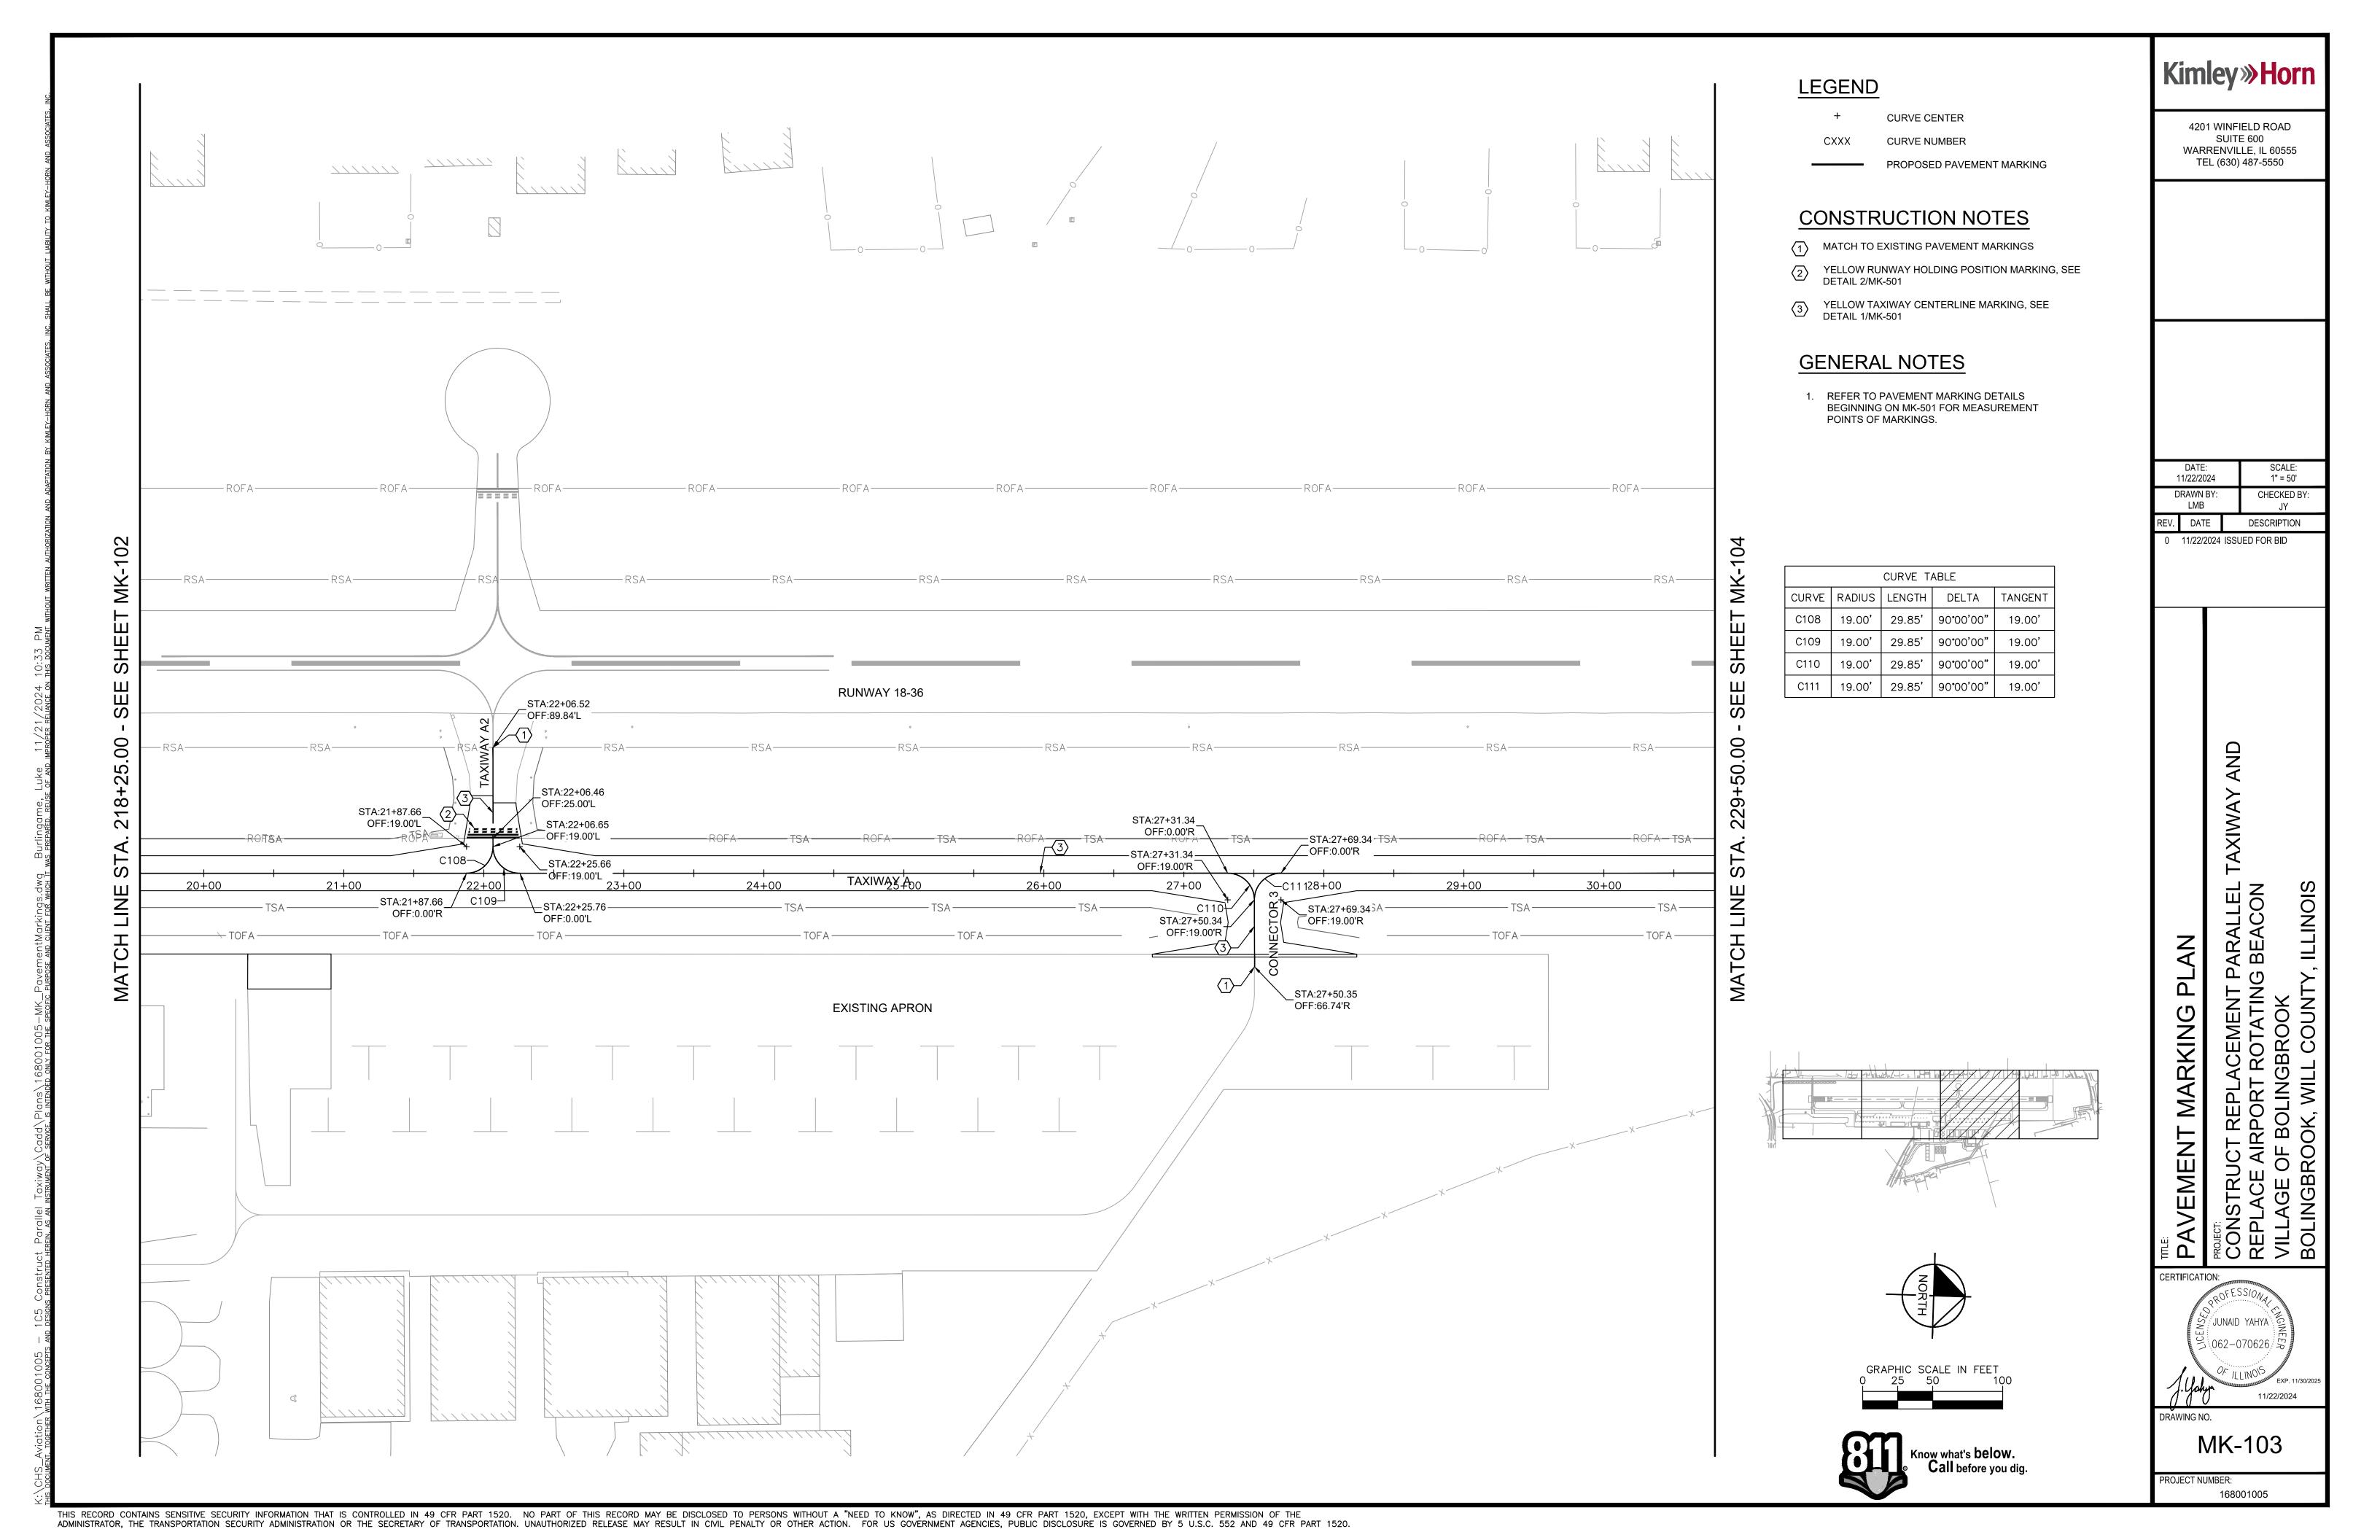
AND SOR STATE OF LLINO


EC-501

PROJECT NUMBER: 168001005






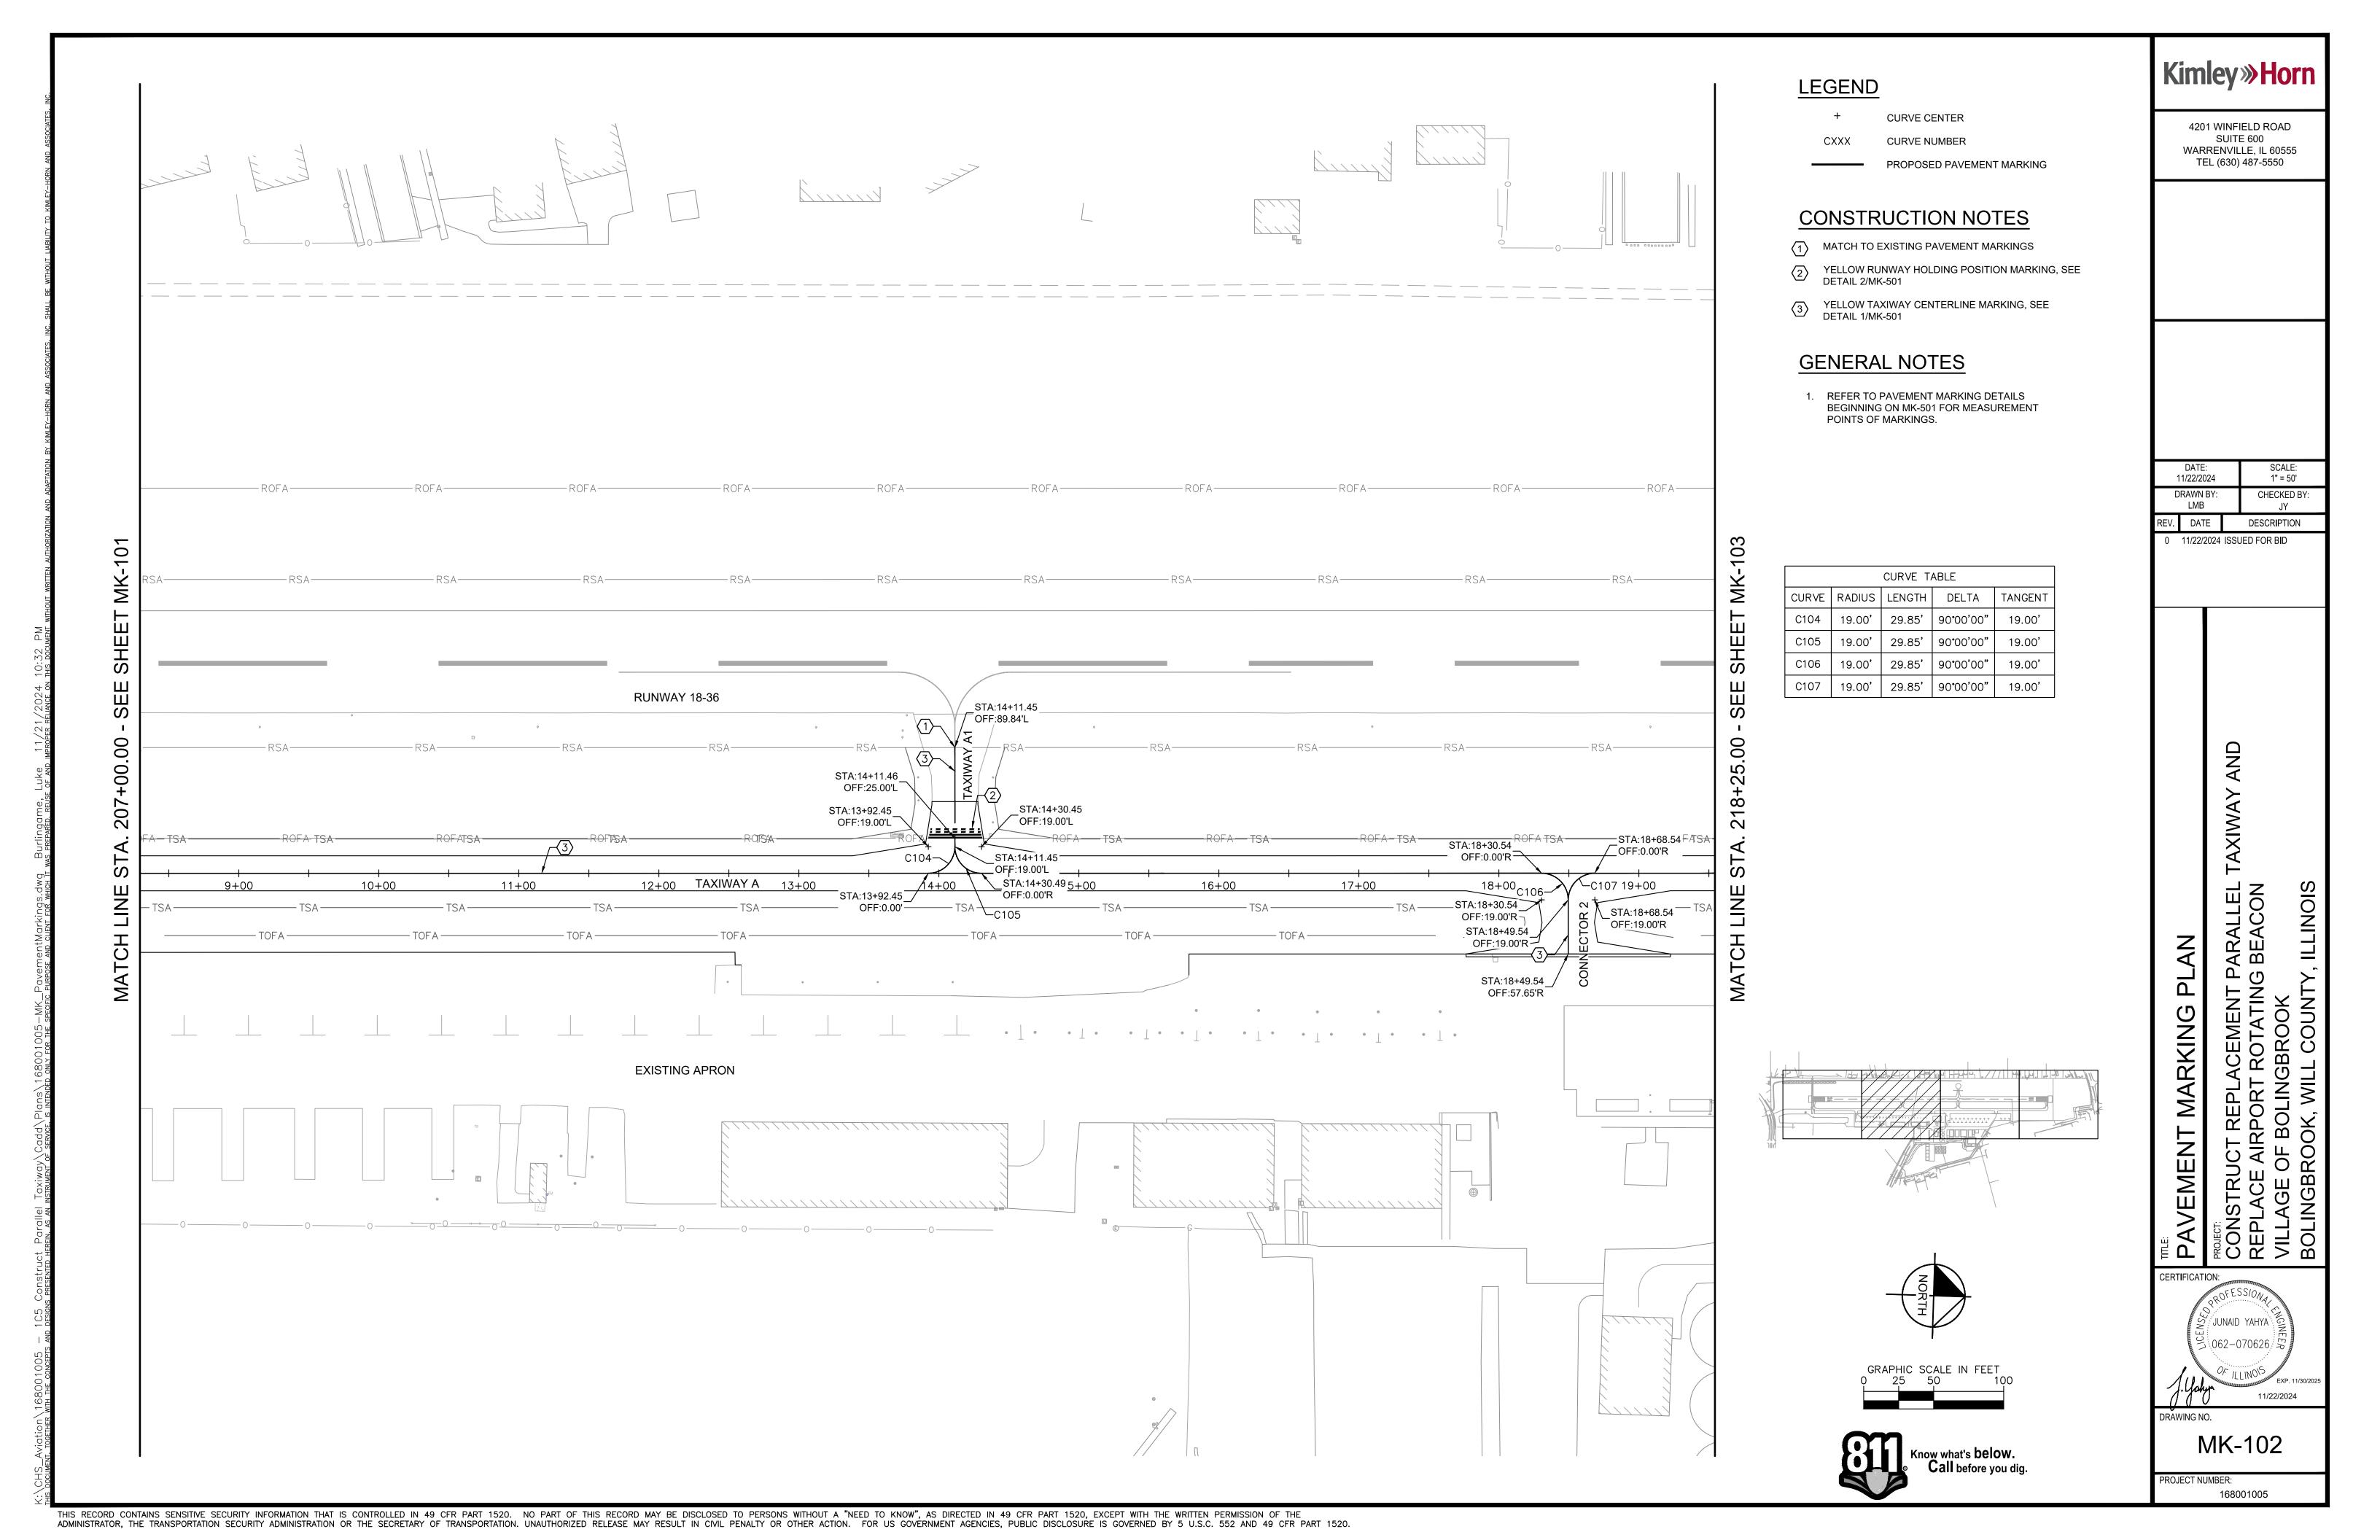

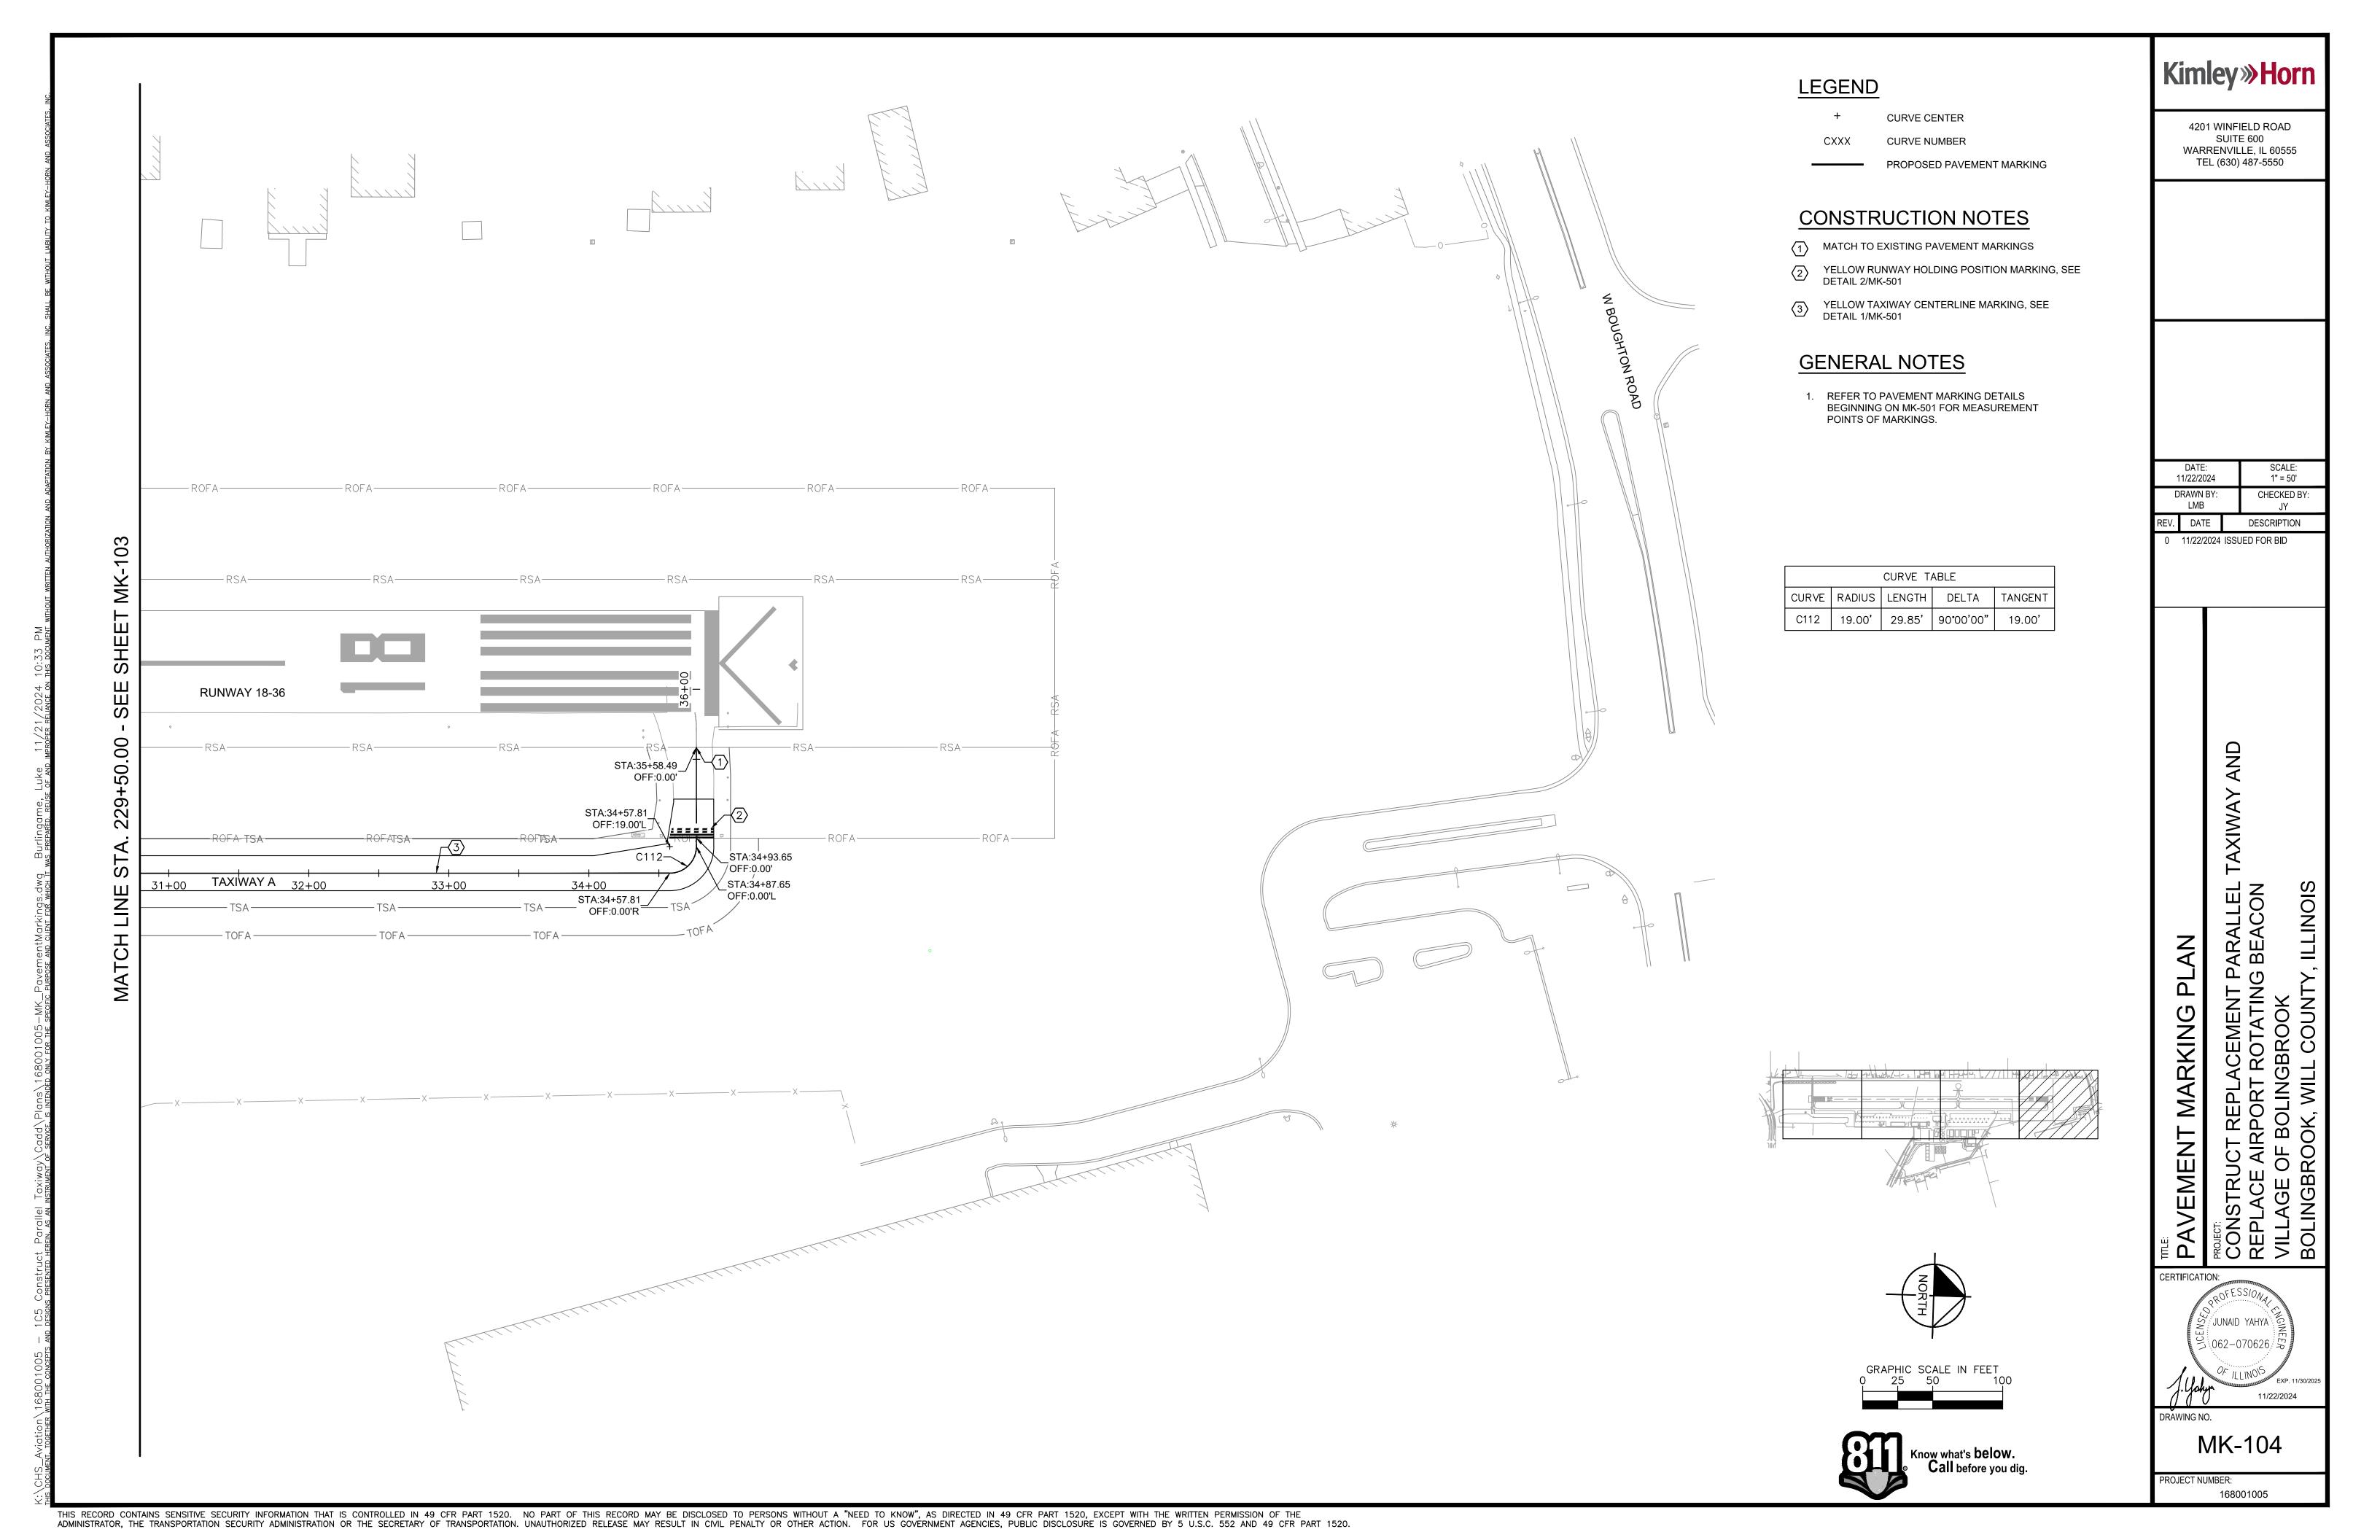



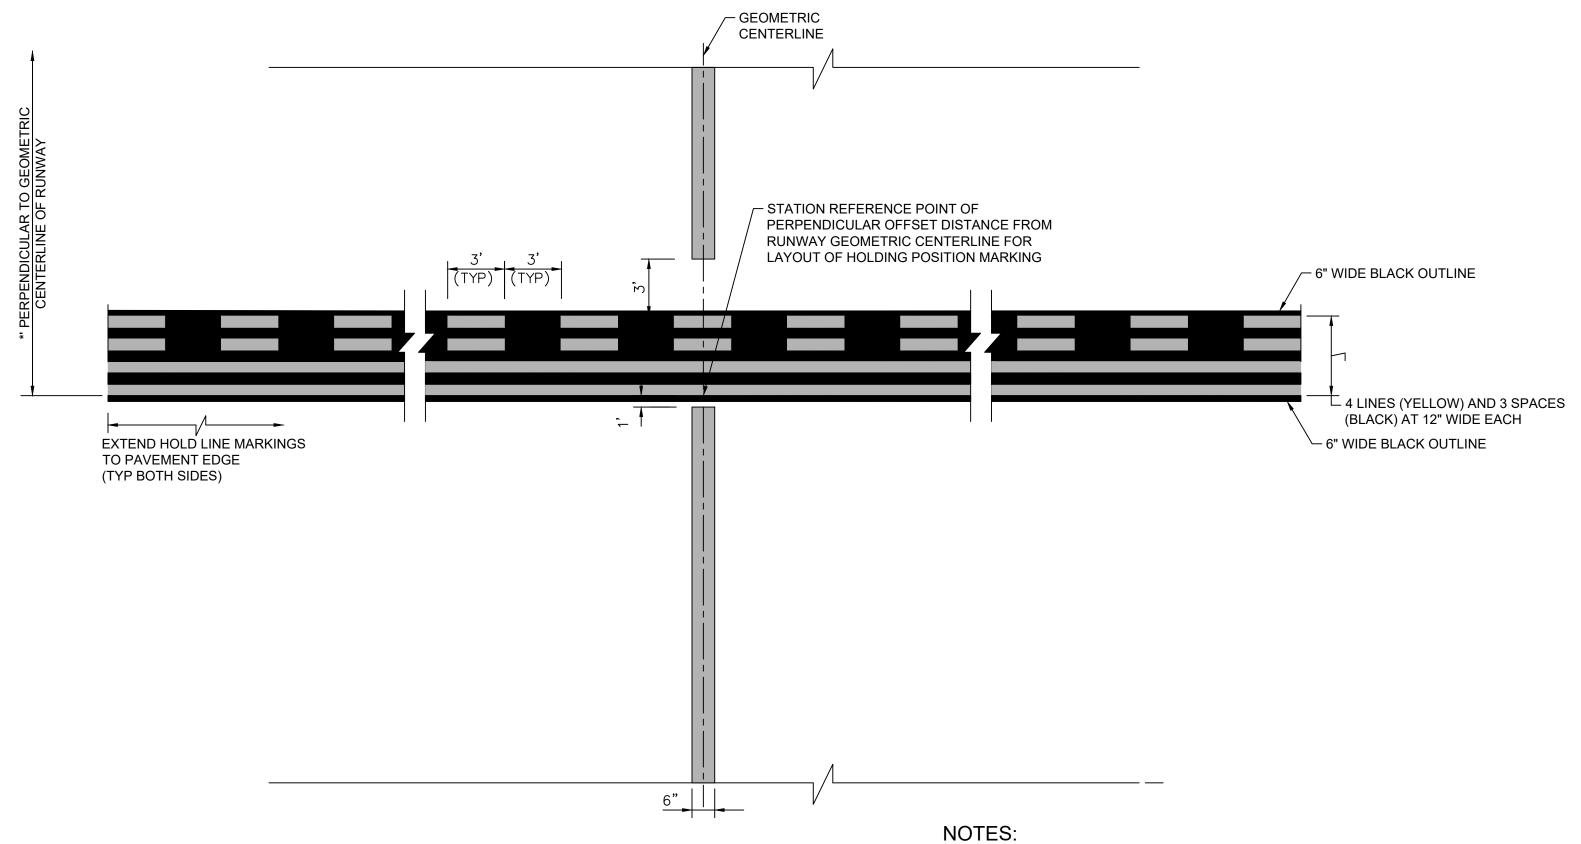

2 RUNWAY HOLDING POSITION MARKING

- 1. IF THE HOLD POSITION MARKING AND TAXIWAY CENTERLINE ARE NOT PERPENDICULAR TO EACH OTHER, THEN THE DISTANCE SHOULD BE MEASURED FROM THE CENTER OF TAXIWAY CENTERLINE TO NEAREST CORNER OF THE SURFACE PAINTED HOLDING POSITION SIGN (SEE ADVISORY CIRCULAR 150/5340-1, LATEST EDITION).
- 2. \* PER FAA AC 150/5300-13B, TABLE 4-2, RUNWAY HOLDING POSITION DIMENSIONS.

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SCALE: NTS DATE: 11/22/2024 CHECKED BY: REV. DATE DESCRIPTION 0 11/22/2024 ISSUED FOR BID


AXIWAY AND

CERTIFICATION: 11/22/2024 DRAWING NO.

> MK-501 PROJECT NUMBER:

> > 168001005

THIS RECORD CONTAINS SENSITIVE SECURITY INFORMATION THAT IS CONTROLLED IN 49 CFR PART 1520. NO PART OF THIS RECORD MAY BE DISCLOSED TO PERSONS WITHOUT A "NEED TO KNOW", AS DIRECTED IN 49 CFR PART 1520, EXCEPT WITH THE WRITTEN PERMISSION OF THE ADMINISTRATION, THE TRANSPORTATION SECURITY ADMINISTRATION OR THE SECRETARY OF TRANSPORTATION. UNAUTHORIZED RELEASE MAY RESULT IN CIVIL PENALTY OR OTHER ACTION. FOR US GOVERNMENT AGENCIES, PUBLIC DISCLOSURE IS GOVERNED BY 5 U.S.C. 552 AND 49 CFR PART 1520.

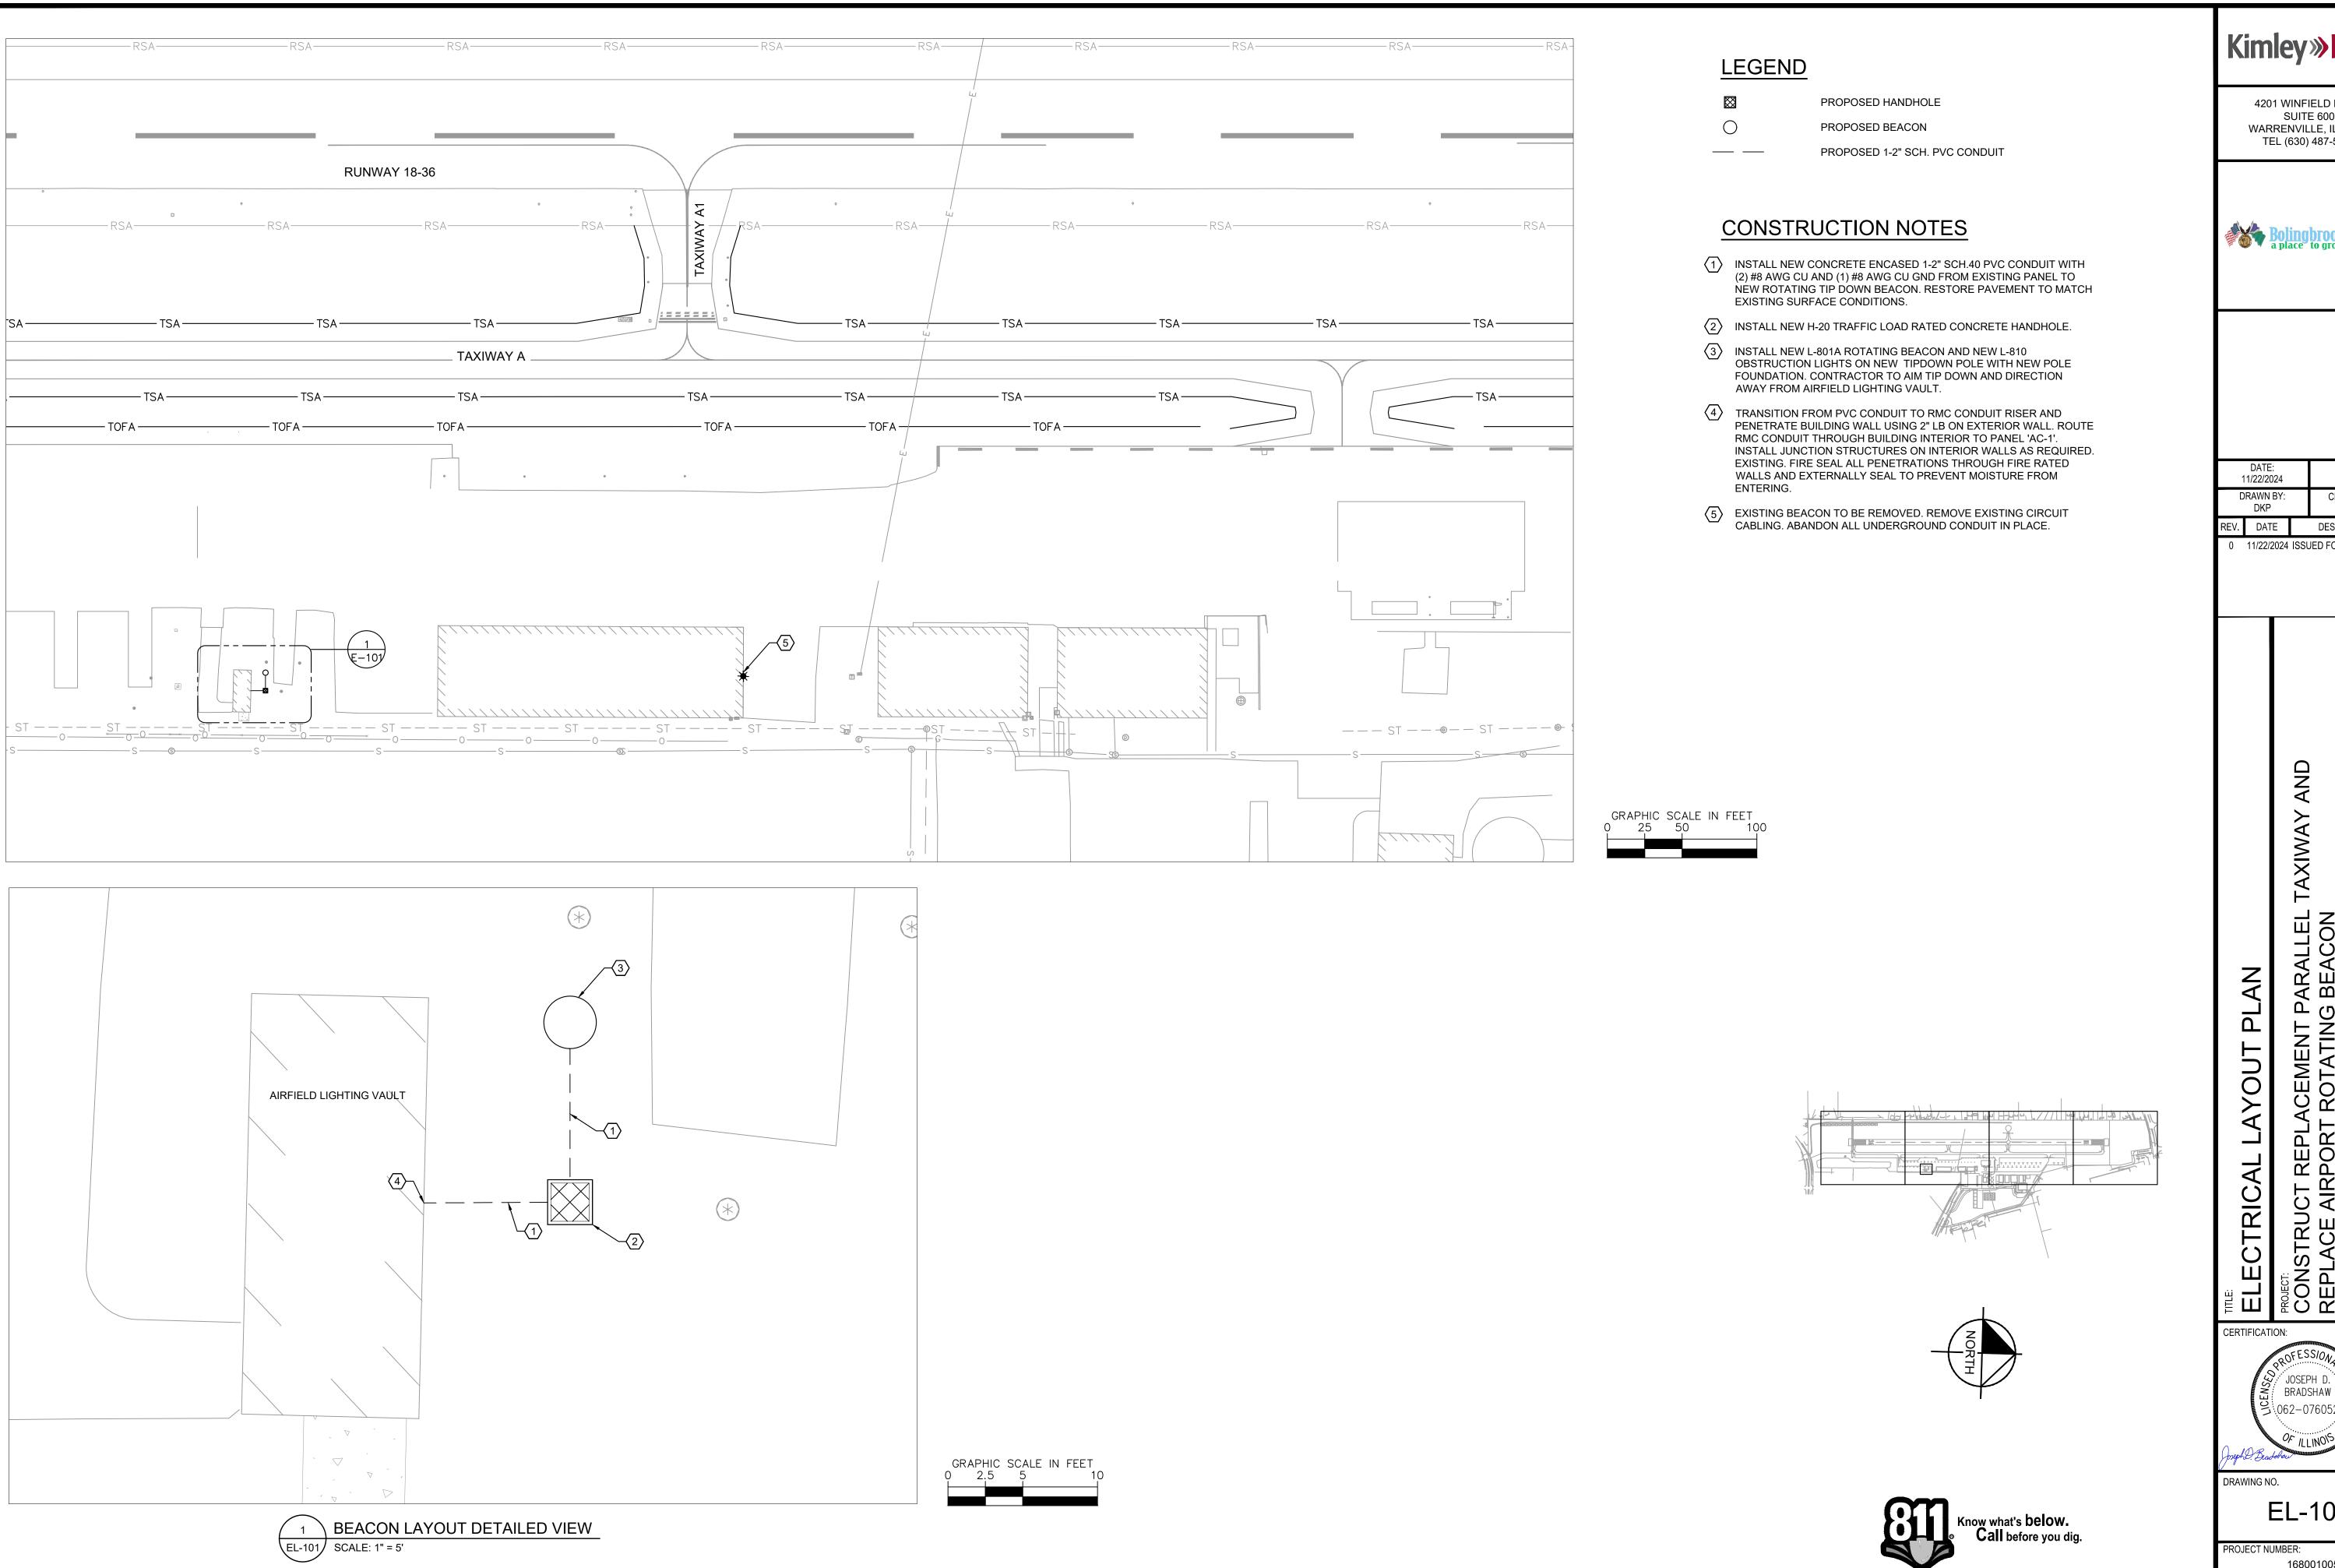

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1" = 50' CHECKED BY:

DESCRIPTION

JDB


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					D	∧NI⊏I N	I∧ N∕I⊏ ·	Λ <u></u> Λ Λ					
	LOCATION:				۲	ANEL		4C-1		A 10 F	2 A TINIO	4017	
						120/240V				RATING:			
SUPPLY FROM: SES		PHASES:									S TYPE:		
MOUNTING: SURFACE		WIRES:					3			MAINS F			
ENCLOSURE: NEMA 3R		MICE								RATING:	200 A		
		LOAD							LOAD				
CKT	CIRCUIT DESCRIPTION	TYPE	TRIP	POLES	A (VA)		B (VA)		POLES	TRIP	TYPE	CIRCUIT DESCRIPTION	CKT
1	(E) INTERIOR LIGHTS	L		1	EX	EX			2	60	Е	(E) LIGHTNING ARRESTOR	2
3	(E) EXTERIOR LIGHTS	L		1			EX	EX		00	ı	(E) EIGITIVIIVO / ITTLE FOR	4
5	(E) INTERIOR RECEPT.	R		1	EX	EX			2	25	Е	(E) HEATER EH1	6
7	(E) EXHAUST FAN	E		1			EX	EX	2 23	20		(L) HE/CIEIC LITT	8
9	(E) CONTROL POWER	E		1	EX	EX			2	2 25	E	(E) HEATER EH2	10
11	(E) FACP	0		1			EX	EX	2 20	20			12
13	(E) SPARE			1	EX	EX			2	80		(E) SPARE	14
15	(E) GFI NORTH EXTERIOR	R		1			EX	EX				` '	16
17	(E) SPARE			1	EX	395			1	20	L	(N) BEACON	18
19	(E) SPARE			1									20
21	(E) SPARE			2									22
23	(2) 31 7 11 (2			_									24
25	(E) SPARE			2									26
27	(2) 31 7 11 (2)												28
29	(E) SPARE			2									30
31													32
33	(E) SPARE			2									34
35													36
37	(E) REGULATOR RUNWAY	E		2	EX	EX							38
39	(_,						EX	EX					40
41			L	L LOAD:									42
			VA	0 VA		]							
TOTAL AMPS: 3.3 A 0 A													
	LOAD CLASSIFICATION LIGHTING (L)			CONNECTED LOAD: (VA)			DEMAND FACTOR		EST. DEMAND (VA)		PANEL TOTALS		
					395.0			125.00%		493.8		TOTAL CONN. LOAD (VA): 395	
												TOTAL EST. DEMAND (VA):	493.75
												TOTAL CONN. (A):	
												TOTAL EST. DEMAND (A):	4.2





2 HANDHOLE - TYPE II (AASHTO H-20 LOAD RATED)
EL-501 NTS

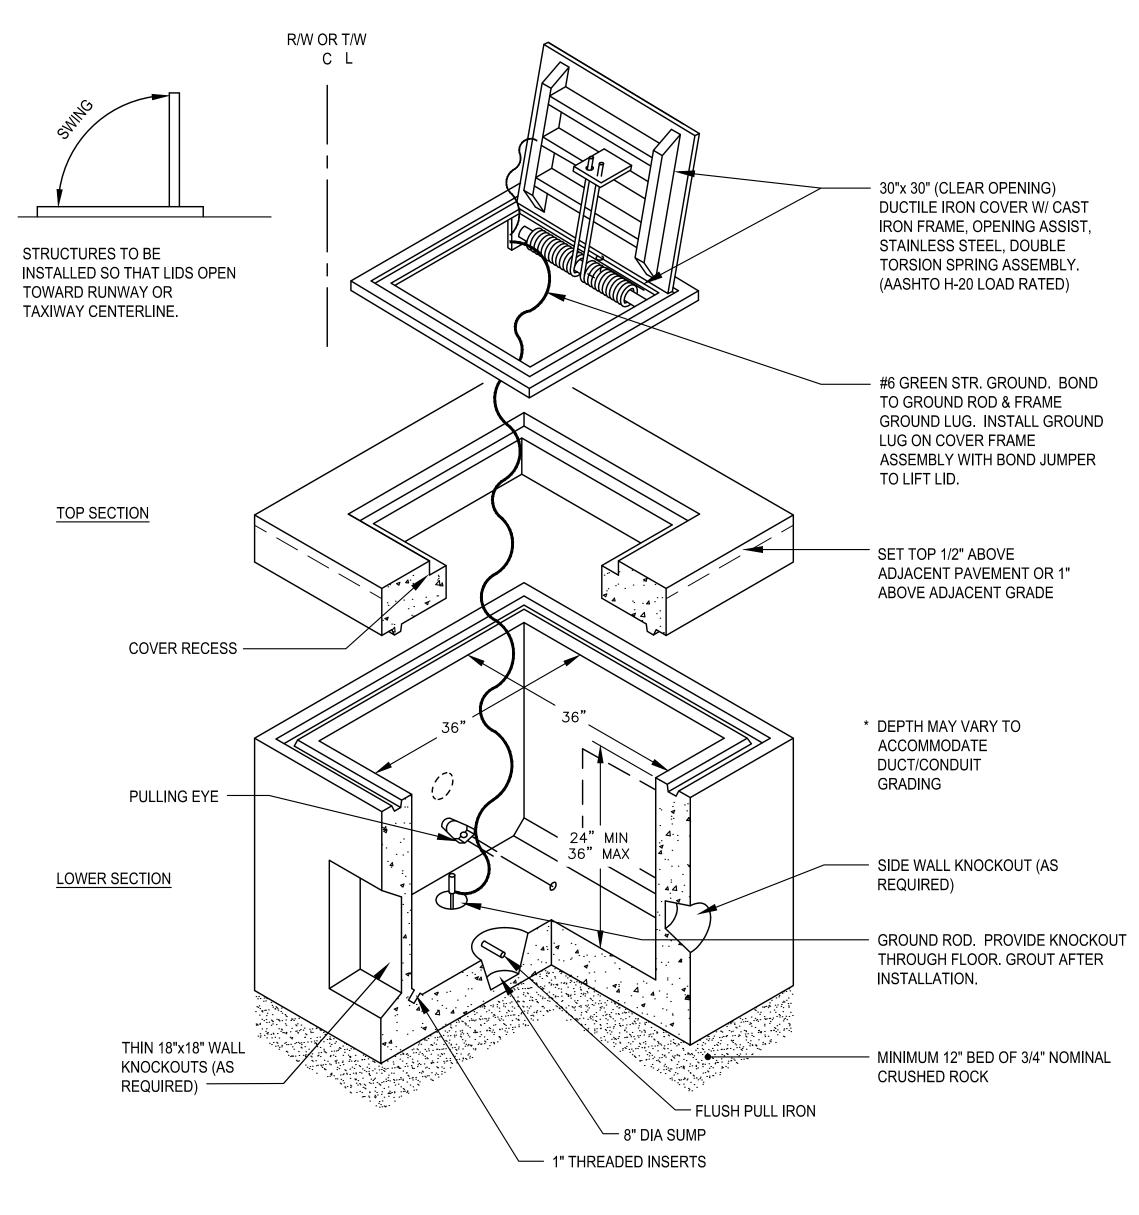

SCALE: NTS

CHECKED BY: JDB

DESCRIPTION

DATE: 11/22/2024

DRAWN BY:

0 11/22/2024 ISSUED FOR BID

AXIWAY AND

CERTIFICATION:

DRAWING NO.

PROJECT NUMBER:

JOSEPH D. BRADSHAW

EL-501


168001005

REV. DATE

MOUNT EQUIPMENT TO NEW BEACON TOWER

SPLICE BEACON CIRCUIT TO BEACON, TWO DUAL L-810 OBSTRUCTION LIGHTS



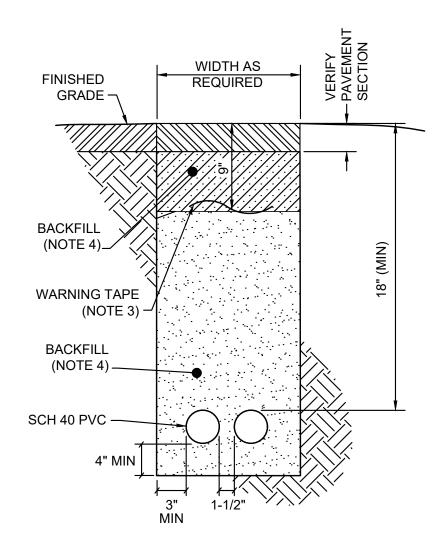




### CONDUIT/DUCT & CABLE INSTALLATION NOTES:

- SEE PLANS FOR REQUIRED DUCT SECTIONS. ALL OF THE SECTIONS SHOWN ON THIS DRAWING MAY NOT BE USED ON THIS PROJECT.
- 2. PROVIDE PULL WIRES IN ALL (NEW) UNUSED CONDUITS. PLUG CONDUIT ENDS IN HANDHOLES OR MANHOLES.
- 3. WARNING TAPE REQUIRED IN ALL AREAS.
- 4. EXCAVATION, SITE PREPARATION, AND BACKFILL IS INCIDENTAL TO ITEM AR101510, AIRPORT ROTATING BEACON.
- 5. BACKFILL NOTES:

D.B. APPLICATIONS: IN MULTIPLE POURS OF FLOWABLE FILL (AKA SLURRY OR CONTROLLED LOW STRENGTH MATERIAL (CLSM)). FILL TO WARNING TAPE AND THEN TO THE FINISHED GRADE OR BASE OF PAVEMENT W/ FLOWABLE FILL.

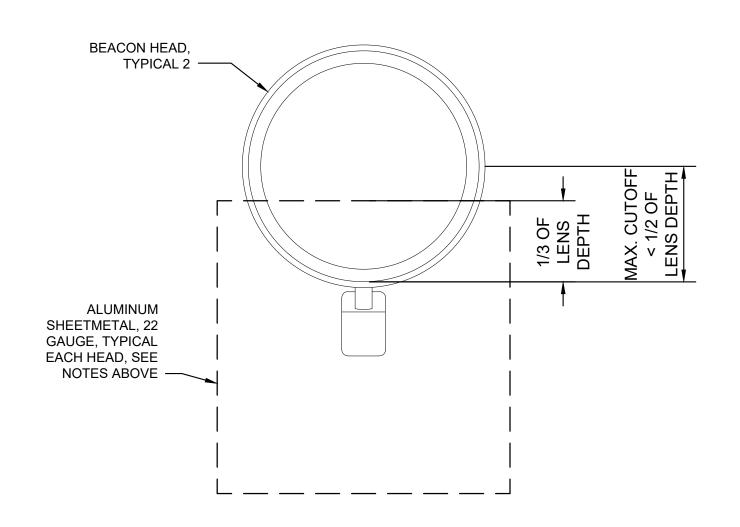


# 2 BEACON BEAM CUTOFF DETAIL EL-502 NTS

# BEACON BEAM CUTOFF NOTES: 22 GAUGE ALUMINUM SHEETME

22 GAUGE ALUMINUM SHEETMETAL TO BE USED FOR FIELD FABRICATION OF LIGHT CUTOFF INSIDE BOTH CLEAR LENSES. CUTOFF ANGLE TO BE DETERMINED IN THE FIELD. FOR EACH OF THE BEACON'S TWO HEADS:

- 1. TREAT MIN. 12"x12" SECTION OF ALUMINUM SHEETMETAL AND PAINT FLAT BLACK WITH HIGH TEMPERATURE SPRAY PAINT.
- 2. TEMPORARILY ATTACH SHEETMETAL TO BLOCK OFF APPROXIMATE BOTTOM 1/3 OF THE LENS DEPTH.
- 3. ADJUST BEACON HEADS TO MAXIMUM UPWARD ANGLE.
- 4. RAISE BEACON INTO OPERATING POSTURE AND TURN BEACON ON.
- CHECK TO SEE IF CUTOFF IS SUFFICIENT.
   ADJUST CUTOFF, TO BE KEPT TO LESS THAN 1/2 OF THE LENS DEPTH, UNTIL DESIRED RESULTS ARE ACHIEVED.
- 7. ONCE THE DEPTH OF THE CUTOFF IS ESTABLISHED, CUT OUT THE ALUMINUM SHEETMETAL TO FIT DIRECTLY INSIDE THE LOWER PORTION OF THE LENSES.
- TOUCH UP PAINT AS NECESSARY.
   LOOSEN THE LENS' CLIPS AND INSTALL THE CUTOFF SO THAT THE CLIPS HOLD THE LENS AND THE CUTOFF SECURELY.

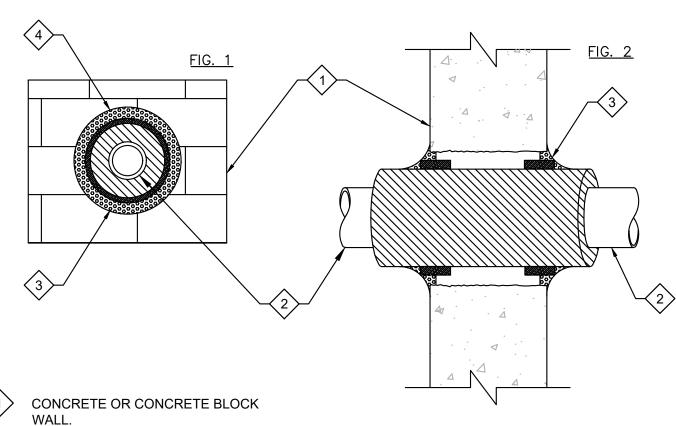

WALL.

2 CONDUIT UP TO 4" TRADE SIZE.

SPECSEAL SERIES 100 SEALANT.
INSTALL 1/4" BEAD AROUND WRAP
STRIP/ CONCRETE WALL ANNULUS
AFTER INSTALLATION OF WRAP
STRIP(S) SHALL RANGE FROM POINT
OF CONTACT TO 1/4" MAXIMUM.

SPECSEAL (SSW12 OR SSWRED)
WRAP STRIP. WRAP PRODUCT
AROUND CONDUIT, SECURE STEEL
TIE WIRE, AND RECESS 1-3/4" INTO
WALL CAVITY. SEE FIG. 3 FOR THE
NUMBER OF LAYERS REQUIRED.

EIG. 3

LAYERS OF WRAP STRIP 1 1 1 2 2

### NOTE:

THE PRODUCTS USED IN THIS DESIGN SYSTEM HAVE BEEN TESTED AS FOLLOWS:


- ASTM E814 (UL1479)
  ASTM E119 (TIME/ TEMP. EXPOSURE)
- ASTM E119 (TIME/ TEMP. EXPOSURE (COTTON WASTE IGNITION)
   ANNULAR SPACE REQUIREMENTS





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TRUCT REPLACEMENT PARALLEL TAXIWAY

CERTIFICATION:

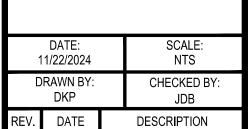CERTIFICATION:

JOSEPH D.

BRADSHAW

OF ILLINO'S

EXP. 11/3

11/22/2

DRAWING NO.

EL-502
PROJECT NUMBER:

168001005

