


LEGEND:

- STORM SEWER
- STORM SEWER INLET
- STORM SEWER CATCH BASIN
- STORM SEWER MANHOLE
- SANITARY SEWER
- SANITARY SEWER MAN HOLE
- WATERMAIN
- VALVE VAULT

GRAPHIC SCALE
 20 0 10 20
 (IN FBST)
 H. 1" = 20 ft. V. 1" = 5 ft.

STRUCTURE #	TYPE	FRAME & GRATE
SS F1	CB TYPE A, 4' DIA.	TYPE 23 FR & GR
SS F1-1	CB TYPE C	TYPE 8 GRATE
SS F2	MH TYPE A, 4' DIA.	TYPE 23 FR & GR
SS F2-1	INLET TYPE A	TYPE 23 FR & GR
SS F3	MH TYPE A, 7' DIA.	TYPE 1 FR & CL (2)
SS F4	CB TYPE A, 4' DIA.	TYPE 23 FR & GR
SS F4-1	CB TYPE A, 4' DIA.	TYPE 23 FR & GR
SS F4-2	INLET TYPE A	TYPE 8 GRATE
SS F4-3	INLET TYPE A	TYPE 8 GRATE
SS F5	CB TYPE A, 4' DIA.	TYPE 23 FR & GR
SS F5-1	MH TYPE A, 4' DIA.	TYPE 8 GRATE
SS F5-2	MH TYPE A, 4' DIA.	TYPE 1 FR & CL
SS F7-3	INLET TYPE A	TYPE 8 GRATE

* MANHOLE WITH RESTRICTOR PLATE SEE DETAIL

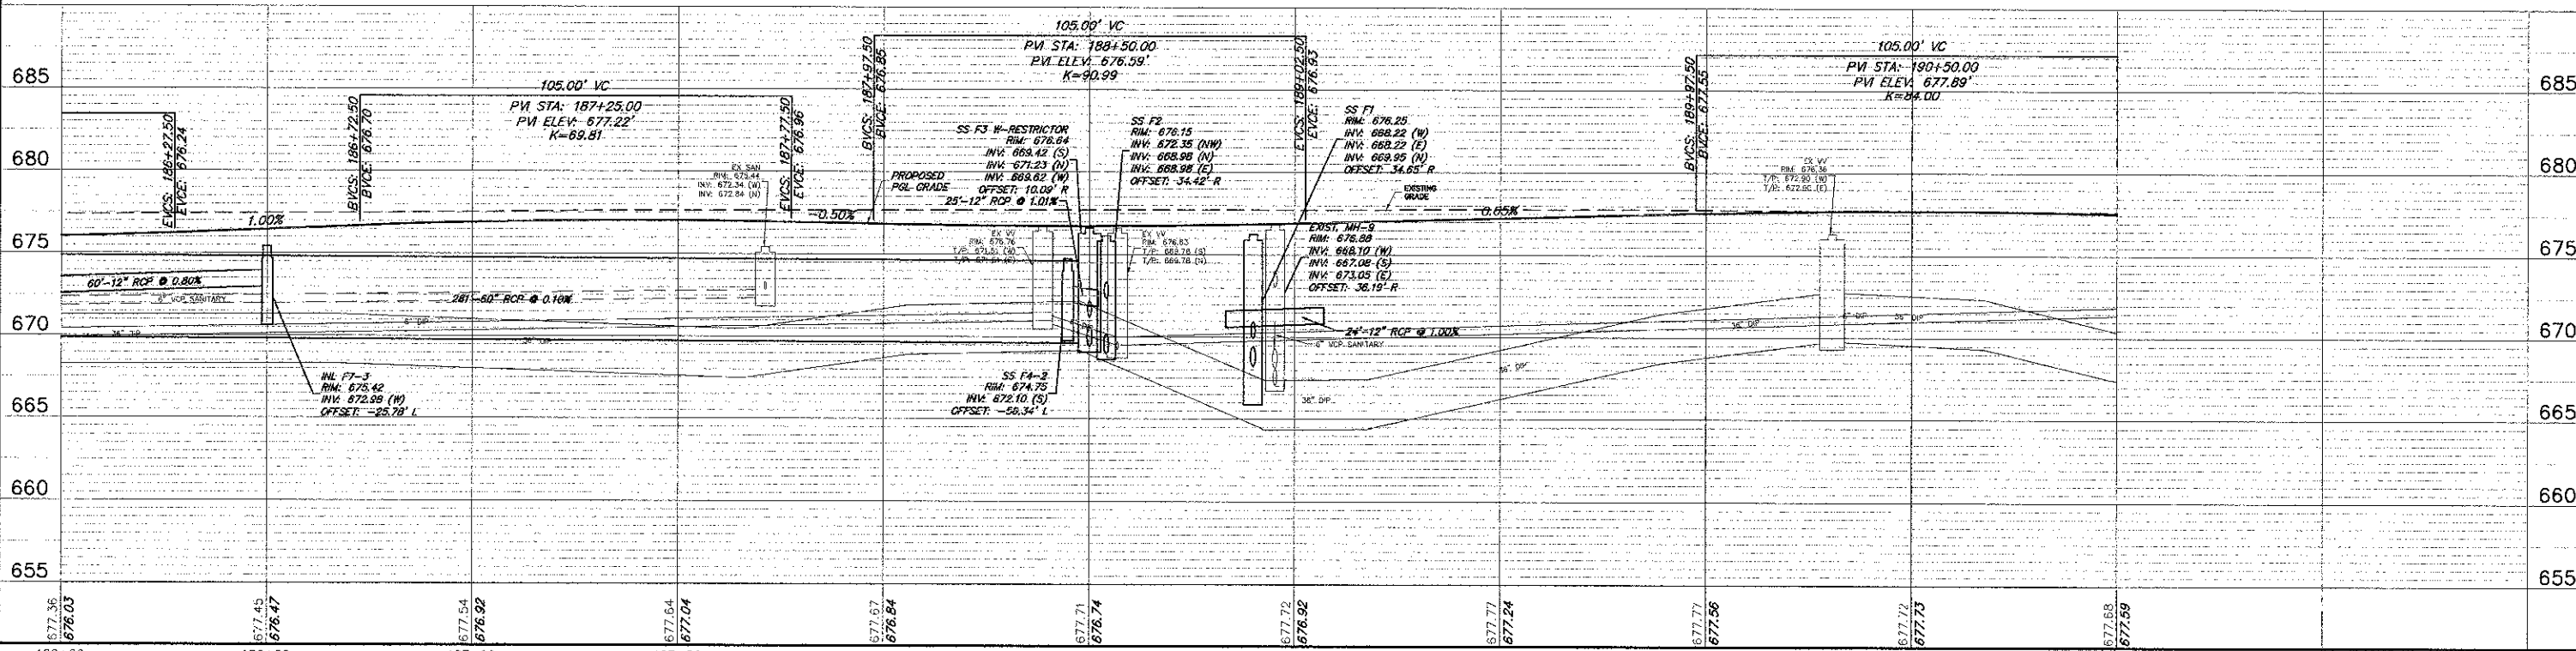

FILE NAME = 4183.800-PR3.dwg	USER NAME = PAUL SWATEK	DESIGNED - BVS	REVISED -	STATE OF ILLINOIS DEPARTMENT OF TRANSPORTATION	DRAINAGE AND UTILITY - PLAN AND PROFILE KENSINGTON ROAD IMPROVEMENTS	FAU RTE	SECTION	COUNTY	TOTAL SHEETS	SHEET NO.	
	PLOT SCALE = 1" = .08'	DRAWN - PJS	REVISED -			1295	09-00154-00-PV	COOK	119	49	
	PLOT DATE = 10/17/2012	CHECKED - KLB	REVISED -			CONTRACT #: 63746					
		DATE - 10/17/12	REVISED -			ILLINOIS FED. AID PROJECT					

SCALE: 1"=20' SHEET NO. OF SHEETS STA. 186+00 TO STA. 191+00