
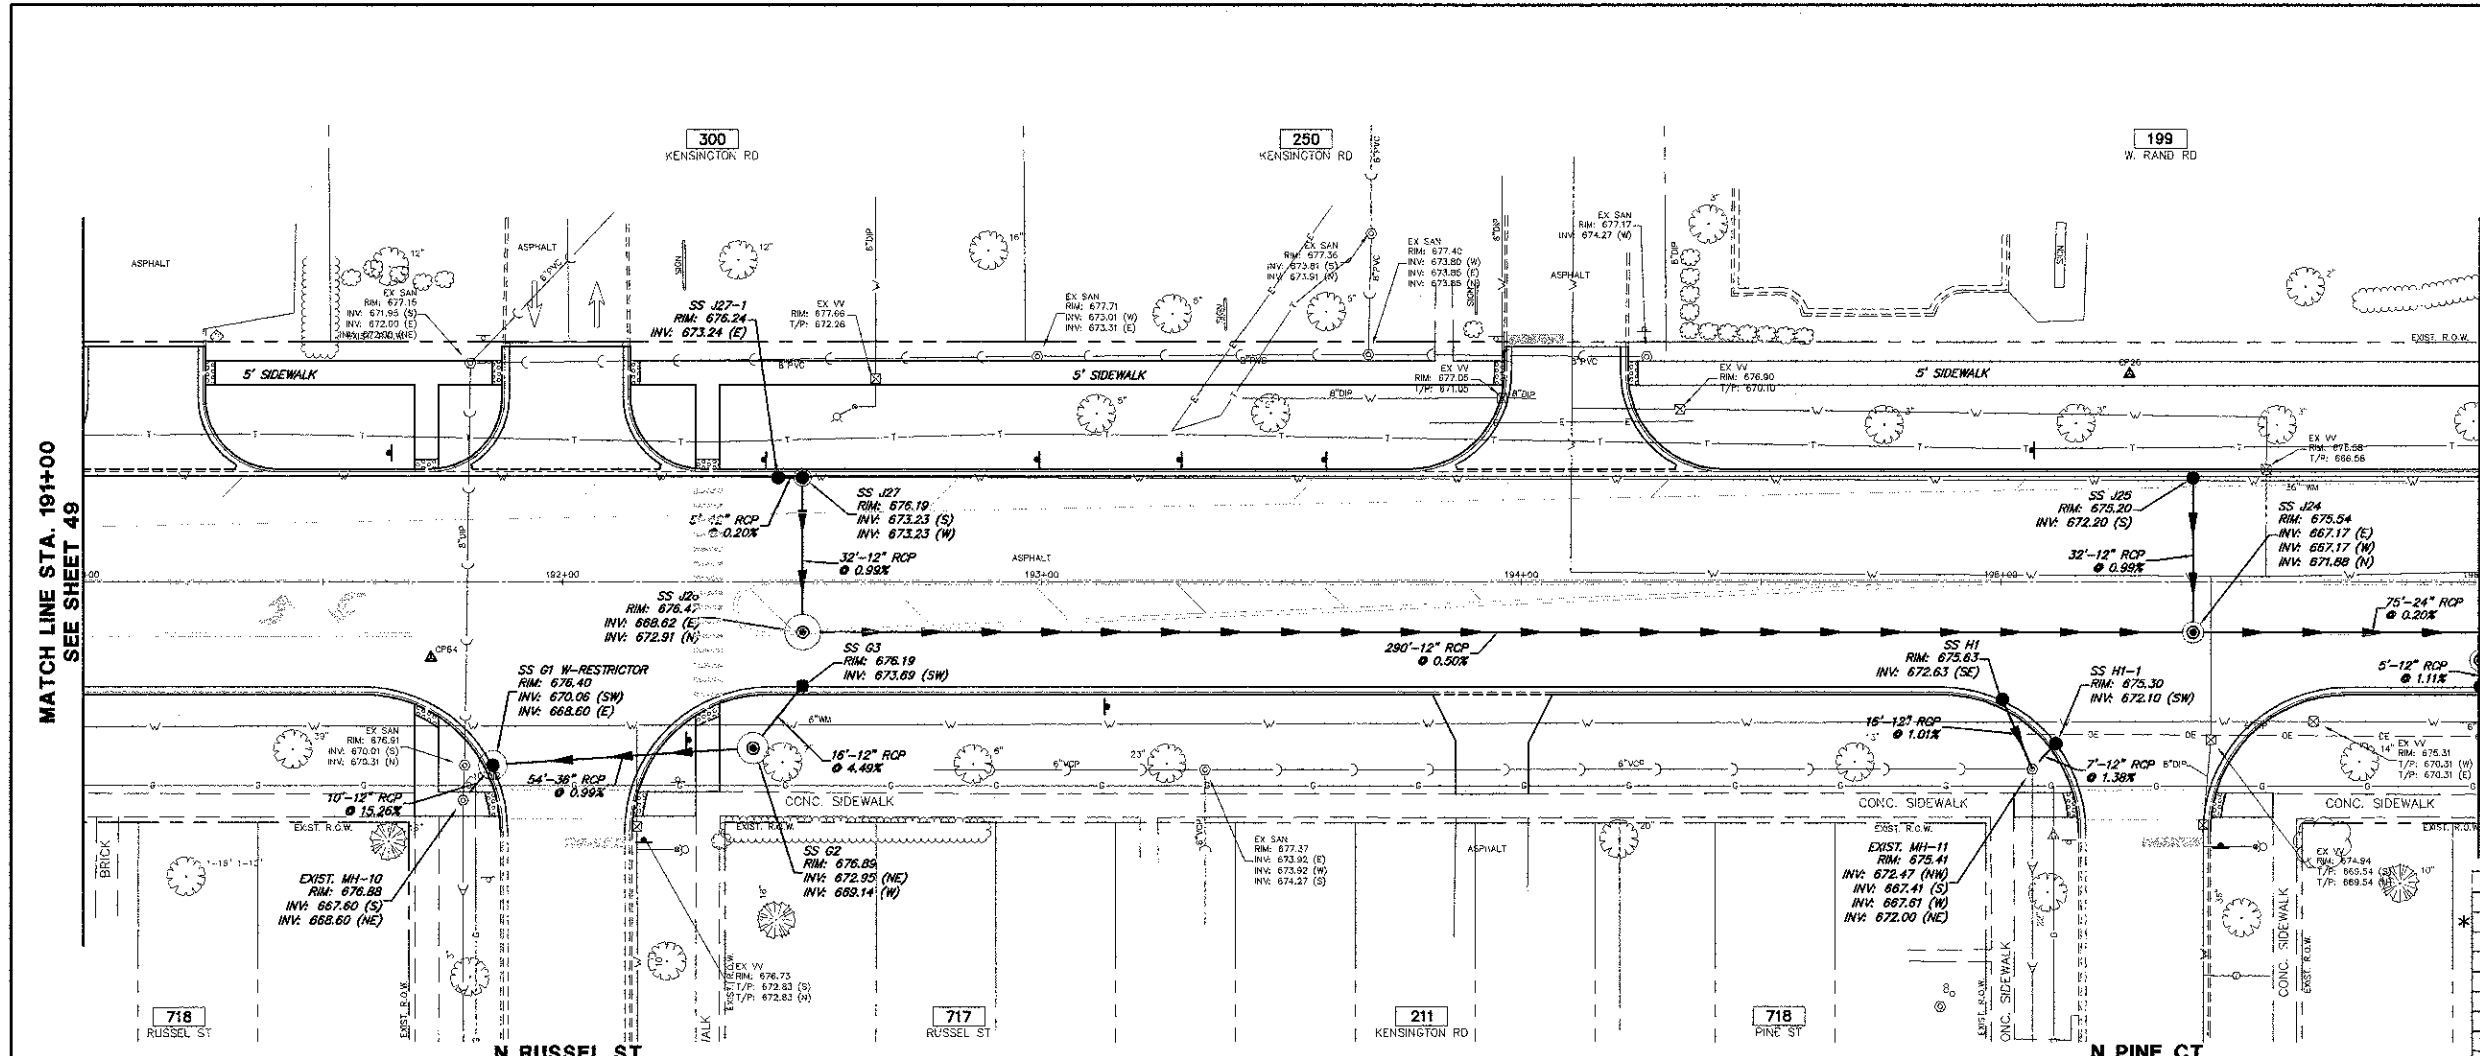



LEGEND:

- STORM SEWER
- STORM SEWER INLET
- STORM SEWER CATCH BASIN
- STORM SEWER MANHOLE
- SANITARY SEWER
- SANITARY SEWER MAN HOLE
- WATERMAIN
- VALVE VAULT

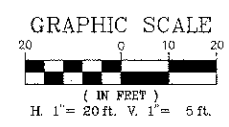

STORM STRUCTURES		
STRUCTURE #	TYPE	FRAME & GRATE
SS G1	MH TYPE A, 6' DIA.	TYPE 23 FR & GR, TYPE 1 FR & CL
SS G2	CB TYPE A, 5' DIA.	TYPE 1 FR & CL
SS G3	INLET TYPE A	TYPE 23 FR & GR
SS H1	CB TYPE C	TYPE 23 FR & GR
SS H1-1	CB TYPE C	TYPE 23 FR & GR
SS J24	MH TYPE A, 4' DIA.	TYPE 1 FR & CL
SS J26	CB TYPE C	TYPE 23 FR & GR
SS J27	MH TYPE A, 4' DIA.	TYPE 1 FR & CL
SS J27-1	INLET TYPE A	TYPE 23 FR & GR

* MANHOLE WITH RESTRICTOR PLATE SEE DETAIL

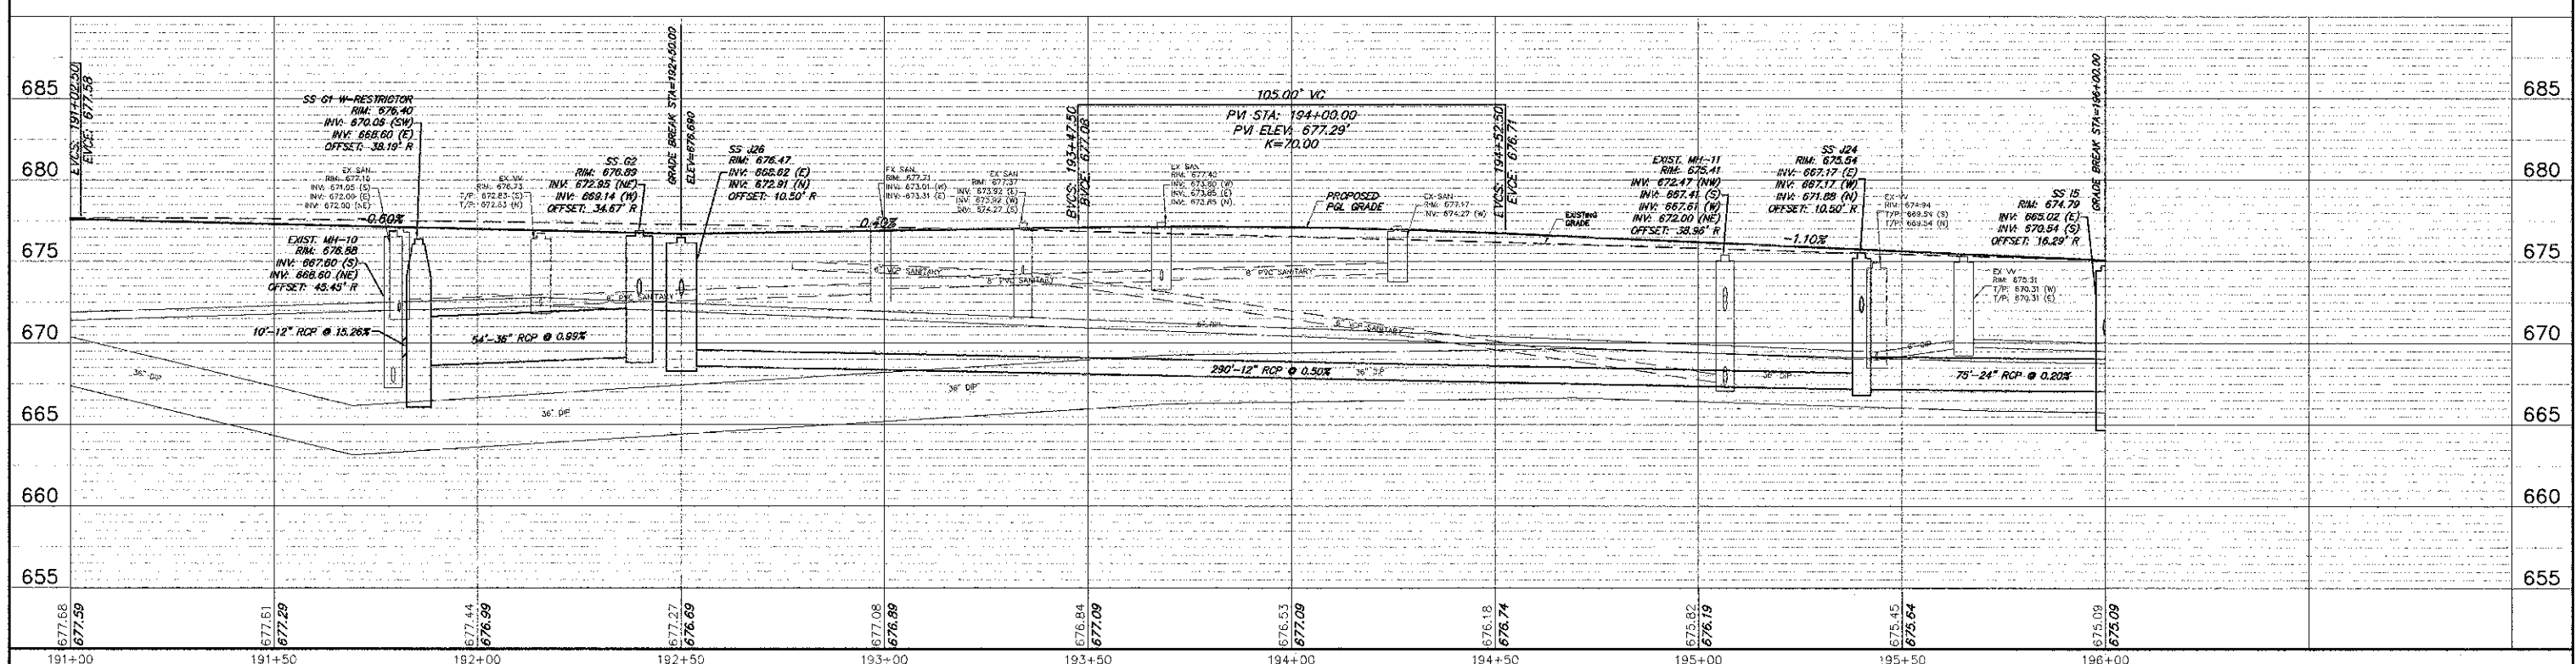

FILE NAME = 4185.600-PR3.dwg	USER NAME = PAUL SWIATEK	DESIGNED - BVS	REVISED -	STATE OF ILLINOIS DEPARTMENT OF TRANSPORTATION	DRAINAGE AND UTILITY - PLAN AND PROFILE KENSINGTON ROAD IMPROVEMENTS	FAU R/E	SECTION	COUNTY	TOTAL SHEETS	SHEET NO.	
	PLOT SCALE = 1" = 40'	DRAWN - PJS	REVISED -			1295	09-00154-00-PV	COOK	119	50	
	PLOT DATE = 10/17/2012	CHECKED - KLB	REVISED -			SCALE: 1"=20'		SHEET NO. OF SHEETS		STA. 191+00 TO STA. 196+00	
		DATE - 10/17/12	REVISED -			CONTRACT #:		63746		ILLINOIS FED. AID PROJECT	