


PROGRAM AND OFFICE ENGINEER: CHARLES F. RIDDLE, P.E. 847-705-4406 SCHAUMBURG, IL
CONSULTING ENGINEER: ENGINEERING ENTERPRISES, INC. CONTACT: JAMES R. LENZINI P.E. 630-466-6700

1-18-13 LETTING ITEM 117

STATE OF ILLINOIS DEPARTMENT OF TRANSPORTATION DIVISION OF HIGHWAYS PLANS FOR PROPOSED FEDERAL-AID HIGHWAY FAU 3553 (BATAVIA ROAD) FROM EAST OF FAP 365 (IL ROUTE 56) TO FAU 1479 (WARRENVILLE ROAD) WIDENING AND RESURFACING SECTION NO. 10-00031-00-RS PROJECT NO. M-9003(866) CITY OF WARRENVILLE DUPAGE COUNTY JOB NO. C-91-086-12


FAU RTE	SECTION	COUNTY	TOTAL SHEETS	SHEET NO.
3553	10-00031-00-RS	DUPAGE	29	1
FED. ROAD DIST. NO. 1 ILLINOIS FED. AID PROJECT - STP			CONTRACT NO. 63758	

INDEX OF SHEETS	
SHEET NO.	SHEET DESCRIPTION
1.	COVER SHEET
2.	GENERAL NOTES AND STATE STANDARDS
3.	SUMMARY OF QUANTITIES
4.-6.	EXISTING AND PROPOSED TYPICAL SECTIONS
7.	SCHEDULE OF QUANTITIES
8.	ALIGNMENT, TIES AND BENCHMARKS
9.	SUGGESTED CONSTRUCTION STAGING PLAN
10.	BATAVIA ROAD DETOUR PLAN
11.-15.	PLAN AND PROFILE
16.	BATAVIA ROAD AND WARRENVILLE ROAD INTERSECTION DETAIL
17.-19.	PAVEMENT MARKING, SIGNING, SIDEWALK AND DRIVEWAY PLAN
20.	PARKING STALL PAVEMENT MARKING DETAIL
21.-22.	SPECIAL DETAILS
DISTRICT ONE DETAILS	
23.	(TC-10) TRAFFIC CONTROL AND PROTECTION FOR SIDE ROADS, INTERSECTIONS, AND DRIVEWAYS
24.	(TC-11) TYPICAL APPLICATIONS RAISED REFLECTIVE PAVEMENT MARKERS (SNOW-LOW RESISTANT)
25.	(TC-13) DISTRICT ONE - TYPICAL PAVEMENT MARKINGS
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27.	(BD-22) PAVEMENT PATCHING FOR HMA SURFACED PAVEMENT
28.	(BD-32) BUTT JOINT AND HMA TAPER DETAILS
29.	(BD-36) FIRE HYDRANT TO BE MOVED

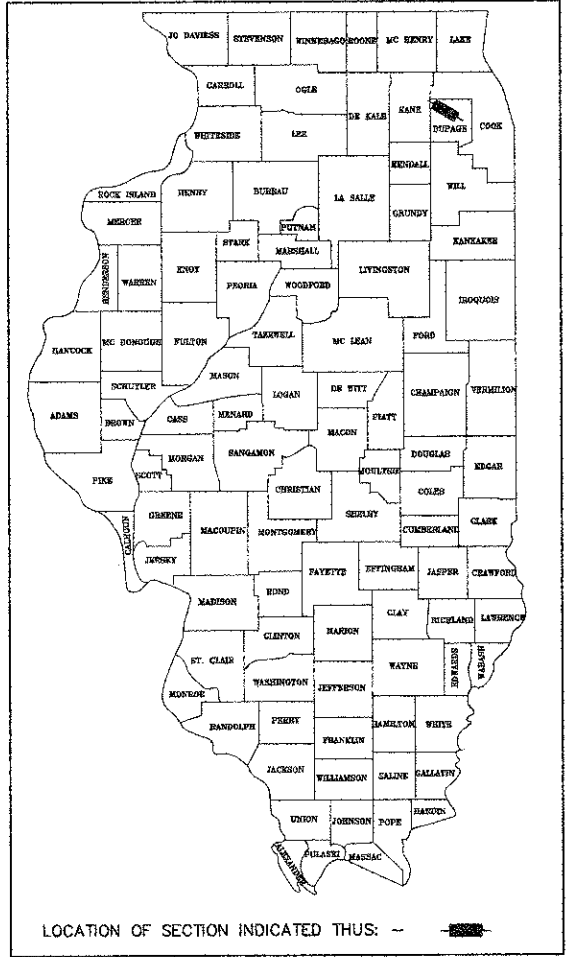


DESIGN DESIGNATION

BATAVIA ROAD: URBAN MINOR ARTERIAL
DESIGN SPEED = 35 M.P.H.
POSTED SPEED = 35 M.P.H.
ADT(2012) = 11,000 VPD

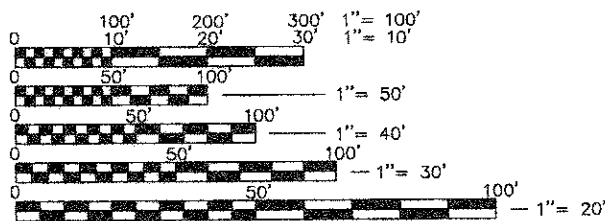

FULL SIZE PLANS HAVE BEEN PREPARED USING STANDARD ENGINEERING SCALES, REDUCED SIZED PLANS WILL NOT CONFORM TO STANDARD SCALES, IN MAKING MEASUREMENTS ON REDUCED PLANS, THE ABOVE SCALES MAY BE USED.

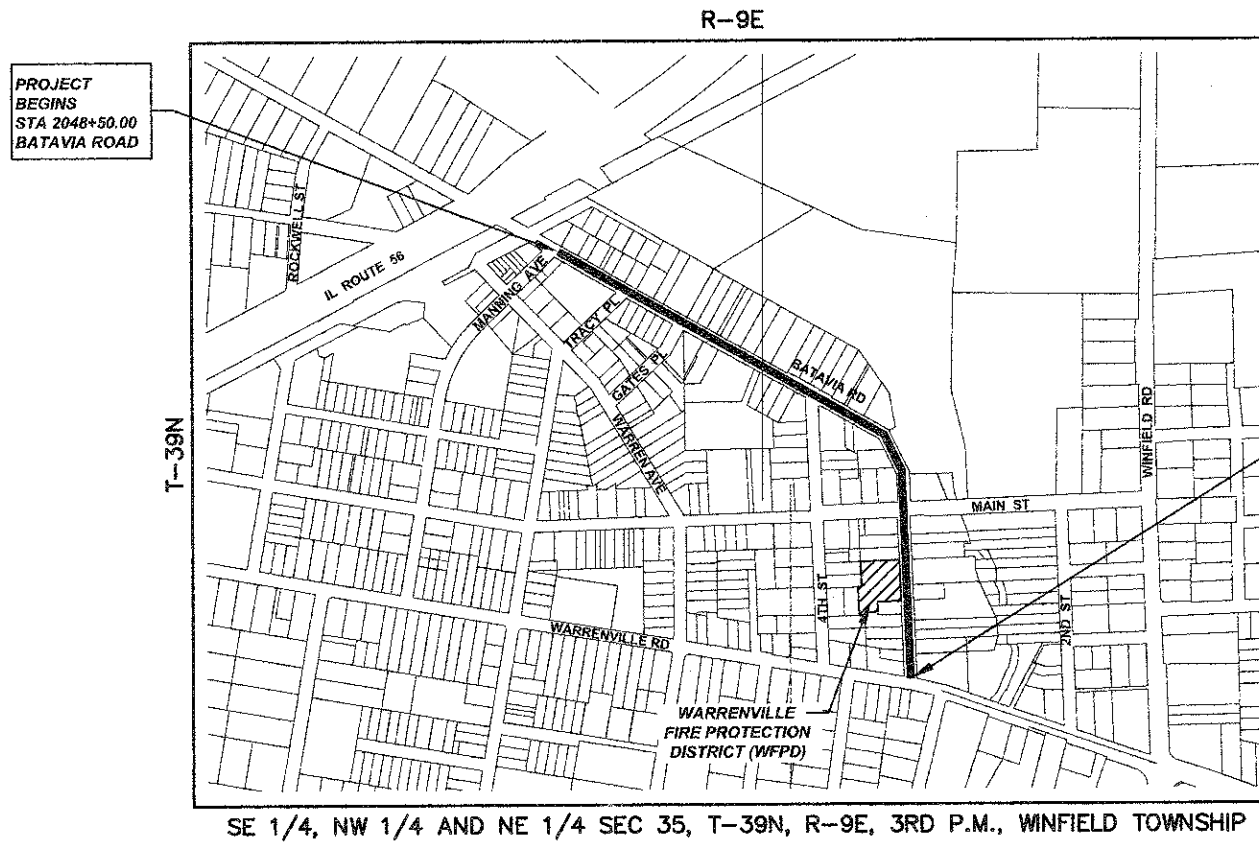

SE 1/4, NW 1/4 AND NE 1/4 SEC 35, T-39N, R-9E, 3RD P.M., WINFIELD TOWNSHIP

LOCATION MAP
1" = 500'

TOTAL GROSS & NET LENGTH OF PROJECT = 3,255 FEET (0.616 MILES)

JULIE
JOINT
UTILITY
LOCATION
INFORMATION FOR
EXCAVATION
CALL 811

Know what's below.
Call before you dig.

CONTRACT NO. 63758

STATE OF ILLINOIS DEPARTMENT OF TRANSPORTATION DIVISION OF HIGHWAYS	
APPROVED	<i>Michael Smith</i> MICHAEL SMITH CITY OF WARRENVILLE, SUPERINTENDENT OF PUBLIC WORKS
PASSED	NOVEMBER 8, 2012 <i>C. Holt</i> C. HOLT DISTRICT 1 ENGINEER OF LOCAL ROADS & STREETS
RELEASING FOR BID BASED ON LIMITED REVIEW	NOVEMBER 8 2012 <i>John F. ...</i> DEPUTY DIRECTOR OF HIGHWAYS, REGION 1 ENGINEER

DATE: 10/11/12	
BY: <i>James R. Lenzini</i> JAMES R. LENZINI	
LICENSE EXPIRES: NOVEMBER 30, 2013	

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Plot Date: October 10, 2012 @ 10:41 AM By: Jm. Schmidt - Tab: 01 Cover - 22,34

P:\117\10031\10031-00-RS\10031-00-RS-01.dwg FINAL ENG 10/10/12 - CVR

GENERAL NOTES

SPECIFICATIONS, STANDARDS, AND SPECIAL PROVISIONS

ALL CONSTRUCTION SHALL BE DONE IN ACCORDANCE WITH THE STANDARD SPECIFICATIONS FOR ROAD AND BRIDGE CONSTRUCTION, ADOPTED JANUARY 1, 2012 (HEREINAFTER REFERRED TO AS THE STANDARD SPECIFICATIONS), THE SUPPLEMENTAL SPECIFICATIONS AND RECURRING SPECIAL PROVISIONS, ADOPTED JANUARY 1, 2013, THE LATEST EDITION OF THE ILLINOIS MANUAL ON UNIFORM TRAFFIC CONTROL DEVICES FOR STREETS AND HIGHWAYS, THE STANDARD SPECIFICATIONS FOR WATER & SEWER MAIN CONSTRUCTION IN ILLINOIS, LATEST EDITION AND REVISIONS THERE TO, THE CODES AND ORDINANCES OF THE CITY OF WARRENVILLE, ILLINOIS, THE DETAILS IN THE PLANS AND THE SPECIAL PROVISIONS INCLUDED IN THE CONTRACT DOCUMENTS.

NO SUBSTITUTIONS OR VARIANCES WILL BE PERMITTED TO ANY STANDARD NOTES OR ORDINANCES UNLESS APPROVED OTHERWISE IN WRITING PRIOR TO COMMENCING CONSTRUCTION ACTIVITY.

ALL TRAFFIC CONTROL AND OTHER ADVISORY SIGNS NEEDED FOR CONSTRUCTION ARE TO BE FURNISHED BY THE CONTRACTOR IN ACCORDANCE WITH ARTICLE 107.14 OF THE STANDARD SPECIFICATIONS.

THE CONTRACTOR SHALL AT ALL TIMES PROVIDE PROTECTION FOR TRAFFIC AS CALLED FOR IN THE APPLICATION OF TRAFFIC CONTROL DEVICES, THE STANDARD SPECIFICATIONS, THE SPECIAL PROVISIONS AND THE PLANS.

UTILITIES

THE CONTRACTOR SHALL COOPERATE WITH THE OWNER IF ANY UTILITY IMPROVEMENTS ARE REQUIRED WITHIN THE DURATION OF THE CONTRACT.

THE CONTRACTOR SHALL BE RESPONSIBLE FOR CONTACTING THE OWNERS OF ALL UTILITIES PRIOR TO CONSTRUCTION TO DETERMINE THE LOCATION OF ALL EXISTING AND PROPOSED UTILITY EQUIPMENT. THE CONTRACTOR SHALL COOPERATE WITH ALL UTILITY OWNERS AS PROVIDED FOR IN THE STANDARD SPECIFICATIONS IF UTILITY RELOCATION, ADJUSTMENT, OR PROTECTION IS NECESSARY.

THE LOCATION OF EXISTING DRAINAGE STRUCTURES, STORM SEWERS, WATER MAINS, SANITARY SEWERS, FIELD TILES AND ANY OTHER PUBLIC OR PRIVATE UTILITIES AS SHOWN ON THE PLANS IS APPROXIMATE AND NOT NECESSARILY COMPLETE; THEIR EXACT LOCATION IS TO BE DETERMINED IN THE FIELD BY THE CONTRACTOR. THIS WORK SHALL BE CONSIDERED INCLUDED IN THE COST OF THE CONTRACT.

THE CONTRACTOR SHALL BE RESPONSIBLE FOR THE PROTECTION OF ALL UNDERGROUND AND SURFACE UTILITIES EVEN THOUGH THEY MAY NOT BE SHOWN ON THE PLANS. ANY UTILITY THAT IS DAMAGED DURING CONSTRUCTION SHALL BE RESTORED TO A CONDITION EQUAL TO THAT EXISTING BEFORE THE DAMAGE OCCURRED. THIS WORK SHALL BE ARRANGED BY THE UTILITY COMPANY AND SHALL BE AT THE CONTRACTOR'S EXPENSE.

IF EXISTING UTILITY LINES OF ANY NATURE ARE ENCOUNTERED WHICH CONFLICT IN LOCATION WITH NEW CONSTRUCTION, THE CONTRACTOR SHALL NOTIFY THE ENGINEER SO THAT THE CONFLICT MAY BE RESOLVED.

UNDER NO CIRCUMSTANCES SHALL THE CONTRACTOR OPERATE ANY VALVES OR HYDRANTS.

STAKING

THE CONTRACTOR SHALL PROTECT AND CAREFULLY PRESERVE ALL SECTION OR SUBSECTION MONUMENTS, PROPERTY CORNERS, AND REFERENCE MARKERS UNTIL THE OWNER, THE OWNER'S AGENT, OR AN AUTHORIZED SURVEYOR HAS WITNESSED OR OTHERWISE REFERENCED THEIR LOCATIONS.

ALL RADII FOR PROPOSED CURB AND GUTTER ARE TO THE BACK OF CURB, UNLESS OTHERWISE NOTED. CURB AND GUTTER ELEVATIONS SHOWN AT POINTS OF CURVE, ETC., ARE TOP OF CURB UNLESS OTHERWISE NOTED.

STRUCTURE OFFSET LOCATIONS GIVEN ON THE DETAILED PLANS ARE TO THE FOLLOWING POINTS:

- A) STRUCTURES FALLING IN THE CURB LINE ARE MEASURED TO THE BACK OF CURB
- B) ALL OTHER STRUCTURES ARE MEASURED TO THE CENTER OF THE STRUCTURE

ELEVATIONS ARE NGVD 29 DATUM, ESTABLISHED FROM THE DUPAGE COUNTY GEODETIC SURVEY BENCHMARK NETWORK.

ALL OFFSET LOCATIONS GIVEN ON THE DETAILED PLANS FOR STRUCTURES, BACK OF CURB, ETC., ARE FROM THE CENTERLINE AS SHOWN ON THE PLANS.

SEWERS AND WATER MAINS

ANY LOOSE MATERIAL DEPOSITED IN THE FLOW LINE OF DRAINAGE STRUCTURES WHICH OBSTRUCTS THE NATURAL FLOW OF WATER SHALL BE REMOVED AT THE CLOSE OF EACH WORKING DAY. PRIOR TO ACCEPTANCE OF THE IMPROVEMENT, ALL DRAINAGE STRUCTURES SHALL BE FREE OF DIRT AND DEBRIS. THIS WORK WILL NOT BE PAID FOR SEPARATELY, IT SHALL BE CONSIDERED INCLUDED IN THE COST OF THE CONTRACT.

WHEN EXISTING DRAINAGE FACILITIES ARE DISTURBED, THE CONTRACTOR SHALL PROVIDE AND MAINTAIN IN AN OPERATING CONDITION TEMPORARY OUTLETS AND CONNECTIONS FOR ALL DRAINS, SEWERS, AND CATCH BASINS. THE CONTRACTOR SHALL PROVIDE FACILITIES WHICH HAVE THE CAPACITY TO RECEIVE AND DISCHARGE THE STORM WATER FLOW RATES NORMALLY ACCEPTED AND RELEASED BY EXISTING DRAINAGE FACILITIES. THIS WORK WILL NOT BE PAID FOR SEPARATELY, BUT SHALL BE CONSIDERED INCLUDED IN THE COST OF THE CONTRACT.

THE COST OF INTERCONNECTIONS BETWEEN THE PROPOSED AND EXISTING SEWER SYSTEMS AND PROPOSED AND EXISTING WATER MAIN SYSTEMS SHALL BE INCLUDED IN THE VARIOUS UNIT PRICES ON THE ITEMS BEING CONNECTED UNLESS NOTED OTHERWISE. THE COSTS OF PLUGGING ANY EXISTING STORM SEWER CONNECTIONS AS INDICATED ON THE PLANS SHALL BE INCLUDED IN THE COST OF STORM SEWER REMOVAL.

ALL FRAMES, GRATES, OR LIDS SCHEDULED TO BE REMOVED FROM EXISTING STRUCTURES SHALL REMAIN THE PROPERTY OF THE CITY. ANY ITEMS DAMAGED DURING REMOVAL SHALL BE REPLACED BY THE CONTRACTOR AT THEIR OWN EXPENSE. THE COST OF SALVAGING EXISTING FRAMES, GRATES, OR LIDS AND/OR STOCKPILING THEM ON THE JOB SITE FOR PICKUP BY THE CITY OR DELIVERY TO THE CITY MAINTENANCE YARD SHALL BE CONSIDERED INCLUDED IN THE COST OF THE CONTRACT.

ALL FRAMES WITH CLOSED LIDS TO BE FURNISHED AS PART OF THIS CONTRACT FOR ANY MANHOLE, CATCH BASIN, INLET, OR VALVE VAULT SHALL HAVE ONE OF THE FOLLOWING WORDS CAST INTO THE LID: "STORM", "SANITARY", OR "WATER" AS APPLICABLE. ANY ADDITIONAL COST FOR THIS REQUIREMENT SHALL BE CONSIDERED INCLUDED IN THE COST OF THE FRAME AND CLOSED LID PROVIDED.

FRAME ELEVATIONS GIVEN ON THE PLANS ARE ONLY TO ASSIST THE CONTRACTOR IN DETERMINING THE APPROXIMATE OVERALL HEIGHT OF THE STRUCTURE. FRAMES ON ALL STRUCTURES WILL BE ADJUSTED TO THE FINAL ELEVATION AND CROSS SLOPE OF THE AREA IN WHICH THEY ARE LOCATED. ALL FINAL ADJUSTMENTS OF FRAMES WILL BE ACCOMPLISHED BY THE USE OF CONCRETE ADJUSTING RINGS SET IN BUTYL ROPE JOINT SEALANT; MORTAR JOINTS WILL NOT BE ALLOWED. HEIGHT OF ADJUSTING RINGS SHALL NOT EXCEED EIGHT INCHES (8"). THE COST OF THE ADJUSTMENT TO FINAL ELEVATION IS INCLUDED IN THE COST OF THE ITEM CONSTRUCTED.

ALL STORM SEWERS SHALL BE PVC SDR 26, MEETING ASTM D-3034, UNLESS NOTED OTHERWISE ON THE PLAN. JOINTS SHALL BE GASKET TYPE MEETING ASTM D-3212.

STORM SEWERS, WATER MAIN QUALITY PIPE SHALL BE PVC DR25 MEETING AWWA C900. JOINTS SHALL BE GASKET TYPE MEETING ASTM D-3139.

BACKFILL

THE COST OF TRENCH BACKFILL SHALL BE CONSIDERED INCLUDED IN THE COST OF STORM SEWER, SANITARY SEWER OR WATER MAIN SPECIFIED

STORM SEWER, SANITARY SEWER, AND WATER MAIN SHALL BE BACKFILLED IN ACCORDANCE WITH ARTICLE 550.07, METHOD 1 ONLY, OR AS DIRECTED BY THE ENGINEER, WITH THE FOLLOWING MODIFICATIONS.

INITIAL TRENCH BACKFILL SHALL BE CA-7. FINAL TRENCH BACKFILL SHALL BE GRADATION CA-6. THE FINAL TRENCH BACKFILL SHALL BE PLACED IN 6" LIFTS AND SHALL BE COMPACTED IN PLACE TO NINETY FIVE PERCENT (95%) OF MAXIMUM DENSITY AT OPTIMUM MOISTURE AS DETERMINED BY THE MODIFIED PROCTOR TEST.

SIGNS

PRIOR TO THE START OF CONSTRUCTION, THE CITY, CONTRACTOR AND ENGINEER SHALL INVENTORY THE LOCATION, SIZE, TYPE, AND CONDITION OF ALL EXISTING SIGNS. ANY SIGN DAMAGED DURING CONSTRUCTION SHALL BE REPLACED AT THE CONTRACTOR'S EXPENSE.

PRIOR TO THE START OF CONSTRUCTION THE CITY WILL REMOVE ALL SIGNS THAT MAY INTERFERE WITH CONSTRUCTION, THE CITY SHALL ALSO REPLACE SIGNS AND FURNISH AND INSTALL PERMANENT SIGNS AS INDICATED ON THE PLANS.

MISCELLANEOUS

THE CONTRACTOR SHALL MAINTAIN EXISTING SIDE STREET, DRIVEWAY AND PEDESTRIAN ACCESS TO ABUTTING PROPERTY AT ALL TIMES DURING CONSTRUCTION OF THE PROJECT, UNLESS OTHERWISE NOTED IN THE PLANS OR DIRECTED BY THE ENGINEER. THIS WORK SHALL BE INCLUDED IN THE ITEM "AGGREGATE FOR TEMPORARY ACCESS".

SAWING OF REMOVAL ITEMS AS NOTED ON THE PLANS, SPECIFIED IN THE STANDARD SPECIFICATIONS, OR AS REQUIRED BY THE ENGINEER SHALL BE INCLUDED IN THE COST OF THE ITEM BEING REMOVED.

AT ALL BUTT JOINT LOCATIONS, THE EXISTING SURFACE SHALL BE CUT TO A MINIMUM THICKNESS OF TWO (2) INCHES AS INDICATED ON THE PLANS.

THE THICKNESS OF ASPHALT MIXTURES SHOWN IN THE PLANS ARE NOMINAL. DEVIATIONS MAY OCCUR DUE TO IRREGULARITIES IN THE SURFACES OR BASES ON WHICH THE ASPHALT MIXTURES ARE TO BE PLACED.

PROTECTIVE COAT SHALL BE APPLIED TO ALL GUTTER FLAGS, FACE AND TOP OF CURB, PCC SIDEWALK, PCC DRIVEWAY PAVEMENT, AND AS DIRECTED BY THE ENGINEER.

THE CONTRACTOR SHALL BE RESPONSIBLE FOR PROTECTING FRESH CONCRETE FROM DAMAGE AND VANDALISM. ANY DAMAGED OR VANDALIZED CONCRETE SHALL BE REMOVED AND REPLACED AT THE CONTRACTOR'S EXPENSE.

THE CONTRACTOR SHALL BE REQUIRED TO MAKE ARRANGEMENTS FOR THE PROPER BRACING, SHORING AND OTHER REQUIRED PROTECTION OF ALL ROADWAYS, STRUCTURES, POLES, CABLES AND PIPE LINES, BEFORE CONSTRUCTION BEGINS. THE CONTRACTOR SHALL BE RESPONSIBLE FOR ANY DAMAGE TO THE STREETS OR ROADWAYS AND ASSOCIATED STRUCTURES AND SHALL MAKE REPAIRS AS NECESSARY TO THE SATISFACTION OF THE ENGINEER AND CITY AT THEIR OWN EXPENSE. ANY SHEETING AND/OR SHORING USED FOR THIS IMPROVEMENT SHALL BE CONSIDERED INCLUDED IN THE COST OF THE CONTRACT.

THE CONTRACTOR SHALL PROTECT ALL EXISTING FACILITIES (E.G. CURB, DRIVEWAYS, PAVEMENT) THAT ARE NOT INDICATED TO BE REMOVED ON THE PLANS. ANY FACILITY THAT IS DAMAGED DURING CONSTRUCTION SHALL BE RESTORED TO A CONDITION EQUAL TO THAT EXISTING BEFORE THE DAMAGE OCCURRED AT THE CONTRACTOR'S EXPENSE.

IT IS THE CONTRACTOR'S RESPONSIBILITY TO ASCERTAIN EXISTING FIELD CONDITIONS BEFORE BIDDING ON THIS CONTRACT.

EXISTING PAVEMENT THICKNESSES SHOWN ON THE PLANS ARE APPROXIMATE, BASED ON AVAILABLE INFORMATION AT THE TIME OF DESIGN. ANY ADDITIONAL COSTS REQUIRED BY THE CONTRACTOR DUE TO THICKNESSES OTHER THAN THOSE SHOWN ON THE PLANS WILL BE INCLUDED IN THE COST OF THE CONTRACT.

WHERE NEW WORK MEETS EXISTING FEATURES TO REMAIN, THE CONTRACTOR SHALL FIELD CHECK ALL DIMENSIONS AND ELEVATIONS BEFORE PROCEEDING WITH CONSTRUCTION. IMMEDIATELY NOTIFY THE ENGINEER OF ANY DISCREPANCIES.

THE CONTRACTOR WILL BE REQUIRED TO COMPLY WITH ALL STATE REGULATIONS REGARDING AIR, WATER AND NOISE POLLUTION. THE CONTRACTOR IS PROHIBITED FROM BURNING ANY MATERIAL WITHIN OR ADJACENT TO THE IMPROVEMENT.

THE CONTRACTOR SHALL PREPARE THE SUBGRADE IN ACCORDANCE WITH ARTICLE 301.03 OF THE STANDARD SPECIFICATIONS PRIOR TO THE REMOVAL OF ANY UNSTABLE MATERIALS.

ALL DISTURBED AREAS WITHIN THE PROJECT THAT ARE NOT OTHERWISE SURFACED SHALL BE CLEANED, LAYERED WITH TOPSOIL, AND SEEDS AS SHOWN IN THE PLANS. LIMITS SHOWN ON THE PLANS ARE THE MAXIMUM PAY WIDTHS FOR PAYMENT PURPOSES. ADDITIONAL AREAS DAMAGED BY MACHINERY, CONSTRUCTION EQUIPMENT, CONTRACTOR NEGLIGENCE OR OVER-EXCAVATION SHALL BE RESTORED TO A CONDITION EQUAL TO THAT EXISTING BEFORE THE DAMAGE OCCURRED AT THE COST OF THE CONTRACTOR.

THE CONTRACTOR SHALL DISPOSE OF AND REMOVE FROM THE SITE EACH DAY ALL CURB AND GUTTER, PAVEMENT AND ALL OTHER EXCAVATED MATERIAL NOT FOR SALVAGE. THE COST FOR HAULING AND TRUCKING TO DISPOSAL LOCATIONS WILL BE INCLUDED IN THE COST OF THE ITEM BEING REMOVED.

ALL EARTH EXCAVATION OR EMBANKMENT REQUIRED TO CONSTRUCT PROPOSED CONTRACT ITEMS SHALL BE INCLUDED IN THE COST OF THE ITEM BEING INSTALLED.

THE ENGINEER AND CITY ARE NOT RESPONSIBLE FOR THE CONSTRUCTION MEANS, METHODS, TECHNIQUES, SEQUENCES OR PROCEDURES, TIME OF PERFORMANCE, PROGRAMS OR FOR ANY SAFETY PRECAUTIONS USED BY THE CONTRACTOR. THE CONTRACTOR IS SOLELY RESPONSIBLE FOR EXECUTION OF THEIR WORK IN ACCORDANCE WITH THE CONTRACT DOCUMENTS AND SPECIFICATIONS.

BITUMINOUS MATERIALS (PRIME COAT) SHALL BE APPLIED AT A RATE OF 0.1 GALLONS PER SQUARE YARD ON CONCRETE/ASPHALT AND 0.5 GALLONS PER SQUARE YARD ON AGGREGATE. BITUMINOUS MATERIALS SHALL BE SS-1 ON CONCRETE/ASPHALT AND MC-30 ON AGGREGATE.

AGGREGATE (PRIME COAT) SHALL BE MECHANICALLY SPREAD AT A UNIFORM RATE OF 4 POUNDS PER SQUARE YARD.

DRIVEWAY PAVEMENT REMOVAL PAY ITEMS SHALL INCLUDE REMOVAL OF ALL EXISTING MATERIAL (WHETHER ASPHALT, CONCRETE, STONE, OR EARTH) TO A DEPTH OF 9 INCHES FROM PROPOSED DRIVEWAY GRADE FOR PCC DRIVEWAY PAVEMENT AND 10 INCHES FOR STABILIZED DRIVEWAYS.

PAVEMENT WIDENING AREAS FOUR FOOT AND LESS IN WIDTH, ADJACENT TO PROPOSED CURB AND GUTTER, SHALL BE BACKFILLED WITH CLASS SI CONCRETE AND HAVE A HMA SURFACE COURSE AS SHOWN IN THE SPECIAL DETAIL. THE CLASS SI CONCRETE WILL BE CONSIDERED INCLUDED IN THE COST OF THE CURB AND GUTTER.

ANY STRUCTURE TO BE ADJUSTED SHALL HAVE ALL RINGS REMOVED. DETERIORATED RINGS SHALL BE REPLACED. BUTYL ROPE SHALL BE USED WHEN RESETTING THE RINGS AND PRIOR TO ANY MORTAR REPAIR. ALL ADJUSTING RINGS, STRUCTURES AND PIPE ENTRANCES SHALL BE MORTARED (FROM BOTH THE INSIDE AND THE OUTSIDE AS NECESSARY) TO CORRECT ANY EXISTING INFILTRATION. THE GRATE SHALL BE ADJUSTED TO GRADE AS DIRECTED BY THE ENGINEER. THIS WORK WILL NOT BE PAID FOR SEPARATELY BUT SHALL BE INCLUDED IN THE PRICE FOR THE ITEMS TO BE ADJUSTED.

IT IS THE RESPONSIBILITY OF THE CONTRACTOR TO CONTACT ANY RESIDENT OR BUSINESS OF ANY REMOVAL AND REPLACEMENT ACTIVITIES THAT WILL INHIBIT OR PROHIBIT ACCESS TO THEIR DRIVEWAY, IN WRITING, A MINIMUM OF 48 HOURS BUT NOT MORE THAN 72 HOURS, PRIOR TO THE COMMENCEMENT OF THESE ACTIVITIES. THE MORNING OF THE WORK, THE CONTRACTOR SHALL AGAIN NOTIFY THE OWNER VERBALLY, TO ALLOW THE OWNER TIME TO MOVE THEIR VEHICLE SO AS NOT TO PROHIBIT THE VEHICLE FROM LEAVING THE DRIVEWAY UPON REMOVAL OF ANY MATERIAL. THE NOTICE GIVEN OUT BY THE CONTRACTOR SHALL PROVIDE INFORMATION REGARDING THE ANTICIPATED DATE THAT FULL ACCESS WILL BE RESTORED. COORDINATION BETWEEN ACTIVITIES SHOULD ALLOW ALL WORK TO BE DONE IN A TIMELY MANNER SO AS TO PERMIT ACCESS TO THE ROADWAY. ANY ADDITIONAL COST OF STAGING REQUIRED TO MAINTAIN ACCESS IS CONSIDERED INCLUDED IN THE COST OF THE CONTRACT.

NO DRIVEWAY SHALL BE REMOVED UNLESS THE CONTRACTOR HAS SCHEDULED, WITHIN 24 HOURS, THE APPROPRIATE MATERIAL TO REPLACE THE DRIVEWAY.

THE WARRENVILLE FIRE PROTECTION DISTRICT (WFPD) IS LOCATED AT 35472 BATAVIA ROAD, WARRENVILLE, IL. REGULAR BUSINESS HOURS ARE FROM 8:00AM TO 4:30PM, MONDAY THROUGH FRIDAY. THE CONTRACTOR SHALL COORDINATE WITH THE WFPD (630-393-1381) AT LEAST 24 HOURS AND IMMEDIATELY BEFORE ANY WORK OCCURS ON THE FIRE STATION ENTRANCES UNLESS OTHERWISE APPROVED OF BY THE WFPD, AT LEAST HALF OF THE DRIVEWAY IN FRONT OF THE VEHICLE BAYS SHALL REMAIN OPEN AT ALL TIMES.

TRAFFIC CONTROL FOR PATCHES OF THE TYPE AND DEPTH SPECIFIED SHALL BE IN ACCORDANCE WITH ARTICLE 701.17 (E) OF THE STANDARD SPECIFICATIONS, OTHER TRAFFIC CONTROL STANDARDS, DETAILS NOTED HEREIN AND AS DIRECTED BY THE ENGINEER. THE CONTRACTOR SHALL COORDINATE WITH THE WARRENVILLE FIRE PROTECTION DISTRICT AS NOTED HEREIN. ANY PATCHES NEAR THE FIRE STATION MUST BE STAGED SUCH THAT ACCESS IS MAINTAINED AT ALL TIMES.

THE CONTRACTOR WILL BE REQUIRED TO TEMPORARILY RESET ALL EXISTING MAILBOXES WHICH INTERFERE WITH CONSTRUCTION OPERATIONS. AFTER COMPLETION OF ROADWAY CONSTRUCTION, THE CONTRACTOR SHALL SET THE MAILBOXES IN THEIR PERMANENT LOCATIONS AS DIRECTED BY THE ENGINEER. THIS WORK SHALL BE IN CONFORMANCE WITH ARTICLE 107.20 OF THE STANDARD SPECIFICATIONS AND THE COST WILL BE CONSIDERED INCLUDED IN THE COST OF THE CONTRACT.


THE CONTRACTOR SHALL CONTACT THE TRAFFIC CONTROL SUPERVISOR, AT (847) 705-4470 A MINIMUM OF 72 HOURS IN ADVANCE OF BEGINNING WORK.

ALL ROADWAY PATCHING NOT RELATED TO STORM SEWER INSTALLATION SHALL BE COMPLETED AFTER MILLING OPERATIONS.

PCC SIDEWALK AND PCC DRIVEWAY PAVEMENT SHALL HAVE FIBER MESH INSTALLED PER CITY REQUIREMENTS.

DETECTABLE WARNINGS SHALL BE BRICK RED IN COLOR.

STORM SEWER STRUCTURE AND PIPE NOTATION

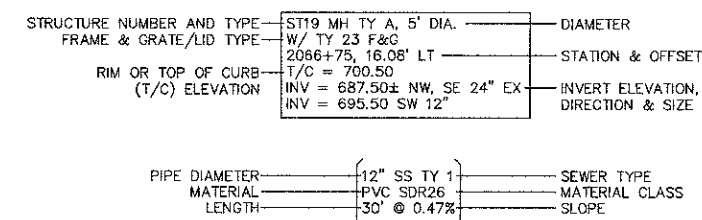

IDOT HIGHWAY STANDARDS

STD. NO.	DESCRIPTION
000001-06	STANDARD SYMBOLS, ABBREVIATIONS, AND PATTERNS
424001-07	PERPENDICULAR CURB RAMPS
424016-01	MID-BLOCK CURB RAMPS
424031-01	MEDIAN PEDESTRIAN CROSSINGS
442101-07	CLASS B PATCHES
442201-03	CLASS C AND D PATCHES
602001-02	CATCH BASIN TYPE A
602011-02	CATCH BASIN TYPE C
602301-03	INLET TYPE A
602306-03	INLET TYPE B
602401-03	MANHOLE TYPE A
602601-02	PRECAST REINFORCED CONCRETE FLAT SLAB TOP
604001-03	FRAME AND LID TYPE 1
604006-04	FRAME AND GRATE TYPE 3
604011-04	FRAME AND GRATE TYPE 3V
604086-02	FRAME AND GRATE TYPE 23
606001-05	CONCRETE CURB TYPE B AND COMBINATION CONCRETE CURB AND GUTTER
606301-04	PC CONCRETE ISLANDS AND MEDIANS
701311-03	LANE CLOSURE, 2L, 2W, MOVING OPERATIONS-DAY ONLY
701501-06	URBAN LANE CLOSURE, 2L, 2W, UNDIVIDED
701606-08	URBAN LANE CLOSURE, MULTILANE, 2W WITH MOUNTABLE MEDIAN
701701-08	URBAN LANE CLOSURE, MULTILANE INTERSECTION
701801-05	LANE CLOSURE MULTILANE, 1W OR 2W CROSSWALK OR SIDEWALK CLOSURE
701901-02	TRAFFIC CONTROL DEVICES
720001-01	SIGN PANEL MOUNTING DETAILS
720006-03	SIGN PANEL ERECTION DETAILS
728001-01	TELESCOPING STEEL SIGN SUPPORT
780001-03	TYPICAL PAVEMENT MARKINGS

Plotted: November 18, 2012 @ 10:26 AM By: Jim Schmidt - Tab: 02 Notes - 2x34
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USER NAME =	DESIGNED - SWM/TVW	REVISED -
PLOT SCALE =	DRAWN - KKP/CLN/JPS	REVISED -
PLOT DATE =	CHECKED - JRL	REVISED -
	DATE - 8/24/12	REVISED -

STATE OF ILLINOIS
DEPARTMENT OF TRANSPORTATION

GENERAL NOTES AND STATE STANDARDS	
SCALE: N/A	SHEET NO. 1 OF 1 SHEETS
STA. N/A TO STA. N/A	

F.A.U. RTE.	SECTION	COUNTY	TOTAL SHEETS	SHEET NO.
3553	10-00031-00-RS	DUPAGE	29	2
CONTRACT NO. 63758				
FED. ROAD DIST. NO. 1 ILLINOIS FED. AID PROJECT - M-900318663				

PROJECT: 10-00031-00-RS-DUPAGE COUNTY DRIVEWAY PAVEMENT - FINAL - ENG - 11/18/12

SUMMARY OF QUANTITIES

SPECIAL PROVISION SPECIALTY ITEM	CODE NO.	ITEM DESCRIPTION	UNIT	URBAN TOTAL QUANTITY	FEDERAL = 70%	
					CITY = 30%	
					ROADWAY	TRANIEES
					0005	0042
	21101615	TOPSOIL FURNISH AND PLACE, 4"	SQ YD	2,286	2,286	
	21301072	EXPLORATION TRENCH 72" DEPTH	FOOT	250	250	
	25000110	SEEDING, CLASS 1A	ACRE	0.5	0.5	
	25000400	NITROGEN FERTILIZER NUTRIENT	POUND	43	43	
	25000500	PHOSPHORUS FERTILIZER NUTRIENT	POUND	43	43	
	25000600	POTASSIUM FERTILIZER NUTRIENT	POUND	43	43	
Δ	25100630	EROSION CONTROL BLANKET	SQ YD	2,286	2,286	
	31101200	SUBBASE GRANULAR MATERIAL, TYPE B 4"	SQ YD	2,138	2,138	
Δ	40201000	AGGREGATE FOR TEMPORARY ACCESS	TON	250	250	
	40600100	BITUMINOUS MATERIALS (PRIME COAT)	GALLON	1,063	1,063	
	40600300	AGGREGATE (PRIME COAT)	TON	21	21	
	40600882	HOT-MIX ASPHALT SURFACE REMOVAL - BUTT JOINT	SQ YD	121	121	
	40603335	HOT-MIX ASPHALT SURFACE COURSE, MIX "D", N50	TON	82	82	
	40603340	HOT-MIX ASPHALT SURFACE COURSE, MIX "D", N70	TON	1,183	1,183	
	42001300	PROTECTIVE COAT	SQ YD	2,425	2,425	
	42300300	PORTLAND CEMENT CONCRETE DRIVEWAY PAVEMENT, 7 INCH	SQ YD	257	257	
	42400200	PORTLAND CEMENT CONCRETE SIDEWALK 5 INCH	SQ FT	5,104	5,104	
	42400400	PORTLAND CEMENT CONCRETE SIDEWALK 7 INCH	SQ FT	1,131	1,131	
	42400800	DETECTABLE WARNINGS	SQ FT	200	200	
	44000200	DRIVEWAY PAVEMENT REMOVAL	SQ YD	268	268	
	44000500	COMBINATION CURB AND GUTTER REMOVAL	FOOT	6,504	6,504	
	44000600	SIDEWALK REMOVAL	SQ FT	2,330	2,330	
	44003100	MEDIAN REMOVAL	SQ FT	503	503	
Δ	44200906	CLASS B PATCHES, TYPE I, 10 INCH	SQ YD	53	53	
Δ	44200970	CLASS B PATCHES, TYPE II, 10 INCH	SQ YD	149	149	
Δ	44200974	CLASS B PATCHES, TYPE III, 10 INCH	SQ YD	54	54	
Δ	44200976	CLASS B PATCHES, TYPE IV, 10 INCH	SQ YD	191	191	
	44201690	CLASS D PATCHES, TYPE I, 4 INCH	SQ YD	2	2	
	44201698	CLASS D PATCHES, TYPE IV, 4 INCH	SQ YD	382	382	
	44201789	CLASS D PATCHES, TYPE III, 10 INCH	SQ YD	68	68	
	44300200	STRIP REFLECTIVE CRACK CONTROL TREATMENT	FOOT	6,246	6,246	
	55000050	STORM SEWERS, CLASS B, TYPE 1 12"	FOOT	316	316	
	55100300	STORM SEWER REMOVAL 8"	FOOT	105	105	
	55100500	STORM SEWER REMOVAL 12"	FOOT	27	27	
Δ *	56106300	ADJUSTING WATER MAIN 6"	FOOT	150	150	
*	56400100	FIRE HYDRANTS TO BE MOVED	EACH	1	1	
	60200305	CATCH BASINS, TYPE A, 4'-DIAMETER, TYPE 3 FRAME AND GRATE	EACH	3	3	
	60200310	CATCH BASINS, TYPE A, 4'-DIAMETER, TYPE 3V FRAME AND GRATE	EACH	5	5	
	60207105	CATCH BASINS, TYPE C, TYPE 3 FRAME AND GRATE	EACH	2	2	
	60207115	CATCH BASINS, TYPE C, TYPE 3V FRAME AND GRATE	EACH	11	11	
	60208230	CATCH BASINS, TYPE C, TYPE 23 FRAME AND GRATE	EACH	2	2	

Δ SEE SPECIAL PROVISIONS
* SPECIALTY ITEMS

SPECIAL PROVISION SPECIALTY ITEM	CODE NO.	ITEM DESCRIPTION	UNIT	URBAN TOTAL QUANTITY	FEDERAL = 70%	
					CITY = 30%	
					ROADWAY	TRANIEES
					0005	0042
	60218400	MANHOLES, TYPE A, 4'-DIAMETER, TYPE 1 FRAME, CLOSED LID	EACH	2	2	
	60222230	MANHOLES, TYPE A, 5'-DIAMETER, TYPE 23 FRAME AND GRATE	EACH	2	2	
	60255500	MANHOLES TO BE ADJUSTED	EACH	1	1	
	60260500	INLETS TO BE ADJUSTED WITH NEW TYPE 3 FRAME AND GRATE	EACH	2	2	
	60260505	INLETS TO BE ADJUSTED WITH NEW TYPE 3V FRAME AND GRATE	EACH	5	5	
	60266600	VALVE BOXES TO BE ADJUSTED	EACH	1	1	
	60500040	REMOVING MANHOLES	EACH	1	1	
	60500080	REMOVING INLETS	EACH	12	12	
	60618300	CONCRETE MEDIAN SURFACE, 4 INCH	SQ FT	288	288	
Δ *	66900200	NON-SPECIAL WASTE DISPOSAL	CU YD	6	6	
Δ *	66900450	SPECIAL WASTE PLANS AND REPORTS	L SUM	1	1	
	67100100	MOBILIZATION	L SUM	1	1	
	70106800	CHANGEABLE MESSAGE SIGN	CAL MO	3	3	
	70300100	SHORT TERM PAVEMENT MARKING	FOOT	1,305	1,305	
	70300210	TEMPORARY PAVEMENT MARKING LETTERS AND SYMBOLS	SQ FT	5	5	
	70300220	TEMPORARY PAVEMENT MARKING - LINE 4"	FOOT	1,105	1,105	
	70301000	WORK ZONE PAVEMENT MARKING REMOVAL	SQ FT	435	435	
*	78000100	THERMOPLASTIC PAVEMENT MARKING - LETTERS AND SYMBOLS	SQ FT	4.6	4.6	
*	78000200	THERMOPLASTIC PAVEMENT MARKING - LINE 4"	FOOT	6,352	6,352	
*	78000400	THERMOPLASTIC PAVEMENT MARKING - LINE 6"	FOOT	535	535	
*	78000600	THERMOPLASTIC PAVEMENT MARKING - LINE 12"	FOOT	50	50	
*	78000650	THERMOPLASTIC PAVEMENT MARKING - LINE 24"	FOOT	100	100	
	78300100	PAVEMENT MARKING REMOVAL	SQ FT	145	145	
	78300200	RAISED REFLECTIVE PAVEMENT MARKER REMOVAL	EACH	140	140	
Δ	X4400157	HOT-MIX ASPHALT SURFACE REMOVAL, 2" SPECIAL	SQ YD	10,738	10,738	
Δ	X4401198	HOT-MIX ASPHALT SURFACE REMOVAL, VARIABLE DEPTH	SQ YD	96	96	
Δ	X6026050	SANITARY MANHOLES TO BE ADJUSTED	EACH	5	5	
Δ	X6060048	COMBINATION CONCRETE CURB AND GUTTER, TYPE B-6.18 (SPECIAL)	FOOT	6,246	6,246	
Δ	X7010216	TRAFFIC CONTROL AND PROTECTION, (SPECIAL)	L SUM	1	1	
Δ *	X7810300	RECESSED REFLECTIVE PAVMENT MARKER	EACH	146	146	
Δ	XX006215	BRICK PAVER REMOVAL AND REPLACEMENT	SQ YD	26	26	
Δ	XX008457	WHEEL STOP REMOVAL AND REPLACEMENT	EACH	5	5	
Δ	XX008200	STABILIZED DRIVEWAY PAVEMENT	SQ YD	206	206	
Δ	Z0004544	HOT-MIX ASPHALT DRIVEWAY PAVEMENT REMOVAL	SQ YD	764	764	
Δ	Z0030850	TEMPORARY INFORMATION SIGNING	SQ FT	82	82	
Δ	Z0056648	STORM SEWERS, TYPE 1, WATER MAIN QUALITY PIPE, 12"	FOOT	113	113	
Δ	Z0066700	STABILIZED DRIVEWAYS 10"	SQ YD	517	517	
Δ	Z0076600	TRIANEES	HOUR	500		500
Δ	Z0078604	TRIANEES TRAINING PROGRAM GRADUATE	HOUR	500		500
Δ	XX008743	STORM SEWERS, CLASS B, TYPE 1 8"	FOOT	20	20	

Plotted: November 2, 2012 @ 12:11 PM By: Jim Scamilli - Tab: 03 Quantities - 22-134
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	DATE - 8/24/12	REVISED -


**STATE OF ILLINOIS
DEPARTMENT OF TRANSPORTATION**

SUMMARY OF QUANTITIES

SCALE: N/A SHEET NO. 1 OF 1 SHEETS STA. N/A TO STA. N/A


F.A.U. RTE.	SECTION	COUNTY	TOTAL SHEETS	SHEET NO.
3553	10-00031-00-RS	DUPAGE	29	3
FED. ROAD DIST. NO. 1 [ILLINOIS]			CONTRACT NO. 63758	
FED. AID PROJECT - M-9003866				

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EXISTING TYPICAL SECTION

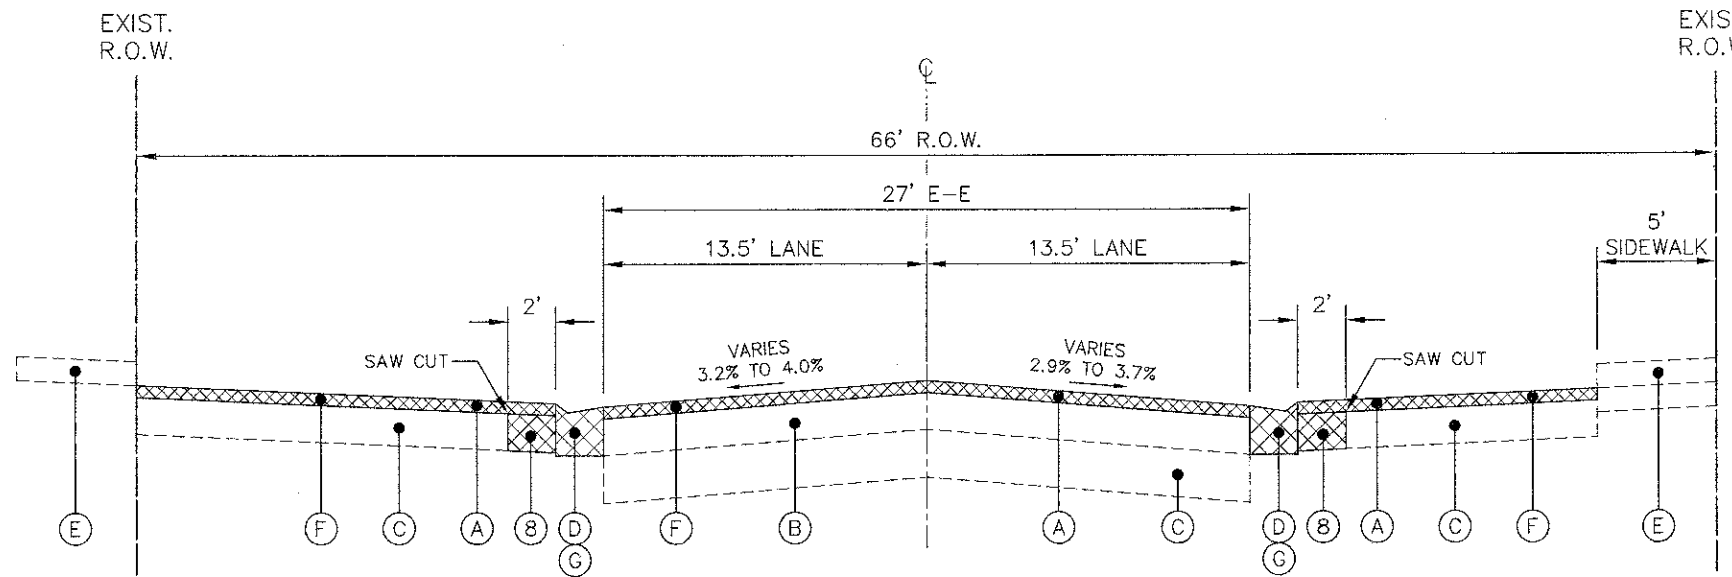BATAVIA ROAD
STA 2048+50 TO STA 2051+42
N.T.S.




PROPOSED TYPICAL SECTION

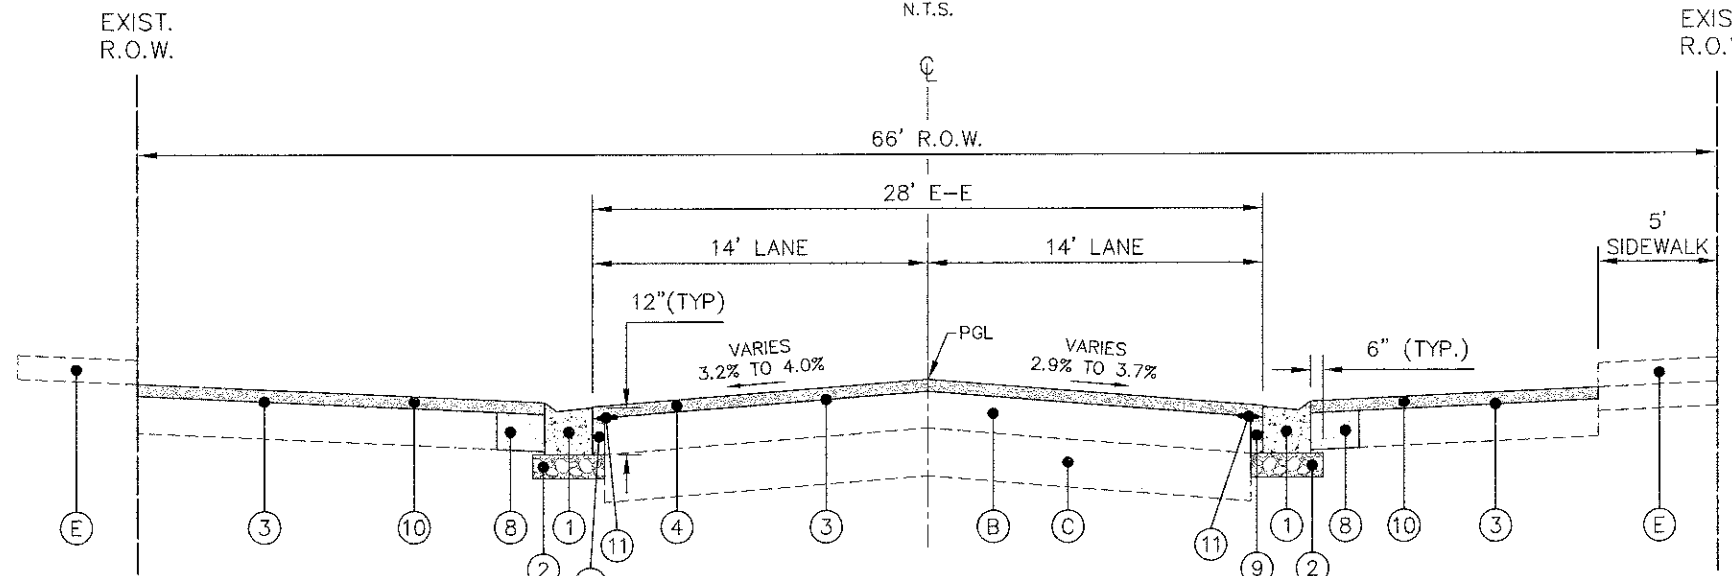BATAVIA ROAD
STA 2048+50 TO STA 2051+42
N.T.S.

EXISTING PAVEMENT CORE DATA

CORE NUMBER	1	2	3	4
APPROXIMATE STATION	2050+20 6' RT	2064+50 6' RT	2074+30 4' LT	2057+30 4' LT
ASPHALT OVERLAY	1.5"	1.75"	1.25"	2.25"
REINFORCED CONCRETE	10.5"	11"	10"	10.75"
STONE SUBBASE	18"	17.25"	18.75"	17"

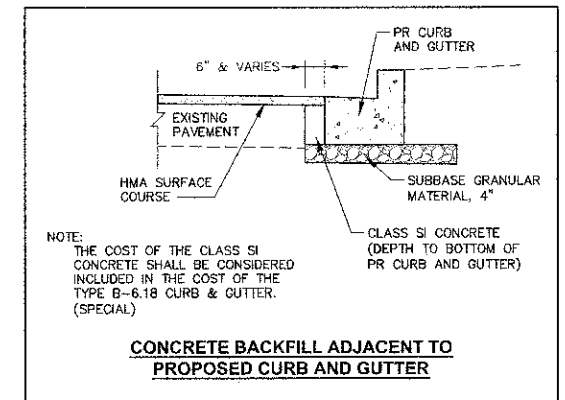

NOTE:
THE COST OF THE CLASS SI
CONCRETE SHALL BE CONSIDERED
INCLUDED IN THE COST OF THE
TYPE B-6.18 CURB & GUTTER.
(SPECIAL)

**CONCRETE BACKFILL ADJACENT TO
PROPOSED CURB AND GUTTER**

LEGEND	
(A) EXISTING ASPHALT SURFACE	(1) COMBINATION CONCRETE CURB AND GUTTER, TYPE B-6.18 (SPECIAL)
(B) EXISTING REINFORCED CONCRETE BASE	(2) SUBBASE GRANULAR MATERIAL, TYPE B, 4"
(C) EXISTING AGGREGATE SUBBASE	(3) BITUMINOUS MATERIALS (PRIME COAT) AND AGGREGATE (PRIME COAT)
(D) EXISTING COMBINATION CONCRETE CURB AND GUTTER, TYPE B-6.18	(4) HOT-MIX ASPHALT SURFACE COURSE, MIX "D", N70, 2.0"
(E) EXISTING PORTLAND CEMENT CONCRETE SIDEWALK	(5) TOPSOIL, 4", SEEDING, FERTILIZER, EROSION CONTROL BLANKET
(F) HOT-MIX ASPHALT SURFACE REMOVAL, 2" SPECIAL	(6) PORTLAND CEMENT CONCRETE SIDEWALK, 5" (7" AT DRIVEWAYS)
(G) COMBINATION CURB AND GUTTER REMOVAL	(7) AGGREGATE BASE COURSE, TYPE B, 2" (INCLUDED IN COST OF SIDEWALK)
(H) SIDEWALK REMOVAL - SPOT REPAIR / LOCATIONS VARY	(8) CLASS D PATCH, 4"
	(9) CONCRETE BACKFILL - SEE DETAIL
	(10) HOT-MIX ASPHALT SURFACE COURSE, MIX "D", N50, 2.0"
	(11) STRIP REFLECTIVE CRACK CONTROL TREATMENT

HOT-MIX ASPHALT MIXTURE REQUIREMENTS

ALL ROADWAY PATCHING NOT RELATED TO STORM SEWER INSTALLATION SHALL BE COMPLETED AFTER MILLING OPERATIONS.

OPERATION	MIXTURE TYPE	AIR VOIDS @ Ndes
ROADWAY RESURFACING	HOT-MIX ASPHALT SURFACE COURSE, MIX "D", N70 (IL-9.5 mm), 2.0"	4% @ 70 Gyr.
PARKING RESURFACING	HOT-MIX ASPHALT SURFACE COURSE, MIX "D", N50 (IL-9.5 mm), 2.0"	4% @ 50 Gyr.
DRIVEWAY RECONSTRUCTION (PE)	STABILIZED DRIVEWAYS, 10" HMA SURFACE COURSE, MIX "D", N50 (IL-9.5 mm), 2.0"	4% @ 50 Gyr.
DRIVEWAY RECONSTRUCTION (CE)	STABILIZED DRIVEWAY PAVEMENT HMA BINDER COURSE, IL-19.0, N50, 2.25" HMA SURFACE COURSE, MIX "D", N50 (IL-9.5 mm), 2.0"	4% @ 50 Gyr. 4% @ 80 Gyr.
PATCHING	CLASS D PATCHES, 4" HMA BINDER COURSE, IL-19.0, N70, 4.0"	4% @ 70 Gyr.
	CLASS D PATCHES, 10" HMA BINDER COURSE, IL-19.0, N70, 10.0" (3 LIFTS)	4% @ 70 Gyr.

THE UNIT WEIGHT USED TO CALCULATE ALL HMA SURFACE MIXTURE QUANTITIES IS 112 LBS/SQ YD INCH.

THE "AC TYPE" FOR POLYMERIZED HMA MIXES SHALL BE "SBS/SBR PG 76-22" AND FOR NON-POLYMERIZED HMA THE "AC TYPE" SHALL BE "PG 64-22" UNLESS MODIFIED BY DISTRICT ONE SPECIAL PROVISIONS. FOR "PERCENT OF RAP" SEE SPECIAL PROVISIONS.

Plot Date: October 19, 2012 @ 7:13 AM By: Jim Schmidt - Tab: 04 Typ Section - 22a34


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**STATE OF ILLINOIS
DEPARTMENT OF TRANSPORTATION**


EXISTING AND PROPOSED TYPICAL SECTIONS	
SCALE: N/A	SHEET NO. 1 OF 3 SHEETS
STA. N/A	TO STA. N/A

F.A.U. RTE.	SECTION	COUNTY	TOTAL SHEETS	SHEET NO.
3553	10-00031-00-RS	DUPAGE	29	4
FED. ROAD DIST. NO. 1 ILLINOIS FED. AID PROJECT - M-30030667			CONTRACT NO. 63758	



EXISTING TYPICAL SECTION

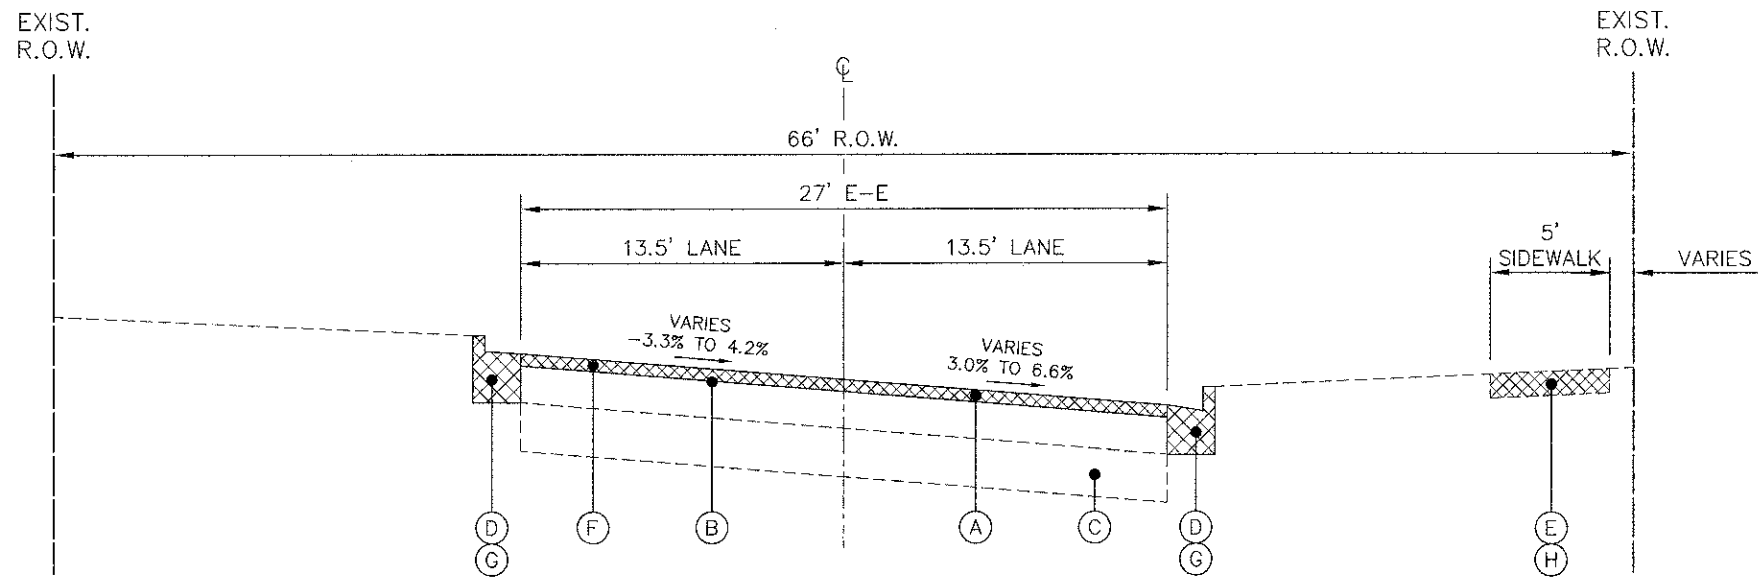BATAVIA ROAD
STA 2065+00 TO STA 2072+50
N.T.S.

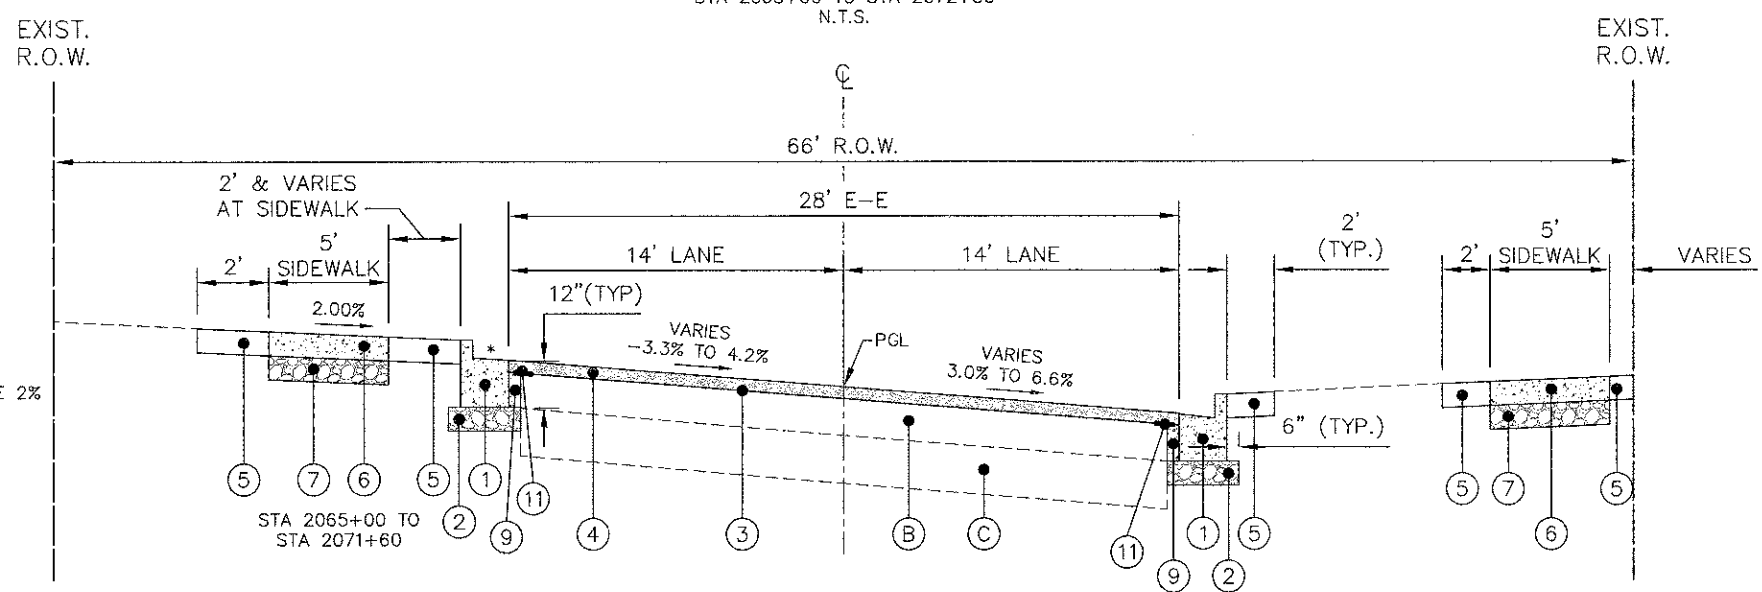

PROPOSED TYPICAL SECTION

BATAVIA ROAD
STA 2065+00 TO STA 2072+50
N.T.S.

* REVERSE GUTTER SLOPE 2% APPROXIMATELY STA 2065+00 TO STA 2071+00

LEGEND

- (A) EXISTING ASPHALT SURFACE
- (B) EXISTING REINFORCED CONCRETE BASE
- (C) EXISTING AGGREGATE SUBBASE
- (D) EXISTING COMBINATION CONCRETE CURB AND GUTTER, TYPE B-6.18
- (E) EXISTING PORTLAND CEMENT CONCRETE SIDEWALK
- (F) HOT-MIX ASPHALT SURFACE REMOVAL, 2" SPECIAL
- (G) COMBINATION CURB AND GUTTER REMOVAL
- (H) SIDEWALK REMOVAL - SPOT REPAIR / LOCATIONS VARY
- (1) COMBINATION CONCRETE CURB AND GUTTER, TYPE B-6.18 (SPECIAL)
- (2) SUBBASE GRANULAR MATERIAL, TYPE B, 4"
- (3) BITUMINOUS MATERIALS (PRIME COAT) AND AGGREGATE (PRIME COAT)
- (4) HOT-MIX ASPHALT SURFACE COURSE, MIX "D", N70, 2.0"
- (5) TOPSOIL, 4", SEEDING, FERTILIZER, EROSION CONTROL BLANKET
- (6) PORTLAND CEMENT CONCRETE SIDEWALK, 5" (7" AT DRIVEWAYS)
- (7) AGGREGATE BASE COURSE, TYPE B, 2" (INCLUDED IN COST OF SIDEWALK)
- (8) CLASS D PATCH, 4"
- (9) CONCRETE BACKFILL - SEE DETAIL
- (10) HOT-MIX ASPHALT SURFACE COURSE, MIX "D", N50, 2.0"
- (11) STRIP REFLECTIVE CRACK CONTROL TREATMENT

Plotted: October 11, 2012 @ 11:09 AM By: Jim Schmidt - Job: 06 Typ: Section - 22x34
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	DATE - 8/24/12	REVISED -

**STATE OF ILLINOIS
DEPARTMENT OF TRANSPORTATION**

EXISTING AND PROPOSED TYPICAL SECTIONS

SCALE: N/A	SHEET NO. 3 OF 3 SHEETS	STA. N/A TO STA. N/A
------------	-------------------------	----------------------

F.A.U. RTE.	SECTION	COUNTY	TOTAL SHEETS	SHEET NO.
3553	10-00031-00-RS	DUPAGE	29	6
FED. ROAD DIST. NO. 1 ILLINOIS			CONTRACT NO. 63758	
FED. AID PROJECT - M-90038661				

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ROADWAY QUANTITIES												
STATION	STATION	HMA SURF REM 2 SPL	HMA SURF REM BUTT JT	HMA SURF REM VAR DEPTH	COMB CURB GUTTER REM	COMB CC&G TB&18 SPL	SUB GRAN MTL B 4	HMA SC "D" N50 (2')	HMA SC "D" N70 (2')	STRIP REF OR CON TR	BIT MATLS PR CT	AGG PR CT
		SQ YD	SQ YD	SQ YD	FOOT	FOOT	SQ YD	TON	TON	FOOT	GAL	TON
2048+50	2050+50	1,182	14		400	400	137	85	67	400	59	1
2050+50	2058+50	2,400	32	60	1,810	1,488	509	17	289	1,488	265	5
2058+50	2066+50	2,400	19		1,600	1,524	522		283	1,524	253	5
2066+50	2074+50	2,400	18	36	1,624	1,564	535		280	1,564	250	5
2074+50	2081+05	2,356	38		1,270	1,270	435		264	1,270	236	5
TOTAL		10,738	121	96	6,504	6,246	2,138	82	1,183	6,246	1,063	21

PATCHING								
STATION	STATION	CL B PATCH T1 10	CL B PATCH T2 10	CL B PATCH T3 10	CL B PATCH T4 10	CL D PATCH T3 10	CL D PATCH T4 4	CL D PATCH T4 4
		SQ YD	SQ YD	SQ YD	SQ YD	SQ YD	SQ YD	SQ YD
2048+50	2050+50	4					2	112
2050+50	2058+50	26	33	24		33		113
2058+50	2066+50	11	36	30	31	20		112
2066+50	2074+50	6	68		25	15		45
2074+50	2081+05	6	12		135			
TOTAL		53	149	54	191	68	2	382

LANDSCAPING							
STATION	STATION	NITROGEN FERT NUTR POUND	PHOSPHOROUS FERT NUTR POUND	POTASSIUM FERT NUTR POUND	EROSION CONTROL BLANKET SQ YD	SEEDING CLASS 1A ACRE	TOPSOIL F&P 4" SQ YD
2048+50	2050+50	2	2	2	93	0.02	93
2050+50	2058+50	9	9	9	477	0.10	477
2058+50	2066+50	11	11	11	572	0.12	572
2066+50	2074+50	14	14	14	763	0.16	753
2074+50	2081+05	7	7	7	391	0.08	391
TOTAL		43	43	43	2,286	0.5	2,286

DRIVEWAY PAVEMENT, MEDIAN, AND SIDEWALK													
STATION	STATION	DRIVEWAY PAVEMENT REM SQ YD	HMA DRIVEWAY PVT REM SQ YD	BRICK PAVER R&R SQ YD	SIDEWALK REM SQ FT	MEDIAN REM SQ FT	CONC MEDIAN SURF 4 SQ FT	PC CONC SIDEWALK 5 SQ FT	PC CONC SIDEWALK 7 SQ FT	DETECTABLE WARNINGS SQ FT	PCC DRIVEWAY PAVT 7 SQ YD	STAB DRIVE PAVEMENT SQ YD	STAB DRIVEWAYS 10 SQ YD
2048+50	2050+50				125		125			60	49		178
2050+50	2058+50	49	178		1,107		857	250		40	62		112
2058+50	2066+50	73	124	26	320		1,178	397		60	66	47	151
2066+50	2074+50	66	227		400		2,731	319		40	80	159	76
2074+50	2081+05	80	235		378	268	520	213	165	40	80	159	76
TOTAL		268	764	26	2,330	288	5,104	1,131	200	257	206	517	

PAVEMENT MARKING								
THERMOPLASTIC PAVEMENT MARKINGS								
STATION	STATION	4" YELLOW FOOT	6" WHITE FOOT	12" WHITE FOOT	24" WHITE FOOT	LETTER & SYMBOLS SQ FT	REC REF PVT MARKER EACH	
2048+50	2050+50	380	669			4.6	10	
2050+50	2058+50	1,316		190		35	34	
2058+50	2066+50	1,406		170		22	36	
2066+50	2074+50	1,454		140		15	38	
2074+50	2081+05	1,050	48	35	50	26	28	
TOTAL		6,352	535	50	100	4.6	146	

STORM SEWER AND STORM SEWER STRUCTURES																		
STRUCTURE NUMBER	STATION	OFFSET	LT/RT	CB TC T3V F&G	CB TC T3 F&G	CB TC T23 F&G	CB TA 4 DIA T3 F&G	CB TA 4 DIA T3V F&G	MH TA 4 DIA T1 CL	MH TA 5 DIA TY 23 F&G	PIPE DIA	LENGTH	SLOPE	SS TY 1. VM QUAL PIPE 12	STORM SEW CL B 18 (PVC SDR 26)	STORM SEW CL B 12 (PVC SDR 26)		
				EACH	EACH	EACH	EACH	EACH	EACH	EACH	INCH	FOOT	%	FOOT	FOOT	FOOT		
ST01	2049+92	16.08	RT	1														
ST02	2049+94	16.08	LT					1										
ST07	2051+90	16.08	RT	1							12	27	0.44	27				
ST06	2052+12.34	28.34	RT	1							12	41	0.44	41				
ST05	2052+95.76	28.68	RT	1							12	45	0.67	45				
ST04	2052+98	16.08	RT					1			12	30	0.6			30		
ST03	2052+98	16.08	LT	1							8	20	0.5		20			
ST08	2054+96	16.08	RT			1												
ST13	2055+80.67	28.33	RT	1							12	35	0.46			35		
ST12	2055+95.64	18.65	RT	1							12	18	0.67			18		
ST11	2056+14.1	16.71	RT			1			1		12	66	0.3			66		
ST10	2056+50	16.08	RT	1														
ST09	2056+51	16.08	LT	1														
ST14	2059+83	16.08	RT	1														
ST17	2053+48.16	27.28	RT		1						12	52	0.44			52		
ST16	2054+02.13	25.83	RT					1			12	45	0.44			45		
ST15	2083+97	20.28	LT						1									
ST18	2065+44	16.08	LT		1													
ST20	2066+75	16.08	RT					1			12	30	0.47			30		
ST19	2065+75	16.08	LT						1									
ST22	2069+25	16.08	RT						1		12	30	0.47			30		
ST21	2069+25	16.08	LT							1								
ST23	2070+47	16.08	RT							1								
ST24	2070+57	16.08	RT							1						10		
ST25	2072+12.48	21.69	RT							1								
ST26	2072+58	16.08	LT	1														
ST27	2077+09	16.08	LT	1														
TOTAL				11	2	2	3	5	2	2				113	20	316		

FOR STORM SEWERS: STATION SHOWN IS FOR THE UPSTREAM END OF THE PIPE

STRUCTURE ADJUSTMENT SCHEDULE								
STATION	OFFSET	LT/RT	INLETS ADJ NEW T3 F&G EACH	INLETS ADJ NEW T3V F&G EACH	MAN ADJUST EACH	SANITARY MANHOLE ADJ EACH	FIRE HYDNTS TO BE MVD EACH	VALVE BOX ADJ EACH
2062+56	17.48	RT				1		
2062+56	22.28	RT						1
2064+96	16.08	LT	1					
2055+55	19.05	RT				1		
2056+80	16.82	RT			1			
2059+82	16.08	RT		1				
2061+99	16.80	RT				1		
2062+90	17.47	RT						
2085+43	16.08	RT		1				
2067+49	23.09	LT					1	
2087+99	16.08	RT		1				
2072+57	16.08	RT		1				
2077+10	16.06	RT		1				
2077+70	22.78	LT				1		
2080+43	16.57	RT	1					
TOTAL			2	6	1	5	1	1

STRUCTURE REMOVAL SCHEDULE					
STATION	OFFSET	LT/RT	REMOV INLETS EACH	REMOV MANHOLES EACH	
2049+92	16.55	RT	1		
2049+94	16.77	LT	1		
2052+98	16.58	RT	1		
2052+98	15.50	LT	1		
2054+96	16.50	RT	1		
2055+95	18.65	RT		1	
2056+80	15.50	RT	1		
2056+81	15.50	LT	1		
2059+83	15.50	LT	1		
2065+44	15.60	LT	1		
2070+47	15.50	RT	1		
2072+58	15.50	LT	1		
2077+09	15.50	LT	1		
TOTAL			12	1	

Plotted: October 15, 2012 @ 9:37 AM By: Jm Schmidt - Tab: 07 Schedule - 22x34

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PLOT DATE =	CHECKED - JRL	REVISED -
	DATE - 8/24/12	REVISED -






**STATE OF ILLINOIS
DEPARTMENT OF TRANSPORTATION**

SCHEDULE OF QUANTITIES

SCALE: N/A SHEET NO. 1 OF 1 SHEETS STA. N/A TO STA. N/A

F.A.U. RTE.	SECTION	COUNTY	TOTAL SHEETS	SHEET NO.
3553	10-00031-00-RS	DUPAGE	29	7
FED. ROAD DIST. NO. 1 ILLINOIS			FED. AID PROJECT - M-90031866	
			CONTRACT NO. 63758	

Path: \\S:\P\000\W\003\DWG\DWG_FINAL_EIG\W\003-C\01

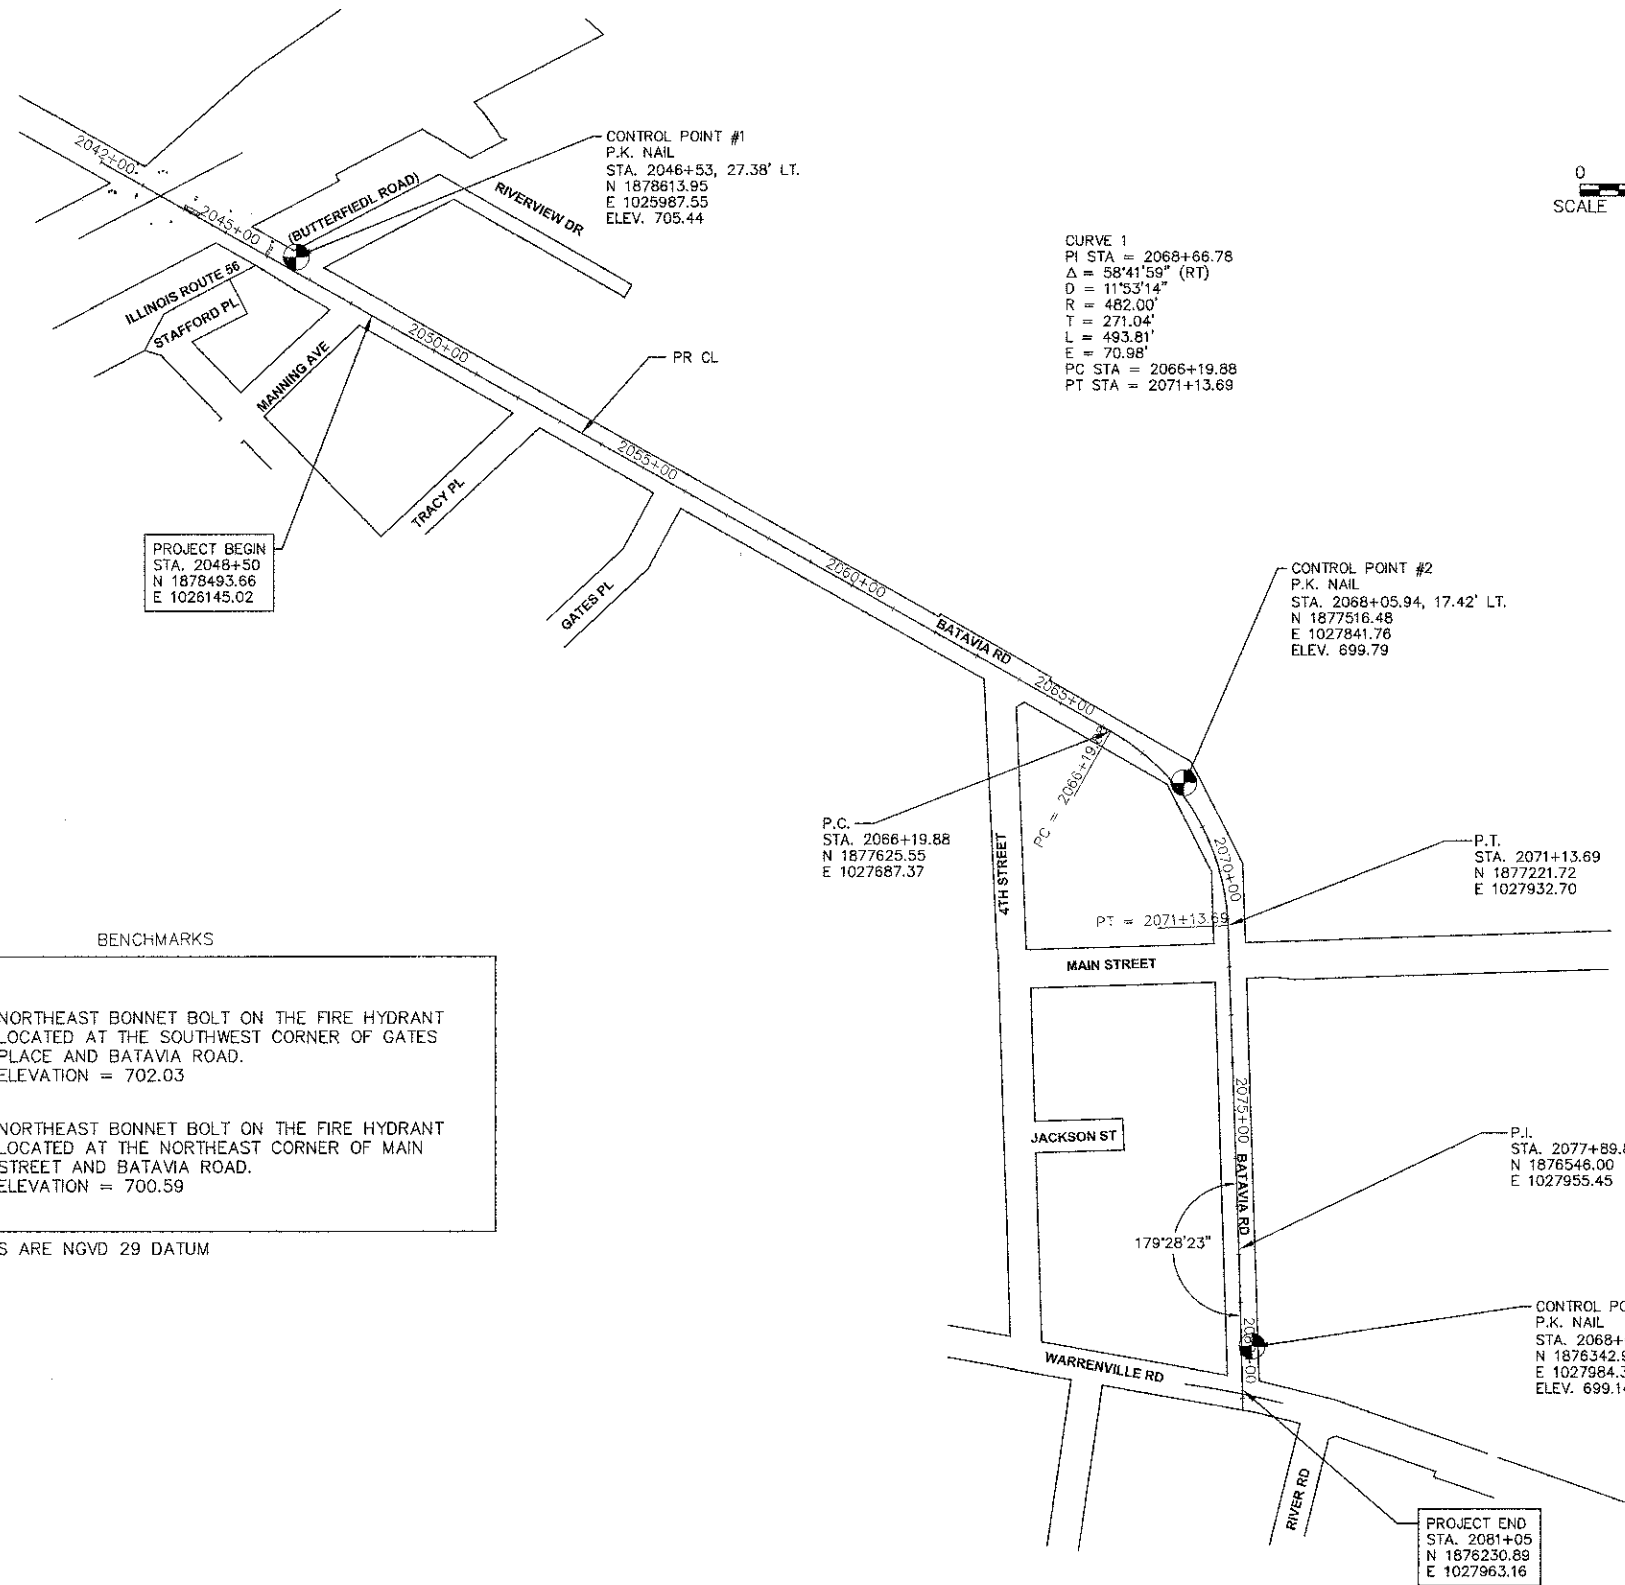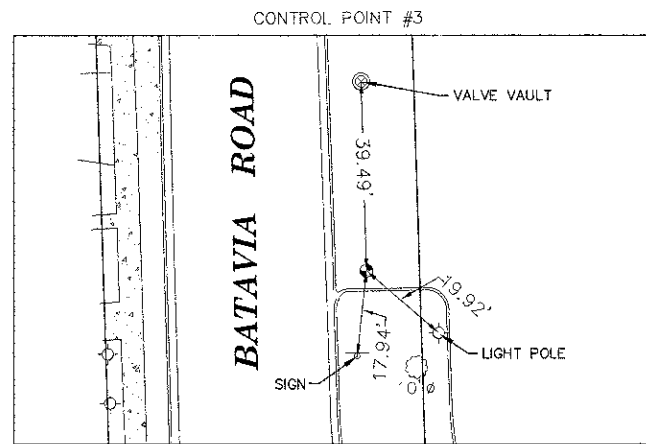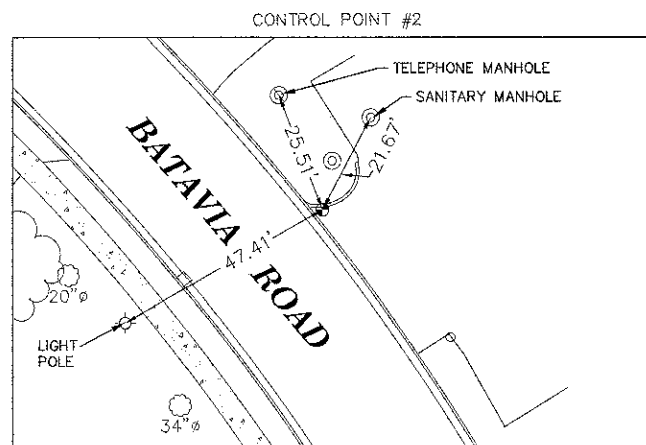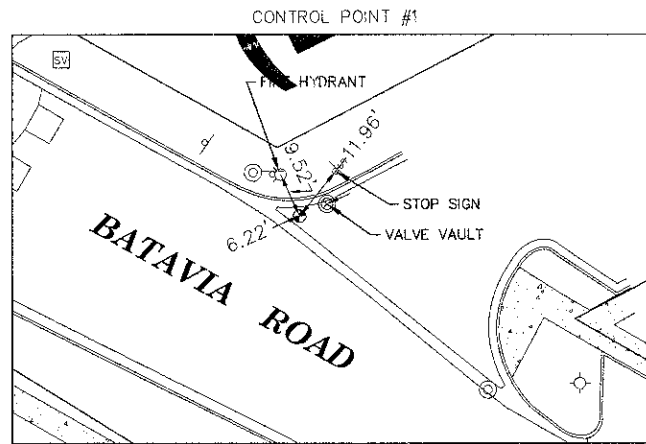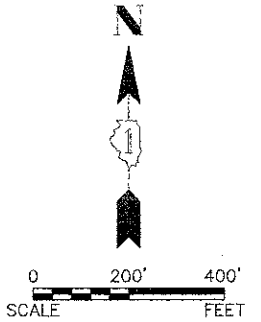

BENCHMARKS




BM#1	NORTHEAST BONNET BOLT ON THE FIRE HYDRANT LOCATED AT THE SOUTHWEST CORNER OF GATES PLACE AND BATAVIA ROAD. ELEVATION = 702.03
BM#2	NORTHEAST BONNET BOLT ON THE FIRE HYDRANT LOCATED AT THE NORTHEAST CORNER OF MAIN STREET AND BATAVIA ROAD. ELEVATION = 700.59

ELEVATIONS ARE NGVD 29 DATUM

CURVE 1
 PI STA = 2068+66.78
 $\Delta = 58^{\circ}41'59''$ (RT)
 $D = 11^{\circ}53'14''$
 $R = 482.00'$
 $T = 271.04'$
 $L = 493.81'$
 $E = 70.98'$
 PC STA = 2066+19.88
 PT STA = 2071+13.69

Plotted: October 11, 2012 @ 11:38 AM By: Jim Schmidt - Tab: 08 Alignment - 22x34
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Engineering Enterprises, Inc. CONSULTING ENGINEERS 52 Wheeler Road Sugar Grove, Illinois 60554 630.466.6700 / www.eeiweb.com	USER NAME =	DESIGNED - SWM/TWV	REVISED -	STATE OF ILLINOIS DEPARTMENT OF TRANSPORTATION	ALIGNMENT, TIES, AND BENCHMARKS	F.A.U. RTE. 3553	SECTION 10-00031-00-RS	COUNTY DUPAGE	TOTAL SHEETS 29	SHEET NO. 8		
	PLOT SCALE =	DRAWN - KKP/CLN/IPS	REVISED -			SCALE: N/A	SHEET NO. 1 OF 1 SHEETS	STA. N/A TO STA. N/A	CONTRACT NO. 63758			
PLOT DATE =	CHECKED - JRL	REVISED -				FED. ROAD DIST. NO. 1 [ILLINOIS] FED. AID PROJECT - M-9003866						
	DATE - 8/24/12	REVISED -										

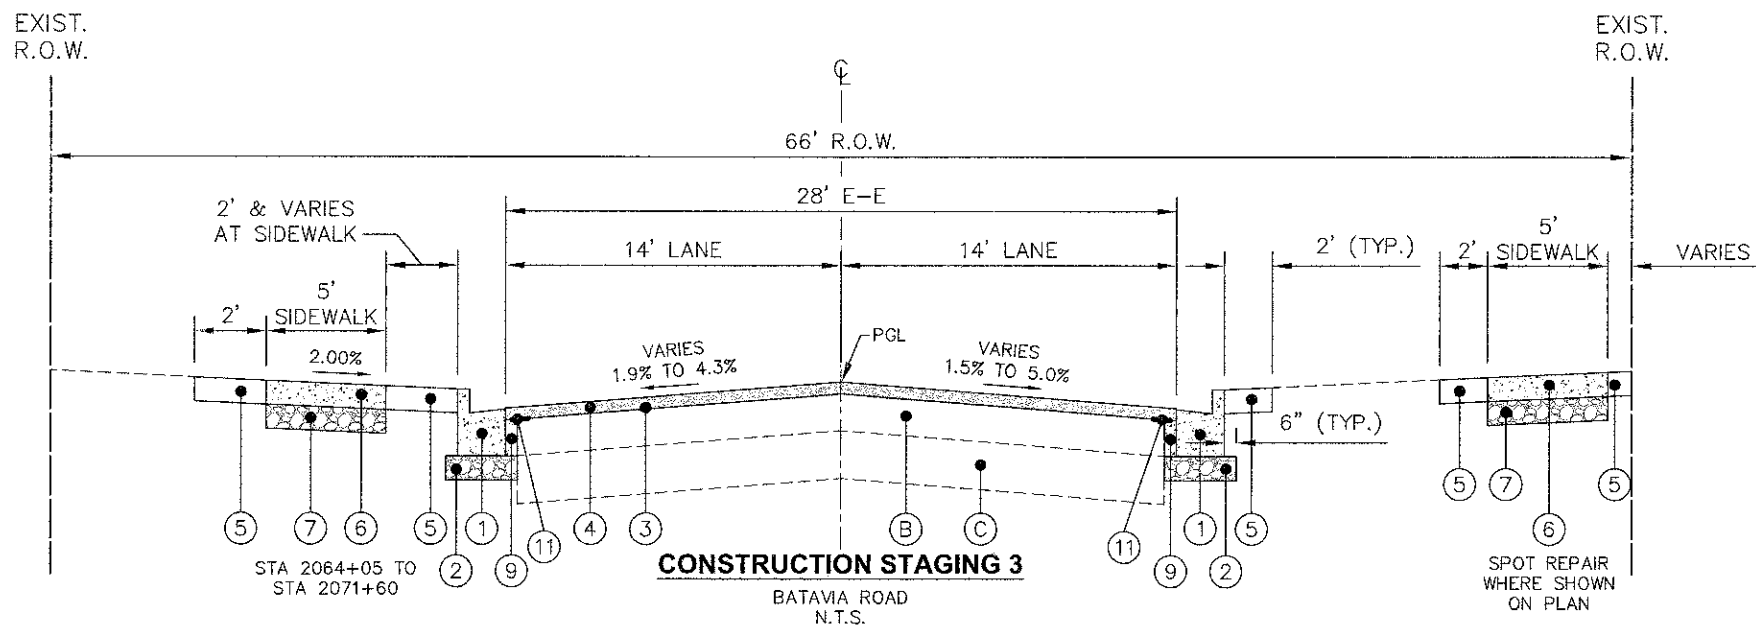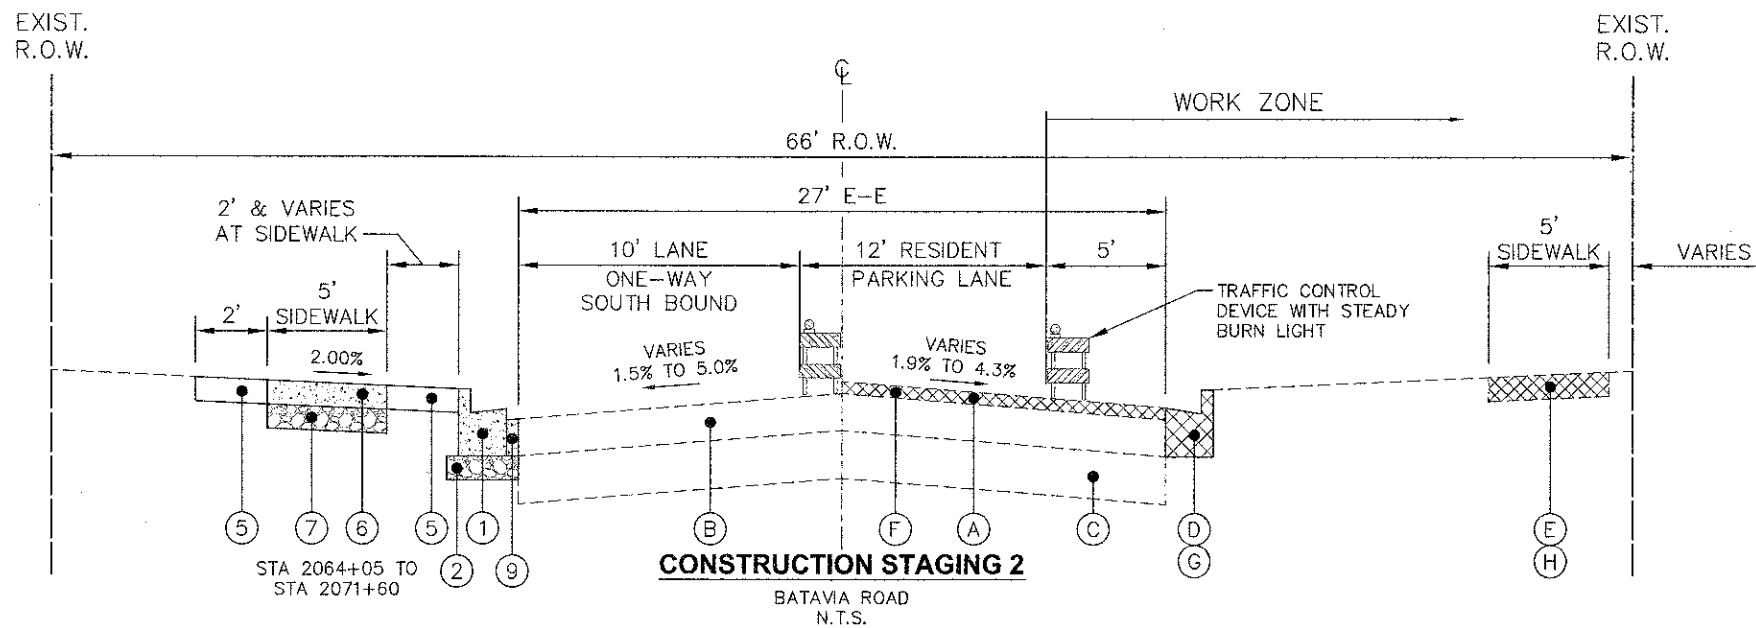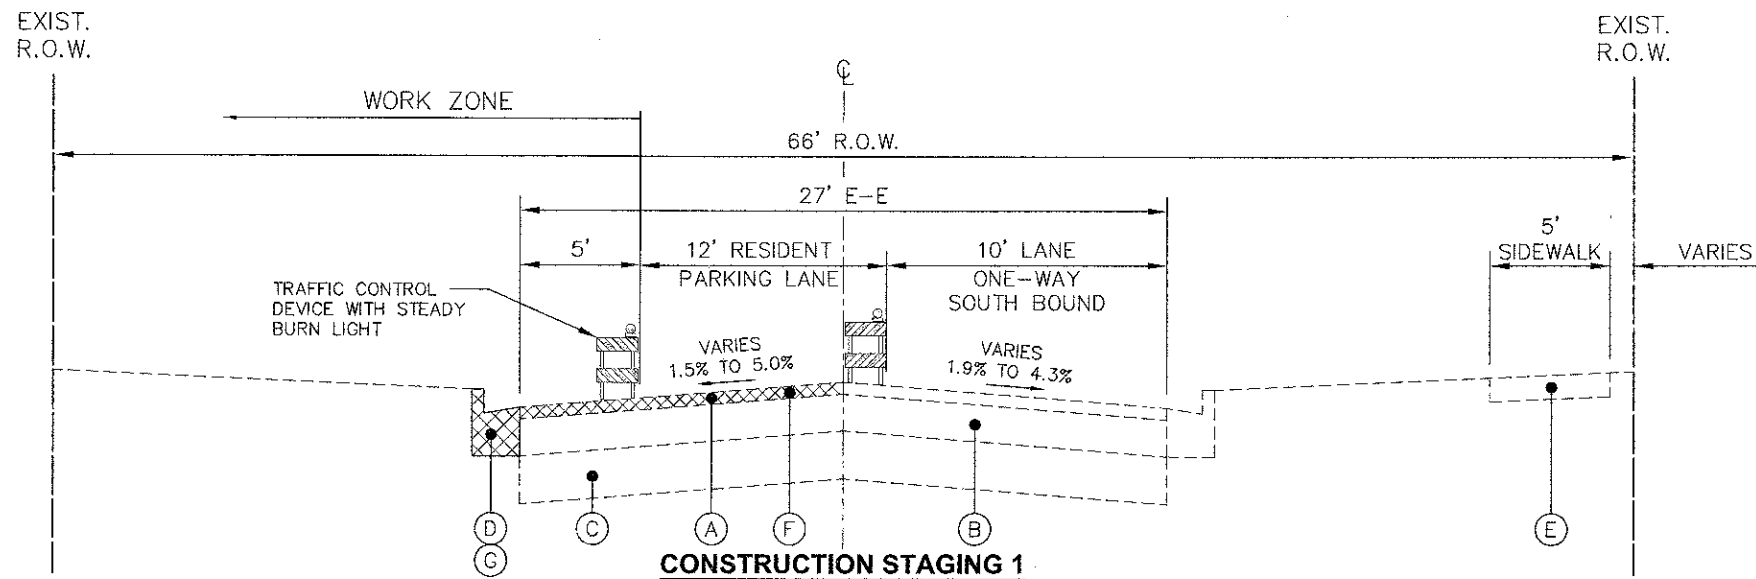

TRAFFIC CONTROL AND PROTECTION GENERAL NOTES

1. TRAFFIC CONTROL AND PROTECTION SHALL BE IN ACCORDANCE WITH THE STANDARD SPECIFICATIONS, CONTRACT SPECIAL PROVISIONS, CONSTRUCTION STAGING PLAN, DETOUR PLAN, THE LATEST EDITION OF THE "MANUAL OF UNIFORM TRAFFIC CONTROL DEVICES FOR STREETS AND HIGHWAYS," AND AS DIRECTED BY THE ENGINEER. TRAFFIC CONTROL SHOWN IN THE CONSTRUCTION STAGING PLAN AND DETOUR PLAN REPRESENT A GUIDE FOR THE SAFE MANAGEMENT OF TRAFFIC DURING THE EXECUTION OF THE WORK. MODIFICATIONS MAY BE NECESSARY DUE TO LOCAL CONDITIONS AT THE TIME OF CONSTRUCTION. ANY PROPOSED CHANGES BY THE CONTRACTOR TO THESE TRAFFIC CONTROL PLANS SHALL BE APPROVED BY THE ENGINEER PRIOR TO BEING IMPLEMENTED. ANY MODIFICATIONS OR ADDITIONS REQUIRED BY THE ENGINEER WILL BE INCLUDED IN THE COST OF TRAFFIC CONTROL AND PROTECTION, (SPECIAL) UNLESS A SEPARATE PAY ITEM HAS BEEN ESTABLISHED FOR THE WORK.
2. ANY EXISTING OR TEMPORARY MARKINGS WHICH CONFLICT WITH MARKINGS REQUIRED FOR CONSTRUCTION STAGING SHALL BE REMOVED ACCORDING TO SECTION 783 OF THE STANDARD SPECIFICATIONS. WATER BLASTING SHALL BE USED TO REMOVE EXISTING PAVEMENT MARKINGS ON FINAL PAVEMENT SURFACES.
3. ACCESS TO ADJACENT PROPERTIES AND SIDE STREETS SHALL BE MAINTAINED AT ALL TIMES, EXCEPT AS NOTED HEREIN OR AS APPROVED BY THE ENGINEER.
4. TEMPORARY PAVEMENT MARKING APPLIED TO FINAL PAVEMENT SURFACES AND EXISTING PAVEMENT SURFACES TO REMAIN SHALL BE PAVEMENT MARKING TAPE, TYPE III.
5. PLATING AND/OR TEMPORARY STRUCTURE ADJUSTMENTS MAY BE REQUIRED DUE TO THE STAGING OF CONSTRUCTION. THIS WORK WILL NOT BE PAID FOR SEPARATELY BUT WILL BE INCLUDED IN THE COST OF TRAFFIC CONTROL AND PROTECTION, (SPECIAL).
6. DURING THE CONCRETE CURING PROCESS RESIDENTS WILL BE ALLOWED TO PARK ADJACENT TO THEIR DRIVEWAYS ALONG BATAVIA ROAD IN THE RESIDENT PARKING LANE AREAS. RESIDENTS SHALL BE NOTIFIED IN WRITING A MINIMUM OF 48 HOURS IN ADVANCE OF LOSING ACCESS. THE CONTRACTOR SHALL TEMPORARILY SIGN AND BARRICADE THE DESIGNATED PARKING AREAS IN ORDER TO AVOID CONFLICTS DURING CONSTRUCTION. THIS WORK WILL NOT BE PAID FOR SEPARATELY BUT WILL BE INCLUDED IN THE COST OF TRAFFIC CONTROL AND PROTECTION, (SPECIAL).
7. DURING CONSTRUCTION BATAVIA ROAD WILL BE A ONE-WAY SOUTH BOUND ROAD FOR LOCAL TRAFFIC. THE DETOUR ROUTE SHOWN ON THE PLANS SHALL BE IMPLEMENTED IMMEDIATELY PRIOR TO ONE-WAY OPERATION. IF NOT IMMEDIATELY PRIOR, DETOUR SIGNS SHALL BE BAGGED UNTIL IN USE.
8. PRIOR TO CONSTRUCTION STAGE 1, THE COMMERCIAL PARKING SPACES BETWEEN MANNING AVENUE AND TRACY PLACE SHALL BE RESTRIPTED. SEE THE PARKING STALL PAVEMENT MARKING DETAIL SHEET FOR DETAILS.
9. STORM SEWER CROSSINGS AND FULL ROADWAY PATCHING SHALL BE CONSTRUCTED ONE HALF AT A TIME.
10. PRIOR TO INSTALLATION OF THE DETOUR SIGNING, THE CONTRACTOR SHALL CONTACT THE IDOT ARTERIAL TRAFFIC CONTROL SUPERVISOR AT (847) 705-4470

LEGEND

- (A) EXISTING ASPHALT SURFACE
- (B) EXISTING REINFORCED CONCRETE BASE
- (C) EXISTING AGGREGATE SUBBASE
- (D) EXISTING COMBINATION CONCRETE CURB AND GUTTER, TYPE B-6.18
- (E) EXISTING PORTLAND CEMENT CONCRETE SIDEWALK
- (F) HOT-MIX ASPHALT SURFACE REMOVAL, 2" SPECIAL
- (G) COMBINATION CURB AND GUTTER REMOVAL
- (H) SIDEWALK REMOVAL - SPOT REPAIR / LOCATIONS VARY
- (1) COMBINATION CONCRETE CURB AND GUTTER, TYPE B-6.18 (SPECIAL)
- (2) SUBBASE GRANULAR MATERIAL, TYPE B, 4"
- (3) BITUMINOUS MATERIALS (PRIME COAT) AND AGGREGATE (PRIME COAT)
- (4) HOT-MIX ASPHALT SURFACE COURSE, MIX "D", N70, 2.0"
- (5) TOPSOIL, 4", SEEDING, FERTILIZER, EROSION CONTROL BLANKET
- (6) PORTLAND CEMENT CONCRETE SIDEWALK, 5" (7" AT DRIVEWAYS)
- (7) AGGREGATE BASE COURSE, TYPE B, 2" (INCLUDED IN COST OF SIDEWALK)
- (8) CLASS D PATCH, 4"
- (9) CONCRETE BACKFILL - SEE DETAIL ON TYPICAL SECTION SHEET
- (10) HOT-MIX ASPHALT SURFACE COURSE, MIX "D", N50, 2.0"
- (11) STRIP REFLECTIVE CRACK CONTROL TREATMENT

19, 2012 @ 11:48 AM By: Jim Schmidt - Tab: 09 Staging - 22-34
 10/11/12 11:48 AM By: Jim Schmidt - Tab: 09 Staging - 22-34

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PLOT DATE =	CHECKED - JRL	REVISED -
	DATE - 8/24/12	REVISED -


STATE OF ILLINOIS
 DEPARTMENT OF TRANSPORTATION

SUGGESTED CONSTRUCTION STAGING PLAN	
SCALE: N/A	SHEET NO. 1 OF 1 SHEETS
STA. N/A	TO STA. N/A

F.A.U. RTE.	SECTION	COUNTY	TOTAL SHEETS	SHEET NO.
3553	10-00031-00-RS	DUPAGE	29	9
FED. ROAD DIST. NO. 1 [ILLINOIS] FED. AID PROJECT - M-9003866			CONTRACT NO. 63758	

NOTES:

1. LOCATIONS OF ALL SIGNS ARE APPROXIMATE. FINAL LOCATION SHALL BE BASED ON FIELD CONDITIONS AND AS APPROVED BY THE ENGINEER.
2. SIGN SPACING = 500 FEET UNLESS NOTED OTHERWISE OR AS DIRECTED BY THE ENGINEER.
3. STREET NAME SIGN (11) TO BE PLACED ABOVE DETOUR SIGNS AND BELOW WARNING SIGNS.
4. CHANGEABLE MESSAGE SIGNS [CM] TO BE INSTALLED A MINIMUM OF TWO WEEKS IN ADVANCE OF ANY CONSTRUCTION WORK NOTIFYING PUBLIC OF PENDING ROAD WORK AND CLOSURE. THE CHANGEABLE MESSAGE SIGNS SHALL BE REMOVED ONCE CONSTRUCTION BEGINS AND THE DETOUR IS IN PLACE.

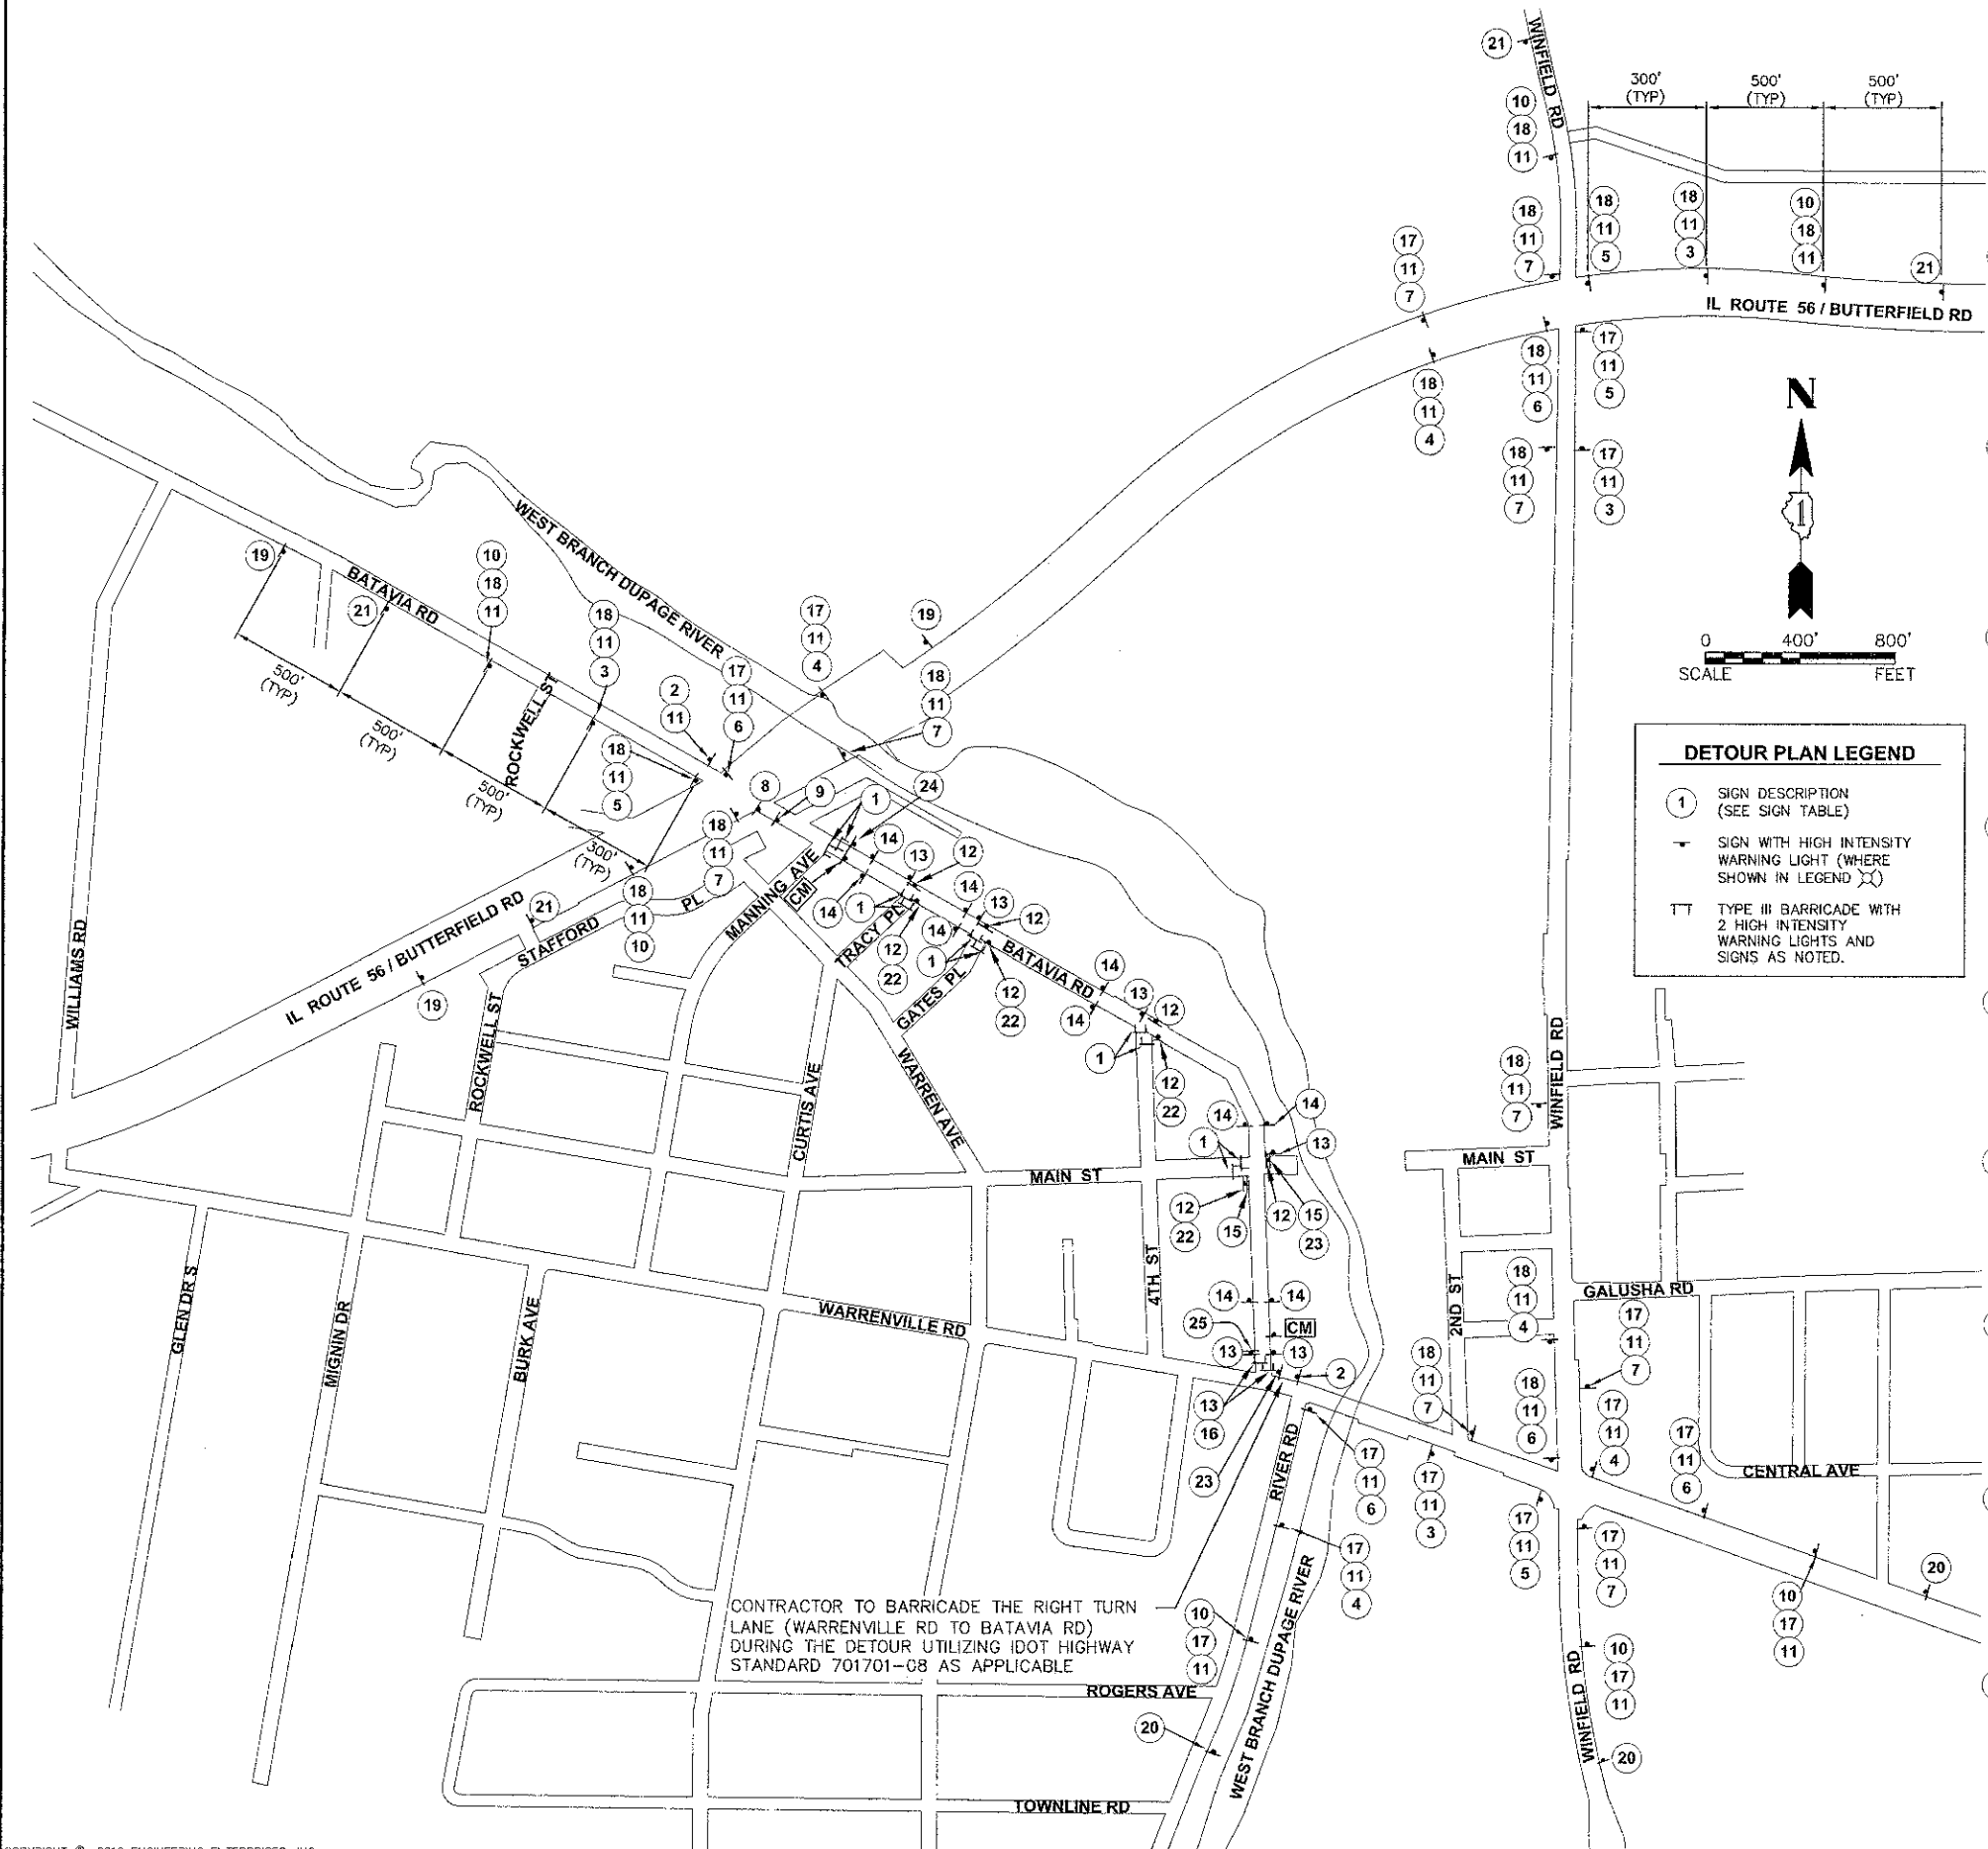

ROAD CLOSED TO THRU TRAFFIC
R11-4 60X30
ON TYPE III BARRICADE W/ FLASHING LIGHT (2 STAGGERED ACROSS ROAD)

BATAVIA RD CLOSED SOUTH OF MANNING AVE LOCAL TRAFFIC ONLY
BLACK ON ORANGE

END DETOUR M4-8A 24X18

DETOUR AHEAD W20-2 48X48

BATAVIA ROAD CLOSED USE DETOUR
BLACK ON ORANGE

DETOUR M4-9L 30X30

BATAVIA RD 30X12 BLACK ON ORANGE

BATAVIA RD CLOSED SOUTH OF MANNING AVE USE DETOUR
BLACK ON ORANGE

DETOUR PLAN LEGEND

- 1 SIGN DESCRIPTION (SEE SIGN TABLE)
- SIGN WITH HIGH INTENSITY WARNING LIGHT (WHERE SHOWN IN LEGEND)
- T TYPE III BARRICADE WITH 2 HIGH INTENSITY WARNING LIGHTS AND SIGNS AS NOTED.

DETOUR M4-9R 30X30

ONE WAY R6-1R 36X12

NO RIGHT TURN R3-2 24X24

DETOUR M4-9L 30X24

DO NOT ENTER R5-1 30X30

NO LEFT TURN R3-1 24X24

DETOUR M4-9R 30X24

WRONG WAY R5-1a 36X24

BEGIN ONE WAY R6-6 18X24

DETOUR M4-9 30X24

ONE WAY R6-1L 36X12

END ONE WAY R6-7 18X24

ROAD CONSTRUCTION AHEAD W20-1 36X36

ROAD CLOSED R11-2 48X30
ON TYPE III BARRICADE W/ FLASHING LIGHT (2 STAGGERED ACROSS ROAD)

CHANGEABLE MESSAGE SIGN [CM]

ROAD CLOSED AHEAD W20-3 36X36

NORTH M3-1 24X12

SOUTH M3-3 24X12

CONTRACTOR TO BARRICADE THE RIGHT TURN LANE (WARRENVILLE RD TO BATAVIA RD) DURING THE DETOUR UTILIZING IDOT HIGHWAY STANDARD 701701-08 AS APPLICABLE

PLOTTED: November 19, 2012 @ 1:26 PM By: Jim Schmidt - Job: 10 Detour Plan 22x34
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 630.466.6700 / www.eeiweb.com

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DRAWN - KKP/CLN/JFS	REVISOR -
CHECKED - JRL	REVISOR -
DATE - 8/24/12	REVISOR -



**STATE OF ILLINOIS
DEPARTMENT OF TRANSPORTATION**

BATAVIA ROAD DETOUR PLAN


SCALE: N.T.S. SHEET NO. 1 OF 1 SHEETS STA. N/A TO STA. N/A

F.A.J. RTE.	SECTION	COUNTY	TOTAL SHEETS	SHEET NO.
3553	10-00031-00-RS	DUPAGE	29	10
FED. ROAD DIST. NO. 1 (ILLINOIS) FED. AID PROJECT - M-9003(866)			CONTRACT NO. 63758	

ST03 CB TY C, 2' DIA. W/ TY 3V F&G 2052+98, 16.08' LT T/C = 698.51 INV = 894.84 NE 12" EX INV = 894.90 SW 12"	ST04 CB TY A, 4' DIA. W/ TY 3V F&G 2052+98, 16.08' RT T/C = 698.46 INV = 895.80 NW B" INV = 895.14 NE&NW 12"	ST05 CB TY C, 2' DIA. W/ TY 3V F&G 2052+55.76, 28.68' RT T/C = 699.62 INV = 695.44 NW, SE 12"	ST06 CB TY C, 2' DIA. W/ TY 3V F&G 2052+12.34, 28.34' RT T/C = 699.90 INV = 695.62 N, SE 12"	ST07 CB TY C, 2' DIA. W/ TY 3V F&G 2051+90.16, 16.08' RT T/C = 699.05 INV = 695.74 S 12"	ST08 CB TY C, 2' DIA. W/ TY 23 F&G 2054+96, 16.08' RT T/C = 697.86 INV = 693.51 NE 12" EX	ST09 CB TY C, 2' DIA. W/ TY 3V F&G 2056+81, 16.08' LT T/C = 698.36 INV = 694.09 NE, SW 12" EX	ST10 CB TY C, 2' DIA. W/ TY 3V F&G 2056+80, 16.08' RT T/C = 698.41 INV = 694.30 NE 12" EX INV = 694.30 NW	ST11 CB TY C, 2' DIA. W/ TY 23 F&G 2056+14.1, 16.71' RT T/C = 698.21 INV = 694.83 NW, SE 12"	ST12 MH TY A, 4' DIA. W/ TY 1 CL 2055+95.54, 18.65' RT RIM = 697.80 INV = 694.95 NW, SE 12" INV = 695.08 SW 8" EX	ST13 CB TY C, 2' DIA. W/ TY 3V F&G 2055+60.57, 29.33' RT T/C = 698.07 INV = 695.11 SE, 12"
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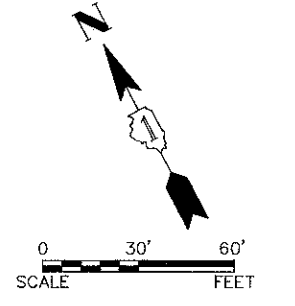
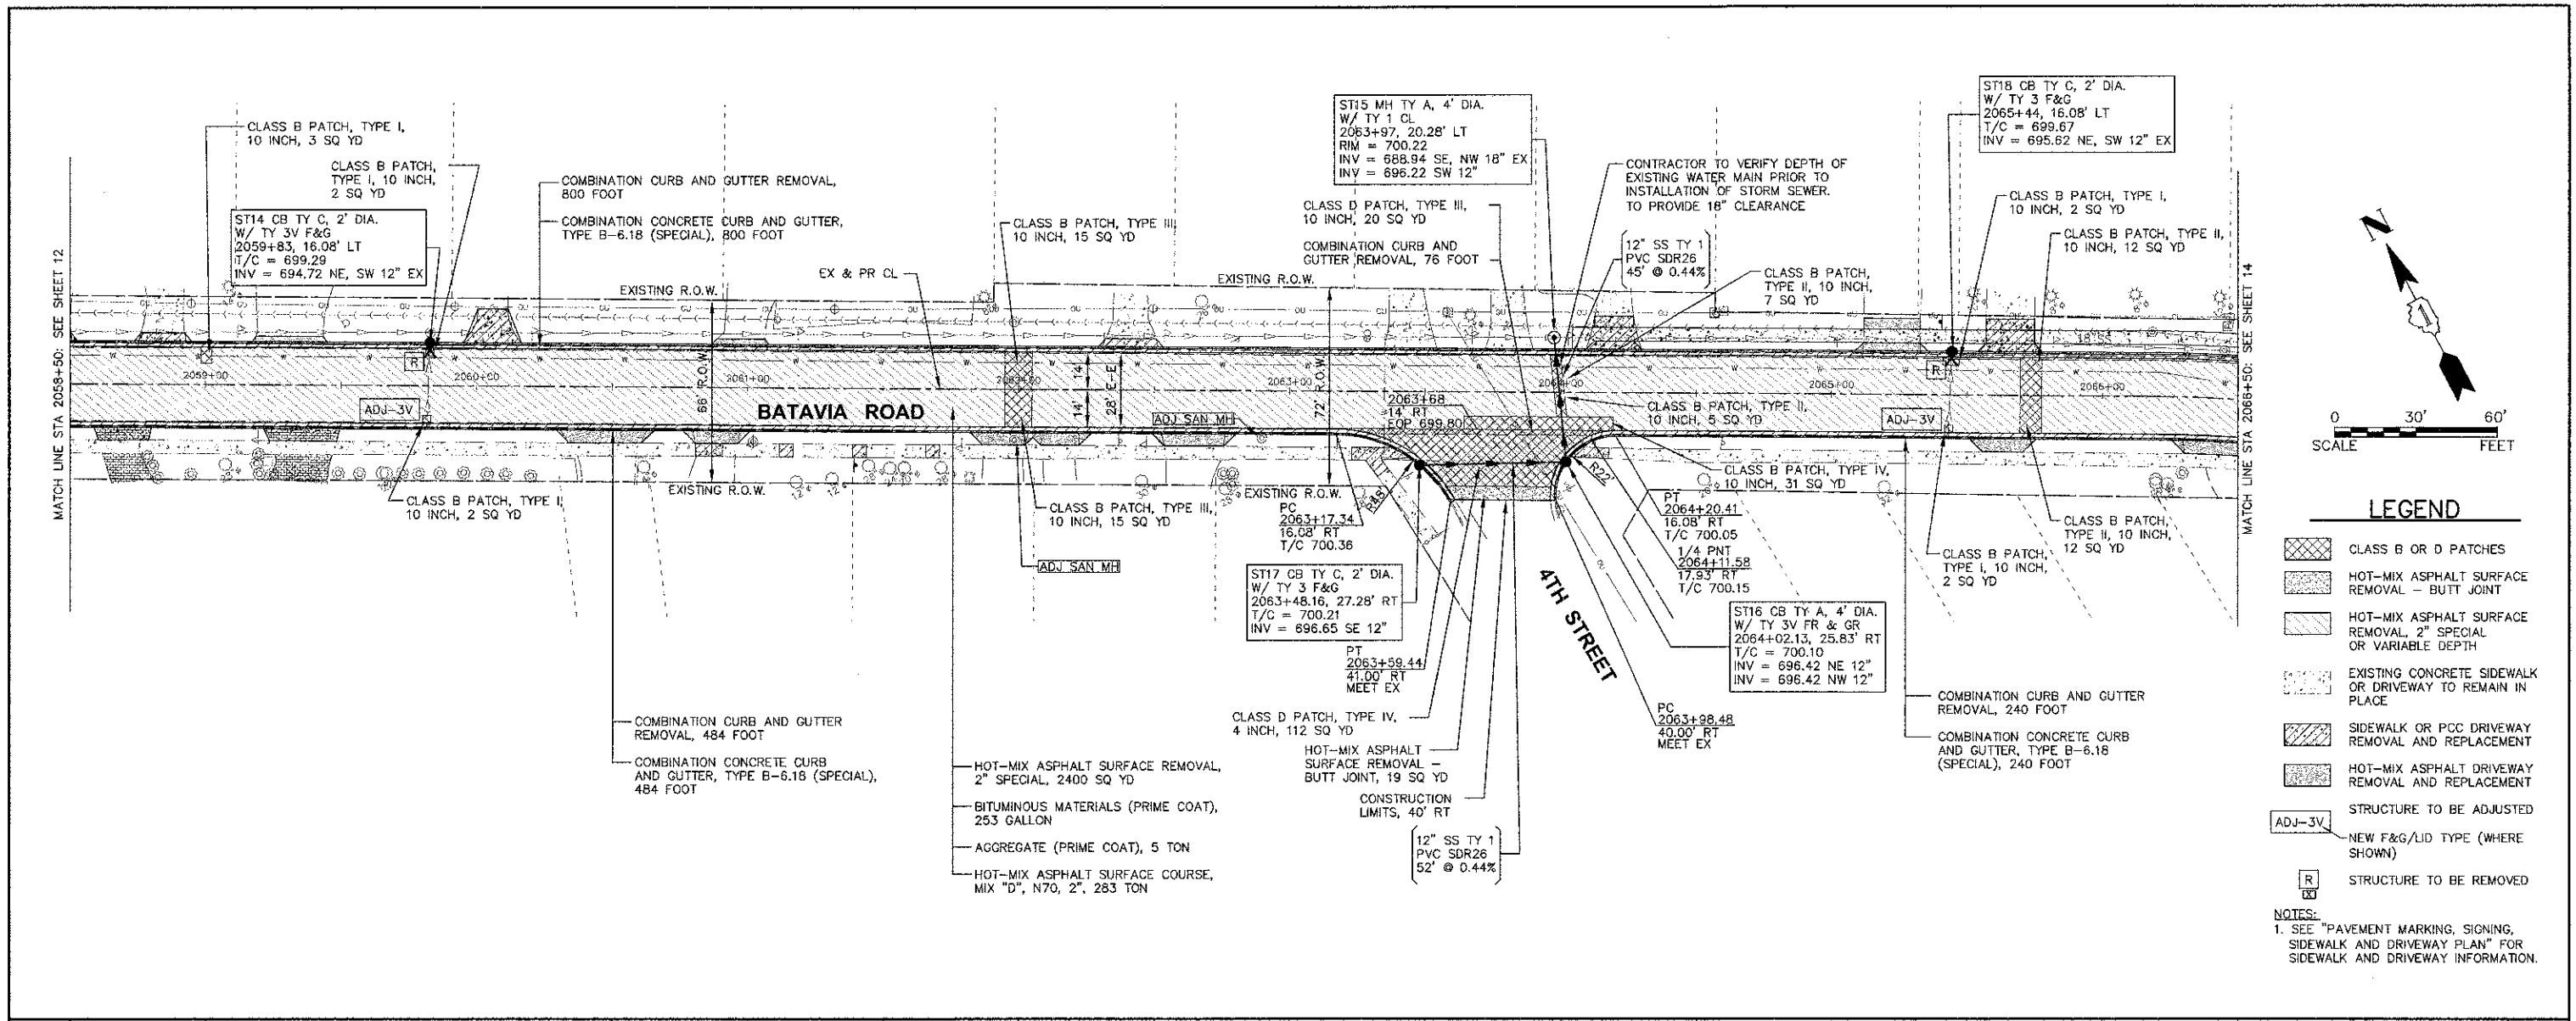
- LEGEND**
- CLASS B OR D PATCHES
 - HOT-MIX ASPHALT SURFACE REMOVAL - BUTT JOINT
 - HOT-MIX ASPHALT SURFACE REMOVAL, 2" SPECIAL OR VARIABLE DEPTH
 - EXISTING CONCRETE SIDEWALK OR DRIVEWAY TO REMAIN IN PLACE
 - SIDEWALK OR PCC DRIVEWAY REMOVAL AND REPLACEMENT
 - HOT-MIX ASPHALT DRIVEWAY REMOVAL AND REPLACEMENT
 - STRUCTURE TO BE ADJUSTED
 - NEW F&G/LID TYPE (WHERE SHOWN)
 - STRUCTURE TO BE REMOVED
- NOTES:**
1. SEE "PAVEMENT MARKING, SIGNING, SIDEWALK AND DRIVEWAY PLAN" FOR SIDEWALK AND DRIVEWAY INFORMATION.

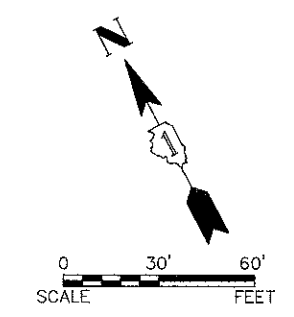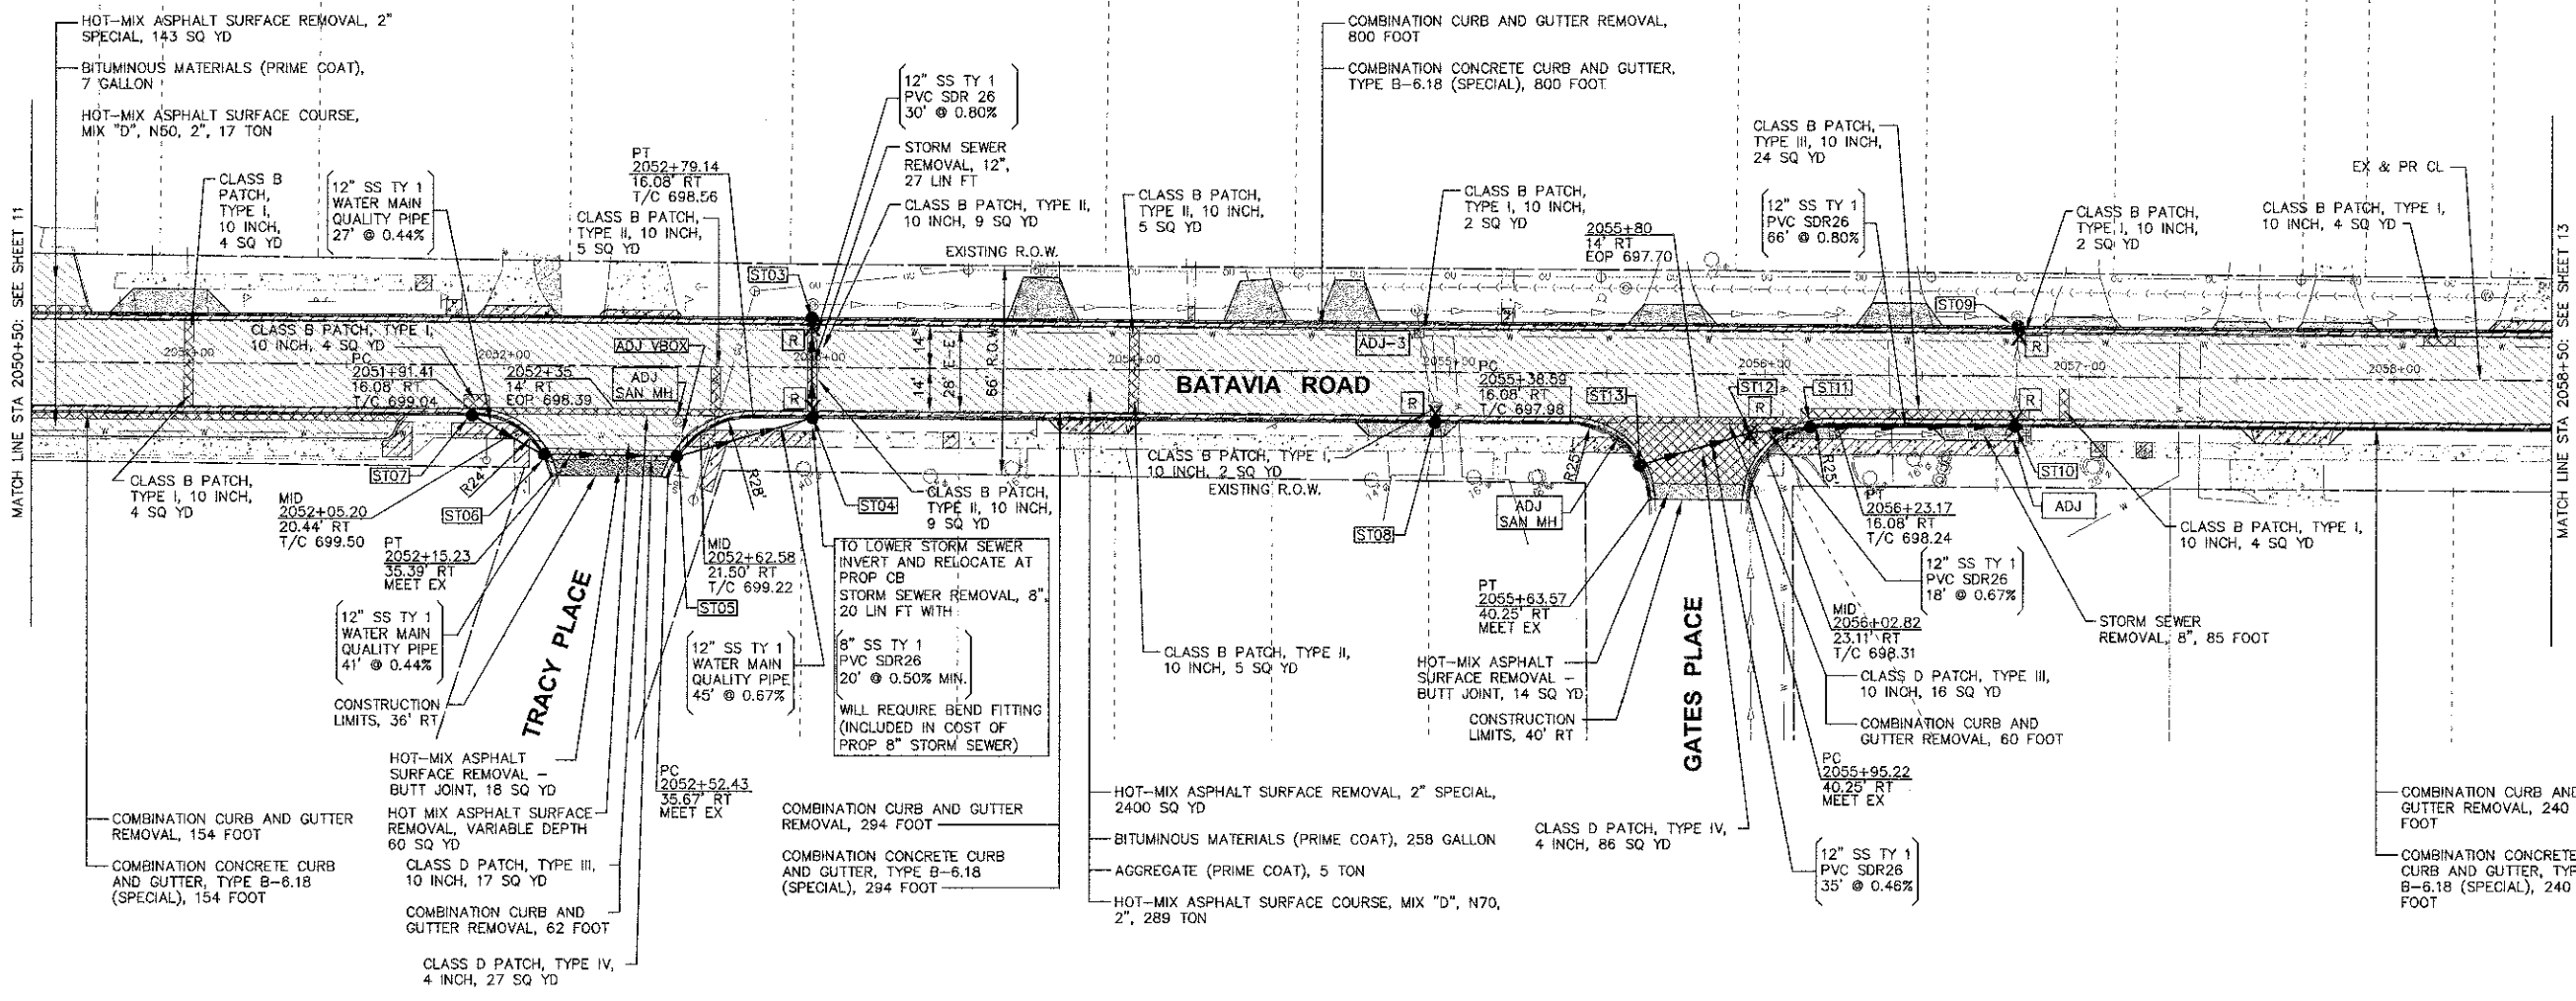

SCALE:
HORIZONTAL 1" = 30'
VERTICAL 1" = 5'

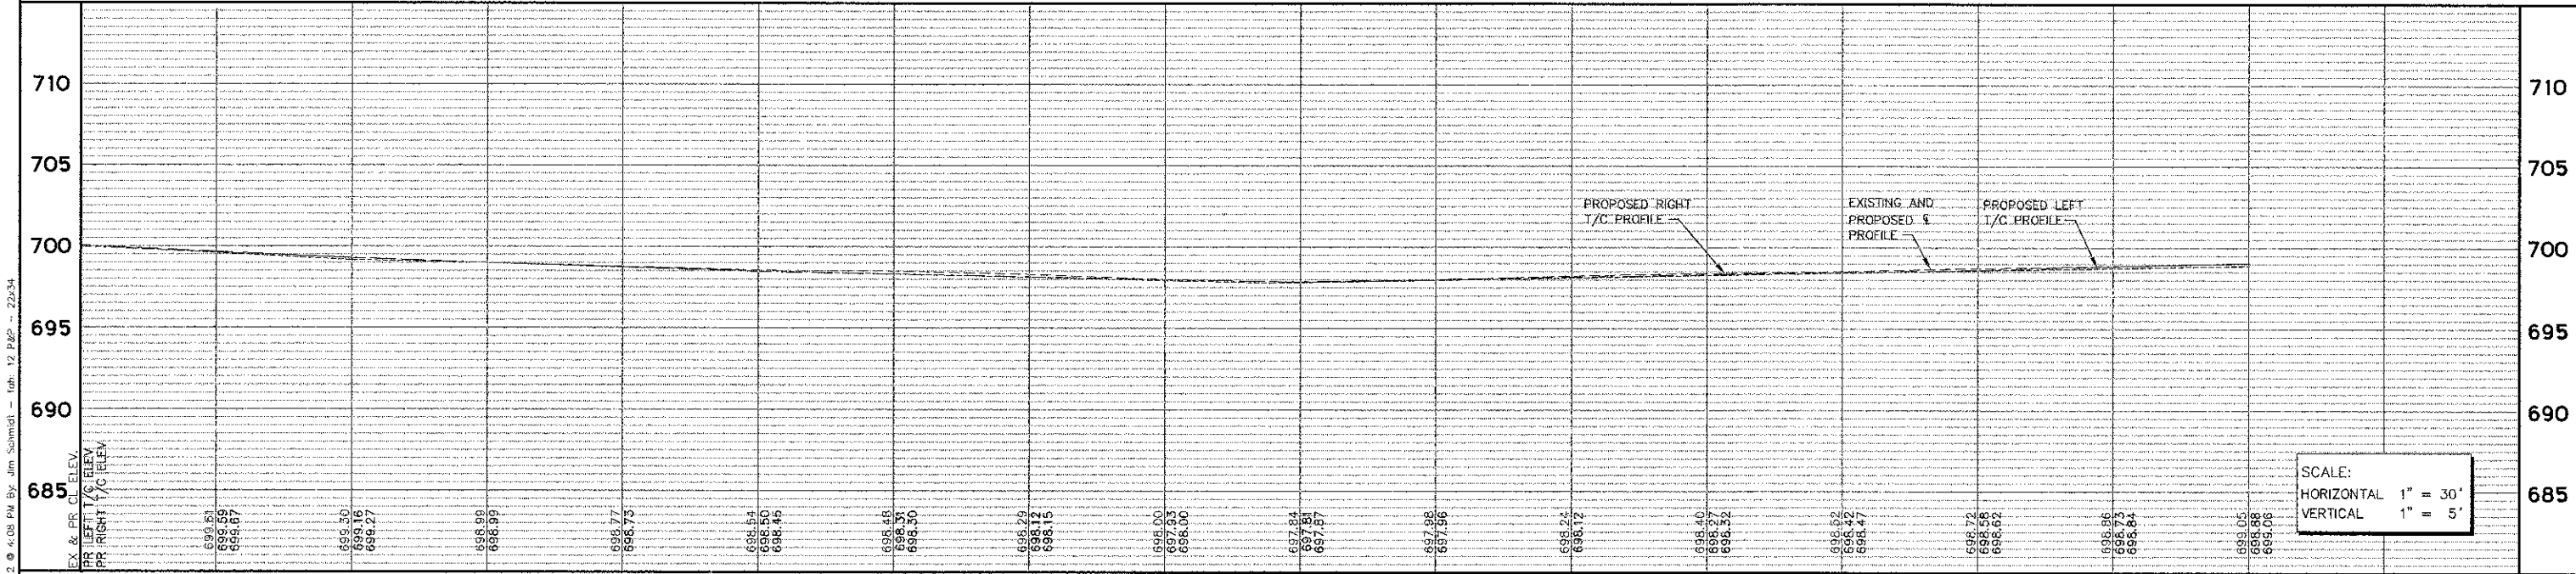
Engineering Enterprises, Inc. CONSULTING ENGINEERS 52 Wheeler Road Sugar Grove, Illinois 60554 630.466.6700 / www.eelweb.com	USER NAME = DESIGNED - SWM/TWV DRAWN - KKP/CLN/JPS CHECKED - JRL DATE = 8/24/12	REVISIONS REVISED - REVISED - REVISED - REVISED -	STATE OF ILLINOIS DEPARTMENT OF TRANSPORTATION	BATAVIA ROAD PLAN AND PROFILE	F.A.U. RTE. 3553 SECTION 10-00031-00-RS COUNTY DUPAGE TOTAL SHEETS 29 SHEET NO. 12 CONTRACT NO. 63758 FED. ROAD DIST. NO. 1 ILLINOIS FED. AID PROJECT - M-900318661
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October 18, 2012 @ 4:04 PM By: Jim Salimeti - Tab. 12 P&P - 22a34
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- LEGEND**
- CLASS B OR D PATCHES
 - HOT-MIX ASPHALT SURFACE REMOVAL - BUTT JOINT
 - HOT-MIX ASPHALT SURFACE REMOVAL, 2\"/>

NOTES:
 1. SEE "PAVEMENT MARKING, SIGNING, SIDEWALK AND DRIVEWAY PLAN" FOR SIDEWALK AND DRIVEWAY INFORMATION.



SCALE:
 HORIZONTAL 1" = 30'
 VERTICAL 1" = 5'

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CURVE 1
 PI STA = 2068+66.78
 $\Delta = 58^{\circ}41'59"$ (RT)
 $D = 11^{\circ}53'14"$
 $R = 482.00'$
 $T = 271.04'$
 $L = 493.81'$
 $E = 70.98'$
 PC STA = 2066+19.88
 PT STA = 2071+13.69

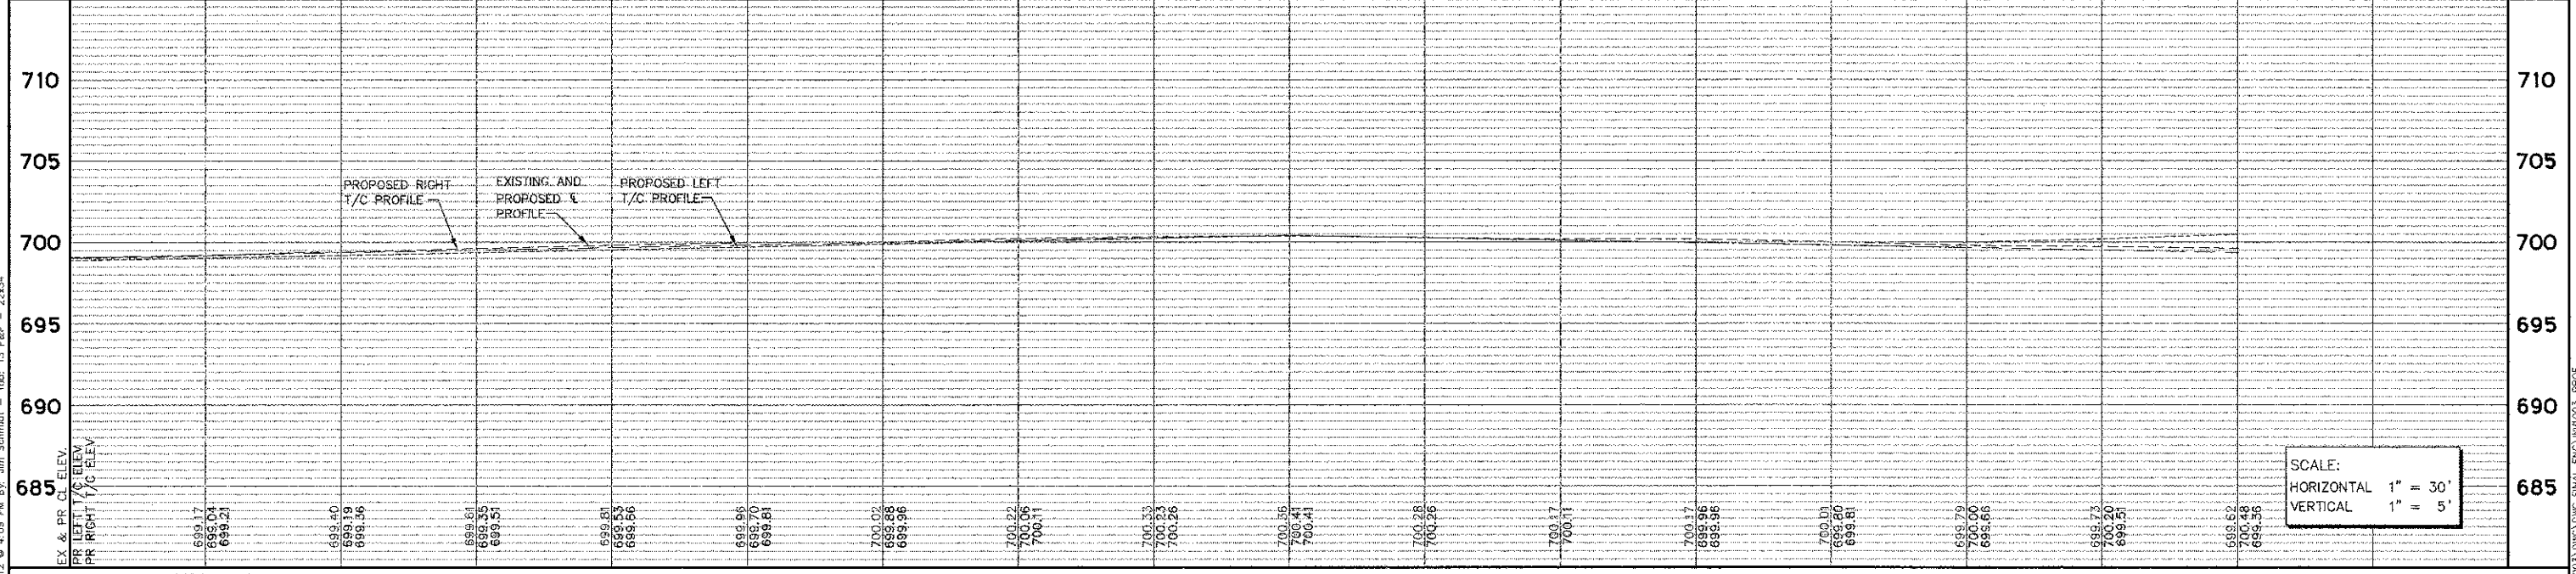WARRENVILLE GROVE FOREST PRESERVE PARKING LOT

CLASS B PATCH, TYPE II, 10 INCH, 9 SQ YD
 CONTRACTOR TO VERIFY DEPTH OF EXISTING WATER MAIN PRIOR TO INSTALLATION OF STORM SEWER. TO PROVIDE 18" CLEARANCE

ST21 MH TY A, 5' DIA.
 W/ TY 23 F&G
 2069+25, 16.08' LT
 T/C = 699.91
 INV = 686.90± NW, SE 24" EX
 INV = 694.75 W 12"

CLASS B PATCH, TYPE II, 10 INCH, 5 SQ YD

CLASS D PATCH, TYPE III, 10 INCH, 15 SQ YD
 COMBINATION CURB AND GUTTER REMOVAL, 60 FOOT

ST26 CB TY C, 2' DIA.
 W/ TY 3V F&G
 2072+58, 16.08' LT
 T/C = 698.46
 INV = 695.02 W 12" EX

COMBINATION CURB AND GUTTER REMOVAL, 820 FOOT
 COMBINATION CONCRETE CURB AND GUTTER, TYPE B-6.18 (SPECIAL), 820 FOOT

CLASS B PATCH, TYPE II, 10 INCH, 9 SQ YD

CONTRACTOR TO VERIFY DEPTH OF EXISTING WATER MAIN PRIOR TO INSTALLATION OF STORM SEWER. TO PROVIDE 18" CLEARANCE

12" SS TY 1 PVC SDR26 30' @ 0.47%

ST19 MH TY A, 5' DIA.
 W/ TY 23 F&G
 2066+75, 16.08' LT
 T/C = 700.50
 INV = 687.50± NW, SE 24" EX
 INV = 695.50 SW 12"

FIRE HYDRANT TO BE MOVED

12" SS TY 1 PVC SDR26 30' @ 0.47%

CLASS B PATCH, TYPE II, 10 INCH, 5 SQ YD

CLASS B PATCH, TYPE II, 10 INCH, 9 SQ YD

ST22 CB TY A, 4' DIA.
 W/ TY 3V F&G
 2069+25, 16.08' RT
 T/C = 698.20
 INV = 694.89 E 12"

12" SS TY 1 PVC SDR26 10' @ 0.50%

ST24 CB TY A, 4' DIA.
 W/ TY 3 F&G
 2070+57, 16.08' RT
 T/C = 697.83
 INV = 692.77 N 12"

PT 2071+69.54 36.27' RT MEET EX

HOT-MIX ASPHALT SURFACE REMOVAL VARIABLE DEPTH, 36 SQ YD
 CONSTRUCTION LIMITS, 36' RT

ST25 CB TY A, 4' DIA.
 W/ TY 3 F&G
 2072+12.85, 21.73' RT
 T/C = 698.35
 INV = 689.80± N, S 18" EX

CLASS D PATCH, TYPE IV, 4 INCH, 45 SQ YD

PC 2072+02.78 36.39' RT MEET EX


HOT-MIX ASPHALT SURFACE REMOVAL - BUTT JOINT, 18 SQ YD

CLASS B PATCH, TYPE I, 10 INCH, 2 SQ YD

CLASS B PATCH, TYPE II, 10 INCH, 9 SQ YD


COMBINATION CURB AND GUTTER REMOVAL, 254 FOOT

COMBINATION CONCRETE CURB AND GUTTER, TYPE B-6.18 (SPECIAL), 254 FOOT

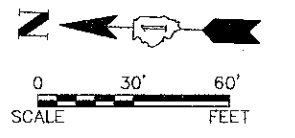

- LEGEND**
- CLASS B OR D PATCHES
 - HOT-MIX ASPHALT SURFACE REMOVAL - BUTT JOINT
 - HOT-MIX ASPHALT SURFACE REMOVAL, 2" SPECIAL OR VARIABLE DEPTH
 - EXISTING CONCRETE SIDEWALK OR DRIVEWAY TO REMAIN IN PLACE
 - SIDEWALK OR PCC DRIVEWAY REMOVAL AND REPLACEMENT
 - HOT-MIX ASPHALT DRIVEWAY REMOVAL AND REPLACEMENT
 - STRUCTURE TO BE ADJUSTED
 - NEW F&G/LID TYPE (WHERE SHOWN)
 - STRUCTURE TO BE REMOVED



NOTES:
 1. SEE "PAVEMENT MARKING, SIGNING, SIDEWALK AND DRIVEWAY PLAN" FOR SIDEWALK AND DRIVEWAY INFORMATION.

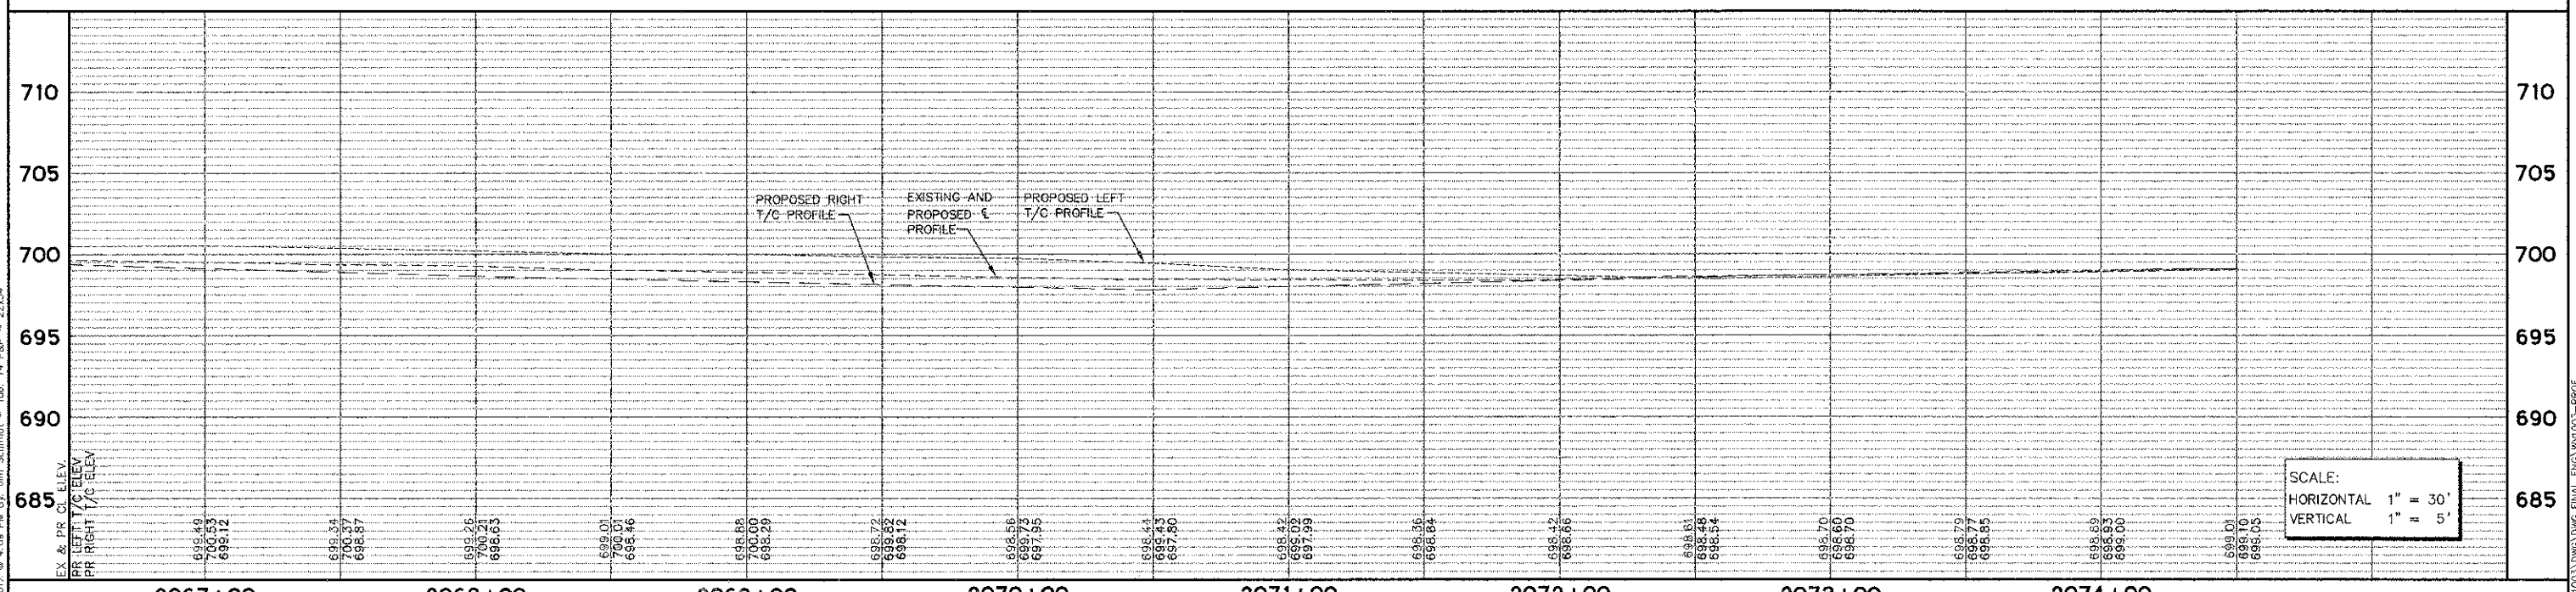

SCALE:
 HORIZONTAL 1" = 30'
 VERTICAL 1" = 5'

Engineering Enterprises, Inc. CONSULTING ENGINEERS 52 Wheeler Road Sugar Grove, Illinois 60554 630.466.8700 / www.eelweb.com	USER NAME = PLOT SCALE = PLOT DATE =	DESIGNED - SWM/TW DRAWN - KKP/CLN/JPS CHECKED - JRL DATE - 8/24/12	REVISED - REVISED - REVISED - REVISED -	STATE OF ILLINOIS DEPARTMENT OF TRANSPORTATION		BATAVIA ROAD PLAN AND PROFILE				F.A.U. RTE. 3553	SECTION 10-00031-00-RS	COUNTY	TOTAL SHEETS 29	SHEET NO. 14	CONTRACT NO. 63758	FED. ROAD DIST. NO. 1 [ILLINOIS] FED. AID PROJECT - M-900318661
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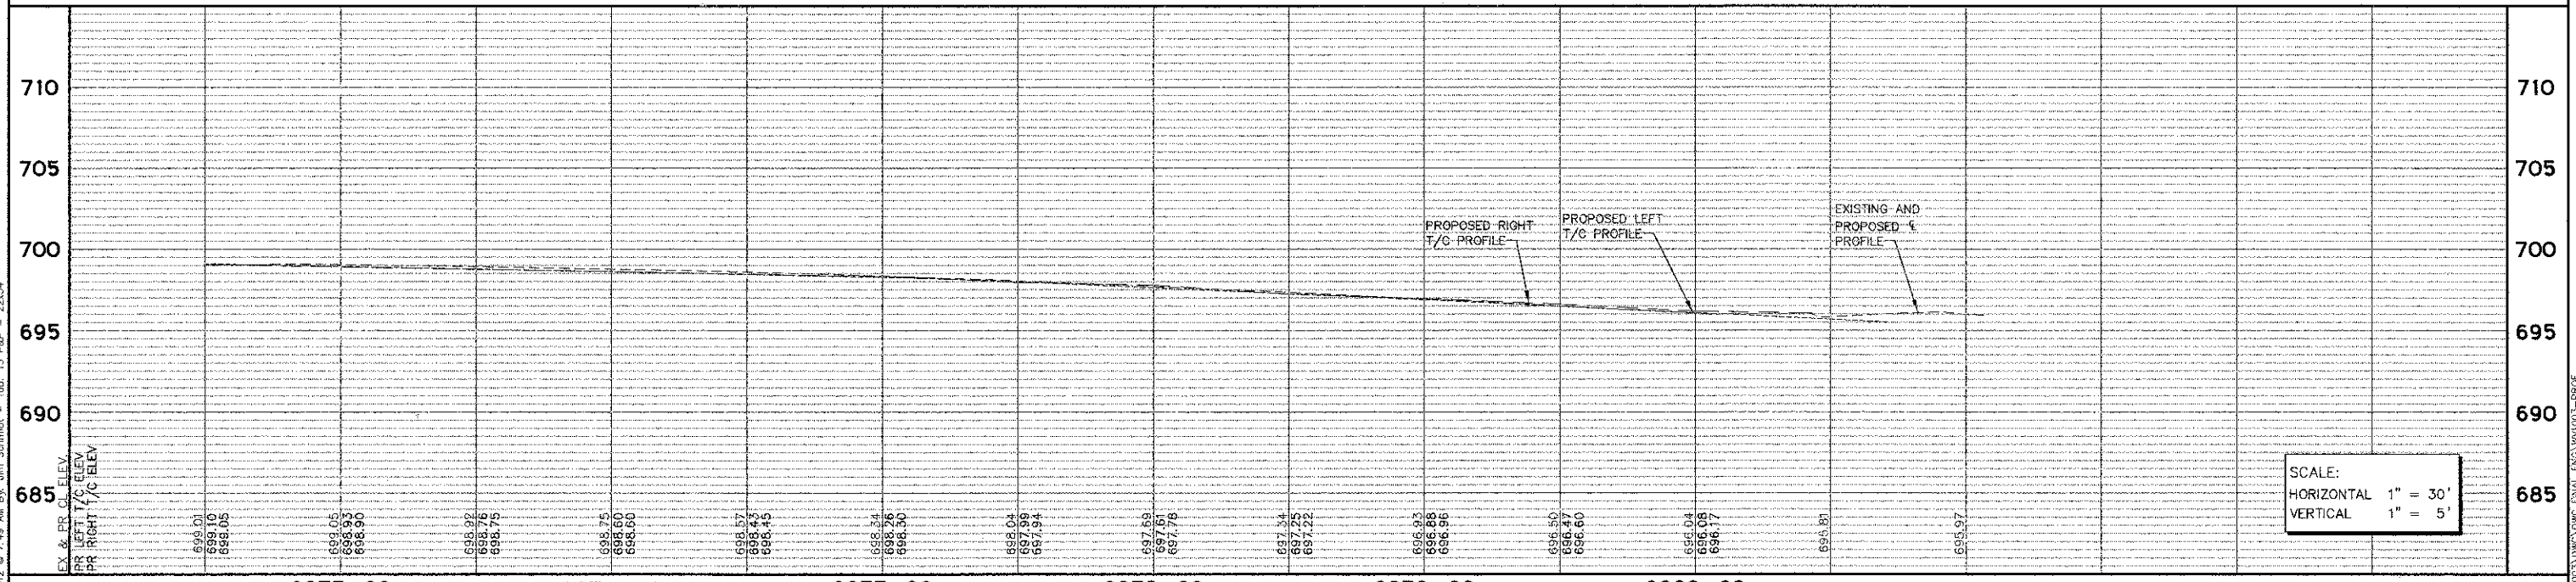
Plotted: October 18, 2012 @ 4:03 PM By: Jim Schmidt - Tab: 14 P&P - 223034
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- LEGEND**
- CLASS B OR D PATCHES
 - HOT-MIX ASPHALT SURFACE REMOVAL - BUTT JOINT
 - HOT-MIX ASPHALT SURFACE REMOVAL, 2" SPECIAL OR VARIABLE DEPTH
 - EXISTING CONCRETE SIDEWALK OR DRIVEWAY TO REMAIN IN PLACE
 - SIDEWALK OR PCC DRIVEWAY REMOVAL AND REPLACEMENT
 - HOT-MIX ASPHALT DRIVEWAY REMOVAL AND REPLACEMENT
 - STRUCTURE TO BE ADJUSTED
 - STRUCTURE TO BE REMOVED

- HOT-MIX ASPHALT SURFACE REMOVAL, 2" SPECIAL, 2356 SQ YD
- BITUMINOUS MATERIALS (PRIME COAT), 236 GALLON
- AGGREGATE (PRIME COAT), 5 TON
- HOT-MIX ASPHALT SURFACE COURSE, MIX "D", N70, 2", 264 TON

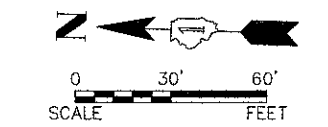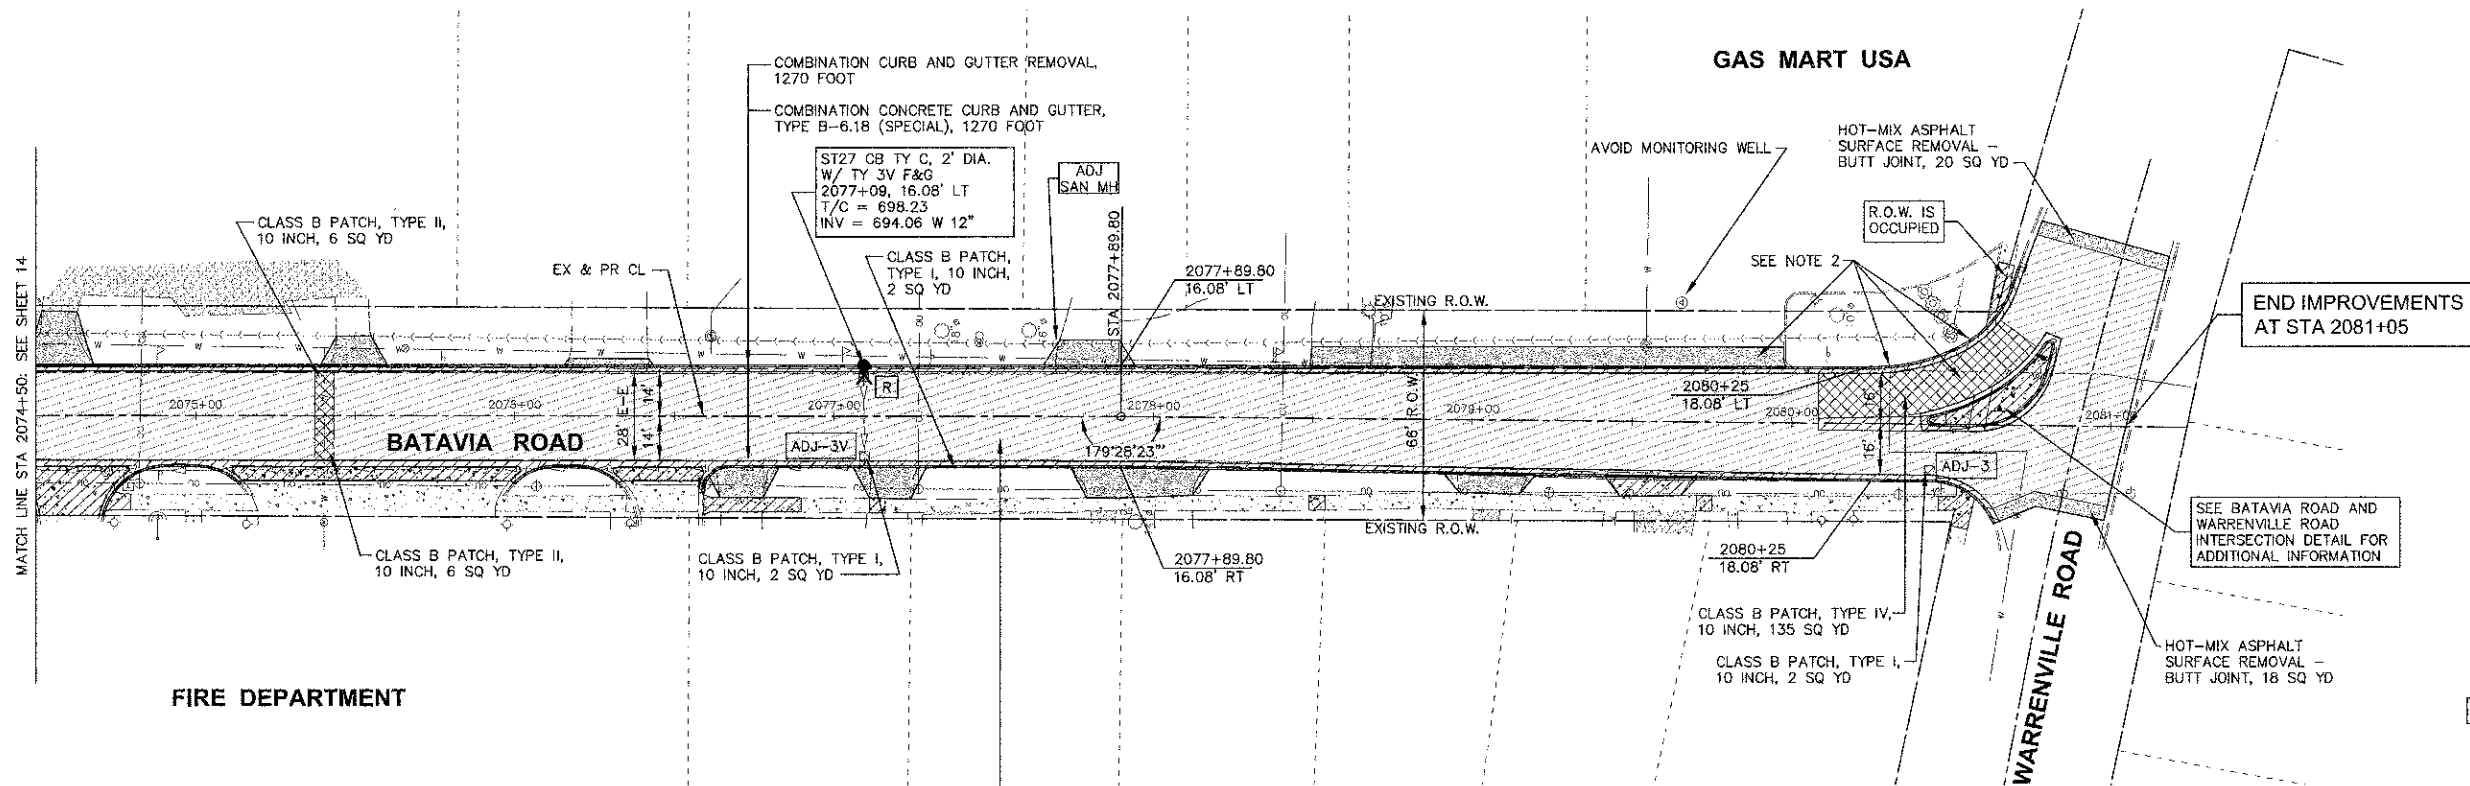- NOTES:**
1. SEE "PAVEMENT MARKING, SIGNING, SIDEWALK AND DRIVEWAY PLAN" FOR SIDEWALK AND DRIVEWAY CALLOUTS
 2. THE GAS MART USA AT THE NORTHEAST CORNER OF BATAVIA ROAD AND WARRENVILLE ROAD WAS IDENTIFIED AS A REC IN THE PHASE I STUDY. ANY SOIL OR STONE EXCAVATION ADJACENT TO THIS PROPERTY MUST REMAIN ON SITE. NO SOIL TESTING HAS BEEN CONDUCTED, BUT IN CASE DURING CONSTRUCTION NON SPECIAL WASTE IS DETECTED, THE FOLLOWING PAY ITEMS SHALL BE USED:
 NON-SPECIAL WASTE DISPOSAL 6 CU YD
 SPECIAL WASTE PLANS AND REPORTS 1 LSUM



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PLOT DATE =	CHECKED - JRL	REVISED -
	DATE - 8/24/12	REVISED -

**STATE OF ILLINOIS
 DEPARTMENT OF TRANSPORTATION**

BATAVIA ROAD PLAN AND PROFILE



SCALE: 1"=30'
 SHEET NO. 5 OF 5 SHEETS
 STA. 2074+50 TO STA. 2080+80

F.A.U. RTE.	SECTION	COUNTY	TOTAL SHEETS	SHEET NO.
3553	10-00031-00-RS	DUPAGE	29	15
FED. ROAD DIST. NO. 1 ILLINOIS			CONTRACT NO. 63758	
FED. AID PROJECT - M-9003(B66)				

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Path: S:\SHPROJ\Warrenville\DWG\FINAL_ENG\WV003-PROF


GAS MART USA

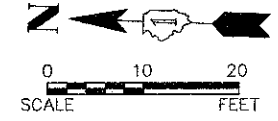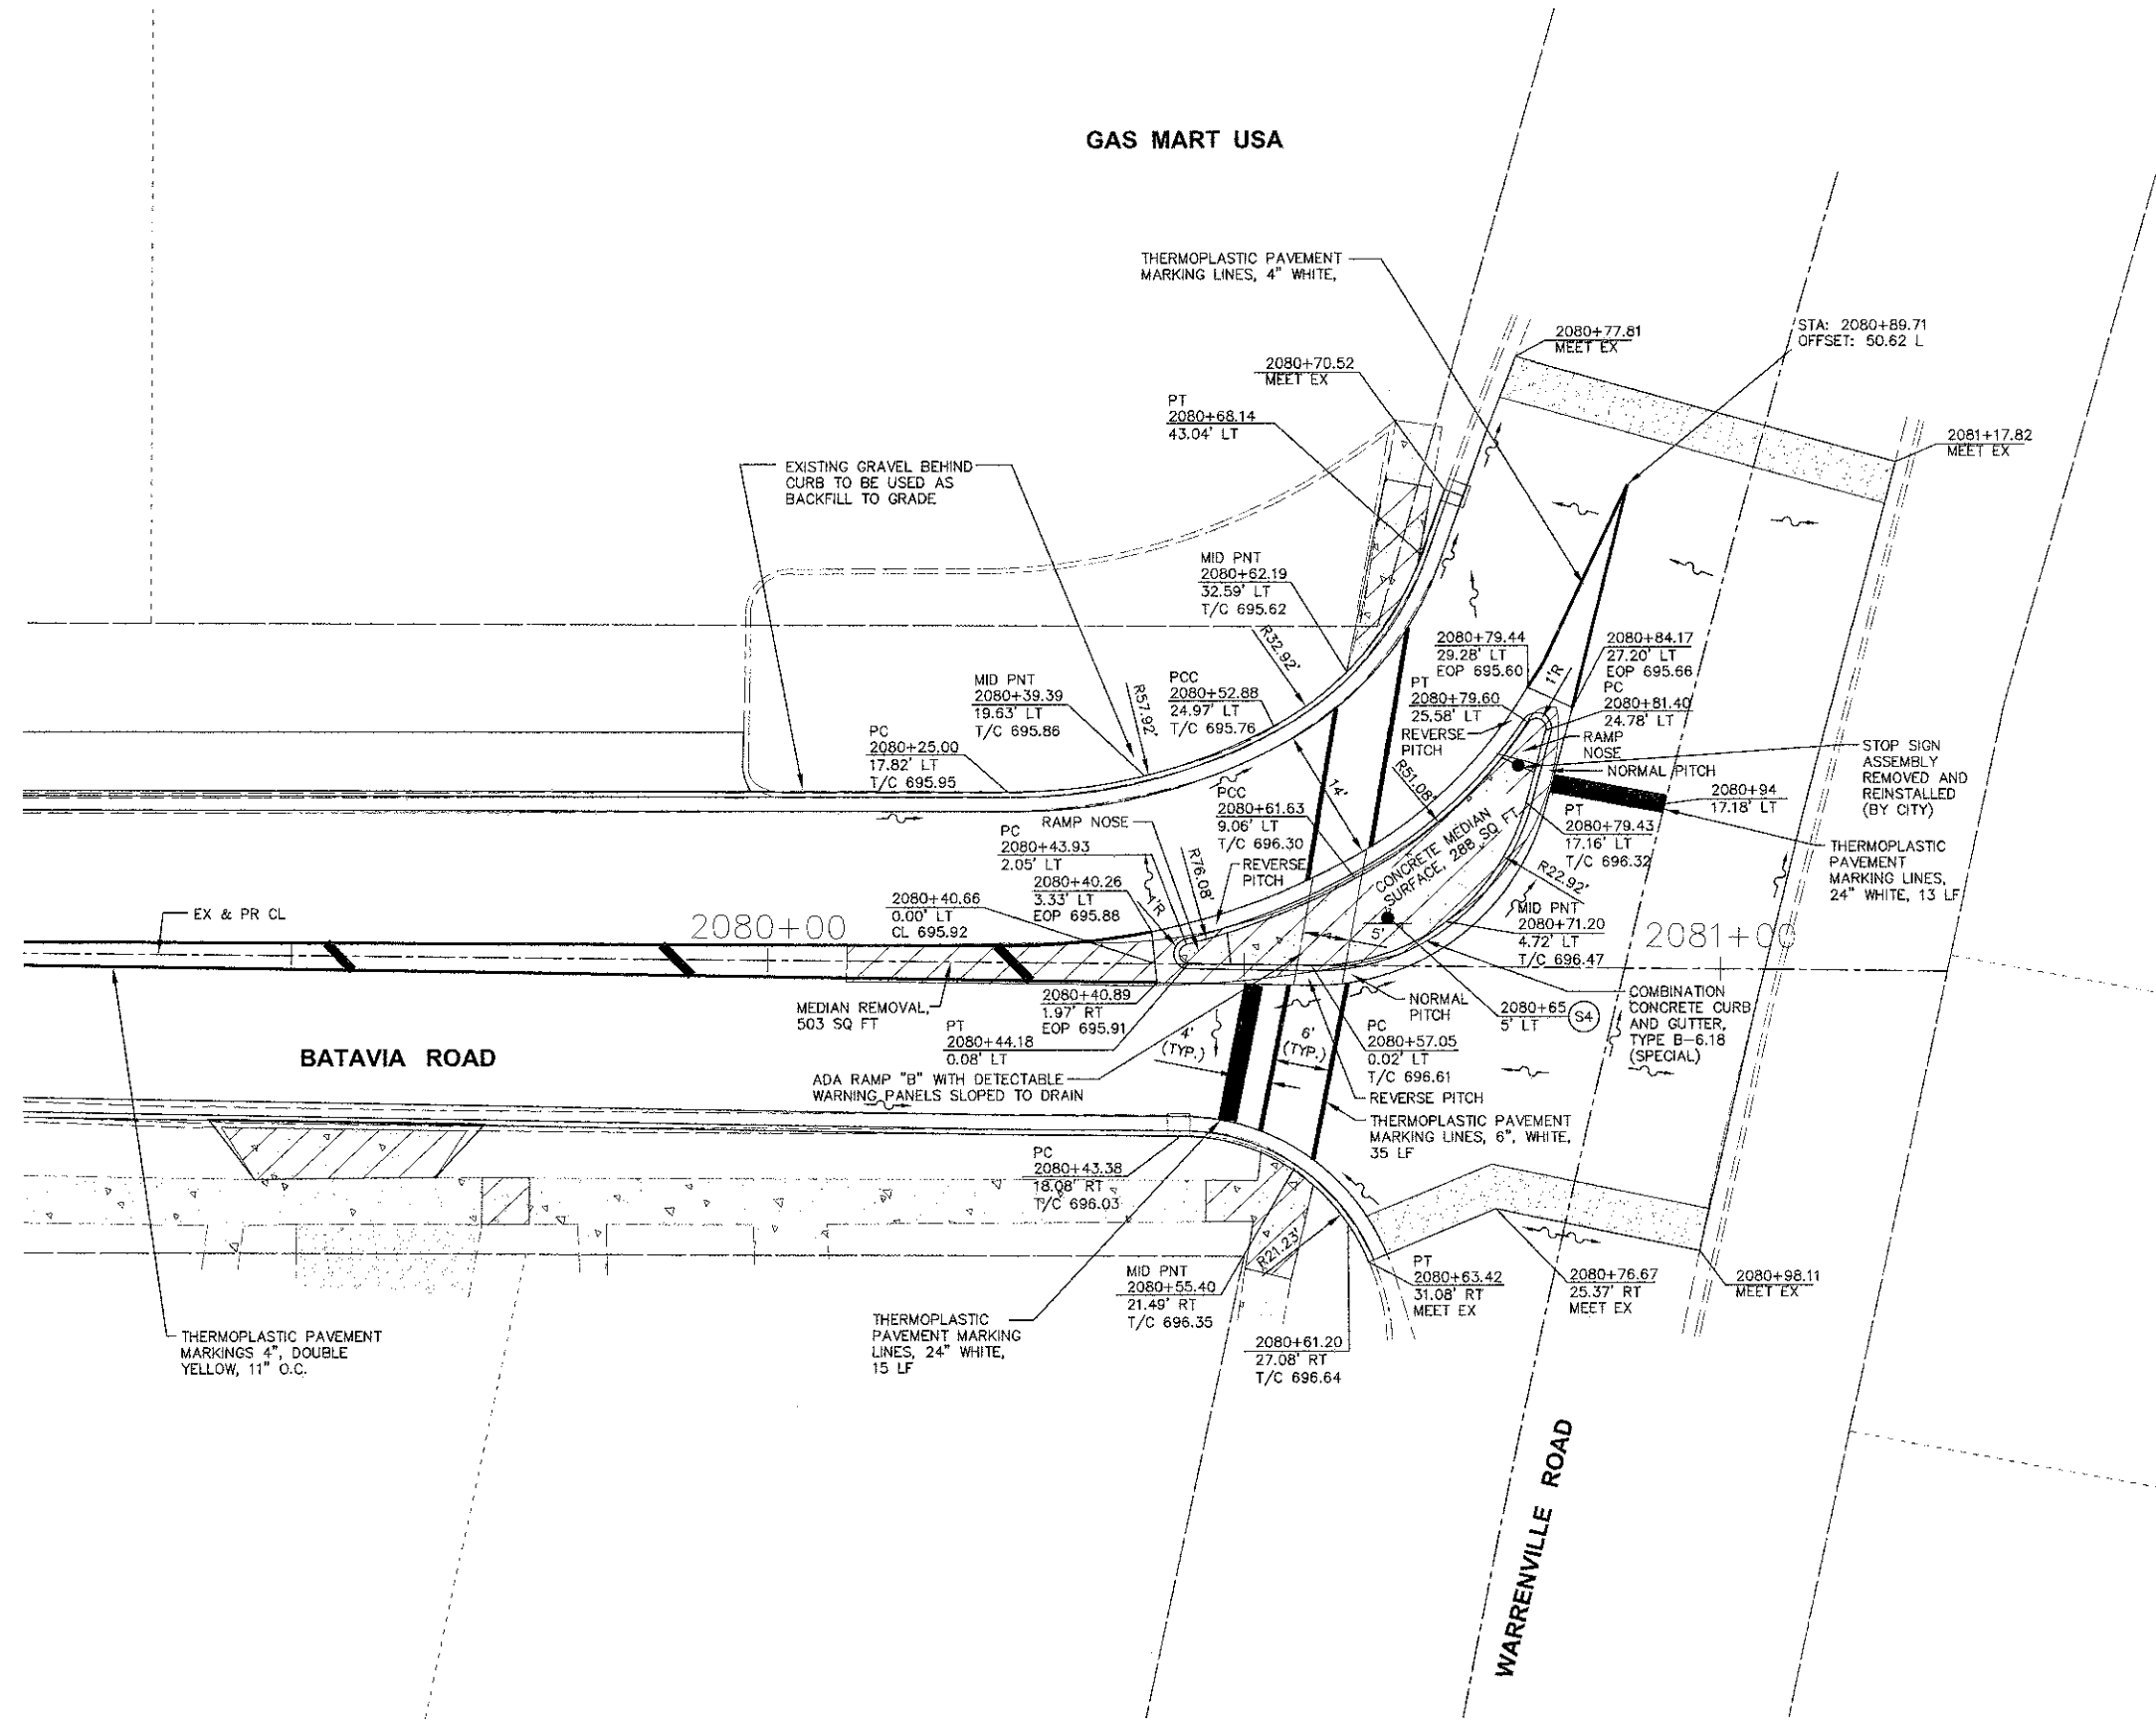

LEGEND

- HOT-MIX ASPHALT SURFACE REMOVAL - BUTT JOINT
- EXISTING CONCRETE SIDEWALK OR DRIVEWAY TO REMAIN IN PLACE
- SIDEWALK OR PCC DRIVEWAY REMOVAL AND REPLACEMENT
- PROPOSED FLOW DIRECTION

NOTES:
1. THE CITY OF WARRENVILLE SHALL REMOVE, REPLACE, RELOCATE AND FURNISH ALL PERMANENT SIGNS.

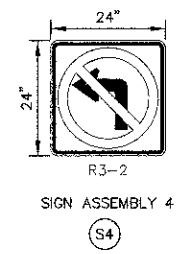

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DRAWN - KKP/CLN/JPS	CHECKED - JRL	REVISED -
PLOT SCALE =	DATE - 8/24/12	REVISED -
PLOT DATE =		



**STATE OF ILLINOIS
DEPARTMENT OF TRANSPORTATION**

BATAVIA ROAD AND WARRENVILLE ROAD INTERSECTION DETAIL

SCALE: N/A SHEET NO. 1 OF 1 SHEETS STA. N/A TO STA. N/A


F.A.U. RTE. 3553	SECTION 10-00031-00-RS	COUNTY	TOTAL SHEETS 29	SHEET NO. 16
CONTRACT NO. 63758		FED. ROAD DIST. NO. 1 ILLINOIS FED. AID PROJECT - N-9003(666)		

PLOTFILE: \\S:\PROJ\W1003\DWG\DWG_FINAL\ENG\W1003-PLAN

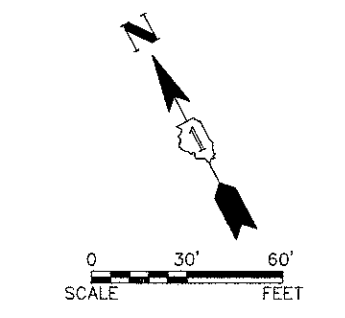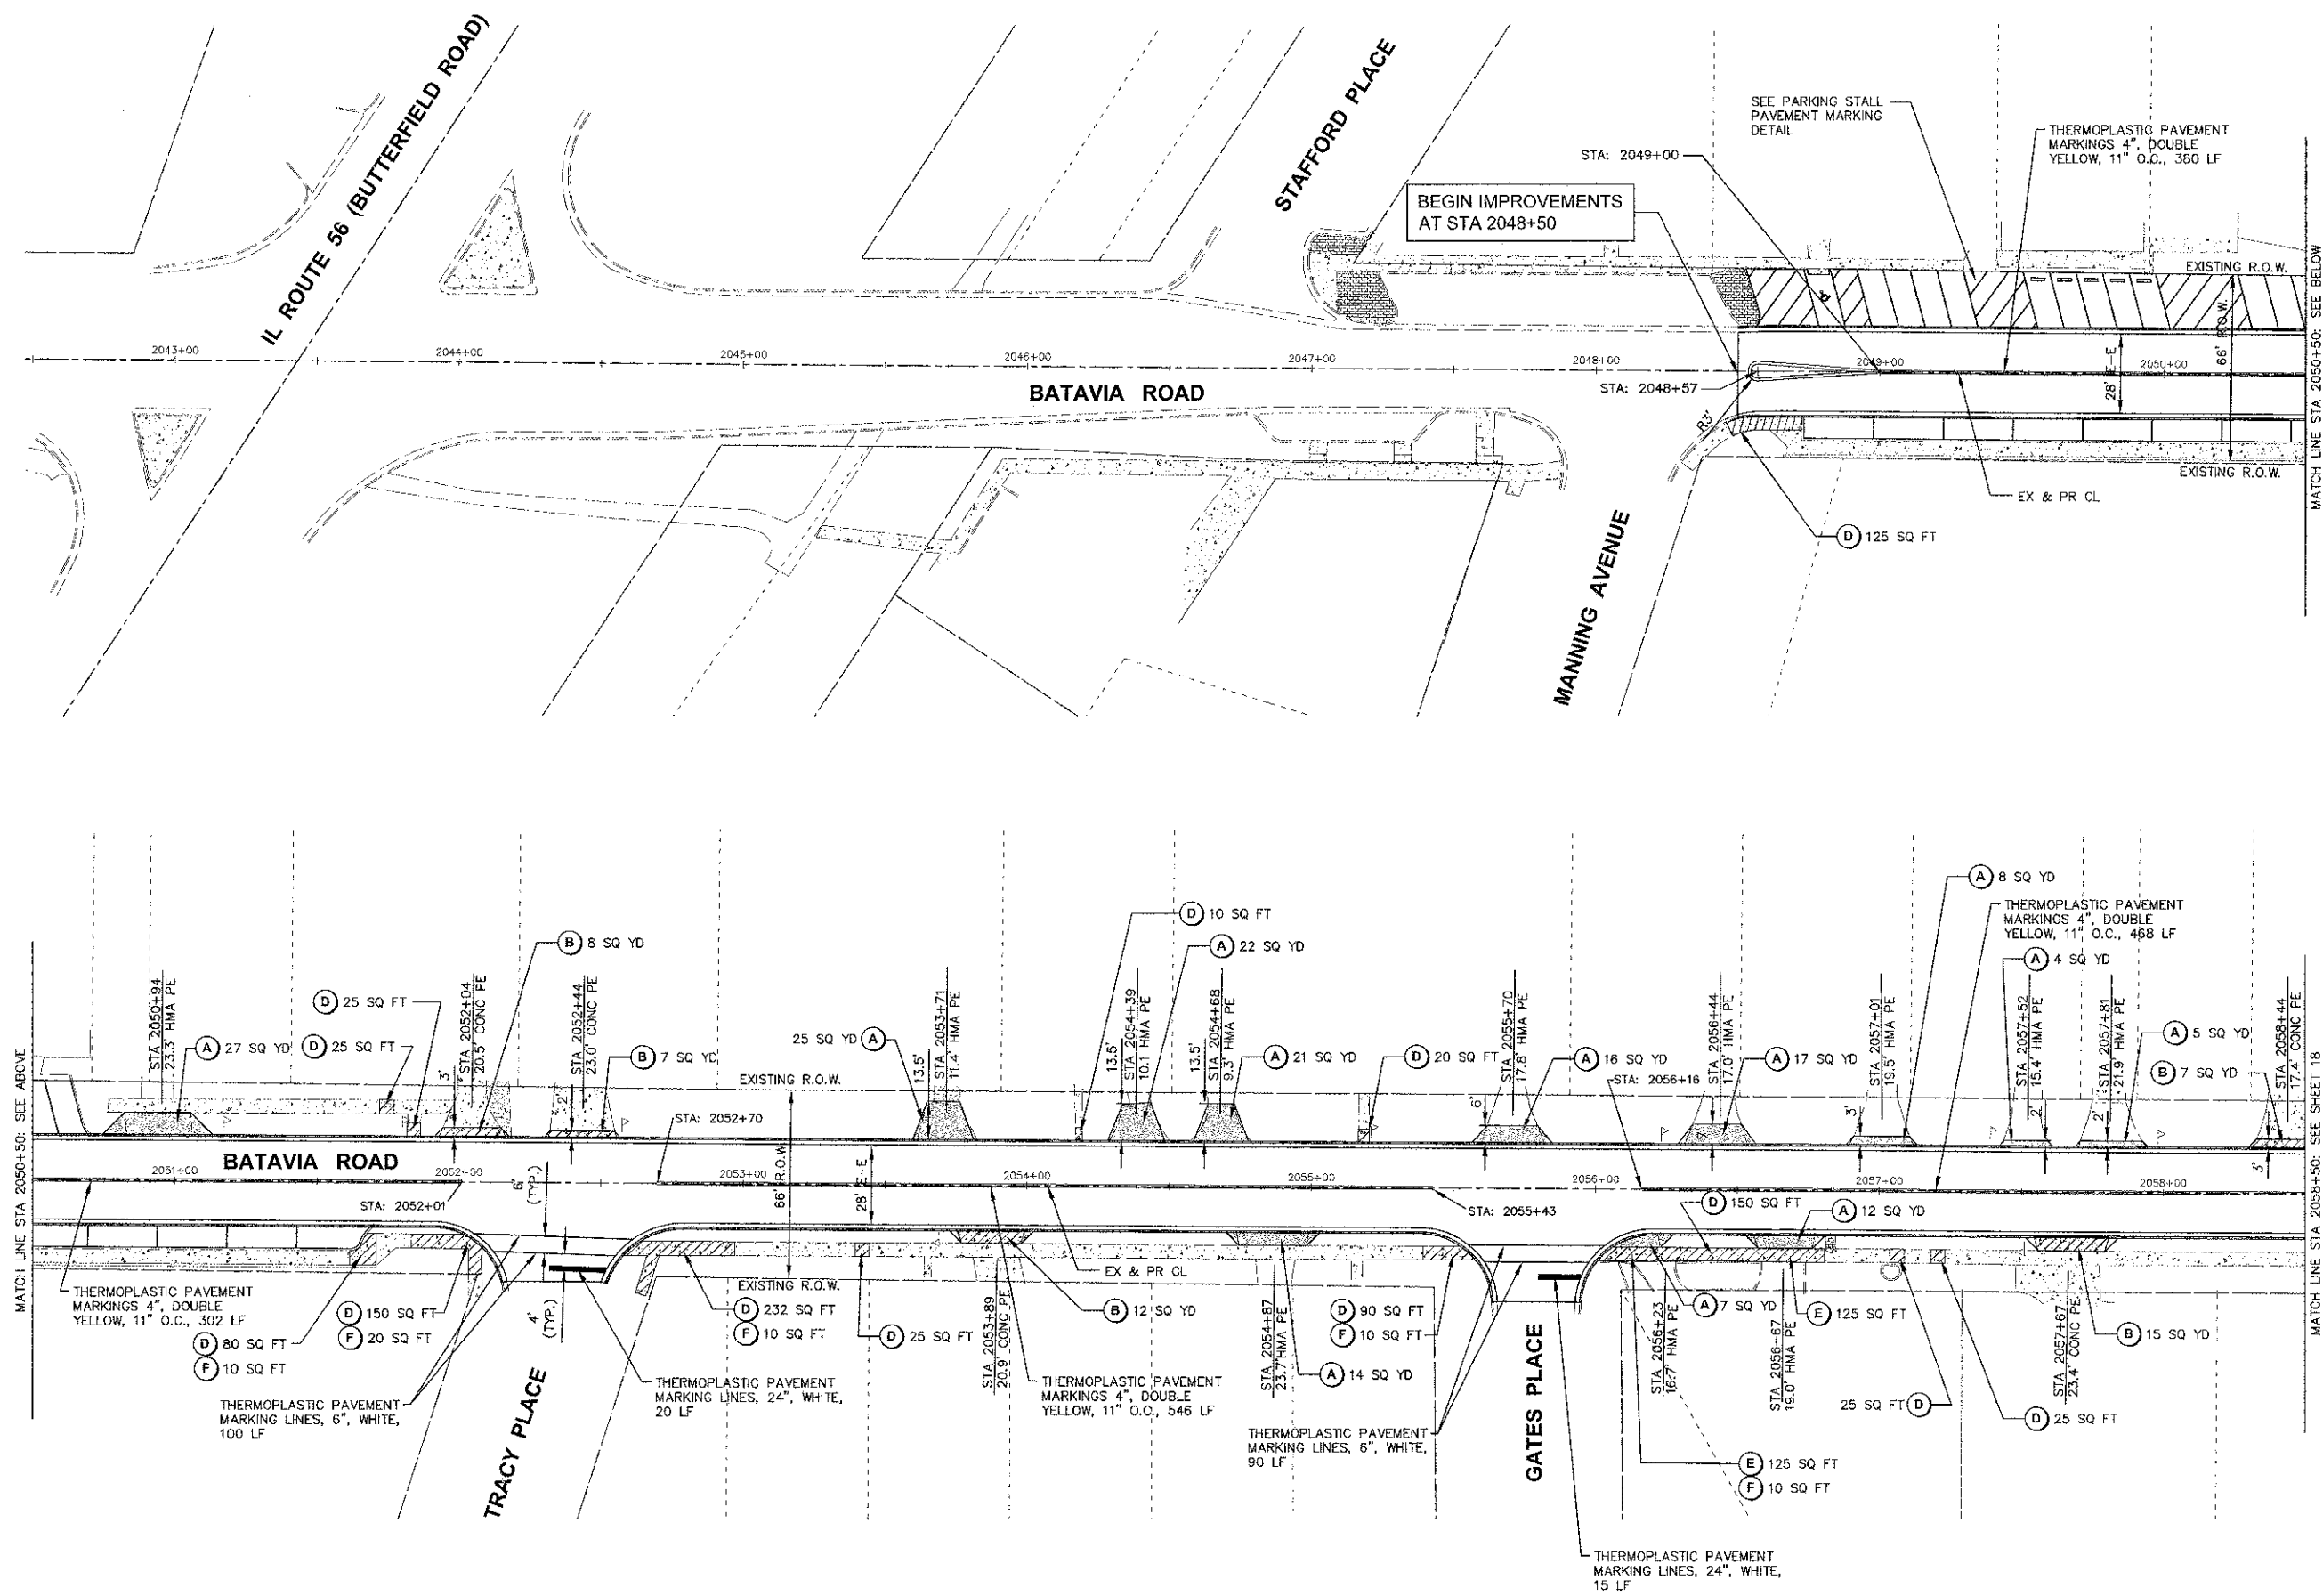

- LEGEND**
- EXISTING CONCRETE SIDEWALK OR DRIVEWAY TO REMAIN IN PLACE
 - SIDEWALK OR PCC DRIVEWAY REMOVAL AND REPLACEMENT
 - HOT-MIX ASPHALT DRIVEWAY REMOVAL AND REPLACEMENT
 - BRICK
 - (A) HOT-MIX ASPHALT DRIVEWAY AND PAVEMENT REMOVAL STABILIZED DRIVEWAYS, 10"
 - (B) DRIVEWAY PAVEMENT REMOVAL AND PORTLAND CEMENT CONCRETE DRIVEWAY PAVEMENT, 7"
 - (C) BRICK PAVER REMOVAL AND REPLACEMENT
 - (D) SIDEWALK REMOVAL AND PORTLAND CEMENT CONCRETE SIDEWALK, 5"
 - (E) SIDEWALK REMOVAL AND PORTLAND CEMENT CONCRETE SIDEWALK, 7"
 - (F) DETECTABLE WARNINGS
 - (G) PORTLAND CEMENT CONCRETE SIDEWALK, 5"
 - (H) PORTLAND CEMENT CONCRETE SIDEWALK, 7"
 - (I) HOT-MIX ASPHALT DRIVEWAY AND PAVEMENT REMOVAL STABILIZED DRIVEWAY PAVEMENT

- NOTES:**
1. THE CITY OF WARRENVILLE SHALL REMOVE, REPLACE, RELOCATE AND FURNISH ALL SIGNS REQUIRED.
 2. RECESSED REFLECTIVE PAVEMENT MARKERS PLACEMENT AND COLOR SHALL CONFORM TO IDOT DISTRICT 1 HIGHWAY STANDARD TC-11

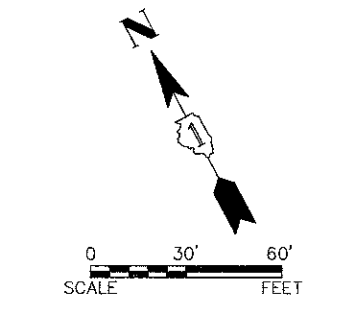

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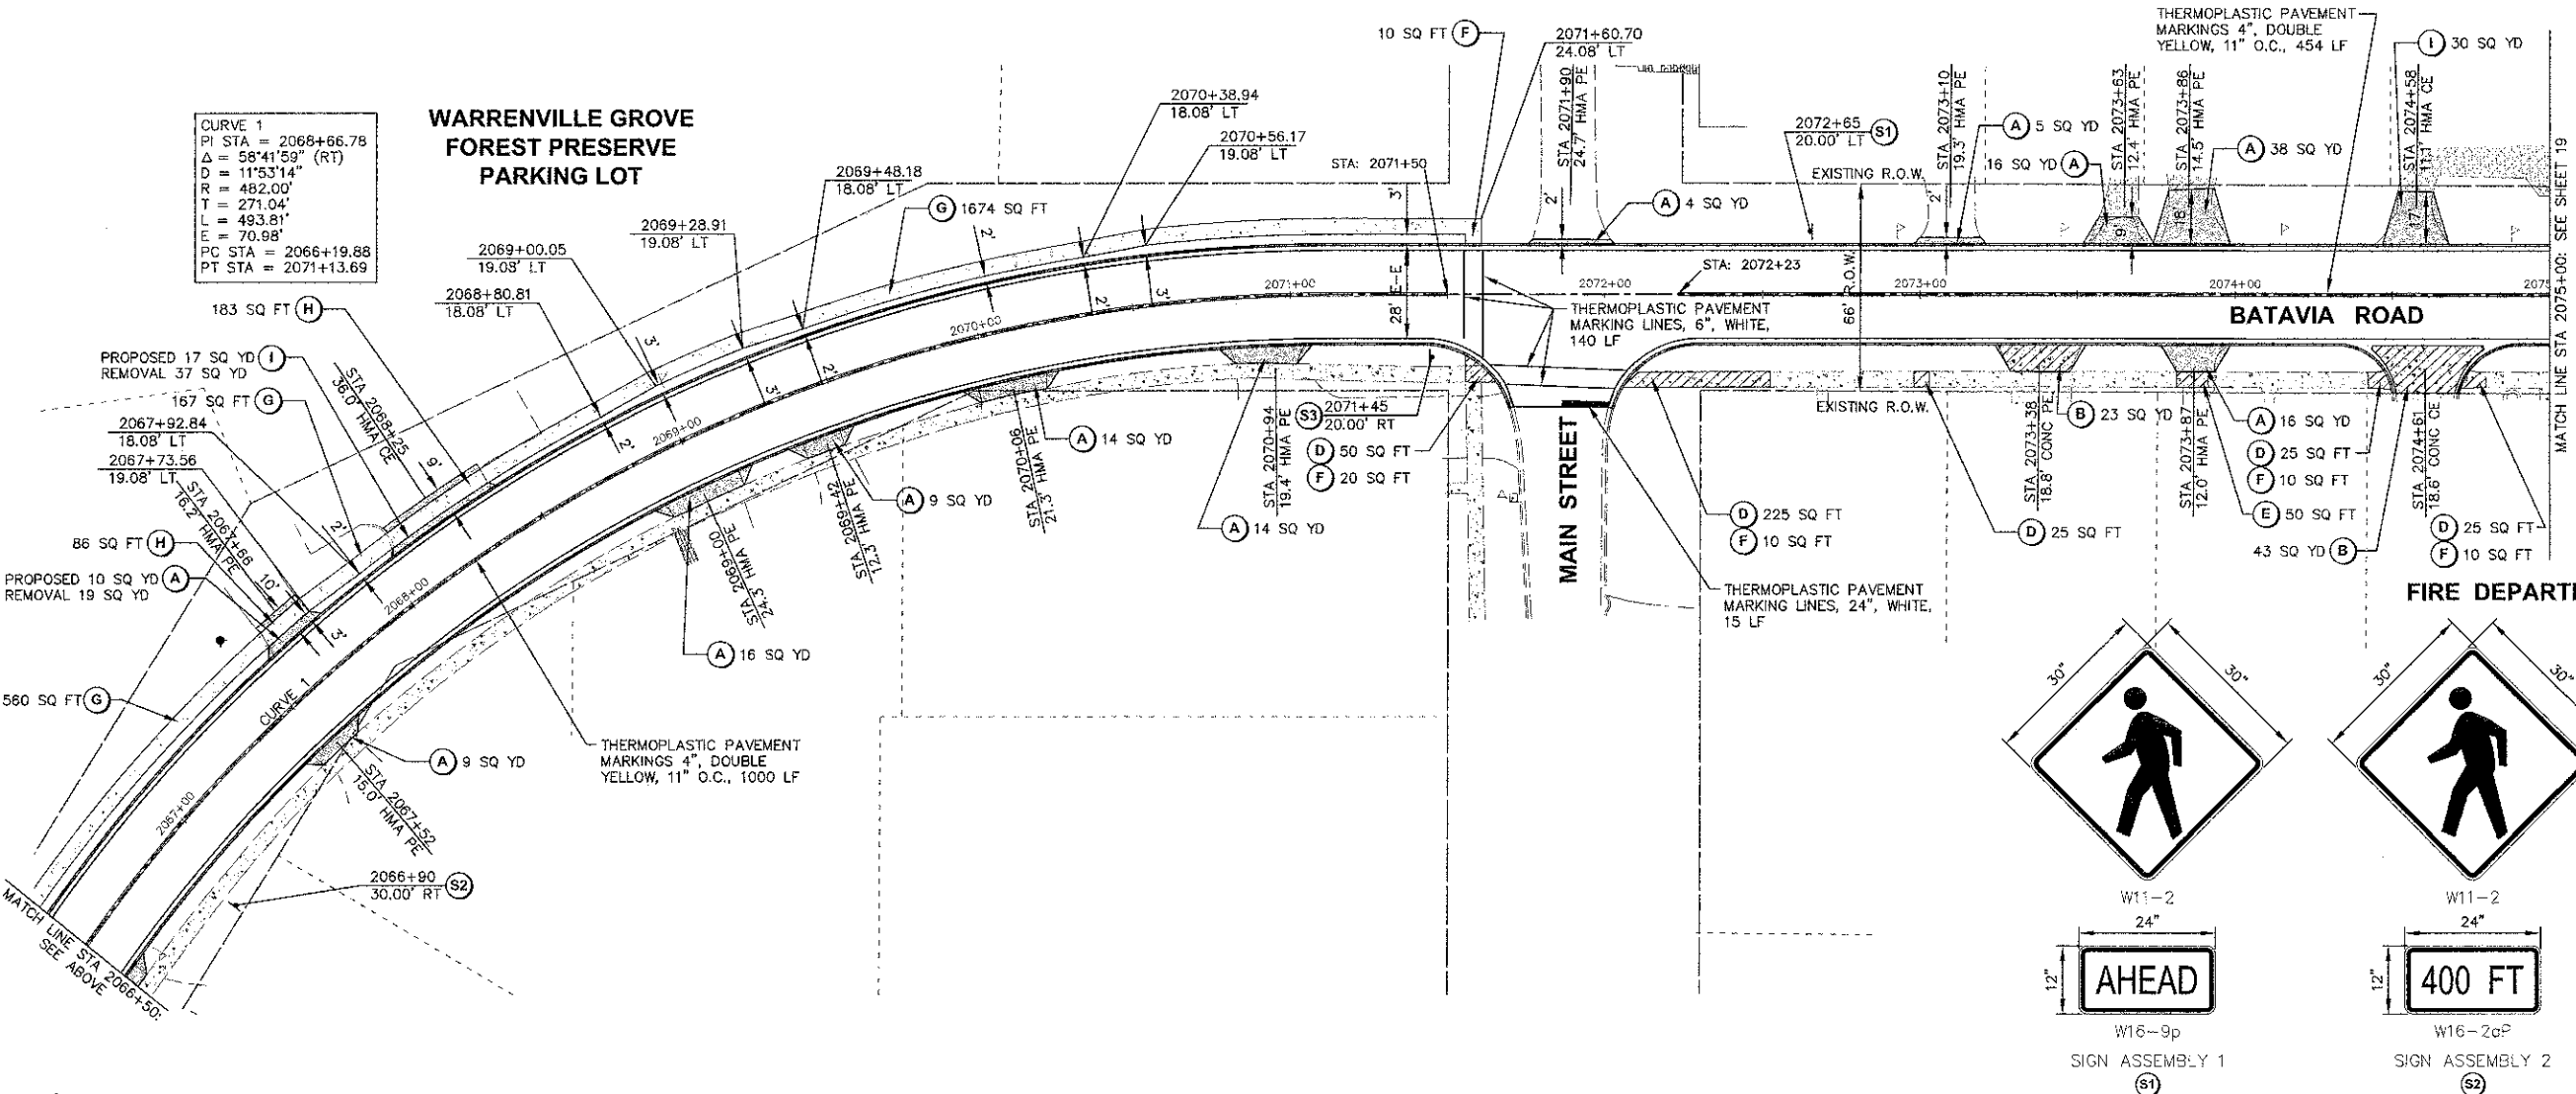
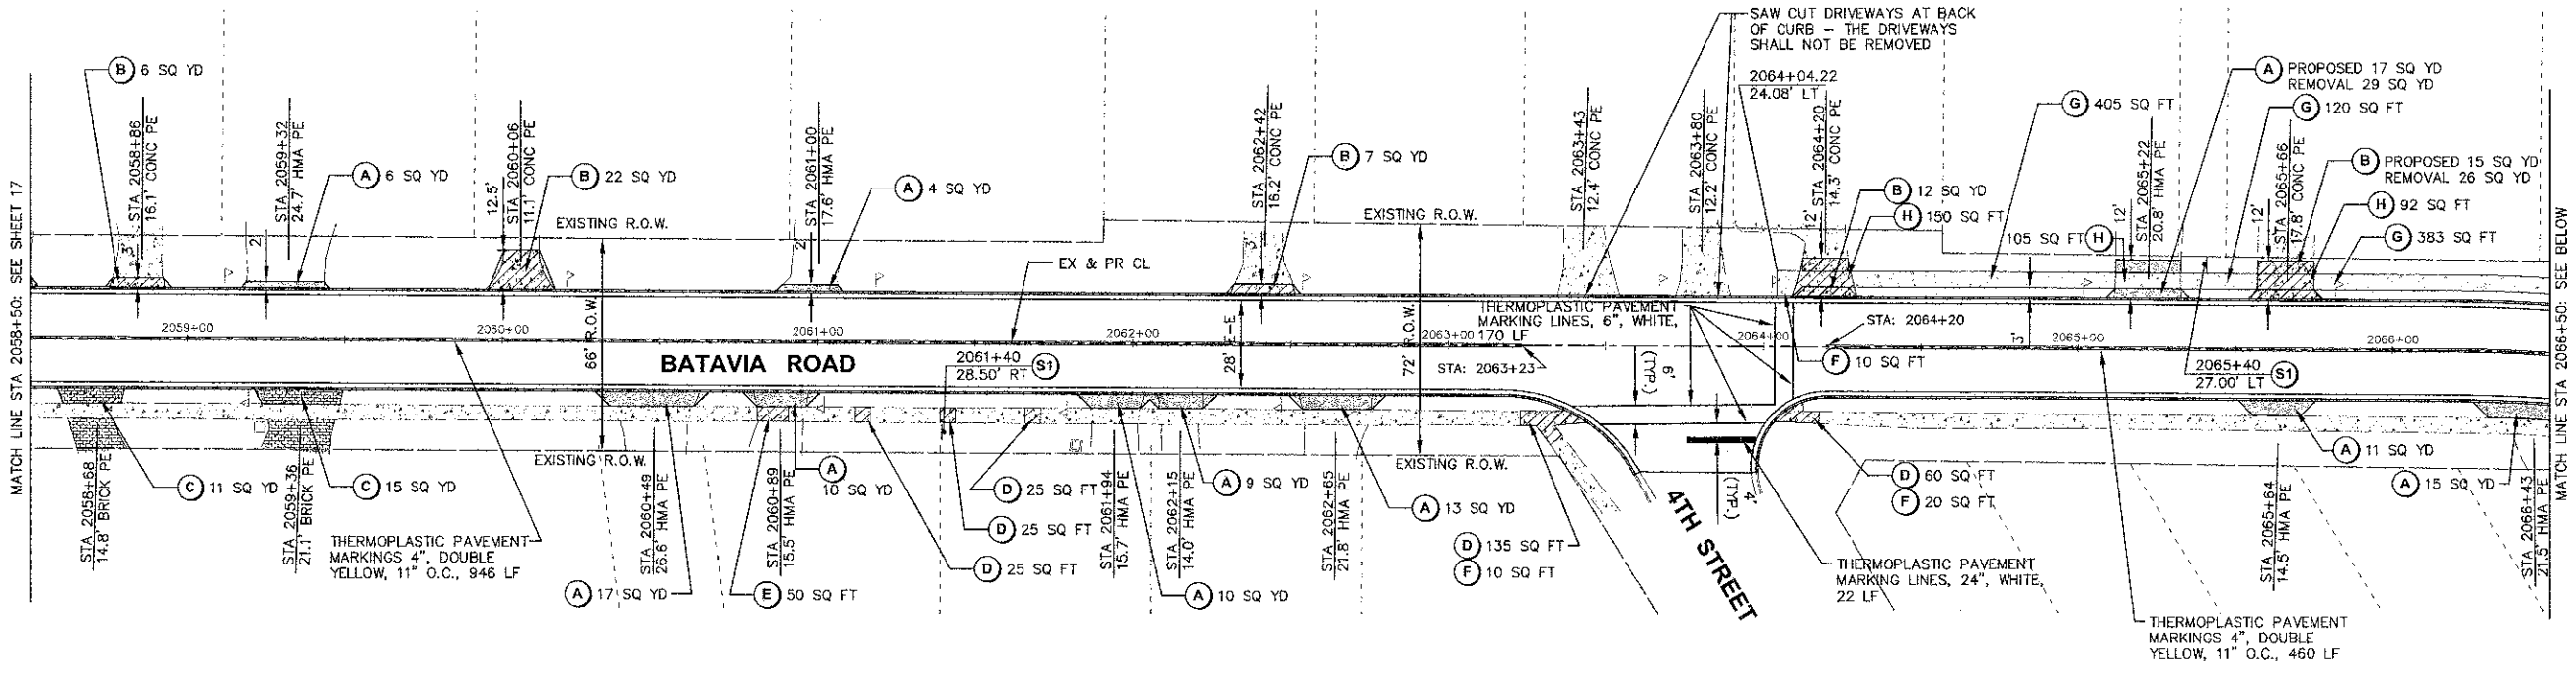
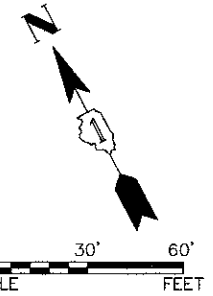
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PLLOT DATE =	CHECKED - JRL	REVISED -
	DATE - 8/24/12	REVISED -

STATE OF ILLINOIS
DEPARTMENT OF TRANSPORTATION

PAVEMENT MARKING, SIGNING, SIDEWALK AND DRIVEWAY PLAN	
SCALE: N/A	SHEET NO. 1 OF 3 SHEETS
STA. 2043+00	TO STA. 2058+50



F.A.J. RTE.	SECTION	COUNTY	TOTAL SHEETS	SHEET NO.
3553	10-00031-00-RS	DUPAGE	29	17
FED. ROAD DIST. NO. 1 ILLINOIS FED. AID PROJECT - M-90038661			CONTRACT NO. 63758	



CURVE 1
 PI STA = 2068+66.78
 $\Delta = 58^{\circ}41'59''$ (RT)
 $D = 11^{\circ}53'14''$
 $R = 482.00'$
 $T = 271.04'$
 $L = 493.81'$
 $E = 70.98'$
 PC STA = 2066+19.88
 PT STA = 2071+13.69



WARRENVILLE GROVE FOREST PRESERVE PARKING LOT

- LEGEND**
- EXISTING CONCRETE SIDEWALK OR DRIVEWAY TO REMAIN IN PLACE
 - SIDEWALK OR PCC DRIVEWAY REMOVAL AND REPLACEMENT
 - HOT-MIX ASPHALT DRIVEWAY REMOVAL AND REPLACEMENT
 - BRICK
 - (A) HOT-MIX ASPHALT DRIVEWAY AND PAVEMENT REMOVAL STABILIZED DRIVEWAYS, 10"
 - (B) DRIVEWAY PAVEMENT REMOVAL AND PORTLAND CEMENT CONCRETE DRIVEWAY PAVEMENT, 7"
 - (C) BRICK PAVER REMOVAL AND REPLACEMENT
 - (D) SIDEWALK REMOVAL AND PORTLAND CEMENT CONCRETE SIDEWALK, 5"
 - (E) SIDEWALK REMOVAL AND PORTLAND CEMENT CONCRETE SIDEWALK, 7"
 - (F) DETECTABLE WARNINGS
 - (G) PORTLAND CEMENT CONCRETE SIDEWALK, 5"
 - (H) PORTLAND CEMENT CONCRETE SIDEWALK, 7"
 - (I) HOT-MIX ASPHALT DRIVEWAY AND PAVEMENT REMOVAL STABILIZED DRIVEWAY PAVEMENT
- NOTES:**
- THE CITY OF WARRENVILLE SHALL REMOVE, REPLACE, RELOCATE AND FURNISH ALL SIGNS REQUIRED.
 - RECESSED REFLECTIVE PAVEMENT MARKERS PLACEMENT AND COLOR SHALL CONFORM TO IDOT DISTRICT 1 HIGHWAY STANDARD TC-11

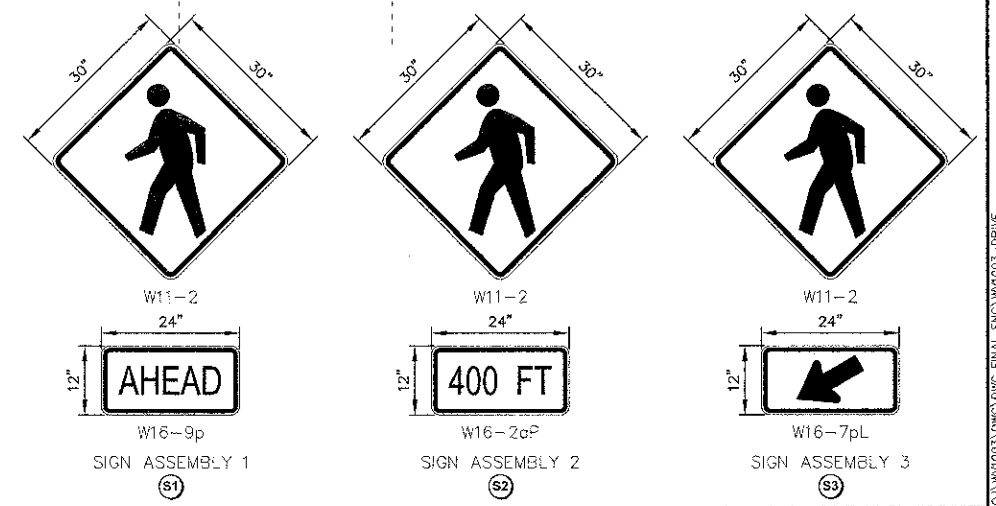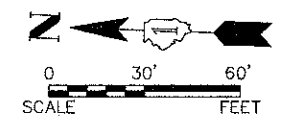


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Engineering Enterprises, Inc. CONSULTING ENGINEERS 52 Wheeler Road Sugar Grove, Illinois 60554 630.456.8700 / www.eelweb.com	USER NAME =	DESIGNED - SWM/LVW	REVISED -	STATE OF ILLINOIS DEPARTMENT OF TRANSPORTATION	PAVEMENT MARKING, SIGNING, SIDEWALK AND DRIVEWAY PLAN			F.A.U. RTE. = 3553	SECTION = 10-00031-00-RS	COUNTY = DUPAGE	TOTAL SHEETS = 29	SHEET NO. = 18
	PLOT SCALE =	DRAWN - KKP/CLN/JPS	REVISED -					SHEET NO. 2 OF 3 SHEETS	STA. 2058+50 TO STA. 2075+00	FED. ROAD DIST. NO. 1 ILLINOIS	FED. AID PROJECT - M-300316661	
	PLOT DATE =	DATE = 8/24/12	REVISED -									

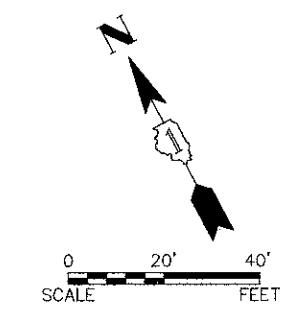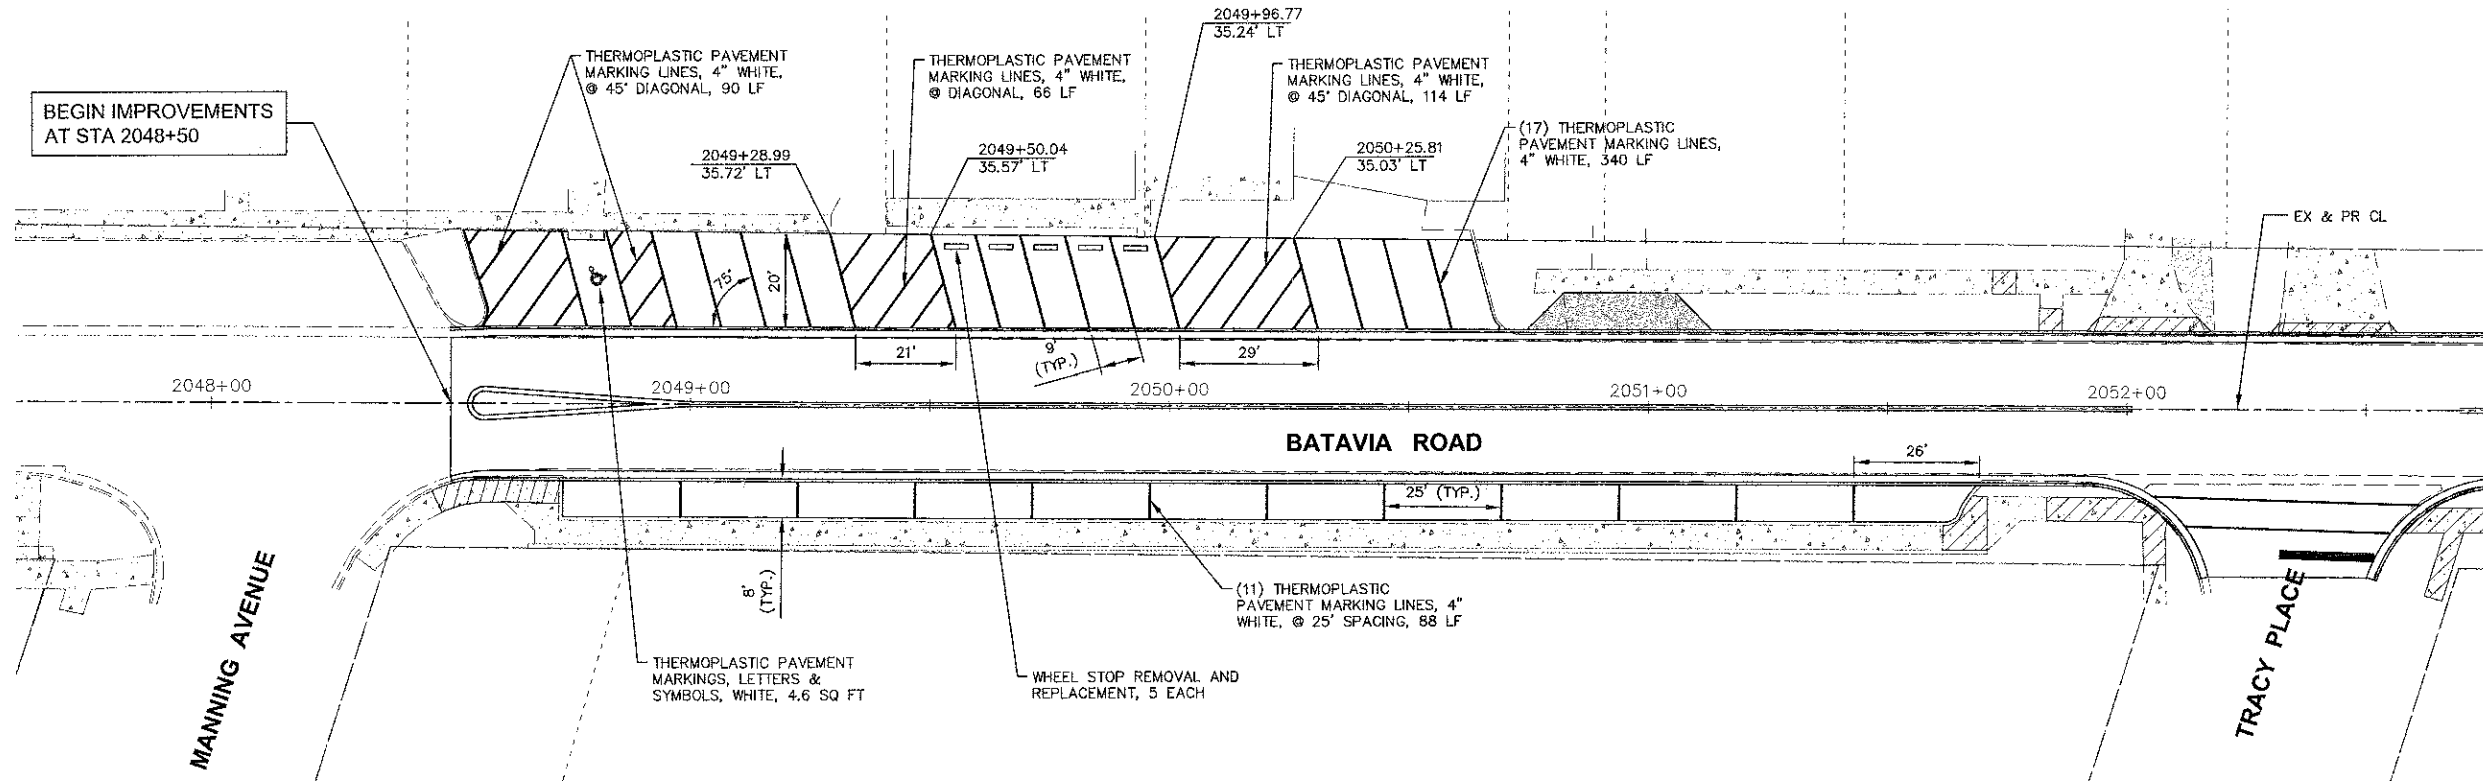

LEGEND

	EXISTING CONCRETE SIDEWALK OR DRIVEWAY TO REMAIN IN PLACE
	SIDEWALK OR PCC DRIVEWAY REMOVAL AND REPLACEMENT
	HOT-MIX ASPHALT DRIVEWAY REMOVAL AND REPLACEMENT

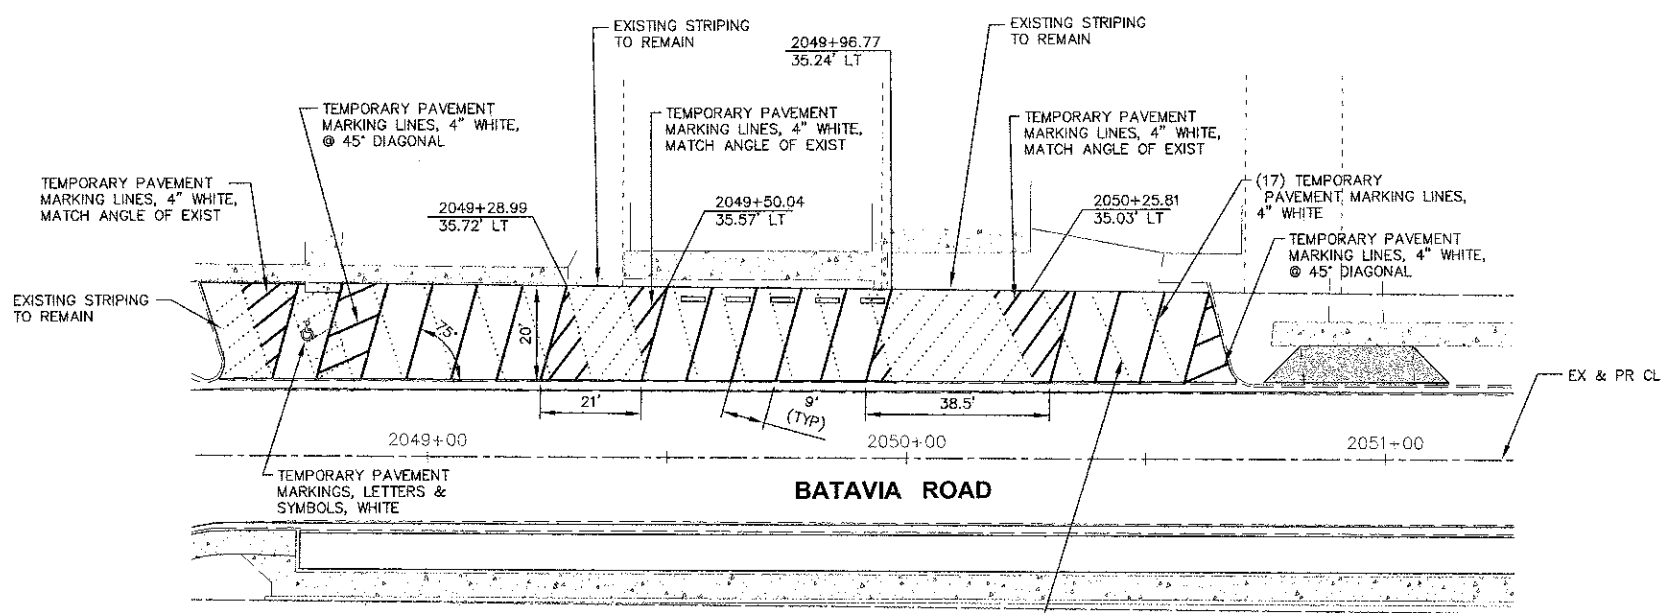

TEMPORARY PARKING STALL PAVEMENT MARKING

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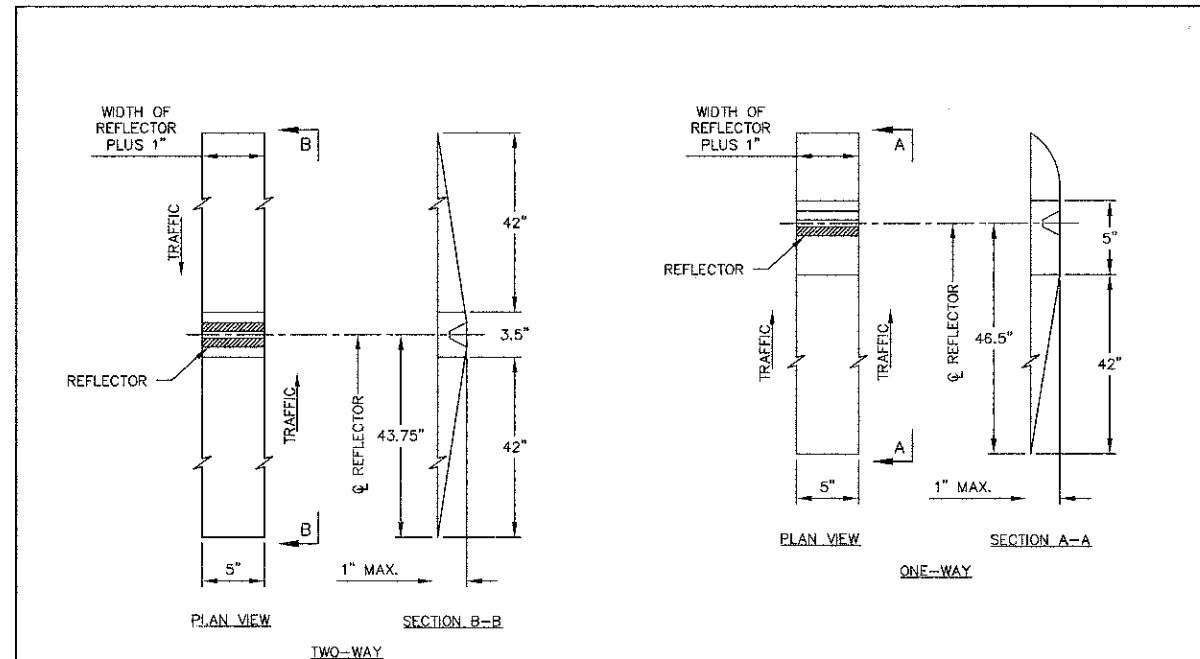
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PLOT DATE =	CHECKED - JRL	REVISED -
	DATE - 8/24/12	REVISED -

STATE OF ILLINOIS
DEPARTMENT OF TRANSPORTATION

PARKING STALL PAVEMENT MARKING DETAIL	
SCALE: 1"=20'	SHEET NO. 1 OF 1 SHEETS
STA. 2048+00	TO STA. 2052+50

F.A.U. RTE.	SECTION	COUNTY	TOTAL SHEETS	SHEET NO.
3553	10-00031-00-RS	DUPAGE	29	20
CONTRACT NO. 63758			FED. ROAD DIST. NO. 1 ILLINOIS FED. AID PROJECT - M-9003(866)	

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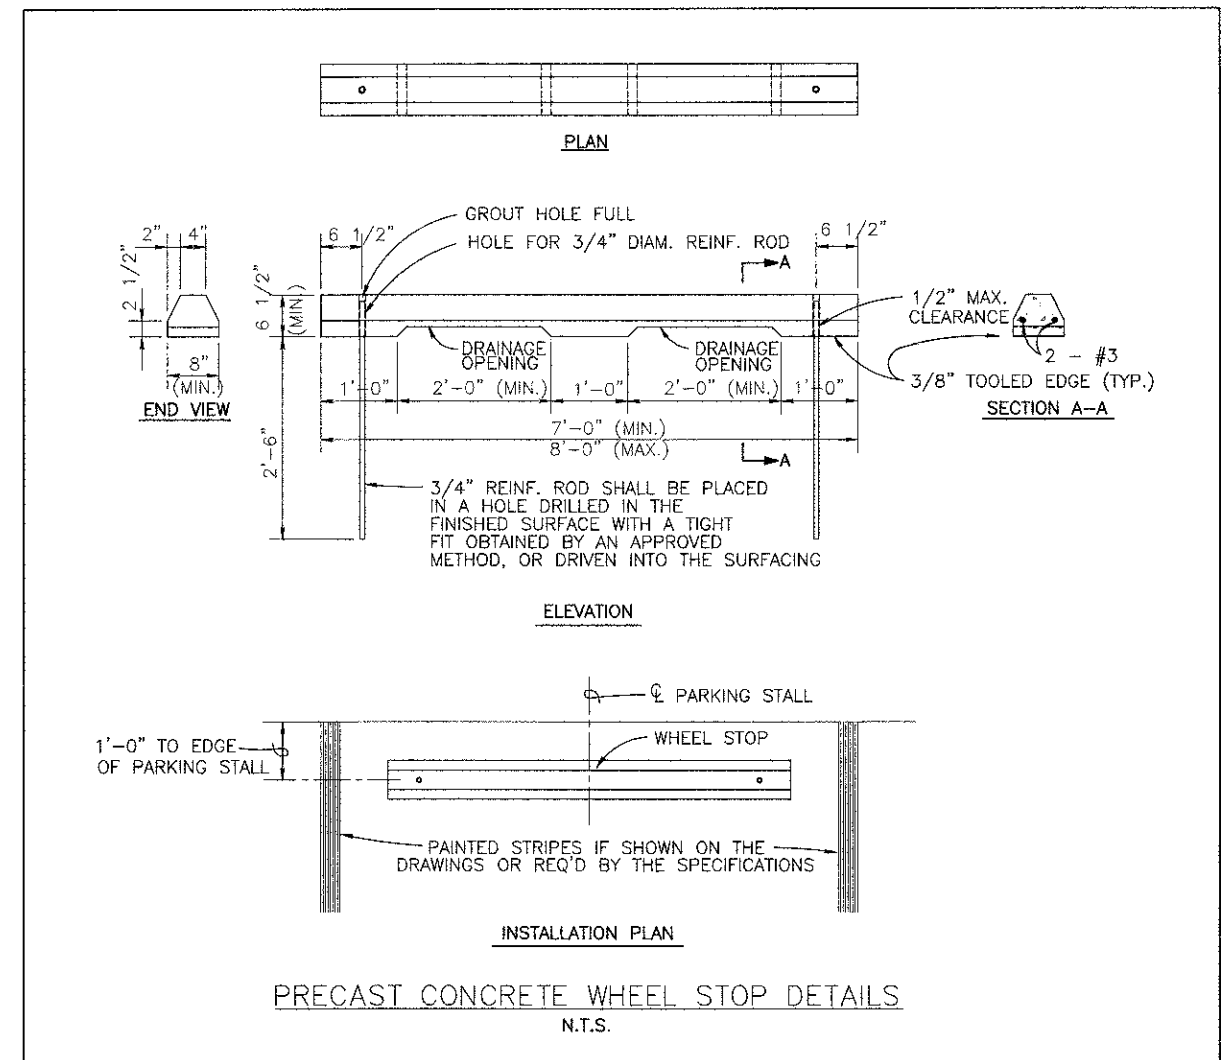
RECESSED REFLECTIVE PAVEMENT MARKERS
N.T.S.

INSTALLATION NOTES:


1. SAW CUT TO DIMENSIONS SHOWN.
2. SAW CUT AREAS TO BE DRY AND FREE OF MATERIAL THAT ADVERSELY AFFECTS THE ADHESIVE BOND.
3. INSTALL THE REFLECTOR WITH AN APPROVED TWO-COMPONENT EPOXY ADHESIVE. EPOXY SHALL NOT OBSCURE OR BLOCK THE LENS.
4. INSTALL TOP OF REFLECTOR 1/2 TO 1/4 INCH BELOW THE PAVEMENT SURFACE.
5. REFLECTOR SHALL BE 3M SERIES 180 OR APPROVED EQUAL.

GENERAL NOTE:

1. MARKER PLACEMENT AND COLOR SHALL CONFORM TO IDOT DISTRICT 1 HIGHWAY STANDARD TC-11.



PRECAST CONCRETE WHEEL STOP DETAILS
N.T.S.

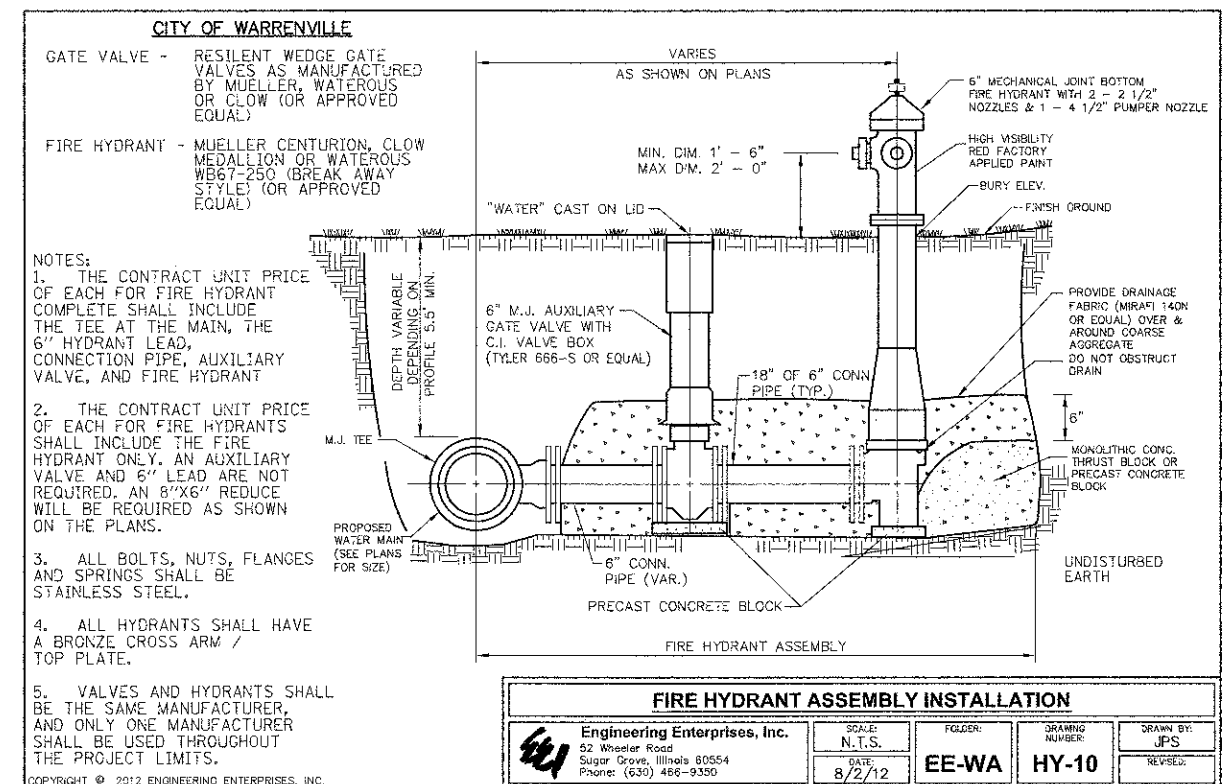

CITY OF WARRENVILLE
GATE VALVE - RESILIENT WEDGE GATE VALVES AS MANUFACTURED BY MUELLER, WATERLOUS OR CLOW (OR APPROVED EQUAL)
FIRE HYDRANT - MUELLER CENTURION, CLOW MEDALLION OR WATERLOUS WB67-250 (BREAK AWAY STYLE) (OR APPROVED EQUAL)

- NOTES:
1. THE CONTRACT UNIT PRICE OF EACH FOR FIRE HYDRANT COMPLETE SHALL INCLUDE THE TEE AT THE MAIN, THE 6" HYDRANT LEAD, CONNECTION PIPE, AUXILIARY VALVE, AND FIRE HYDRANT
 2. THE CONTRACT UNIT PRICE OF EACH FOR FIRE HYDRANTS SHALL INCLUDE THE FIRE HYDRANT ONLY. AN AUXILIARY VALVE AND 6" LEAD ARE NOT REQUIRED. AN 8"x6" REDUCE WILL BE REQUIRED AS SHOWN ON THE PLANS.
 3. ALL BOLTS, NUTS, FLANGES AND SPRINGS SHALL BE STAINLESS STEEL.
 4. ALL HYDRANTS SHALL HAVE A BRONZE CROSS ARM / TOP PLATE.
 5. VALVES AND HYDRANTS SHALL BE THE SAME MANUFACTURER, AND ONLY ONE MANUFACTURER SHALL BE USED THROUGHOUT THE PROJECT LIMITS.

FIRE HYDRANT ASSEMBLY INSTALLATION

Engineering Enterprises, Inc.
52 Wheeler Road
Sugar Grove, Illinois 60554
Phone: (630) 466-9350

SCALE: N.T.S.
DATE: 8/2/12

FOLDER: EE-WA
DRAWING NUMBER: HY-10

DRAWN BY: JPS
REVISED:

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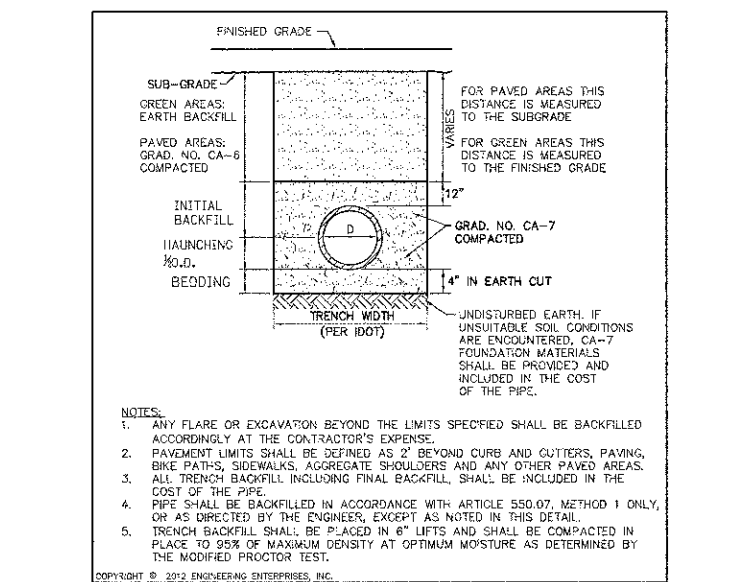
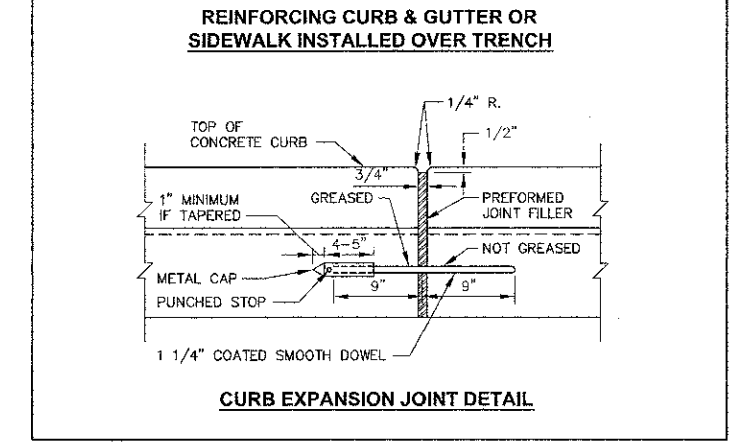
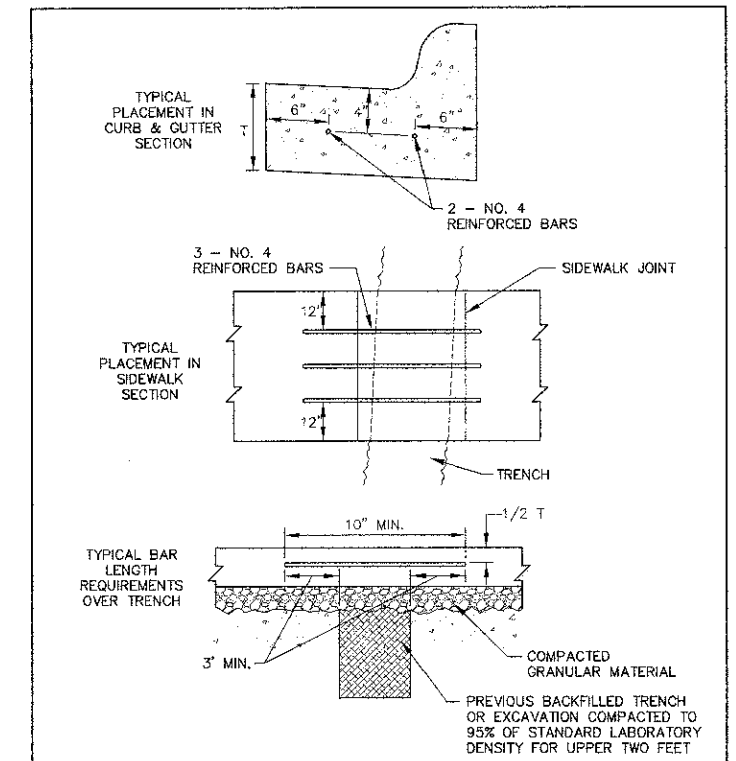
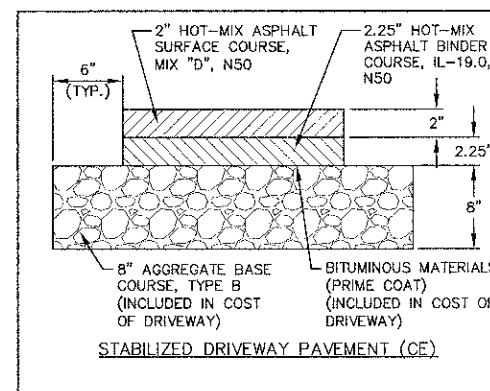
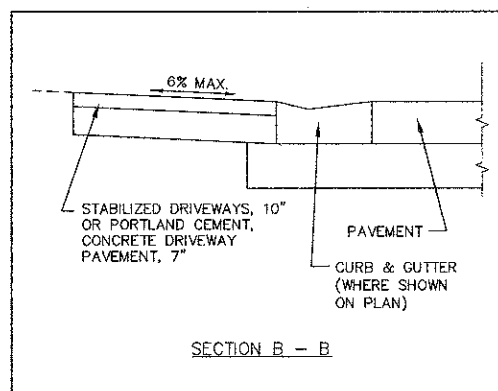
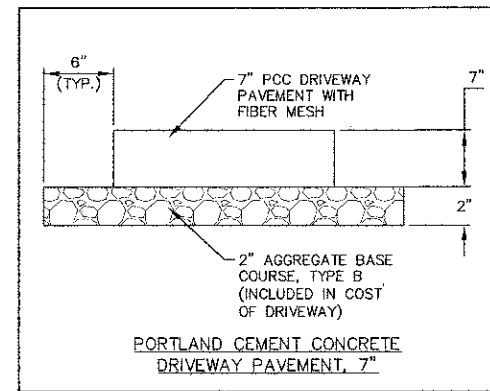
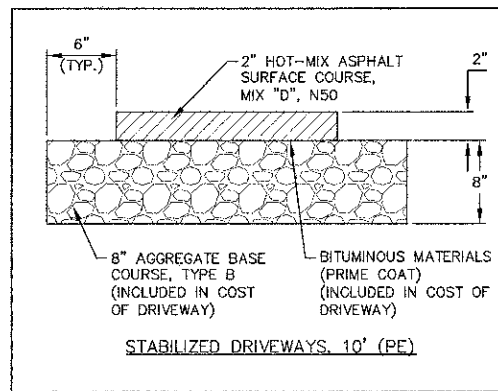
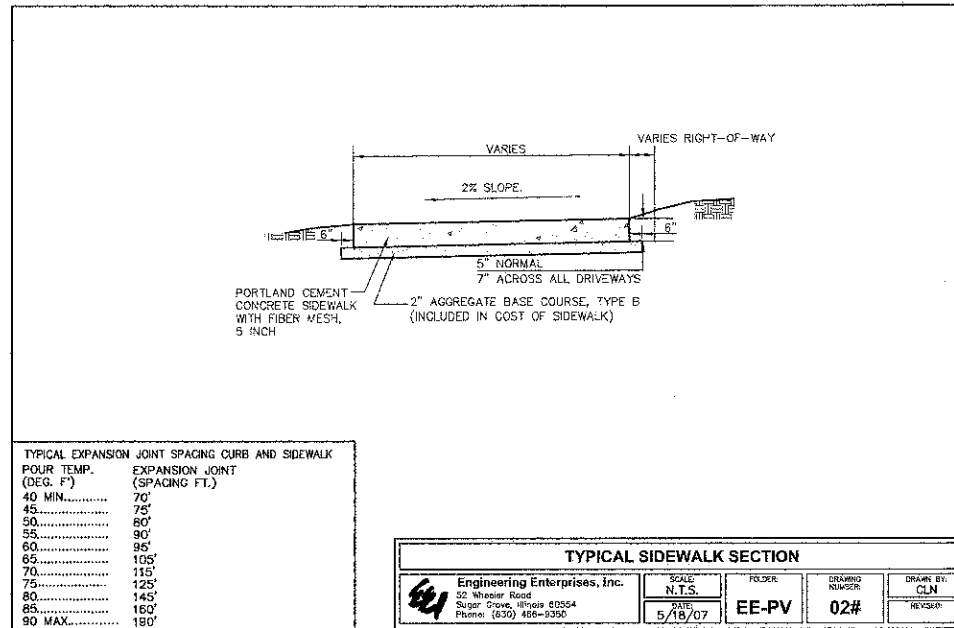
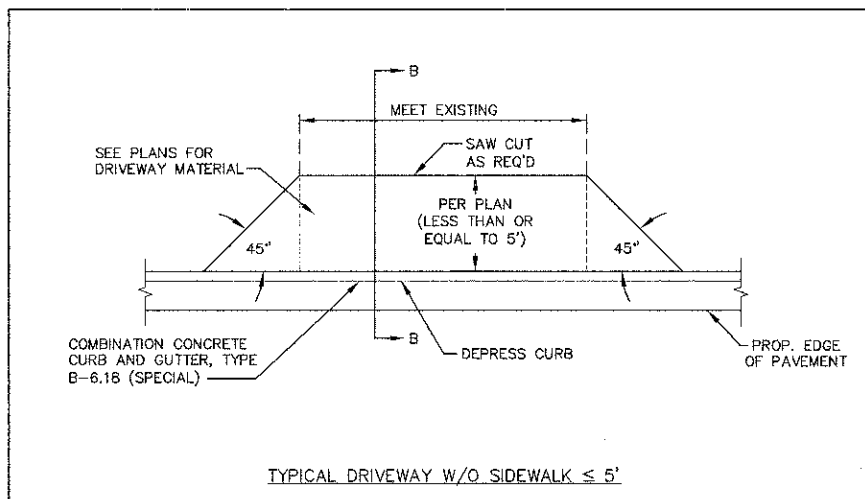
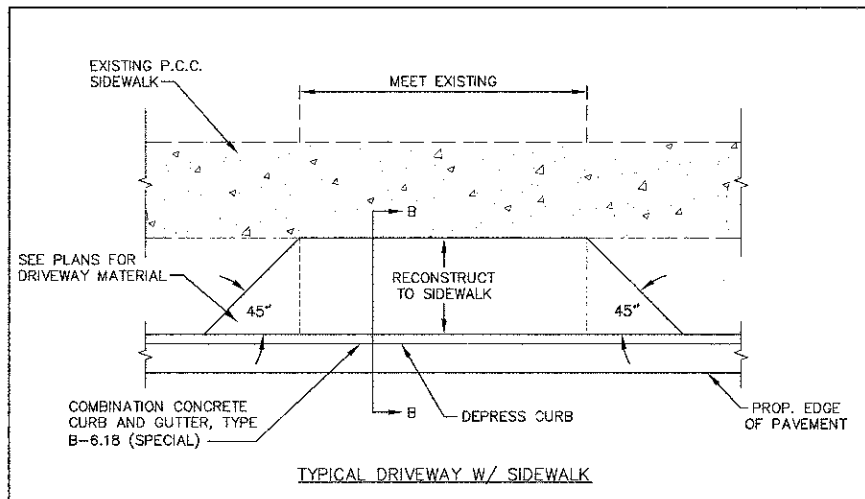
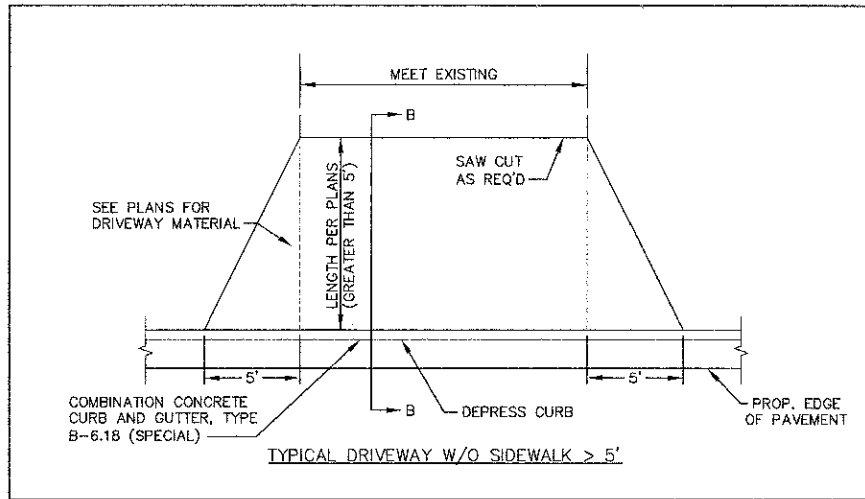
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PLOT SCALE =	DRAWN - KKP/CLN/JPS	REVISED -
PLOT DATE =	CHECKED - JRL	REVISED -
	DATE - 8/24/12	REVISED -

STATE OF ILLINOIS
DEPARTMENT OF TRANSPORTATION

SPECIAL DETAILS
SCALE: N/A
SHEET NO. 1 OF 2 SHEETS
STA. N/A TO STA. N/A

F.A.U. RTE. 3553	SECTION 10-00031-00-RS	COUNTY DUPAGE	TOTAL SHEETS 29	SHEET NO. 21
CONTRACT NO. 63758			FED. ROAD DIST. NO. 1 [ILLINOIS] FED. AID PROJECT - M-9003866	

FILE: \\SHPROD\VP\003\DWG\016 FINAL ENG\WFO03-CVR



Engineering Enterprises, Inc. 32 Wheeler Road Sugar Grove, Illinois 60054 Phone: (630) 466-9350	SCALE: N.T.S. DATE: 8/2/12	FOLDER: EE-SA	DRAWING NUMBER: TR-08	DRAWN BY: JPS	REVIEWED: 8/21/12
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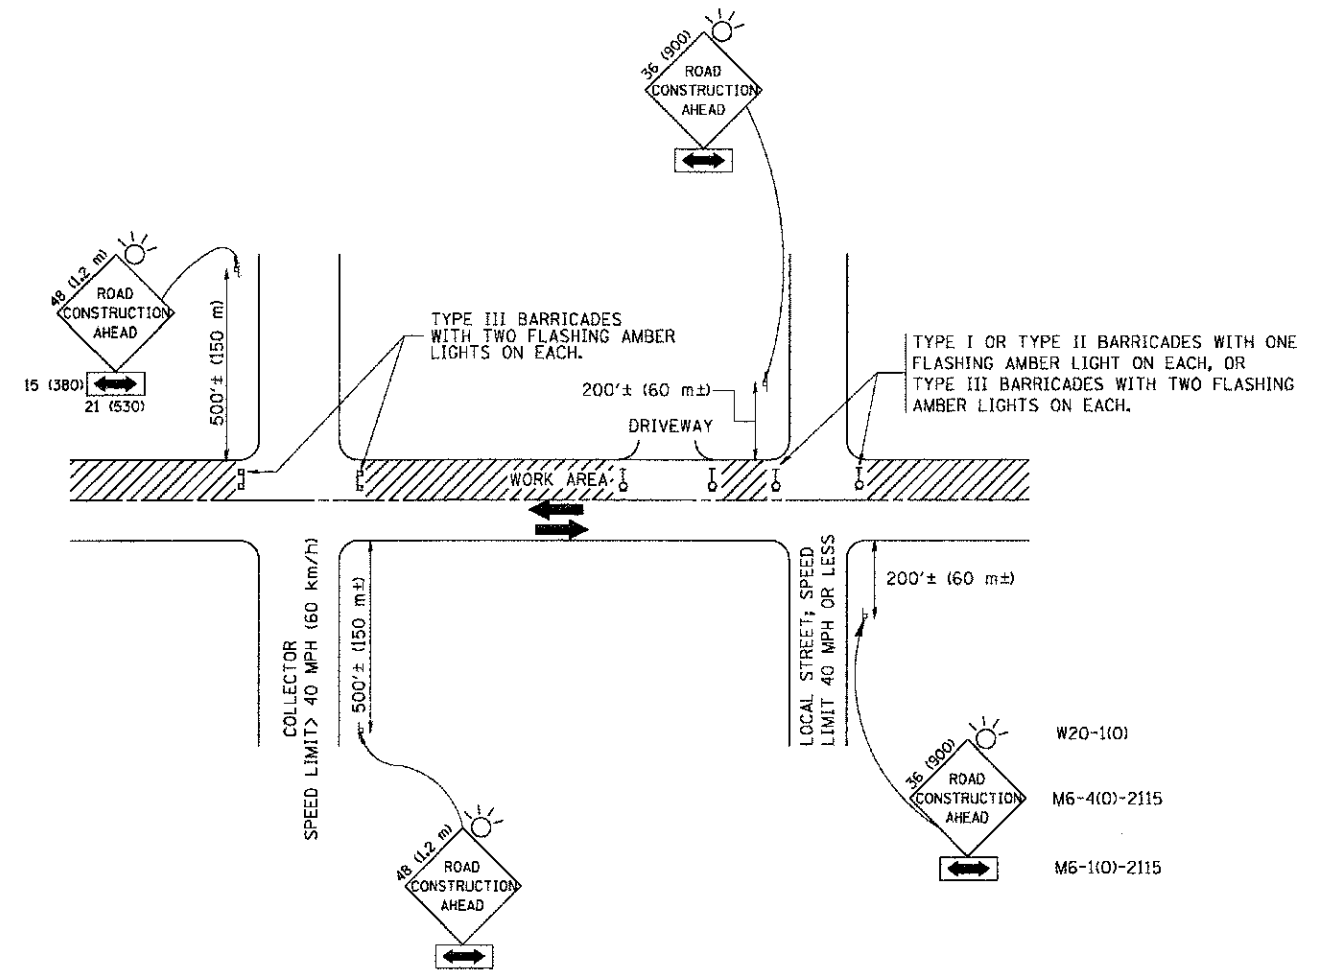
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PLOT DATE =	CHECKED - JRL	REVISED -
	DATE - 8/24/12	REVISED -

STATE OF ILLINOIS
DEPARTMENT OF TRANSPORTATION

SCALE: N/A	SHEET NO. 2 OF 2 SHEETS	STA. N/A TO STA. N/A
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F.A.U. RTE. 3553	SECTION 10-00031-00-RS	COUNTY DUPAGE	TOTAL SHEETS 29	SHEET NO. 22
FED. ROAD DIST. NO. 1 ILLINOIS			CONTRACT NO. 63758	
FED. AID PROJECT - M-9003866				

Path: S:\SIB\603\W1003\DWG\FINAL_ENG\W1003-CR



TRAFFIC CONTROL AND PROTECTION FOR SIDE ROADS, INTERSECTIONS, AND DRIVEWAYS

NOTES:

A. FOR NO LANE RESTRICTION ON THE SIDE ROAD OR DRIVEWAYS

1. SIDE ROAD WITH A SPEED LIMIT OF 40 MPH (60 km/h) OR LESS AS SHOWN ON THE DRAWING AND AS DIRECTED BY THE ENGINEER:
 - a) ONE ROAD CONSTRUCTION AHEAD SIGN 36 x 36 (900x900) WITH A FLASHER AND FLAG MOUNTED ON IT APPROXIMATELY 200' (60 m) IN ADVANCE OF THE MAIN ROUTE.
 - b) THE CLOSED PORTION OF THE MAIN ROUTE SHALL BE PROTECTED BY BLOCKING WITH TYPE I, TYPE II OR TYPE III BARRICADES, 1/3 OF THE CROSS SECTION OF THE CLOSED PORTION.
2. SIDE ROAD WITH A SPEED LIMIT GREATER THAN 40 MPH (60 km/h) AS SHOWN ON THE DRAWING AND AS DIRECTED BY THE ENGINEER:
 - a) ONE ROAD CONSTRUCTION AHEAD SIGN 48 x 48 (1.2 m x 1.2 m) WITH A FLASHER MOUNTED ON IT APPROXIMATELY 500' (150 m) IN ADVANCE OF THE MAIN ROUTE.
 - b) THE CLOSED PORTION OF THE MAIN ROUTE SHALL BE PROTECTED BY BLOCKING WITH TYPE III BARRICADES, 1/2 OF THE CROSS SECTION OF THE CLOSED PORTION.
3. WHEN THE SIDE ROAD LIES BETWEEN THE BEGINNING OF THE MAINLINE SIGNING AND THE WORK ZONE, A SINGLE HEADED ARROW (M6-1) SHALL BE USED IN LIEU OF THE DOUBLE HEADED ARROW (M6-4).

B. FOR A LANE CLOSURE ON A SIDE ROAD OR DRIVEWAY:

- USE APPLICABLE PORTIONS OF THE TYPICAL APPLICATION OF TRAFFIC CONTROL DEVICES (STD. 701501, STD. 701606 OR THE APPROPRIATE STANDARD). THE SPACING OF SIGNS AND BARRICADES SHALL BE ADJUSTED FOR FIELD CONDITIONS AS DIRECTED BY THE ENGINEER. THE DIRECTIONAL ARROW SHALL BE COVERED OR REMOVED WHEN NO LONGER CONSISTENT WITH THE SIDE ROAD LANE CLOSURE.
- C. ADVANCE WARNING SIGNS ARE TO BE OMITTED ON DRIVEWAY UNLESS OTHERWISE NOTED.
- D. THE TRAFFIC CONTROL AND PROTECTION FOR SIDE ROADS, INTERSECTIONS, AND DRIVEWAYS SHALL BE INCIDENTAL TO THE COST OF SPECIFIED TRAFFIC CONTROL STANDARDS OR ITEMS.

All dimensions are in millimeters (inches) unless otherwise shown.

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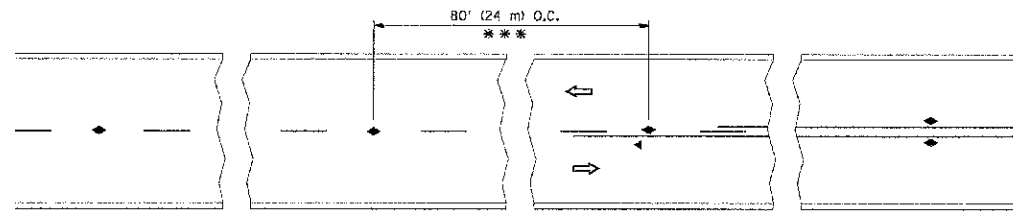
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			REVISED - T. RAMMACHER 01-06-00

STATE OF ILLINOIS
DEPARTMENT OF TRANSPORTATION

TRAFFIC CONTROL AND PROTECTION FOR SIDE ROADS, INTERSECTIONS, AND DRIVEWAYS			
SCALE: NONE	SHEET NO. 1 OF 1 SHEETS	STA.	TO STA.


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TC-10			CONTRACT NO. 63758	
FED. ROAD DIST. NO. 1 ILLINOIS FED. AID PROJECT - M-9003(866)				

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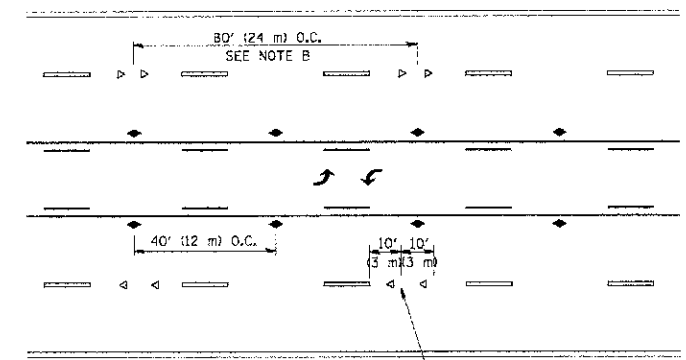


*** REDUCE TO 40' (12 m) O.C. ON CURVES WITH POSTED OR ADVISORY SPEED 45 M.P.H. (70 km/h) OR LESS.


TWO-LANE/TWO-WAY

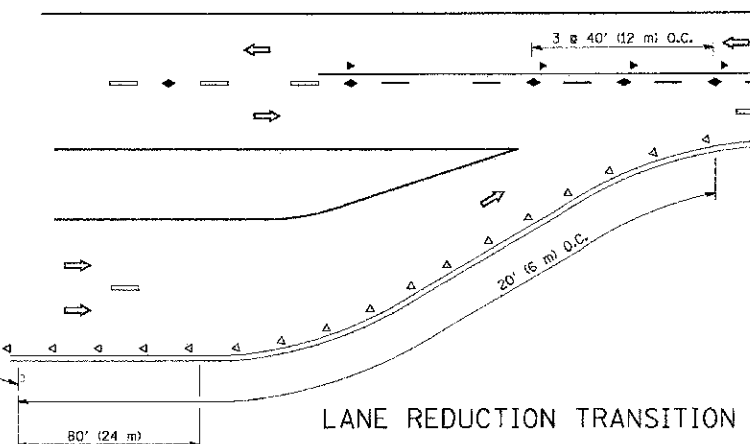


LANE REDUCTION TRANSITION



TWO-WAY LEFT TURN

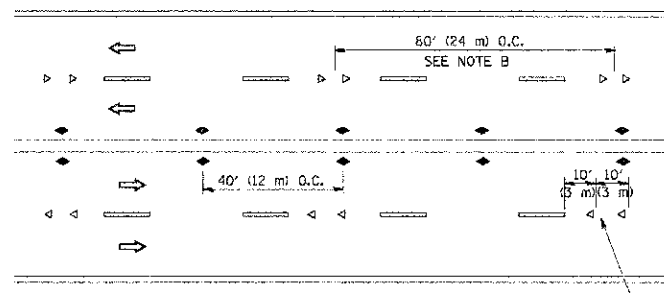

MULTI-LANE/UNDIVIDED

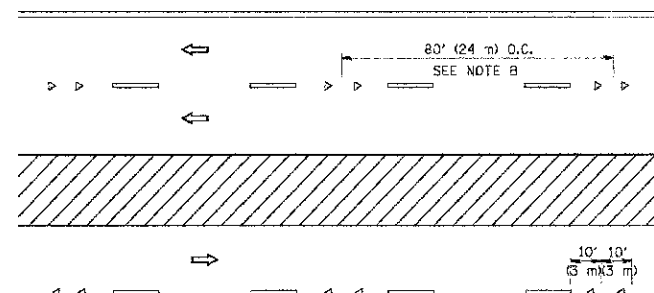

MULTI-LANE/DIVIDED

GENERAL NOTES

1. MARKERS USED WITH DASHED LINES SHALL BE CENTERED IN THE GAP BETWEEN SEGMENTS.
2. MARKERS USED ADJACENT TO SOLID LINES SHALL BE OFFSET 2 TO 3 (60 TO 75) TOWARD TRAFFIC AS SHOWN.
3. MARKERS THROUGH TANGENTS LESS THAN 500' (150 m) IN LENGTH BETWEEN CURVES SHALL BE INSTALLED AT THE LESSER OF THE TWO CURVE SPACINGS.

SYMBOLS


- YELLOW STRIPE
- WHITE STRIPE
- ◀ ONE-WAY AMBER MARKER
- ◁ ONE-WAY CRYSTAL MARKER (W/O)
- ◆ TWO-WAY AMBER MARKER

LANE MARKER NOTES

- A. USE DOUBLE LANE LINE MARKERS SPACED AS SHOWN.
- B. REDUCE TO 40' (12 m) O.C. ON CURVES WHERE ADVISORY SPEEDS ARE 10 M.P.H. (20 km/h) LOWER THAN POSTED SPEEDS.

DESIGN NOTES

1. DOUBLE LANE LINE MARKERS SHALL BE USED UNLESS SPECIFIED OTHERWISE.
2. EXCEPT AS SHOWN ON THE LANE REDUCTION TRANSITION AND FREEWAY EXIT RAMP DETAIL, MARKERS ARE NOT TO BE SPECIFIED ON RIGHT EDGE LINES.
3. THE EXACT MARKER LIMITS, SPACING, AND COLOR SHOULD BE INCLUDED IN THE PLANS.
4. MARKERS SHOULD NOT BE USED ALONGSIDE CURBS EXCEPT FOR EXTREMELY SHORT SECTIONS OF CURBS WHERE NOT MORE THAN TWO MARKERS WOULD BE INVOLVED.

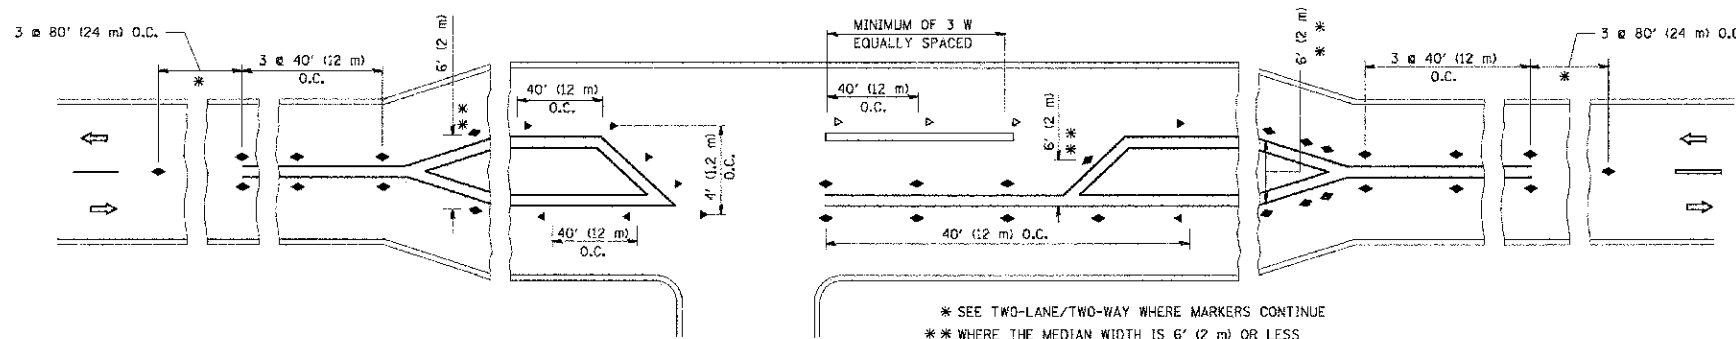

LEFT TURN

* SEE TWO-LANE/TWO-WAY WHERE MARKERS CONTINUE
 ** WHERE THE MEDIAN WIDTH IS 6' (2 m) OR LESS USE TWO-WAY MARKERS.

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 CHECKED -
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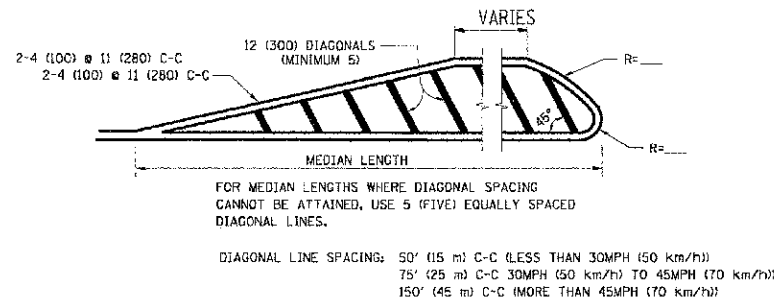
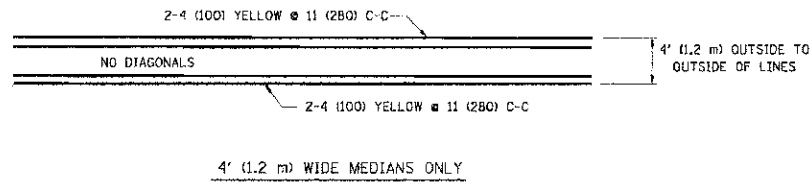
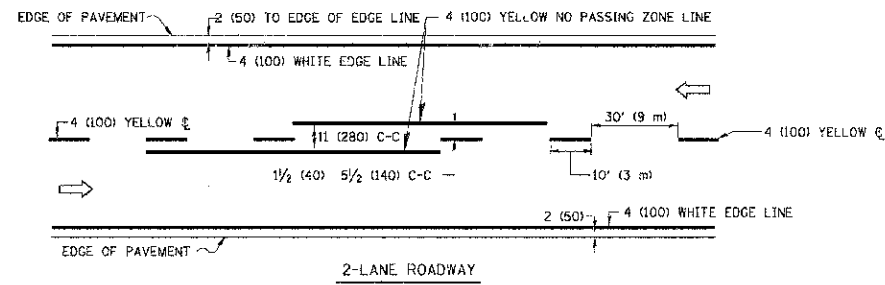
STATE OF ILLINOIS
 DEPARTMENT OF TRANSPORTATION

TYPICAL APPLICATIONS			
RAISED REFLECTIVE PAVEMENT MARKERS (SNOW-PLOW RESISTANT)			
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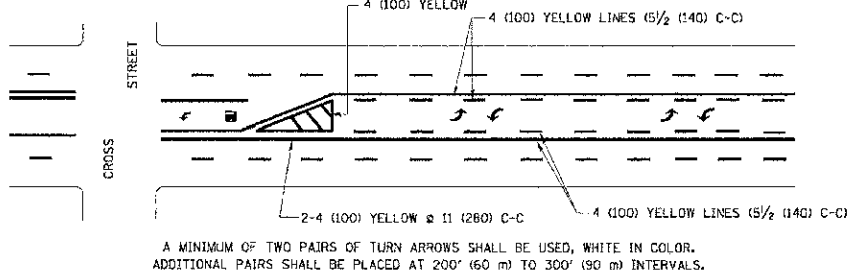
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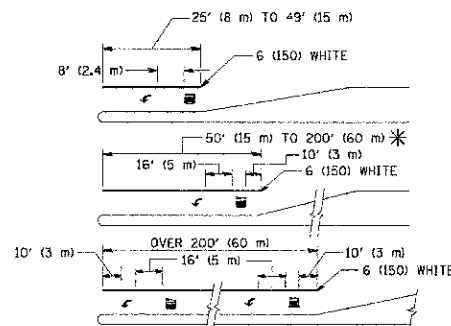
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MEDIANS OVER 4' (1.2 m) WIDE



TYPICAL PAINTED MEDIAN MARKING





FULL SIZE LETTERS 6" (152 mm) AND ARROWS SHALL BE USED.
AREA = 15.6 SQ. FT. (1.5 m²) | AREA = 20.8 SQ. FT. (1.9 m²)

* TURN LANES IN EXCESS OF 400' (120 m) IN LENGTH MAY HAVE AN ADDITIONAL SET OF ARROW - "ONLY" INSTALLED MIDWAY BETWEEN THE OTHER TWO SETS OF ARROW - "ONLY".

TYPICAL LEFT (OR RIGHT) TURN LANE

TYPICAL TURN LANE MARKING

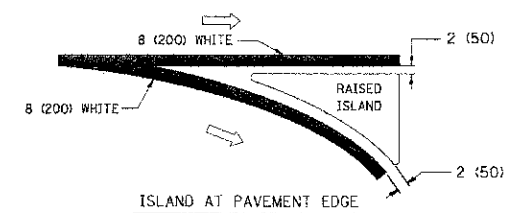
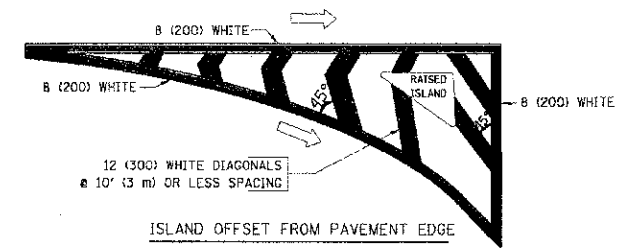


TYPICAL ISLAND MARKING

TYPE OF MARKING	WIDTH OF LINE	PATTERN	COLOR	SPACING / REMARKS
CENTERLINE ON 2 LANE PAVEMENT	4 (100)	SKIP-DASH	YELLOW	10' (3 m) LINE WITH 30' (9 m) SPACE
CENTERLINE ON MULTI-LANE UNDIVIDED PAVEMENT	2 & 4 (100)	SOLID	YELLOW	11 (280) C-C
NO PASSING ZONE LINES FOR ONE DIRECTION FOR BOTH DIRECTIONS	4 (100) 2 & 4 (100)	SOLID SOLID	YELLOW YELLOW	5/2 (140) C-C FROM SKIP-DASH CENTERLINE 11 (280) C-C OMIT SKIP-DASH CENTERLINE BETWEEN
LANE LINES	4 (100) 5 (125) ON FREEWAYS	SKIP-DASH SKIP-DASH	WHITE WHITE	10' (3 m) LINE WITH 30' (9 m) SPACE
DOTTED LINES (EXTENSIONS OF CENTER, LANE OR TURN LANE MARKINGS)	SAME AS LINE BEING EXTENDED	SKIP-DASH	SAME AS LINE BEING EXTENDED	2' (600) LINE WITH 6' (1.8 m) SPACE
EDGE LINES	4 (100)	SOLID	YELLOW-LEFT WHITE-RIGHT	OUTLINE MOUNTABLE MEDIANS IN YELLOW; EDGE LINES ARE NOT USED NEXT TO BARRIER CURB
TURN LANE MARKINGS	6 (150) LINE, FULL SIZE LETTERS & SYMBOLS (8" (2.4m))	SOLID	WHITE	SEE TYPICAL TURN LANE MARKING DETAIL
TWO WAY LEFT TURN MARKING	2 & 4 (100) EACH DIRECTION 8' (2.4m) LEFT ARROW	SKIP-DASH AND SOLID IN PAIRS	YELLOW WHITE	10' (3 m) LINE WITH 30' (9 m) SPACE FOR SKIP-DASH; 5/2 (140) C-C BETWEEN SOLID LINE AND SKIP-DASH LINE SEE TYPICAL TWO-WAY LEFT TURN MARKING DETAIL
CROSSWALK LINES (PEDESTRIAN) A. DIAGONALS (BIKE & EQUESTRIAN) B. LONGITUDINAL BARS (SCHOOL)	2 & 6 (150) 12 (300) @ 45° 12 (300) @ 90°	SOLID SOLID SOLID	WHITE WHITE WHITE	NOT LESS THAN 6' (1.8 m) APART 2' (600) APART SEE TYPICAL CROSSWALK MARKING DETAILS.
STOP LINES	24 (600)	SOLID	WHITE	PLACE 4' (1.2 m) IN ADVANCE OF AND PARALLEL TO CROSSWALK, IF PRESENT, OTHERWISE PLACE AT DESIRED STOPPING POINT, PARALLEL TO CROSSROAD CENTERLINE, WHERE POSSIBLE
PAINTED MEDIANS	2 & 4 (100) WITH 12 (300) DIAGONALS @ 45° NO DIAGONALS USED FOR 4' (1.2 m) WIDE MEDIANS	SOLID	YELLOW; TWO WAY TRAFFIC WHITE; ONE WAY TRAFFIC	11 (280) C-C FOR THE DOUBLE LINE SEE TYPICAL PAINTED MEDIAN MARKING.
GORE MARKING AND CHANNELIZING LINES	8 (200) WITH 12 (300) DIAGONALS @ 45°	SOLID	WHITE	DIAGONALS: 15' (4.5 m) C-C (LESS THAN 30MPH (50 km/h)) 20' (6 m) C-C (30MPH (50 km/h) TO 45MPH (70 km/h)) 30' (9 m) C-C (OVER 45MPH (70 km/h))
RAILROAD CROSSING	24 (600) TRANSVERSE LINES; "RR" IS 6" (1.8 m) LETTERS; 16 (400) LINE FOR "X"	SOLID	WHITE	SEE STATE STANDARD 780001 AREA OF: "R"=3.6 SQ. FT. (0.33 m ²) EACH "X"=54.0 SQ. FT. (5.0 m ²)
SHOULDER DIAGONALS	12 (300) @ 45°	SOLID	WHITE - RIGHT YELLOW - LEFT	50' (15 m) C-C (LESS THAN 30MPH (50 km/h)) 75' (23 m) C-C (30 MPH (50 km/h) TO 45MPH (70 km/h)) 150' (45 m) C-C (OVER 45MPH (70 km/h))



FOR FURTHER DETAILS ON PAVEMENT MARKING REFER TO STANDARD SPECIFICATIONS FOR ROAD AND BRIDGE CONSTRUCTION AND STATE STANDARD 780001.

All dimensions are in inches (millimeters) unless otherwise shown.

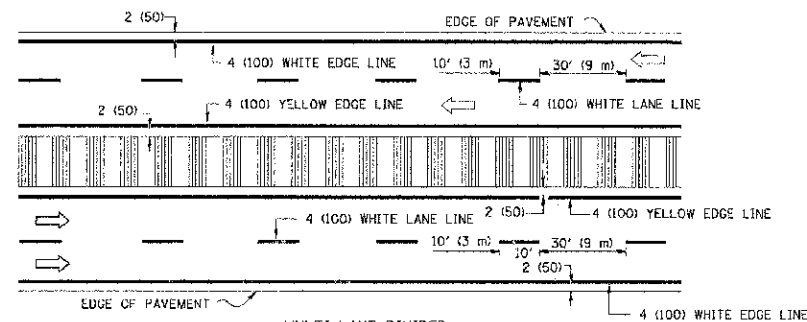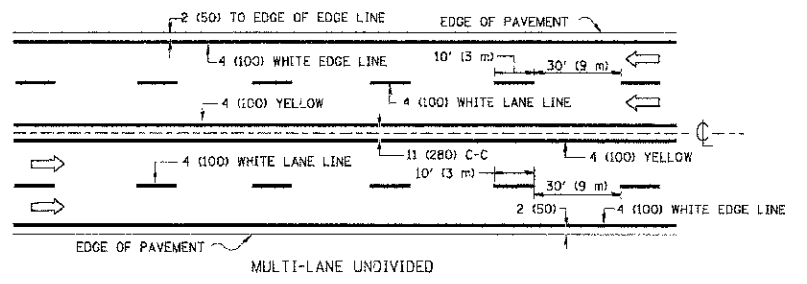

NOTE: MEDIANS WITH BARRIER CURB DO NOT REQUIRE AN EDGE LINE

TYPICAL LANE AND EDGE LINE MARKING

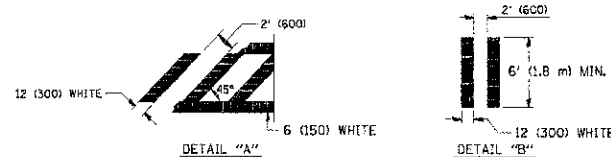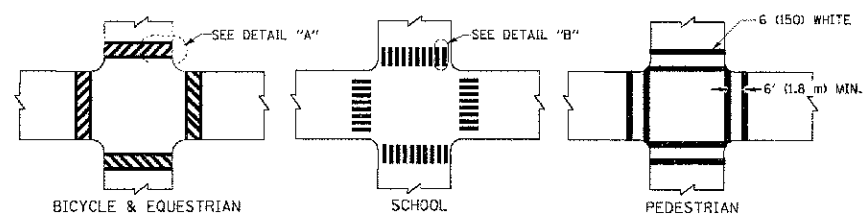

TYPICAL CROSSWALK MARKING

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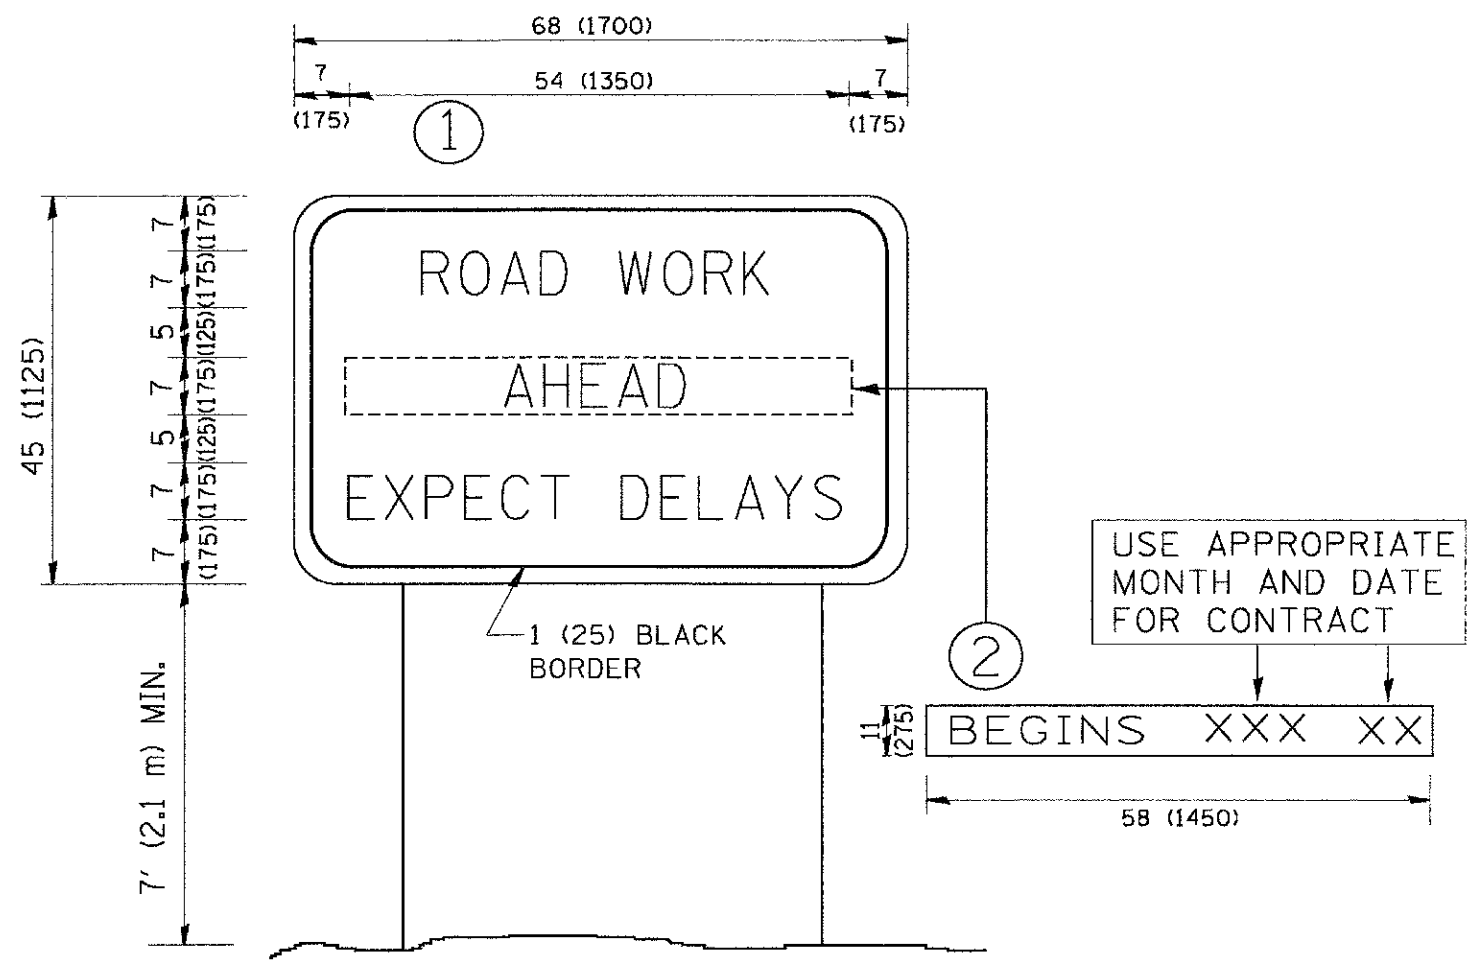
STATE OF ILLINOIS
DEPARTMENT OF TRANSPORTATION

DISTRICT ONE
TYPICAL PAVEMENT MARKINGS

SCALE: NONE SHEET NO. 1 OF 1 SHEETS STA. TO STA.

F.A.U. RTE.	SECTION	COUNTY	TOTAL SHEET NO.
3553	10-00031-00-RS	DUPAGE	29 / 25
TC-13			CONTRACT NO. 63758
FED. ROAD DIST. NO. 1 (ILLINOIS) FED. AID PROJECT - M-9003(866)			

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NOTES:

1. USE BLACK LETTERING ON ORANGE BACKGROUND.
2. ERECT SIGNS IN ADVANCE OF THE LOCATION FOR THE "ROAD CONSTRUCTION AHEAD" SIGN AT LOCATIONS AS DIRECTED BY THE ENGINEER.
3. ERECT SIGN ① WITH INSTALLED PANEL ② ONE WEEK PRIOR TO THE START OF CONSTRUCTION.
4. REMOVE PANEL ② SOON AFTER THE START OF CONSTRUCTION.
5. SEE SPECIAL PROVISION FOR "TEMPORARY INFORMATION SIGNING" FOR ADDITIONAL INFORMATION.
6. ONE SIGN ASSEMBLY EQUALS 25.70 SQ. FT. (2.3 SQ. M.)
7. SHALL BE PAID FOR AS TEMPORARY INFORMATION SIGNING.

ALL DIMENSIONS ARE IN INCHES (MILLIMETERS) UNLESS OTHERWISE SHOWN.

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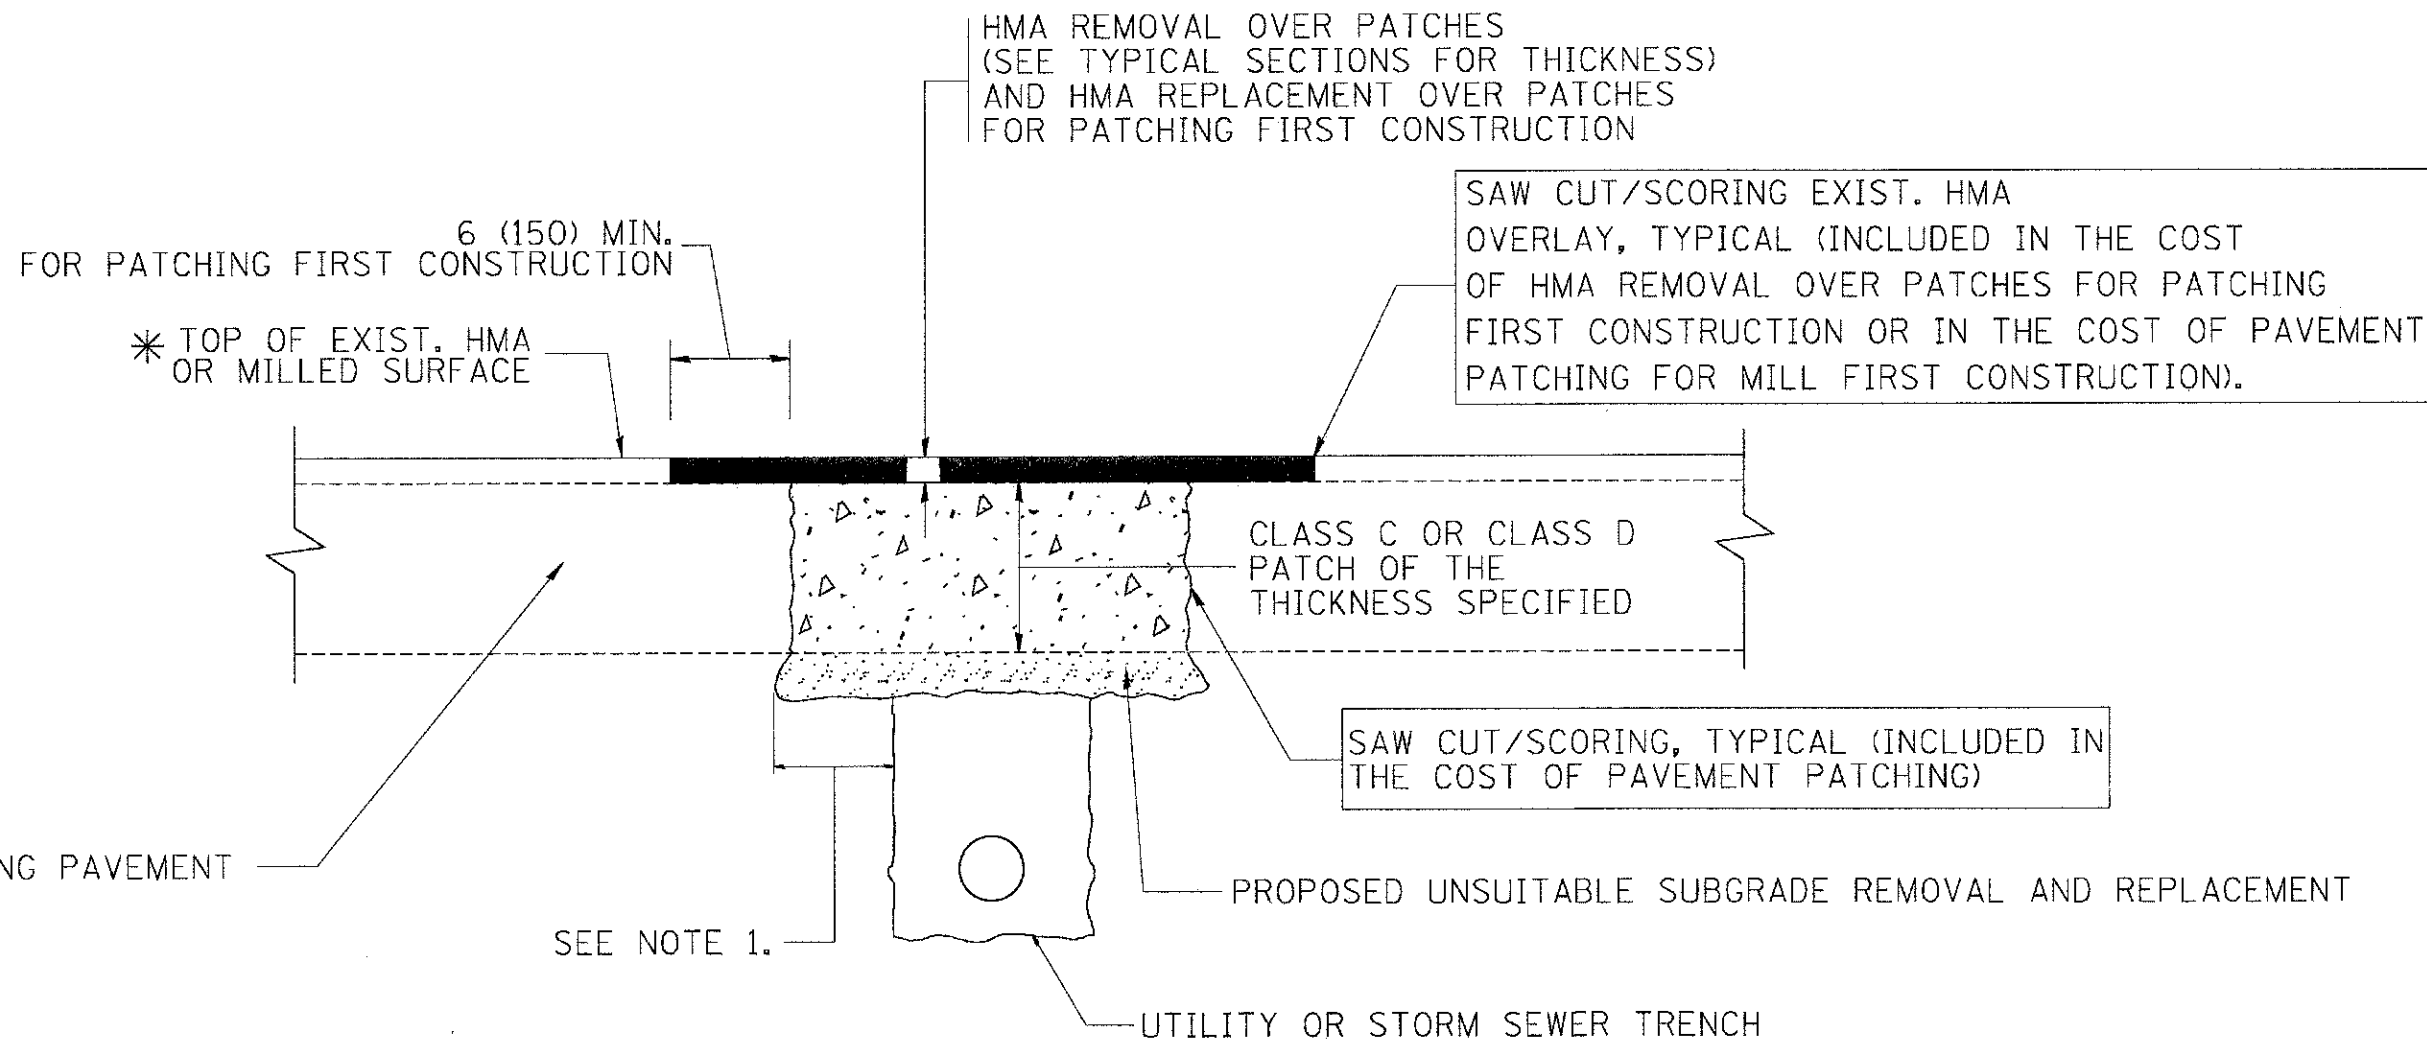
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PLOT DATE = 1/4/2008	DATE -	REVISED - C. JUCIUS 01-31-07	

**STATE OF ILLINOIS
DEPARTMENT OF TRANSPORTATION**

ARTERIAL ROAD INFORMATION SIGN	
SCALE: NONE	SHEET NO. 1 OF 1 SHEETS
STA.	TO STA.

F.A.LL RTE. 3553	SECTION 10-00031-00-RS	COUNTY DUPAGE	TOTAL SHEETS 29	SHEET NO. 26
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FED. ROAD DIST. NO. 1 (ILLINOIS) FED. AID PROJECT - M-9003(866)				

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* SEE TYPICAL SECTIONS FOR THICKNESS AND MATERIALS

NOTES:

1. THE WIDTH OF THE FULL DEPTH PATCH OVER A TRENCH SHALL BE 12 (300) WIDER ON EACH SIDE OF THE TRENCH.
2. FOR METHOD OF MEASUREMENT AND BASIS OF PAYMENT, SEE RECURRING SPECIAL PROVISION "PATCHING WITH HOT-MIX ASPHALT OVERLAY REMOVAL".

SEQUENCE OF CONSTRUCTION (PATCHING FIRST)

1. REMOVE THE EXISTING HMA MATERIAL OVER THE AREA TO BE PATCHED.
2. REMOVE AND REPLACE WITH CLASS C OR D PATCH.
3. REPLACE HMA MATERIAL OVER THE AREA TO BE PATCHED.

SEQUENCE OF CONSTRUCTION (MILLING FIRST)

1. MILL HMA FIRST IF THERE IS AT LEAST 4 1/2 INCHES OR MORE OF HMA MATERIAL ON TOP OF THE EXISTING PAVEMENT OR IF THE PAVEMENT IS FULL DEPTH HMA. A MINIMUM OF 2 INCHES OF HMA MATERIAL SHALL BE IN PLACE AFTER MILLING.
2. REMOVE AND REPLACE WITH FULL DEPTH CLASS D PATCHES TO TOP OF MILLED SURFACE.

ALL DIMENSIONS ARE IN INCHES (MILLIMETERS) UNLESS OTHERWISE SHOWN.

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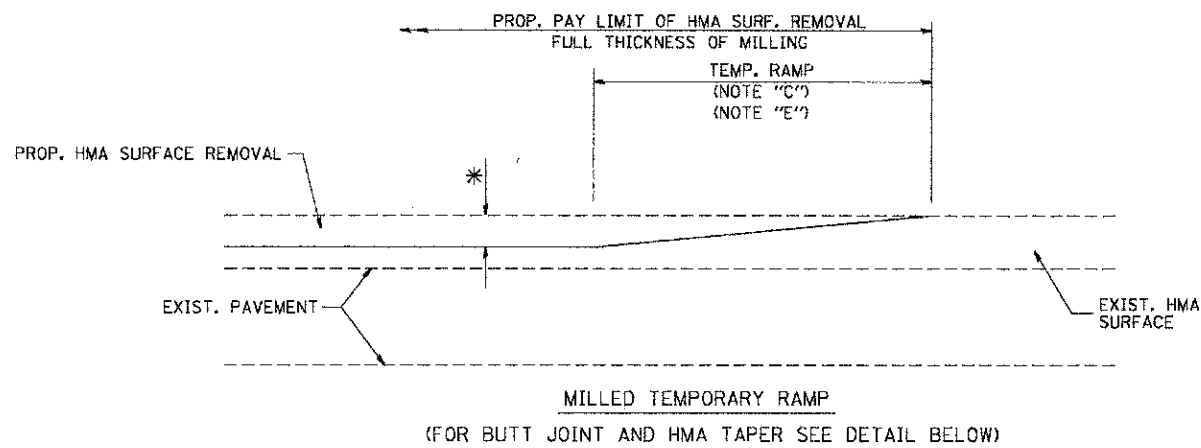
**STATE OF ILLINOIS
DEPARTMENT OF TRANSPORTATION**

**PAVEMENT PATCHING FOR
HMA SURFACED PAVEMENT**


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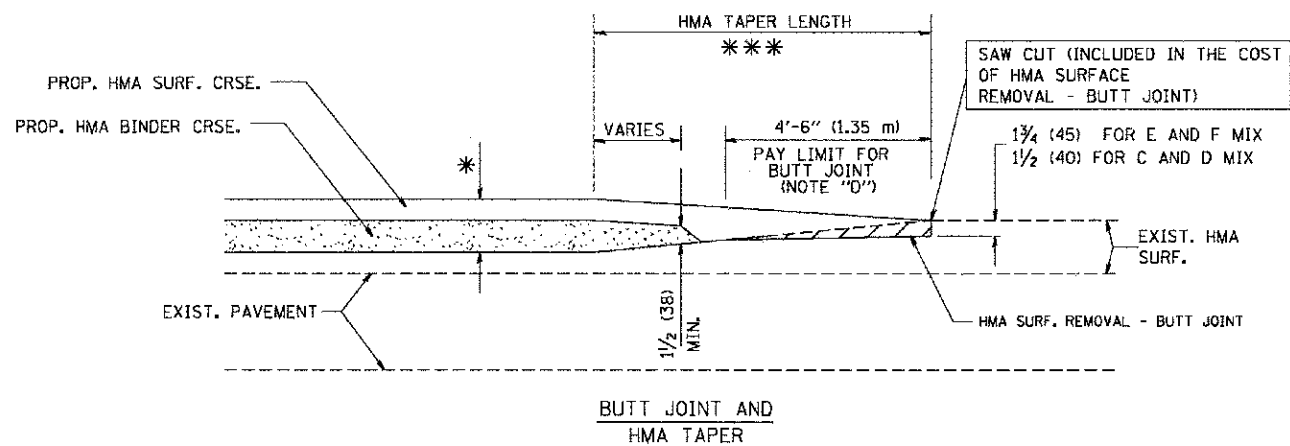
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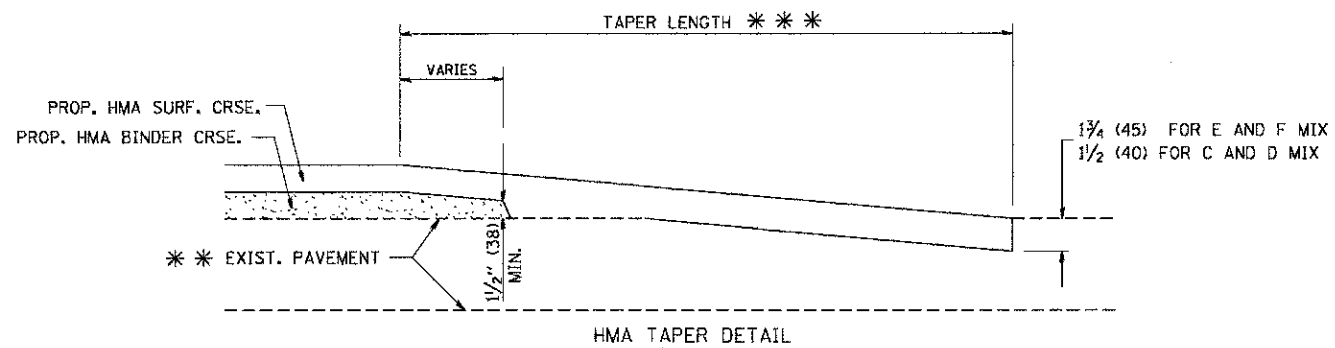
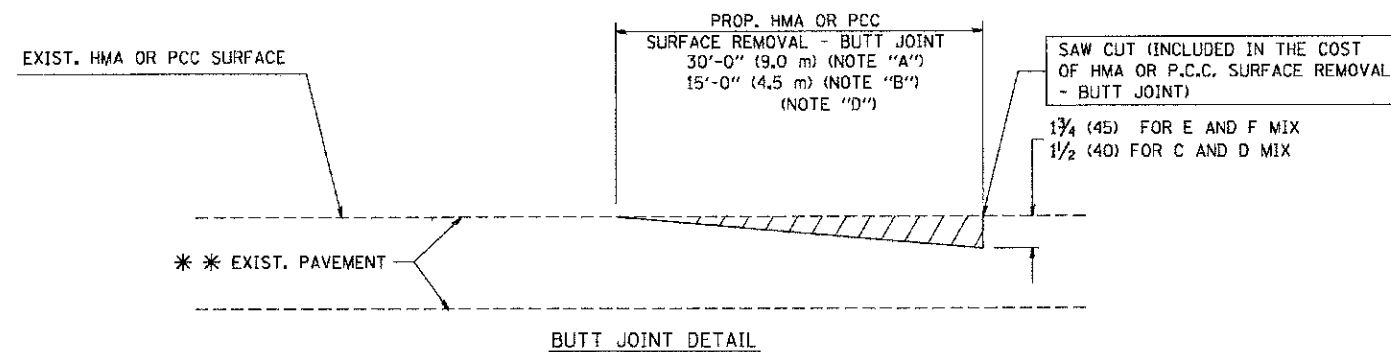
OPTION 1



**OPTION 2
TYPICAL TEMPORARY RAMP**



**TYPICAL BUTT JOINT AND HMA TAPER
FOR MILLING AND RESURFACING**

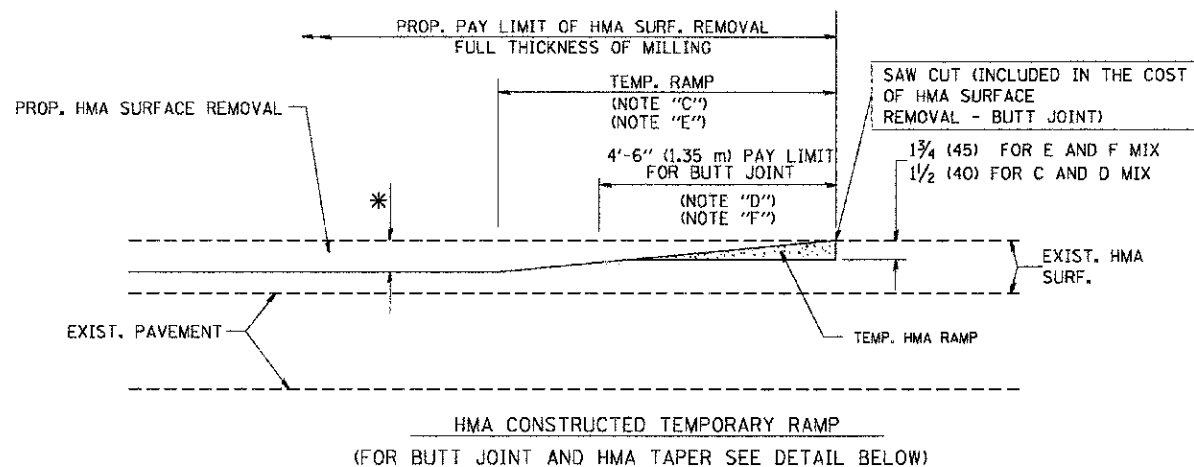

**TYPICAL BUTT JOINT AND HMA TAPER
FOR RESURFACING ONLY**

*** PC CONCRETE, HMA OR HMA RESURFACED PAVEMENT.

NOTES

- A: MAINLINE ROADWAYS AND MAJOR SIDE ROADS.
 - B: MINOR SIDE ROADS.
 - C: THE TEMP. RAMP SHALL BE CONSTRUCTED IMMEDIATELY UPON REMOVAL OF THE EXISTING HMA SURFACE.
 - D: THE BUTT JOINT SHALL BE CONSTRUCTED IMMEDIATELY PRIOR TO PLACING THE PROPOSED HMA COURSES.
 - E: TAPER THE TEMP. RAMP AT A RATE OF 3'-0" (900 mm) PER 1 INCH (25 mm) OF MILLING THICKNESS.
 - F: INSTALLATION AND REMOVAL OF THE 4'-6" (1.35 m) TEMP. RAMP IS INCLUDED IN COST OF HMA SURFACE REMOVAL - BUTT JOINT
 - G: SEE ARTICLE 406.08 AND 406.14 OF THE STANDARD SPECIFICATIONS FOR "HMA AND/OR PCC SURFACE REMOVAL, BUTT JOINT".
- * SEE TYPICAL SECTIONS FOR MILLING THICKNESS.
- *** 20'-0" (6.1 m) PER 1 (25) RESURFACING (NOTE "A")
10'-0" (3.0 m) PER 1 (25) RESURFACING (NOTE "B")

BASIS OF PAYMENT:

THE BUTT JOINT WILL BE PAID FOR AT THE CONTRACT UNIT PRICE PER SQUARE YARD (SQUARE METER) FOR "HOT-MIX ASPHALT SURFACE REMOVAL - BUTT JOINT" OR FOR "PORTLAND CEMENT CONCRETE SURFACE REMOVAL - BUTT JOINT".

ALL DIMENSIONS ARE IN INCHES (MILLIMETERS) UNLESS OTHERWISE SHOWN.

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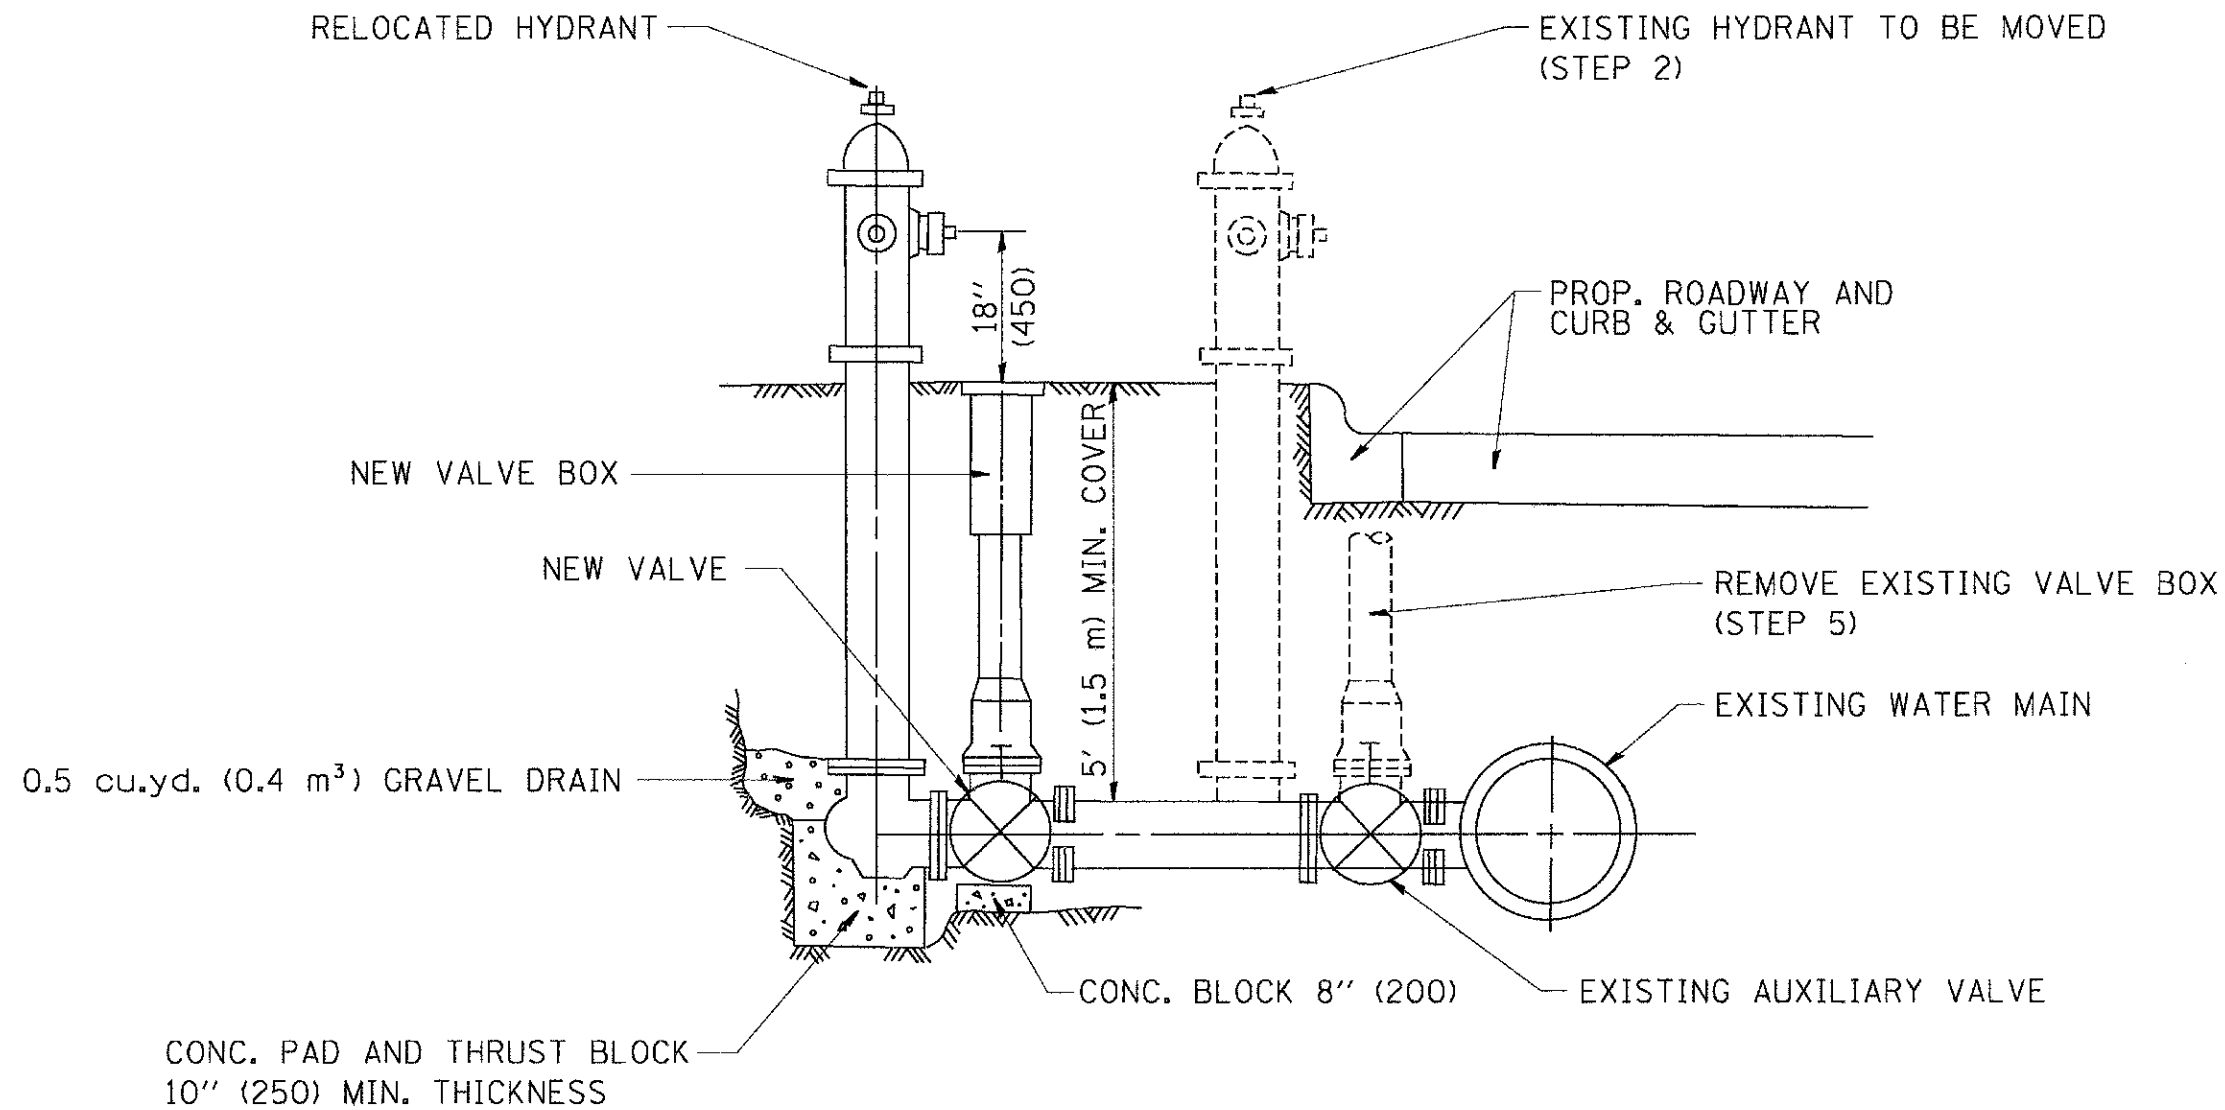
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		CHECKED -	REVISED - M. GOMEZ 04-06-01
		DATE - 06-13-90	REVISED - R. BORO 01-01-07

**STATE OF ILLINOIS
DEPARTMENT OF TRANSPORTATION**

BUTT JOINT AND HMA TAPER DETAILS		F.A.U. RTE.	SECTION	COUNTY	TOTAL SHEETS	SHEET NO.
SCALE: NONE		3553	10-00031-00-RS	DUPAGE	29	28
SHEET NO. 1 OF 1 SHEETS		BD400-05 BD32		CONTRACT NO. 63758		
STA. TO STA.		FED. ROAD DIST. NO. 1 ILLINOIS FED. AID PROJECT - M-9003(866)				

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SEQUENCE OF CONSTRUCTION:

1. CLOSE EXISTING VALVE.
2. REMOVE EXISTING HYDRANT.
3. INSTALL HYDRANT EXTENSION AND NEW VALVE.
4. RELOCATE EXISTING HYDRANT.
5. OPEN EXISTING VALVE, REMOVE BOX.
6. BACKFILL.
7. FLUSH AND TEST FOR CHLORIDE RESIDUAL AND PROVIDE TEST.

ALL WORK TO BE DONE IN ACCORDANCE WITH ARTICLE 564 OF THE STANDARD SPECIFICATIONS. NEW VALVE AND BOX SHALL BE SAME MAKE AND MODEL AS EXISTING.

FIRE HYDRANT TO BE MOVED

ALL DIMENSIONS ARE IN INCHES (MILLIMETERS) UNLESS OTHERWISE SHOWN.

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DESIGNED -
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 DATE -

STATE OF ILLINOIS
DEPARTMENT OF TRANSPORTATION

FIRE HYDRANT TO BE MOVED
 SCALE: NONE SHEET NO. 1 OF 1 SHEETS STA. TO STA.

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3553	10-00031-00-RS	DUPAGE	29	29
BD-36			CONTRACT NO. 63758	
FED. ROAD DIST. NO. 1 ILLINOIS FED. AID PROJECT - M-9003(866)				