
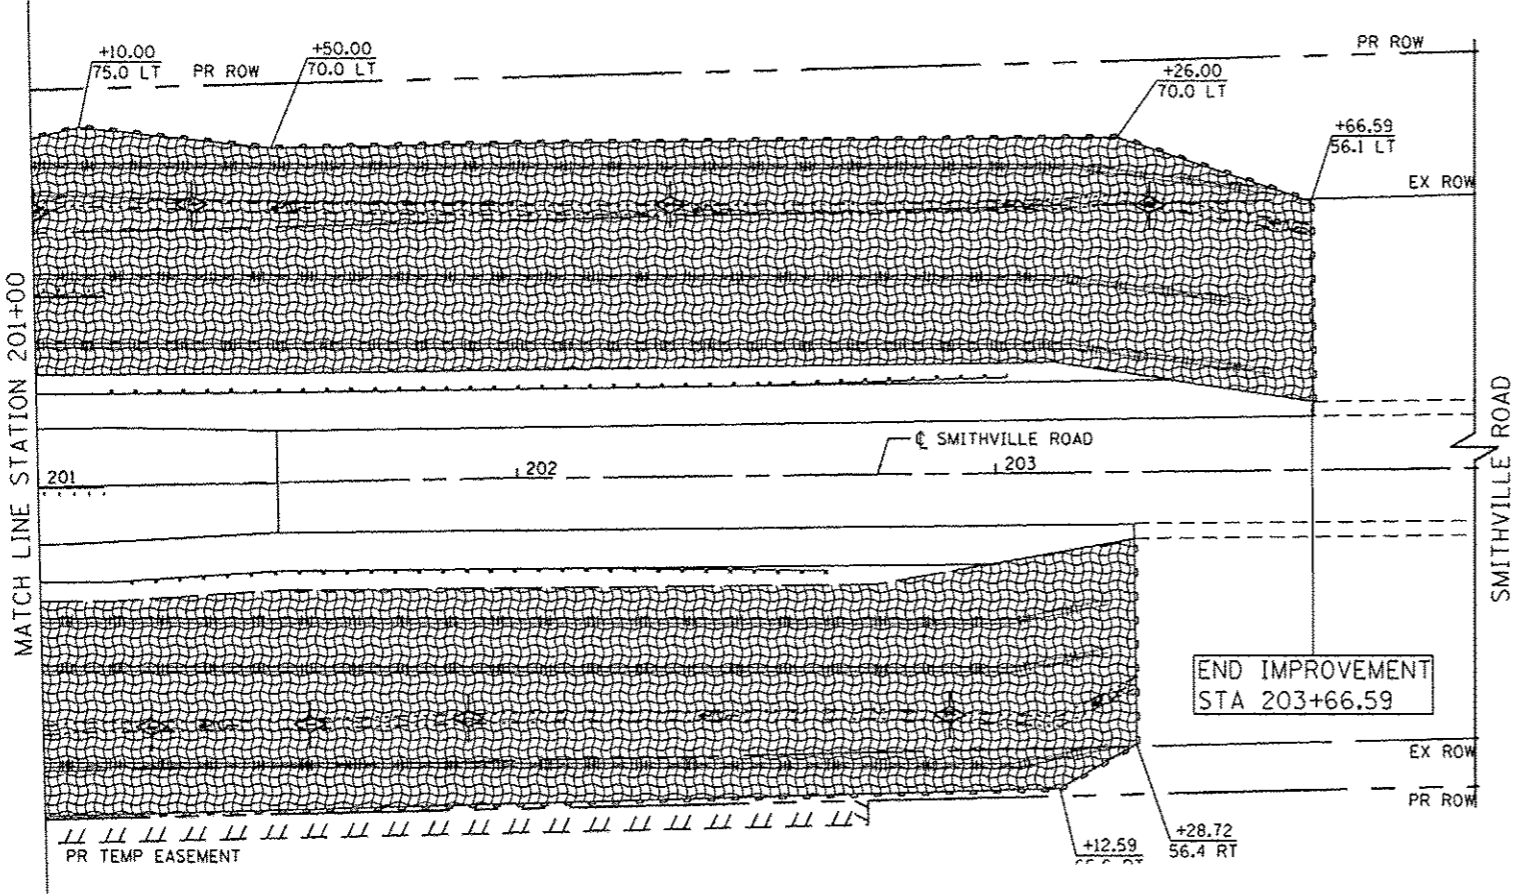


**LEGEND**

- TEMPORARY DITCH CHECK
- STONE RIPRAP, CLASS A5 (SEE BRIDGE SHEETS)
- HEAVY DUTY EROSION CONTROL BLANKET AND SEEDING, CLASS 3
- PERIMETER EROSION BARRIER (SILT FENCE)
- PERIMETER EROSION BARRIER (ROLLED EXCELSIOR)

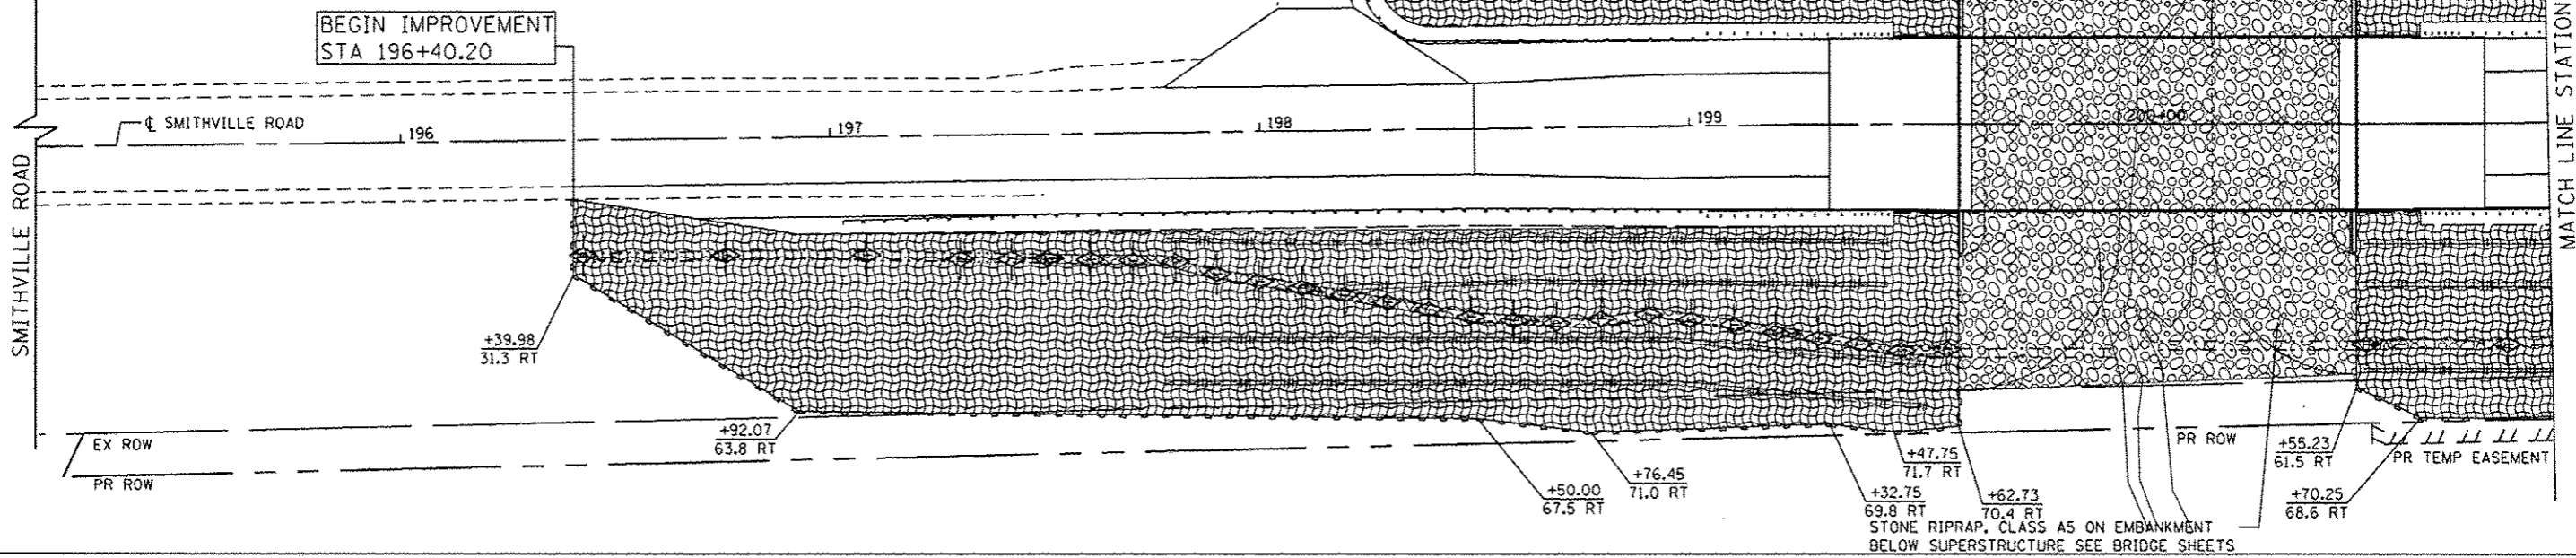

**TEMPORARY EROSION CONTROL NOTES**

1. THE CONTRACTOR IS TO IMPLEMENT AND MAINTAIN EROSION CONTROL MEASURES PRIOR TO START OF WORK.
2. EROSION CONTROL TO BE CONSTRUCTED AS SHOWN ON THE PLANS AND AS DIRECTED BY THE ENGINEER AND TO BE INSPECTED AND DOCUMENTED BY THE CONTRACTOR 24 HOURS AFTER ANY RAIN EVENT EXCEEDING 0.5 INCHES OF PRECIPITATION AND ON A WEEKLY BASIS. THE CONTRACTOR SHALL IMMEDIATELY PLACE AND MAINTAIN TEMPORARY EROSION CONTROL SEEDING AT ALL ERODIBLE/BARE AREAS. THE WORK SHALL BE COMPLETED IN ACCORDANCE WITH SECTION 280 -TEMPORARY EROSION CONTROL OF THE STANDARD SPECIFICATIONS, HIGHWAY STANDARD 280001-05, AND AS DIRECTED BY THE ENGINEER.
3. NO RUNOFF FROM STRIPPED AREA IS TO LEAVE THE SITE OTHER THAN THROUGH EROSION CONTROL PROTECTIVE MEASURES. THE CONTRACTOR WILL ADJUST HIS OPERATIONS AND IMPLEMENT EROSION CONTROL MEASURES ACCORDINGLY.
4. THE CONTRACTOR SHALL TAKE ALL PRECAUTIONS TO PREVENT POLLUTION OF STORM WATER AND SHALL CONFORM TO IEPA AND IDOT CONSTRUCTION MEMORANDUM NO. 06-60.
5. EROSION CONTROL SHALL BE PROVIDED IN ACCORDANCE WITH SEQUENCE OF STAGE CONSTRUCTION.
6. ALL DISTURBED AREAS SHALL BE SEEDED AS SOON AS PRACTICAL AFTER CONSTRUCTION ACTIVITIES IN THAT AREA HAVE CONCLUDED. AREAS THAT HAVE BEEN STRIPPED AND WILL NOT RECEIVE PERMANENT LANDSCAPING BEFORE THE END OF THE FALL SEEDING RESTRICTION SHALL RECEIVE TEMPORARY EROSION CONTROL SEEDING, MULCH, AND EROSION CONTROL BLANKET.
7. THIS PROJECT DISTURBS MORE THAN 1 ACRE. THEREFORE, ALL CONSTRUCTION ACTIVITIES WILL BE IN ACCORDANCE WITH THE SITE-SPECIFIC STORM WATER POLLUTION PREVENTION PLAN (SWPPP), AS PER NATIONAL POLLUTANT DISCHARGE ELIMINATION SYSTEM (NPDES) REQUIREMENTS. (SEE SPECIAL PROVISIONS)
8. THE PERIMETER EROSION BARRIER SHALL REMAIN IN PLACE UNTIL ALL DISTURBED AREAS HAVE BEEN STABILIZED WITH VEGETATION. AT THAT TIME, THE PERIMETER EROSION BARRIER SHALL BE REMOVED AND THE AREAS DAMAGED BY THE FENCE INSTALLATION SHALL BE RESTORED.
9. HEAVY DUTY EROSION CONTROL BLANKET SHALL BE INSTALLED ON ALL AREAS, IMMEDIATELY AFTER SEEDING.
10. LANDSCAPE SEEDING LIMITS ARE THE SAME LIMITS AS THE EROSION CONTROL SEEDING LIMITS.

INFRASTRUCTURE ENGINEERING, INC.  
 488 E. State Street, Suite 100, Peoria, IL 61602  
 TEL: 309.691.4000 FAX: 309.691.4001

FILE NAME = #FILES*	DESIGNED - AJP	REVISED -	<b>PEORIA COUNTY HIGHWAY DEPARTMENT</b>	<b>EROSION AND SEDIMENT CONTROL PLAN</b>	F.A.S. RTE. 1381	SECTION 10-00005-03-8R	COUNTY PEORIA	TOTAL SHEETS 55	SHEET NO. 17		
USER NAME = IEI	DRAWN - AJP	REVISED -			SCALE: 1" = 20'	SHEET NO. 1 OF 1 SHEETS	STA. 194+25.00 TO STA. 204+00.00	CONTRACT NO. 89464			
PLOT SCALE = 48.0000' / 1"	CHECKED - BAR	REVISED -			ILLINOIS FED. AID PROJECT						
PLOT DATE = 10/26/2012	DATE - 11/02/2012	REVISED -									