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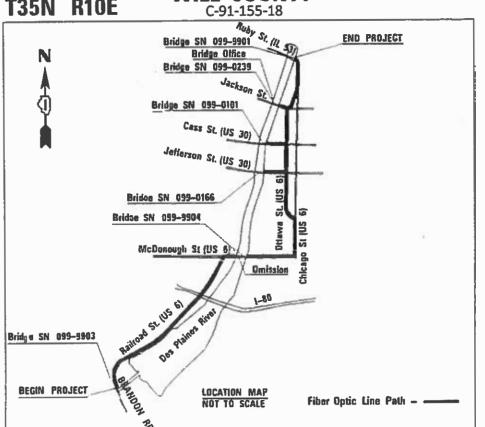
STATE OF ILLINOIS 01-18-2019 LETTING ITEM 095

DEPARTMENT OF TRANSPORTATION

# **PROPOSED HIGHWAY PLANS**

FAP 607 (US 30) CITY OF JOLIET & VILLAGE OF ROCKDALE **SECTION 2018-0021** PROJECT: STP-R1PL(364) **MOVEABLE BRIDGES IN JOLIET AREA BRANDON ROAD TO RUBY STREET FIBER OPTIC CABLE INSTALLATION** 

**WILL COUNTY T35N R10E** 



US 6 /IL 53 LENGTH = 16.130 FT, = 3.05 MILE JACKSON ST LENGTH = 209 FT, = 0.04 MILE CASS ST LENGTH = 712 FT. = 0.13 MILE JEFFERSON ST LENGTH = 009 FT. = 0.15 MILE DMISSION LENGTH = 792 FT. = 0.15 MILE NET LENGTH = 17,860 FT. = 3.36 MILE GROSS LENGTH = 18,652 FT. = 3.50 MILE

## FOR INDEX OF SHEETS, SEE SHEET NO. 2

DESIGN DESIGNATION: ARTERIAL RUBY ST 1087 ST = 20,400 DESIGN SPEED = 30 MPH POSTED SPEED = 30 MPH

CASS ST 2017 ADT = 15,210 DESIGN SPEED = 30 MPH POSTED SPEED = 30 MPH

JEFFERSON ST 2017 AOT = 11,410 DESIGN SPEED = 30 MPH POSTED SPEED = 30 MPH

OTTAWA ST 2017 ADT = 11,950 DESIGN SPEED = 30 MPH POSTED SPEED = 30 MPH

CHICAGO ST 2017 ADT = 14,000 DESIGN SPEED = 30 MPH POSTED SPEED = 30 MPH

2015 ADT = 10,600 DESIGN SPEED = 30 MPH POSTED SPEED = 30 MPH RAILROAD ST 2017 ADT = 4,000 DESIGN SPEED = 40 MPH POSTED SPEED = 40 MPH


DESIGN DESIGNATION; MINDR COLLECTOR JACKSON ST 2015 ADT == 8,050 DESIGN SPEED == 30 MPH POSTED SPEED == 30 MPH

BRANDON RD 2015 ADT = 5.500 DESIGN SPEED = 25 MPH POSTED SPEED = 35 MPH

DESIGN DESIGNATION; MAJOR COLLECTOR JACKSON ST 2015 ADT = 8.050 DESIGN SPEED = 30 MPH POSTED SPEED = 30 MPK

PROJECT IS LOCATED IN THE CITY OF JOLIET AND VILLAGE OF ROCKDALE



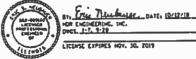



FULL SIZE PLANS HAVE BEEN PREPARED USING STANDARD ENGINEERING SCALES. REDUCED SIZED PLANS WILL NOT CONFORM TO STANDARD SCALES, IN MAKING MEASUREMENTS ON REDUCED PLANS, THE ABOVE SCALES MAY BE USED.

8550 W. Bryn Mowr Ave., Sulte 900 Chicago, 11 60631

KOR, Inc.

DESIGN FIRM REGISTRATION NUMBER 184.001070

JOINT UTILITY LOCATION INFORMATION FOR EXCAVATION 1-800-892-0123 OR 811

PROJECT ENGINEER ANA ABREU (847) 705-4482 PROJECT MANAGER SERIN KELLER (847) 705-4556

CONTRACT NO. 62G14

COUNTY SHEETS NO. SECTION WILL 29 L 2018 -0021



STATE OF ILLINOIS DEPARTMENT OF TRANSPORTATION

SUBMITTED OCHUSER, UL 20 18

PRINTED BY THE AUTHORITY

OF THE STATE OF ILLINOIS

REV. 11/29/18

## **INDEX OF SHEETS**

## SHEET NO. DESCRIPTION

TITLE SHEET
INDEX OF SHEETS AND HIGHWAY STANDARDS

GENERAL NOTES

4 - 6 SUMMARY OF QUANTITIES

TYPICAL SECTIONS

8 TRAFFIC CONTROL PLAN GENERAL NOTES AND TYPICAL SECTIONS
9 – 18 FIBER OPTIC AND RESTORATION PLAN

INTERCONNECT SYSTEM TOPOLOGY

HANDHOLE DETAIL

21 – 29 IDOT DISTRICT 1 STANDARD DRAWINGS

## INOT STANDARDS REFERENCED

וטעו פ	I ANDARDS RELEBENCED
NUMBER	DESCRIPTION
000001-07	STANDARD SYMBOLS, ABBREVIATIONS AND PATTERNS
280001-07	TEMPORARY EROSION CONTROL SYSTEMS
442201-03	CLASS C AND D PATCHES
701001-02	OFF-RD OPERATIONS, 2L, 2W, MORE THAN 15' (4.5m) AWAY
701006-05	OFF-RD OPERATIONS, 2L, 2W, 15' (4.5m) TO 24" (600mm) FROM PAVEMENT EDGE
701101-05	OFF-RD OPERATIONS, MULTILANE, 15' (4.5m) TO 24" (600 mm) FROM PAVEMENT EDGE
701106-02	OFF-RD OPERATIONS, MULTILANE, MORE THAN 15' (4.5m) AWAY
701301-04	LANE CLOSURE, 2L, 2W, SHORT TIME OPERATIONS
701311-03	LANE CLOSURE 2L, 2W MOVING OPERATIONS-DAY ONLY
701427-05	LANE CLOSURE, MULTILANE, INTERMITTENT OR MOVING OPER., FOR SPEEDS <= 40 MPH
701501-06	URBAN LANE CLOSURE, 2L, 2W, UNDIVIDED
701502-09	URBAN LANE CLOSURE, 2L, 2W, WITH BIDIRECTIONAL LEFT TURN LANE
701601-09	URBAN LANE CLOSURE, MULTILANE, 1W OR 2W WITH NONTRAVERSABLE MEDIAN
701602-10	URBAN LANE CLOSURE, MULTILANE, 2W WITH BIDIRECTIONAL LEFT TURN LANE
701606-10	URBAN SINGLE LANE CLOSURE, MULTILANE, 2W WITH MOUNTABLE MEDIAN
701611-01	URBAN HALF ROAD CLOSURE, MULTILANE, 2W WITH MOUNTABLE MEDIAN
701701–10	URBAN LANE CLOSURE, MULTILANE INTERSECTION
701801-06	SIDEWALK, CORNER OR CROSSWALK CLOSURE
701901-08	TRAFFIC CONTROL DEVICES

FILE NAME =	USER NAME = JKJELLMA	DESIGNED - NK	REVISED -		l In	NDEX OF SHEETS AND HIGHWAY STANDARDS	F.A.U RTF	SECTION	COUNTY	TOTAL	SHEET NO.
JOLIET-SHT-INDEX		DRAWN - AF	REVISED -	STATE OF ILLINOIS	•••	FIBER OPTIC CABLE INSTALLATION	VAR.	2018-0021	WILL	29	2
	PLOT SCALE = 24.0000 ' / in.	CHECKED - JK	REVISED -	DEPARTMENT OF TRANSPORTATION		FIDER UPIIC CADLE INSTALLATION			CONTRACT	F NO. 6	2G14
Default	PLOT DATE = 10/12/2018	DATE - 10/12/2018	REVISED -		SCALE: N/A	SHEET 1 OF 1 SHEETS STA. TO STA.		ILLINOIS FED. AI	ID PROJECT		

## **GENERAL NOTES**

- BEFORE STARTING ANY EXCAVATION, THE CONTRACTOR SHALL CALL "JULIE" AT 800-892-0123 OR 811 FOR FIELD LOCATIONS OF BURIED UTILITIES. (48 HOUR NOTIFCATION IS REQUIRED).
- THE CONTRACTOR SHALL COORDINATE CONSTRUCTION ACTIVITIES WITH UTILITY COMPANIES AND THE CITY OF JOLIET.
- THE CONTRACTOR WILL NOT BE ALLOWED TO SET UP A YARD OR FIELD OFFICE ON STATE, COUNTY, OR LOCAL MUNICIPAL PROPERTY WITHOUT WRITTEN PERMISSION FROM THE DEPARTMENT.
- PRIOR TO BEGINNING ANY WORK, THE CONTRACTOR SHALL RETAIN AND RECORD ALL EXISTING PAVEMENT, PAVEMENT MARKING. AND ROADSIDE CONDITIONS IN ORDER THAT THESE LOCATIONS CAN BE RE-ESTABLISHED DURING RESTORATION ACTIVITIES TO THEIR ORIGINAL CONDITIONS, DIMENSIONS, AND SLOPES.
- THE CONTRACTOR SHALL VERIFY ALL EXISTING CONDITIONS AND UTILITIES IN THE FIELD PRIOR TO BEGINNING ANY WORK.
- ALL WORK SHALL COMPLY WITH THE CURRENT EDITION OF THE NATIONAL ELECTRICAL CODE IN EFFECT AT THE BID OPENING TIME AND ALL APPLICABLE STATE AND/OR LOCAL CODES.
- THE LAYOUT FOR THE FIBER OPTIC LINE IS A GENERAL LAYOUT. IT IS THE CONTRACTOR'S RESPONSIBILITY TO DETERMINE THE EXACT LOCATION OF THE FIBER OPTIC LINE, HANDHOLES, AND OTHER EQUIPMENT PRIOR TO BEGINNING ANY CONSTRUCTION. THE LAYOUT SHALL BE SUCH THAT THE MINIMUM DISTURBANCE POSSIBLE TO THE EXISTING CONDITIONS AND EXISTING UTILITIES IS MAINTAINED. LOCATIONS OF ALL FIBER OPTIC LINES, AND UTILITY STRUCTURES SHALL BE LAYED OUT FOR APPROVAL BY THE ENGINEER. DISTURBANCE TO ANY EXISTING CONDITIONS AND EXISTING UTILITIES NOT APPROVED BY THE ENGINEER SHALL BE REPLACED IN KIND BY THE CONTRACTOR AT HIS OWN EXPENSE.
- THE CONTRACTOR SHALL UTILIZE A DIRECTIONAL BORE METHOD FOR THE FIBER OPTIC CONDUIT INSTALLATION TO PREVENT IMPACTS TO MOTORISTS AND DISTURBANCE OF THE EXISTING CONDITIONS. OPEN CUT TRENCHES MAY BE UTILIZED IN THE RAILROAD STREET AGGREGATE SHOULDER AND IN AREAS APPROVED BY THE ENGINEER.
- HANDHOLE AND JUNCTION BOXES SPACING SHALL BE A MAXIMUM 1,000 FEET.
- LOCATIONS WHERE CONDUIT IS INSTALLED VIA AN OPEN TRENCH METHOD THE CONTRACTOR SHALL INSTALL WARNING TAPE IN ACCORDANCE WITH IDOT DISTRICT 1 STANDARD BE-702.
- 11. THE CONTROL CENTER FOR THE BRIDGES UTILITIZING THE PROPOSED FIBER OPTIC SYSTEM CONSTRUCTED IN THIS CONTRACT IS LOCATED AT 105 BRIDGE STREET, JOLIET, IL 60435.
- 12. THE CONTRACTOR WILL NOT BE REQUIRED TO PROVIDE AN ENGINEER'S FIELD OFFICE. IDOT WILL ASSIGN A FIELD OFFICE FOR THE ENGINEER.
- 13. THE CONTRACTOR'S ATTENTION IS DIRECTED TO THE FACT THAT A PORTION OF THE WORK WILL BE PERFORMED WITHIN WILL COUNTY RIGHT-OF-WAY ALONG BRANDON ROAD. IT IS THE CONTRACTOR'S RESPONSIBILITY TO PROCURE ALL PERMITS INCLUDING WILL COUNTY DIVISION OF TRANSPORTATION PERMTS IN ACCORDANCE WITH ARTICLE 107.04.
- THE CONTRACTOR SHALL NOT PERFORM ANY EXCAVATION FOR BORING PITS WITHIN 10 FEET OF BRANDON ROAD. IF ANY EXCAVATION WITH A DEPTH OF MORE THAN 2 FEET ALONG BRANDON ROAD IS REQUIRED AS DETERMINED BY THE ENGINEER THE FOLLOWING REQUIREMENTS SHALL BE MET:
  - A. EXCAVATION BETWEEN 2 FEET AND 10 FEET FROM THE EDGE OF PAVEMENT THE TRENCH SHALL BE BACKFILLED WITH TRENCH BACKELL OR CLSM
  - B. EXCAVATION BETWEEN 0 FEET AND 2 FEET FROM THE EDGE OF PAVEMENT THE TRENCH SHALL BE BACKFILL WITH ONLY

THE BACKFILL SHALL BE PAID FOR AT THE CONTRACTOR'S EXPENSE. NO ADDITIONAL COMPENSATION SHALL BE PROVIDED. TRENCH BACKFILL SHALL BE IN ACCORDANCE WITH ARTICLE 208.02 AND CLSM SHALL BE IN ACCORDANCE WITH ARTICLES 593.02, 593.03, AND 593.04,

- 15. RESTORATION, EROSION CONTROL, AND EXPLORATION FOR CONDUIT AND FIBER OPTIC CABLE INSTALLATION SHALL BE IN ACCORDANCE WITH THE SPECIFICATIONS. EXPLORATION AND RESTORATION FOR THE DISTURBANCE CAUSED BY THE CONSTRUCTION OF HANDHOLES, JUNCTION BOXES, OTHER STRUCTURES, EROSION CONTROL, AND BORING PITS SHALL BE PERFORMED UTILIZING THE ITEMS BELOW FOR WHICH NOMINAL QUANTITIES HAVE BEEN PROVIDED. QUANTITIES PROVIDED ARE BASED ON RESTORATION FOR HANDHOLE LOCATIONS AND A SINGLE BORING PIT WHERE THE DISTANCE BETWEEN HANDHOLES IS GREATER THAN 500 FT. RESTORATION FOR AREAS DISTURBED BEYOND A 15 FT X 10 FT AREA CENTERED ON THE STRUCTURE OR DIRECTIONAL BORING PIT BEING CONSTRUCTED SHALL BE THE SOLE RESPONSIBILITY OF THE CONTRACTOR AND WILL NOT BE PAID FOR UNLESS APPROVED BY THE ENGINEER PRIOR TO ANY EXCAVATION OR REMOVAL OF EXISTING ITEMS. THE CONTRACTOR SHALL PERFORM OPERATIONS TO MINIMIZE THE AMOUNT OF NECESSARY RESTORATION. WORK.
  - 20101100. TREE TRUNK PROTECTION, EACH
  - 20101200, TREE ROOT PRUNING, EACH
  - 20101300, TREE PRUNING (1 TO 10 INCH DIAMETER), EACH
  - 20101350, TREE PRUNING (OVER 10 INCH DIAMETER), EACH
  - 20200100. EARTH EXCAVATION. CU YD
  - 20200200, ROCK EXCAVATION, CU YD
  - 20201200, REMOVAL AND DISPOSAL OF UNSUITABLE MATERIAL, CU YD
  - 20400800, FURNISHED EXCAVATION, CU YD
  - 21101505. TOPSOIL EXCAVATION AND PLACEMENT, CU YD
  - 21301048, EXPLORATION TRENCH 48" DEPTH, FOOT
  - 25200110, SODDING, SALT TOLERANT, SQ YD
  - 28000400, PERIMETER EROSION BARRIER, FOOT
  - 28000510, INLET FILTERS, EACH
  - 40601005, HOT-MIX ASPHALT REPLACEMENT OVER PATCHES, TON
  - 42001300, PROTECTIVE COAT, SQ YD
  - 42400200, PORTLAND CEMENT CONCRETE SIDEWALK 5 INCH, SQ FT
  - 44000600. SIDEWALK REMOVAL. SQ FT
  - 44002209, HOT-MIX ASPHALT REMOVAL OVER PATCHES, 2 1/4", SQ YD
  - 44201349, CLASS C PATCHES, TYPE I, 10 INCH, SQ YD
  - 44201353, CLASS C PATCHES, TYPE II, 10 INCH, SQ YD
  - 44201357, CLASS C PATCHES, TYPE III, 10 INCH, SQ YD
  - 44201359, CLASS C PATCHES, TYPE IV, 10 INCH, SQ YD
  - 78000100, THERMOPLASTIC PAVEMENT MARKING LETTERS AND SYMBOLS, SQ FT
  - 78009000, MODIFIED URETHANE PAVEMENT MARKING LETTERS AND SYMBOLS, SQ FT
  - X4400220, CURB REMOVAL AND REPLACEMENT, FOOT
- 16. FOR REPLACEMENT OF ANY CURB AND GUTTER, THE CONTRACTOR SHALL MATCH THE HORIZONTAL AND VERTICAL DIMENSIONS OF THE EXISTING ADJACENT CURB AND GUTTER TO PROVIDE A SMOOTH AND CONTINUOUS SECTION. THE COST OF THIS WORK SHALL BE PAID FOR AT THE UNIT PRICE FOR CURB REMOVAL AND REPLACEMENT.
- 17. EXISTING PAVEMENT MARKINGS INCLUDING ALL PAVEMENT MARKING LINES AND SYMBOLS REMOVED SHALL BE REINSTALLED IN THEIR ORIGINAL GEOMETRY AND DIMENSIONS AND SHALL BE PAID FOR AT THE UNIT PRICE FOR THERMOPLASTIC PAVEMENT MARKING - LETTERS AND SYMBOLS OR MODIFIED URETHANE PAVEMENT MARKING - LETTERS AND SYMBOLS AND CONSTRUCTED IN ACCORDANCE WITH SECTION 780 OF THE STANDARD SPECIFICATIONS.
- 18. THE CONTRACTOR'S ATTENTION IS DIRECTED TO THE FACT THAT DRILLING THROUGH BEDROCK. BOULDERS, AND OTHER HARD EARTH MATERIALS MAY BE REQUIRED. IT IS ESTIMATED 15 PERCENT OF THE TOTAL FIBER OPTIC LENGTH WILL REQUIRE BORING THROUGH ROCK

FILE NAME =	USER NAME = JKJELLMA	DESIGNED -	NK	KENIZED -	
JOLIET-SHT-GENERAL NOTES		DRAWN -	AF	REVISED -	STAT
	PLOT SCALE = 24.0000 '/ in.	CHECKED -	JK	REVISED -	DEPARTMENT
Default	PLOT DATE = 10/18/2018	DATE -	10/12/2018	REVISED -	

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SCALE:	N/A	SHEET	1	OF	1	SHEETS	STA.	TO STA.

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				80% 20%	STATE
				ROADWAY	UTILITY
CODE NO.	ITEM	LINITT	TOTAL	0006	URBAN
	ITEM TREE TRUNK PROTECTION	UNIT	94	URBAN 94	URBAN
20101100	TREE TRUNK PROTECTION	EACH	34		
20101200	TREE ROOT PRUNING	EACH	45	45	
20101300	TREE PRUNING (1 TO 10 INCH DIAMETER)	EACH	20	20	
20101350	TREE PRUNING (OVER 10 INCH DIAMETER)	EACH	20	20	
20200100	EARTH EXCAVATION	CU YD	150	150	
20200200	ROCK EXCAVATION	CU YD	75	75	
20201200	REMOVAL AND DISPOSAL OF UNSUITABLE MATERIAL	CU YD	25	25	
20400800	FURNISHED EXCAVATION	CU YD	70	70	
21101505	TOPSOIL EXCAVATION AND PLACEMENT	CU YD	40	40	
21301048	EXPLORATION TRENCH 48" DEPTH	FOOT	600		600
213010 10	EXCEDITION INCREMENTS DEL TIT	1001	555		000
25200110	SODDING, SALT TOLERANT	SQ YD	270	270	
28000400	PERIMETER EROSION BARRIER	FOOT	400	400	
28000510	INLET FILTERS	EACH	30	30	
40601005	HOT-MIX ASPHALT REPLACEMENT OVER PATCHES	TON	7	7	
42001300	PROTECTIVE COAT	SQ YD	386	386	
.2001300	. 10.1201112 0081	34 10	330	330	
12400200	PORTLAND CEMENT CONCRETE SIDEWALK 5 INCH	SO FT	1,575	1,575	
14000600	SIDEWALK REMOVAL	SO FT	1,575	1,575	
44002209	HOT-MIX ASPHALT REMOVAL OVER PATCHES, 2 1/4"	SQ YD	720	720	
44201349	CLASS C PATCHES, TYPE I, 10 INCH	SQ YD	180	180	
44201353	CLASS C PATCHES, TYPE II, 10 INCH	SQ YD	180	180	-
17601333	CENSO C FRICIES, THE 11, 10 INCH	30 TD	100	100	-
44201357	CLASS C PATCHES, TYPE III, 10 INCH	SQ YD	180	180	
	SPECIALTY ITEM				

FILE NAME =

JOLIET-SHT-SOO-Øl.dgn

USER NAME = JKJELLMA

PLOT SCALE = 2.0000 '/ in.

PLOT DATE = 10/12/2018

DESIGNED - NK

DRAWN - AF

REVISED -

COUNTY SHEET NO.

WILL 29 4

CONTRACT NO. 62G14 F.A.U RTE. VAR. SUMMARY OF QUANTITIES STATE OF ILLINOIS REVISED -2018-002I FIBER OPTIC CABLE INSTALLATION CHECKED - JK

DATE - 10/12/2018 REVISED -**DEPARTMENT OF TRANSPORTATION** SHEET 1 OF 1 SHEETS STA. REVISED -SCALE: N/A TO STA.

SECTION

				CONSTR 80% 20% S	FED
			<del>                                     </del>	ROADWAY	UTILITY
CODE			TOTAL -	0006	0043
NO.	ITEM	UNIT	QUANTITY	URBAN	URBAN
	CLASS C PATCHES, TYPE IV, 10 INCH	SQ YD	180	180	
48101500	AGGREGATE SHOULDERS, TYPE B 6"	SQ YD	2,223	2,223	
66900530	SOIL DISPOSAL ANALYSIS	EACH	5	5	
66901001	REGULATED SUBSTANCES PRE-CONSTRUCTION PLAN	L SUM	1	1	
66901002	ON-SITE MONITORING OF REGULATED SUBSTANCES	CAL DA	45	45	
56901003	REGULATED SUBSTANCES FINAL CONSTRUCTION REPORT	L SUM	1	1	
66900300	NON-SPECIAL WASTE DISPOSAL	CU YD	250	250	
00300200	NON-SPECIAL WASTE DISPOSAL	CU 1D	230	250	
			+		
 67100100	MOBILIZATION	L SUM	1	1	
70300100	SHORT TERM PAVEMENT MARKING	FOOT	4,000	4,000	
70300150	SHORT TERM PAVEMENT MARKING REMOVAL	SQ FT	1,334	1,334	
78000100	THERMOPLASTIC PAVEMENT MARKING - LETTERS AND SYMBOLS	SQ FT	150	150	
78009000	MODIFIED URETHANE PAVEMENT MARKING - LETTERS AND SYMBOLS	SQ FT	150	150	
78100300	REPLACEMENT REFLECTOR	EACH	50	50	
70300200	RAISED REFLECTIVE PAVEMENT MARKER REMOVAL	FACH	50	50	
10300200	NAISED REFLECTIVE FAVEMENT MARKER REMOVAL	EACH	50	υU	
81028240	UNDERGROUND CONDUIT, GALVANIZED STEEL, 4" DIA.	FOOT	8,969		8,969
	The state of the s	1 301	5,505		
81028790	UNDERGROUND CONDUIT, COILABLE NONMETALLIC CONDUIT, 4" DIA.	FOOT	2,199		2,199
81101005	CONDUIT ATTACHED TO STRUCTURE, 4" DIA., PVC COATED GALVANIZED STEEL	FOOT	95		95
81300960	JUNCTION BOX, STAINLESS STEEL, ATTACHED TO STRUCTURE, 42" X 36" X 12"	EACH	2		2
81400100	HANDHOLE	EACH	15		15
81400200	HEAVY-DUTY HANDHOLE	EACH	23		23

• SPECIALTY ITEM

FILE NAME = JOLIET-SHT-S00-02.dgn	USER NAME = JKJELLMA	DESIGNED - NK DRAWN - AF	REVISED -	STATE OF ILLINOIS		SUMMARY OF QUANTITIES
	PLOT SCALE = 2.00000 '/ in.	CHECKED -	REVISED -	DEPARTMENT OF TRANSPORTATION		FIBER OPTIC CABLE INSTALLATION
Default	PLOT DATE = 10/17/2018	DATE - 10/12/2018	REVISED -		SCALE: N/A	SHEET 2 OF 3 SHEETS STA.

F.A.U RTE. VAR.

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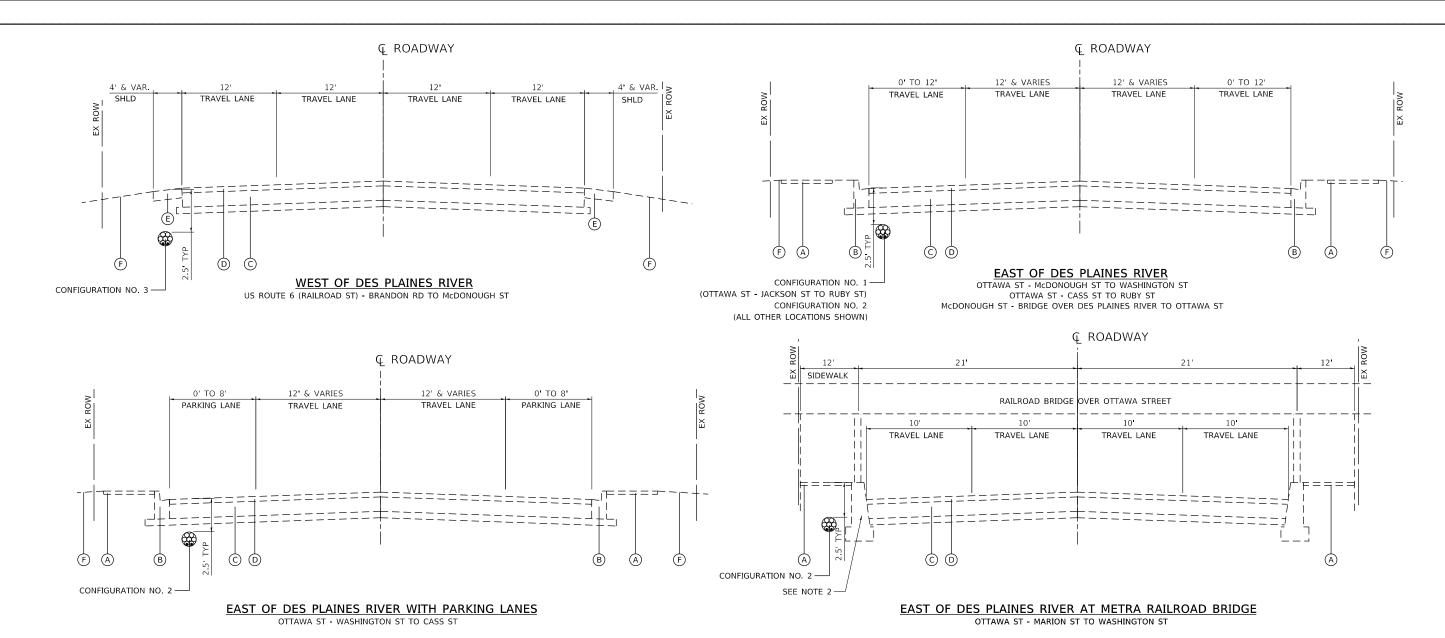
2018-002I

			[	CONSTR	R. CODE
					FED
				ROADWAY	STATE UTILITY
CODE			TOTAL	0006	0043
NO.	ITEM	UNIT	QUANTITY	URBAN	URBAN
x0327980	PAVEMENT MARKING REMOVAL - WATER BLASTING	SQ FT	1,334	1,334	
X1400301	FIBER OPTIC CABLE, MICRO, 96 FIBERS, SINGLE MODE	FOOT	49,324		49,324
X4021000	TEMPORARY ACCESS (PRIVATE ENTRANCE)	EACH	4	4	
X4022000	TEMPORARY ACCESS (COMMERCIAL ENTRANCE)	EACH	4	4	
×4400220	CURB REMOVAL AND REPLACEMENT	FOOT	100	100	
X7010216	TRAFFIC CONTROL AND PROTECTION, (SPECIAL)	L SUM	1	1	
70107025	CHANGEABLE MESSAGE SIGN	CAL DA	280	280	
X8100863	INTERCEPT EXISTING CONDUIT	EACH	7		7
		5007	10.047		10.047
X8101100	UNDERGROUND CONDUIT, MULTI-DUCT, 7-16MM MICRODUCTS	FOOT	18,047		18,047
Z0013798	CONSTRUCTION LAYOUT	L SUM	1		1
70030050	TEMPORARY INFORMATION SIGNING	SQ FT	278	278	
20030830	TEMPONANT INFORMATION SIGNING	SUFI	210	210	
20076600	TRAINEES	HOUR	500	500	
Z0076604	TRAINEES TRAINING PROGRAM GRADUATE	HOUR	500	500	

• SPECIALTY ITEM
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Default	PLOT DATE = 10/18/2018	DATE	-	10/12/2018	REVISED -	1
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		SU	мма	RY	OF QUA	NTITIES		F.A.U RTE.	SECTION	COUNTY	TOTAL SHEETS	SHEET NO.
	FIR	EFR	прті	cc	ARIF IN	ISTALLA	TION	VAR.	2018-0021	WILL	29	6
		LII	01 11		ADLL II	IOIALLA				CONTRAC	T NO. 6	52G14
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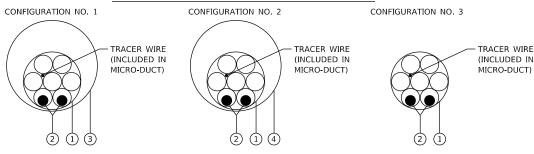
## **EXISTING ROADWAY LEGEND**

- (A) SIDEWALK, 5"
- B CURB AND GUTTER, TYPE B-6.12
- C PAVEMENT, 8"
- D HMA SURFACE, 2"
- E EXISTING AGGREGATE SHOULDER 6"
- F EXISTING GROUND

## PROPOSED FIBER OPTIC AND CONDUIT LEGEND

- 1) UNDERGROUND CONDUIT, MULTI-DUCT, 7-16MM MICRODUCTS (X8101100)
- 2) FIBER OPTIC CABLE, MICRO, 96 FIBERS, SINGLE MODE (X1400301)
- (3) UNDERGROUND CONDUIT, COILABLE NONMETALLIC CONDUIT, 4" DIA. (81028790)
- 4 UNDERGROUND CONDUIT, GALVANIZED STEEL, 4" DIA. (81028240)

#### FIBER OPTIC CABLE AND CONDUIT SECTION



## HMA MIXTURE REQUIREMENTS CHART

OPERATION	MIXTURE TYPE	AIR VOIDS (%) @ NDES	QUALITY MANAGEMENT PROGRAM (QMP)
HOT-MIX ASPHALT REPLACEMENT OVER PATCHES	HOT-MIX ASPHALT SURFACE COURSE, MIX "D", N70 (IL 9.5 mm)	4% @ 70 GYR.	QC/QA
QMP DESIGNATIONS: QUALITY (	CONTROL/QUALITY ASSURANCE (QC/QA); QUALITY CONTROL FOR PE	RFORMANCE (QCP); PA	AY FOR PERFORMANCE (PFP)

- 1. THE UNIT WEIGHT USED TO CALCULATE ALL HMA SURFACE MIXTURE QUANTITIES IS 112 LBS/SQ YD/IN
- 2. THE "AC TYPE" FOR POLYMERIZED HMA MIXES SHALL BE "SBS/SBR PG 76-22" AND FOR NON-POLYMERIZED HMA THE "AC TYPE" SHALL BE "PG 64-22" UNLESS MODIFIED BY DISTRICT ONE SPECIAL PROVISIONS.

SCALE: NTS

- 3. FOR USE OF RECYCLED MATERIALS SEE SPECIAL PROVISIONS.
- 4. QUALITY MANAGEMENT PROGRAM (QMP) IDENTIFIES THE PARTICULAR CONTROL SPECIFICATION THAT APPLIES TO THE HMA MIXTURE.

- NOTE.
- 1. EXISTING PAVEMENT AND SIDEWALK THICKNESSES ARE BASED ON ASSUMED DEPTHS. ACTUAL THICKNESSES MAY VARY.
- 2. CONTRACTOR SHALL TAKE EXTRA PRECAUTIONS NOT TO DISTURB ANY STRUCTURAL ELEMENTS OF THE EXISTING RAILROAD BRIDGE STRUCTURE.
- 3. CLASS C PATCHES, 10 INCH, OF THE TYPE SPECIFIED SHALL BE UTILIZED AS DIRECTED BY THE ENGINEER AND SHALL UTILIZE HIGH EARLY STRENGTH CONCRETE. PAVEMENT PATCHES SHALL BE OPEN TO TRAFFIC A MINIMUM OF 72 HOURS FROM WHEN THE PATCH IS POURED.
- 4. HOT-MIX ASPHALT REPLACEMENT OVER PATCHES (40601005) SHALL BE A MINIMUM OF 2-1/4" INCHES AND UTILIZED ALONG ALL ROADWAYS WITH AN EXISTING BITUMINOUS SURFACE. THIS ITEM IS TO BE CONSTRUCTED OVER CLASS C PATCHES, 10 INCH, OF THE TYPE SPECIFIED.
- FIBER OPTIC CONFIGURATIONS SHOWN ALONG VARIOUS ROUTES ARE THE TYPICAL CONFIGURATIONS USED.
   SEE FIBER OPTIC AND RESTORATION PLAN FOR CONFIGURATIONS TO BE CONSTRUCTED AT EACH LOCATION.


JOLIET-SHT-TYP DRAWN - AF REVISED -	
PLOT SCALE = 10.0000 1/ 10. CHECKED - JK REVISED -	
Defoult PLOT DATE = 10/18/2018 DATE - 10/12/2018 REVISED -	

## STATE OF ILLINOIS DEPARTMENT OF TRANSPORTATION

	TYPICAL SECTIONS FIBER OPTIC CABLE INSTALLATION					TIONS		F.A.U RTE.	SECTION	COUNTY	TOTAL SHEETS	SHEET NO.
						NITALIA.	TION	VAR.	2018-0021	WILL	29	7
		LII	01 11		ADEL II	IOIALLA				CONTRAC	T NO.	62G14
	SHEET	1	ΩF	1	SHEETS	STA.	TO STA.		TILINOIS EED /	ID PROJECT		

## WEST OF DES PLAINES RIVER

US ROUTE 6 (RAILROAD ST) - BRANDON RD TO McDONOUGH ST

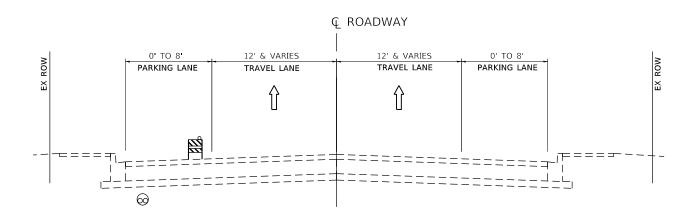


## EAST OF DES PLAINES RIVER WITH PARKING LANES

OTTAWA ST - WASHINGTON ST TO CASS ST

## TRAFFIC CONTROL GENERAL NOTES


- THE CONTRACTOR MUST SUBMIT A PLAN SHOWING PROPOSED LOCATIONS OF BORING EQUIPMENT, LANE CLOSURES, HANDHOLES, EXPLORATION TRENCHES, ETC. ALONG WITH TRAFFIC CONTROL STANDARDS TO BE USED TO THE ENGINEER FOR APPROVAL AT LEAST 5 WORKING DAYS IN ADVANCE OF BEGINNING WORK. THE CONTRACTOR MUST OBTAIN APPROVAL FROM THE ENGINEER FOR ALL LANE CLOSURES 48 HOURS IN ADVANCE OF PLACING A
- 2. THE CONTRACTOR SHALL USE TRAFFIC CONTROL STANDARDS LISTED IN THE "TRAFFIC CONTROL PLAN" SPECIFICATION.
- 3. ALL TRAFFIC CONTROL WILL BE PAID FOR AT THE CONTRACT LUMP SUM FOR TRAFFIC CONTROL AND PROTECTION (SPECIAL). SEE "TRAFFIC CONTROL AND PROTECTION (ARTERIALS)" SPECIFICATION.
- 4. WHENEVER POSSIBLE THE CONTRACTOR SHALL LIMIT CONSTRUCTION ACTIVITIES TO PARKING LANES, SHOULDERS, OR PARKWAYS. A MINIMUM OF ONE 11-FOOT-WIDE LANE MUST REMAIN OPEN TO TRAFFIC AT ALL TIMES.
- 5. ALL TRAVEL LANES MUST BE OPEN TO TRAFFIC DURING NON-WORKING HOURS EXCEPT AS APPROVED BY THE ENGINEER.
- 6. ACCESS MUST BE MAINTAINED TO ALL BUSINESSES AND RESIDENCES AT ALL TIMES

- 7. ALL OPEN HOLES SHALL BE FILLED WITH AGGREGATE OR COVERED WITH STEEL PLATES SUITABLE TO CARRY TRAFFIC DURING NON-WORKING HOURS, ALL PATCHES OR HANDHOLES IN TRAFFIC LANES SHALL BE COVERED WITH STEEL PLATES SUITABLE TO CARRY TRAFFIC UNTIL CONCRETE HAS REACHED REQUIRED STRENGTH.
- TEMPORARY PAVEMENT MARKINGS SHALL BE USED IF A LANE CLOSURE WILL BE IN PLACE FOR LONGER THAN 5 WORKING DAYS. TEMPORARY PAVEMENT MARKINGS SHALL BE WET REFLECTIVE TAPE, TYPE III. A NOMINAL QUANTITY HAS BEEN PROVIDED.
- 9. ANY RAISED REFLECTIVE PAVEMENT MARKERS WHICH CONFLICT WITH TEMPORARY PAVEMENT MARKINGS MUST HAVE THE REFLECTIVE LENSES REMOVED AS DIRECTED BY THE ENGINEER.
- 10. ANY SIGNS WHICH CONFLICT WITH TRAFFIC CONTROL MUST BE COVERED AS DIRECTED BY THE ENGINEER.
- 11. THE CONTRACTOR SHALL CONTACT THE D1 TRAFFIC CONTROL SUPERVISOR AT (847) 705-4470 A MINIMUM OF 72 HOURS BEFORE BEGINNING WORK.

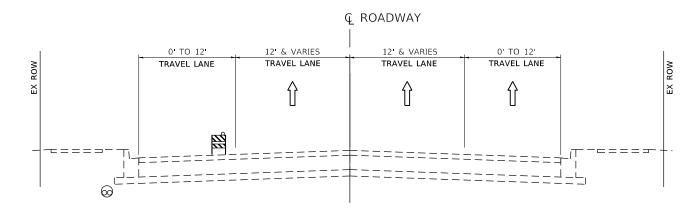

## EAST OF DES PLAINES RIVER

OTTAWA ST - McDONOUGH ST TO WASHINGTON ST OTTAWA ST - CASS ST TO RUBY ST McDONOUGH ST - RAILROAD ST TO OTTAWA ST

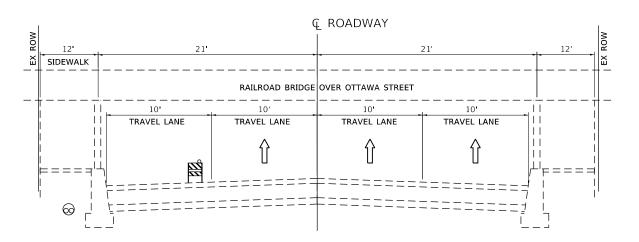

### EAST OF DES PLAINES RIVER AT METRA RAILROAD BRIDGE

OTTAWA ST - MARION ST TO WASHINGTON ST

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	DRAWN -	MS	REVISED -
PLOT SCALE = 100.0000 ' / in.	CHECKED -	JH	REVISED -
PLOT DATE = 10/18/2018	DATE -	10/18/2018	REVISED -

STATE OF ILLINOIS **DEPARTMENT OF TRANSPORTATION** 

SECTION TRAFFIC CONTROL PLAN - GENERAL NOTES AND TYPICAL SECTIONS 2018-002I WILL 29 FIBER OPTIC CABLE INSTALLATION CONTRACT NO. 62G14 SHEET 1 OF 1 SHEETS STA. SCALE: NTS




#### EXISTING UTILITY LEGEND:

#### NOTES:


- 1. CONTRACTOR TO LOCATE AND INTERCEPT EXISTING EMPTY CONDUIT CONSTRUCTED UNDER CONTRACT 60P55. INSTALL 100 FT OF FIBER OPTIC CABLE, MICRO, 96 FIBERS, SINGLE MODE (X1400301) IN EXISTING EMPTY CONDUIT AND MAKE AVAILABLE FOR CONTRACT 60P55 TO TERMINATE ALL STRANDS OF THE 2 96-FIBER IN THE EXISTING FIBER OPTIC PATCH PANEL. THIS WORK SHALL BE PAID FOR AT THE UNIT PRICE FOR INTERCEPT EXISTING CONDUIT.
- 2. LENGTHS SHOWN FOR CONDUIT AND FIBER OPTIC CABLE DO NOT INCLUDE SLACK PROVIDED IN THE STRUCTURES. SEE SPECIFICATIONS FOR SLACK LENGTH REQUIREMENTS. LENGTHS SHOWN INCLUDE THE COMBINED LENGTH FOR EACH SECTION OF THE TWO PARALLEL RUNS OF FIBER OPTIC CABLE.
- 3. SEE GENERAL NOTES AND SPECIFICATIONS FOR EXISTING CONDITIONS DISTURBANCE AND RESTORATION REQUIREMENTS.
- 4. CONTRACTOR SHALL REGRADE THE EMBANKMENT ADJACENT TO THE PROPOSED HANDHOLE IN ORDER TO INSTALL THE HANDHOLE FRAME AND LID AT A LEVEL SLOPE. REGRADING LIMITS SHALL BE APPROVED BY THE ENGINEER.
- 5. SECTION UNDER DRIVEWAY SHALL NOT BE OPEN TRENCHED. A DIRECTIONAL BORING METHOD SHALL BE UTILIZED.

#### LEGEND

- ① 1 UNDERGROUND CONDUIT, MULTI-DUCT, 7-16MM MICRODUCTS (X8101100)
- ② 2 FIBER OPTIC CABLE, MICRO, 96 FIBERS, SINGLE MODE (X1400301)
- ③ 1 UNDERGROUND CONDUIT, COILABLE NONMETALLIC CONDUIT, 4" DIA. (81028790)
- ① 1 UNDERGROUND CONDUIT, GALVANIZED STEEL, 4" DIA. (81028240)

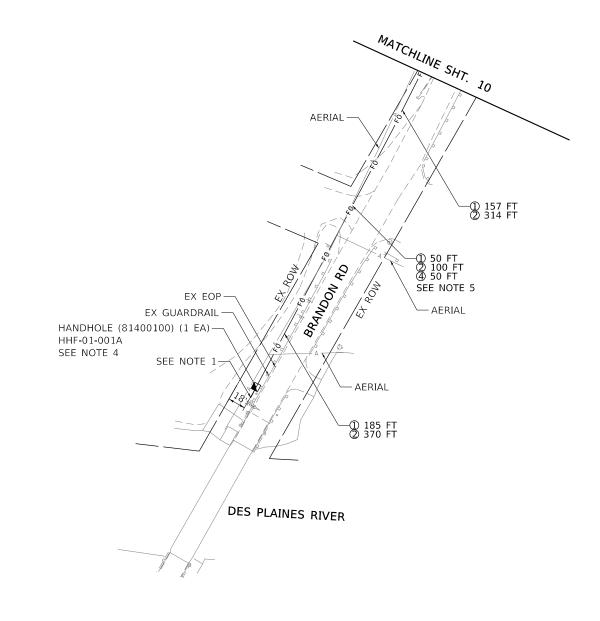



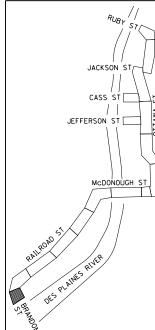



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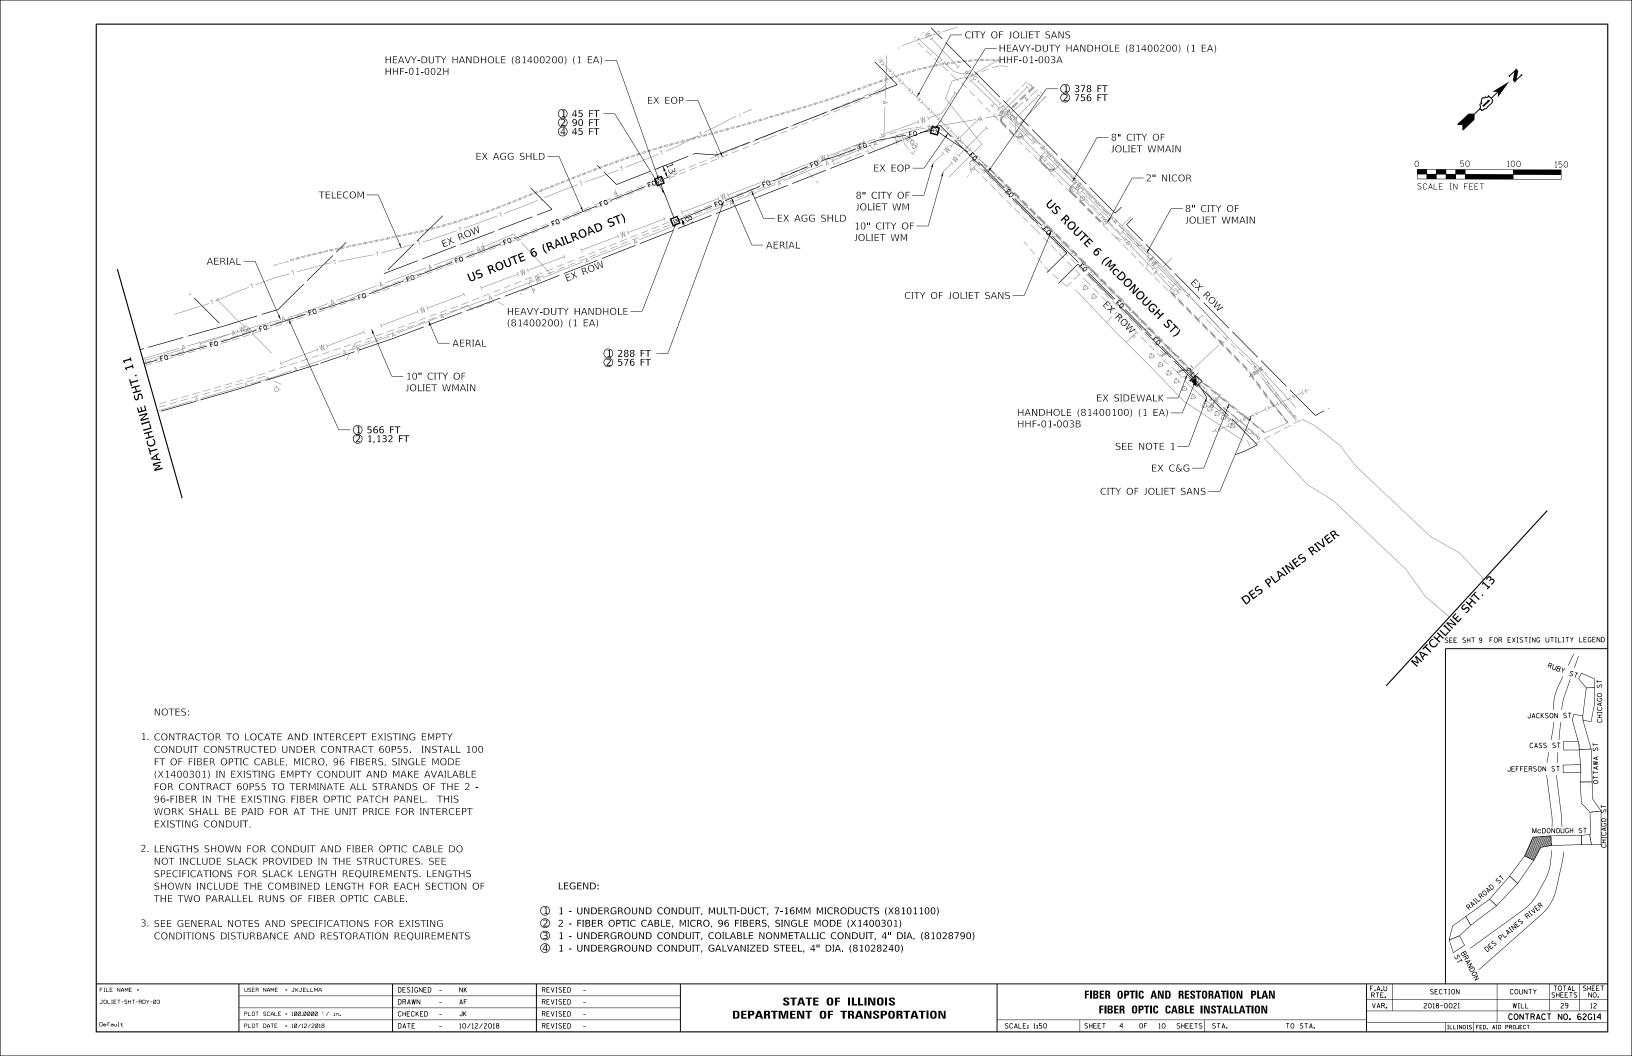
STATE OF ILLINOIS
DEPARTMENT OF TRANSPORTATION


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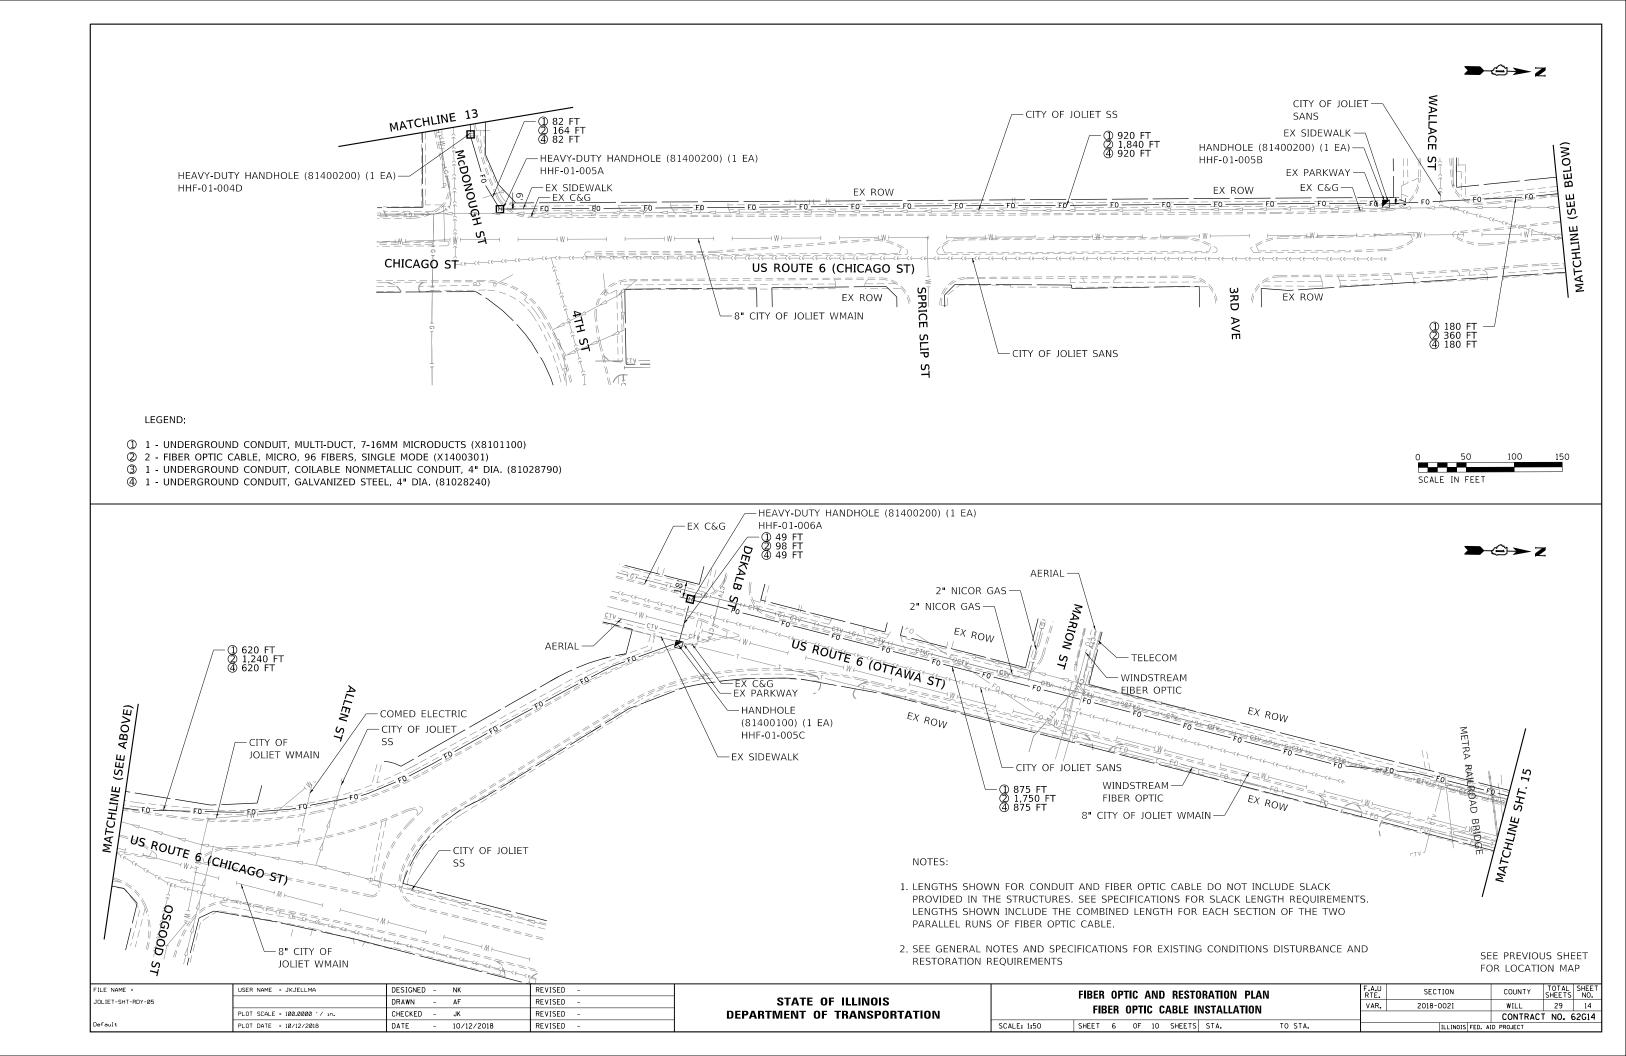
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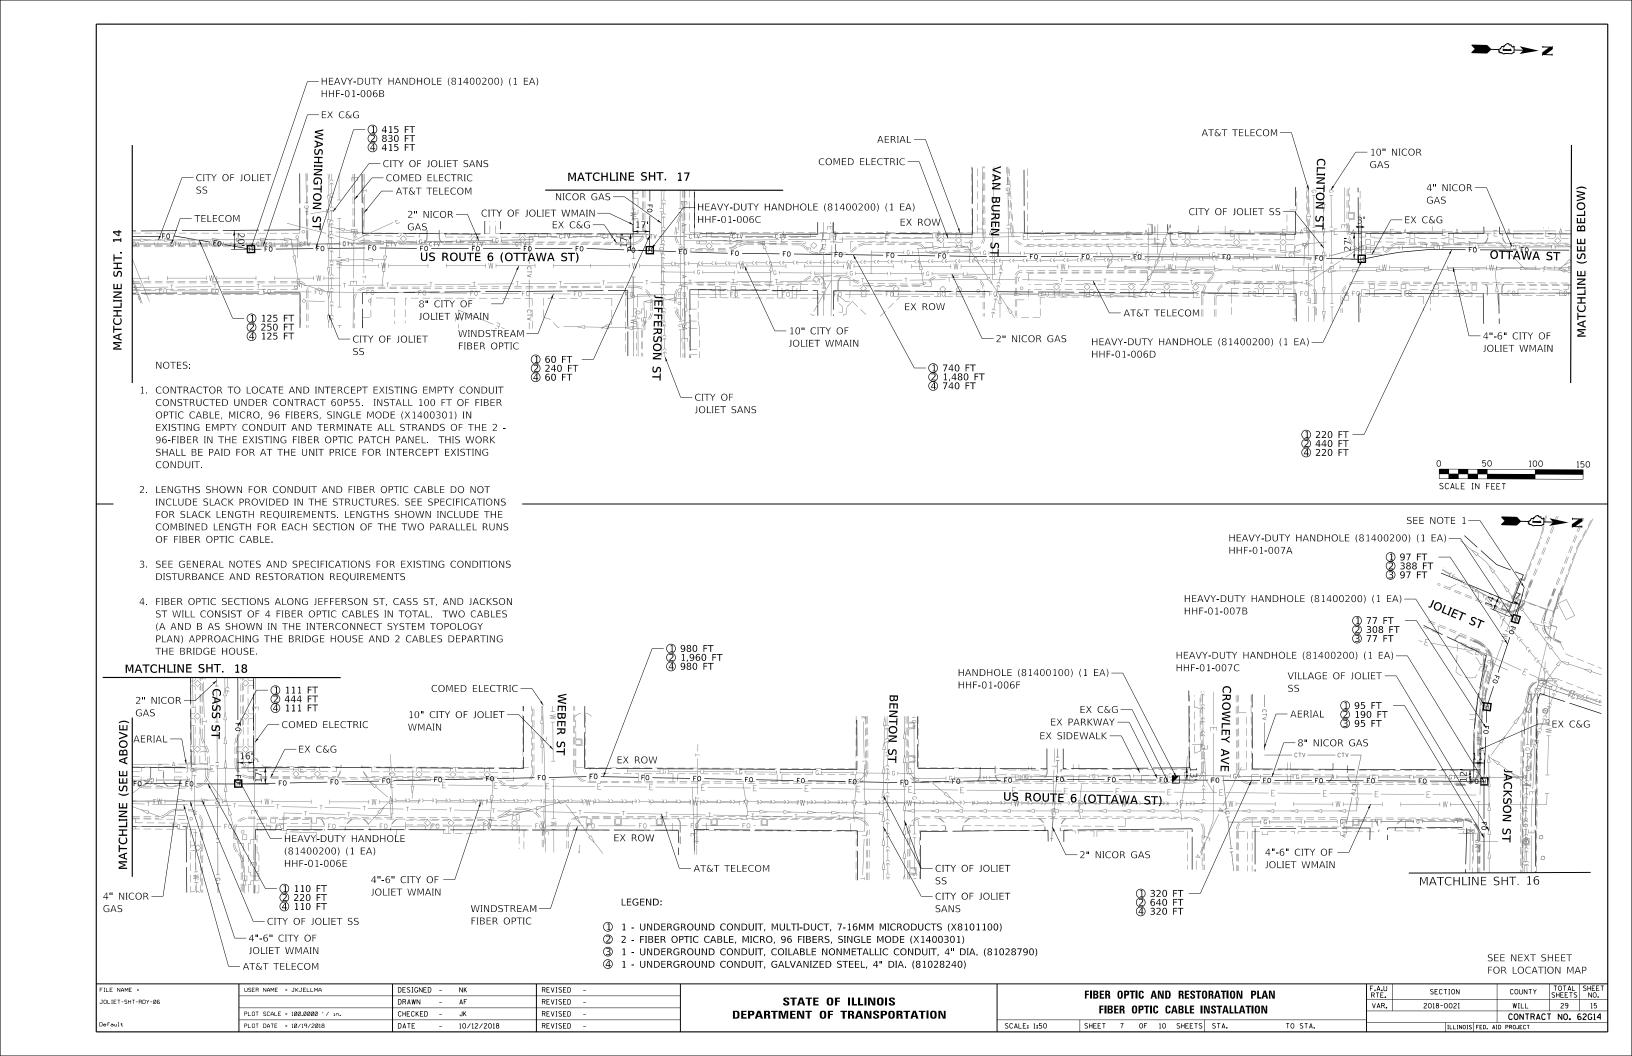







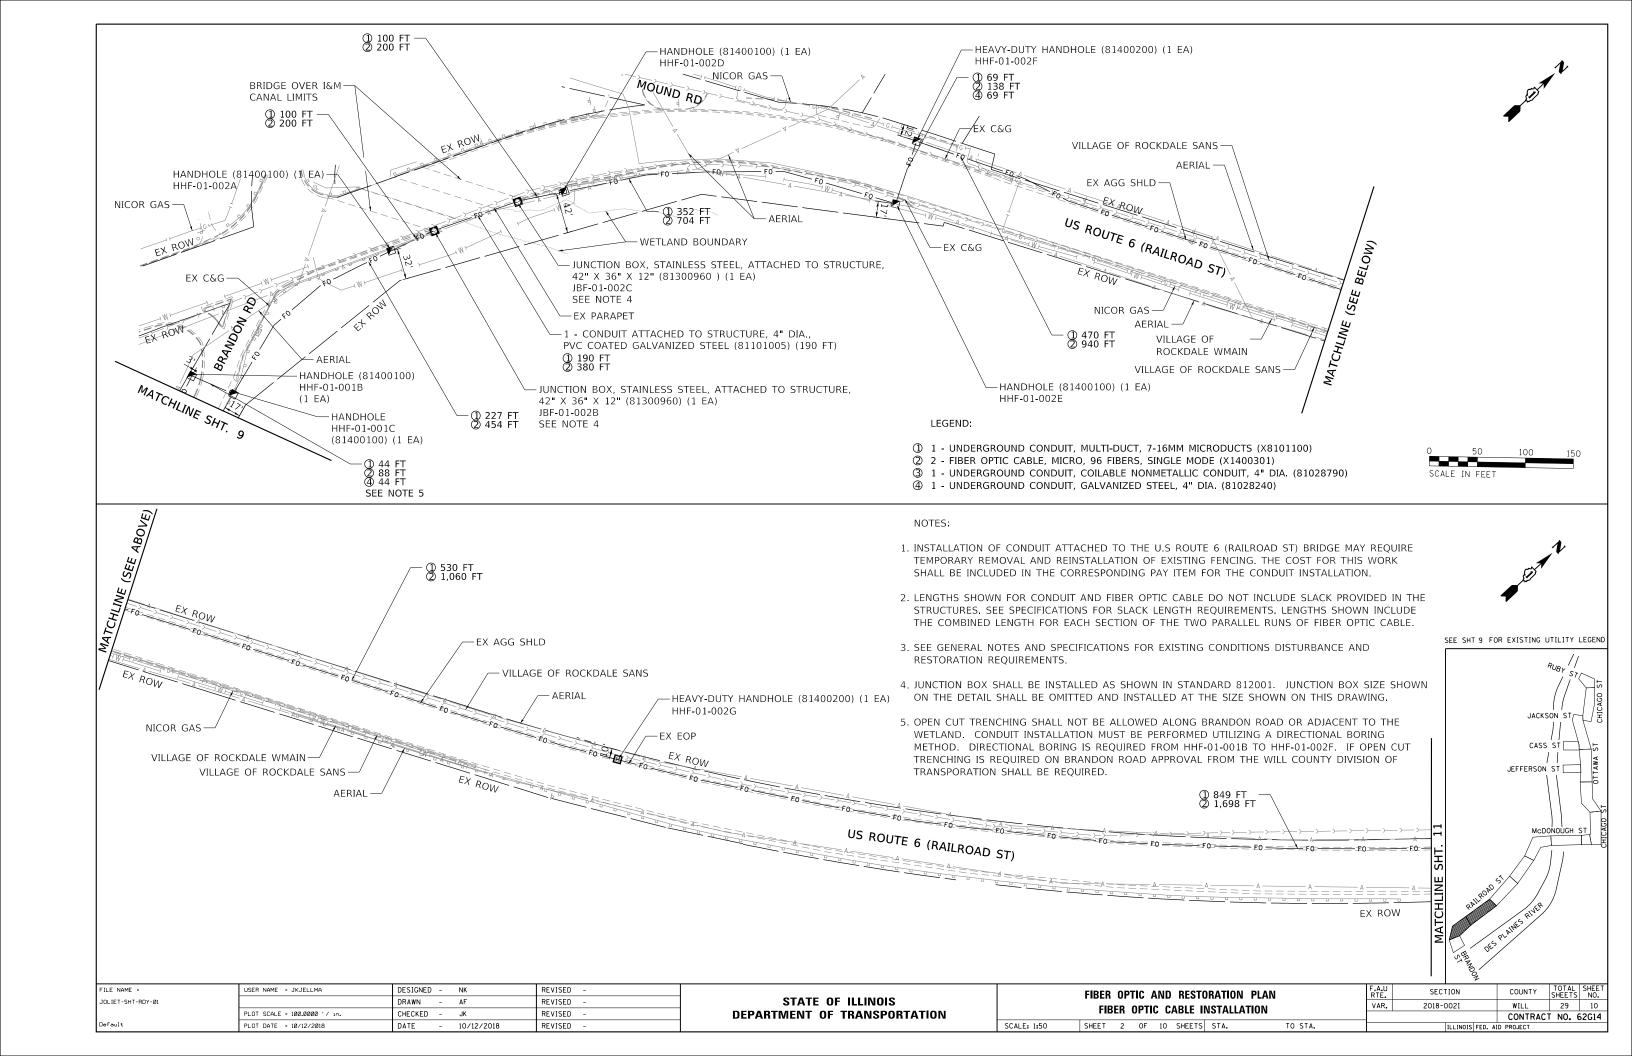


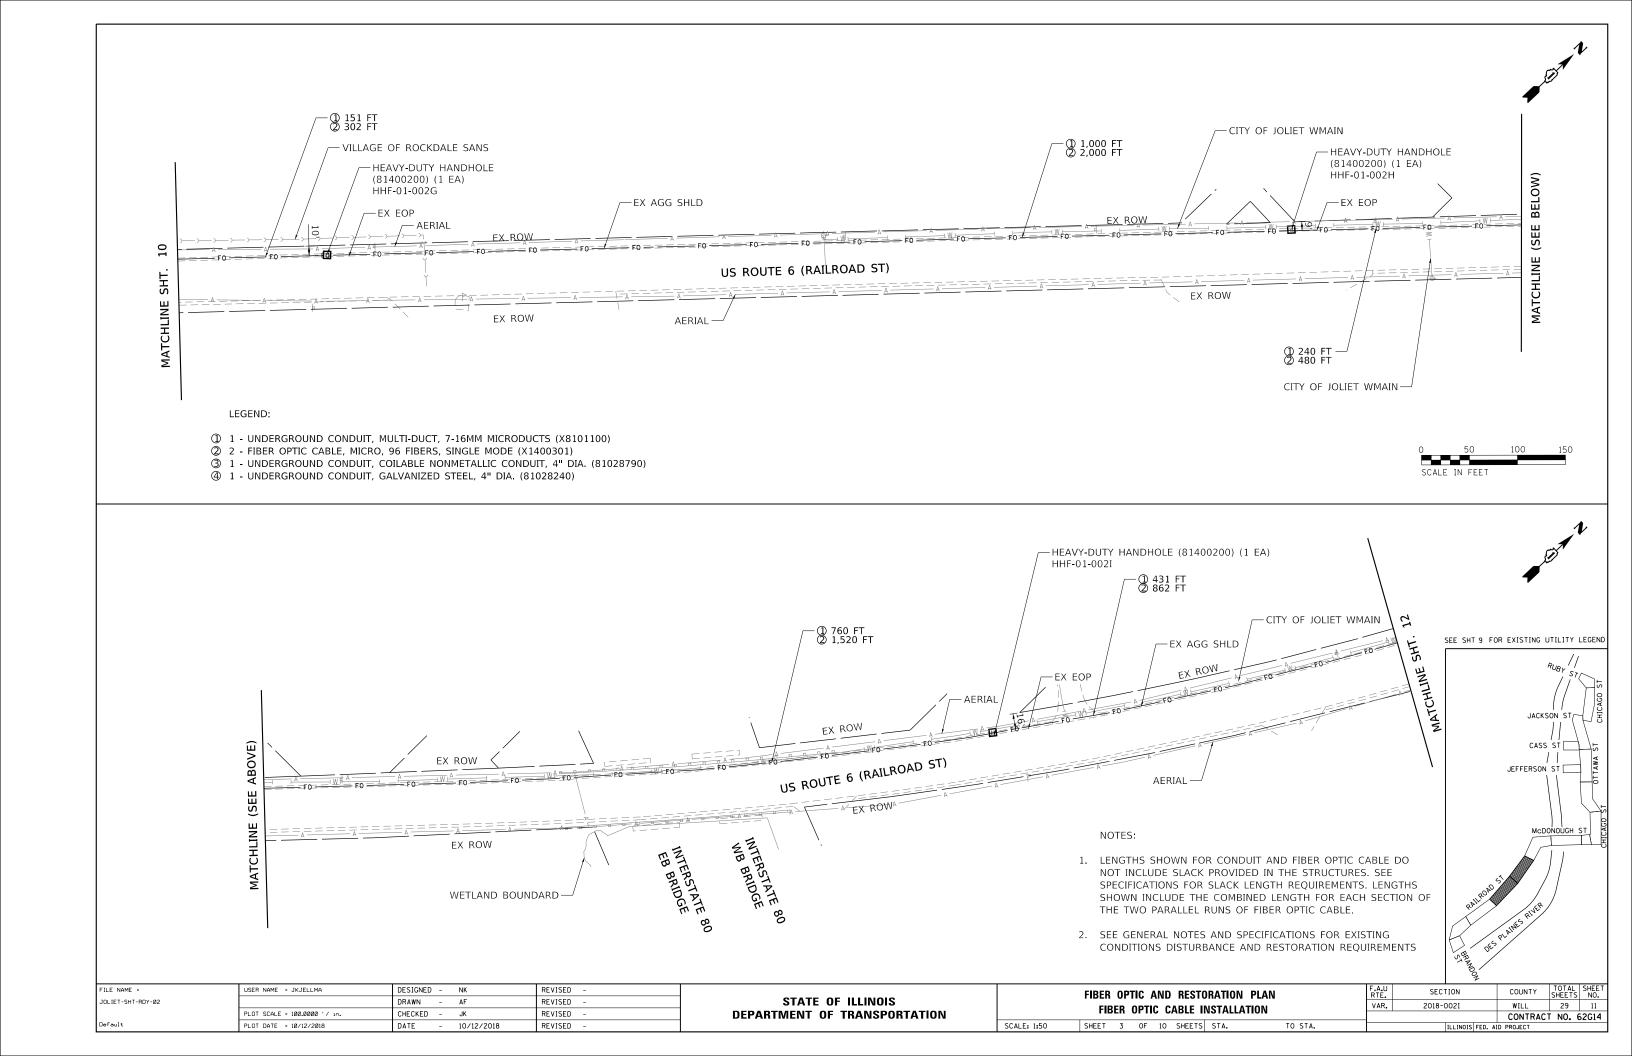

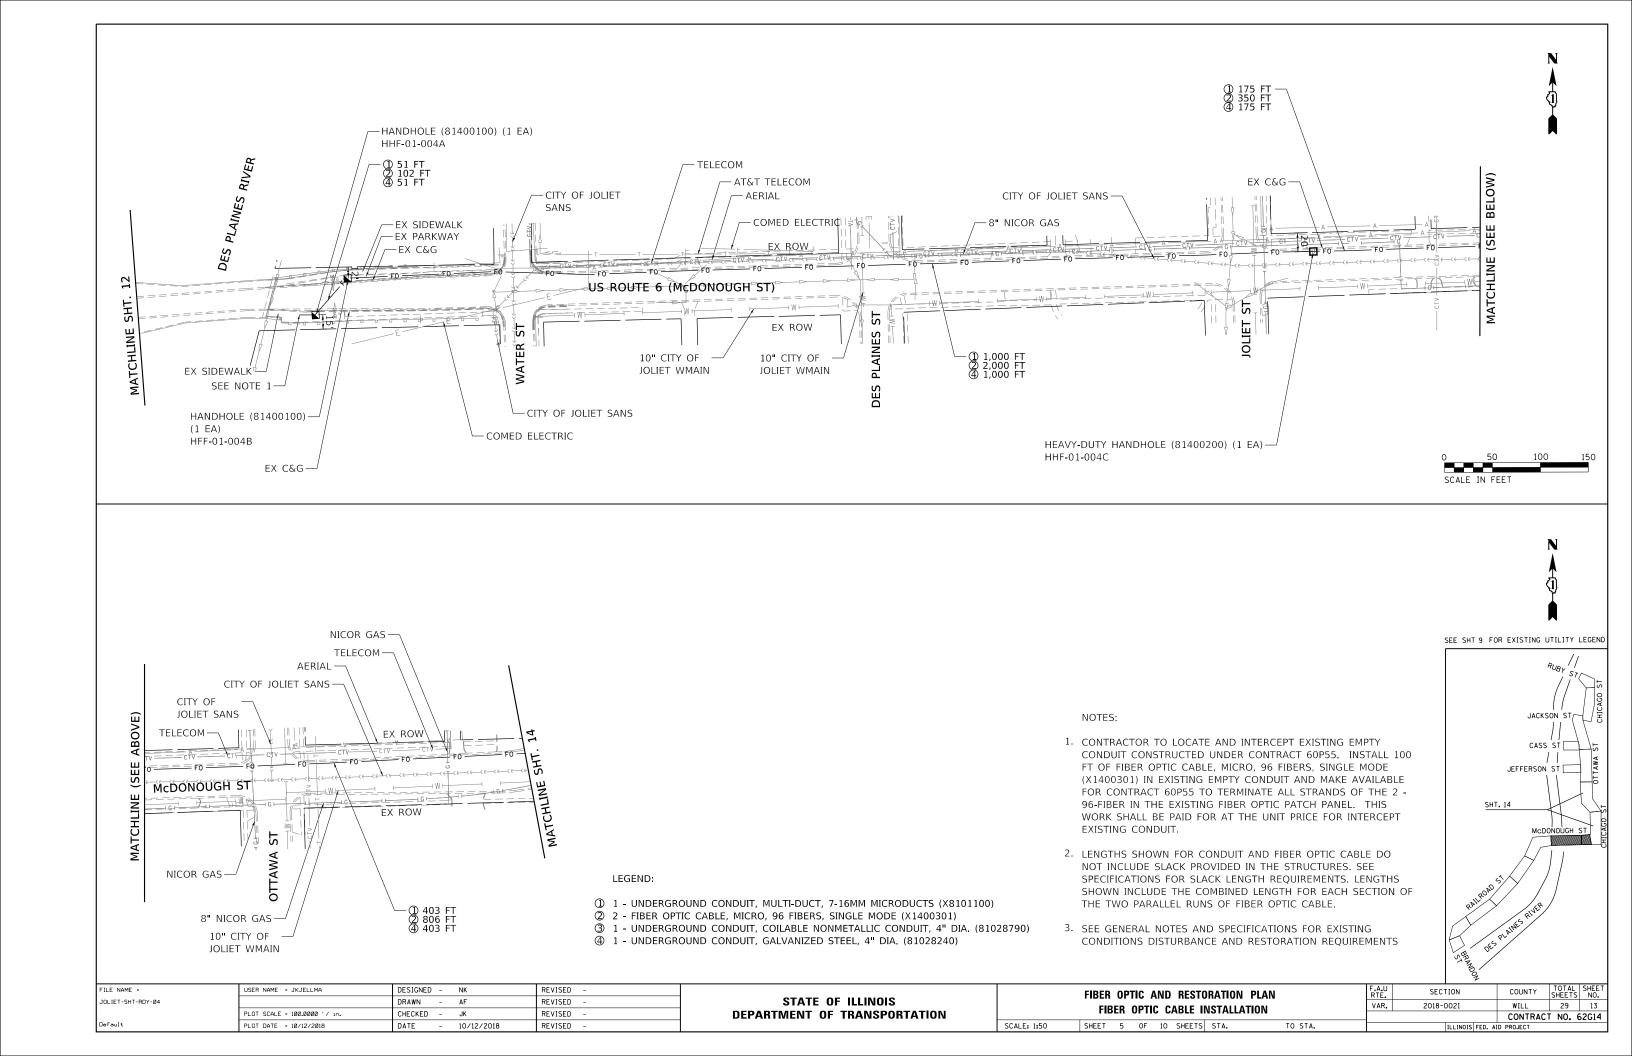

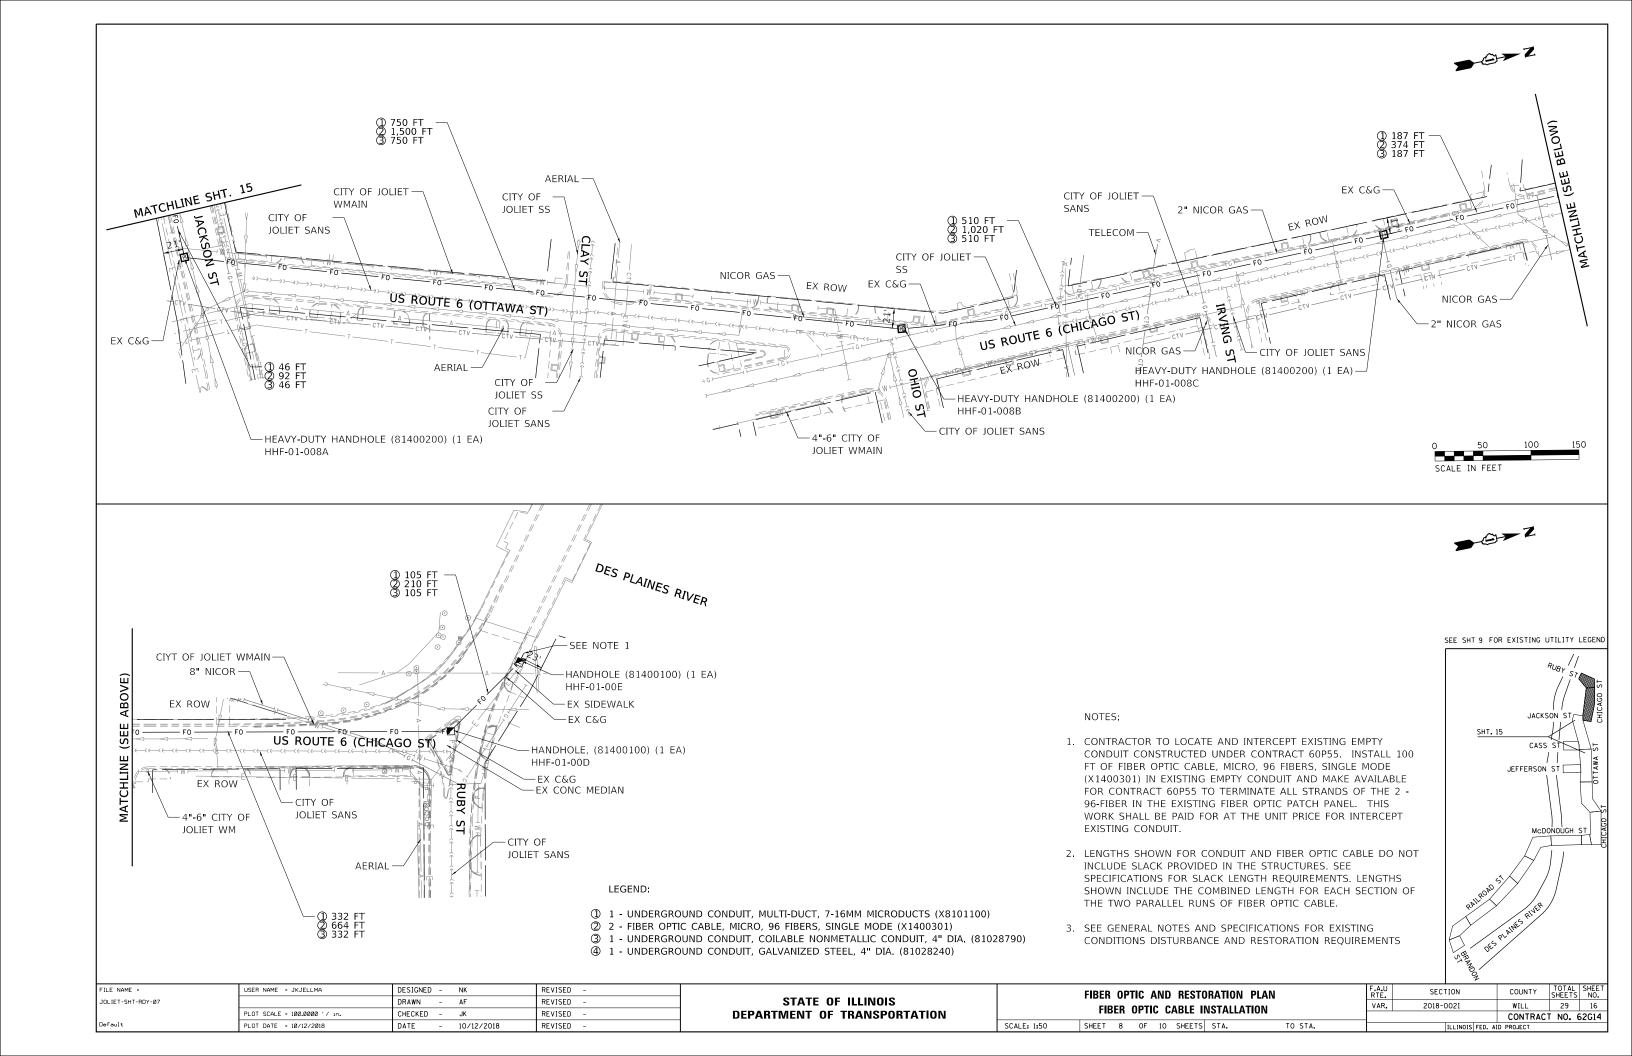



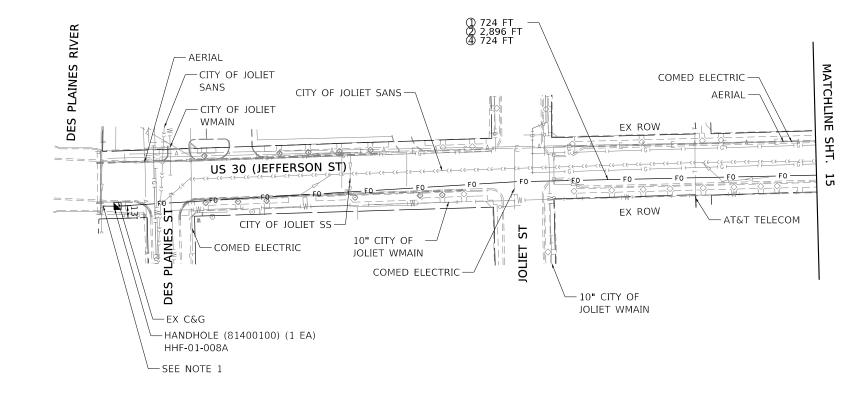




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- 1. CONTRACTOR TO LOCATE AND INTERCEPT EXISTING EMPTY CONDUIT CONSTRUCTED UNDER CONTRACT 60P55. INSTALL 100 FT OF FIBER OPTIC CABLE, MICRO, 96 FIBERS, SINGLE MODE (X1400301) IN EXISTING EMPTY CONDUIT AND MAKE AVAILABLE FOR CONTRACT 60P55 TO TERMINATE ALL STRANDS OF THE 2 96-FIBER IN THE EXISTING FIBER OPTIC PATCH PANEL. THIS WORK SHALL BE PAID FOR AT THE UNIT PRICE FOR INTERCEPT EXISTING CONDUIT.
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- 3. SEE GENERAL NOTES AND SPECIFICATIONS FOR EXISTING CONDITIONS DISTURBANCE AND RESTORATION REQUIREMENTS
- 4. FIBER OPTIC SECTIONS ALONG JEFFERSON ST, CASS ST, AND JACKSON ST WILL CONSIST OF 4 FIBER OPTIC CABLES IN TOTAL. TWO CABLES (A AND B AS SHOWN IN THE INTERCONNECT SYSTEM TOPOLOGY PLAN) APPROACHING THE BRIDGE HOUSE AND 2 CABLES DEPARTING THE BRIDGE HOUSE.



SEE SHT 9 FOR EXISTING UTILITY LEGEND

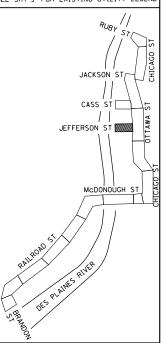

#### LEGEND:

- ① 1 UNDERGROUND CONDUIT, MULTI-DUCT, 7-16MM MICRODUCTS (X8101100)
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- ① 1 UNDERGROUND CONDUIT, GALVANIZED STEEL, 4" DIA. (81028240)


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STATE OF ILLINOIS
DEPARTMENT OF TRANSPORTATION

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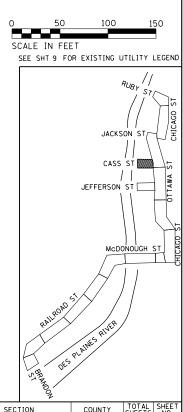


## LEGEND:

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- 3. SEE GENERAL NOTES AND SPECIFICATIONS FOR EXISTING CONDITIONS DISTURBANCE AND RESTORATION REQUIREMENTS.
- 4. FIBER OPTIC SECTIONS ALONG JEFFERSON ST, CASS ST, AND JACKSON ST WILL CONSIST OF 4 FIBER OPTIC CABLES IN TOTAL. TWO CABLES (A AND B AS SHOWN IN THE INTERCONNECT SYSTEM TOPOLOGY PLAN) APPROACHING THE BRIDGE HOUSE AND 2 CABLES DEPARTING THE BRIDGE HOUSE.

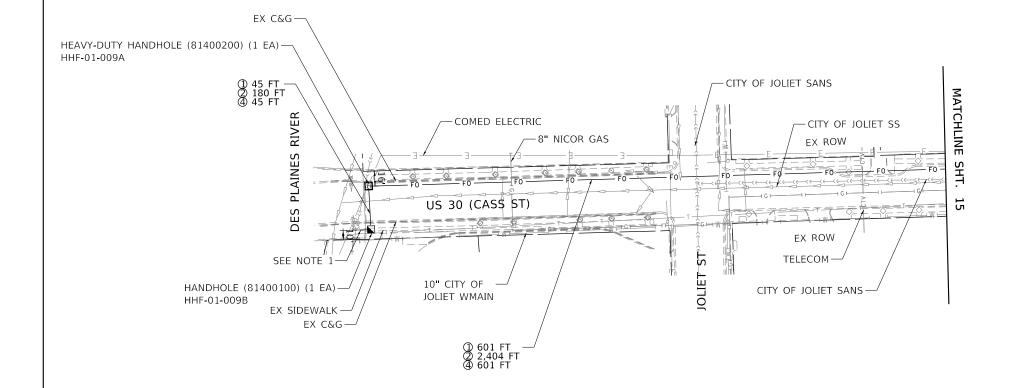


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Default	PLOT DATE = 10/18/2018	DATE -	10/12/2018	REVISED -

STATE OF ILLINOIS
DEPARTMENT OF TRANSPORTATION

FIBER OPTIC AND RESTORATION PLAN FIBER OPTIC CABLE INSTALLATION							
SCALE: 1:50	SHEET	10	OF	10	SHEETS	STA.	TO STA.

		2				
F.A.U RTE.	SEC.	TION		COUNTY	TOTAL SHEETS	SHEET NO.
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				CONTRACT	NO. 6	2G14
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FIBER OPTIC CABLE A

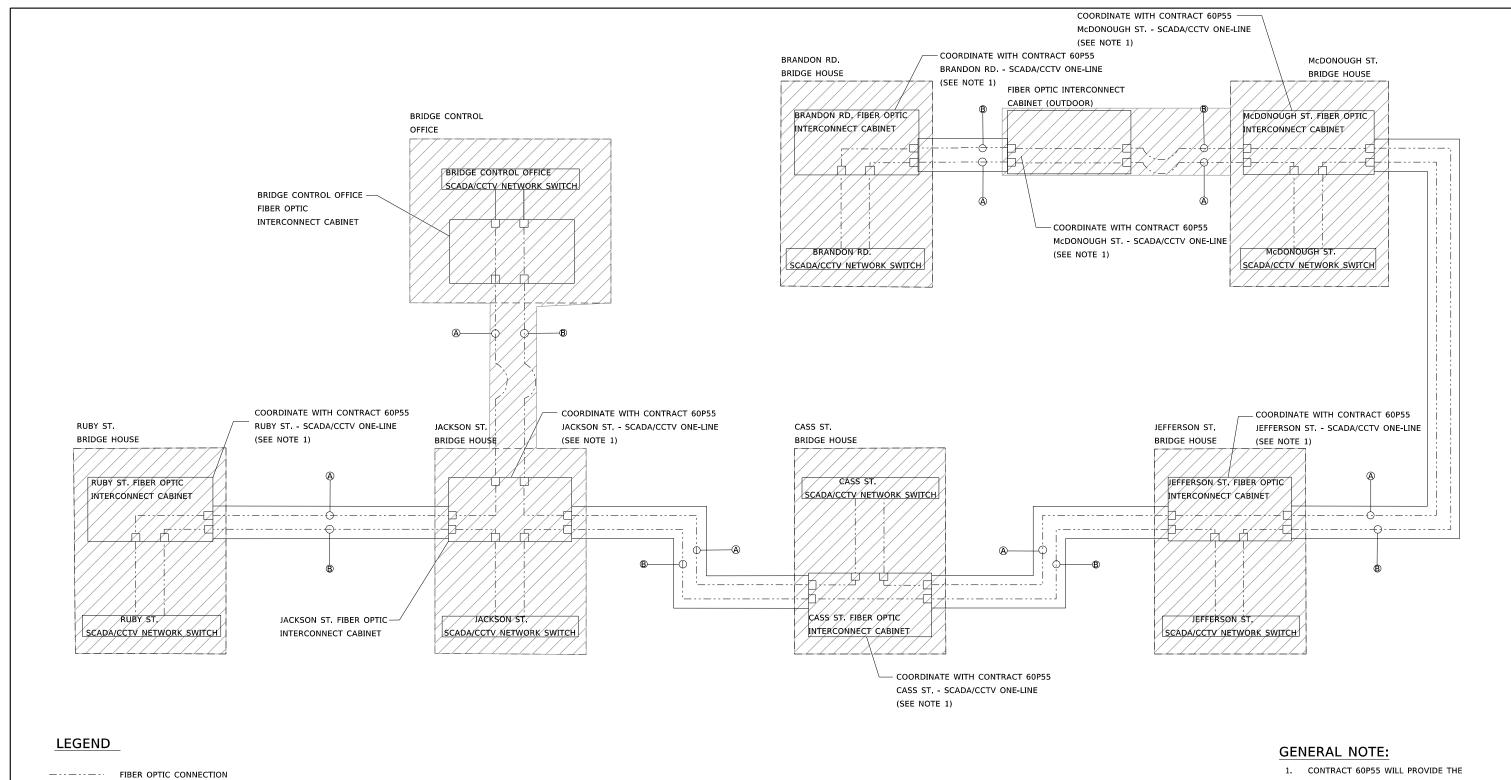
FIBER OPTIC CABLE B


BRIDGE AERIAL CABLES

DENOTES PORTION OF FIBER OPTIC NETWORK TO BE INSTALLED UNDER CONTRACT 60P55

- INTERCONNECT CABINETS AND FIBER OPTIC PATCH PANELS. CONTRACTOR TO COORDINATE WITH 60P55 AND RUN 2-96 SINGLE MODE FIBER OPTIC TO THE EXISTING PATCH PANEL. 60P55 TO TERMINATE IN THE PATCH PANEL.
- 2. CONTRACTOR TO TEST FIBER OPTIC SYSTEM ONCE CONTRACT 60P55 PERFORMS THE TERMINATIONS IN THE PATCH PANELS.

FI	ILE NAME =	USER NAME = JKJELLMA	DESIGNED - NK	REVISED -			INTERCONNECT SYSTEM TOPOLOGY		RTE.	SECTION	COUNTY	SHEETS	NO.
J	OLIET-SHT-SCHEMATIC		DRAWN - AF	REVISED -	STATE OF ILLINOIS	FIBER OPTIC CABLE INSTALLATION			VAR.	2018-0021	WILL	29	19
		PLOT SCALE = 10.0000 '/ in.	CHECKED - JK	REVISED -	DEPARTMENT OF TRANSPORTATION		FIBER UPITE CABLE INSTALLATION				CONTRAC	CT NO. 67	G14
De	efault	PLOT DATE = 10/12/2018	DATE - 10/12/2018	REVISED -		SCALE: NTS SHEET 1 OF 1 SHEETS STA. TO STA.		TO STA.		ILLINOIS FED. A	ID PROJECT		

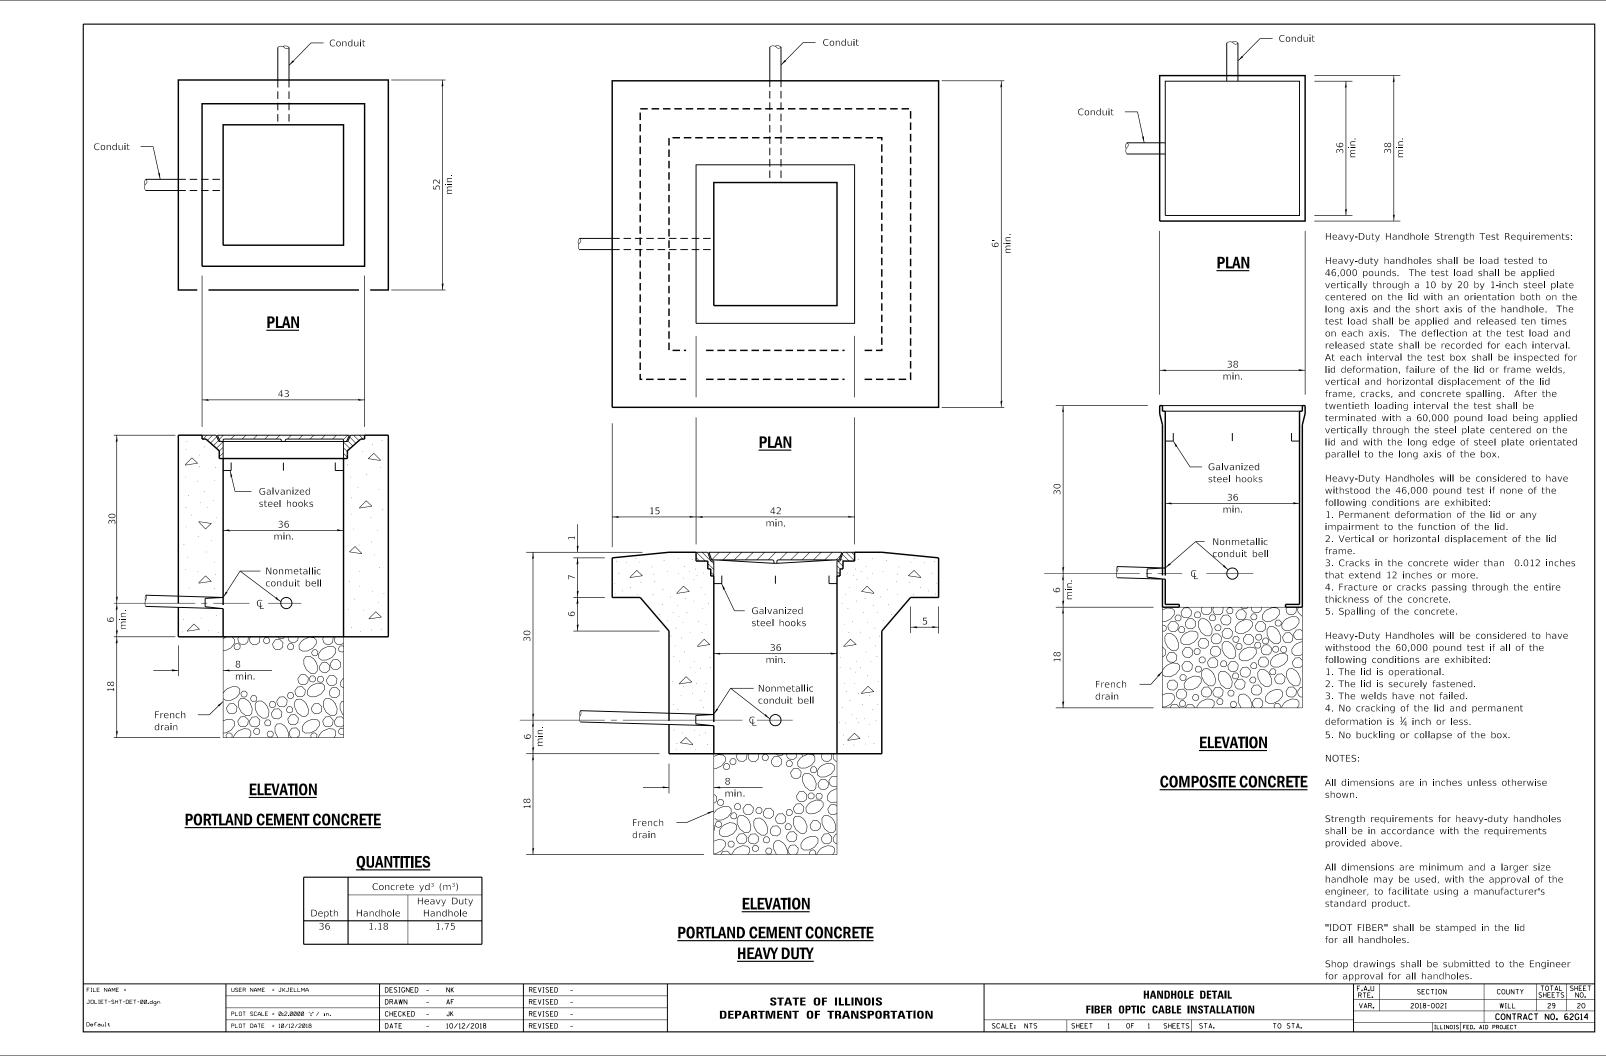

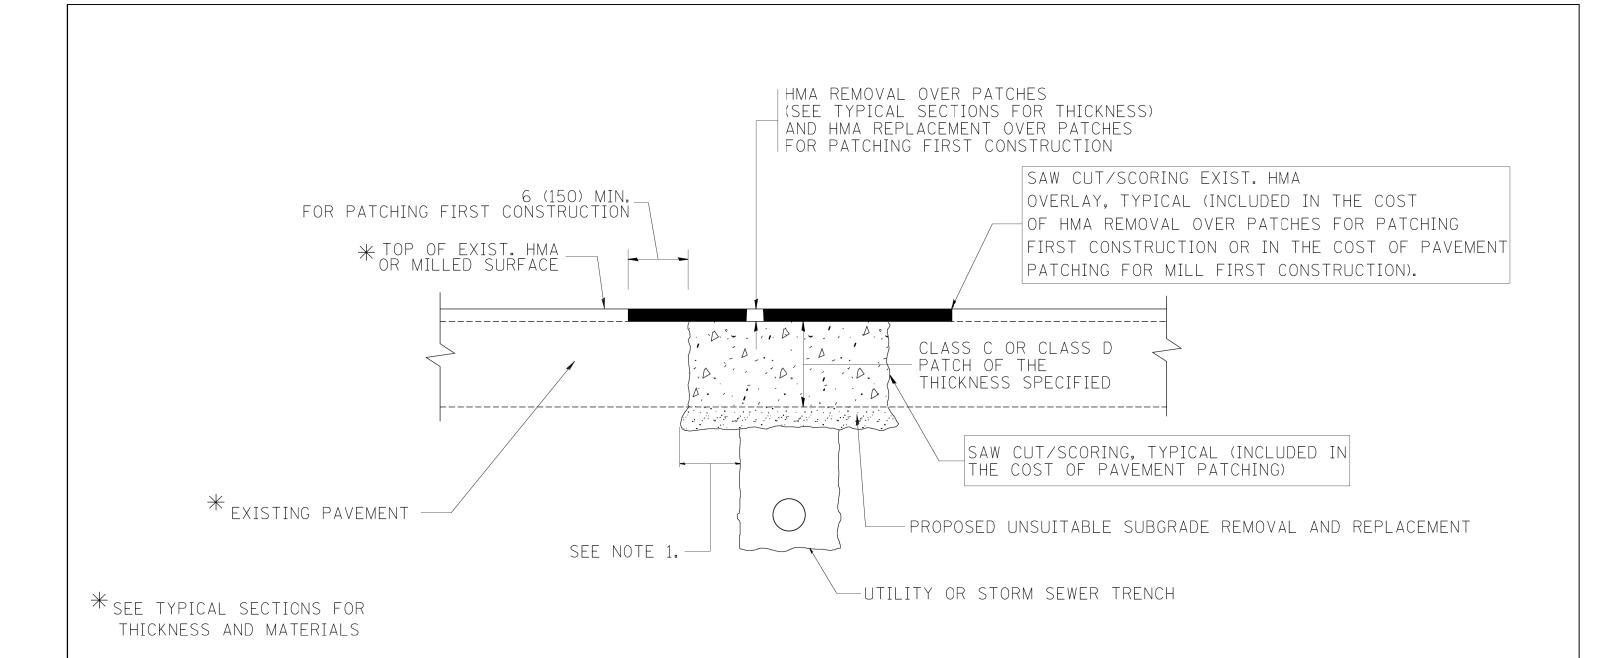

## NOTES:

- 1. THE WIDTH OF THE FULL DEPTH PATCH OVER A TRENCH SHALL BE 12 (300) WIDER ON EACH SIDE OF THE TRENCH.
- 2. FOR METHOD OF MEASUREMENT AND BASIS OF PAYMENT, SEE RECURRING SPECIAL PROVISION "PATCHING WITH HOT-MIX ASPHALT OVERLAY REMOVAL".

## SEQUENCE OF CONSTRUCTION (PATCHING FIRST)


- 1. REMOVE THE EXISTING HMA MATERIAL OVER THE AREA TO BE PATCHED.
- 2. REMOVE AND REPLACE WITH CLASS C OR D PATCH.
- 3. REPLACE HMA MATERIAL OVER THE AREA TO BE PATCHED.

## SEQUENCE OF CONSTRUCTION (MILLING FIRST)

- 1. MILL HMA FIRST IF THERE IS AT LEAST 41/2 INCHES OR MORE OF HMA MATERIAL ON TOP OF THE EXISTING PAVEMENT OR IF THE PAVEMENT IS FULL DEPTH HMA. A MINIMUM OF 2 INCHES OF HMA MATERIAL SHALL BE IN PLACE AFTER MILLING.
- 2. REMOVE AND REPLACE WITH FULL DEPTH CLASS D PATCHES TO TOP OF MILLED SURFACE.

ALL DIMENSIONS ARE IN INCHES (MILLIMETERS) UNLESS OTHERWISE SHOWN.

FILE NAME =	USER NAME = bauerdl	DESIGNED - R. SHAH	REVISED - A. ABBAS 04-27-98			PAVEMENT PATCHING FOR		RTE.	SECTION	COUNTY	SHEETS NO.
c:\projects\diststd22x34\bd22.dgn		DRAWN -	REVISED - R. BORO 01-01-07	STATE OF ILLINOIS				VAR.	2018-0021	WILL	29 21
	PLOT SCALE = 50.000 '/ IN.	CHECKED -	REVISED - R. BORO 09-04-07	DEPARTMENT OF TRANSPORTATION		HMA SURFACED PAVEMENT			D400-04 (BD-22)	CONTRAC	CT NO. 62G14
	PLOT DATE = 10/27/2008	DATE - 10-25-94	REVISED - K. ENG 10-27-08		SCALE: NONE	SHEET NO. 1 OF 1 SHEETS STA.	TO STA.	FED. ROAD		AID PROJECT	

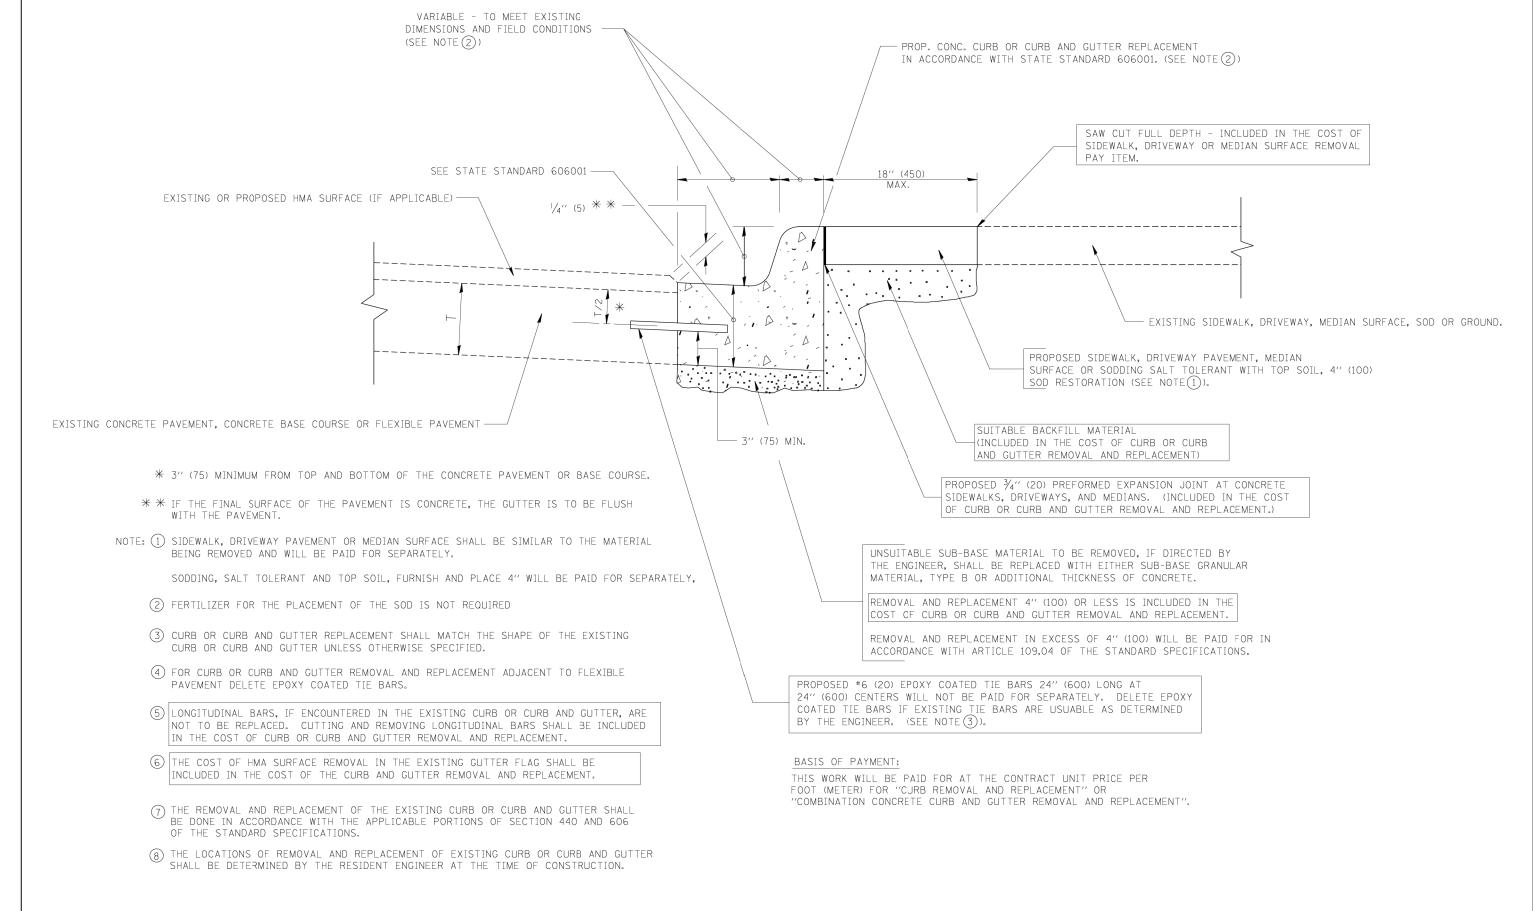

## CURB OR CURB AND GUTTER REMOVAL AND REPLACEMENT


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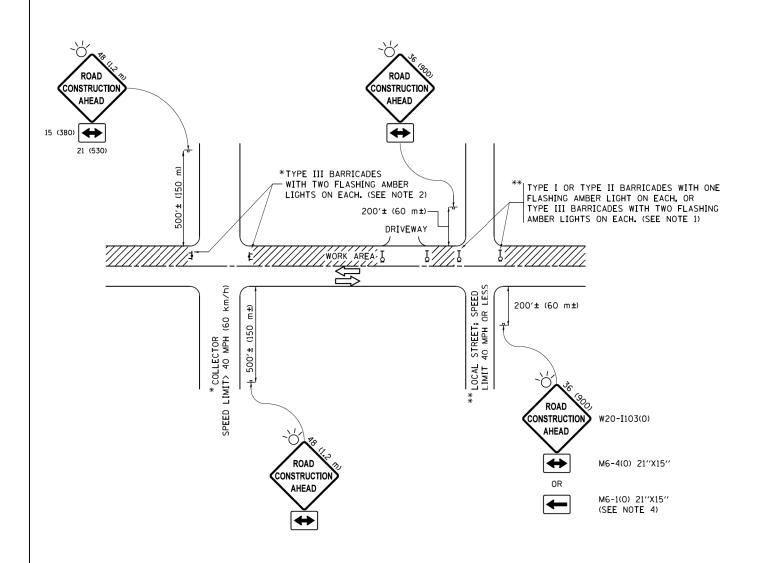
ALL DIMENSIONS ARE IN INCHES (MILLIMETERS) UNLESS OTHERWISE SHOWN.

FILE NAME =	USER NAME = drivakosgn	DESIGNED - A. HOUSEH	REVISED -	R. SHAH 10-03-96
c:\pw_work\pwidot\drivakosgn\d0108315\bd	24.dgn	DRAWN -	REVISED -	A. ABBAS 03-21-97
PLOT SCALE = 50.000 ' / IN.		CHECKED -	REVISED -	M. GOMEZ 01-22-01
	PLOT DATE = 12/15/2009	DATE - 03-11-94	REVISED -	R. BORO 12-15-09

STATE OF ILLINOIS
DEPARTMENT OF TRANSPORTATION

CURB OR C	URB AN	D GUTTER		F.A.U. RTE.	SECTION	COUNTY	TOTAL SHEETS	SHEE'
				VAR.	2018-002I	WILL	29	22
REMOVAL AND REPLACEMENT					BD600-06 (BD-24)	CONTRACT	NO. (	52G14
SHEET NO. 1 OF 1	SHEETS	STA.	TO STA.	FFD. R	OAD DIST, NO. 1 ILLINOIS FED. A	D PROJECT		



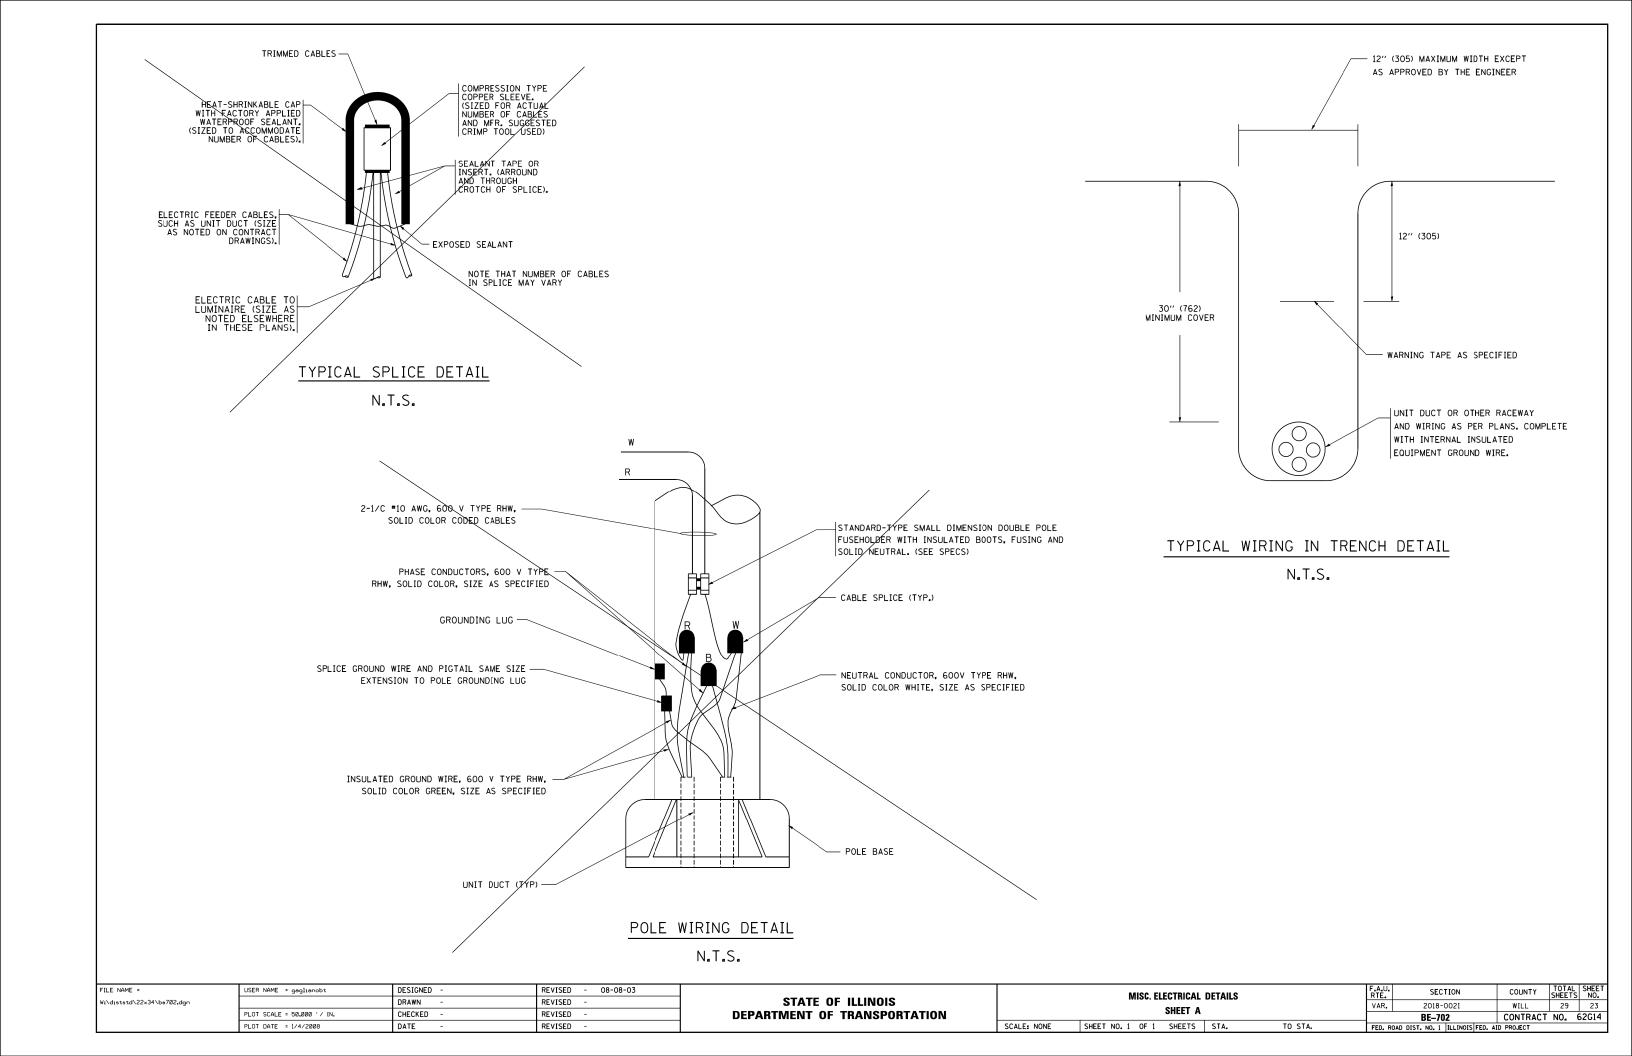

## **NOTES:**

- SIDE ROAD WITH A SPEED LIMIT OF 40 MPH (60 km/h) OR LESS AS SHOWN ON THE DRAWING AND AS DIRECTED BY THE ENGINEER:
  - a) ONE "ROAD CONSTRUCTION AHEAD" SIGN 36 x 36 (900x900) WITH A FLASHER MOUNTED ON IT APPROXIMATELY 200" (60 m) IN ADVANCE OF THE MAIN ROUTE.
  - b) THE CLOSED PORTION OF THE MAIN ROUTE SHALL BE PROTECTED BY BLOCKING WITH TYPE I, TYPE II OR TYPE III BARRICADES, 1/3 OF THE CROSS SECTION OF THE CLOSED PORTION.
- 2. SIDE ROAD WITH A SPEED LIMIT GREATER THAN 40 MPH (60 km/h) AS SHOWN ON THE DRAWING AND AS DIRECTED BY THE ENGINEER:
  - a) ONE "ROAD CONSTRUCTION AHEAD" SIGN 48 x 48 (1.2 m x 1.2 m) WITH A FLASHER MOUNTED ON IT APPROXIMATELY 500" (150 m) IN ADVANCE OF THE MAIN ROUTE.
  - b) THE CLOSED PORTION OF THE MAIN ROUTE SHALL BE PROTECTED BY BLOCKING WITH TYPE III BARRICADES, 1/2 OF THE CROSS SECTION OF THE CLOSED PORTION.
- 3. CONES MAY BE SUBSTITUTED FOR BARRICADES OR DRUMS AT HALF THE SPACING DURING DAY OPERATIONS. CONES SHALL BE A MINIMUM OF 28 (710)
- 4. WHEN THE SIDE ROAD LIES BETWEEN THE BEGINNING OF THE MAINLINE SIGNING AND THE WORK ZONE, A SINGLE HEADED ARROW (M6-1) SHALL BE USED IN LIEU OF THE DOUBLE HEADED ARROW (M6-4).

SCALE: NONE

- 5. WHEN WORK IS BEING PERFORMED ON A SIDE ROAD OR DRIVEWAY, FOLLOW THE APPLICABLE STANDARD(S). THE DIRECTIONAL ARROW (M6-1 OR M6-4) SHALL BE COVERED OR REMOVED WHEN NO LONGER CONSISTENT WITH THE TRAFFIC CONTROL SET-UP.
- 6. ADVANCE WARNING SIGNS ARE TO BE OMITTED ON DRIVEWAYS UNLESS OTHERWISE SPECIFIED IN THE PLANS OR BY THE ENGINEER
- 7. THE TRAFFIC CONTROL AND PROTECTION FOR SIDE ROADS, INTERSECTIONS, AND DRIVEWAYS SHALL BE INCLUDED IN THE COST OF SPECIFIED TRAFFIC CONTROL STANDARDS OR ITEMS.


All dimensions are in inches (millimeters) unless otherwise shown.

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pw:\\ILØ84EBIDINTEG.:ll:no:s.gov:PWIDOT\Do	cuments\IDOT Offices\District 1\Projects\Dist	Gt <b>DR'AWM</b> \CADD <del>o</del> to\CADsheets\tc10.dgn	REVISED	-T. RAMMACHER 01-06-00
	PLOT SCALE = 50.000 ' / in.	CHECKED -	REVISED	- A. SCHUETZE 07-01-13
Default	PLOT DATE = 9/15/2016	DATE - 06-89	REVISED	- A. SCHUETZE 09-15-16

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DEPARTMENT	<b>OF</b>	TRANSPORTATION


TRAFFIC CONTROL AND PROTECTION FOR						RTE.	
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31	DE HOADS	, IIII LIIO	LOTION	, AND	DIIIVEVVAIO		
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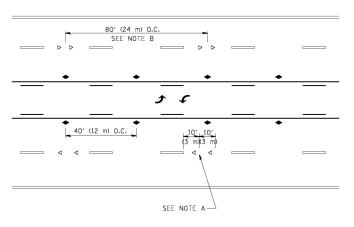
	I	LLINOIS FE	D. Al	D PROJECT		
TC-10				CONTRACT	NO. 6	52G14
VAR.	2018-00		WILL	29	24	
RTE.	SECTI	ON		COUNTY	SHEETS	NO.

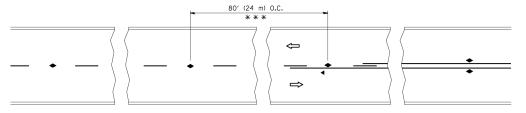


\*\*\* REDUCE TO 40' (12 m) O.C. ON CURVES WITH POSTED OR ADVISORY SPEED 45 M.P.H. (70 km/h) OR LESS.

### TWO-LANE/TWO-WAY




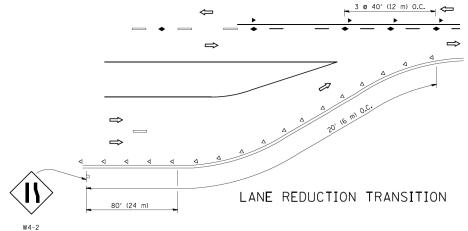

TWO-WAY LEFT TURN

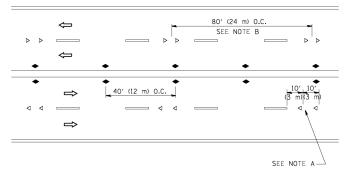

MULTI-LANE/UNDIVIDED

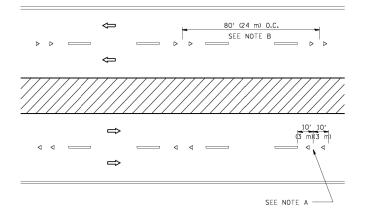

MULTI-LANE/DIVIDED

## GENERAL NOTES

- MARKERS USED WITH DASHED LINES SHALL BE CENTERED IN THE GAP BETWEEN SEGMENTS.
- 2. MARKERS USED ADJACENT TO SOLID LINES SHALL BE OFFSET 2 TO 3 (50 TO 75) TOWARD TRAFFIC AS SHOWN.
- 3. MARKERS THROUGH TANGENTS LESS THAN 500' (150 m) IN LENGTH BETWEEN CURVES SHALL BE INSTALLED AT THE LESSER OF THE TWO CURVE SPACINGS.

### LANE MARKER NOTES

A. USE DOUBLE LANE LINE MARKERS SPACED AS SHOWN.

B. REDUCE TO 40' (12 m) O.C. ON CURVES WHERE ADVISORY SPEEDS ARE 10 M.P.H (20 km/h) LOWER THAN POSTED SPEEDS.

## SYMBOLS

---- YELLOW STRIPE

---- WHITE STRIPE

- ONE-WAY AMBER MARKER
- ONE-WAY CRYSTAL MARKER (₩/0)
- ◆ TWO-WAY AMBER MARKER

## DESIGN NOTES


- 1. DOUBLE LANE LINE MARKERS SHALL BE USED UNLESS SPECIFIED OTHERWISE.
- EXCEPT AS SHOWN ON THE LANE REDUCTION TRANSITION AND FREEWAY EXIT RAMP DETAIL, MARKERS ARE NOT TO BE SPECIFIED ON RIGHT EDGE LINES.
- 3. THE EXACT MARKER LIMITS, SPACING, AND COLOR SHALL BE INCLUDED IN THE PLANS WHEN STANDARD SPECIFICATIONS ARE NOT BEING USED.
- 4. MARKERS SHOULD NOT BE USED ALONGSIDE CURBS EXCEPT FOR EXTREMELY SHORT SECTIONS OF CURBS WHERE NOT MORE THAN TWO MARKERS WOULD BE INVOLVED.

## 

LEFT TURN

All dimensions are in inches (millimeters) unless otherwise shown.

FILE NAME =	USER NAME = leysa	DESIGNED -	REVISED -T. RAMMACHER 09-19-94		TYPICAL APPLICATIONS	RTF.	SECTION	COUNTY SHEETS	L SHEET
c:\pw_work\pwidot\leysa\d0108315\tc11.dgn		DRAWN -	REVISED -T. RAMMACHER 03-12-99	STATE OF ILLINOIS		VAR.	2018-0021	WILL 29	25
	PLOT SCALE = 50.000 '/ IN.	CHECKED -	REVISED -T. RAMMACHER 01-06-00	DEPARTMENT OF TRANSPORTATION	RAISED REFLECTIVE PAVEMENT MARKERS (SNOW-PLOW RESISTANT)		TC-11	CONTRACT NO.	62G14
	PLOT DATE = 3/2/2011	DATE -	REVISED - C. JUCIUS 09-09-09		SCALE: NONE SHEET NO. 1 OF 1 SHEETS STA. TO STA.	FED. ROAD	DIST. NO. 1 ILLINOIS FED.	. AID PROJECT	

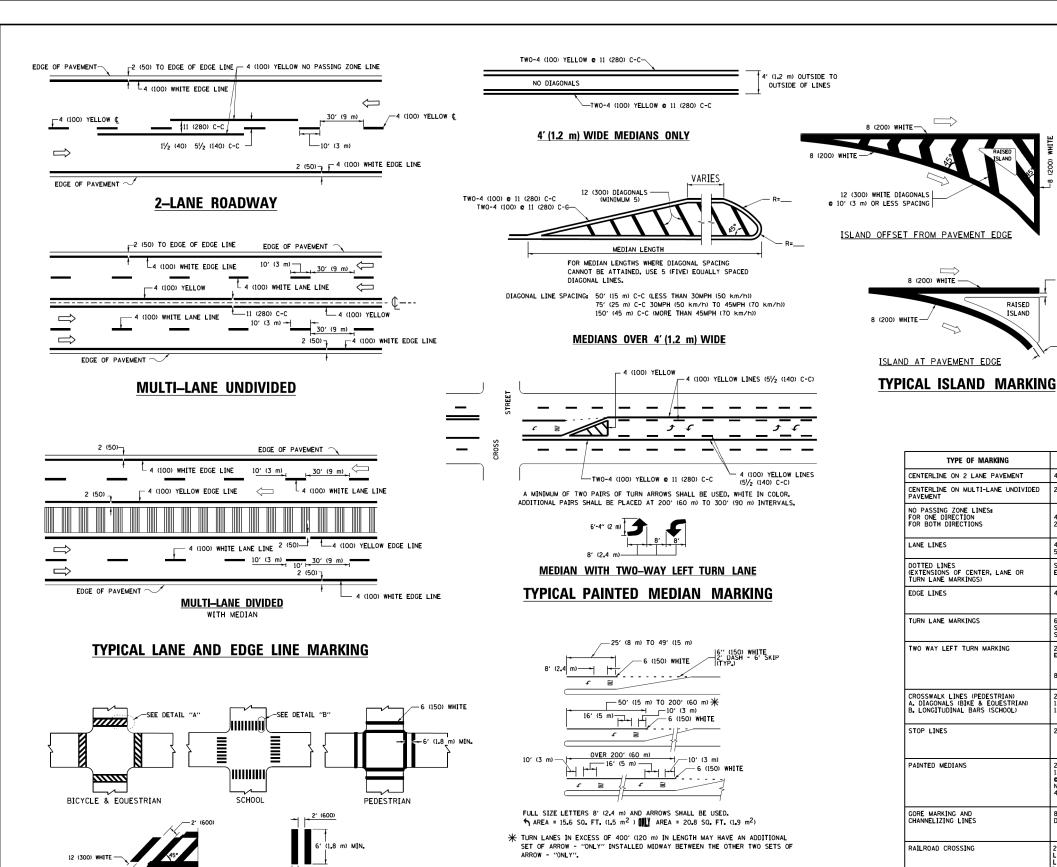

TYPICAL LEFT (OR RIGHT) TURN LANE

TYPICAL TURN LANE MARKING

665 750 40 (1020) **COMBINATION** LEFT AND U-TURN 5'-4" (1620) √ 32 R (810)

## LANE REDUCTION TRANSITION

SPEED LIMIT

30

55

\* LANE REDUCTION ARROWS REQUIRED AT SPEEDS OF 45 MPH OF GREATER OR WHEN SPECIFIED IN PLANS.

TYPE OF MARKING	WIDTH OF LINE	PATTERN	COLOR	SPACING /REMARKS
CENTERLINE ON 2 LANE PAVEMENT	4 (100)	SKIP-DASH	YELLOW	10' (3 m) LINE WITH 30' (9 m) SPACE
CENTERLINE ON MULTI-LANE UNDIVIDED PAVEMENT	2 @ 4 (100)	SOLID	YELLOW	11 (280) C-C
NO PASSING ZONE LINES: FOR ONE DIRECTION FOR BOTH DIRECTIONS	4 (100) 2 <b>c</b> 4 (100)	SOLID SOLID	YELLOW YELLOW	5½ (140) C-C FROM SKIP-DASH CENTERLINE 11 (280) C-C OMIT SKIP-DASH CENTERLINE BETWEEN
LANE LINES	4 (100) 5 (125) ON FREEWAYS	SKIP-DASH SKIP-DASH	WHITE WHITE	10' (3 m) LINE WITH 30' (9 m) SPACE
DOTTED LINES (EXTENSIONS OF CENTER, LANE OR TURN LANE MARKINGS)	SAME AS LINE BEING EXTENDED	SKIP-DASH	SAME AS LINE BEING EXTENDED	2' (600) LINE WITH 6' (1.8 m) SPACE
EDGE LINES	4 (100)	SOLID	YELLOW-LEFT WHITE-RIGHT	OUTLINE MEDIANS IN YELLOW
TURN LANE MARKINGS	6 (150) LINE; FULL SIZE LETTERS & SYMBOLS (8' (2.4m))	SOLID	WHITE	SEE TYPICAL TURN LANE MARKING DETAIL
TWO WAY LEFT TURN MARKING	2 @ 4 (100) EACH DIRECTION 8' (2.4m) LEFT ARROW	SKIP-DASH AND SOLID IN PAIRS	YELLOW	10' (3 m) LINE WITH 30' (9 m) SPACE FOR SKIP-DASH; 5½ (140) C-C BETWEEN SOLID LINE AND SKIP-DASH LINE SEE TYPICAL TWO-WAY LEFT TURN MARKING DETAIL
CROSSWALK LINES (PEDESTRIAN) A. DIAGONALS (BIKE & EQUESTRIAN) B. LONGITUDINAL BARS (SCHOOL)	2 <b>e</b> 6 (150) 12 (300) <b>e</b> 45° 12 (300) <b>e</b> 90°	SOLID SOLID SOLID	WHITE WHITE WHITE	NOT LESS THAN 6' (1.8 m) APART 2' (600) APART 2' (600) APART 2' (600) APART SEE TYPICAL CROSSWALK MARKING DETAILS.
STOP LINES	24 (600)	SOLID	WHITE	PLACE 4' (1.2 m) IN ADVANCE OF AND PARALLEL TO CROSSWALK, IF PRESENT; OTHERNISE, PLACE AT DESIRED STOPPING POINT. PARALLEL TO CROSSROAD CENTERLINE, WHERE POSSIBLE
PAINTED MEDIANS	2 © 4 (100) WITH 12 (300) DIAGONALS © 45° NO DIAGONALS USED FOR 4' (1.2 m) WIDE MEDIANS	SOLID	YELLOW: TWO WAY TRAFFIC WHITE: ONE WAY TRAFFIC	11 (280) C-C FOR THE DOUBLE LINE SEE TYPICAL PAINTED MEDIAN MARKING.
CORE MARKING AND CHANNELIZING LINES	8 (200) WITH 12 (300) DIAGONALS @ 45°	SOLID	WHITE	DIAGONALS: 15' (4,5 m) C-C (LESS THAN 30MPH (50 km/h)) 20' (6 m) C-C 30MPH (50 km/h) T0 45MPH (70 km/h)) 30' (9 m) C-C (OVER 45MPH (70 km/h))
RAILROAD CROSSING	24 (600) TRANSVERSE LINES; "RR" IS 6' (1.8 m) LETTERS; 16 (400) LINE FOR "X"	SOLID	WHITE	SEE STATE STANDARD 780001 AREA OF: "R"*33.6 SQ. FT. (0.33 m²) EACH "X"=54.0 SQ. FT. (5.0 m²)
SHOULDER DIAGONALS (REQUIRED FOR SHOULDERS > 8')	12 (300) <b>e</b> 45°	SOLID	WHITE - RIGHT YELLOW - LEFT	50' (15 m) C-C (LESS THAN 30MPH (50 km/h)) 75' (25 m) C-C (30 MPH (50 km/h) T0 45MPH (70 km/h)) 150' (45 m) C-C (0VER 45MPH (70 km/h))
U TURN ARROW	SEE DETAIL	SOLID	WHITE	16 <sub>*</sub> 3 SF
2 ARROW COMBINATION LEFT AND U TURN	SEE DETAIL	SOLID	WHITE	30.4 SF

**U-TURN** 

FOR FURTHER DETAILS ON PAVEMENT MARKING REFER TO STANDARD SPECIFICATIONS FOR ROAD AND BRIDGE CONSTRUCTION AND STATE STANDARD 780001.

8 (200) WHITE -

RAISED

2 (50)

unless otherwise shown.

FILE NAME =	USER NAME = leysa	DESIGNED - EVERS	REVISED -	C. JUCIUS 09-09-09
W:\diststd\22x34\tcl3.dgn		DRAWN -	REVISED -	C. JUCIUS 07-01-13
	PLOT SCALE = 50.000 ' / in.	CHECKED -	REVISED -	C. JUCIUS 12-21-15
Default	PLOT DATE = 6/23/2017	DATE - 03-19-90	REVISED -	C. JUCIUS 04-12-16

TYPICAL CROSSWALK MARKING

 $oldsymbol{st}$  markings shall be installed parallel to the centerline of the road which it crosses

-12 (300) WHITE


DETAIL "B"

-6 (150) WHITE


DETAIL "A"


STATE OF ILLINOIS **DEPARTMENT OF TRANSPORTATION** 

SECTION COUNTY DISTRICT ONE 2018-0021 WILL TYPICAL PAVEMENT MARKINGS TC-13 CONTRACT NO. 62G14 SHEET 1 OF 1 SHEETS STA. TO STA. SCALE: NONE

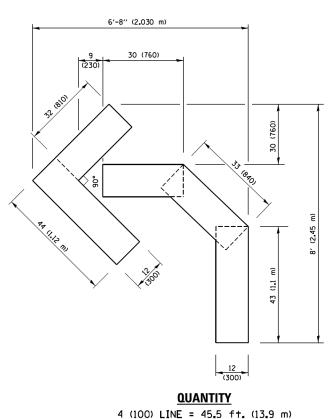


## 4 (100) LINE = 45.5 ft. (13.9 m) 15.2 sq. ft. (1.41 sq. m)

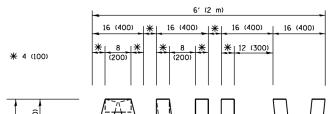

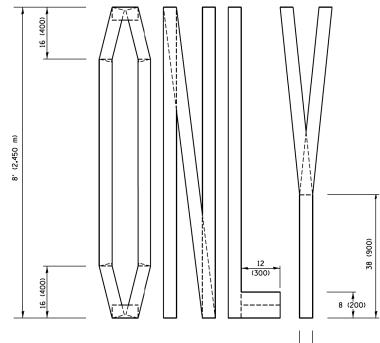

4 (100) LINE = 64.1 ft. (19.5 m) 21.4 sq. ft. (1.99 sq. m)

QUANTITY

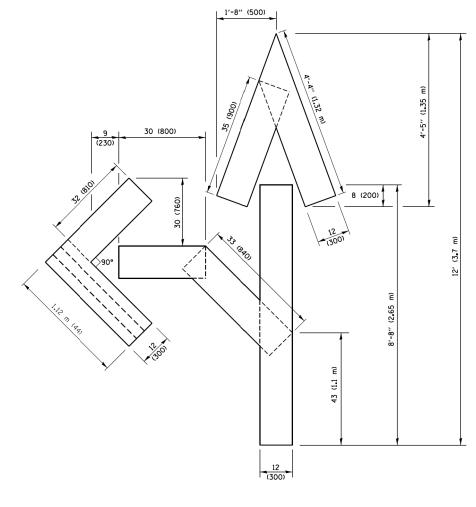


## QUANTITY

4 (100) LINE = 82.5 ft. (25.1 m) 27.5 sq. ft. (2.53 sq. m)

## NOTE:

ALL QUANTITIES OF PLACEMENT ARE REPRESENTED IN LINEAR FEET OF 4" LINES TO MATCH THE 4" TEMPORARY TAPE PAY ITEM AND REPRESENTS THE TOTAL QUANTITY OF 4" TAPE REQUIRED.

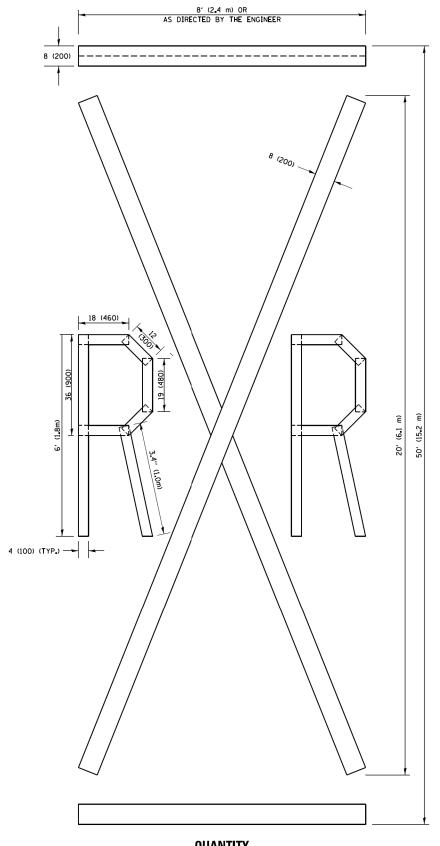

## QUANTITY

4 (100) LINE = 225.9 ft. (68.9 m) 75.3 sq. ft. (6.99 sq. m)


> All dimensions are in inches (millimeters) unless otherwise shown.

FILE NAME =	USER NAME = footemj	DESIGNED -	REVISED	-T. RAMMACHER 03-02-98
pw:\\ILØ84EBIDINTEG.:ll1no1s.gov:PWIDOT\Do	cuments\IDOT Offices\District 1\Projects\Dist	t <b>DRAWM</b> \CADData\CADsheets\tc16.dgn	REVISED	-E. GOMEZ 08-28-00
	PLOT SCALE = 50.0000 '/ in.	CHECKED -	REVISED	-E. GOMEZ 08-28-00
	PLOT DATE = 9/15/2016	DATE - 09-18-94	REVISED	- A. SCHUFTZF 09-15-16

STATE OF ILLINOIS **DEPARTMENT OF TRANSPORTATION** 

/AD	
/AR.	201
	TC-
En pr	DAD DIST. NO.
-	ED. RO

COUNTY TOTAL SHEETS NO.
WILL 29 27
CONTRACT NO. 62G14 SECTION 018-002I C-16 FED. ROAD DIST. NO. 1 ILLINOIS FED. AID PROJECT

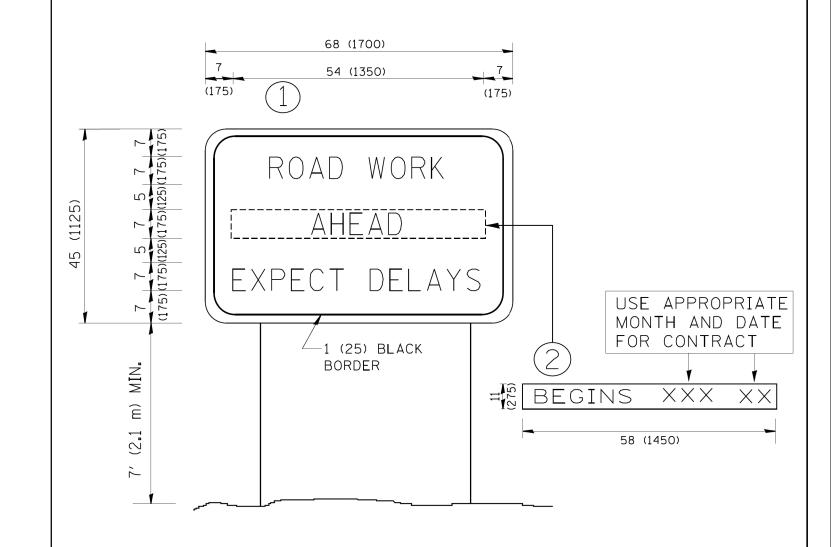


## NOTES:

- 1. USE BLACK LETTERING ON ORANGE BACKGROUND.
- 2. ERECT SIGNS IN ADVANCE OF THE LOCATION FOR THE "ROAD CONSTRUCTION AHEAD" SIGN AT LOCATIONS AS DIRECTED BY THE ENGINEER.
- 3. ERECT SIGN () WITH INSTALLED PANEL (2) ONE WEEK PRIOR TO THE START OF CONSTRUCTION.
- 4. REMOVE PANEL (2) SOON AFTER THE START OF CONSTRUCTION.
- 5. SEE SPECIAL PROVISION FOR "TEMPORARY INFORMATION SIGNING" FOR ADDITIONAL INFORMATION.
- 6. ONE SIGN ASSEMBLY EQUALS 25.70 SQ. FT. (2.3 SQ. M.)
- 7. SHALL BE PAID FOR AS TEMPORARY INFORMATION SIGNING.

ALL DIMENSIONS ARE IN INCHES (MILLIMETERS) UNLESS OTHERWISE SHOWN.

F	ILE NAME =	USER NAME = gaglianobt	DESIGNED -	REVISED - R. MIRS 09-15-97	·	APTICIAL DOAD	F.A.U.	SECTION	COLINITY	TOTAL S	HEET
٧	V:\diststd\22x34\tc22.dgn		DRAWN -	REVISED - R. MIRS 12-11-97	STATE OF ILLINOIS	ARTERIAL ROAD	VAR.	2018-0021	WILL	29	28
		PLOT SCALE = 50.000 '/ IN.	CHECKED -	REVISED -T. RAMMACHER 02-02-99	DEPARTMENT OF TRANSPORTATION	INFORMATION SIGN		TC-22	CONTRACT	NO. 67	2G14
		PLOT DATE = 1/4/2008	DATE -	REVISED - C. JUCIUS 01-31-07		SCALE: NONE SHEET NO. 1 OF 1 SHEETS STA. TO STA.	FED. ROAD DIS				

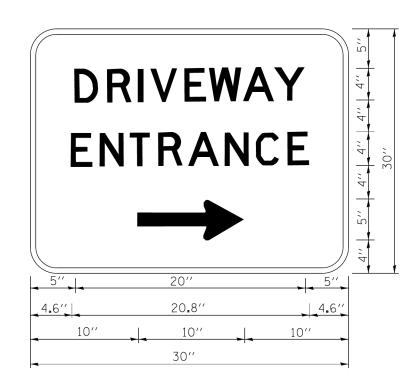

3.0" RADIUS, 0.5" BORDER, WHITE ON GREEN; REFLECTORIZED "DRIVEWAY" D; "ENTRANCE" D; STANDARD ARROW CUSTOM 12.0" x 5.0"

## NOTES:

- 1. HALF OF THE SIGNS WILL REQUIRE A LEFT HAND FACING ARROW.
- 2. TWO SIGNS SHALL BE USED AT EACH COMMERCIAL ENTRANCE PLACED BACK-TO-BACK: ONE WITH A RIGHT HAND ARROW (SHOWN) SHALL BE PLACED ON THE NEAR RIGHT SIDE THE DRIVEWAY AND ONE WITH A LEFT HAND ARROW SHALL BE PLACED ON THE FAR LEFT SIDE OF THE DRIVEWAY.
- 3. SIGNS TO BE PAID FOR AS ITEM "TEMPORARY INFORMATION SIGNING".

FILE NAME =	USER NAME = gaglianobt	DESIGNED -	REVISED - C. JUCIUS 02-15-07
c:\pw_work\pwidot\gaglianobt\d0108315\tc	26 <b>.</b> dgn	DRAWN -	REVISED -
	PLOT SCALE = 50.000 ' / in.	CHECKED -	REVISED -
	PLOT DATE = 12/13/2012	DATE -	REVISED -

STATE OF ILLINOIS	
DEPARTMENT OF TRANSPORTATION	

SCALE: NONE

DRIVEWAY ENTRANCE SIGNING				F.A.U. RTE.	SECTION	COUNTY	TOTAL SHEETS	SHEET NO.	
				VAR.	2018-0021	WILL	29	29	
						TC-26	CONTRACT	NO.	52G14
	SHEET NO. 1 OF 1	SHEETS	STA.	TO STA.	FED. R	FED. ROAD DIST. NO. 1 ILLINOIS FED. AID PROJECT			