
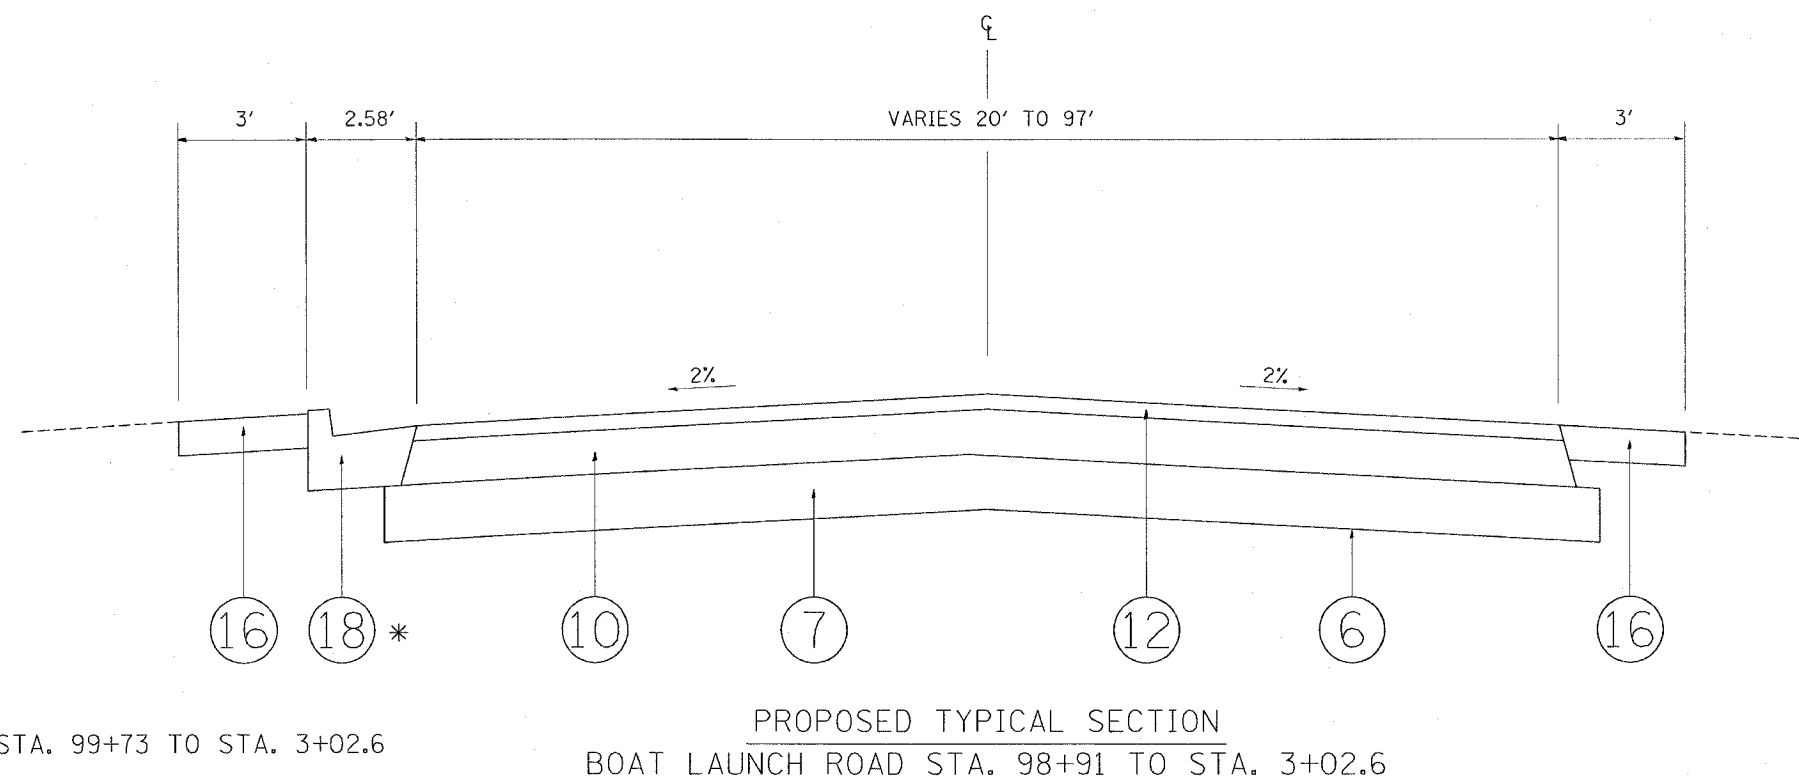


F.A.I. RTE.	SECTION	COUNTY	TOTAL SHEETS	SHEET NO.
* 2004-025	RS	LAKE	116	15
FED. ROAD DIST. NO.	ILLINOIS	FED. AID PROJECT		
* PARK ROADS	IDNR File No. 2-03-025 D91-191-04			

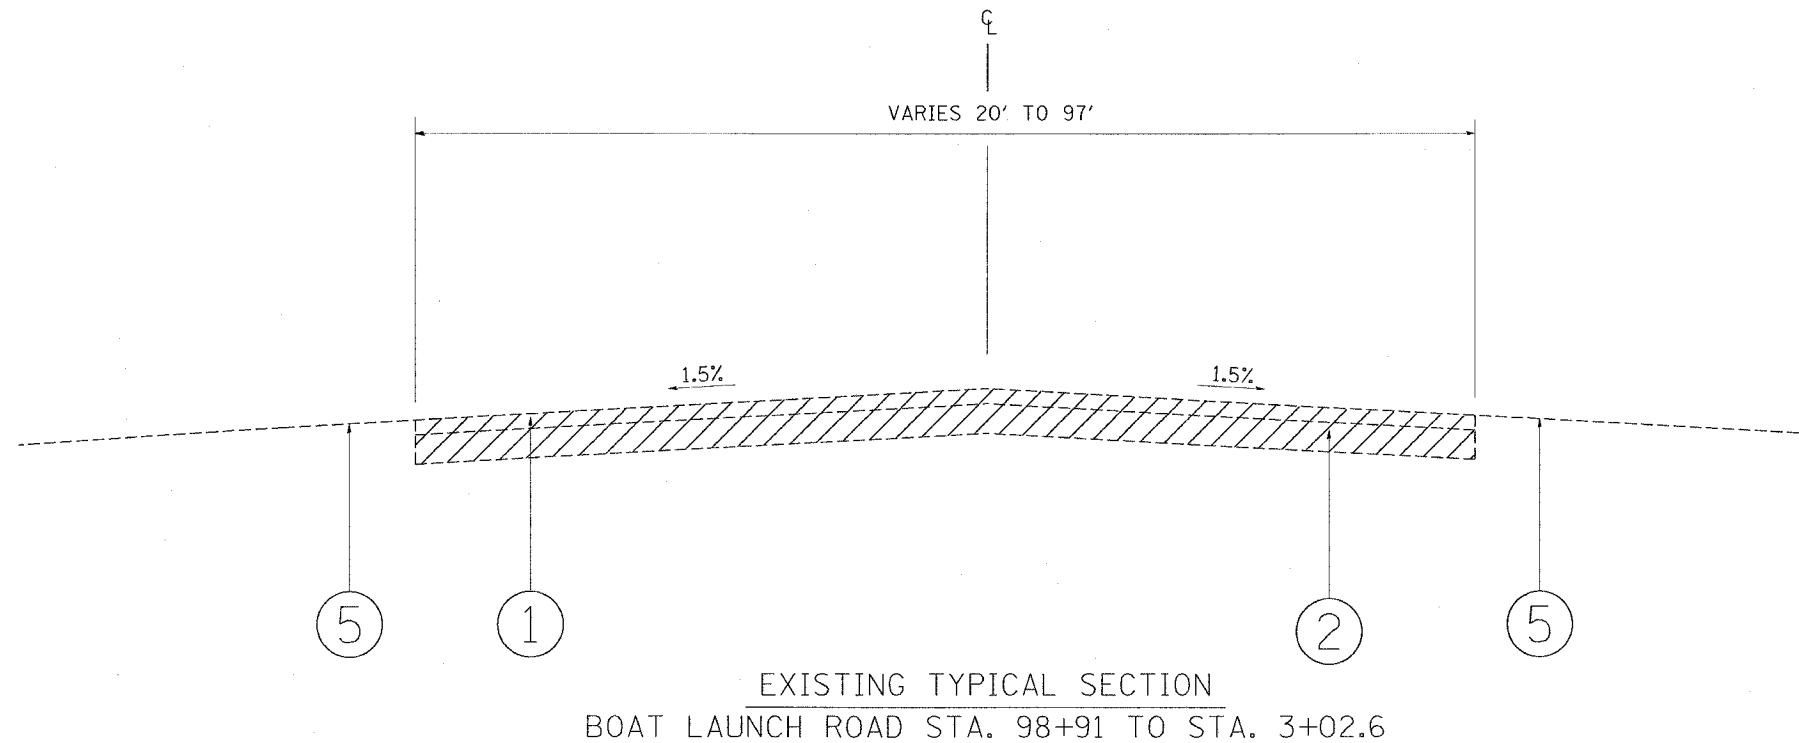

\* STA. 99+73 TO STA. 3+02.6

**LEGEND**

- ① EXISTING BITUMINOUS PAVEMENT, 3"
  - ② EXISTING AGGREGATE BASE COURSE, 6"
  - ③ EXISTING BITUMINOUS SHOULDER
  - ④ EXISTING AGGREGATE SHOULDER
  - ⑤ EXISTING GROUND COVER
  - ⑥ PROPOSED GEOTECHNICAL FABRIC
  - ⑦ PROPOSED AGGREGATE SUBGRADE, 12"
  - ⑧ PROPOSED SUB-BASE GRANULAR MATERIAL, TYPE B, 6"
  - ⑨ PROPOSED BITUMINOUS BASE COURSE, SUPERPAVE, 6"
  - ⑩ PROPOSED BITUMINOUS BASE COURSE, SUPERPAVE, 7 1/2"
  - ⑪ PROPOSED POLYMERIZED LEVELING BINDER (MACHINE METHOD) SUPERPAVE, IL-4.75, N50, 3/4"
  - ⑫ PROPOSED BITUMINOUS CONCRETE SURFACE COURSE, SUPERPAVE, MIX "D", N50, 1 1/2"
  - ⑬ PROPOSED BITUMINOUS SHOULDER, SUPERPAVE, 8"
  - ⑭ PROPOSED AGGREGATE SHOULDER, 8"
  - ⑮ PROPOSED AGGREGATE SHOULDER, TYPE B
  - ⑯ PROPOSED TOPSOIL FURNISH AND PLACE, 4" (SPECIAL), SEEDING, CLASS 4A (MODIFIED), EROSION CONTROL BLANKET (SPECIAL)
  - ⑰ PROPOSED CONCRETE SHOULDER
  - ⑱ PROPOSED CONCRETE CURB AND GUTTER, TYPE B-6.24
  - ⑲ SLOTTED DRAIN
- HMA - HOT MIX ASPHALT

REVISIONS	
NAME	DATE

ILLINOIS DEPARTMENT OF TRANSPORTATION  
PARK ROADS  
ILLINOIS BEACH STATE PARK  
NORTH POINT MARINA  
TYPICAL SECTIONS

SCALE: VERT.  
HORIZ.  
DATE

DRAWN BY: CDT  
CHECKED BY

PLOT DATE = 11/27/2006  
 PLOT NAME = I:\PROJECTS\2004\025\RS\LAKE\DESIGN\ROADS\TYPICAL\TYPICAL.DWG  
 PLOT SCALE = 1/8" = 1'-0"  
 REFERENCE = REF