FOR INDEX OF SHEETS, SEE SHEET NO. 2 01-19-2024 LETTING ITEM 053 FOR LIST OF HIGHWAY STANDARDS SEE SHEET NO. 2

STATE OF ILLINOIS **DEPARTMENT OF TRANSPORTATION** 

# PLANS FOR PROPOSED FEDERAL-AID HIGHWAY

WINN ROAD (FAU 0157) FROM MAIN STREET TO ILLINOIS RTE 173 RESURFACING

> **SECTION: 21–00018–00–RS** PROJECT NO.: ZBWA(049) **VILLAGE OF SPRING GROVE MCHENRY COUNTY** C-91-138-22

> > PROJECT LOCATION MAP N.T.S.


ILLINOIS RTE 173 ENGLISH PRAIRIE RD LBRENTWOOD DR PROJECT ENDS STA 142+61.00 **PROJECT BEGINS** STA 10 + 42.61 THELEN GROVE PARK PARK E SOLON RD WISCONSIN SOUTHERN RA RICHMOND TOWNSHIP

PROJECT LENGTH

NET LENGTH OF PROJECT = 13.218 FT. = 2.50 MILES GROSS LENGTH OF PROJECT = 13,218 FT. = 2.50 MILES

McHENRY 20 1 21-00018-00-RS 0157 FED. ROAD DIST. NO 1 | ILLINOIS | CONTRACT NO. 61/98



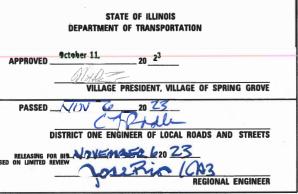




1391 CORPORATE DRIVE, SUITE 203 | McHENRY, ILLINOIS 60050 815.385.1778 | Toll Free: 800.728.7805 | Fax: 815.385.1778 | HRGre ILLINOIS PROFESSIONAL DESIGN FIRM #184-001322

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**HIGHWAY CLASSIFICATION** WINN ROAD - MAJOR COLLECTOR

TRAFFIC DATA 2021 ADT **WINN ROAD - 3,800** 

POSTED & DESIGN SPEED LIMIT WINN ROAD - 45 MPH

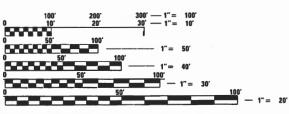

ENGINEERING SCALES. REDUCED SIZED PLANS WILL NOT CONFORM TO STANDARD SCALES, IN MAKING MEASUREMENTS ON REDUCED PLANS, THE ABOVE SCALES MAY BE USED.

JOINT UTILITY LOCATION INFORMATION FOR EXCAVATION

1-800-892-0123 OR 811

CONTRACT NO. 61J98

E. RAMOS, P.E., SCHAUMBURG, **ENGINEER: CARMEN** 

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#### **INDEX OF SHEETS**

1 COVER SHEET

INDEX OF SHEETS, STATE STANDARDS, DISTRICT ONE DETAILS AND GENERAL NOTES

3 GENERAL NOTES

4 - 6 SUMMARY OF QUANTITIES

7 TYPICAL SECTIONS

8 - 12 RESURFACING PLANS

13 CONSTRUCTION DETAILS

14 - 20 IDOT DISTRICT 1 DETAILS

#### **DISTRICT ONE DETAILS**

STANDARD NO.	LIST OF DESCRIPTION
BD-22	PAVEMENT PATCHING FOR HMA SURFACED PAVEMENT
BD-24	CURB OR CURB AND GUTTER REMOVAL AND REPLACEMENT
BD-32	BUTT JOINT AND HMA TAPER DETAILS
TC-10	TRAFFIC CONTROL AND PROTECTION FOR
	SIDE ROADS, INTERSECTIONS, AND DRIVEWAYS
TC-13	DISTRICT ONE TYPICAL PAVEMENT MARKINGS
TC-16	SHORT TERM PAVEMENT MARKING LETTERS AND SYMBOLS
TC-22	ARTERIAL ROAD INFORMATION SIGN

#### **STATE STANDARDS**

STANDARD NO.	LIST OF DESCRIPTION
000001-08	STANDARD SYMBOLS, ABBREVIATIONS AND PATTERNS
424001-11	PERPENDICULAR CURB RAMPS FOR SIDEWALKS
424021-06	DEPRESSED CORNER FOR SIDEWALKS
442201-03	CLASS C AND D PATCHES
482011-03	HMA SHOULDER STRIPS/SHOULDERS WITH RESSURFACING OR
	WIDENING & RESURFACING PROJECTS
602001-02	CATCH BASIN TYPE A
602011-02	CATCH BASIN TYPE C
602601-06	PRECAST REINFORCED CONCRETE FLAT SLAB TOP
604036-03	GRATE TYPE 8
701006-05	OFF-RD OPERATIONS, 2L, 2W, 15' TO 24" FROM PAVEMENT EDGE
701201-05	LANE CLOSURE, 2L, 2W DAY ONLY, FOR SPEEDS $\geq$ 45 MPH
701301-04	LANE CLOSURE, 2L, 2W, SHORT TIME OPERATIONS
701306-04	LANE CLOSURE, 2L, 2W, SLOW OPERATIONS DAY ONLY, FOR SPEEDS $\geq$ 45MPH
701311-03	LANE CLOSURE, 2L, 2W, MOVING OPERATIONS-DAY ONLY
701501-06	URBAN LANE CLOSURE, 2L, 2W, UNDIVIDED
701701-10	URBAN LANE CLOSURE, MULTILANE INTERSECTION
701801-06	SIDEWALK, CORNER OR CROSSWALK CLOSURE
701901-09	TRAFFIC CONTROL DEVICES

#### **GENERAL NOTES**

- ALL REFERENCES TO "STANDARD SPECIFICATIONS" IN THESE GENERAL NOTES SHALL

  BE INTERPRETED TO MEAN "STANDARD SPECIFICATIONS FOR ROAD AND BRIDGE

  CONSTRUCTION" ADOPTED BY THE ILLINOIS DEPARTMENT OF TRANSPORTATION,

  JANUARY 1, 2022. ALL WORK TO BE COMPLETED IN ACCORDANCE WITH THE

  STANDARD SPECIFICATIONS.
- 2. IT IS THE CONTRACTOR'S RESPONSIBILITY TO ASCERTAIN EXISTING FIELD CONDITIONS PRIOR TO BIDDING ON THE PROJECT.
- 3. BEFORE STARTING ANY EXCAVATION, THE CONTRACTOR SHALL CALL "JULIE" (JOINT UTILITY LOCATION INFORMATION FOR EXCAVATION) AT (800) 892-0123 FOR FIELD LOCATIONS OF BURIED UTILITIES (48 HOURS NOTIFICATION IS REQUIRED).
- 4. THE CONTRACTOR WILL NOT BE ALLOWED TO SET UP A YARD OR FIELD OFFICE ON MUNICIPAL PROPERTY WITHOUT WRITTEN PERMISSION FROM THE ENGINEER.
- 5. OFFSET LOCATIONS GIVEN IN THE PLANS FOR EDGE OF PAVEMENT, ETC. ARE FROM THE ROADWAY CENTERLINE.
- 6. THE CONTRACTOR SHALL BE RESPONSIBLE FOR SWEEPING AND CLEANING STREETS OF ANY DEBRIS AND MATERIAL THAT HAS ACCUMULATED AS A RESULT OF THE CONSTRUCTION ACTIVITY. A MECHANICAL SWEEPER, MECHANICALLY DRIVEN AIR AND HANDWORK WITH SHOVEL AND BROOM SHALL BE UTILIZED TO PROVIDE A CLEAN STREET FOR THE MOTORING PUBLIC. WITHIN 24 HOURS OF PLACING PRIME COAT AND THE LAYING OF HMA, THE CONTRACTOR SHALL SWEEP THE PAVEMENT AND REMOVE STANDING WATER, EARTH, WEEDS, LEAVES, DIRT, CONSTRUCTION DEBRIS, AND ALL LOOSE MATERIAL.
- 7. CONSTRUCTION WORK MAY BE PERFORMED MONDAY THRU FRIDAY DURING THE
  HOURS OF 7:00 A.M. TO 7:00 P.M. AND ON WEEKENDS FROM 8:00 A.M. TO 6:00 P.M IN
  ACCORDANCE WITH LOCAL ORDINANCE. NO WORK MAY BE PERFORMED PRIOR OR
  BEYOND THIS PERIOD WITHOUT PRIOR WRITTEN APPROVAL FROM THE VILLAGE.
- 8. EXISTING AGGREGATE DRIVEWAYS WILL BE RESURFACED AND PAID FOR IN CONJUNCTION WITH MAINLINE PAVING. SEE CONSTRUCTION DETAILS.
- 9. CONTRACTOR SHALL TAKE PRECAUTION BY PRESERVING EXISTING TREES WITHIN THE RIGHT OF WAY. IF ANY DAMAGE OCCURS, TREES SHALL BE REPLACED IN KIND PER ARTICLE 201.07. REPAIR OR REPLACEMENT OF EXISTING PLANT MATERIAL REQUIREMENTS STATED HEREIN.
- 10. PHOSPHORUS FERTILIZER HAS BEEN INTENTIONALLY OMITTED FROM THE CONTRACT

  DUE TO THE PROXIMITY TO THE EXISTING WETLANDS/BODIES OF WATER. A

  PHOSPHORUS-FREE FERTILIZER SHALL BE USED (MIDDLE NUMBER SHOULD EQUAL 0).

### UTILITIES

THE CONTRACTOR SHALL BE RESPONSIBLE FOR CONTACTING THE OWNERS OF ALL
UTILITIES PRIOR TO CONSTRUCTION TO DETERMINE THE LOCATION OF ALL UTILITY
EQUIPMENT. THE CONTRACTOR SHALL COOPERATE WITH ALL UTILITY OWNERS IN
ACCORDANCE WITH THE STANDARD SPECIFICATIONS IF UTILITY RELOCATION,
ADJUSTMENT, OR PROTECTION IS NECESSARY.

- 2. THE CONTRACTOR SHALL BE RESPONSIBLE FOR THE PROTECTION OF ALL UNDERGROUND AND SURFACE UTILITIES EVEN THOUGH THEY MIGHT NOT BE SHOWN ON THE PLANS. ANY UTILITY PROPERTY DAMAGED DURING CONSTRUCTION SHALL BE REPAIRED OR REPLACED TO THE SATISFACTION OF THE OWNER.
- 3. THE CONTRACTOR SHALL USE ALL NECESSARY PRECAUTIONS AND PROTECTION
  MEASURES REQUIRED TO MAINTAIN EXISTING UTILITIES, SEWERS, AND
  APPURTENANCES THAT MUST BE KEPT IN OPERATION.
- 4. ANY LOOSE MATERIAL DEPOSITED IN THE FLOWLINE OF CULVERTS OR DITCHES, WHICH OBSTRUCTS THE NATURAL FLOW OF WATER SHALL BE REMOVED AT THE CLOSE OF EACH WORKING DAY. PRIOR TO ACCEPTANCE OF THE IMPROVEMENT, ALL DRAINAGE APPURTENANCES SHALL BE FREE OF DIRT AND DEBRIS.
- 5. THE INDISCRIMINATE USE OF FIRE HYDRANTS OR EXISTING STREAMS, CREEKS,
  WETLANDS OR PONDS IS STRICTLY PROHIBITED. THE CONTRACTOR SHALL PROVIDE A
  WATER TRUCK AND DRIVER AS REQUIRED TO OBTAIN AND TRANSPORT THIS WATER.
  THE CONTRACTOR SHALL BE RESPONSIBLE FOR OBTAINING THIS WATER FROM AN
  APPROVED SOURCE. IF THIS WATER IS FROM A SOURCE OTHER THAN HIS YARD,
  WRITTEN APPROVAL FROM THE AGENCY HAVING JURISDICTION FOR THE SOURCE OF
  THE WATER MUST BE RECEIVED BY THE ENGIEER PRIOR TO USE OF THE WATER.

#### <u>PAVING</u>

- 1. LONGITUNDINAL CONSTRUCTION JOINTS WILL NOT BE PERMITTED OVERNIGHT.
- TRANSVERSE CONSTRUCTION JOINTS WILL BE ALLOWED DURING PAVING PROVIDED
  THE CONTRACTOR COMPLETE A SAWCUT AT LEAST SIX INCHES INTO THE ADJACENT
  MAT AT THE START OF PAVING THE FOLLOWING DAY.

#### SIGNING AND STRIPING

- 1. SIGNS SHALL NOT BE MOVED OR COVERED UNTIL PROGRESS OF WORK NECESSITATES IT.
- 2. THE CONTRACTOR WILL BE REQUIRED TO TEMPORARILY RESET ALL SUCH SIGNS THAT INTERFERE WITH HIS CONSTRUCTION OPERATIONS. ALL SUCH SIGNS MUST BE MAINTAINED STRAIGHT AND CLEAN FOR THE DURATION OF THE TEMPORARY SETTING AND MUST BE RE-ERECTED AT A TEMPORARY LOCATION IN A WORKMANLIKE MANNER AND BE VISIBLE TO THE TRAFFIC FOR WHICH IT IS INTENDED.
- SEE IDOT DISTRICT ONE DETAILS AND PLAN SHEETS FOR PAVEMENT MARKING DETAILS.
- 4. GRINDING OF PAVEMENT MARKINGS ON NEWLY CONSTRUCTED HOT-MIX ASPHALT PAVEMENT WILL NOT BE PERMITTED.
- 5. THE CONTRACTOR SHALL BE RESPONSIBLE FOR POSTING "FRESH OIL" SIGNS (48"X48" MINIMUM) AS NEEDED FOR THE PROJECT. THE CONTRACTOR SHALL INSTALL AND MAINTAIN TEMPORARY SIGNS IN THE PARKWAY TWENTY-FOUR (24) HOURS PRIOR TO STARTING WORK ON EACH STREET. THE SIGNS SHALL READ "FRESH OIL, TRAVEL AT YOUR OWN RISK." THE CONTRACTOR SHALL REMOVE THE SIGNS AND REINSTALL THEM AS NEEDED.

INDEX	OF SHEET	S,STAT	E S	TAN	DAR	DS,DIST	RICT	1 DETAILS&C	ENERAL	NOTES	F.A. RTE	SEC <sup>-</sup>	ΓΙΟΝ	COUNTY	TOTAL SHEETS	SHEET NO.
WINN ROAD								0157	21-00018-00-RS		McHENRY	20	2			
WINN HOAD											CONTRACT	NO.	61J98			
SCALE:	N.T.S	SHEET	1	OF	2	SHEETS	STA.	TO	STA.				ILLINOIS FED. A	ID PROJECT		

# GENERAL NOTES CONTINUED

- 6. IN ACCORDANCE WITH THE IDOT DROP OFF POLICY AT INSTANCES IN WHICH THERE IS
  A GREATER THAN 1.5 INCH HEIGHT DIFFERENCE IN VERTICAL MILLED FACE, OR WHEN
  THERE IS A GREATER THAN 2.5 INCH LIFT DIFFERENCE, UNEVEN LANE SIGNS (W8-11)
  WILL BE REQUIRED.
- 7. THE CONTRACTOR SHALL CONTACT KALPANA KANNAN-HOSADURGA, THE DISTRICT ONE TRAFFIC CONTROL SUPERVISOR, AT KALPANA.KANNAN-HOSADURGA@ILLINOIS.GOV A MINIMUM OF 72 HOURS IN ADVANCE OF BEGINNING WORK.

## **COMMITMENTS**

NONE.

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	DRAWN - DMS	REVISED - XX/XX/XXXX
PLOT SCALE = 2.0000 ' / in.	CHECKED -	REVISED - XX/XX/XXXX
PLOT DATE = 10/18/2023	DATE -	REVISED - XX/XX/XXXX

STATE OF	ILLINOIS
DEPARTMENT OF T	RANSPORTATION

			G	ENE	RAL NO	TES				F.A. RTE	SEC	TION		COUNTY	TOTAL SHEETS	SHEET NO.
			v	VINI	N BUYL	ı				0157	21-00018-00-RS		McHENRY	20	3	
	WINN ROAD													CONTRACT	NO.	61J98
SCALE: N.T.S	SHEET	2	OF	2	SHEETS	STA.	TO	STA.				ILLINOIS	FED. AI	ID PROJECT		

		CODE NO.	ITEM DESCRIPTION	UNIT	TOTAL QUANTITY	STU 80% FEDERAL 0005
		20200600	EXCAVATING AND GRADING EXISTING SHOULDER	UNIT	12	12
		20800150	TRENCH BACKFILL	CU YD	12	12
_	-	21101615	TOPSOIL FURNISH AND PLACE, 4"	SQ YD	2,265	2,265
_	-	25000210	SEEDING, CLASS 2A	ACRE	0.50	0.50
-	-	25000400	NITROGEN FERTILIZER NUTRIENT	POUND	45	45
-	-	25000600	POTASSIUM FERTILIZER NUTRIENT	POUND	45	45
		28000250	TEMPORARY EROSION CONTROL SEEDING	POUND	50	50
		35101600	AGGREGATE BASE COURSE, TYPE B 4"	SQ YD	170	170
		40600290	BITUMINOUS MATERIALS (TACK COAT)	POUND	29,721	29,721
		40000370	LONGITUDINAL IONIT CENTANT	5007	17.701	17.701
	-	40600370	LONGITUDINAL JOINT SEALANT	FOOT	17,781	17,781
		40600400	MIXTURE FOR CRACKS, JOINTS, AND FLANGEWAYS	TON	15	15
		40800400	MINTURE FOR CRACKS, JOINTS, AND FLANGEWATS	TON	13	13
		40600982	HOT-MIX ASPHALT SURFACE REMOVAL - BUTT JOINT	SQ YD	1,121	1,121
		40000302	THE THINK TO THE TENOME SOTT JOINT	30 15	1,121	1,121
		40603200	POLYMERIZED HOT-MIX ASPHALT BINDER COURSE, IL-4.75, N50	TON	2,535	2,535
					, -	,
		40604062	HOT-MIX ASPHALT SURFACE COURSE, IL-9.5, MIX "D", N70	TON	5,065	5,065
		40800050	INCIDENTAL HOT-MIX ASPHALT SURFACING	TON	60	60
		42400200	PORTLAND CEMENT CONCRETE SIDEWALK 5 INCH	SQ FT	1,860	1,860
		42400800	DETECTABLE WARNINGS	SQ FT	274	274
		44000157	HOT-MIX ASPHALT SURFACE REMOVAL, 2"	SQ YD	44,030	44,030
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+ SPECIALTY ITEM

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PLOT DATE = 12/1/2023	DATE -	REVISED - XX/XX/XXXX

SUMMARY OF QUANTITIES											A. SECTION			COUNTY	TOTAL SHEETS	SHEET NO.
WINN ROAD										0157	57 21-00018-00-RS			McHENRY	20	4
VVIIVIV NOAD														CONTRACT	NO.	61J98
SCALE: N.T.S	SHEET	1	OF	3	SHEETS	STA.	TO	STA.				ILLINOIS	FED. A	ID PROJECT		

CODE NO.	ITEM DESCRIPTION	UNIT	TOTAL	STU 80% FEDERAL 0005
44000600	SIDEWALK REMOVAL	SQ FT	1,690	1,690
44201717	CLASS D PATCHES, TYPE II, 6 INCH	SQ YD	445	445
44201721	CLASS D PATCHES, TYPE III, 6 INCH	SQ YD	445	445
44201723	CLASS D PATCHES, TYPE IV, 6 INCH	SQ YD	445	445
48101200	AGGREGATE SHOULDERS, TYPE B	TON	1,000	1,000
48203021	HOT-MIX ASPHALT SHOULDERS, 6"	SQ YD	125	125
550A0050	STORM SEWERS, CLASS A, TYPE 1 12"	FOOT	48	48
60200805	CATCH BASINS, TYPE A, 4'-DIAMETER, TYPE 8 GRATE	EACH	1	1
60207605	CATCH BASINS, TYPE C, TYPE 8 GRATE	EACH	1	1
67100100	MOBILIZATION	L SUM	1	1
70100450	TRAFFIC CONTROL AND PROTECTION, STANDARD 701201	L SUM	1	1
70100460	TRAFFIC CONTROL AND PROTECTION, STANDARD 701306	L SUM	1	1
70102620	TRAFFIC CONTROL AND PROTECTION, STANDARD 701501	L SUM	1	1
70102635	TRAFFIC CONTROL AND PROTECTION, STANDARD 701701	L SUM	1	1
70102640	TRAFFIC CONTROL AND PROTECTION, STANDARD 701801	L SUM	1	1
70300100	SHORT TERM PAVEMENT MARKING	FOOT	10,638	10,638
70300150	SHORT TERM PAVEMENT MARKING REMOVAL	SQ FT	5,342	5,342

+ SPECIALTY ITEM

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		su	IMM.	ARY	OF QU	ANTITIES	 S			F.A. RTE	SEC	TION		COUNTY	TOTAL	
WINN ROAD								0157	157 21-00018-00-RS		McHENRY	20	5			
WHITE HOAD											CONTRACT	NO.	61J98			
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PLOT DATE = 12/1/2023	DATE -	REVISED -	XX/XX/XXXX

CODE NO.

# STATE OF ILLINOIS DEPARTMENT OF TRANSPORTATION

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CALE: N.	.s	SHEET	3	OF	3	SHEETS	STA.	TO	STA.	

STU 80% FEDERAL 0005

TOTAL

QUANTITY

UNIT

 F.A. RTE.
 SECTION
 COUNTY SHEETS NO.
 TOTAL SHEETS NO.


 0157
 21-00018-00-RS
 MCHENRY 20
 6

 CONTRACT NO. 61J98

 ILLINOIS FED. AID PROJECT

+		78009000	MODIFIED URETHANE PAVEMENT MARKING - LETTERS AND SYMBOLS	SQ FT	219	219
+		78009004	MODIFIED URETHANE PAVEMENT MARKING - LINE 4*	FOOT	51,702	51,702
+		78009006	MODIFIED URETHANE PAVEMENT MARKING - LINE 6"	FOOT	1,927	1,927
+		78009012	MODIFIED URETHANE PAVEMENT MARKING - LINE 12"	FOOT	1,520	1,520
+		78009024	MODIFIED URETHANE PAVEMENT MARKING - LINE 24"	FOOT	93	93
+		78011000	GROOVING FOR RECESSED PAVEMENT MARKING LETTERS AND SYMBOLS	SQ FT	219	219
+		78011025	GROOVING FOR RECESSED PAVEMENT MARKING 5"	FOOT	51,702	51,702
+		78011035	GROOVING FOR RECESSED PAVEMENT MARKING 7"	FOOT	1,927	1,927
+		78011065	GROOVING FOR RECESSED PAVEMENT MARKING 13"	FOOT	1,520	1,520
+		78011125	GROOVING FOR RECESSED PAVEMENT MARKING 25"	FOOT	93	93
		X0326806	WASHOUT BASIN	L SUM	1	1
+		X2511630	EROSION CONTROL BLANKET (SPECIAL)	SQ YD	2,265	2,265
		X4400196	HOT-MIX ASPHALT SURFACE REMOVAL, SPECIAL	SQ YD	103	103
		X4400501	COMBINATION CURB AND GUTTER REMOVAL AND REPLACEMENT LESS THAN OR EQUAL TO 10 FEET	FOOT	250	250
		X4400503	COMBINATION CURB AND GUTTER REMOVAL AND REPLACEMENT GREATER THAN 10 FEET	FOOT	500	500
		X4401198	HOT-MIX ASPHALT SURFACE REMOVAL, VARIABLE DEPTH	SQ YD	2,924	2,924
		X4830030	PORTLAND CEMENT CONCRETE SHOULDERS 8" (SPECIAL)	SQ YD	25	25
+		Z0030850	TEMPORARY INFORMATION SIGNING	SQ FT	55	55
	IIC		VICED VY/VY/VYV	<u> </u>		

ITEM DESCRIPTION

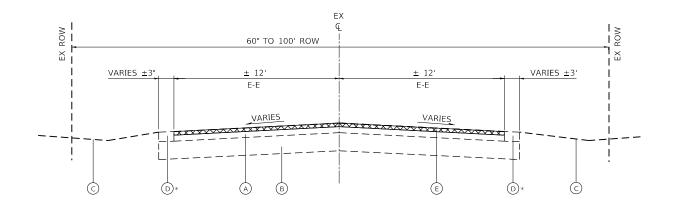

# EX & PR 60' TO 100' ROW ± 11' ± 11 LANE LANE

## **EXISTING TYPICAL SECTION**

WINN ROAD STA. 10+42 TO 142+61

EXISTING CONCRETE GUTTER OR CURB AND GUTTER AT THE FOLLOWING LOCATIONS: STA 11+72 TO 15+76 RT STA 33+60 TO 34+35 LT STA 35+22 TO 36+64 LT STA 89+74 TO 93+10 LT STA 91+93 TO 92+92 LT STA 93+75 TO 94+95 RT STA 93+96 TO 97+00 LT STA 104+90 TO 111+63 LT STA 111+92 TO 113+74 LT STA 139+36 TO 141+53 LT STA 139+36 TO 141+53 RT SPOT REMOVAL & REPLACEMENT AS DIRECTED BY THE ENGINEER.

## **EXISTING LEGEND**

- A EXISTING HOT-MIX ASPHALT PAVEMENT; 8"
- B EXISTING AGGREGATE BASE COURSE; 12"
- © EXISTING GROUND
- D EXISTING AGGREGATE SHOULDER
- (E) HOT-MIX ASPHALT SURFACE REMOVAL; 2"
- $\begin{picture}(60,0)\put(0,0){\line(1,0){10}}\put(0,0){\line(1,0){10}$

#### PROPOSED LEGEND

- 1 BITUMINOUS MATERIALS (TACK COAT)
- 2 AGGREGATE SHOULDERS, TYPE B (9% MAX SLOPE) (CA-6 CRUSHED GRAVEL OR CRUSHED STONE)
- 3 HOT-MIX ASPHALT SURFACE COURSE, IL-9.5, MIX "D", N70; 2"
- 4 POLYMERIZED HOT-MIX ASPHALT BINDER COURSE, IL-4.75, N50; 1"
- (5) MODIFIED URETHANE PAVEMENT MARKING, LINE 4" (SEE RESURFACING PLANS)

# PROPOSED TYPICAL SECTION

WINN ROAD STA. 10+42 TO 142+61

HOT MY ACRUALT MYTHE PEOUPENTS							
HOT-MIX ASPHALT MIXTURE REQUIREMENTS							
MIXTURE TYPE	AIR VOIDS	OMP					
	<u>w</u> waes	QIVIF					
PAVEMENT RESURFACING							
HMA SURFACE COURSE, MIX "D", N70 (IL-9.5mm); 2"	4.0% @ 70 GYR.	LR 1030-2					
POLYMERIZED HOT-MIX ASPHALT BINDER COURSE, IL-4.75, N50; 1"	3.5% @ 50 GYR.	LR 1030-2					
HMA SHOULDERS 6"							
HMA BINDER COURSE, IL-19.0, N70; 6"	4.0% @ 70 GYR.	LR 1030-2					
INCIDENTAL HMA SURFACING (DRIVEWAYS)							
HMA SURFACE COURSE, MIX "D", N70 (IL-9.5mm); 2"	4.0% @ 70 GYR.	LR 1030-2					
PAVEMENT PATCHING							
CLASS D PATCHES, (HMA BINDER, IL-19mm); 6" 4.0% @ 70 GYR. LR 1030-2							
QMP DESIGNATION: QUALITY CONTROL/QUALITY ASSURANCE (QC/QA) PER LR 1030-2							

THE UNIT WEIGHT TO CALCULATE ALL HMA SURFACE MIXTURE QUATITIES IS 112 LBS/SQ YD/IN

THE "AC TYPE" FOR POLYMERIZED HMA MIXES SHALL BE "SBS/SBR PG 76-22" AND FOR NON-POLYMERIZED HMA THE "AC TYPE" SHALL BE "PG 64-22" UNLESS MODIFIED BY RECLAIMED MATERIAL SPECIFICATIONS.

PATCHING LOCATIONS TO BE DETERMINED BY THE ENGINEER AFTER MILLING


LONGITUDINAL JOINT SEALANT SHALL BE PLACED OVER THE POLY HMA BC IL-4.75 N50


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HRG PROJECT NO HRG PROJ. CONTA FILE NAME: 2110717 PLOT DRIVER: IL., PLOT DRIVER: IC., PEN TABLE: plot	HRGreen

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USER NAME = jstrzal	DESIGNED - JJS	REVISED - XX/XX/XXXX
	DRAWN - DMS	REVISED - XX/XX/XXXX
PLOT SCALE = 20.0000 / in.	CHECKED -	REVISED - XX/XX/XXXX
PLOT DATE = 12/1/2023	DATE -	REVISED - XX/XX/XXXX

AT PLANNED SURFACE COURSE CONSTRUCTION JOINTS.		
EXISTING & PROPOSED TYPICAL SECTIONS	F.A. RTE.	SECTION
WINN DOAD	0157	21-00018-00-RS



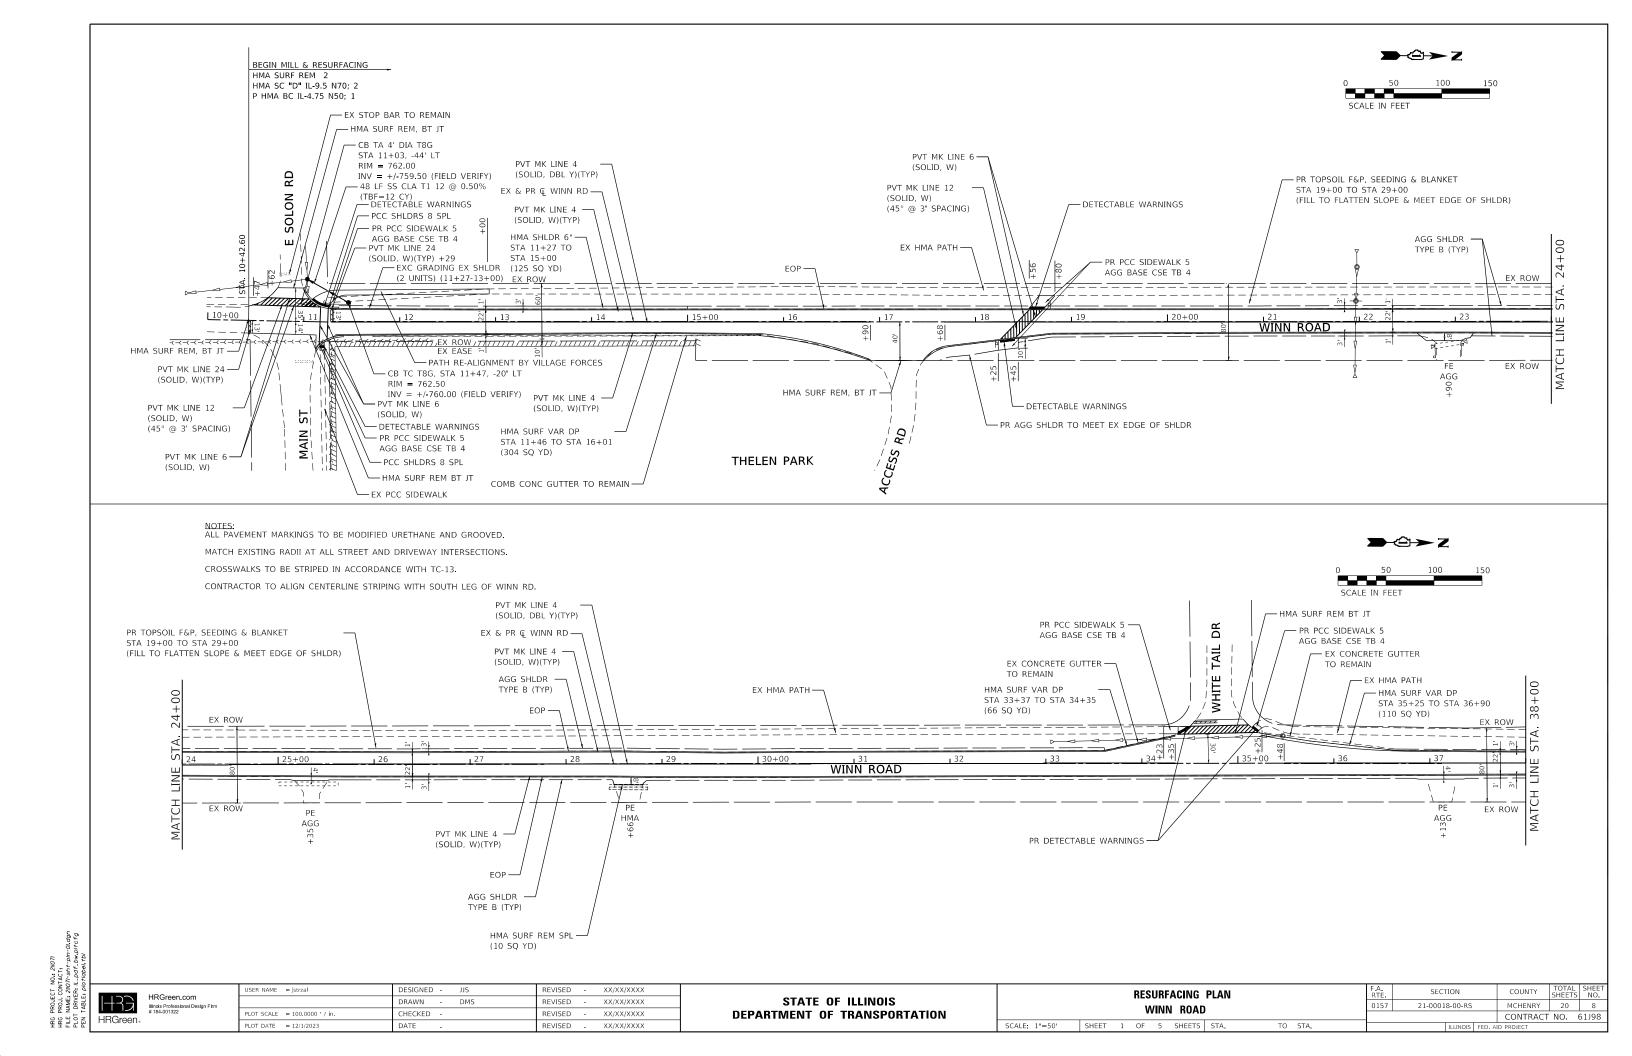


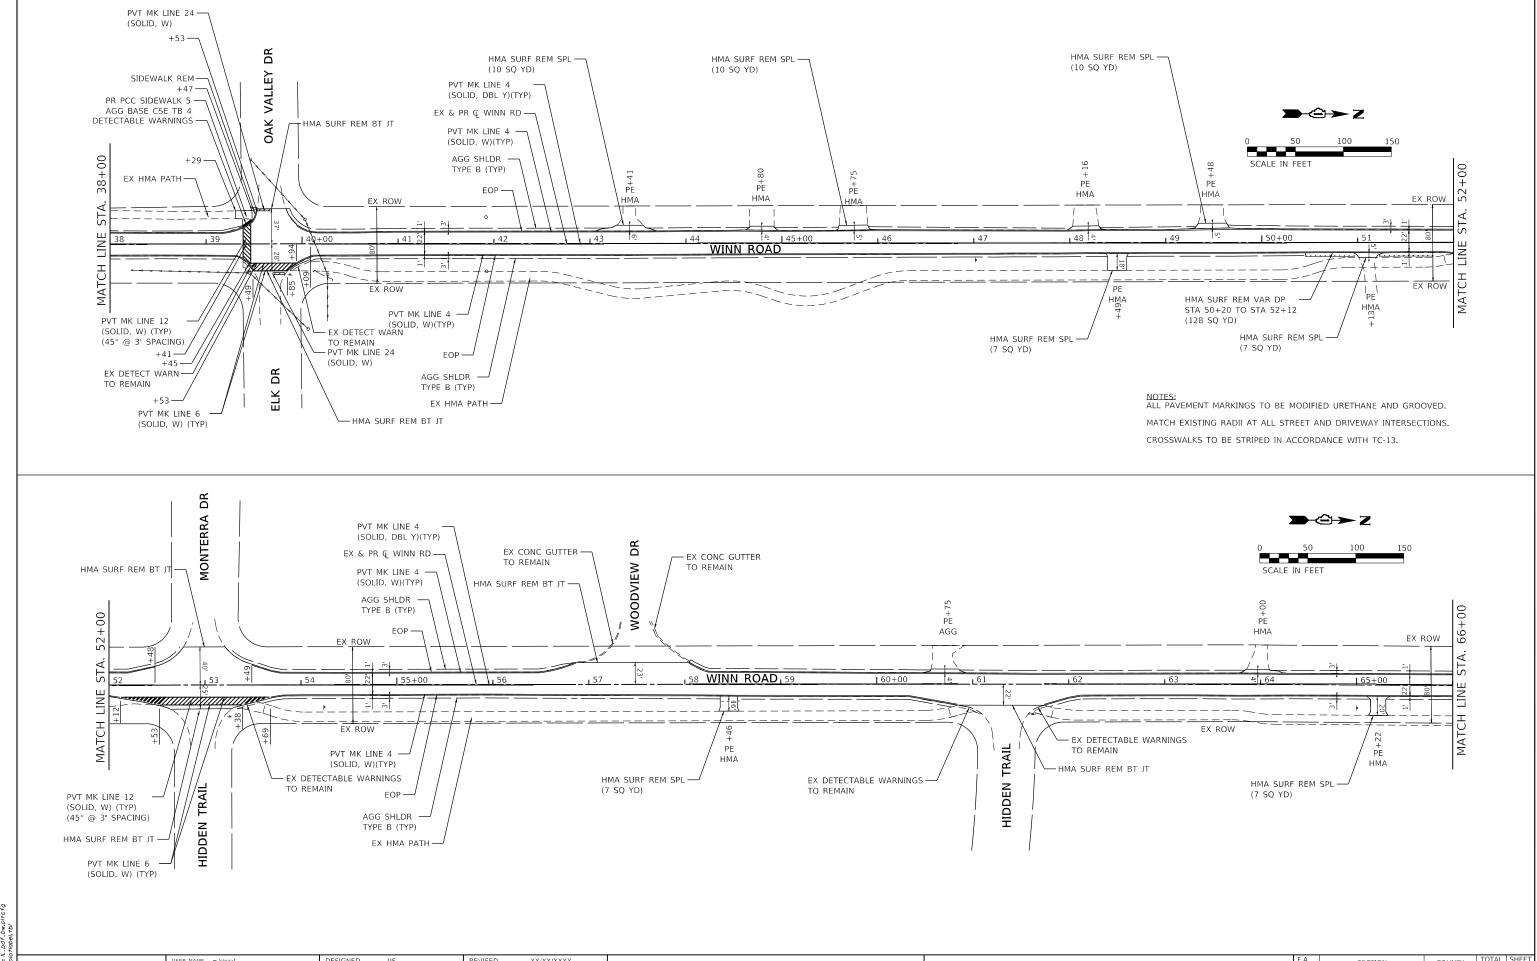
HRG PROJECT NO. 2/1071
HRG PROJ. CONTACT:
FILE NAME. 2/1071-snt-pin-02.dgn
PLOT DRIVER: IL. pdf. bw.pitcfg
PEN TABLE: ploridabel.tbi

USER NAME = jstrzal	DESIGNED - JJS	REVISED -	XX/XX/XXXX
	DRAWN - DMS	REVISED -	XX/XX/XXXX
PLOT SCALE = 100.0000 ' / in.	CHECKED -	REVISED -	XX/XX/XXXX
PLOT DATE = 12/1/2023	DATE -	REVISED -	XX/XX/XXXX

STATE OF ILLINOIS						
DEPARTMENT	OF TRANSPORTATI	ON				

RESURFACING	RTE	SECTION	COUNTY	SHEETS	110	
WINN ROAD	0157	20	9			
WINN HOAD			CONTRACT	NO.	61J98	
SCALE: 1"=50' SHEET 2 OF 5 SHEETS	STA. TO STA.	ILLINOIS FED. AID PROJECT				

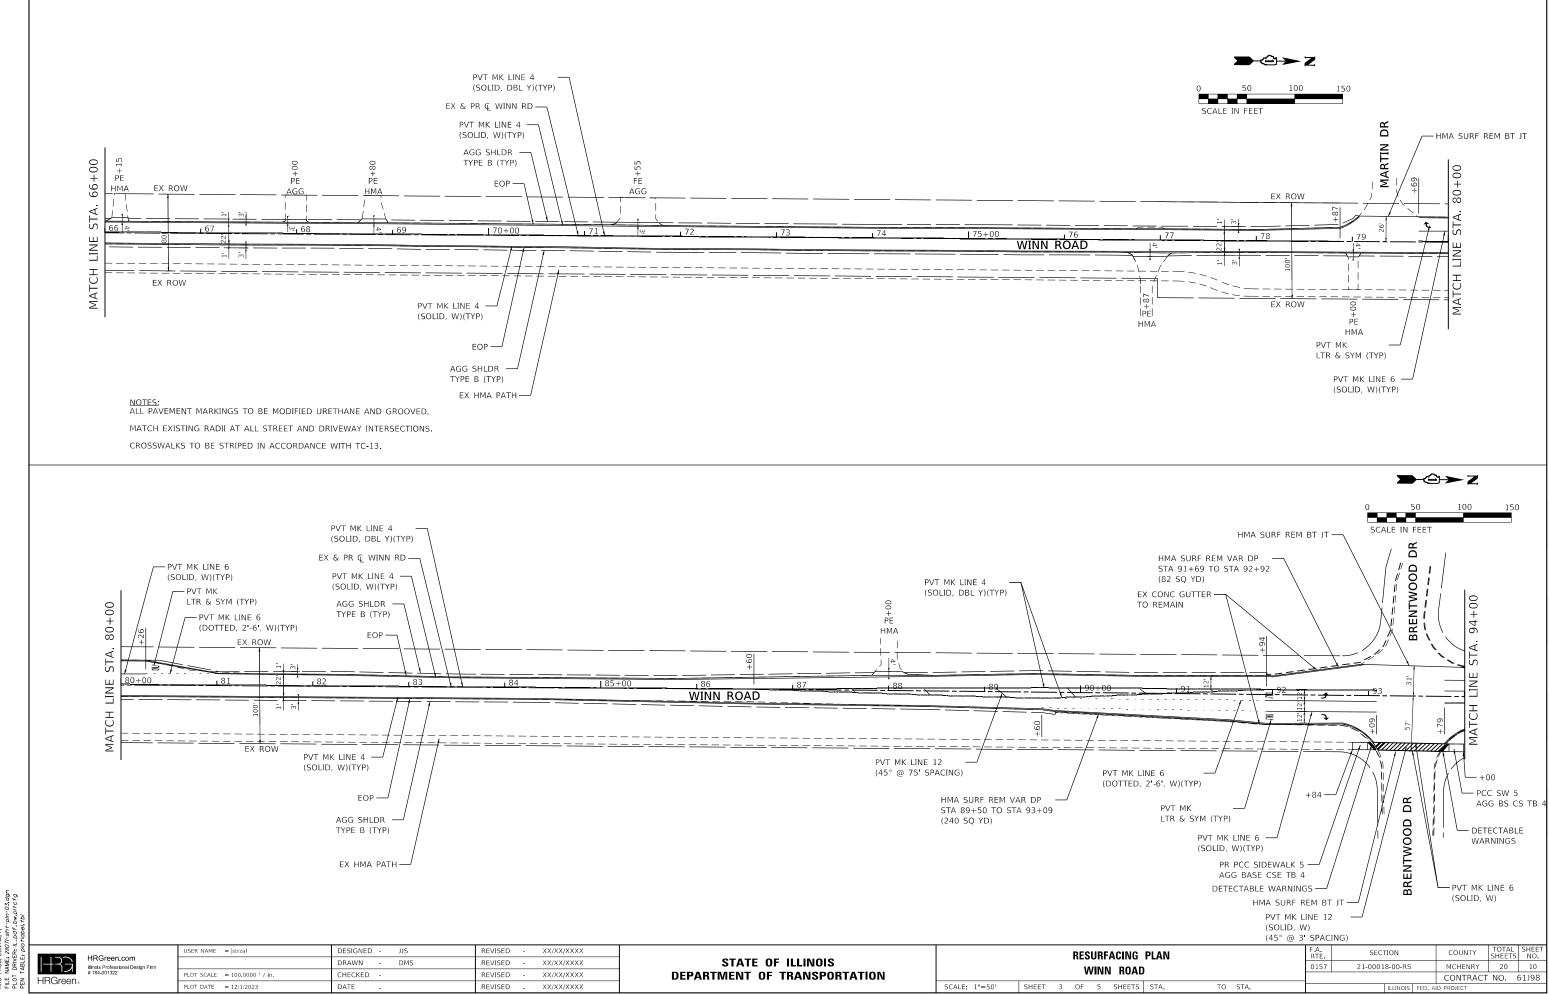

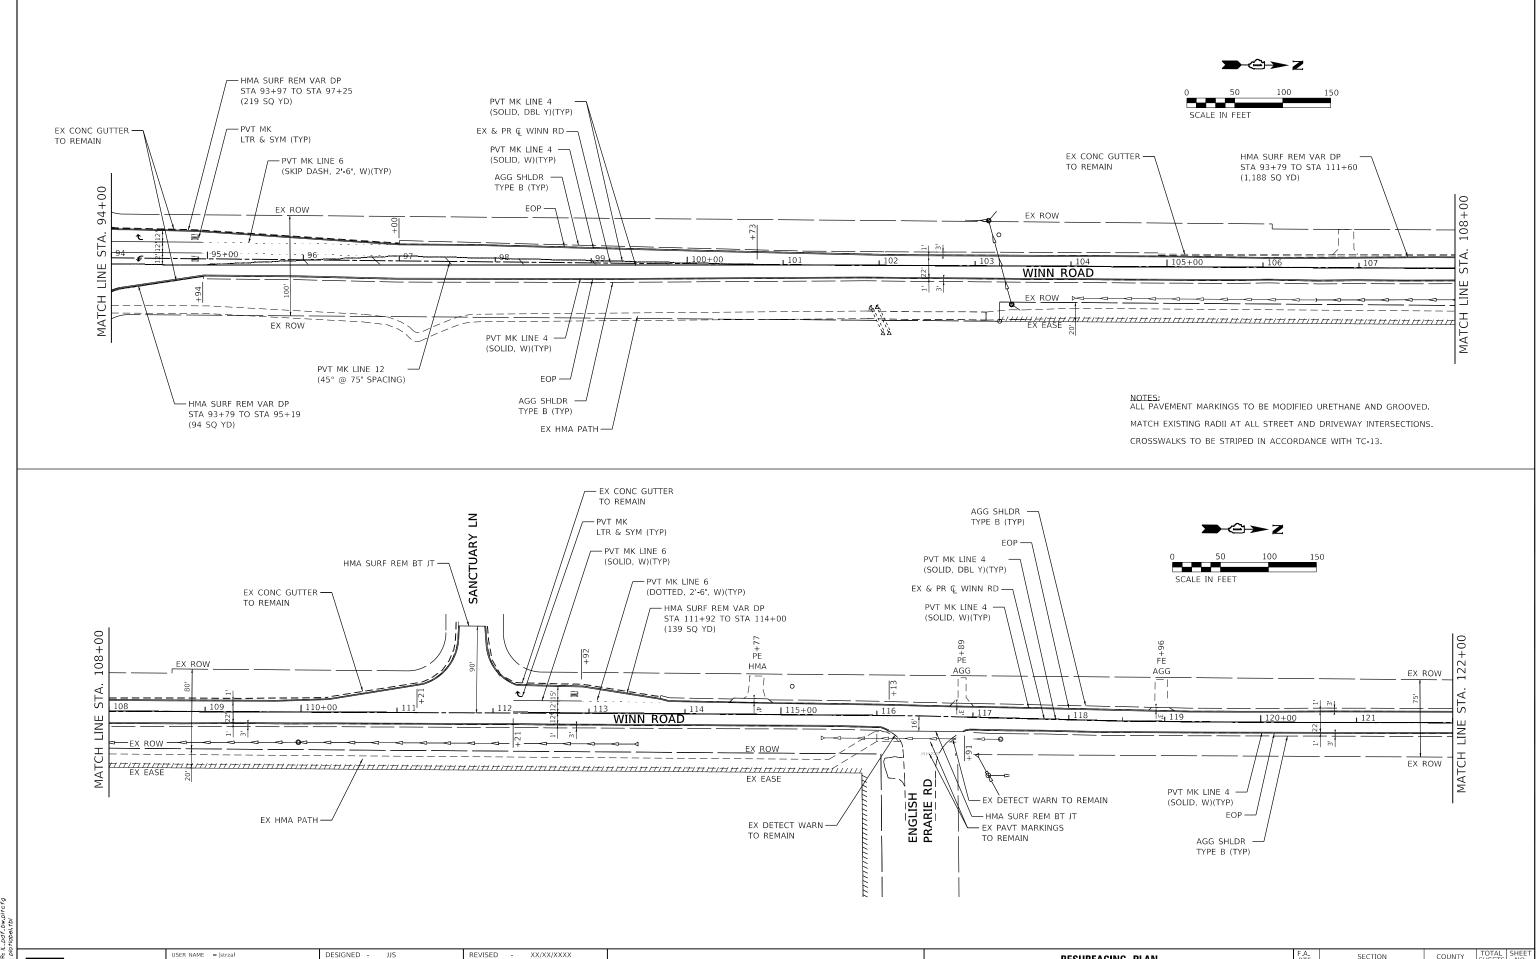


HRG PROJECT NO., 2/107/ HRG PROJ. CONTACT: FILE NAME, 2/107/-5/11-D/1-04.c PLOT DRIVER: 1L. Ddf. Dw. pitch PEN TABLE: p/o+idbel, tbl

HRGreen

HRGreen.com
Illinois Professional Design Firm
# 184-001322

STATE OF ILLINOIS
DEPARTMENT OF TRANSPORTATION

| RESURFACING PLAN | RATE | SECTION | COUNTY | TOTAL | SHEET | SHEE

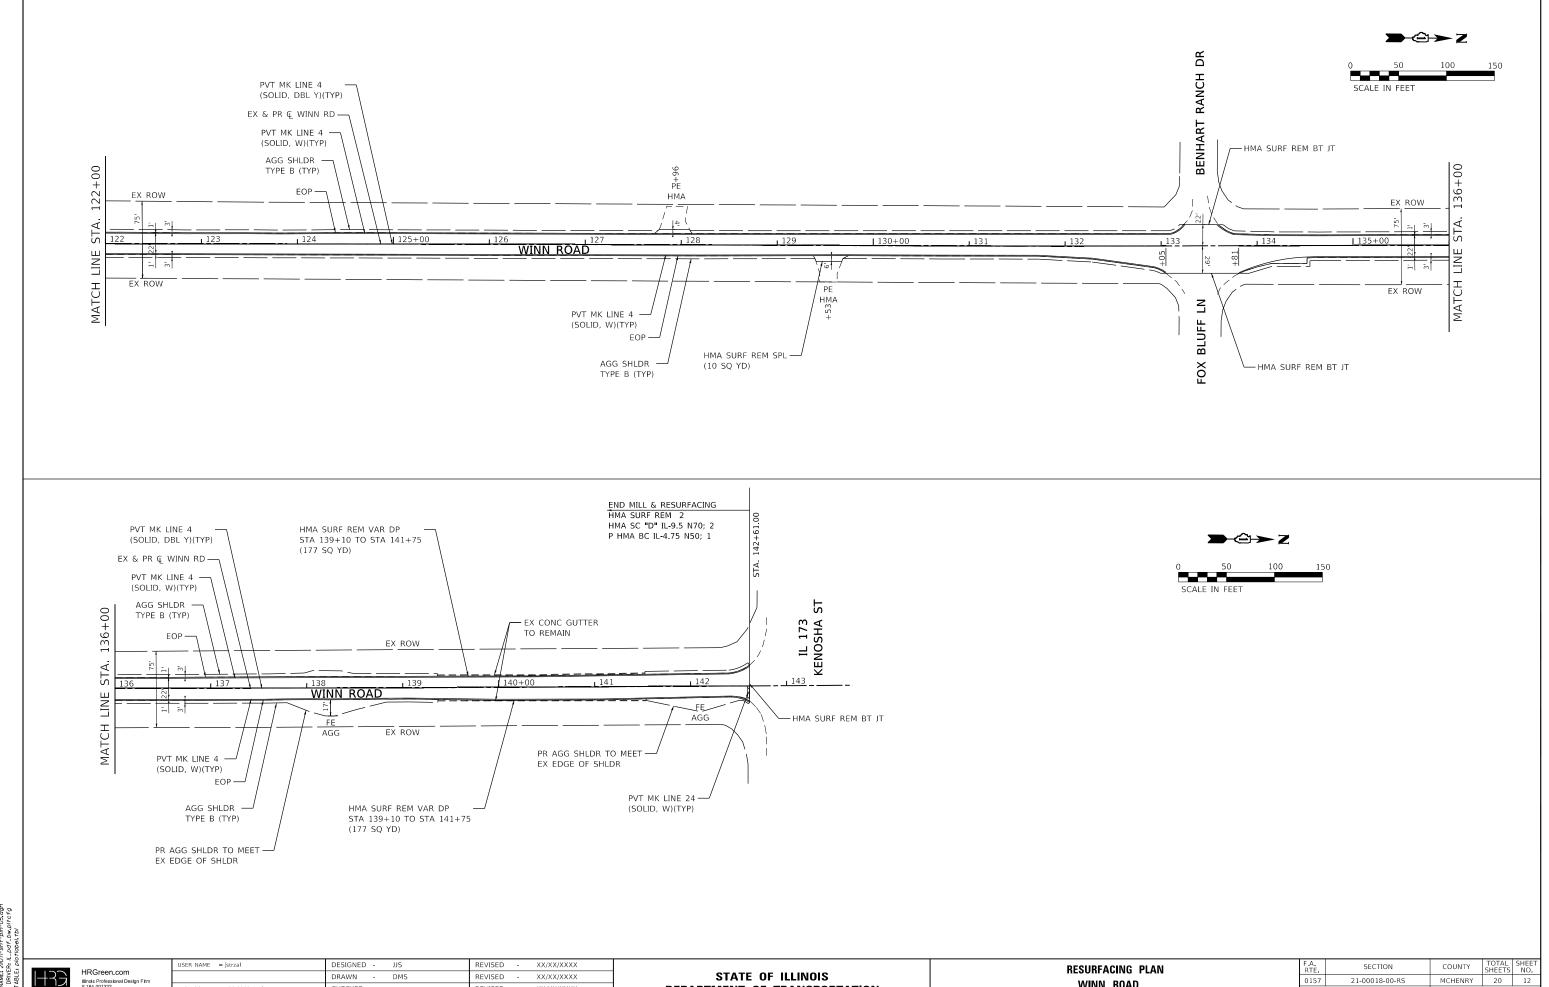


HRGreen.


DRAWN -DMS REVISED -XX/XX/XXXX CHECKED -REVISED -PLOT DATE = 12/1/2023 DATE REVISED -XX/XX/XXXX

STATE OF ILLINOIS **DEPARTMENT OF TRANSPORTATION** 

MCHENRY 20 12 0157 21-00018-00-RS WINN ROAD CONTRACT NO. 61J98 SCALE: 1"=50' SHEET 5 OF 5 SHEETS STA. TO STA.

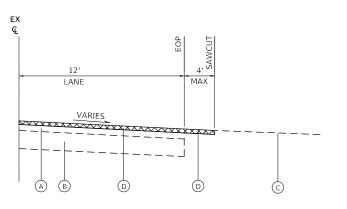


EXISTING / REMOVAL DETAIL

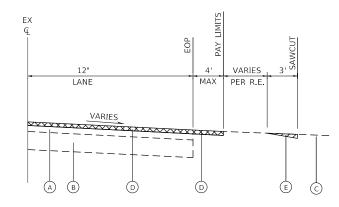

EXISTING / REMOVAL DETAIL

#### **EXISTING LEGEND**

- A EXISTING HOT-MIX ASPHALT PAVEMENT; 6"
- B EXISTING AGGREGATE BASE COURSE; 12"
- © EXISTING DRIVEWAY PAVEMENT
- HOT-MIX ASPHALT SURFACE REMOVAL, 2" (SEE RESURFACING PLANS) D
- E HOT-MIX ASPHALT SURFACE REMOVAL, SPECIAL (PER SQ YD)

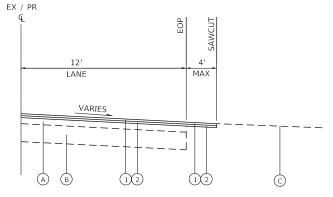

PROPOSED / RESURFACING DETAIL


EX / PR VARIES LANE PER R.E.

PROPOSED / RESURFACING DETAIL

<u>CASE II</u>

CASE I

**DRIVEWAY RESURFACING DETAILS** 

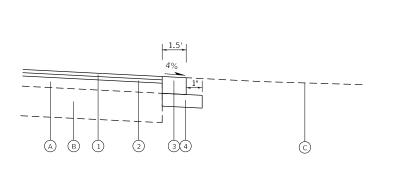


# PCC SHOULDERS 8" SPECIAL

# **EXISTING LEGEND**

- A EXISTING HOT-MIX ASPHALT PAVEMENT; 6"
- B EXISTING AGGREGATE BASE COURSE; 12"
- © EXISTING GROUND

#### PROPOSED LEGEND

- 1 PROPOSED RESURFACING; HMA SURFACE COURSE
- 2 PROPOSED RESURFACING; POLY HMA LEVELING
- 3 PCC SHOULDER 8" SPECIAL (PER SQ YD)
- (4) AGGREGATE BASE COURSE, TYPE B, 12"
  (CA-6 CRUSHED STONE OR CRUSHED GRAVEL)
  (PAID FOR AS PCC SHOULDER 8" SPECIAL)

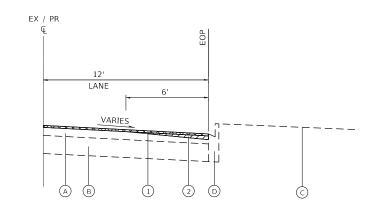

## HOT-MIX ASPHALT SURFACE REMOVAL, VARIABLE DEPTH

# PROPOSED LEGEND

- 1 PROPOSED RESURFACING; HMA SURFACE COURSE (SEE HMA MIX TABLE)
- 2 PROPOSED RESURFACING; POLY HMA BINDER COURSE (SEE HMA MIX TABLE)
- 3 INCIDENTAL HOT-MIX ASPHALT SURFACING (PER TON)

# **EXISTING LEGEND**

- (A) EXISTING HOT-MIX ASPHALT PAVEMENT; 6"
- B EXISTING AGGREGATE BASE COURSE; 12"
- C EXISTING GROUND
- D EXISTING CONCRETE CURB AND/OR GUTTER

#### PROPOSED LEGEND

- 1 HMA SURFACE REMOVAL, 2 (PER SQ YD)
- 2 HMA SURFACE REMOVAL, VARIABLE DEPTH (PER SQ YD)

HRGreen.com HRGreen.

USER NAME = jstrzal	DESIGNED - JJS	REVISED -	XX/XX/XXXX
	DRAWN - DMS	REVISED -	XX/XX/XXXX
PLOT SCALE = 2.0000 / in.	CHECKED -	REVISED -	XX/XX/XXXX
PLOT DATE = 12/1/2023	DATE -	REVISED -	XX/XX/XXXX

CONSTRUCTION DETAILS WINN ROAD											
SCALE: 1"=50'	SHEET	1	OF	1	SHEETS	STA.	7	ТО	STA.		


F.A. RTE	SECTION		COUNTY	TOTAL SHEETS	SHEET NO.
0157	21-00018-00-RS	5	MCHENRY	20	13
		CONTRACT	NO.	61J98	

# METHOD OF MEASUREMENT

REFER TO SECTION 442 OF THE STANDARD SPECIFICATIONS FOR ROAD AND BRIDGE CONSTRUCTION AND THE RECURRING SPECIAL PROVISION "PATCHING WITH HOT-MIX ASPHALT OVERLAY REMOVAL."

# **BASIS OF PAYMENT**

- 1. REFER TO SECTION 442 OF THE STANDARD SPECIFICATIONS FOR ROAD AND BRIDGE CONSTRUCTION AND THE RECURRING SPECIAL PROVISION "PATCHING WITH HOT-MIX ASPHALT OVERLAY REMOVAL."
- SAW CUT/SCORING OF EXISTING HMA OVERLAY IS INCLUDED IN THE COST OF PAVEMENT PATCHING.
- 3. SAW CUT/SCORING OF EXISTING PAVEMENT IS INCLUDED IN THE COST OF PAVEMENT PATCHING.

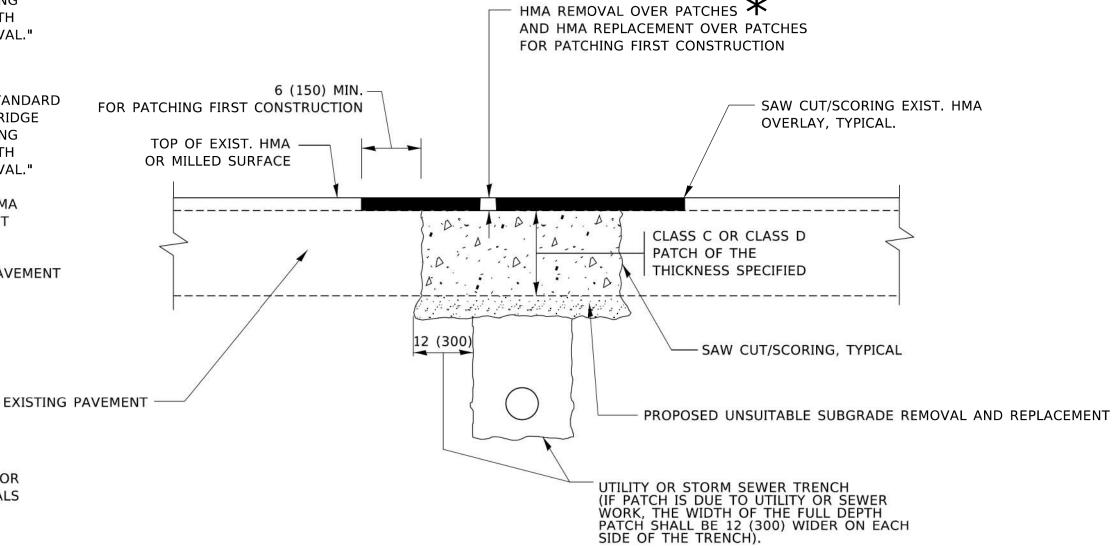

# SEQUENCE OF CONSTRUCTION (PATCHING FIRST)

1. REMOVE THE EXISTING HMA MATERIAL OVER THE AREA TO BE PATCHED.

SEE TYPICAL SECTIONS FOR

THICKNESS AND MATERIALS


- 2. REMOVE AND REPLACE WITH CLASS C OR D PATCH.
- 3. REPLACE HMA MATERIAL OVER THE AREA TO BE PATCHED.

# SEQUENCE OF CONSTRUCTION (MILLING FIRST)

- 1. MILL HMA FIRST IF THERE IS AT LEAST  $4\frac{1}{2}$  INCHES OR MORE OF HMA MATERIAL ON TOP OF THE EXISTING PAVEMENT OR IF THE PAVEMENT IS FULL DEPTH HMA. A MINIMUM OF 2 INCHES OF HMA MATERIAL SHALL BE IN PLACE AFTER MILLING.
- 2. REMOVE AND REPLACE WITH FULL DEPTH CLASS D PATCHES TO TOP OF MILLED SURFACE.

ALL DIMENSIONS ARE IN INCHES (MILLIMETERS) UNLESS OTHERWISE SHOWN.

USER NAME = Lawrence.DeManche	DESIGNED - R. SHAH	REVISED -	R. BORO 01-01-07			P	AVEMEN	ГРАТСН	ING FOR		F.A.	SECTION	COUNTY	TOTAL S	SHEET
	DRAWN -	REVISED -	R. BORO 09-04-07	STATE OF ILLINOIS							0157	21-00018-00-RS	MCHENRY	20	14
PLOT SCALE = 100.0000 ' / in.	CHECKED -	REVISED -	K. ENG 10-27-08	DEPARTMENT OF TRANSPORTATION	HMA SURFACED PAVEMENT  SCALE: NONE SHEET 1 OF 1 SHEETS STA. TO STA.				BD400-04 (BD-22)	CONTRACT	NO. 6	1J98			
PLOT DATE = 11/18/2022	DATE - 10-25-94	REVISED -	K. SMITH 11-18-22						ILLINOIS FED. AI	D PROJECT					

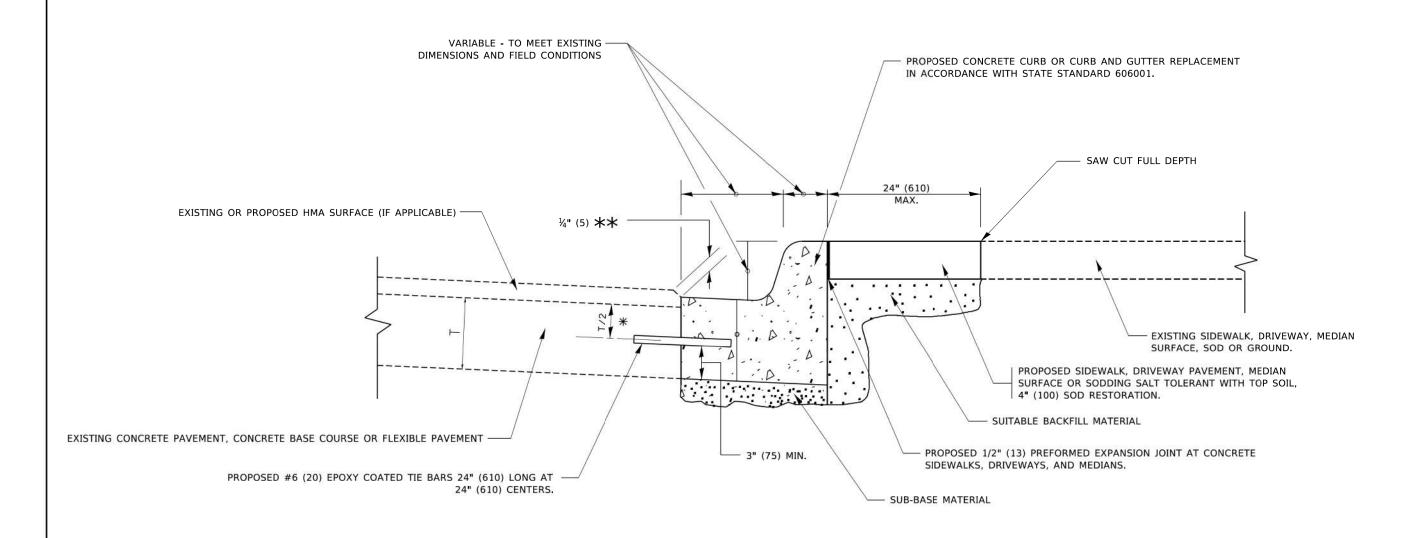

- X 3" (75) MINIMUM FROM TOP AND BOTTOM OF THE CONCRETE PAVEMENT OR BASE COURSE.
- \*\* IF THE FINAL SURFACE OF THE PAVEMENT IS CONCRETE, THE GUTTER IS TO BE FLUSH WITH THE PAVEMENT.


# **CURB OR CURB AND GUTTER REMOVAL AND REPLACEMENT**

ALL DIMENSIONS ARE IN INCHES (MILLIMETERS) UNLESS OTHERWISE SHOWN.

USER NAME = footemj	DESIGNED - A. HOUSEH	REVISED -	A. ABBAS 03-21-97
	DRAWN -	REVISED -	M. GOMEZ 01-22-01
PLOT SCALE = 50.0000 ' / in.	CHECKED -	REVISED -	R. BORO 12-15-09
PLOT DATE = 7/11/2019	DATE - 03-11-94	REVISED -	K. SMITH 07-11-19


STATE OF ILLINOIS
DEPARTMENT OF TRANSPORTATION

SCALE: NONE

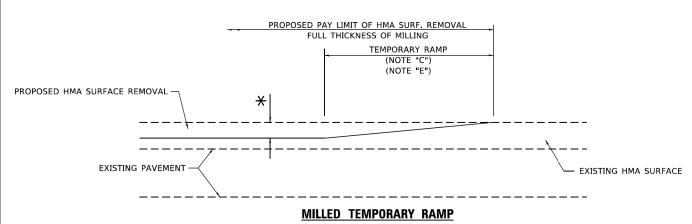

(FOR BUTT JOINT AND HMA TAPER SEE DETAIL BELOW)

# OPTION 1

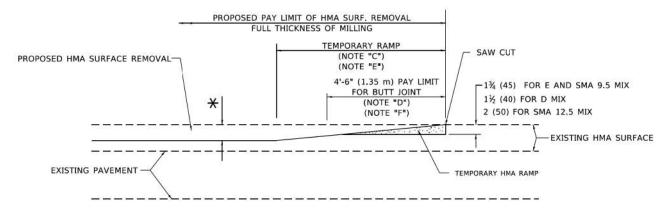


#### HMA CONSTRUCTED TEMPORARY RAMP

(FOR BUTT JOINT AND HMA TAPER SEE DETAIL BELOW)

# OPTION 2

# TYPICAL TEMPORARY RAMP

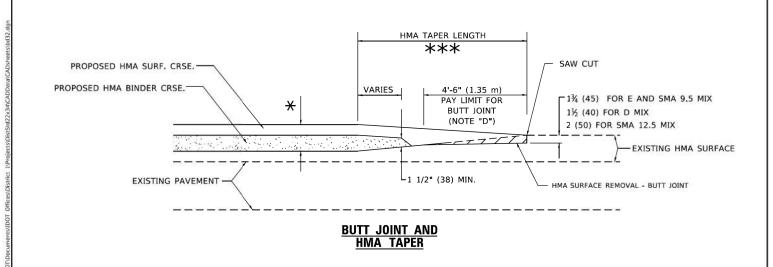

# TYPICAL BUTT JOINT AND HMA TAPER FOR MILLING AND RESURFACING

STATE OF ILLINOIS
DEPARTMENT OF TRANSPORTATION


PROPOSED HMA OR PCC
SURFACE REMOVAL - BUTT JOINT
30'-0" (9.0 m) (NOTE "A")
15'-0" (4.5 m) (NOTE "B")
40'-0" (12.0M) (NOTE "A1")

\*\* \* EXISTING PAVEMENT

\*\* \* EXISTING PAVEMENT

\*\* \* EXISTING PAVEMENT

\*\* \* BUTT JOINT DETAIL

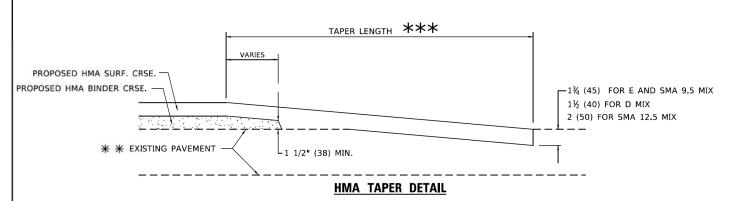

# TYPICAL BUTT JOINT AND HMA TAPER FOR RESURFACING ONLY

\*\* PC CONCRETE, HMA OR HMA RESURFACED PAVEMENT.

### **GENERAL NOTES**

- A. MAINLINE ARTERIAL ROADWAYS AND MAJOR SIDE ROADS.
- A1. INTERSTATES
- B. MINOR SIDE ROADS.
- C. THE TEMP. RAMP SHALL BE CONSTRUCTED IMMEDIATELY UPON REMOVAL OF THE EXISTING HMA SURFACE.
- D. THE BUTT JOINT SHALL BE CONSTRUCTED IMMEDIATELY PRIOR TO PLACING THE PROPOSED HMA COURSES.
- E. TAPER THE TEMP. RAMP AT A RATE OF 3' 4" (1.02m) PER 1 INCH (25 mm) OF MILLING THICKNESS.
  - igstar SEE TYPICAL SECTIONS FOR MILLING THICKNESS.
- F. SEE ARTICLE 406.08 AND 406.14 OF THE STANDARD SPECIFICATIONS FOR "HMA AND/OR PCC SURFACE REMOVAL, BUTT JOINT".
- \*\*\* 20'-0" (6.1 m) PER 1 (25) RESURFACING (NOTE "A") 10'-0" (3.0 m) PER 1 (25) RESURFACING (NOTE "B")

#### **BASIS OF PAYMENT**

- THE BUTT JOINT WILL BE PAID FOR AT THE CONTRACT UNIT PRICE PER SQUARE YARD (SQUARE METER) FOR "HOT-MIX ASPHALT SURFACE REMOVAL - BUTT JOINT" OR FOR "PORTLAND CEMENT CONCRETE SURFACE REMOVAL- BUTT JOINT".
- THE TEMPORARY RAMP AND SAW CUT SHALL BE INCLUDED IN THE UNIT COST FOR HMA OR PCC SURFACE REMOVAL-BUTT JOINT.


ALL DIMENSIONS ARE IN INCHES (MILLIMETERS) UNLESS OTHERWISE SHOWN.

COUNTY

MCHENRY

20

CONTRACT NO. 61J98

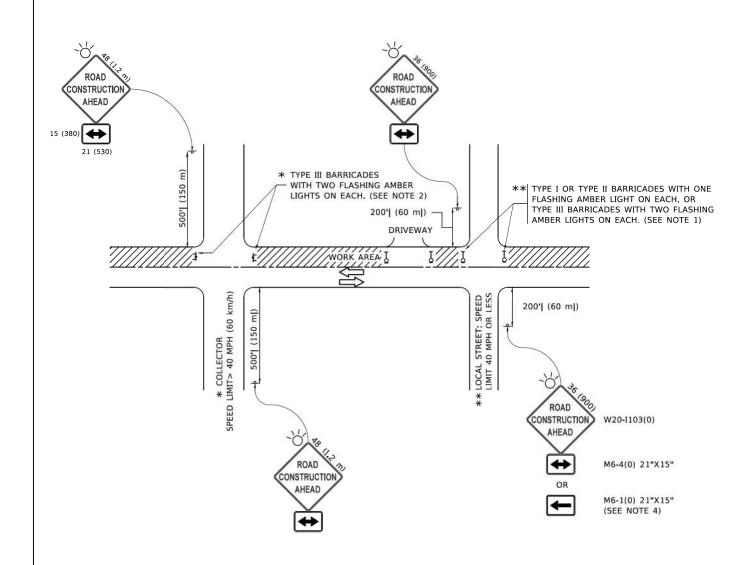

#### NOTES:

- SIDE ROAD WITH A SPEED LIMIT OF 40 MPH (60 km/h) OR LESS AS SHOWN ON THE DRAWING AND AS DIRECTED BY THE ENGINEER:
- a) ONE "ROAD CONSTRUCTION AHEAD" SIGN 36 x 36 (900x900) WITH A FLASHER MOUNTED ON IT APPROXIMATELY 200' (60 m) IN ADVANCE OF THE MAIN ROUTE.
- b) THE CLOSED PORTION OF THE MAIN ROUTE SHALL BE PROTECTED BY BLOCKING WITH TYPE I, TYPE II OR TYPE III BARRICADES, 1/3 OF THE CROSS SECTION OF THE CLOSED PORTION.
- SIDE ROAD WITH A SPEED LIMIT GREATER THAN 40 MPH (60 km/h) AS SHOWN ON THE DRAWING AND AS DIRECTED BY THE ENGINEER:
- a) ONE "ROAD CONSTRUCTION AHEAD" SIGN 48 x 48 (1.2 m x 1.2 m) WITH A FLASHER MOUNTED ON IT APPROXIMATELY 500" (150 m) IN ADVANCE OF THE MAIN ROUTE.
- THE CLOSED PORTION OF THE MAIN ROUTE SHALL BE PROTECTED BY

  b) BLOCKING WITH TYPE III BARRICADES, 1/2 OF THE CROSS SECTION

  OF THE CLOSED PORTION.
- CONES MAY BE SUBSTITUTED FOR BARRICADES OR DRUMS AT HALF THE SPACING DURING DAY OPERATIONS. CONES SHALL BE A MINIMUM OF 28 (710)
- WHEN THE SIDE ROAD LIES BETWEEN THE BEGINNING OF THE MAINLINE
  4. SIGNING AND THE WORK ZONE, A SINGLE HEADED ARROW (M6-1) SHALL
  BE USED IN LIEU OF THE DOUBLE HEADED ARROW (M6-4).

SCALE: NOTUS.

- WHEN WORK IS BEING PERFORMED ON A SIDE ROAD OR DRIVEWAY, FOLLOW THE APPLICABLE STANDARD(S). THE DIRECTIONAL ARROW (M6-1 OR M6-4) SHALL BE COVERED OR REMOVED WHEN NO LONGER CONSISTENT WITH THE TRAFFIC CONTROL SET-UP.
- ADVANCE WARNING SIGNS ARE TO BE OMITTED ON DRIVEWAYS UNLESS OTHERWISE SPECIFIED IN THE PLANS OR BY THE ENGINEER
- THE TRAFFIC CONTROL AND PROTECTION FOR SIDE ROADS, INTERSECTIONS, AND DRIVEWAYS SHALL BE INCLUDED IN THE COST OF SPECIFIED TRAFFIC CONTROL STANDARDS OR ITEMS.

All dimensions are in inches (millimeters) unless otherwise shown.

 USER NAME
 = footenj
 DESIGNED
 - LLSI.A.
 REVISED
 - A. HOUSEH 10-15-96

 DRAWN
 - DMS
 REVISED
 - T. RAMMACHER 01-06-00


 PLOT SCALE
 = 50.0000 ' / h.
 CHECKED
 REVISED
 - A. SCHUETZE 07-01-13

 PLOT DATE
 = 3/4/2019
 DATE
 06-89
 REVISED
 - A. SCHUETZE 09-15-16

STATE OF ILLINOIS
DEPARTMENT OF TRANSPORTATION

TRAFFIC CONTROL AND PROTECTION FOR SIDE ROADS, INTERSECTIONS, AND DRIVEWAYS

| SHEET 14 OF 17 SHEETS STA. TO ST

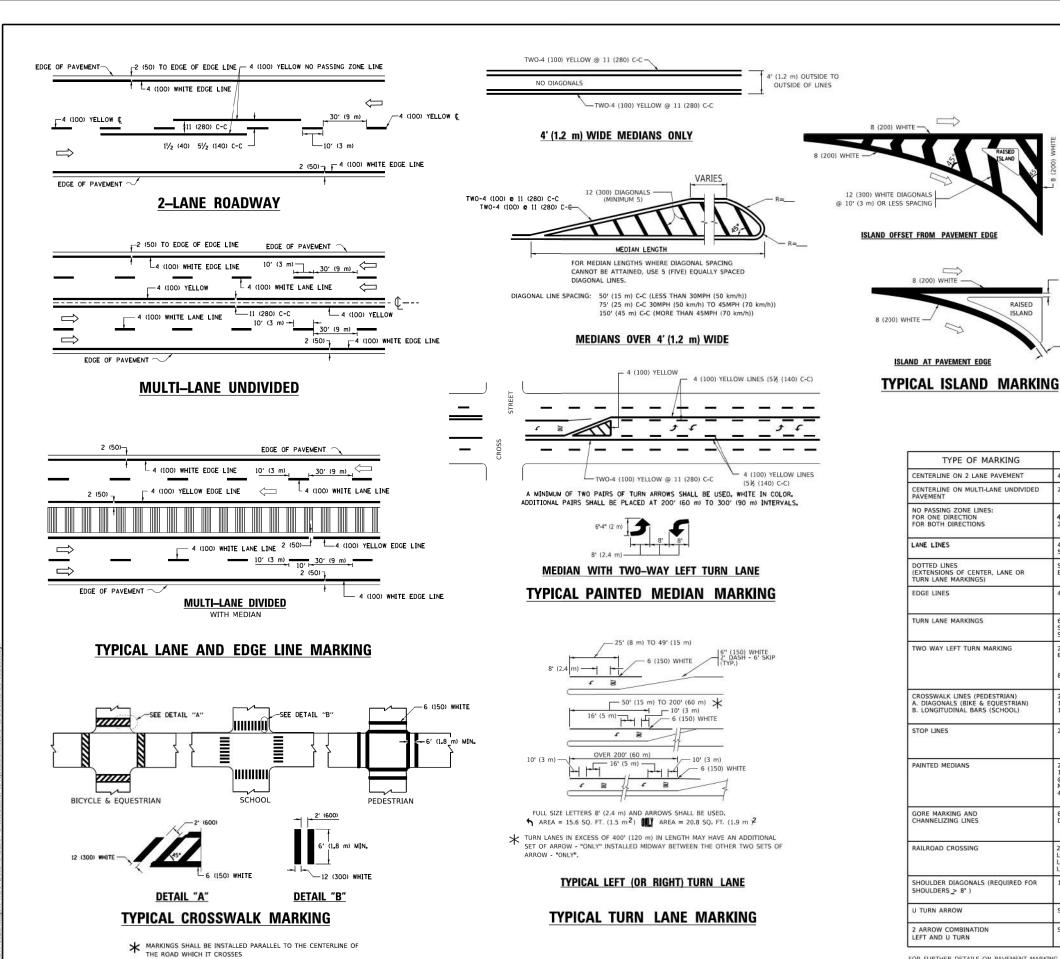

665 750 COMBINATION LEFT AND U-TURN 5'-4" (1620) T 32 R (810) LANE REDUCTION TRANSITION \* LANE REDUCTION ARROWS REQUIRED AT SPEEDS OF 45 MPH OF GREATER OR WHEN SPECIFIED IN PLANS. U-TURN PATTERN

D(FT)

SPEED LIMIT

TYPE OF MARKING WIDTH OF LINE COLOR SPACING / REMARKS CENTERLINE ON 2 LANE PAVEMENT YELLOW 10' (3 m) LINE WITH 30' (9 m) SPACE NO PASSING ZONE LINES: FOR ONE DIRECTION FOR BOTH DIRECTIONS 5½ (140) C-C FROM SKIP-DASH CENTERLINE 11 (280) C-C OMIT SKIP-DASH CENTERLINE BETWEEN LANE LINES SKIP-DASH SKIP-DASH 10' (3 m) LINE WITH 30' (9 m) SPACE (125) ON FREEWAYS DOTTED LINES SAME AS LINE BEING EXTENDED SKIP-DASH SAME AS LINE BEING EXTENDED 2' (600) LINE WITH 6' (1.8 m) SPACE (EXTENSIONS OF CENTER, LANE OR TURN LANE MARKINGS) EDGE LINES 4 (100) SOLID YELLOW-LEFT WHITE-RIGHT OUTLINE MEDIANS IN YELLOW 6 (150) LINE; FULL SIZE LETTERS & SYMBOLS (8' (2.4m)) TURN LANE MARKINGS SOLID SEE TYPICAL TURN LANE MARKING DETAIL WHITE TWO WAY LEFT TURN MARKING YELLOW 10' (3 m) LINE WITH 30' (9 m) SPACE FOR 2 @ 4 (100) EACH DIRECTION SKIP-DASH; 51/2 (140) C-C BETWEEN SOLID LINE AND SKIP-DASH LINE SEE TYPICAL TWO-WAY LEFT TURN MARKING DETAIL 3' (2.4m) LEFT ARROW CROSSWALK LINES (PEDESTRIAN) A. DIAGONALS (BIKE & EQUESTRIAN) B. LONGITUDINAL BARS (SCHOOL) NOT LESS THAN 6' (1.8 m) APART 2' (600) APART 2' (600) APART SEE TYPICAL CROSSWALK MARKING DETAILS. PLACE 4' (1.2 m) IN ADVANCE OF AND PARALLEL TO CROSSWALK, IF PRESENT. OTHERWISE, PLACE AT DESIRED STOPPING POINT. PARALLEL TO CROSSROAD CENTERLINE, WHERE STOP LINES 24 (600) SOLID WHITE 11 (280) C-C FOR THE DOUBLE LINE SEE TYPICAL PAINTED MEDIAN MARKING. PAINTED MEDIANS 2 @ 4 (100) WITH 12 (300) DIAGONALS SOLID YELLOW: TWO WAY TRAFFIC WHITE: ONE WAY TRAFFIC NO DIAGONALS USED FOR 4" (1.2 m) WIDE MEDIANS 8 (200) WITH 12 (300) DIAGONALS @ 45° SOLID DIAGONALS: 15' (4.5 m) C-C (LESS THAN 30MPH (50 km/h)) 20' (6 m) C-C 30MPH (50 km/h) TO 45MPH (70 km/h)) 30' (9 m) C-C (OVER 45MPH (70 km/h)) 24 (600) TRANSVERSE LINES; "RR" IS 6' (1.8 m) LETTERS; 16 (400) LINE FOR "X" RAILROAD CROSSING SOLID WHITE SEE STATE STANDARD 780001 50' (15 m) C-C (LESS THAN 30MPH (50 km/h)) 75' (25 m) C-C (30 MPH (50 km/h) TO 45MPH (70 km/h)) 150' (45 m) C-C (OVER 45MPH (70 km/h)) SHOULDER DIAGONALS (REQUIRED FOR SHOULDERS > 8') 12 (300) @ 45° SOLID WHITE - RIGHT YELLOW - LEFT U TURN ARROW SEE DETAIL SOLID WHITE 2 ARROW COMBINATION LEFT AND U TURN 30.4 SF

FOR FURTHER DETAILS ON PAVEMENT MARKING REFER TO STANDARD SPECIFICATIONS FOR ROAD AND BRIDGE CONSTRUCTION AND STATE STANDARD 780001.

SCALE NOTE

8 (200) WHITE -

2 (50)

2 (50)


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unless otherwise shown.

USER NAME = footemj	DESIGNED	-	<b>B</b> ₩ERS	REVISED	-	C. JUCIUS 09-09-09
	DRAWN	-	DMS	REVISED	-	C. JUCIUS 07-01-13
PLOT SCALE = 50.0000 ' / in.	CHECKED	-		REVISED	-	C. JUCIUS 12-21-15
PLOT DATE = 3/4/2019	DATE	-	03-19-90	REVISED	-	C. JUCIUS 04-12-16


STATE OF ILLINOIS **DEPARTMENT OF TRANSPORTATION** 

SECTION DISTRICT ONE 21-00018-00-RS MCHENRY 20 TYPICAL PAVEMENT MARKINGS TC-13 CONTRACT NO. 61J98 SHEET 15 OF 2 SHEETS STA.

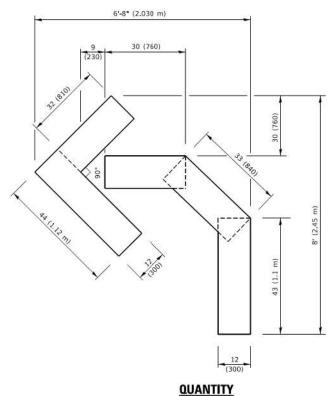

# 4 (100) LINE = 45.5 ft. (13.9 m)

4 (100) LINE = 45.5 ft. (13.9 m) 15.2 sq. ft. (1.41 sq. m)

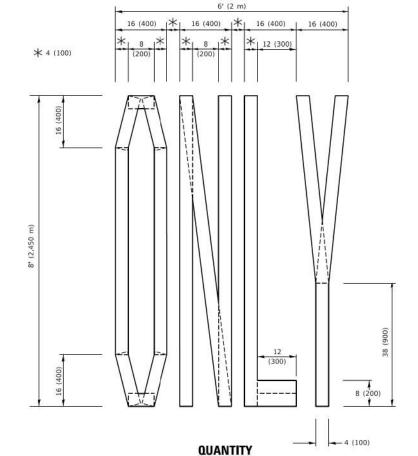

4 (100) LINE = 64.1 ft. (19.5 m) 21.4 sq. ft. (1.99 sq. m)

DRAWN

DATE


DESIGNED -

CHECKED -

- 09-18-94

USER NAME = footemj

PLOT DATE = 3/4/2019

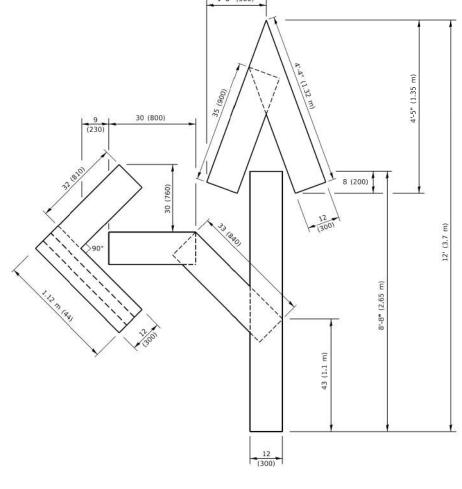


# QUANTITY

4 (100) LINE = 82.5 ft. (25.1 m) 27.5 sq. ft. (2.53 sq. m)

## NOTE:

ALL QUANTITIES OF PLACEMENT ARE REPRESENTED IN LINEAR FEET OF 4" LINES TO MATCH THE 4" TEMPORARY TAPE PAY ITEM AND REPRESENTS THE TOTAL QUANTITY OF 4" TAPE REQUIRED.

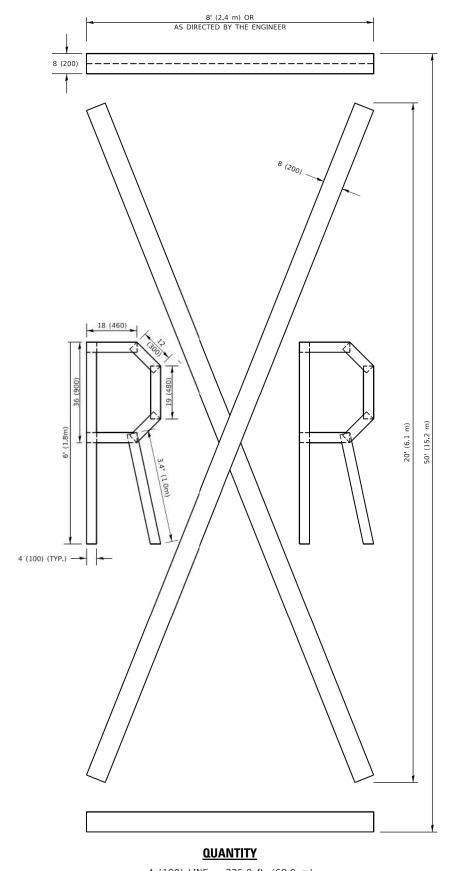

4 (100) LINE = 225.9 ft. (68.9 m) 75.3 sq. ft. (6.99 sq. m)

All dimensions are in inches (millimeters) unless otherwise shown.

REVISED - T. RAMMACHER 03-02-98

REVISED - E. GOMEZ 08-28-00

REVISED - E. GOMEZ 08-28-00

REVISED - A. SCHUETZE 09-15-16


STATE OF ILLINOIS
DEPARTMENT OF TRANSPORTATION

SCALE: NONE SHEET 1 OF 1 SHEETS STA. TO STA.

 
 F.A. RTE.
 SECTION
 COUNTY
 TOTAL SHEETS
 SHEETS NO.

 0157
 21-00018-00-RS
 MCHENRY
 20
 19

 TC-16
 CONTRACT NO.
 61J98

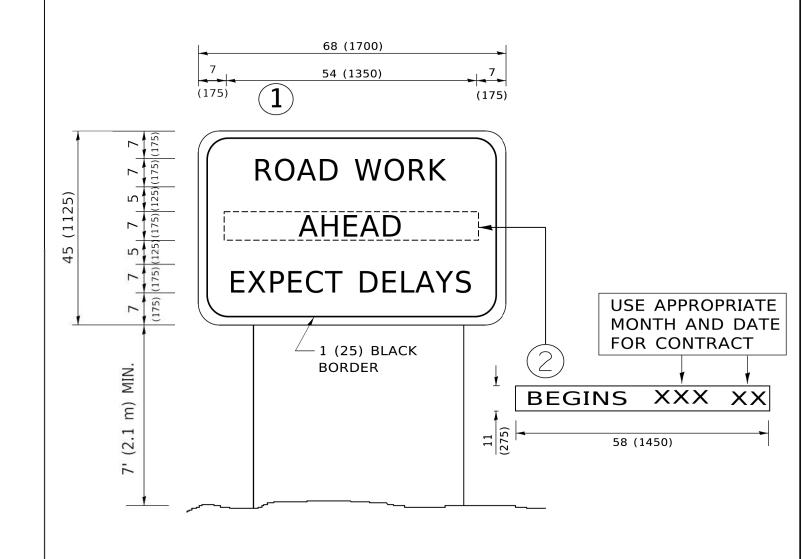

# NOTES:

- 1. USE BLACK LETTERING ON ORANGE BACKGROUND.
- 2. ERECT SIGNS IN ADVANCE OF THE LOCATION FOR THE "ROAD CONSTRUCTION AHEAD" SIGN AT LOCATIONS AS DIRECTED BY THE ENGINEER.
- 3. ERECT SIGN 1 WITH INSTALLED PANEL 2 ONE WEEK PRIOR TO THE START OF CONSTRUCTION.
- 4. REMOVE PANEL 2 SOON AFTER THE START OF CONSTRUCTION.
- 5. SEE SPECIAL PROVISION FOR "TEMPORARY INFORMATION SIGNING" FOR ADDITIONAL INFORMATION.
- 6. ONE SIGN ASSEMBLY EQUALS 25.70 SQ. FT. (2.3 SQ. M.)
- 7. SHALL BE PAID FOR AS TEMPORARY INFORMATION SIGNING.

ALL DIMENSIONS ARE IN INCHES (MILLIMETERS) UNLESS OTHERWISE SHOWN.

USER NAME = footemj	DESIGNED - JJS		CTATE OF HIMOIC		ARTERIAL ROAD		F.A. RTE.	SECTION	COUNTY	TOTAL SH SHEETS N	IO.
	DRAWN - DMS				INFORMATION SIGN		0157	21-00018-00-RS	MCHENRY	20 2	20
PLOT SCALE = 50.0000 ' / in.	CHECKED -	REVISED -T. RAMMACHER 02-02-99	DEPARTMENT OF TRANSPORTATION		INI ONIMATION SIGN		•	TC-22	CONTRACT	NO. 61J	98
PLOT DATE = 3/4/2019	DATE -	REVISED - C. JUCIUS 01-31-07		SCALE: NOTE	SHEET 17 OF 17 SHEETS STA.	TO STA.		ILLINOIS FED. AI	D PROJECT		
	PLOT SCALE = 50.0000 ' / in.	DRAWN - DMS   PLOT SCALE = 50.0000 ' / in.   CHECKED -	DRAWN - DMS   REVISED - R. MIRS 12-11-97	DRAWN - DMS REVISED - R. MIRS 12-11-97  PLOT SCALE = 50.0000 ' / ib. CHECKED - REVISED - T. RAMMACHER 02-02-99  DEPARTMENT OF TRANSPORTATION	DRAWN - DMS REVISED - R. MIRS 12-11-97  PLOT SCALE = 50.0000 ' / in. CHECKED - REVISED - T. RAMMACHER 02-02-99  DEPARTMENT OF TRANSPORTATION  STATE OF ILLINOIS  DEPARTMENT OF TRANSPORTATION	DRAWN - DMS REVISED - R. MIRS 12-11-97  PLOT SCALE = 50.0000 1 / ib. CHECKED - REVISED - T. RAMMACHER 02-02-99  REVISED - T. RAMMACHER 02-02-99  DEPARTMENT OF TRANSPORTATION  ARTERIAL ROAD INFORMATION SIGN	DRAWN - DMS REVISED - R. MIRS 12-11-97  PLOT SCALE = 50.0000 ' / h. CHECKED - REVISED - T. RAMMACHER 02-02-99  DEPARTMENT OF TRANSPORTATION  ARTERIAL ROAD  INFORMATION SIGN	DRAWN - DMS REVISED - R. MIRS 12-11-97  PLOT SCALE = 50.0000 '/ h. CHECKED - REVISED - R. RAMMACHER 02-02-99  REVISED - T. RAMMACHER 02-02-99  DEPARTMENT OF TRANSPORTATION  ARTERIA ROAD  INFORMATION SIGN  REVISED - T. RAMMACHER 02-02-99	DRAWN - DMS REVISED - R. MIRS 12-11-97  PLOT SCALE = 50.0000 '/ h. CHECKED - REVISED - T. RAMMACHER 02-02-99  DESIGNATE - MIRS 19-13-97  STATE OF ILLINOIS  INFORMATION SIGN  TC-22	DRAWN - DMS REVISED - R. MIRS 12-11-97  PLOT SCALE = 50.0000 '/ h. CHECKED - REVISED - T. RAMMACHER 02-02-99  DESCRIPTION SIGN  ARTERIAL ROAD  NTE. SECTION COUNTY  1NFORMATION SIGN  TC-22 CONTRACT	DRAWN   DMS   REVISED   T. RAMMACHER 02-02-99