

# **CONSTRUCTION PLANS**

# RECONSTRUCT SELECT PORTIONS OF AIRPORT TERMINAL ENTRANCE ROAD

DECATUR PARK DISTRICT
DECATUR AIRPORT (DEC)
DECATUR, MACON COUNTY, ILLINOIS
IDA PROJECT NO.: DEC-4822

100% PLANS: NOVEMBER 17, 2023

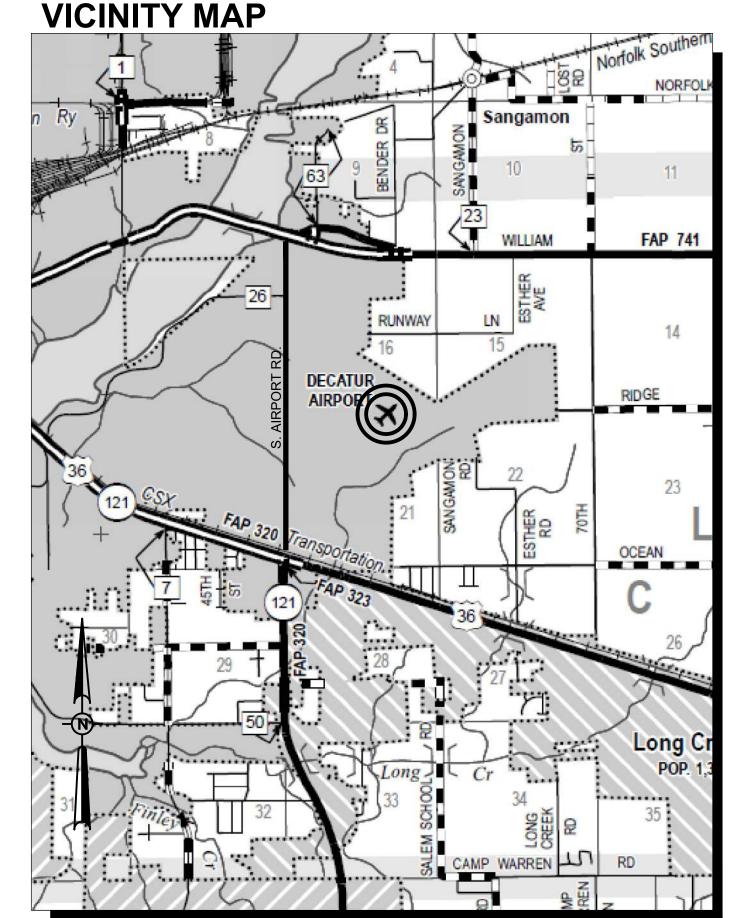


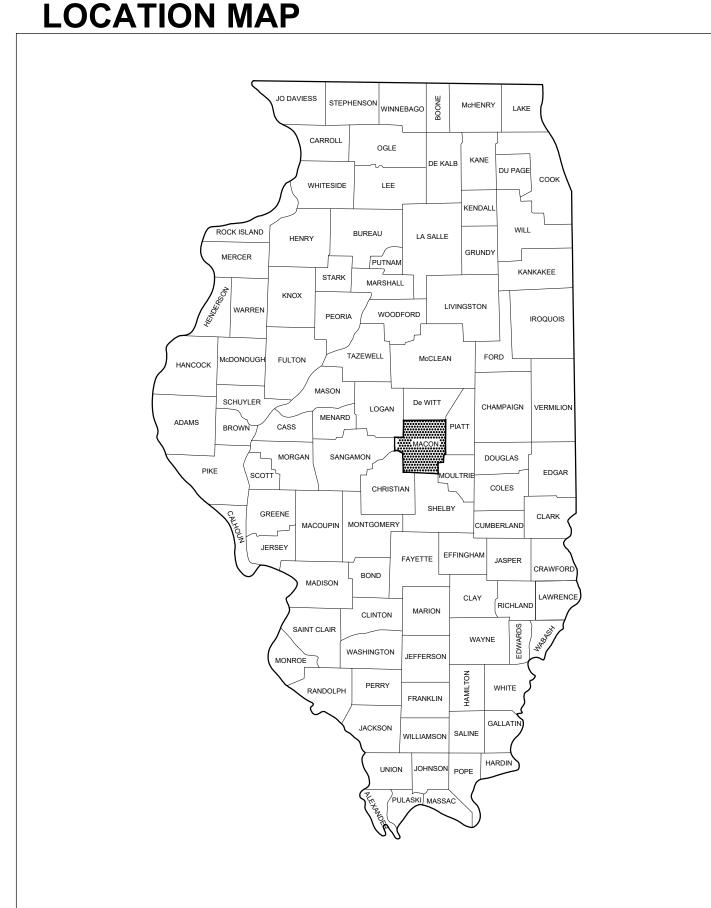

NOTICE TO CONTRACTORS AND BIDDERS

THESE CONSTRUCTION PLANS RELY UPON THE PROJECT MANUAL AND THE REFERENCED SPECIFICATIONS TO PROVIDE FOR A COMPLETE DESCRIPTION OF THE WORK AND CONSTRUCTION REQUIREMENTS. THE PLANS SHALL ONLY BE USED IN COMBINATION WITH ALL CONTRACT DOCUMENTS.



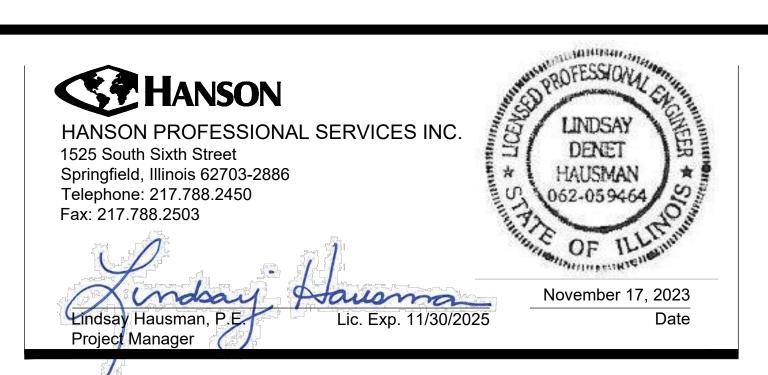



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	SUMMARY OF QUANTITI	ES - BASE BID		
ITEM NO.	DESCRIPTION	UNIT	TOTAL QUANTITY	AS-BUILT QUANTITY
AR150510	ENGINEER'S FIELD OFFICE	L SUM	1	
AR150520	MOBILIZATION	L SUM	1	
AR150530	TRAFFIC MAINTENANCE	L SUM	1	
AR152540	SOIL STABILIZATION FABRIC	SQ YD	1,602	
AR209604	CRUSHED AGG. BASE COURSE-4"	SQ YD	1,602	
AR209606	CRUSHED AGG. BASE COURSE-6"	SQ YD	24	
AR501508	8" PCC PAVEMENT	SQ YD	1,602	
AR501530	PCC TEST BATCH	EACH	1	
AR501605	5" PCC SIDEWALK	SQ FT	216	
AR501690	PCC SIDEWALK REMOVAL	SQ FT	216	
AR501905	REMOVE PAVEMENT	SQ YD	1,602	
AR620520	PAVEMENT MARKING-WATERBORNE	SQ FT	498	
AR751411	INLET-TYPE A	EACH	1	
AR751900	REMOVE INLET	EACH	1	
AR751927	REPLACE FRAME & GRATE	EACH	1	
AR754924	REPLACE COMB CURB & GUTTER	FOOT	45	

SUMMARY OF QUANTITIES - ADDITIVE ALTERNATE 1					
ITEM NO. DESCRIPTION UNIT TOTAL AS-BUILT					
TTEIVINO.	DESCRIPTION	ONT	QUANTITY	QUANTITY	
AS152540	SOIL STABILIZATION FABRIC	SQ YD	194		
AS209604	CRUSHED AGG. BASE COURSE-4"	SQ YD	194		
AS501508	8" PCC PAVEMENT	SQ YD	194		
AS501905	REMOVE PAVEMENT	SQ YD	194		

SUMMARY OF QUANTITIES - ADDITIVE ALTERNATE 2					
ITEM NO.	DESCRIPTION	UNIT	TOTAL QUANTITY	AS-BUILT QUANTITY	
AT152540	SOIL STABILIZATION FABRIC	SQ YD	178		
AT209604	CRUSHED AGG. BASE COURSE-4"	SQ YD	178		
AT501508	8" PCC PAVEMENT	SQ YD	178		
AT501905	REMOVE PAVEMENT	SQ YD	178		

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RECONSTRUCT SELECT PORTIONS OF THE AIRPORT TERMINAL **ENTRANCE ROAD** 

Illinois Proj. No.: DEC-4822


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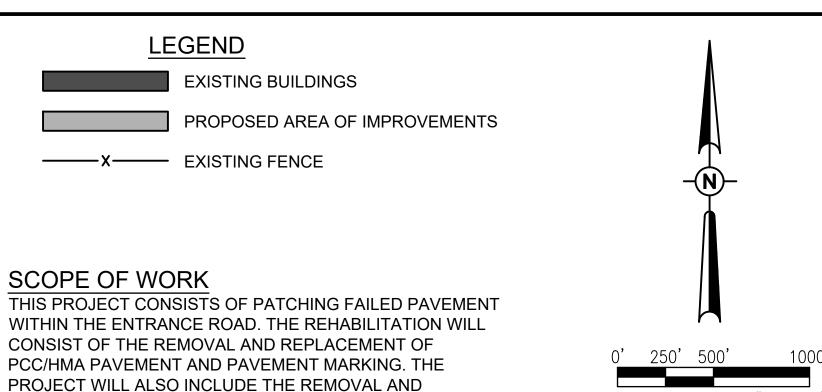
DESIGN BY: HLE 04/07/2023 DRAWN BY: HLE 04/07/2023

REVIEWED BY: LDH 11/2/23

SHEET TITLE

SUMMARY OF **QUANTITIES AND** INDEX OF SHEETS



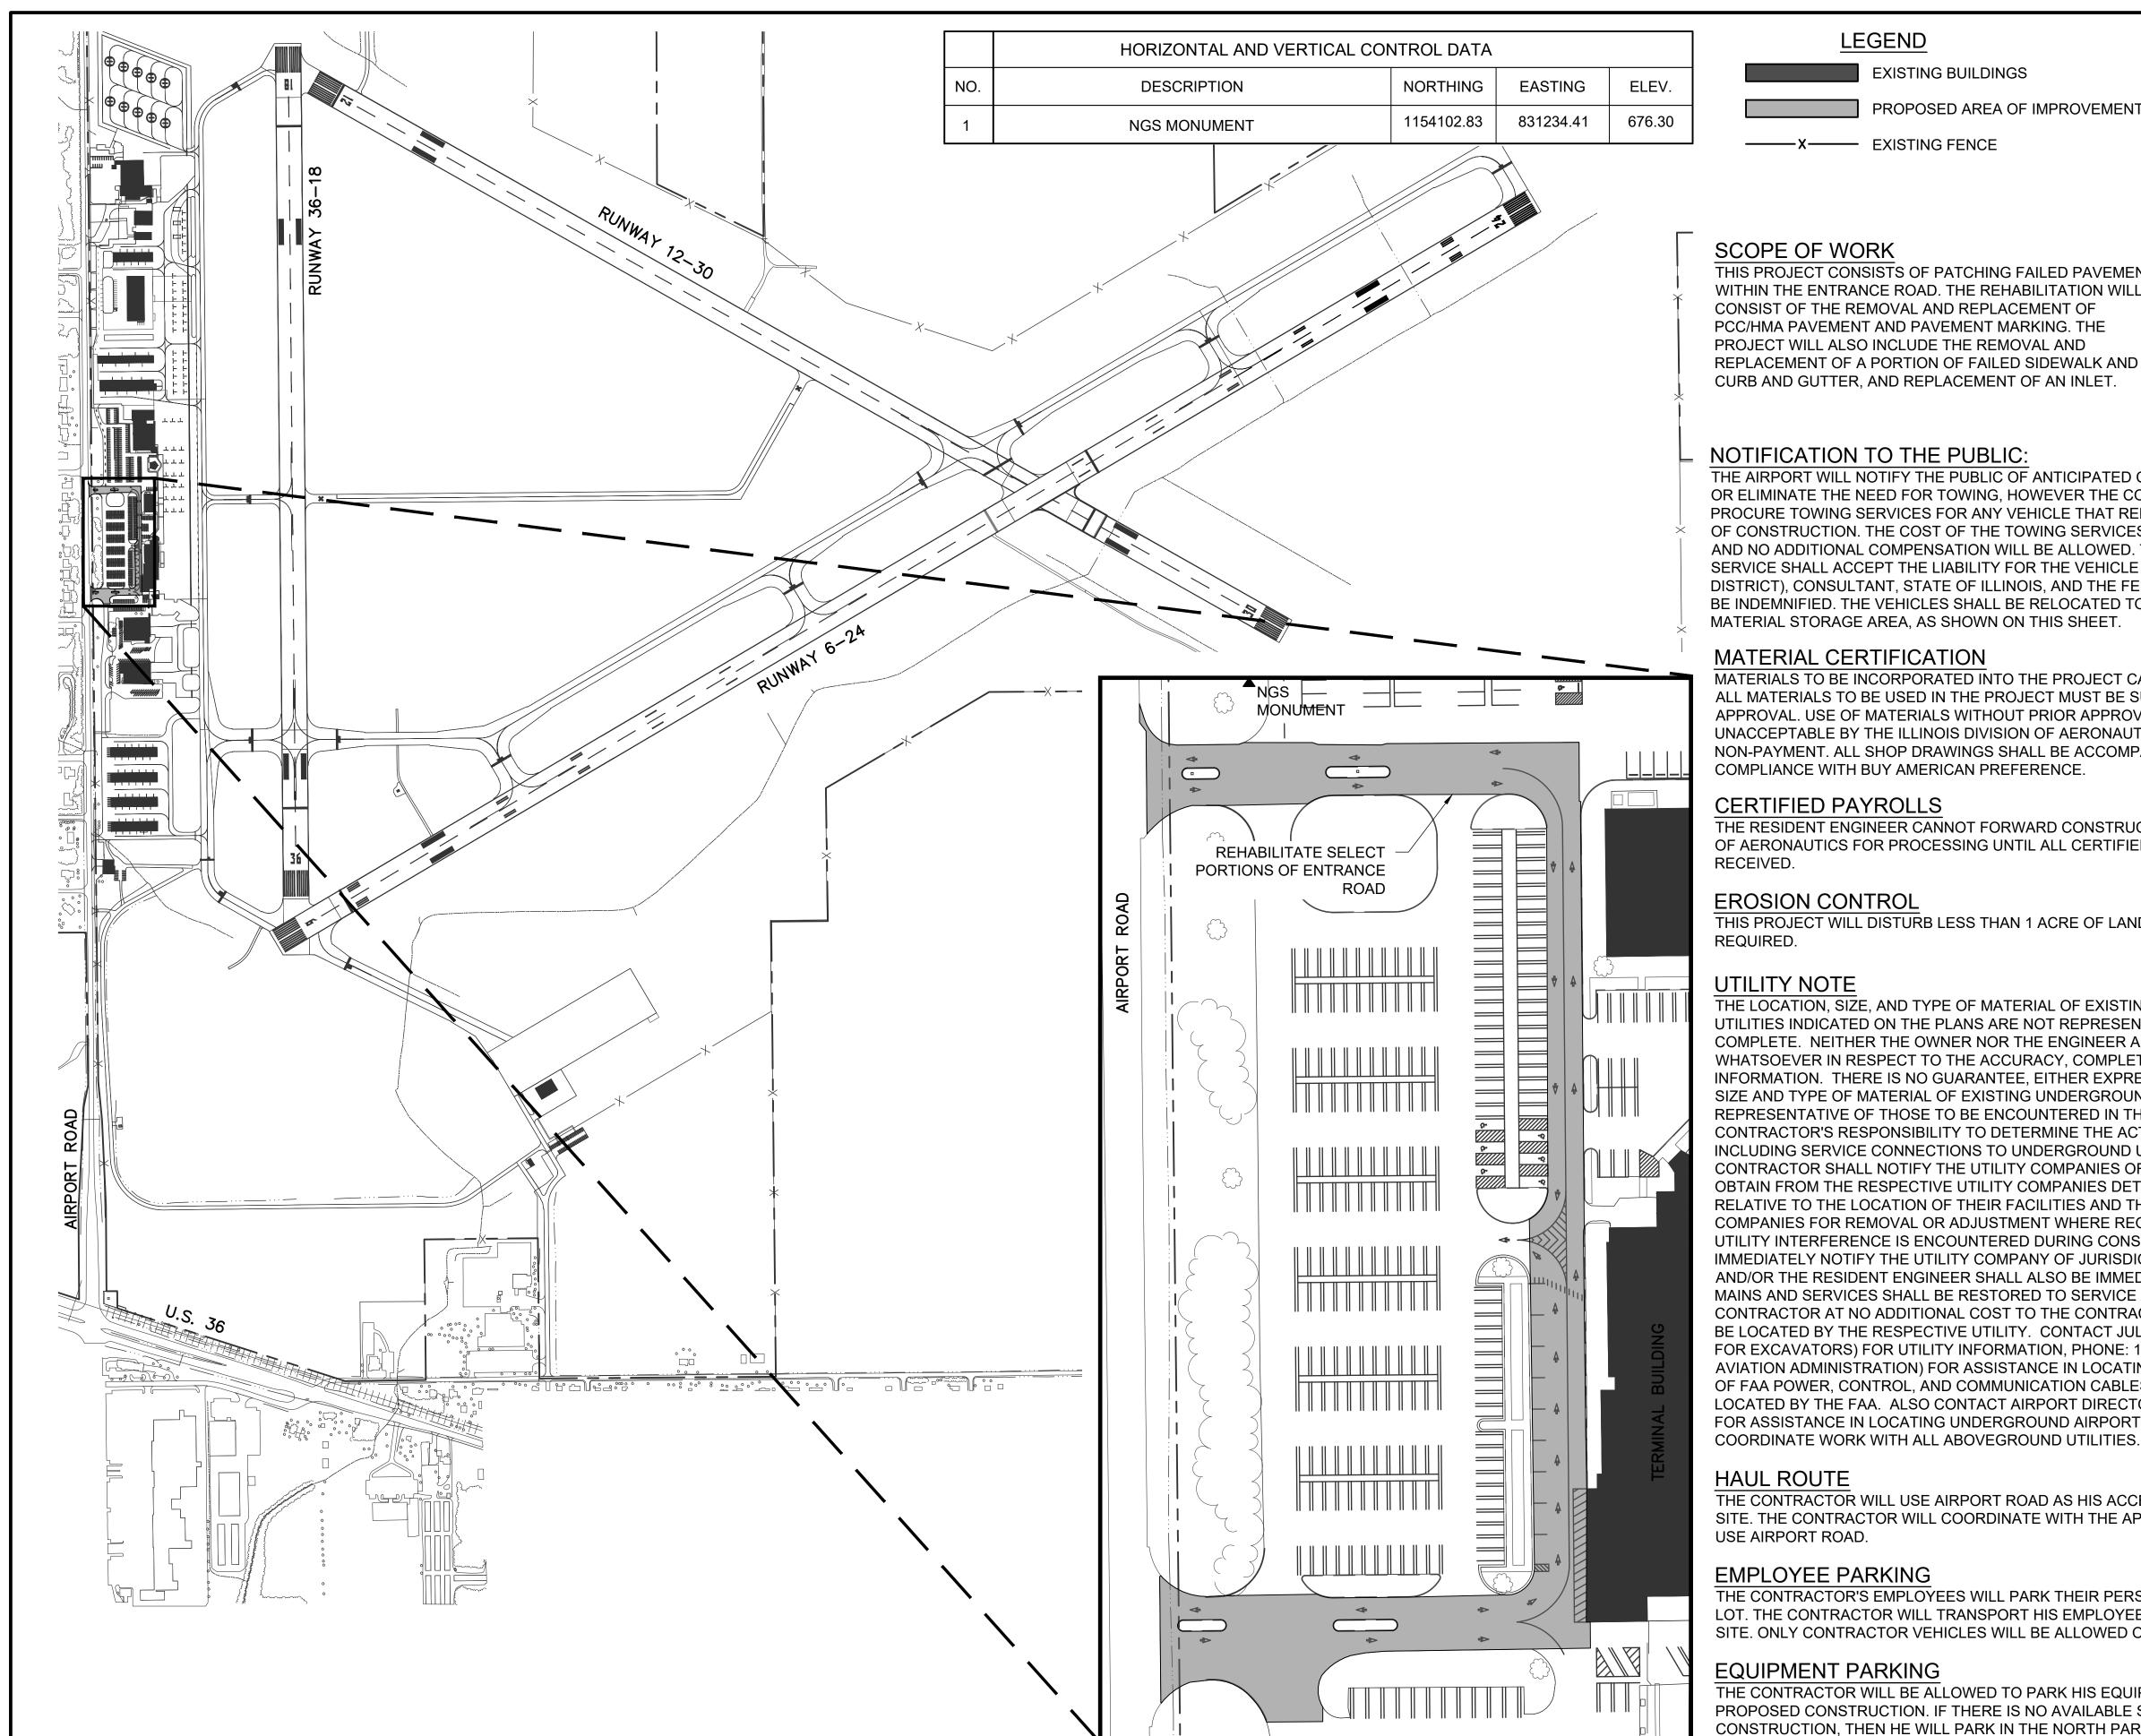

HALF SIZE SCALE: 1"= 1000'

FULL SIZE SCALE: 1"= 500'

#### NOTIFICATION TO THE PUBLIC:

THE AIRPORT WILL NOTIFY THE PUBLIC OF ANTICIPATED CONSTRUCTION IN AN EFFORT TO REDUCE OR ELIMINATE THE NEED FOR TOWING, HOWEVER THE CONTRACTOR SHALL BE REQUIRED TO PROCURE TOWING SERVICES FOR ANY VEHICLE THAT REMAINS IN THE PROJECT AREA AT THE TIME OF CONSTRUCTION. THE COST OF THE TOWING SERVICES SHALL BE INCIDENTAL TO THE CONTRACT AND NO ADDITIONAL COMPENSATION WILL BE ALLOWED. THE CONTRACTOR AND/OR THE TOWING SERVICE SHALL ACCEPT THE LIABILITY FOR THE VEHICLE RELOCATION, AND THE AIRPORT (PARK DISTRICT), CONSULTANT, STATE OF ILLINOIS, AND THE FEDERAL AVIATION ADMINISTRATION SHALL BE INDEMNIFIED. THE VEHICLES SHALL BE RELOCATED TO THE CONTRACTOR EQUIPMENT PARKING & MATERIAL STORAGE AREA. AS SHOWN ON THIS SHEET.

#### MATERIAL CERTIFICATION

MATERIALS TO BE INCORPORATED INTO THE PROJECT CANNOT BE USED WITHOUT PRIOR APPROVAL ALL MATERIALS TO BE USED IN THE PROJECT MUST BE SUBMITTED TO THE RESIDENT ENGINEER FOR APPROVAL. USE OF MATERIALS WITHOUT PRIOR APPROVAL AND ULTIMATELY DETERMINED TO BE UNACCEPTABLE BY THE ILLINOIS DIVISION OF AERONAUTICS ARE SUBJECT TO REMOVAL AND/OR NON-PAYMENT. ALL SHOP DRAWINGS SHALL BE ACCOMPANIED BY DOCUMENTATION INDICATING COMPLIANCE WITH BUY AMERICAN PREFERENCE.

#### **CERTIFIED PAYROLLS**

THE RESIDENT ENGINEER CANNOT FORWARD CONSTRUCTION REPORTS TO THE ILLINOIS DIVISION OF AERONAUTICS FOR PROCESSING UNTIL ALL CERTIFIED PAYROLLS FOR THE PERIOD HAVE BEEN RECEIVED.

#### **EROSION CONTROL**

THIS PROJECT WILL DISTURB LESS THAN 1 ACRE OF LAND, THEREFORE NO N.P.D.E.S. PERMIT WILL BE REQUIRED.

#### UTILITY NOTE

THE LOCATION, SIZE, AND TYPE OF MATERIAL OF EXISTING UNDERGROUND AND/OR ABOVEGROUND UTILITIES INDICATED ON THE PLANS ARE NOT REPRESENTED AS BEING ACCURATE, SUFFICIENT OR COMPLETE. NEITHER THE OWNER NOR THE ENGINEER ASSUMES ANY RESPONSIBILITY WHATSOEVER IN RESPECT TO THE ACCURACY, COMPLETENESS, OR SUFFICIENCY OF THE INFORMATION. THERE IS NO GUARANTEE, EITHER EXPRESSED OR IMPLIED, THAT THE LOCATIONS, SIZE AND TYPE OF MATERIAL OF EXISTING UNDERGROUND UTILITIES INDICATED ARE REPRESENTATIVE OF THOSE TO BE ENCOUNTERED IN THE CONSTRUCTION. IT SHALL BE THE CONTRACTOR'S RESPONSIBILITY TO DETERMINE THE ACTUAL LOCATION OF ALL SUCH FACILITIES, INCLUDING SERVICE CONNECTIONS TO UNDERGROUND UTILITIES. PRIOR TO CONSTRUCTION, THE CONTRACTOR SHALL NOTIFY THE UTILITY COMPANIES OF HIS OPERATIONAL PLANS AND SHALL OBTAIN FROM THE RESPECTIVE UTILITY COMPANIES DETAILED INFORMATION AND ASSISTANCE RELATIVE TO THE LOCATION OF THEIR FACILITIES AND THE WORKING SCHEDULE OF THE COMPANIES FOR REMOVAL OR ADJUSTMENT WHERE REQUIRED. IN THE EVENT AN UNEXPECTED UTILITY INTERFERENCE IS ENCOUNTERED DURING CONSTRUCTION, THE CONTRACTOR SHALL IMMEDIATELY NOTIFY THE UTILITY COMPANY OF JURISDICTION. THE OWNER'S REPRESENTATIVE AND/OR THE RESIDENT ENGINEER SHALL ALSO BE IMMEDIATELY NOTIFIED. ANY DAMAGE TO SUCH MAINS AND SERVICES SHALL BE RESTORED TO SERVICE AT ONCE AND PAID FOR BY THE CONTRACTOR AT NO ADDITIONAL COST TO THE CONTRACT. ALL UTILITY CABLES AND LINES SHALL BE LOCATED BY THE RESPECTIVE UTILITY. CONTACT JULIE (JOINT UTILITY LOCATION INFORMATION FOR EXCAVATORS) FOR UTILITY INFORMATION, PHONE: 1-800-892-0123. CONTACT THE FAA (FEDERAL AVIATION ADMINISTRATION) FOR ASSISTANCE IN LOCATING FAA CABLES AND UTILITIES. LOCATION OF FAA POWER, CONTROL, AND COMMUNICATION CABLES SHALL BE COORDINATED WITH AND/OR LOCATED BY THE FAA. ALSO CONTACT AIRPORT DIRECTOR/MANAGER AND AIRPORT PERSONNEL FOR ASSISTANCE IN LOCATING UNDERGROUND AIRPORT CABLES AND/OR UTILITIES. ALSO COORDINATE WORK WITH ALL ABOVEGROUND UTILITIES.

#### HAUL ROUTE

THE CONTRACTOR WILL USE AIRPORT ROAD AS HIS ACCESS TO THE PROPOSED CONSTRUCTION SITE. THE CONTRACTOR WILL COORDINATE WITH THE APPROPRIATE AUTHORITIES IN ORDER TO USE AIRPORT ROAD.

#### EMPLOYEE PARKING

THE CONTRACTOR'S EMPLOYEES WILL PARK THEIR PERSONAL VEHICLES IN THE NORTH PARKING LOT. THE CONTRACTOR WILL TRANSPORT HIS EMPLOYEES TO THE PROPOSED CONSTRUCTION SITE. ONLY CONTRACTOR VEHICLES WILL BE ALLOWED ON THE PROPOSED CONSTRUCTION SITE.

#### **EQUIPMENT PARKING**

THE CONTRACTOR WILL BE ALLOWED TO PARK HIS EQUIPMENT WITHIN THE LIMITS OF THE PROPOSED CONSTRUCTION. IF THERE IS NO AVAILABLE SPACE WITHIN THE PROPOSED CONSTRUCTION, THEN HE WILL PARK IN THE NORTH PARKING LOT AT A LOCATION DESIGNATED BY THE AIRPORT DIRECTOR.



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decatur AIRPORT A Decatur Park District Proper

**Decatur Park District** Decatur Airport 910 South Airport Road Decatur, IL 62521

RECONSTRUCT SELECT PORTIONS OF THE AIRPORT TERMINAL **ENTRANCE ROAD** 

Illinois Proj. No.: DEC-4822


NO.	DATE	DESCRIPTION		
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ISSUE: NOVEMBER 17, 2023				

PROJECT NO: 22A0100D CAD FILE: G-003-SFY.DWG DESIGN BY: HLE 04/07/2023

DRAWN BY: HLE 04/07/2023 REVIEWED BY: LDH 11/2/23

SHEET TITLE

PROJECT LAYOUT

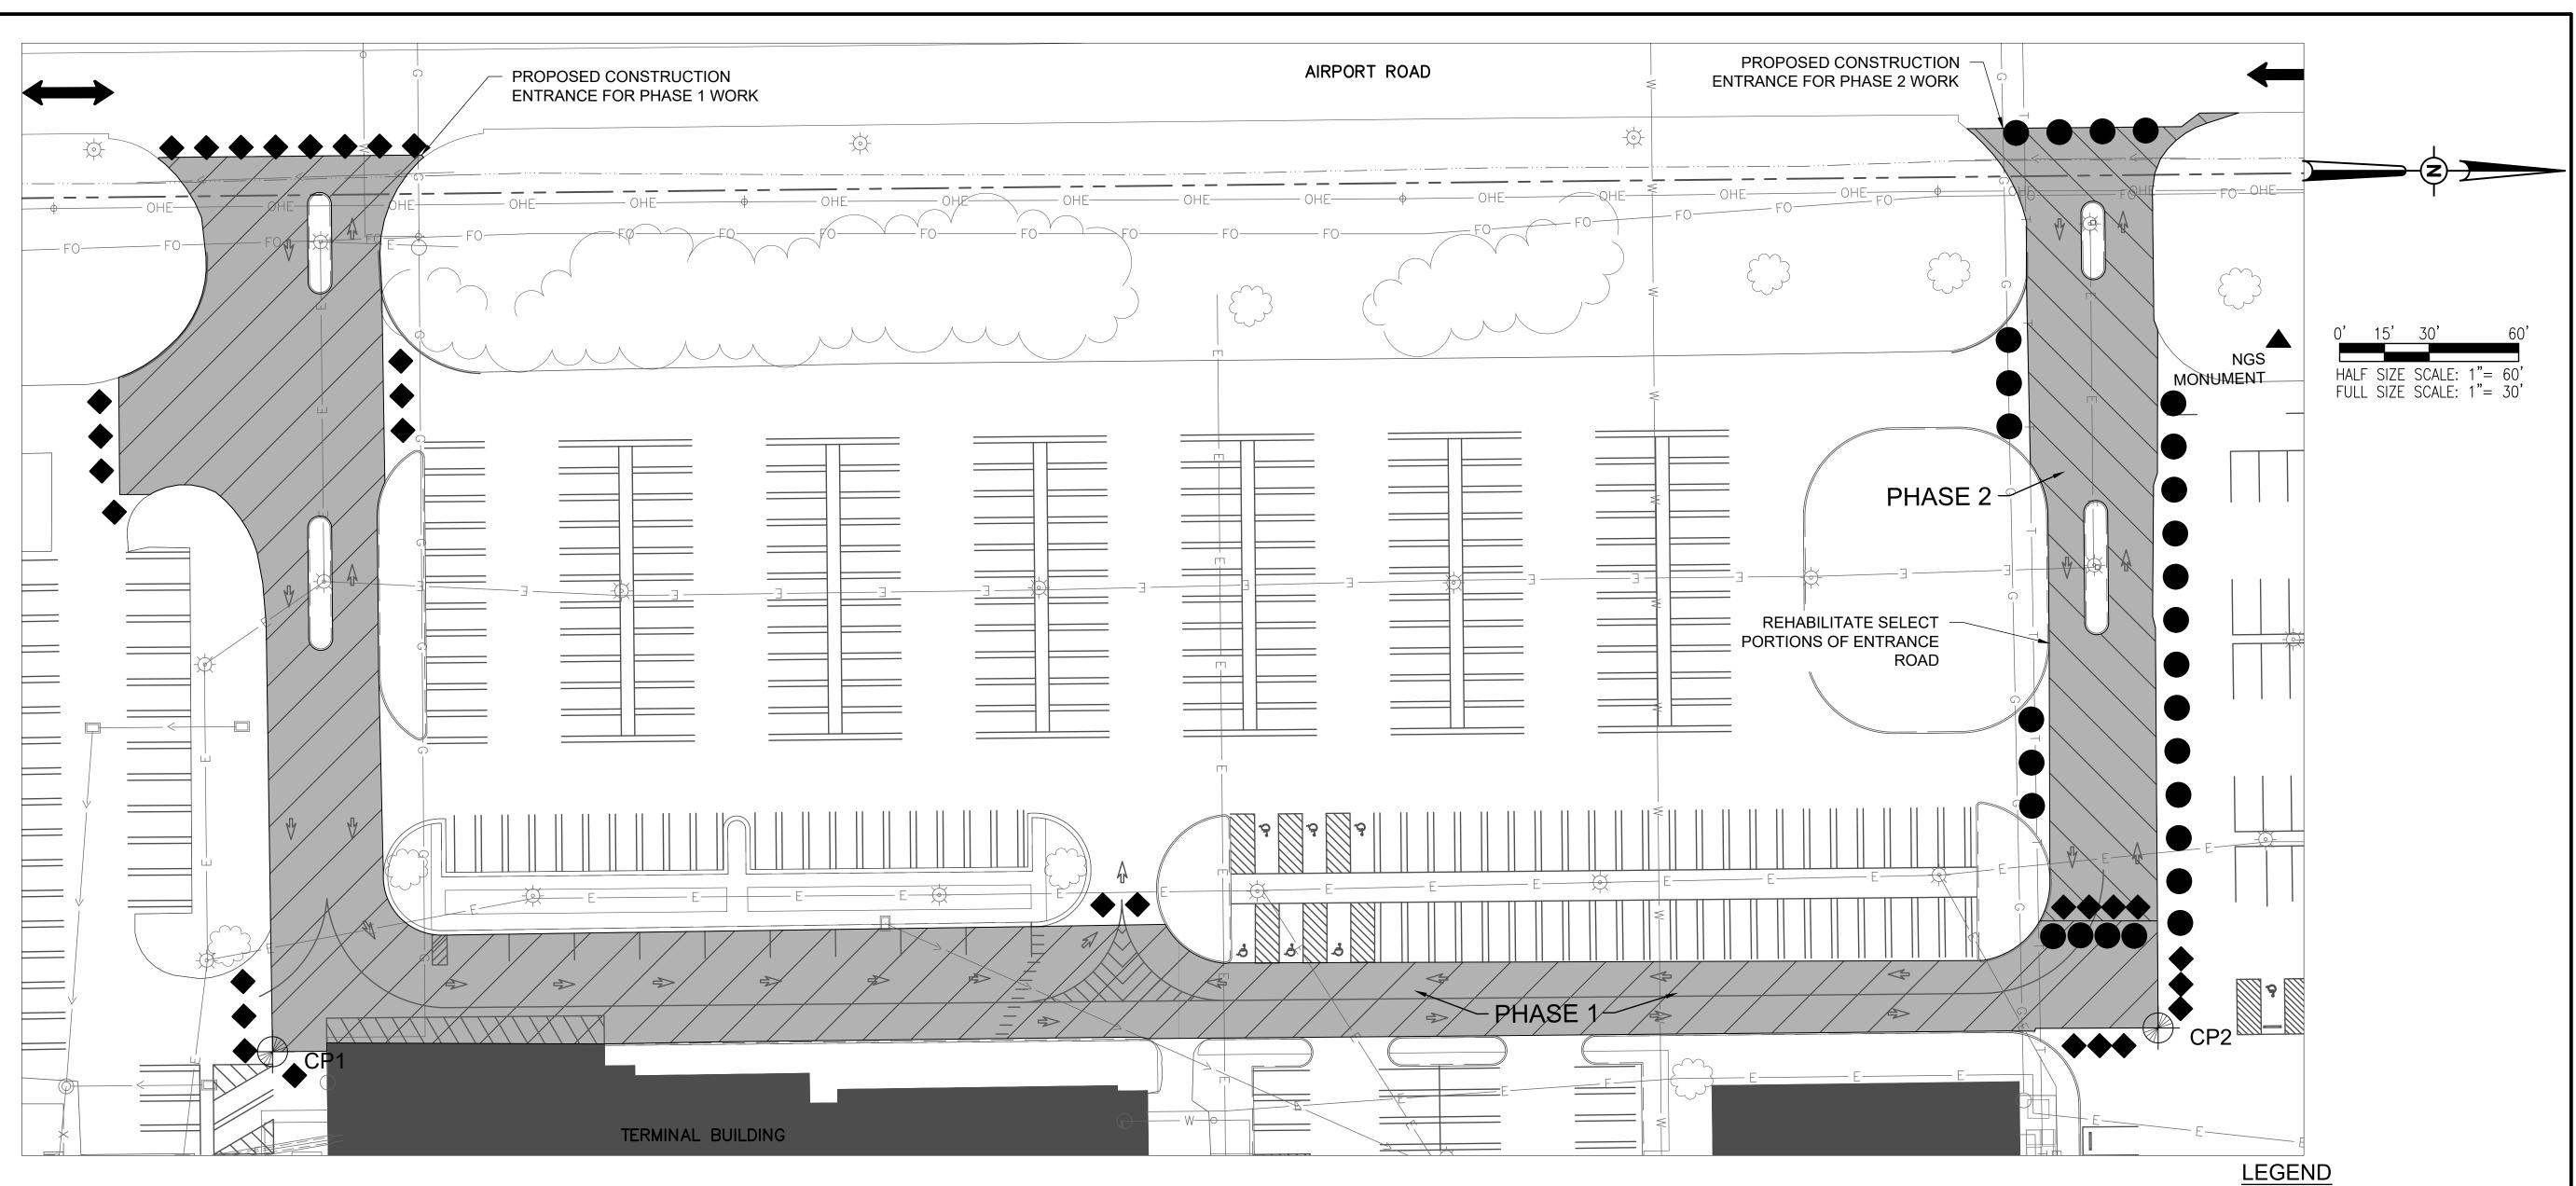

#### PROPOSED SAFETY PLAN

- 1. GENERAL THE DECATUR AIRPORT IS COMPRISED OF THREE RUNWAYS. THE PROPOSED CONSTRUCTION WILL NOT NECESSITATE CLOSING ANY RUNWAYS.
- 2. ALL PROVISIONS OF THE LATEST EDITION OF FAA ADVISORY CIRCULAR 150/5370-10, "OPERATIONAL SAFETY ON AIRPORTS DURING CONSTRUCTION" APPLY TO THIS CONTRACT, EXCEPT AS MODIFIED BY THIS SAFETY PLAN AND APPROVED BY THE FAA AND THE AIRPORT.
- 3. THE CONTRACTOR WILL BE REQUIRED TO SUBMIT TO THE RESIDENT ENGINEER, FOR APPROVAL BY THE AIRPORT DIRECTOR, A SCHEDULE OF CONSTRUCTION ACTIVITIES PRIOR TO THE START OF CONSTRUCTION. CLOSURE OF ANY PORTION OF AIRPORT ROAD BEGINNING AND ENDING TIMES WILL BE DETERMINED BY THE AIRPORT DIRECTOR. THE CONTRACTOR IS REQUIRED TO ALLOW SUFFICIENT TIME PRIOR TO THE ENDING OF THE CLOSURE TIME FOR CURING OF PLACED MATERIALS AND CLEAN UP OF THE WORK AREA.
- 4. THE CONTRACTOR IS REQUIRED TO NOTIFY THE AIRPORT DIRECTOR THROUGH THE RESIDENT ENGINEER, A MINIMUM OF 7 DAYS PRIOR TO THE START OF CONSTRUCTION.
- 5. THE INTENT OF THE PROPOSED WORK AREAS IS FOR THE CONTRACTOR TO START AND COMPLETE WORK IN PHASE 1 FIRST AND THEN PHASE 2. THE CONTRACTOR MAY NOT PROCEED TO THE NEXT WORK AREA UNTIL EACH AREA IS APPROVED BY THE OWNER TO BE OPENED TO TRAFFIC.
- 6. THE AWARDED CONTRACTOR MAY PROPOSE AN ALTERNATE, PRACTICAL AND EFFECTIVE STAGING PLAN THAT WILL MINIMIZE DISRUPTION TO NORMAL AIRPORT ACTIVITY WHILE NOT COMPROMISING SAFETY OF PERSONNEL OR THE QUALITY OF THE PROJECT. SUCH AN ALTERNATE PROPOSAL WILL BE CONSIDERED BY THE OWNER FOR APPROVAL.

#### **CONTRACTOR RESPONSIBILITIES**

- 1. THE CONTRACTOR AND HIS EMPLOYEES WILL BE RESTRICTED TO THE WORK AREA AND ALL OTHER AREAS OF THE AIRPORT ARE "OFF LIMITS" TO THEM.
- 2. THE CONTRACTOR SHALL MAINTAIN FULL USE AND ACCESS TO ALL ADMINISTRATIVE AND PARKING AREAS NOT UNDER ACTIVE CONSTRUCTION FOR THE DURATION OF THE PROJECT.
- 3. TRENCHES AND/OR HOLES THAT REMAIN OPEN OVERNIGHT WILL REQUIRE BARRICADES AND/OR CONES TO INDICATE THEIR LOCATION AND PREVENT ACCIDENTAL ENTRANCE, WITHIN THE PROJECT AREA AND OUTSIDE ANY ACTIVE SAFETY AREAS.
- 4. IDENTIFICATION WHEN THE CONTRACTORS VEHICLES AND EQUIPMENT ARE ON THE AIRPORT THEY SHALL BE PROPERLY MARKED WITH THREE (3') FOOT SQUARE CHECKERED FLAGS (INTERNATIONAL ORANGE AND WHITE). THE CONTRACTOR WILL ALSO PROVIDE WORKERS WITH SOME TYPE OF TAG OR GARMENT TO IDENTIFY THE PERSON AS BEING PART OF THE CONSTRUCTION CREW.

POINT # DESCRIPTION | ELEVATION

BARRICADES

BARRICADES

CRITICAL POINTS

667

LATITUDE

039° 49' 57.49"

039° 50' 03.74"

#### HEIGHT OF CONSTRUCTION EQUIPMENT

THE MAXIMUM ANTICIPATED HEIGHT OF THE CONSTRUCTION EQUIPMENT WILL BE 20 FEET. THE TALLEST EQUIPMENT IS EXPECTED TO BE A SEMI-TRUCK AND TRAILER.

#### NOTE

LONGITUDE

-088° 52' 38.36"

-088° 52' 38.51"

CONTRACTOR SHALL BE RESPONSIBLE FOR CONSTRUCTION SIGNAGE AND MAINTENANCE OF TRAFFIC ON AIRPORT ROAD DURING CONSTRUCTION IN ACCORDANCE WITH MUTCD AND/OR LOCAL REQUIREMENTS. DURING WORK HOURS, MAINTAIN A MINIMUM OF ONE LANE OPEN TO TRAFFIC ON AIRPORT RD. DURING NON-WORK HOURS, AIRPORT ROAD SHALL REMAIN UNOBSTRUCTED.

ALL CONSTRUCTION/OPERATIONS ARE TO BE PERFORMED IN ACCORDANCE WITH FAA ADVISORY CIRCULAR (AC) 150/5370-10 "OPERATIONAL SAFETY ON AIRPORTS DURING CONSTRUCTION" AND AC 150/5300-13 "AIRPORT DESIGN".

ALL CONSTRUCTION EQUIPMENT ON THE AIRPORT SHALL BE MARKED, LIGHTED AND/OR FLAGGED IN ACCORDANCE WITH AC 150/5210-20 AND 70/7460-1.

#### J.U.L.I.E. INFORMATION

	PROPOSED PHASE 1 IMPROVEMENTS
	PROPOSED PHASE 2 IMPROVEMENTS
X	EXISTING FENCE
——Е——	EXISTING ELECTRIC
——— SS———	EXISTING STORM SEWER
W	EXISTING WATER
	EXISTING SANITARY
——т—	EXISTING TELEPHONE
—— FO——	EXISTING FIBER OPTIC
——— G———	EXISTING GAS
	AIRPORT PROPERTY LINE
<b>-</b> / <b>o</b>	EXISTING STORM INLET/MANHOLE
-o-/¤	EXISTING LIGHT POLE/ POLE-MOUNTED LIGHT
<b>**</b>	PROP. BARRICADES- PHASE 1
	PROP. BARRICADES- PHASE 2

**EXISTING BUILDINGS** 

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Decatur Park District Decatur Airport 910 South Airport Road Decatur, IL 62521

#### RECONSTRUCT SELECT PORTIONS OF THE AIRPORT TERMINAL ENTRANCE ROAD


Illinois Proj. No.: DEC-4822

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DRAWN BY: HLE 04/07/2023
REVIEWED BY: LDH 11/2/23

SHEET TITLE

PROPOSED SAFETY AND PHASING PLAN

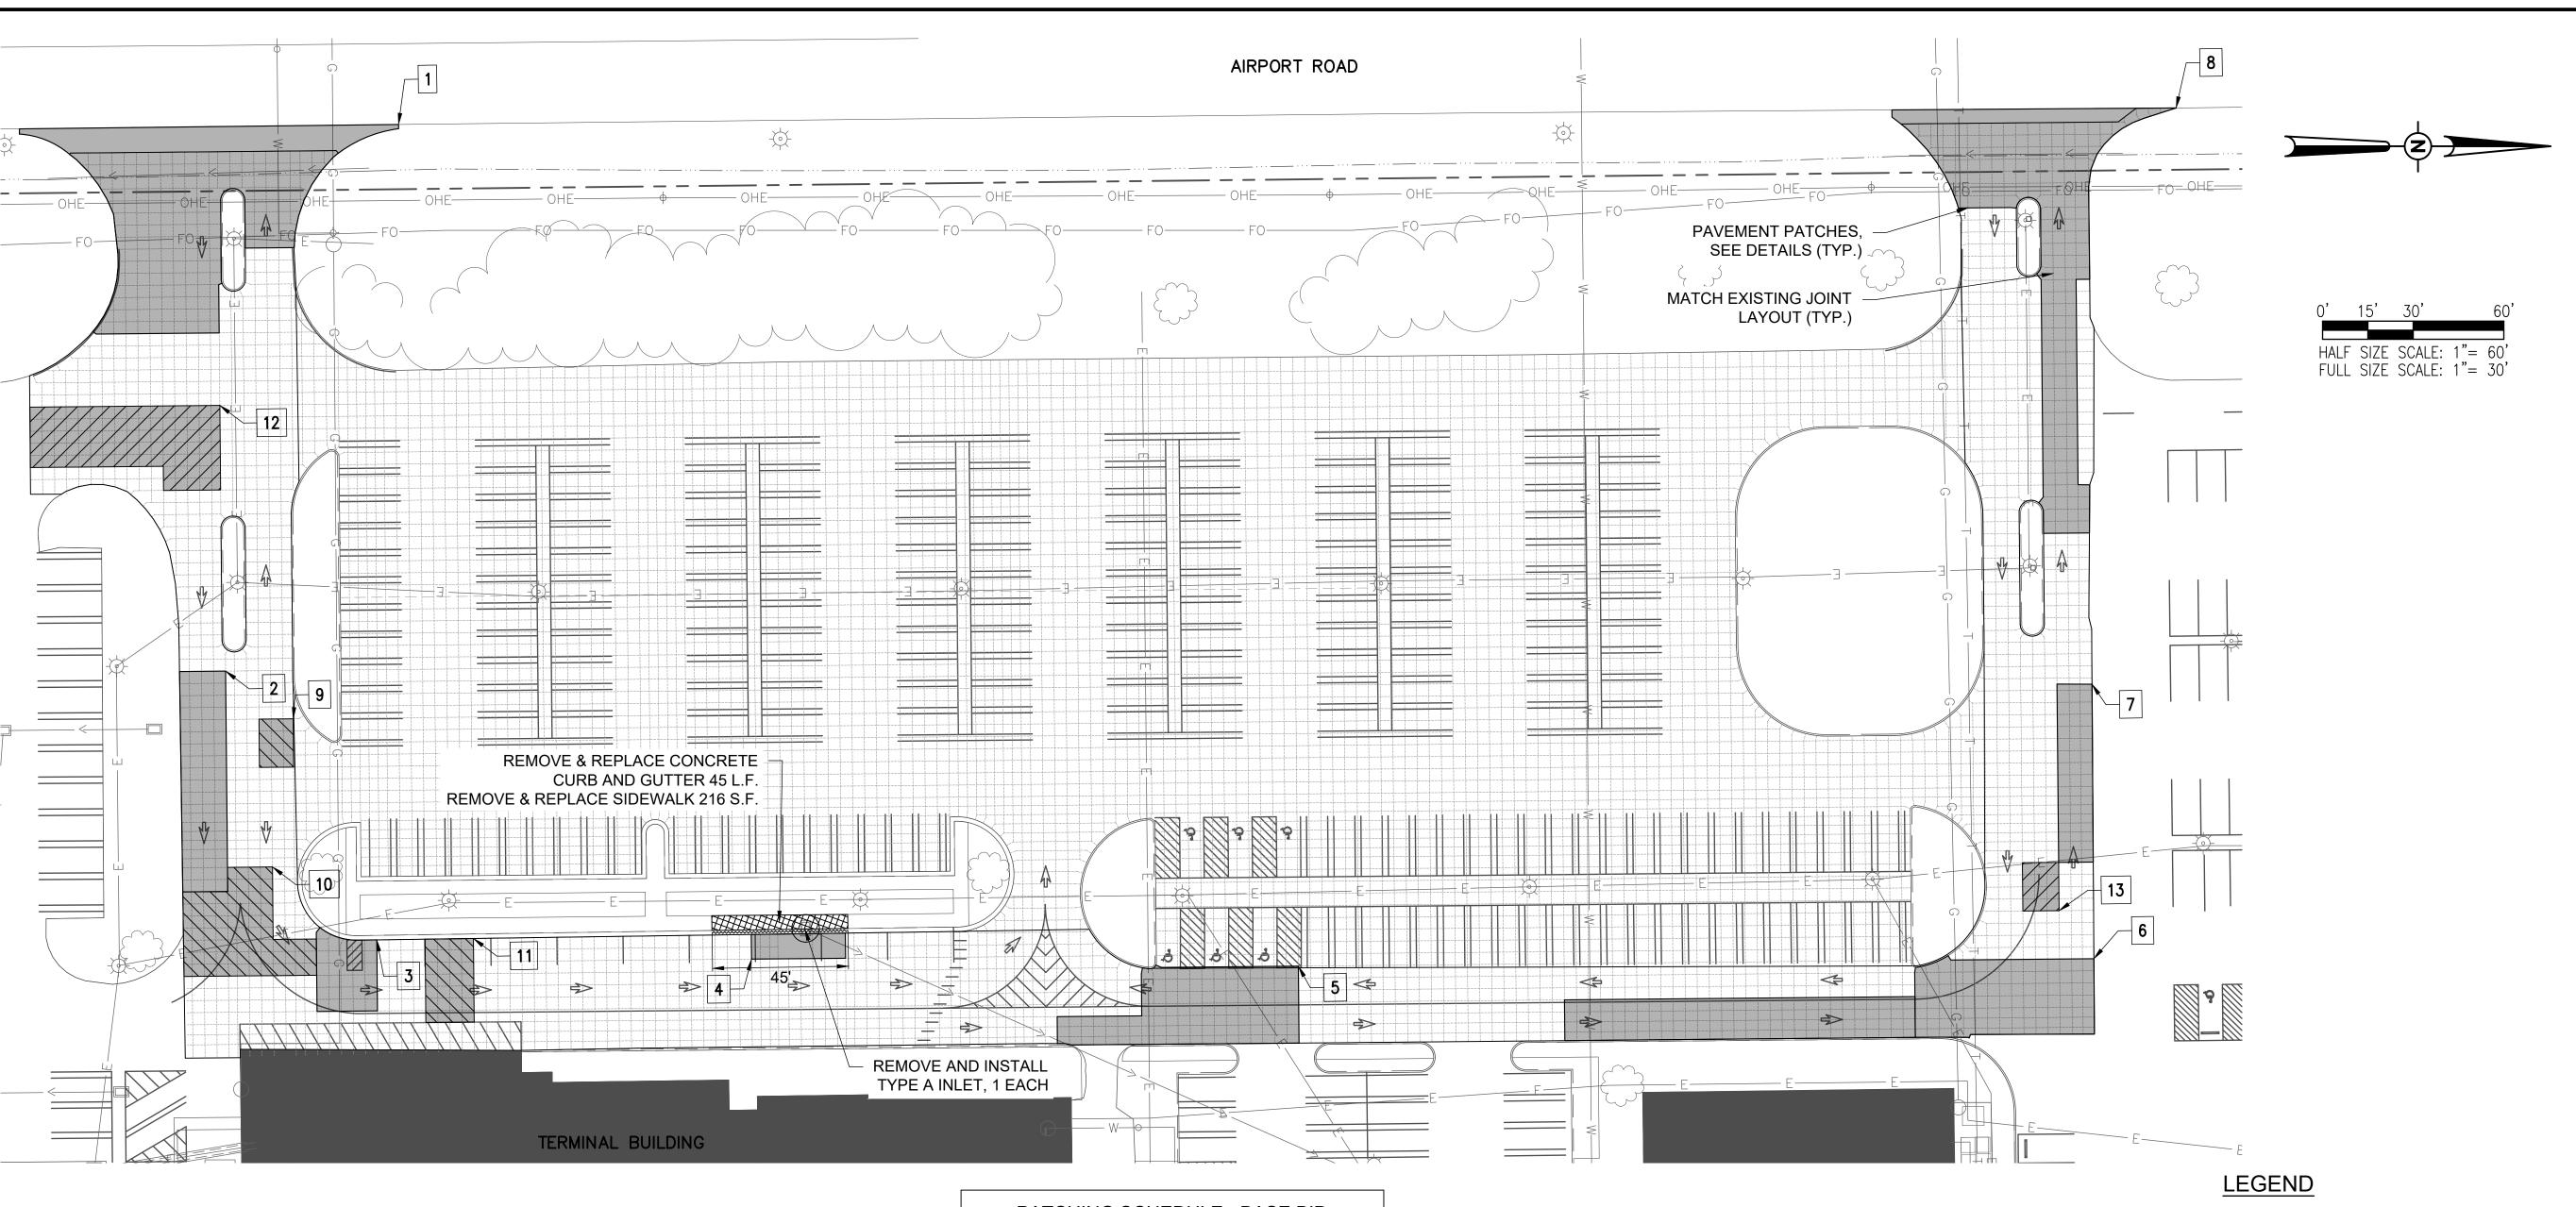

PATCHING SCHEDULE - BASE BID			
PATCH NO.	TOTAL (S.Y.)		
1	58' X 68'	438	
2	15' X 73'	122	
3	20' X 24'	55	
4	8' X 32'	29	
5	26' X 80'	176	
6	175' X 25'	338	
7	12' X 59'	76	
8	24' X 140'	368	
TOTAL 1602			

PATO	PATCHING SCHEDULE - ADD ALT 1				
PATCH NO.   APPROX. DIMENSIONS   TOTAL (S.Y.)					
9	16' X 12'	20			
10	36' X 44'	125			
11	11 16' X 28'				
	TOTAL 194				

PATCHING SCHEDULE - ADD ALT 2			
PATCH NO.	TOTAL (S.Y.)		
12	63' X 12'	157	
13	13 16' X 12'		
	178		

#### CURB AND GUTTER REMOVAL NOTES

THE EXISTING CONCRETE CURB AND GUTTER SHOWN FOR REMOVAL WILL BE REMOVED FULL DEPTH. THE ACTUAL AMOUNT OF EXISTING CURB AND GUTTER TO BE REMOVED WILL BE DETERMINED BY THE RESIDENT ENGINEER AT THE TIME OF CONSTRUCTION. THE RESIDENT ENGINEER WILL MARK CURB THAT IS TO BE REMOVED AND REPLACED. THE EXISTING PAVEMENT ADJOINING THE CURB TO BE REMOVED WILL BE SAWED TO ALLOW THE REMOVAL OF THE CURB WITHOUT DISPLACEMENT OF THE REMAINING PAVEMENT. SAWING WILL BE CONSIDERED AS AN INCIDENTAL ITEM TO THE CURB REMOVAL AND NO ADDITIONAL COMPENSATION WILL BE ALLOWED. ANY DISPLACEMENT OR DAMAGE TO THE ADJACENT PAVEMENT WILL BE REPAIRED BY THE CONTRACTOR AT HIS OWN EXPENSE.

THE REMOVED CURB & GUTTER WILL BE DISPOSED OF OFF THE AIRPORT SITE AT THE CONTRACTOR'S OWN EXPENSE.

THESE ITEMS OF WORK SHALL BE PAID FOR UNDER ITEM:

AR754924 "REPLACE COMB. CURB & GUTTER" \_\_\_\_ PER L.F.

### **GENERAL NOTES**

EXISTING TURF AREA DISTURBED DURING PATCHING OPERATIONS SHALL BE SMOOTH GRADED SEEDED AND MULCHED. THIS WORK SHALL BE INCIDENTAL TO THE CONTRACT.

	EXISTING BUILDINGS
	PAVEMENT PATCHES
	PAVEMENT PATCHES - ADD ALT 1
	PAVEMENT PATCHES - ADD ALT 2
	REMOVE SIDEWALK
······	AR754924 REMOVE CURB AND GUTTE
×	EXISTING FENCE
——Е——	EXISTING ELECTRIC
——— SS———	EXISTING STORM SEWER
W	EXISTING WATER
——————————————————————————————————————	EXISTING SANITARY
——т—	EXISTING TELEPHONE
—— FO——	EXISTING FIBER OPTIC
G	EXISTING GAS
	AIRPORT PROPERTY LINE
□/∘	EXISTING STORM INLET/MANHOLE

EXISTING LIGHT POLE/ POLE-MOUNTED LIGHT

-o-/¤



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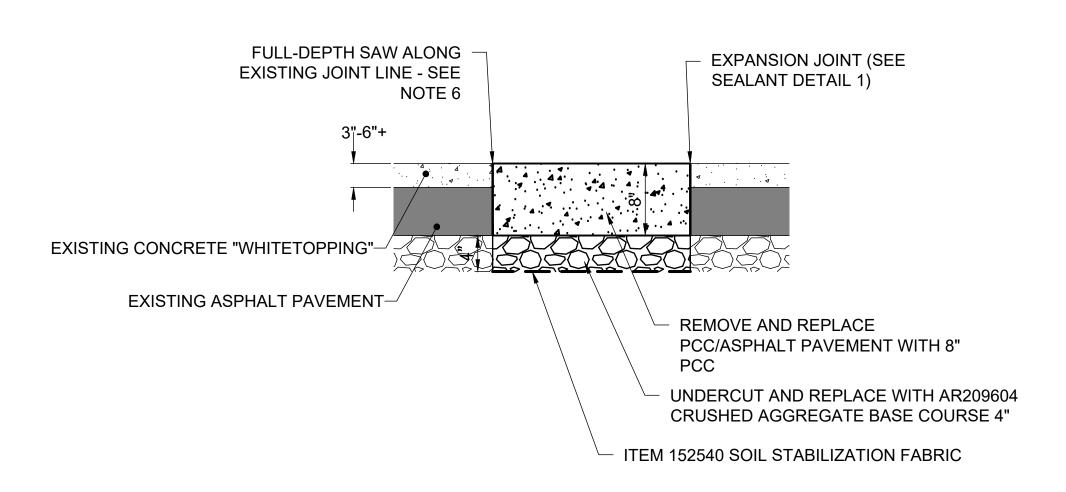
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PROPOSED PLAN

REVIEWED BY: LDH 11/2/23

SHEET TITLE

5




## PAVEMENT PATCHING DETAIL


NOT TO SCALE


#### NOTES:

- 1. RESIDENT ENGINEER/TECHNICIAN WILL CONFIRM AND LAYOUT PATCHING LIMITS.
- 2. PCC MIX SHALL BE IDOT CLASS PP-2.
- 3. CRUSHED AGGREGATE BASE SHALL BE PAID FOR FOR UNDER PAY ITEM AR209604 "CRUSHED AGGREGATE BASE COURSE- 4"" - PER SQUARE YARD.
- 4. SOIL STABILIZATION FABRIC SHALL BE PAID FOR UNDER PAY ITEM AR152540
- 5. ALL OTHER WORK AND MATERIALS SHOWN, INCLUDING JOINTING AND SEALING, SHALL BE INCLUDED IN AND PAID FOR UNDER PAY ITEM AR501508 "8" PCC PAVEMENT" - PER SQUARE YARD.
- 6. CARE SHALL BE TAKEN NOT TO DAMAGE EXISTING CONCRETE PANELS WHILE SAW-CUTTING AND REMOVING EXISTING PAVEMENT. CRACKED OR DAMAGED PANELS SHALL BE REMOVED AND REPLACED AT THE CONTRACTOR'S EXPENSE.

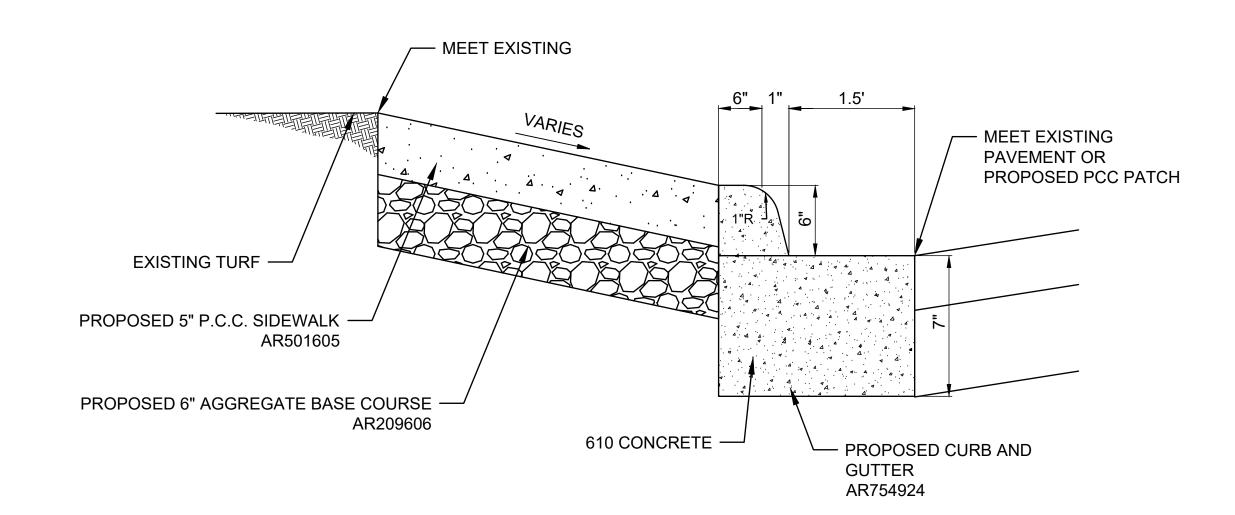

#### PCC SIDEWALK (AR501605) AND COMBINATION CURB AND GUTTER REMOVAL AND REPLACEMENT (AR754924) DETAIL NOT TO SCALE

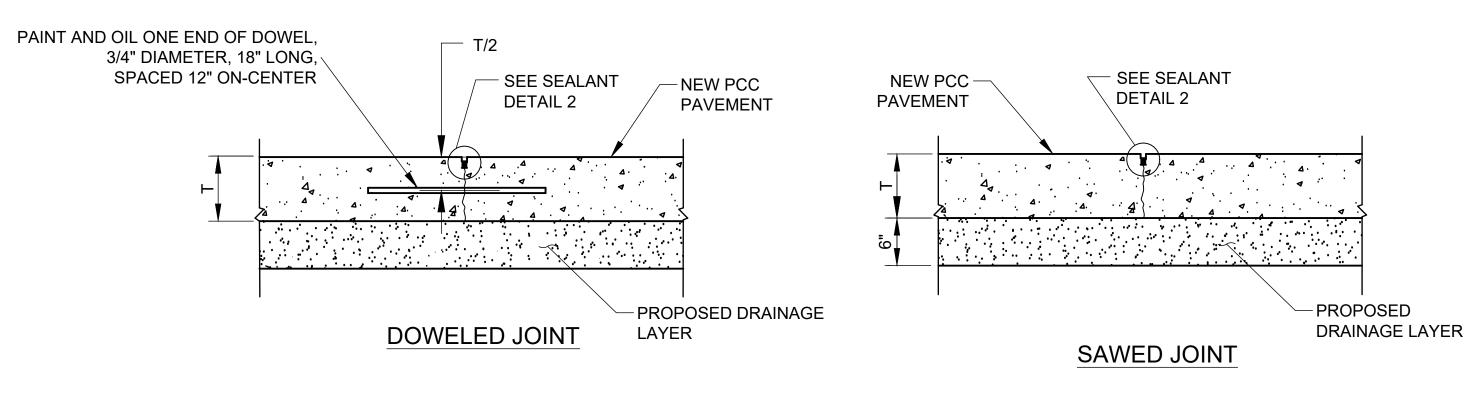

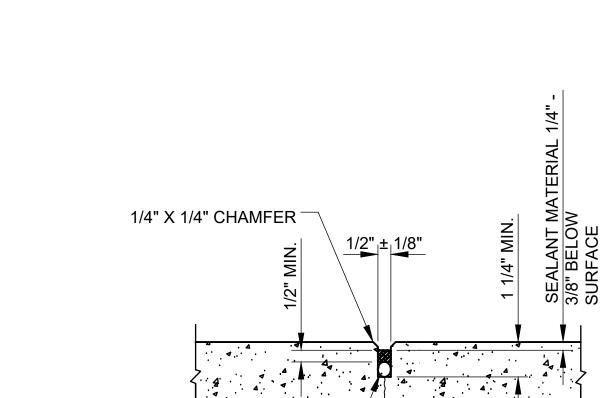


5/8" BACKER ROD MATERIAL

OR SPONGE RUBBER)

(CLOSED CELL RESILIENT FOAM

DETAIL 2 - SEALANT

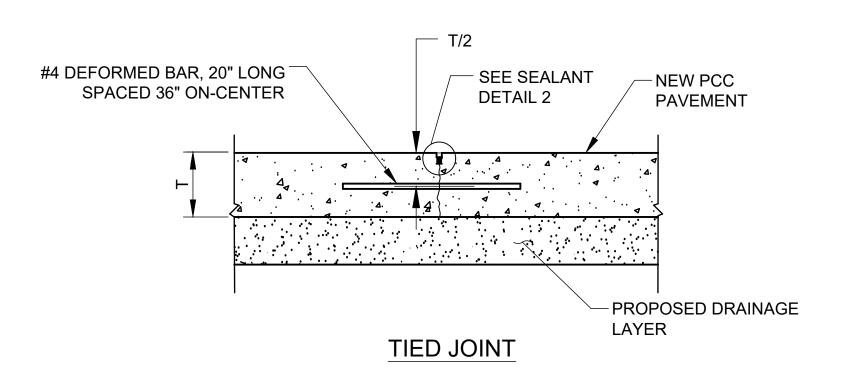

#### **JOINTING NOTES:**

- 1. JOINT SPACING SHALL MATCH EXISTING.
- 2. TRANSVERSE JOINTS SHALL BE DOWELED JOINTS.
- 3. LONGITUDINAL JOINTS SHALL BE ALTERNATING SAWED AND TIED JOINTS.

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Illinois Proj. No.: DEC-4822

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j	ISSUE:	NOVEME	BER 17	, 2023	
PROJECT NO: 22A0100D					

CAD FILE: C-501-DET.DWG DESIGN BY: HLE 04/11/2023 DRAWN BY: HLE 04/11/2023

REVIEWED BY: LDH 11/2/23

SHEET TITLE

PATCHING DETAILS

MATERIAL (CLOSED CELL\_ RESILIENT FOAM OR SPONGE RUBBER)

1/4" RADIUS OR

5/8" BACKER ROD

CHAMFER

1/2" ± 1/8"

**DETAIL 1 - SEALANT** 

NON-EXTRUDED

COMPRESSIBLE

MATERIAL ASTM D-1751 OR 1752

PREMOLDED

THE PAVEMENT MARKING-WATERBORNE (620) SHALL BE PLACED IN ACCORDANCE WITH ITEM 620 "PAVEMENT MARKING" AS STATED IN THE ILLINOIS STANDARD SPECIFICATIONS FOR CONSTRUCTION OF AIRPORTS, ADOPTED MARCH 22, 2023.

THIS ITEM SHALL CONSIST OF PAVEMENT MARKINGS IN ACCORDANCE WITH THESE SPECIFICATIONS AND AT THE LOCATIONS SHOWN ON THE CONSTRUCTION PLANS. THE PROPOSED PAVEMENT MARKING WILL BE APPLIED IN TWO APPLICATIONS.

ANY MATERIAL DELIVERED THAT FAILS TO MEET THE SPECIFICATIONS SHALL BE DISPOSED OF BY THE VENDOR AND IMMEDIATELY REPLACED WITH ACCEPTABLE MATERIAL ENTIRELY AT THE VENDOR'S EXPENSE, INCLUDING HANDLING AND TRANSPORTATION CHARGES.

ALL PROPOSED MARKING WILL BE COMPLETED IN ACCORDANCE WITH THE DETAILS SHOWN ON THE CONSTRUCTION PLANS.

GLASS BEADS SHALL BE REQUIRED ONLY ON THE SECOND APPLICATION OF

CUT-OFF SHEETS WILL BE REQUIRED TO INSURE STRAIGHT EDGES.

THE PROPOSED MARKING WILL BE PAID FOR UNDER ITEM: AR620520 PAVEMENT MARKING-WATERBORNE \_\_\_\_ PER S.F.

MARKING QUANTITIES				
DESCRIPTION	CRIPTION UNIT AREA (S.F.) NO. REQ'D			
CENTERLINE STRIPE	227	1	227	
PARKING STALL STRIPE (10')	3.33	3	10	
SIDEWALK EXIT/NO PARKING	17	1	17	
STRAIGHT ARROW	8.7	15	130.5	
NEW CURB PAINTING	2.5 S.F./L.F.	45 L.F.	113	
	498			

#### NOTES:

QUANTITY OF PAINT FOR NEW CURB PAINTING WAS DETERMINED BY AN ASSUMPTION OF 2.5 SF PER LINEAR FOOT OF NEW CURB.

# PAVEMENT MARKINGS - DIRECTIONAL ARROWS

1.	THE PROPOSED DIRECTIONAL ARROW PAVEMENT
	MARKINGS SHALL BE LOCATED AS SHOWN ON THE
	PAVEMENT MARKING PLAN. LAYOUT OF ARROWS SHALL
	BE APPROVED BY RESIDENT ENGINEER AND OWNER
	PRIOR TO PAINTING.

2.	ARROWS SHALL CONFORM TO IDOT STANDARD
	DRAWING NO. 780001 - LARGE ARROW, AND SHALL BE
	YELLOW IN COLOR.

3. THIS ITEM OF WORK SHALL BE PAID FOR UNDER THE FOLLOWING ITEM: AR62050 "PAVEMENT MARKING - WATERBORNE" - PER S.F.

a		
	а	

Legend Height	Arrow Size	a
6' (1.8 m)	Small	2.9 (74)
8' (2.4 m)	Large	3.8 (96)

The space between adjacent letters or numerals should be approximately 3 (75) for 6' (1.8 m) legend and 4 (100) for 8' (2.4 m)

IDOT STANDARD NO. 780001-05

STRAIGHT ARROW NOT TO SCALE



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Decatur Park District Decatur Airport 910 South Airport Road Decatur, IL 62521

#### RECONSTRUCT SELECT PORTIONS OF THE AIRPORT TERMINAL ENTRANCE ROAD

Illinois Proj. No.: DEC-4822

NO.	DATE	DES	CRIPT	ION
NO.	DATE	DES	DWN	REV
ISSUE:	NOVEME	BER 17	, <mark>2023</mark>	

PROJECT NO: 22A0100D

CAD FILE: C-103-MRK.DWG

DESIGN BY: HLE 04/12/2023

DRAWN BY: HLE 04/12/2023


REVIEWED BY: LDH 11/2/23

SHEET TITLE


MARKING PLAN


I:\22JOBS\22A0100D\CAD\AIRPORT\SHEET\C-103-MRK.D\

THE MARKING.

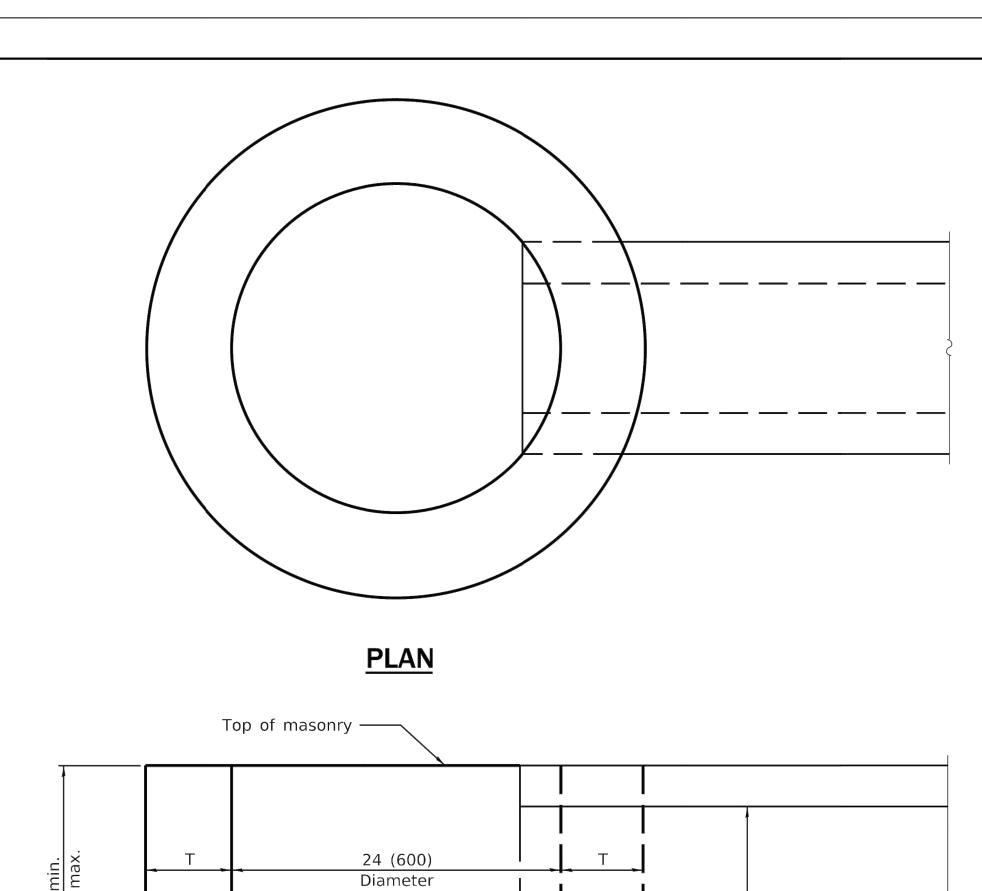

ALTERNATE MATERIALS FOR WALLS	Т
BRICK MASONRY	8 (200)
CAST-IN-PLACE CONCRETE	6 (150)
CONCRETE MASONRY UNIT	5 (125)
PRECAST REINFORCED CONCRETE SECTION	3 (75)

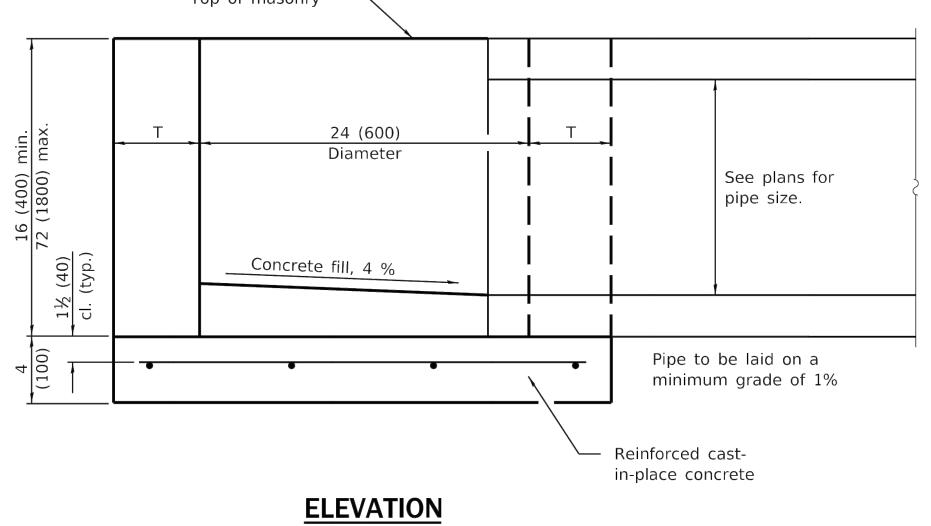

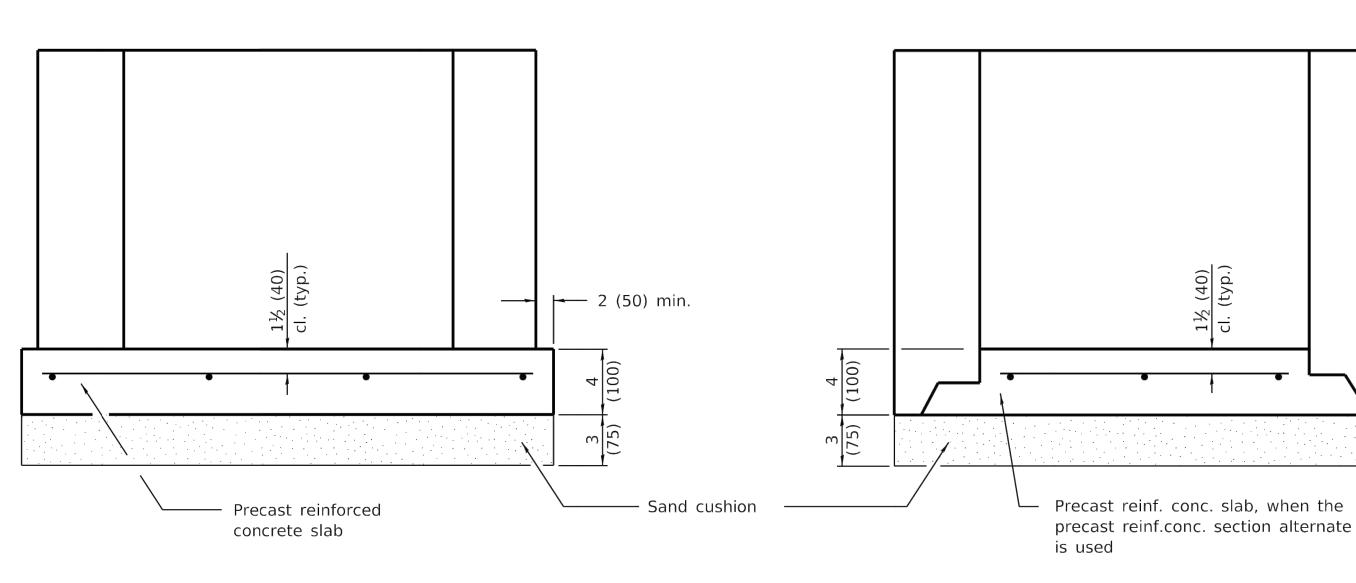

# **ALTERNATE METHODS**

## **GENERAL NOTES**

Bottom slabs shall be reinforced with a minimum of 0.24 sq. in./ft. (510 sq. mm/m) in both directions with a maximum spacing of 10 (250).

Bottom slabs may be connected to the riser as determined by the fabricator; however, only a single row of reinforcement around the perimeter may be utilized.

All dimensions are in inches (millimeters) unless otherwise shown.

DATE	REVISIONS	
1-1-14	Increased height to	
	72 (1800) maximum.	
1-1-11	Detailed rein. in slabs.	
	Added max. limit to height.	
	Added general notes.	

**INLET - TYPE A** 

STANDARD 602301-04

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RECONSTRUCT SELECT PORTIONS OF THE AIRPORT TERMINAL ENTRANCE ROAD

Illinois Proj. No.: DEC-4822

NO	O. DATE	DESCRIPTION		ION
INO.		DES	DWN	REV
ISSUE: NOVEMBER 17, 2023				
DDO IEC	DDO IECT NO: 22A0100D			

PROJECT NO: 22A0100D

CAD FILE: C-501-DET.DWG

DESIGN BY: HLE 04/11/2023

DRAWN BY: HLE 04/11/2023

REVIEWED BY: LDH 11/2/23

SHEET TITLE

IDOT STANDARD DETAIL - SHEET 1

Illinois Department of Transportation

Michael Brand ENGINEER OF POLICY AND PROCEDURES

ENGINEER OF DESIGN AND ENVIRONMENT

APPROVED January 1, 2014

January 1,

HANSON

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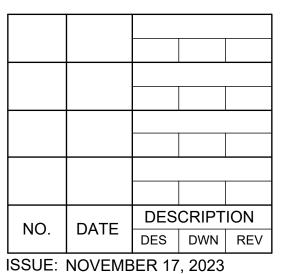
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RECONSTRUCT SELECT PORTIONS OF THE AIRPORT TERMINAL ENTRANCE ROAD

Illinois Proj. No.: DEC-4822



PROJECT NO: 22A0100D

CAD FILE: C-501-DET.DWG

DESIGN BY: HLE 04/11/2023

DRAWN BY: HLE 04/11/2023

REVIEWED BY: LDH 11/2/23

SHEET TITLE

IDOT STANDARD DETAIL - SHEET 2

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#### RECONSTRUCT SELECT PORTIONS OF THE AIRPORT TERMINAL ENTRANCE ROAD

Illinois Proj. No.: DEC-4822

NO.	DATE	DESCRIPTION		
'\\O.	DATE	DES	DWN	REV

PROJECT NO: 22A0100D

CAD FILE: C-501-DET.DWG

DESIGN BY: HLE 04/11/2023

DRAWN BY: HLE 04/11/2023
REVIEWED BY: LDH 11/2/23

REVIEWED BY: LDH 11/2/2

SHEET TITLE

IDOT STANDARD DETAIL - SHEET 3

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Illinois Proj. No.: DEC-4822

NO	DATE	DESCRIPTION			
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ISSUE: NOVEMBER 17, 2023					

PROJECT NO: 22A0100D

CAD FILE: C-501-DET.DWG

DESIGN BY: HLE 04/11/2023

DRAWN BY: HLE 04/11/2023
REVIEWED BY: LDH 11/2/23

SHEET TITLE

IDOT STANDARD DETAIL - SHEET 4