



TYPICAL SECTION A - 3.0' SEGMENTAL CONCRETE BLOCK WALL
NTS

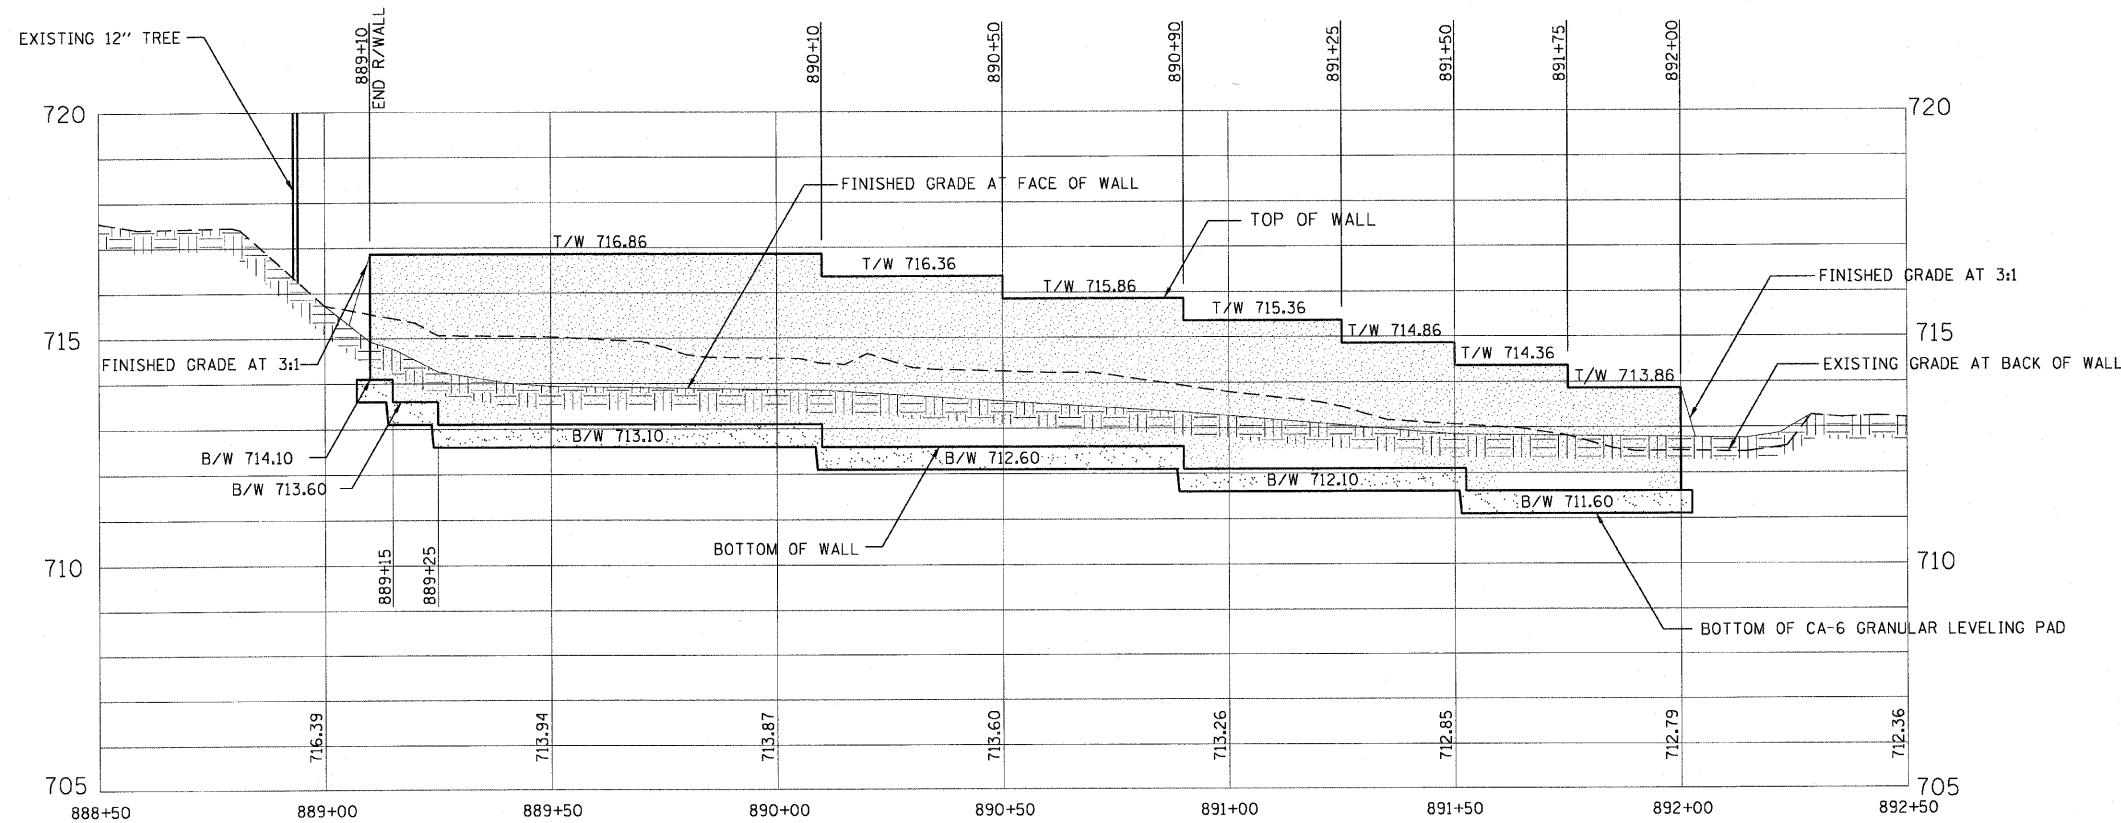

ELEVATION VIEW

- NOTES:**
- IT IS THE CONTRACTOR'S RESPONSIBILITY TO VERIFY EXISTING CONDITIONS AND DIMENSIONS BEFORE START OF THE WORK OR ORDERING MATERIALS.
 - SEE GRADING PLANS FOR LOCATIONS, GRADING, LENGTH AND ELEVATIONS
 - THE BASE FOUNDATION FOR THE GRANULAR LEVELING PAD SHALL BE APPROVED BY THE RESIDENT ENGINEER PRIOR TO PLACEMENT OF THE LEVELING PAD. MINIMUM SOIL PRESSURE UNDER PAD=2000 PSF.
 - EACH COURSE OF THE MODULAR BLOCKS TO BE SET BACK 3/4\"/>

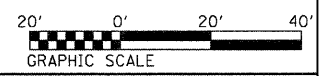

FILE NAME =	USER NAME = #USER#	DESIGNED DA	REVISED 10/24/2011	STATE OF ILLINOIS DEPARTMENT OF TRANSPORTATION	SEGMENTAL CONCRETE BLOCK WALL TYPICAL SECTION AND ELEVATION	F.A.P. RTE.	SECTION	COUNTY	TOTAL SHEETS	SHEET NO.
#FILE#	DRAWN JR/BB	REVISED 01/03/2012 ADDENDUM A	347			02-00077-00-SW	DUPAGE	73	53	
PLOT SCALE = #SCALE#	CHECKED JJ	REVISED	CONTRACT NO. 63197							
PLOT DATE = #DATE#	DATE 06/08/2011	REVISED	FED. ROAD DIST. NO. [ILLINOIS] FED. AID PROJECT							
						SCALE: AS SHOWN	SHEET NO. 1 OF 2 SHEETS	STA. 888+50.00 TO STA. 892+50.00		