




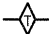
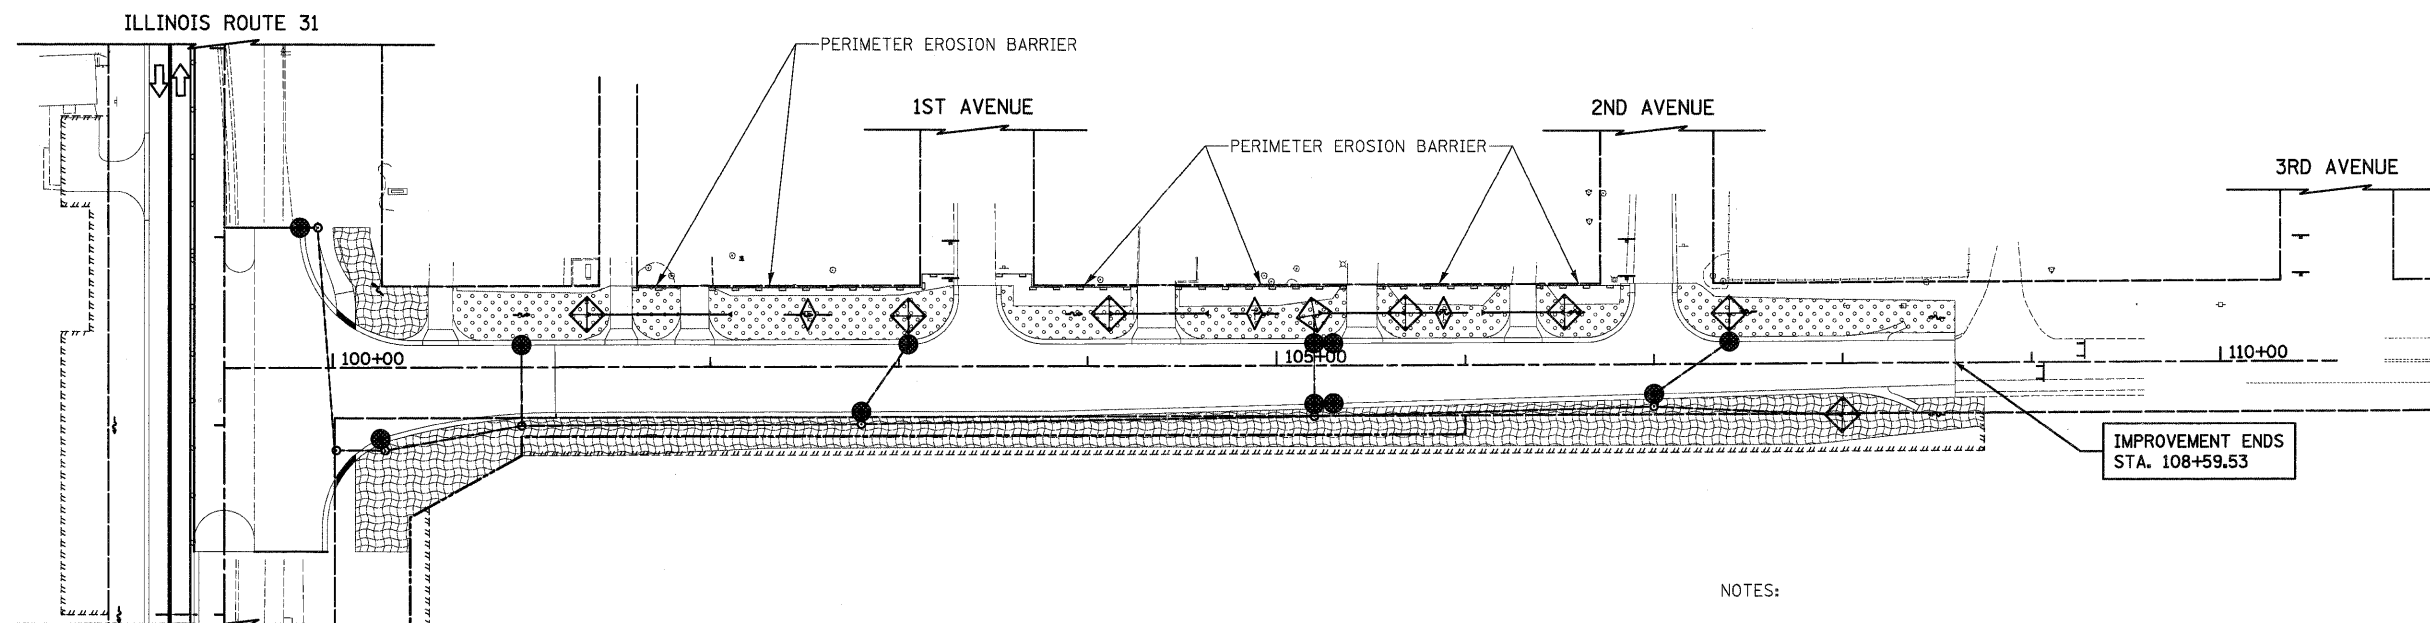



**LEGEND**

-  TEMPORARY PAVEMENT
-  EROSION CONTROL BLANKET AND TEMPORARY EROSION CONTROL SEEDING
-  MULCH, METHOD 2 AND TEMPORARY EROSION CONTROL SEEDING
-  INLET FILTER AND PERIMETER EROSION BARRIER PLACED AROUND OPEN GRATE STRUCTURE IN ACCORDANCE WITH 280001-05
-  INLET FILTERS
-  TEMPORARY DITCH CHECKS



**NOTES:**

1. ALL TEMPORARY DITCH CHECKS ARE 1 FOOT IN HEIGHT UNLESS OTHERWISE NOTED.

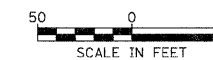

**KLASEN ROAD - STAGE 2A**

FILE NAME =	USER NAME = dte	DESIGNED - DTE	REVISED -	<b>STATE OF ILLINOIS DEPARTMENT OF TRANSPORTATION</b>	<b>EROSION AND SEDIMENT CONTROL - STAGE 2A</b>	F.A.U. RTE.	SECTION	COUNTY	TOTAL SHEETS	SHEET NO.	
Y:\2278 Virginia Klase\cad\sheet\10-ErosionControl\2278_ER0_05.dgn	PLOT SCALE = 58.0000' / 1in.	DRAWN - DTE	REVISED -			3887	96-00209-01-PV	MCHENRY	271	92	
PLOT DATE = 10/24/2011	DATE - 10/24/11	CHECKED - GAB	REVISED -			<b>CONTRACT NO. 63553</b>					
						SCALE: 1" = 50'		SHEET NO. 5 OF 9 SHEETS		STA. 101+00 TO STA. 108+59.53	