



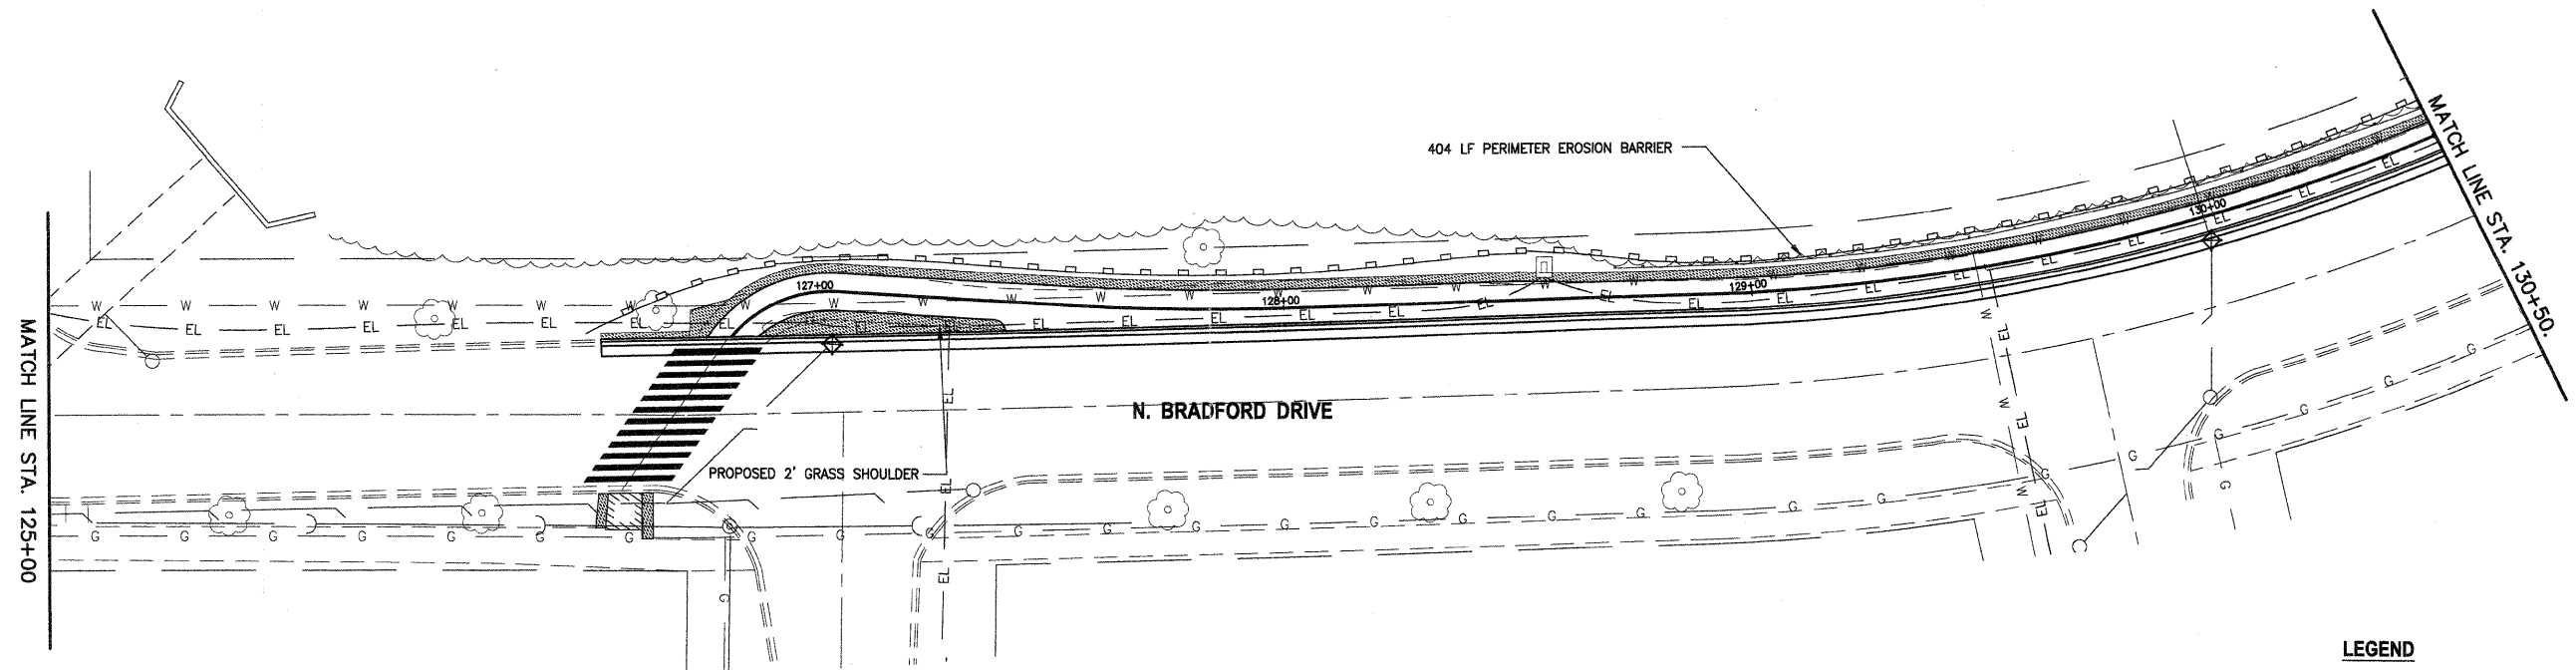


PLAN	SUBMITTED	DATE
	REVISED	
	DESIGNED	
	CHECKED	
	BY	
	NO.	
	STRUCTURE NOTATION CHNO	

PROFILE	SUBMITTED	DATE
	REVISED	
	DESIGNED	
	CHECKED	
	BY	
	NO.	
	STRUCTURE NOTATION CHNO	



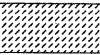


LEGEND

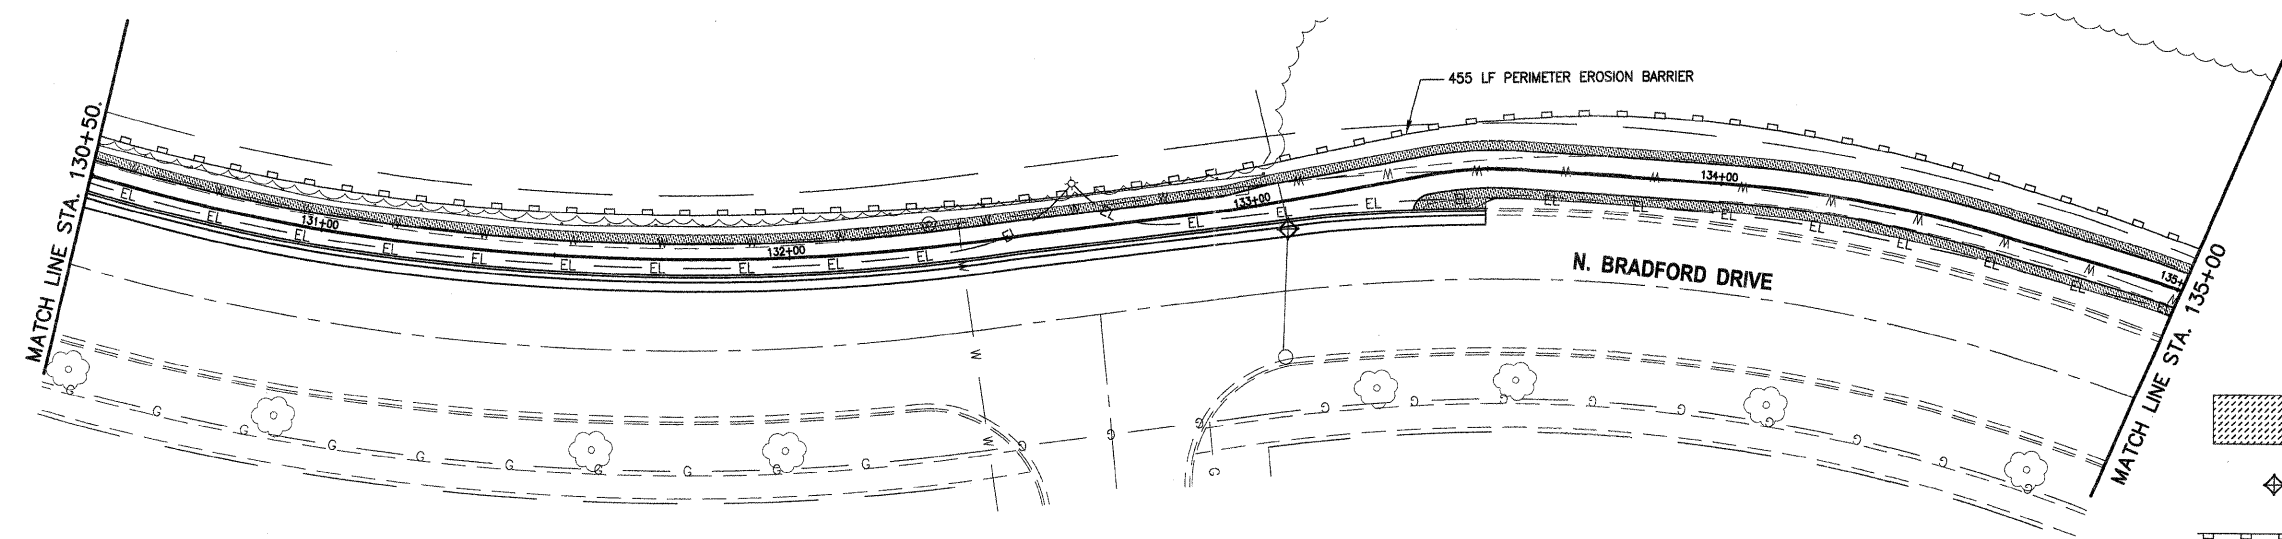-  SODDING, FERTILIZERS, TOPSOIL FURNISH AND PLACE, VARIABLE DEPTH
-  INLET FILTERS
-  PERIMETER EROSION BARRIER



LEGEND

-  SODDING, FERTILIZERS, TOPSOIL FURNISH AND PLACE, VARIABLE DEPTH
-  INLET FILTERS
-  PERIMETER EROSION BARRIER

FILE NAME = 3d-phase1McDonald.dwg	USER NAME = chomuth LAYOUT NAME = 125+00-135+00 ER PLOT SCALE = 20.00' / IN. PLOT DATE = Oct 24, 2011 - 4:10pm	DESIGNED - BS DRAWN - CH CHECKED - JM DATE - 04/12/2011	REVISED - REVISED - REVISED - REVISED -	STATE OF ILLINOIS DEPARTMENT OF TRANSPORTATION	MC DONALD CREEK MULTI USE PATH EROSION CONTROL / SOD REPLACEMENT	F.A. RTE.	SECTION 10-00196-00-BT	COUNTY COOK	TOTAL SHEETS 26	SHEET NO. 18		
	SCALE: 1"=20'					SHEET NO. OF SHEETS	STA. 125+00 TO STA. 135+00		FED ROAD DIST. NO. 1 ILLINOIS FED. AID PROJECT			
						CONTRACT NO. 63624						

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