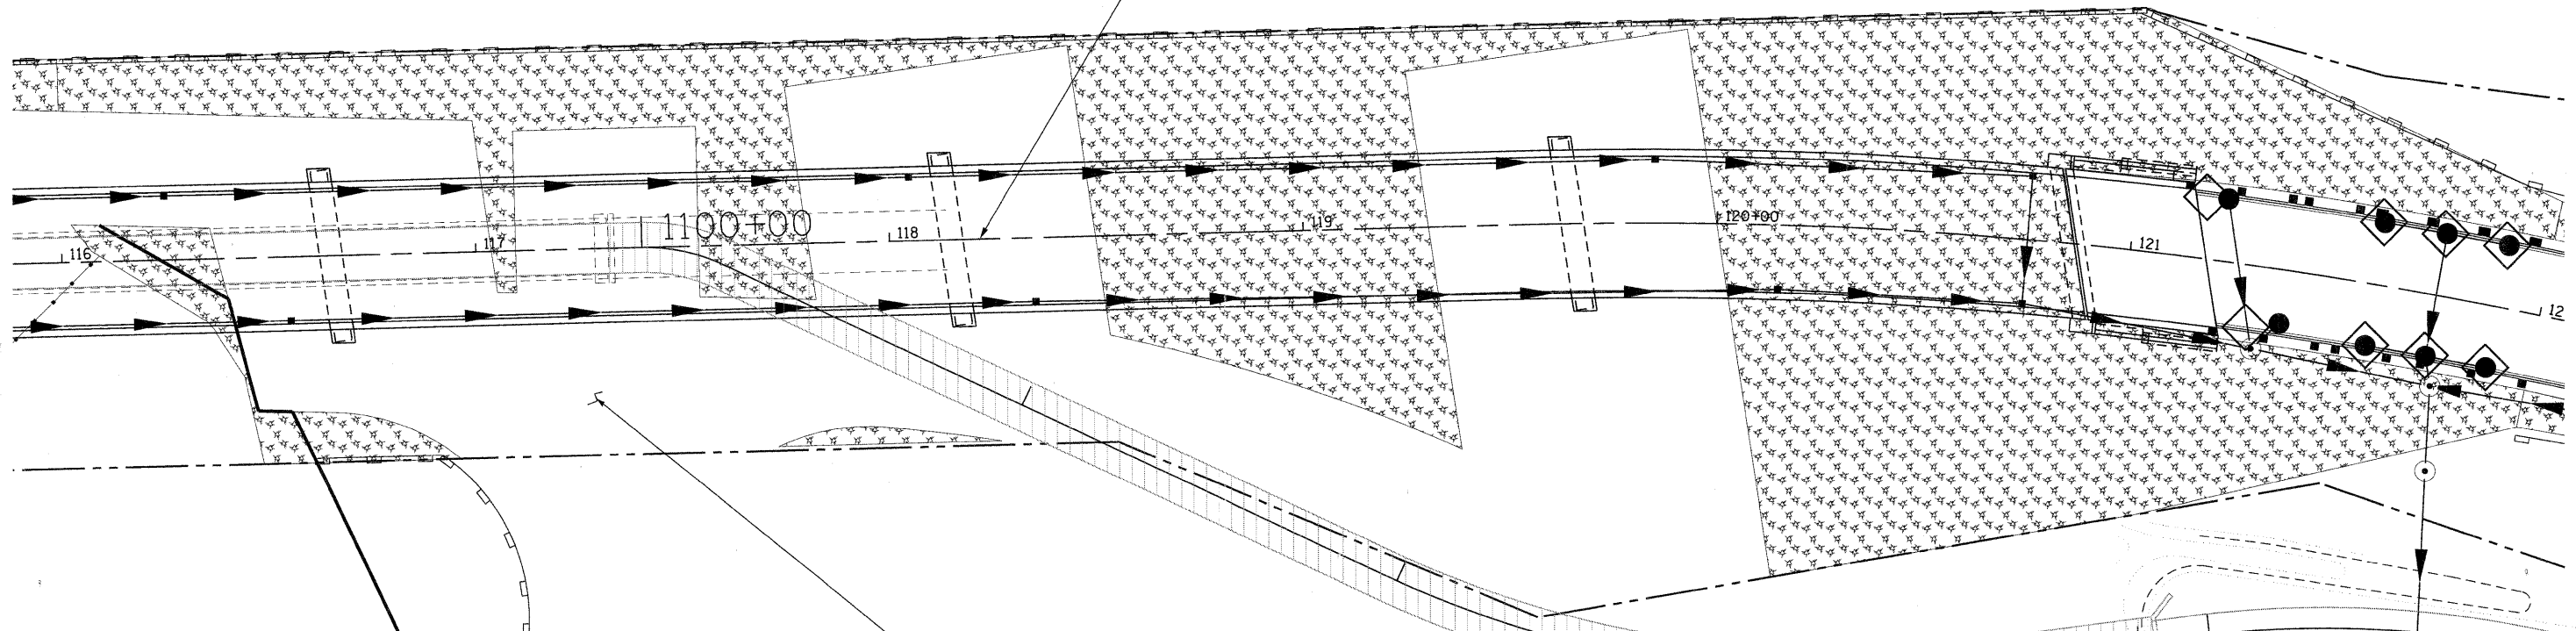


PR & RED GATE ROAD







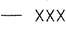
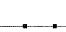



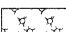


AFTER CAUSEWAY, TEMP BRIDGE AND HAUL ROAD ARE REMOVED, RE-ESTABLISH PERIMETER EROSION BARRIER AND INSTALL FINAL LANDSCAPING

PR & BIKE PATH

AFTER HAUL ROAD IS REMOVED, RESTORE AREA AND RE-ESTABLISH PERIMETER EROSION BARRIER AS DIRECTED BY ENGINEER

LEGEND:

-  CULVERT INLET PROTECTION - STONE, XX006723 & XX006723
-  INLET & PIPE PROTECTION, 28000500
-  TEMPORARY DITCH CHECK, 28000300
-  INLET FILTERS, 28000510
-  PERIMETER EROSION BARRIER, 28000400
-  - XXX - TEMPORARY FENCE, 20101000
-  - - - - - TURBIDITY CURTAIN, XX003967
-  PERIMETER EROSION BARRIER, ROLLED EXCELSIOR XX006729
-  () SEDIMENT BASIN, 20200300
-  MULCH, METHOD 2, 25100115
-  RIP RAP, 28100105 & 28100107
-  STABILIZED CONSTRUCTION ENTRANCE, X0322671

PLOT SCALE: 1"=20' FILE NAME: ... USER NAME: tblank PLOT DATE: 11/9/2011

FILE NAME =	DESIGNED - MAC	REVISED -
...nprpln-abc-shr-pond-west-2-es.dgn	DRAWN - TMB	REVISED -
USER NAME = tblank	CHECKED - RMT	REVISED -
PLOT DATE = 11/9/2011	DATE - 10/23/2011	REVISED -



CITY OF ST. CHARLES

EROSION CONTROL DETAILS - EAST ABUTMENT

SCALE: 1"=20' SHEET NO. 22 OF 23 SHEETS STA. TO STA.

F.A. RTE.	SECTION	COUNTY	TOTAL SHEETS	SHEET NO.
	04-00092-00-BR	KANE	440	123
CONTRACT NO. 63650				
ILLINOIS FED. AID PROJECT				