01-20-2023 LETTING ITEM 106

FOR INDEX OF SHEETS, SEE SHEET NO. 2 FOR HIGHWAY STANDARDS, SEE SHEET NO. 2

DESIGN DESIGNATION -

CRETE ROAD (FAU 4309)

ADT 3,600

PV=400 SU=40 MU=0

% DESIGN TRAFFIC IN DESIGN LANE

PV=99% S=1% M=0%

ACTUAL TF=.05 SSS=FAIR

CRETE ROAD

2019 ADT -

1,925 (1.1% TRUCK)

2040 ADT -

3,600 (1.1% TRUCK)

POSTED SPEED LIMIT -

35 mph

DESIGN PERIOD -

25 YEARS

DESIGN SPEED LIMIT -

35 mph

STREET CLASSIFICATION -

URBAN MINOR COLLECTOR

STATE OF ILLINOIS DEPARTMENT OF TRANSPORTATION **DIVISION OF HIGHWAYS**

PLANS FOR PROPOSED FEDERAL AID HIGHWAY


FAU ROUTE 4309 (CRETE ROAD) EXCHANGE STREET TO RICHTON ROAD ROADWAY WIDENING/RESURFACING/RECONSTRUCTION **SECTION NO.: 15-00049-00-PV**

PROJECT NO.: UMBW(332)

VILLAGE of CRETE

WILL COUNTY

JOB NO.: C-91-378-15

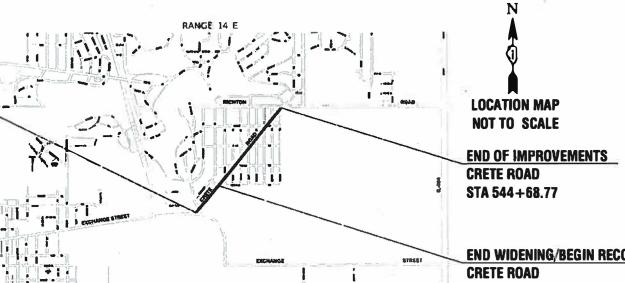

LOCATION MAP

GROSS LENGTH= 4,350 FEET= 6,63 MILES
NET LENGTH= 4,350 FEET= 0.63 MILES

LOCATION OF SECTION INDICATED THUS: .

END WIDENING/BEGIN RECON STA 506+50.00

> PRINTED BY THE AUTHORITY OF THE STATE OF ILLINOIS

RIMENTOF TRANSPORTATION

BEGINNING OF IMPROVEMENTS

CRETE ROAD STA 501+09.02

> VILLAGE CRETE

FULL SIZE PLANS HAVE BEEN PREPARED USING STANDARD ENGINEERING SCALES, REDUCED SIZED PLANS WILL NOT CONFORM TO STANDARD SCALES, IN MAKING MEASUREMENTS ON REDUCED PLANS, THE ABOVE SCALES MAY BE USED.

J. U. L. L E. JOINT UTILITY LOCATION INFORMATION FOR EXCAVATION 1 - 800 - 892 - 0123

CONTRACT NO. 61H99

21R0318-COVR-01 - C01

INDEX OF SHEETS

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IDOT DISTRICT 1 STANDARDS

BD-32	BUTT	JOINT	AND	HMA	TAPER	DETAILS	
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- TC-10 TRAFFIC CONTROL AND PROTECTION FOR SIDE ROADS, INTERSECTIONS, AND DRIVEWAYS
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- 000001-08 STANDARD SYMBOLS, ABBREVIATIONS AND PATTERNS
- 280001-07 TEMPORARY EROSION CONTROL SYSTEMS
- 442201-03 CLASS C & D PATCHES
- 542301-03 PRECAST REINFORCED CONCRETE FLARED END SECTION
- 601001-05 PIPE UNDERDRAINS
- 602001-02 CATCH BASIN, TYPE A
- 602011-02 CATCH BASIN, TYPE C
- 602301-04 INLET, TYPE A
- 602401-07 PRECAST MANHOLE, TYPE A, 4' DIAMETER
- 602402-03 PRECAST MANHOLE, TYPE A, 5' DIAMETER
- 602406-11 PRECAST MANHOLE, TYPE A, 6' DIAMETER
- 602411-09 PRECAST MANHOLE, TYPE A, 7' DIAMETER
- 602416-09 PRECAST MANHOLE, TYPE A, 8' DIAMETER
- 602701-02 MANHOLE STEPS
- 604001-05 FRAMES AND LIDS, TYPE 1 604036-03 GRATE TYPE 8
- 604051-04 FRAME AND GRATE, TYPE 11
- 606001-08 CONCRETE CURB TYPE B AND COMBINATION CONCRETE CURB AND GUTTER
- 701001-02 OFF-RD OPERATIONS, 2L, 2W, MORE THAN 15' (4.5m) AWAY
- 701006-05 OFF-RD OPERATIONS, 2L, 2W, 15' (4.5m) TO 24" (600mm) FROM PAVEMENT EDGE
- 701011-04 OFF-RD MOVING OPERATIONS, 2L, 2W, DAY ONLY 701301-04 LANE CLOSURE, 2L, 2W,SHORT TIME OPERATIONS
- 701311-03 LANE CLOSURE, 2L, 2W MOVING OPERATIONS-DAY ONLY
- 701501-06 URBAN LANE CLOSURE, 2L, 2W, UNDIVIDED
- 701901-08 TRAFFIC CONTROL DEVICES
- 720001-01 SIGN PANEL MOUNTING DETAILS
- 720006-04 SIGN PANEL ERECTIONS DETAILS
- 720011-01 METAL POSTS FOR SIGNS, MARKERS & DELINEATORS
- 725001-01 OBJECT AND TERMINAL MARKERS
- 729001-01 APPLICATIONS OF TYPES A & B METAL POSTS (FOR SIGNS & MARKERS)

EARTHWORK QUANTITIES

TOTAL CUT	=	7,701	CY
TOTAL EXISTING PAVEMENT REMOVAL	=	2,100	CY
TOTAL AVAILABLE CUT TO FILL	=	5,601	CY
TOTAL FILL	=	258	CY
CUT TO FILL (15% SHRINKAGE)	=	297	CY
EXCESS HAUL AWAY MATERIAL	=	5,304	CY

GENERAL NOTES

- . ALL ROADWAY CONSTRUCTION SHALL CONFORM TO THE "STANDARD SPECIFICATIONS FOR ROAD AND BRIDGE CONSTRUCTION", ADOPTED JANUARY 1, 2022 BY THE ILLINOIS DEPARTMENT OF TRANSPORTATION AND ALL AMENDMENTS THERETO.
- THE CONTRACTOR SHALL BE RESPONSIBLE FOR HAVING THE UTILITY COMPANIES LOCATE THEIR FACILITIES IN THE FIELD PRIOR TO CONSTRUCTION AND SHALL ALSO BE RESPONSIBLE FOR THE MAINTENANCE AND PRESERVATION OF THESE FACILITIES. THE ENGINEER DOES NOT WARRANT THE LOCATION OF ANY EXISTING UTILITIES SHOWN ON THE PLAN. THE CONTRACTOR SHALL CALL J.U.L.I.E. AT 800-892-0123 AND THE VILLAGE OF CRETE FOR UTILITY LOCATIONS.
- THE CONTRACTOR IS RESPONSIBLE FOR VERIFYING THE NATURE AND STATUS OF ALL UTILITY RELOCATION WORK PRIOR TO THE START OF CONSTRUCTION. THE CONTRACTOR SHALL TAKE APPROPRIATE MEASURES TO ENSURE THAT CONSTRUCTION OPERATIONS DO NOT INTERFERE WITH UTILITY FACILITIES AND RELOCATION WORK. THE SCHEDULE SHOULD REFLECT CONSTRUCTION SEQUENCING, WHICH COORDINATES WITH ALL UTILITY RELOCATION WORK. THE CONTRACTOR SHALL BE REQUIRED TO ADJUST THE ORDER OF ITS WORK FROM TIME TO TIME, TO COORDINATE SAME WITH UTILITY RELOCATION WORK, AND SHALL PREPARE REVISED SCHEDULE (S) IN COMPLIANCE THEREWITH AS DIRECTED BY THE OWNER. THE OWNER AND THE ENGINEER SHALL BE NOTIFIED IN WRITING BY THE CONTRACTOR AT LEAST 48 HOURS PRIOR TO THE START OF ANY OPERATION REQUIRED COOPERATION WITH OTHERS. ALL OTHER AGENCIES, UNLESS OTHERWISE NOTED, WILL BE NOTIFIED IN WRITING BY THE CONTRACTOR TEN (10) DAYS PRIOR TO THE START OF ANY SUCH OPERATION. THE UTILITY COMPANIES HAVE BEEN CONTACTED IN REFERENCE TO UTILITIES THEY OWN AND OPERATE WITHIN THE LIMITS FOR THIS PROJECT. ALL KNOWN DATA FROM THESE AGENCIES HAS BEEN INCORPORATED INTO THE PLANS. IT IS HOWEVER, THE CONTRACTOR'S RESPONSIBILITY TO CONFIRM OR ESTABLISH THE EXISTENCE OF ALL UTILITY FACILITIES AND THEIR EXACT LOCATIONS, WHETHER CONTAINED IN THE DATA SUBMITTED BY THESE AGENCIES OR NOT, AND TO SAFELY SCHEDULE ALL UTILITY FRELOCATIONS.
- THE CONTRACTOR SHALL PRESERVE ALL CONSTRUCTION STAKES UNTIL THEY ARE NO LONGER NEEDED. ANY STAKES DESTROYED OR DISTURBED BY THE CONTRACTOR PRIOR TO THEIR USE SHALL BE RESET BY THE CONTRACTOR AS APPROVED BY THE ENGINEER.
- 5. REMOVAL OF SPECIFIED ITEMS, INCLUDING BUT NOT LIMITED TO, PAVEMENT, SIDEWALK, CURB, CURB AND GUTTER, CULVERTS, ETC. SHALL BE DISPOSED OF OFF-SITE BY THE CONTRACTOR. THE CONTRACTOR IS RESPONSIBLE FOR ANY PERMITS REQUIRED FOR SUCH DISPOSAL. THE REMOVAL SHALL BE ACCOMPLISHED BY MEANS OF A SAW CUT JOINT, AT THE DIRECTION OF THE ENGINEER.
- 5. THE CONTRACTOR SHALL COLLECT AND REMOVE ALL CONSTRUCTION DEBRIS, EXCESS MATERIALS, TRASH, OIL AND GREASE RESIDUE, MACHINERY, TOOLS AND OTHER MISCELLANEOUS ITEMS WHICH WERE NOT PRESENT PRIOR TO PROJECT COMMENCEMENT AT NO ADDITIONAL EXPENSE TO THE OWNER. THE CONTRACTOR SHALL BE RESPONSIBLE FOR ACQUIRING ANY AND ALL PERMITS NECESSARY FOR THE HAULING AND DISPOSAL REQUIRED FOR CLEAN-UP AS DIRECTED BY THE ENGINEER OR OWNER. BURNING ON THE SITE IS NOT PERMITTED.
- AT THE CLOSE OF EACH WORKING DAY AND AT THE CONCLUSION OF CONSTRUCTION OPERATIONS, ALL DRAINAGE STRUCTURES AND FLOW LINES SHALL BE FREE FROM DIRT AND DEBRIS.
- TREES NOT MARKED FOR REMOVAL SHALL BE CONSIDERED AS DESIGNATED TO BE SAVED AND SHALL BE PROTECTED UNDER THE PROVISIONS OF ARTICLE 201.05 OF THE SSRBC.
- THE TRENCHES FOR PIPE INSTALLATION SHALL BE KEPT DRY AT ALL TIMES DURING PIPE PLACEMENT. APPROPRIATE FACILITIES TO MAINTAIN THE DRY TRENCH SHALL BE PROVIDED BY THE CONTRACTOR.
- 10. TRENCH BACKFILL WILL BE REQUIRED TO THE FULL DEPTH ABOVE SEWERS AND WATER MAIN WITHIN TWO (2) FEET OF PROPOSED OR EXISTING PAVEMENT.
- II. IT SHALL BE THE CONTRACTOR'S RESPONSIBILITY TO VERIFY ALL DIMENSIONS AND CONDITIONS EXISTING IN THE FIELD PRIOR TO CONSTRUCTION AND ORDERING OF MATERIALS. THIS SHALL INCLUDE LOCATING THE MAST ARM FOUNDATIONS AND VERIFYING THE MAST ARM LENGTHS.
- 12. THE THICKNESS OF HMA MIXTURE STATED IN THE SPECIFICATIONS IS THE NOMINAL THICKNESS. DEVIATIONS FROM THE NOMINAL THICKNESS WILL BE PERMITTED WHEN SUCH DEVIATIONS FROM THE NOMINAL THICKNESS OCCUR DUE TO IRREGULARITIES IN THE EXISTING SURFACE OR BASE ON WHICH THE HMA SURFACE IS PLACED
- 13. ACCESS TO DRIVEWAYS SHALL BE MAINTAINED AT ALL TIMES BY LIMITING CURB AND GUTTER REPAIR TO ONE-HALF THE DRIVEWAY WIDTH AT ONE TIME AS THROUGH THE USE OF AGGREGATE FOR TEMPORARY ACCESS.
- 14. THE CONTRACTOR WILL NOT BE ALLOWED TO SET UP A YARD OR FIELD OFFICE ON VILLAGE RIGHT OF WAY WITHOUT WRITTEN PERMISSION FROM THE ENGINEER.
- 15. THE ENGINEER SHALL CONTACT THE AREA TRAFFIC FIELD TECHNICIAN, PATRICE HARRIS, AT PATRICE.HARRIS@ILLINOIS.GOV TWO (2) WEEKS PRIOR TO PLACING PERMANENT PAVEMENT MARKINGS,
- 16. THE CONTRACTOR SHALL CONTACT KALPANA KANNAN-HOSADURGA, THE DISTRICT ONE TRAFFIC CONTROL SUPERVISOR, AT KALPANA.KANNAN-HOSADURGA@ILLINOIS.GOV, ROBINSON ENGINEERING (708)331-6700 AND THE VILLAGE OF CRETE (708)672-5431 A MINIMUM OF 72 HOURS IN ADVANCE OF BEGINNING WORK.
- 17. THE CONTRACTOR SHALL TAKE PRECAUTION BY PRESERVING EXISTING TREES WITHIN THE RIGHT OF WAY. IF ANY DAMAGE OCCURS, TREES SHALL BE REPLACED IN KIND PER ARTICLE 201.07 REPAIR OR REPLACEMENT OF EXISTING PLAN MATERIAL REQUIREMENTS STATED HEREIN.
- 18. INSTALL ALL CHANGEABLE MESSAGE SIGNS, INFORMING THE PUBLIC OF THE DETOUR, AT LEAST ONE WEEK PRIOR TO THE ROADWAY CLOSURE.
- 9. THE AGGREGATE GRADATION FOR THE AGGREGATE SUBGRADE IMPROVEMENT 12" LOWER LIFT SHALL BE CS 1 OR RR 1.

STORM SEWER NOTES

- ON ALL IMPROVEMENTS THE FRAMES AND LIDS OF EXISTING CATCH BASINS, INLETS, MANHOLES AND VALVE VAULTS WHICH ARE TO BE ABANDONED DUE TO CONSTRUCTION OF THIS IMPROVEMENT ARE TO REMAIN THE PROPERTY OF THE VILLAGE OF CRETE AND BE SALVAGED. THE OWNER SHALL BE NOTIFIED AS TO AVAILABILITY FOR PICK-UP.
- THE TOP OF ALL STRUCTURES SHALL BE FLUSH WITH THE ADJACENT SURFACE OR AT THE INDICATED ELEVATIONS SHOWN ON THE PLANS.
- 3. FRAME ELEVATIONS ARE GIVEN ONLY TO ASSIST IN DETERMINING THE APPROXIMATE OVERALL HEIGHT OF THE STRUCTURE. FRAMES ON ALL NEW STRUCTURES WILL BE ADJUSTED TO THE FINAL ELEVATION OF THE AREA IN WHICH THEY ARE LOCATED.
- I. PIPE UNDERDRAINS SHALL BE INSTALLED ACCORDING TO SECTION 601 OF THE SSRBC AND STANDARD 601001-05. TOP OF PIPE UNDERDRAINS SHALL BE PLACED MINIMUM 6" BELOW THE AGGREGATE SUBGRADE IMPROVEMENT LAYER.
- 5. BACKFILLING STORM SEWER CONSTRUCTED UNDER THE ROADWAY SPECIFIED UNDER ARTICLE 550.07 (b, c) OF THE SSRBC WILL NOT BE ALLOWED.

EARTHWORK NOTES

- 1. GENERAL
 - A. IT IS THE CONTRACTOR'S RESPONSIBILITY TO UNDERSTAND THE SOIL AND GROUNDWATER CONDITIONS AT THE SITE
 - B. THE CONTRACTOR WILL NOTE THAT THE ELEVATIONS SHOWN ON THE CONSTRUCTION PLANS ARE FINISHED GRADE AND SUBGRADE ELEVATIONS (AS NOTED) AND THAT PAVEMENT THICKNESS, TOPSOIL, ETC. MUST BE ACCOUNTED FOR.
 - C. THE CONTRACTOR SHALL MAINTAIN POSITIVE DRAINAGE DURING CONSTRUCTION, AND PREVENT STORMWATER FROM RUNNING INTO OR STANDING IN EXCAVATED AREAS. THE FAILURE TO PROVIDE PROPER DRAINAGE WILL NEGATE ANY POSSIBLE ADDED COMPENSATION REQUESTED DUE TO DELAYS OR UNSUITABLE MATERIALS CREATED AS A RESULT THEREOF. FINAL GRADES SHALL BE PROTECTED AGAINST DAMAGE FROM EROSION, SEDIMENTATION AND TRAFFIC.
 - D. PLANS FOR THE SITE DEWATERING, IF EMPLOYED, SHALL BE SUBMITTED AND APPROVED PRIOR TO IMPLEMENTATION.
 - E. THE CONTRACTOR SHALL BE RESPONSIBLE FOR IMPLEMENTATION OF THE "SOIL EROSION AND SEDIMENTATION CONTROL MEASURES". THE INITIAL ESTABLISHMENT OF EROSION CONTROL PROCEDURES AND THE PLACEMENT OF SILT AND FILTER FENCING, ETC. TO PROTECT ADJACENT PROPERTY, WETLANDS, ETC. SHALL OCCUR BEFORE GRADING REGINS
 - F. ALL STORM INLETS SHALL BE PROTECTED BY INLET FILTERS. PLACEMENTS AND MAINTENANCE OR SILT BARRIER SHALL BE AS DIRECTED BY THE ENGINEER, BASED ON ACTUAL GRADING. GRADE THE AREA WITHIN FOUR (4) FEET AROUND STRUCTURES ONE (1) FOOT BELOW RIM TO SERVE AS A SEDIMENTATION BASIN DURING CONSTRUCTION
 - G. FINAL LOCATION OF SILT FENCE SHALL BE ADJUSTED BASED ON ACTUAL SITE GRADING CONDITIONS. ADDITIONAL MEASURES SHALL BE ADDED AS DIRECTED BY THE ENGINEER.
 - ALL AREAS DISTURBED DURING CONSTRUCTION SHALL BE RESEEDED AS SOON AS PRACTICAL.
 - I. THE SUBGRADE STABILITY SHALL BE VERIFIED BY PROOF ROLLING WITH A FULLY LOADED TANDEM-AXLE TRUCK.
 - J. AGGREGATE SUBGRADE IMPROVEMENT (CU YD) HAS BEEN PROVIDED FOR USE AT THE LOCATIONS INDICATED FOR SOILS THAT TEND TO BE UNSTABLE AND/OR UNSUITABLE. THE ACTUAL NEED FOR REMOVAL AND REPLACEMENT WITH ASI WILL BE DETERMINED IN THE FIELD AT THE TIME OF CONSTRUCTION BY THE GEOTECHNICAL ENGINEER. ALL POTENTIALLY UNSTABLE SOILS SHOULD BE TESTED WITH A STATIC OR DYNAMIC CONE PENETROMETER AND TREATED IN ACCORDANCE WITH ARTICLE 301.04 OF THE SSRBC AND IDOT SUBGRADE STABILITY MANUAL. IF UNSTABLE AND/OR UNSUITABLE SOILS ARE NOT ENCOUNTERED, THEN THE QUANTITY SHALL BE DEDUCTED AND NO ADDITIONAL COMPENSATION WILL BE DUE TO THE CONTRACTOR.
 - K. ANY AGGREGATE SUBGRADE IMPROVEMENT CONTAMINATED AND/OR DAMAGED BY THE CONTRACTOR'S VEHICLES AND/OR EQUIPMENTS IS TO BE REMOVED AND REPLACEED AS DIRECTED BY THE ENGINEER AT THE CONTRACTOR'S EXPENSE.

LANDSCAPING NOTES

1. CONTRACTOR SHALL TAKE PRECAUTION BY PRESERVING EXISTING TREES WITHIN THE RIGHT OF WAY. IF ANY DAMAGE OCCURS, TREES SHALL BE REPLACED IN KIND PER ARTICLE 201,07 REPAIR OR REPLACEMENT OF EXISTING PLANT MATERIAL REQUIREMENTS STATED HEREIN THIS NOTE SHALL APPLY TO ANY TREE INDIVIDUALLY NOTED ON THE PLANS THAT IS NOT OTHERWISE CALLED OUT FOR REMOVAL. THIS NOTE SHALL NOT APPLY TO REMOVALS NECESSARY FOR GRADING THAT ARE ILLUSTRATED BY AS A BRUSH/TREE LINE ON THE CONTRACT PLANS.

COMMITMENTS

NONE

FILE NAME = 21R0316-INDX-01 - P01	USER NAME =	DESIGNED — JPH	PEVISED		T	ODETE DOAD	LEAD	OFOTION	OOLINT)	TOTAL	SHEET
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		CHECKED — WPD	REVISED —	STATE OF ILLINOIS	R	OADWAY WIDENING/RESURFACING/RECONSTRUCTION	4309	15-00049-00-PV	WILL	52	2
	PLOT SCALE =	DRAWN — RG	REVISED —	DEPARTMENT OF TRANSPORTATION		INDEX OF SHEETS & STATE STANDARDS			CONTRACT	Γ NO. 61H	
	PLOT DATE = 11-16-22	CHECKED — AG	REVISED —		SCALE: NONE	SHEET NO. 2 OF 52 SHEETS STA. TO STA.	FED. ROA	D DIST. NO. 1 ILLINOIS FED. A	D PROJECT UMB	3W(332)	

					· ·		CONSTRUC		
						ROADWAY	SAFETY	LNSC	TRAINEES
S.P.	SPECIALTY ITEM	PAY CODE	PAY ITEM DESCRIPTION	UNIT	TOTAL QUANTITY	0003	0021	0031	0042
						URBAN	URBAN	URBAN	URBAN
***		***************************************				FED 80%/LPA 20%	FED 80%/LPA 20%	FED 80%/LPA 20%	FED 80%/LPA 20
		20101100	TREE TRUNK PROTECTION	£ACH	9			9	
				12.5					
	XX	20101200	TREE ROOT PRUNING	EACH	9	<u></u>		9	
	VV	20101700	SUPPLEMENTAL WATERING	UNIT	170	170			
	XX			SMI	,,,	1,0			
V		20200100	EARTH EXCAVATION	CU YD	5,300	5,300		-	
	310-2								
		20201200	REMOVAL AND DISPOSAL OF UNSUITABLE MATERIAL	CU YD	100	100			
		20800150	TRENCH BACKFILL	CU YD	520	520	-		
-		*					- Marie and a second		
		21001000	GEOTECHNICAL FABRIC FOR GROUND STABILIZATION	SQ YD	7,500	7,500			
- 0		21101615	TODGON FURNICH AND DIAGE. 4"	50.40	47.000			47.000	
		21101615	TOPSOIL FURNISH AND PLACE, 4"	SQ YD	17,000			17,000	and the same
·	XX	25000210	SEEDING, CLASS 2A	ACRE	3.0			3.0	
	XX	25000310	SEEDING, CLASS 4	ACRE	0.75			0.75	
	\ \ \ \ \ \ \ \ \ \ \ \ \ \ \ \ \ \ \	25000400	NITROGEN FERTILIZER NUTRIENT	POUND	270	-200		270	- 50000 1000
-	XX			1 00110	210			2,0	

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		CHECKED WPD	REVISED —
	PLOT SCALE =	DRAWN — RG	REVISED
	PLOT DATE = 11-16-22	CHECKED - AG	REVISED

STATE OF ILLINOIS
DEPARTMENT OF TRANSPORTATION

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SCALE. NONE	SHEET NO. 3	OF 52	SHEETS	STA	TO STA.

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1111						FED 80%/LPA 20%	FED 80%/LPA 20%	FED 80%/LPA 20%	FED 80%/LPA 20	
	XX	25000500	PHOSPHORUS FERTILIZER NUTRIENT	POUND	270			270		
	XX	25000600	POTASSIUM FERTILIZER NUTRIENT	POUND	270			270		
	\ \ \ \ \ \ \ \ \ \ \ \ \ \ \ \ \ \ \						- 111		-	
	хх	25100630	EROSION CONTROL BLANKET	SQ YD	17,000			17,000	- 21	
		28000250	TEMPORARY EROSION CONTROL SEEDING	POUND	360			360		
		2800030#	TEMPODADY DITOU	5007	560			560		
	-	28000305	TEMPORARY DITCH CHECKS	FOOT	560			360		
		28000400	PERIMETER EROSION BARRIER	FOOT	11,250		-111	11,250		
_		28000510	INLET FILTERS	EACH	41			41		
-		28100107	STONE RIPRAP, CLASS A4	SQ YD	75			75		
			>*							
		28200200	FILTER FABRIC	SQ YD	75			75		
		72								
		30300001	AGGREGATE SUBGRADE IMPROVEMENT	CU YD	100	100				
		30300112	AGGREGATE SUBGRADE IMPROVEMENT 12"	SQ YD	15,000	15000				
~		71000000	DDOOFCCING THE CTADILIZED COIL MINISTED 40"	50 VD	7,500	7500			-	
×		31000600	PROCESSING LIME STABILIZED SOIL MIXTURE 12"	SQ YD	7,300	7500	,			

FILE NAME = 21R0318-QUAN-01 - Q02	USER NAME =	DESIGNED - JPH	REVISED —	Ī
40		CHECKED WPD	REVISED -	i
-	PLOT SCALE =	DRAWN RG	REVISED -	ĺ
	PLOT DATE = 11-16-22	CHECKED - AG	REVISED —	

STATE OF ILLINOIS	
DEPARTMENT OF TRANSPORTATION	

SCALE: NONE		RY OF QUA		
ROAL	OWAY WIDEN	 RETE ROA ESURFAC	_	CONSTRUCTION

	-	CONTRACT	NO. 61 H	99	
4309	15-00049-00-PV	WILL	52	4	
F.A.U. RTE.	SECTION	COUNTY	SHEETS	SHEET NO.	

	T T		T		T .		CONSTRUCTION CODE			
	SPECIALTY ITEM					ROADWAY	SAFETY	LNSC	TRAINEES	
S.P.		PAY CODE	PAY ITEM DESCRIPTION	UNIT	TOTAL QUANTITY	000 4	0021	0031	0042	
						URBAN	URBAN	URBAN	URBAN	
						FED 80%/LPA 20%	FED 80%/LPA 20%	FED 80%/LPA 20%	FED 80%/LPA 20	
		31001500	LIME	TON	375	375	- 1			
		40201000	AGGREGATE FOR TEMPORARY ACCESS	TON	50	50			c:	
		40201000	AGONEGATE FOR TERMI GRANT AGGEGG	1011		30				
		40600275	BITUMINOUS MATERIALS (PRIME COAT)	POUND	28,000	28,000				
		. 20 50 - 00 - 00 - 00							7400-5	
		40600290	BITUMINOUS MATERIALS (TACK COAT)	POUND	6,820	6,820				
1000		40600370	LONGITUDINAL JOINT SEALANT	FOOT	8,200	8,200				
					•	·	<u> </u>			
***		40600982	HOT-MIX ASPHALT SURFACE REMOVAL - BUTT JOINT	SQ YD	35	35				
		40603080	HOT-MIX ASPHALT BINDER COURSE, IL-19.0, N50	TON	4,210	4,210				
		mŭ								
		40604060	HOT-MIX ASPHALT SURFACE COURSE, IL-9.5, MIX "D", N50	TON	1,200	1,200				
		44000100	PAVEMENT REMOVAL	SQ YD	9,800	9,800				
		44000100	PAVEMENT NEMOVAL	30 10	3,000	3,000				
		44000163	HOT-MIX ASPHALT SURFACE REMOVAL, 3 1/2"	SQ YD	1,810	1,810				
		44000200	DRIVEWAY PAVEMENT REMOVAL	SQ YD	260	260			70000 EV.	
		44000500	COMBINATION CURB AND GUTTER REMOVAL	FOOT	50	50				

FILE NAME = 21R0318-QUAN-01 - Q03	USER NAME =	DESIGNED — JPH	REVISED —
		CHECKED WPD	REVISED
	PLOT SCALE -	DRAWN — RG	REVISED
	PLOT DATE = 11-16-22	CHECKED — AG	REVISED —

STATE OF ILLINOIS	
DEPARTMENT OF TRANSPORTATION	

F	ROADWAY WIDEN	CRETE F IING/RESURF IMMARY OF C	ACING/REC		
SCALE: NONE	SHEET NO. 5	OF 52 SHEETS	STA.	TO STA.	

F.A.U. RTE.	SEC	TION COU		COUNTY	TOTAL SHEETS	SHEET NO.
4309	15-000	49-00-PV		MILL	52	5
				CONTRACT	NO. 61H	99
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			PAY CODE PAY ITEM DESCRIPTION			ROADWAY	SAFETY	LNSC	TRAINEES
S.P.	SPECIALTY ITEM	PAY CODE		UNIT	TOTAL QUANTITY	0004	0021	0031	0042
					URBAN	URBAN	URBAN	URBAN	
	1					FED 80%/LPA 20%	FED 80%/LPA 20%	FED 80%/LPA 20%	FED 80%/LPA 20%
		44201713	CLASS D PATCHES, TYPE I, 6 INCH	SQ YD	20	20	***************************************		
Į.		44201717	CLASS D PATCHES, TYPE II, 6 INCH	SQ YD	30	30			
		44201721	CLASS D PATCHES, TYPE III, 6 INCH	SQ YD	40	40			
AH .									
		44201723	CLASS D PATCHES, TYPE IV, 6 INCH	SQ YD	50	50			
		50405000	DIDE CHINEDE DEMONI	5007					
J		50105220	PIPE CULVERT REMOVAL	FOOT	180	180			
		54001001	BOX CULVERT END SECTIONS, CULVERT NO. 1	EACH	2	2	11	111	
		54010302	PRECAST CONCRETE BOX CULVERTS 3' X 2'	FOOT	57	57			
									1101 III III III
		54213657	PRECAST REINFORCED CONCRETE FLARED END SECTIONS 12"	EACH	1	1			
		54213681	PRECAST REINFORCED CONCRETE FLARED END SECTIONS 36"	EACH	1	1			
							7,540	01000	
		550A0050	STORM SEWERS, CLASS A, TYPE 1 12"	FOOT	892	892			
		550A0070	STORM SEWERS, CLASS A, TYPE 1 15"	FOOT	364	364			
								#	
		550A0090	STORM SEWERS, CLASS A, TYPE 1 18"	FOOT	574	574			
				The state of the s					

1	FILE NAME = 21R0315-QUAN-01 - 004	USER NAME =	DESIGNED - JPH	REVISED	
			CHECKED WPD	AEVISED —	
į		PLOT SCALE ==	DRAWN — RG	REVISED	[
		PLOT DATE = 11-16-22	CHECKED - AG	REVISED	

STATE OF ILLINOIS
DEPARTMENT OF TRANSPORTATION

RO		CRETE RO IING/RESURFA IMMARY OF Q	CING/REC	CONSTRUCTION	
SCALE: NONE	SHEET NO. 6	OF 52 SHEETS	STA.	TO STA.	

F.A.U. SECTION		COUNTY	TOTAL	SHEET NO.
4309 15-00049-00-PV		WILL	6	
	I =hinty	CONTRACT	NO. 61H	99
	The second second second second		Linear	

					CONSTRUC	TION CODE			
						ROADWAY	SAFETY	LNSC	TRAINEES
s.P.	SPECIALTY ITEM	DAY CODE	DAY ITEM DECODIDITION	UNIT	TOTAL QUANTITY	0004	0021	0031	0042
5.7.	ITEM	PAY CODE	PAY ITEM DESCRIPTION	UNII	TOTAL QUANTITY	URBAN	URBAN	URBAN	URBAN
						FED 80%/LPA 20%	FED 80%/LPA 20%	FED 80%/LPA 20%	FED 80%/LPA 20%
		550A0120	STORM SEWERS, CLASS A, TYPE 1 24"	FOOT	940	940			
		550A0140	STORM SEWERS, CLASS A, TYPE 1 30"	FOOT	375	375			
		550A0450	STORM SEWERS, CLASS A, TYPE 2 36"	FOOT	1,389	1,389			
Х	XX	56106600	ADJUSTING WATER MAIN 12"	FOOT	200	200			
Х	XX	56400300	FIRE HYDRANTS TO BE ADJUSTED	EACH	15	15			
		60108204	PIPE UNDERDRAINS, TYPE 2, 4"	FOOT	1,000	1,000			
		60200805	CATCH BASINS, TYPE A, 4'-DIAMETER, TYPE 8 GRATE	EACH	1	1			
		60201105	CATCH BASINS, TYPE A, 4'-DIAMETER, TYPE 11 FRAME AND GRATE	EACH	6	6			
				FACU					
		60204505	CATCH BASINS, TYPE A, 5'-DIAMETER, TYPE 8 GRATE	EACH	5	5			
		60204805	CATCH BASINS, TYPE A, 5'-DIAMETER, TYPE 11 FRAME AND GRATE	EACH	1	1			
		60207605	CATCH BASINS, TYPE C, TYPE 8 GRATE	EACH	1	1			
		60207905	CATCH BASINS, TYPE C, TYPE 11 FRAME AND GRATE	EACH	15	15			

FILE NAME = 2:R0316-QUAN-01 - Q05	USER NAME =	DESIGNED JPH	REVISED —
		CHECKED - WPD	REVISED —
	PLOT SCALE -	DRAWN — RG	REVISED
	PLOT DATE = 11-16-22	CHECKED — AG	REVISED

STATE OF ILLINOIS
DEPARTMENT OF TRANSPORTATION

F	ROADWA		ING/RI	RETE ROA ESURFAC IY OF QUA	NG/RE	CONSTRUCTION	
SCALE: NONE	SHE	ET NO. 7	OF 52	SHEETS	STA.	TO STA.	***************************************

F.A.U. RTE,	SECTION			COUNTY	TOTAL SHEETS	SHEET NO.					
4309	15-00049-00-PV			WILL	52	7					
					CONTRACT	NO. 61H	99				
		1	ETD BOAD DICT NO. 1 BURDIS DED AID BOD JECT LINGWISSON								

	·						CONSTRUC		
						ROADWAY	SAFETY	LNSC	TRAINEES
S.P.	SPECIALTY ITEM	PAY CODE	PAY ITEM DESCRIPTION	UNIT	TOTAL QUANTITY	0003	0021	0031	0042
	II E.M			91	, on a gold and	URBAN	URBAN	URBAN	URBAN
						FED 80%/LPA 20%	FED 80%/LPA 20%	FED 80%/LPA 20%	FED 80%/LPA 20
		60221100	MANHOLES, TYPE A, 5'-DIAMETER, TYPE 1 FRAME, CLOSED LID	EACH	1	1			
		60223800	MANHOLES, TYPE A, 6'-DIAMETER, TYPE 1 FRAME, CLOSED LID	EACH	4	4			
		60224005	MANHOLES, TYPE A, 6'-DIAMETER, TYPE 8 GRATE	EACH	1	1			
		60224448	MANHOLES, TYPE A, 7'-DIAMETER, TYPE 8 GRATE	EACH	2	2			
		60224458	MANHOLES, TYPE A, 8'-DIAMETER, TYPE 8 GRATE	EACH	1	1			
		60236200	INLETS, TYPE A, TYPE 8 GRATE	EACH	3	3			
				CACIT	3	J			
		60236800	INLETS, TYPE A, TYPE 11 FRAME AND GRATE	EACH	7	7			
		60266600	VALVE BOXES TO BE ADJUSTED	EACH	5.0	5.0			
		60500060	REMOVING INLETS	EACH	1	1			
		60603800	COMBINATION CONCRETE CURB AND GUTTER, TYPE B-6.12	FOOT	8,720	8,720			
		67100100	MOBILIZATION	LSUM	1	1			
		70107025	CHANGEABLE MESSAGE SIGN	CAL DA	90		90		

ı				
	FILE NAME = 21R0316-QUAN-01 - Q05	USER NAME =	DESIGNED — JPH	REVISED —
	:		CHECKED WPD	REVISED
		PLOT SCALE ∞	DRAWN — RG	REVISED —
		PLOT DATE = 11-16-22	CHECKED AG	REVISED

STATE OF ILLINOIS	
DEPARTMENT OF TRANSPORTATION	

_			CRETE RO		
	RC		ING/RESURFA IMMARY OF Q		CONSTRUCTION S
	SCALE: NONE	SHEET NO. 8	OF 52 SHEETS	STA.	TO STA.

F.A.U. ATE.	SECTION	COUNTY	TOTAL SHEETS	SHEET NO,
4309	15-00049-00-PV	WILL	52	6
		CONTRACT	VO. 61H	99
FED. RO	AD DIST NO 1 HUNOIS FED A	D PROJECT LIMBY	((332)	


						ROADWAY		TION CODE	TOAINEEC
							SAFETY	LNSC	TRAINEES
S.P.	SPECIALTY ITEM	PAY CODE	PAY ITEM DESCRIPTION	UNIT	TOTAL QUANTITY	0003	0021	0031	0042
						URBAN FED 80%/LPA 20%	URBAN FED 80%/LPA 20%	URBAN FED 80%/LPA 20%	URBAN FED 80%/LPA 20%
		72000100	SIGN PANEL TYPE 1		40	120 80%/ EFA 20%		FED 80%/LPA 20%	FED 80%/LFA 20%
	XX	72000100	SIGN PANEL TIPE T	SQ FT	48		48		
X		72400100	REMOVE SIGN PANEL ASSEMBLY — TYPE A	EACH	7		7		
		72400200	REMOVE SIGN PANEL ASSEMBLY — TYPE B	EACH	1		1		
	Хχ	72900200	METAL POST — TYPE B	FOOT	90		90		
	xx	78000200	THERMOPLASTIC PAVEMENT MARKING LINE 4"	FOOT	8,550		8550		
	xx	78000650	THERMOPLASTIC PAVEMENT MARKING — LINE 24"	FOOT	20		20		
x		X0100029	EXPLORATORY EXCAVATION	FOOT	160	160			
х		X0322917	PROPOSED STORM SEWER CONNECTION TO EXISTING MANHOLE	EACH	2	2			
X	ХХ	X0327112	STUMP REMOVAL, ACRES	ACRE	1			1	10141
X	XX	X2010400	STUMP REMOVAL ONLY	UNIT	352			352	
x		X7010216	TRAFFIC CONTROL AND PROTECTION, (SPECIAL)	L SUM	1	1		·	
x		Z0004514	HOT-MIX ASPHALT DRIVEWAY PAVEMENT, 4"	SQ YD	340	340			

FILE NAME == 2180316-QUAN-01 - Q07	USER NAME =	DESIGNED — JPH	REVISED —		CRETE ROAD	F.A.U. SECTION	COUNTY TOTAL SHEET
		CHECKED WPD	REVISED -	STATE OF ILLINOIS	ROADWAY WIDENING/RESURFACING/RECONSTRUCTION	DIE.	SHEETS NO.
	PLOT SCALE =	DRAWN — RG	REVISED	DEPARTMENT OF TRANSPORTATION	SUMMARY OF QUANTITIES	4309 15-00049-00-PV	WILL 52 9
	PLOT DATE = 11-16-22	CHECKED — AG	REVISED —		SCALE: NONE SHEET NO. 9 OF 52 SHEETS STA. TO STA.		CONTRACT NO. 61H99

						CONSTRUCTION CODE					
						ROADWAY	SAFETY	LNSC	TRAINEES		
S.P.	SPECIALTY	PAY CODE	PAY ITEM DESCRIPTION	UNIT	TOTAL QUANTITY	000 4	0021	0031	0042		
/	ITEM	,,,,,,	TAT TEM SESONI HOX		TOTAL QUANTITY	URBAN	URBAN	URBAN	URBAN '		
						FED 80%/LPA 20%	FED 80%/LPA 20%	FED 80%/LPA 20%	FED 80%/LPA 20%		
Х		Z0017400	DRAINAGE & UTILITY STRUCTURES TO BE ADJUSTED	EACH	5	5					
X	XX	Z0073510	TEMPORARY TRAFFIC SIGNAL TIMING	EACH	4	4					
X	*	Z0076600	TRAINEES	HOUR	500				500		
•											
		Z0076604	TRAINEES TRAINING PROGRAM GRADUATE	HOUR	500				500		


FILE NAME = 21R0316-QUAN-01 - Q08	USER NAME =	DESIGNED — JPH	REVISED —
		CHECKED WPD	REVISED —
	PLOTSCALE =	DRAWN RG	REVISED
	PLOT DATE = 11-16-22	CHECKED AG	REVISED

CRETE ROAD										
ROADWAY WIDENING/RESURFACING/RECONSTRUCTION SUMMARY OF QUANTITIES										
SOMMANI OF QUANTITIES										
SCALE: NONE	SHEET NO, 10	OF 52	SHEETS	STA.	TO STA.					

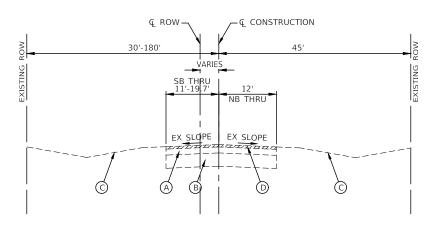


EXISTING TYPICAL SECTION

CRETE ROAD STA 501+09.02 TO STA 506+50.00

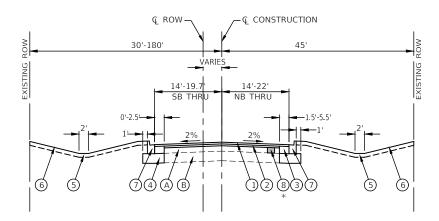


PROPOSED TYPICAL SECTION

CRETE ROAD STA 501+09.02 TO STA 506+50.00

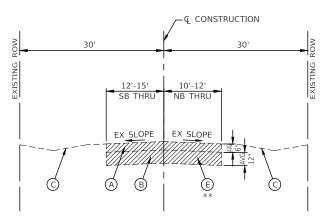


EXISTING TYPICAL SECTION

CRETE ROAD STA 506+50.00 TO STA 543+50.00

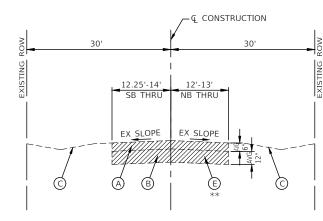


EXISTING TYPICAL SECTION

CRETE ROAD STA 543+50.00 TO STA 544+68.77

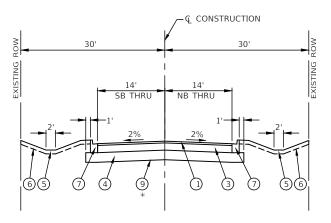

PROPOSED TYPICAL SECTION

CRETE ROAD STA 506+50.00 TO STA 543+50.00

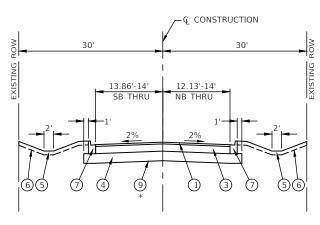

PROPOSED TYPICAL SECTION

CRETE ROAD STA 543+50.00 TO STA 544+68.77

EXISTING LEGEND

- (A) EXISTING PAVEMENT SEE PROJECT GEOTECHNICAL REPORT
- B EXISTING AGGREGATE SUBGRADE
- © EXISTING AGGREGATE/TURF SHOULDER
- D HOT-MIX ASPHALT SURFACE REMOVAL, 3-1/2"
- E ROADWAY TO BE REMOVED
- ITEMS TO BE REMOVED

**REMOVAL OF EXISTING HMA ROADWAY MATERIAL SHALL BE PAID FOR AS PAVEMENT REMOVAL. ANY AGGREGATE BASE, STONE SHOULDER OR OTHER NON-HMA MATERIAL REQUIRED TO BE REMOVED SHALL BE PAID FOR AS EARTH EXCAVATION.

PROPOSED LEGEND

- 1) HOT-MIX ASPHALT SURFACE COURSE, MIX "D", IL-9.5, N50, 1-1/2"
- (2) HOT-MIX ASPHALT BINDER COURSE, IL-19.0, N50, 2-1/4"
- (3) HOT-MIX ASPHALT BINDER COURSE, IL-19.0, N50, 6"
- 4 AGGREGATE SUBGRADE IMPROVEMENT, 12"
- 5 TOPSOIL, FURNISH AND PLACE, 4"
- 6 SEEDING, CLASS 2A
- 7 COMBINATION CONCRETE CURB AND GUTTER, TYPE B-6.12
- 8 CLASS D PATCH, 6"
- 9 GEOTECHNICAL FABRIC FOR GROUND STABILIZATION

*AS DIRECTED BY THE ENGINEER

NOTE: LONGITUDINAL JOINT SEALANT SHALL BE PLACED BELOW THE SURFACE COURSE THROUGHOUT THE LENGTH OF THE PROJECT.

HOT-MIX ASPHALT MIXTURE REQUIREMENTS

MIXTURE TYPE	AIR VOIDS @ Ndes	QMP
PAVEMENT RECONSTRUCTION & WIDENING		
HOT MIX ASPHALT SURFACE COURSE, MIX "D", IL-9.5, N50, 1-1/2"	4% @ 50 Gyr.	LR 1030-2
HOT MIX ASPHALT BINDER COURSE, IL-19.0, N50, 6"	4% @ 50 Gyr.	LR 1030-2
PAVEMENT RESURFACING		
HOT MIX ASPHALT SURFACE COURSE, MIX "D", IL-9.5, N50, 1-1/2"	4% @ 50 Gyr.	LR 1030-2
HOT-MIX ASHPALT BINDER COURSE, IL-19.0, N50, 2-1/4"	4% @ 50 Gyr.	LR 1030-2
HOT-MIX ASPHALT DRIVEWAY PAVEMENT, 4"		
HOT MIX ASPHALT SURFACE COURSE, MIX "D", IL-9.5, N50, 4" (IN 2 LIFTS)	4% @ 50 Gyr.	LR 1030-2
PAVEMENT PATCHING		
CLASS D PATCH (HMA BINDER IL-19.0), 6"	4% @ 70 Gyr.	LR 1030-2
QMP DESIGNATION: QUALITY CONTROL/QUALITY ASSURANCE (QC/QA) PER LR 1030-2		


NOTES:


- 1. THE UNIT WEIGHT USED TO CALCULATE ALL HMA SURFACE MIXTURE IS 112 LBS/SQ/IN.
- 2. ALL PATCHING OPERATIONS SHALL TAKE PLACE AFTER SURFACE MILLING HAS BEEN COMPLETED.
- 3. THE "AC TYPE" FOR POLYMERIZED HMA MIXES SHALL BE "SBS/SBR PG 76-22" AND FOR NON-POLYMERIZED HMA THE "AC TYPE" SHALL BE "PG-22" UNLESS MODIFIED BY RECLAIMED MATERIALS SPECIFICATIONS.


FILE NAME = 21R0316-TYPX-01 - P01	USER NAME =	DESIGNED — JPH	REVISED —
		CHECKED — WPD	REVISED —
	PLOT SCALE =	DRAWN — RG	REVISED —
	PLOT DATE = 11-16-22	CHECKED — AG	REVISED —


STATE OF ILLINOIS
DEPARTMENT OF TRANSPORTATION


	F.A.U. RTE.	SEC.	SECTION			TOTAL SHEETS	SHEET NO.			
ROADWAY WIDENING/RESURFACING/RECONSTRUCTION					9 15-00049-00-PV			WILL	52	11
	TYPICAL CROSS SECTIONS							CONTRACT	NO. 61H	99
SCALE: 1"=10'	SHEET NO. 11 OF 52 SHEETS	STA.	TO STA.	FFD. BC	FED BOAD DIST, NO. 1 JI LINOIS FED AID PROJECT LIMB			V(332)		

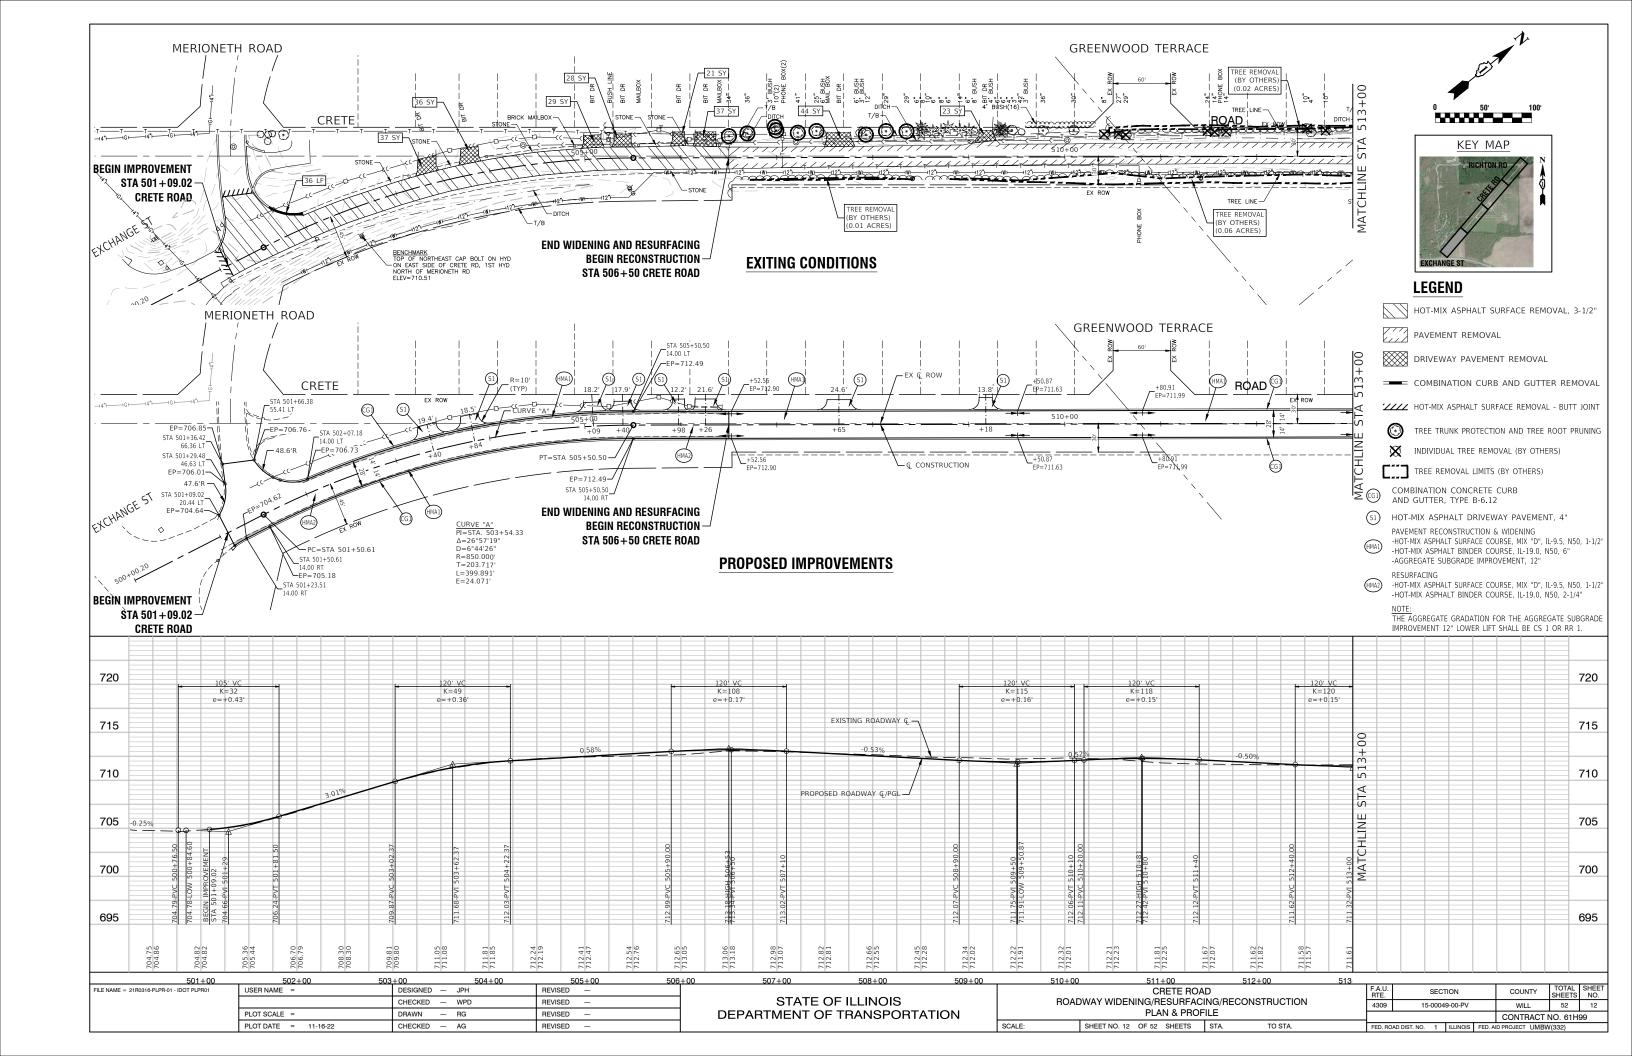


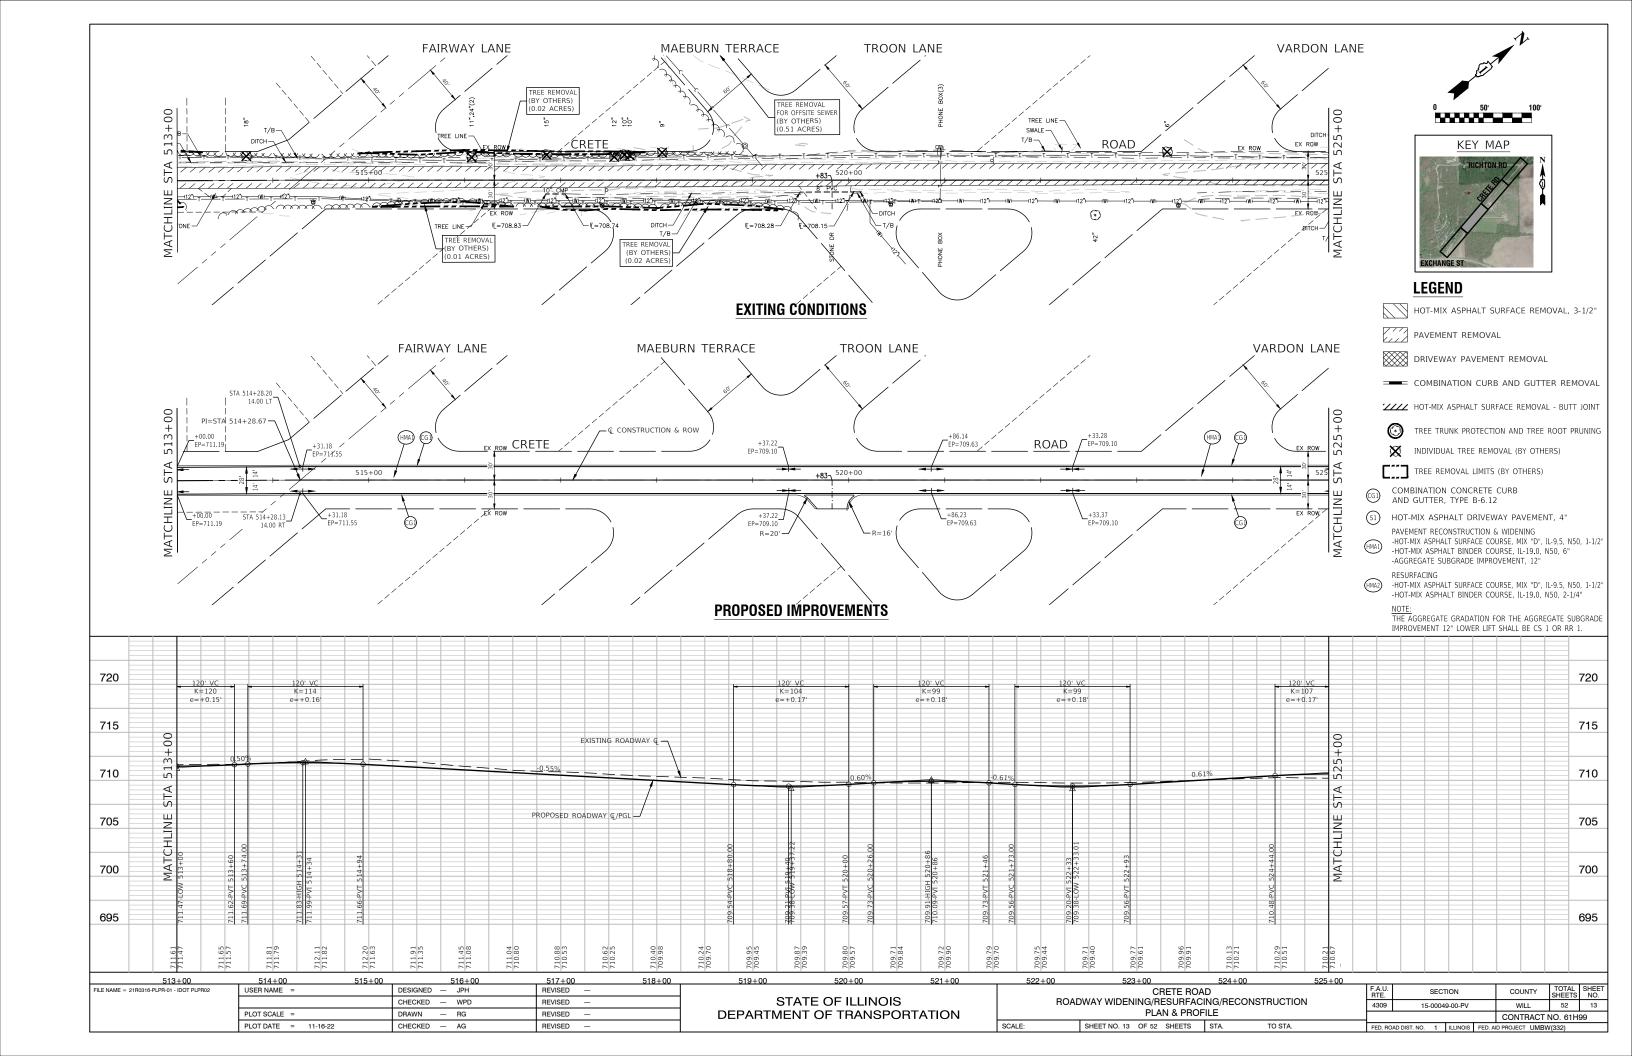


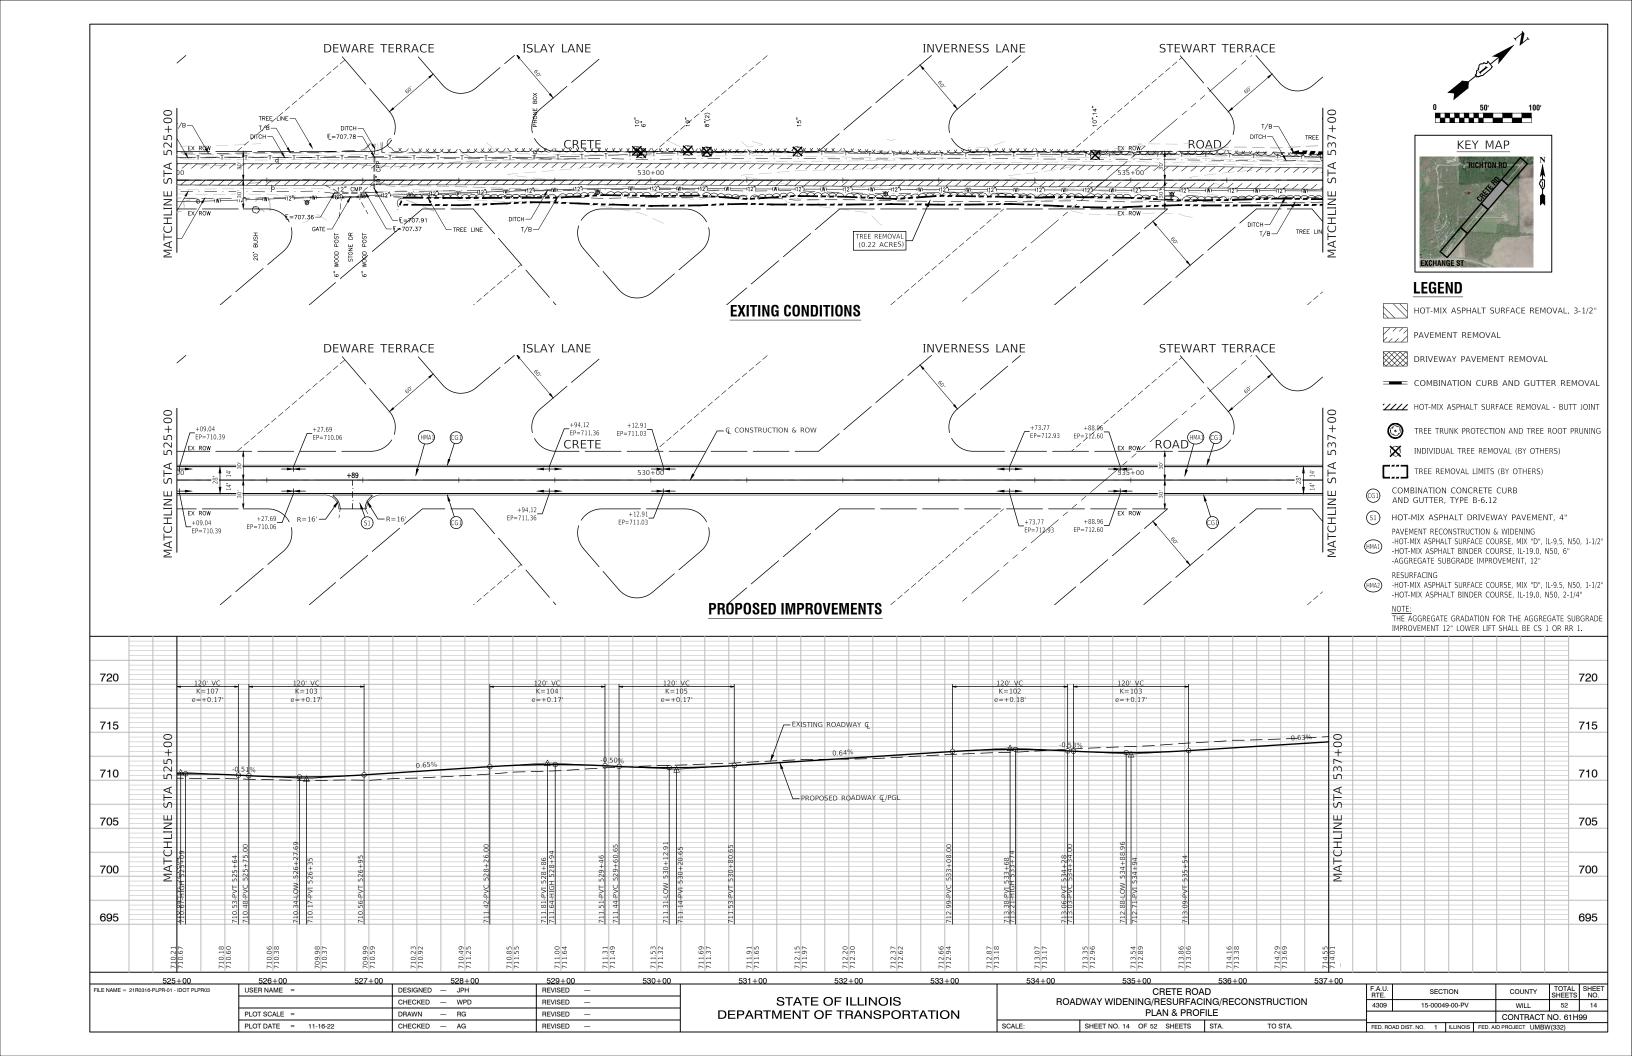


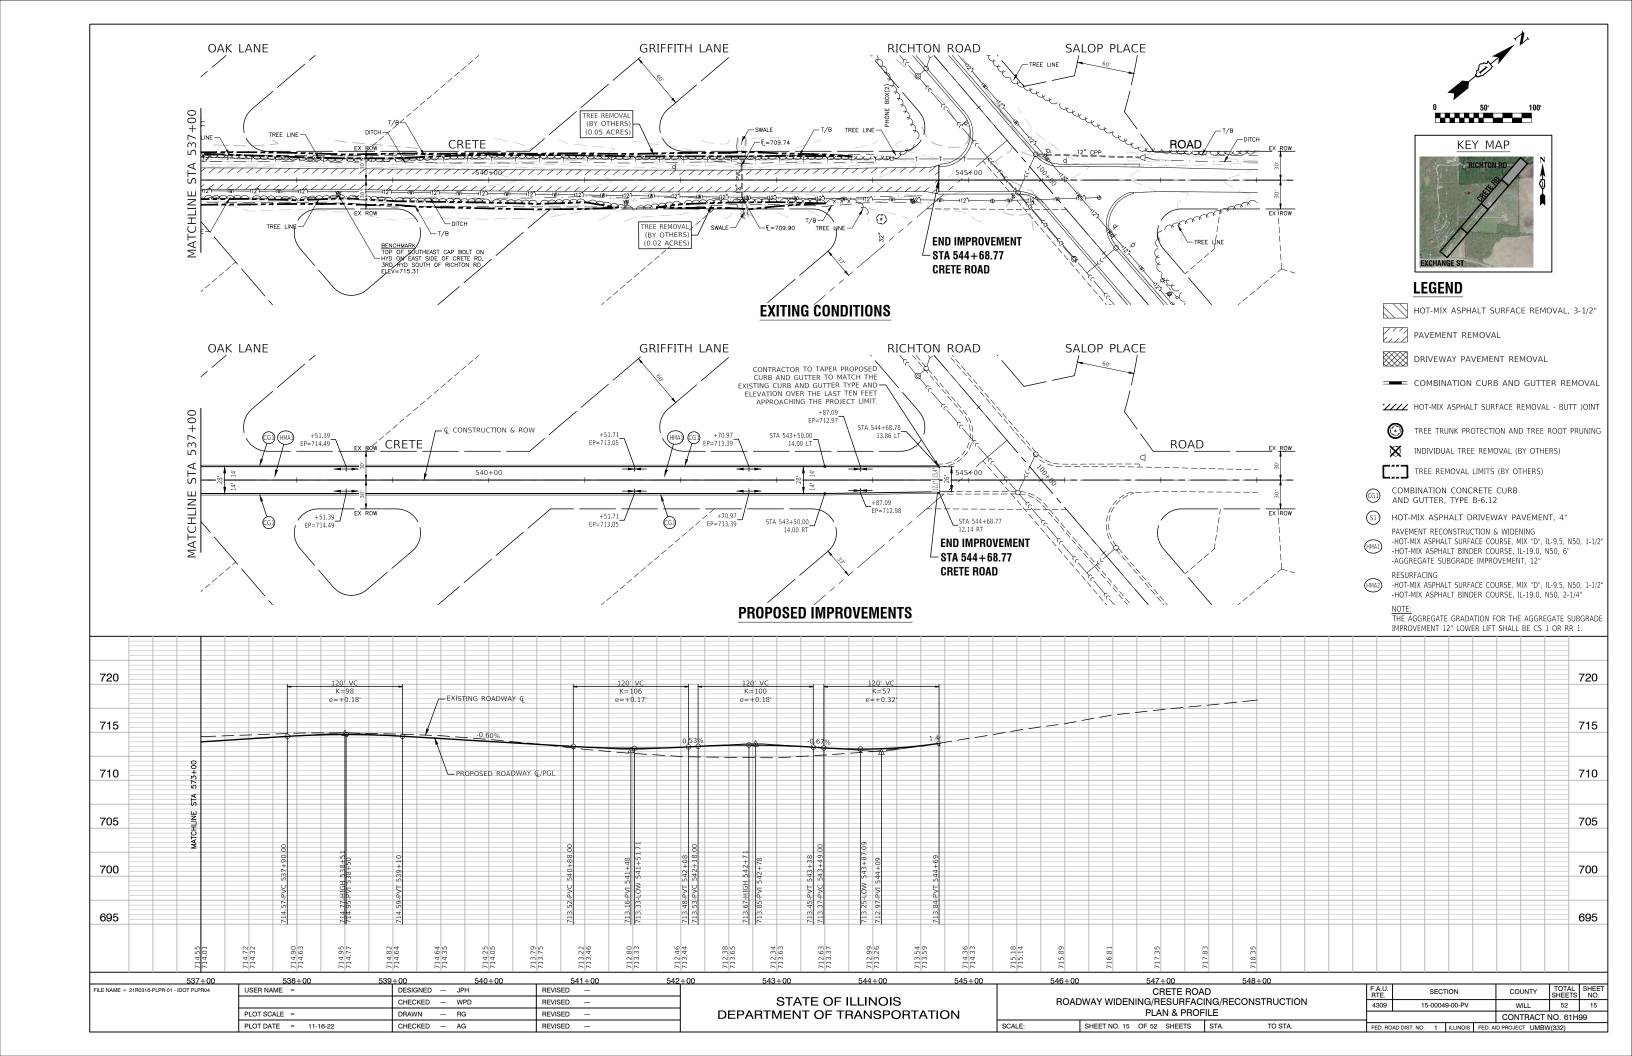


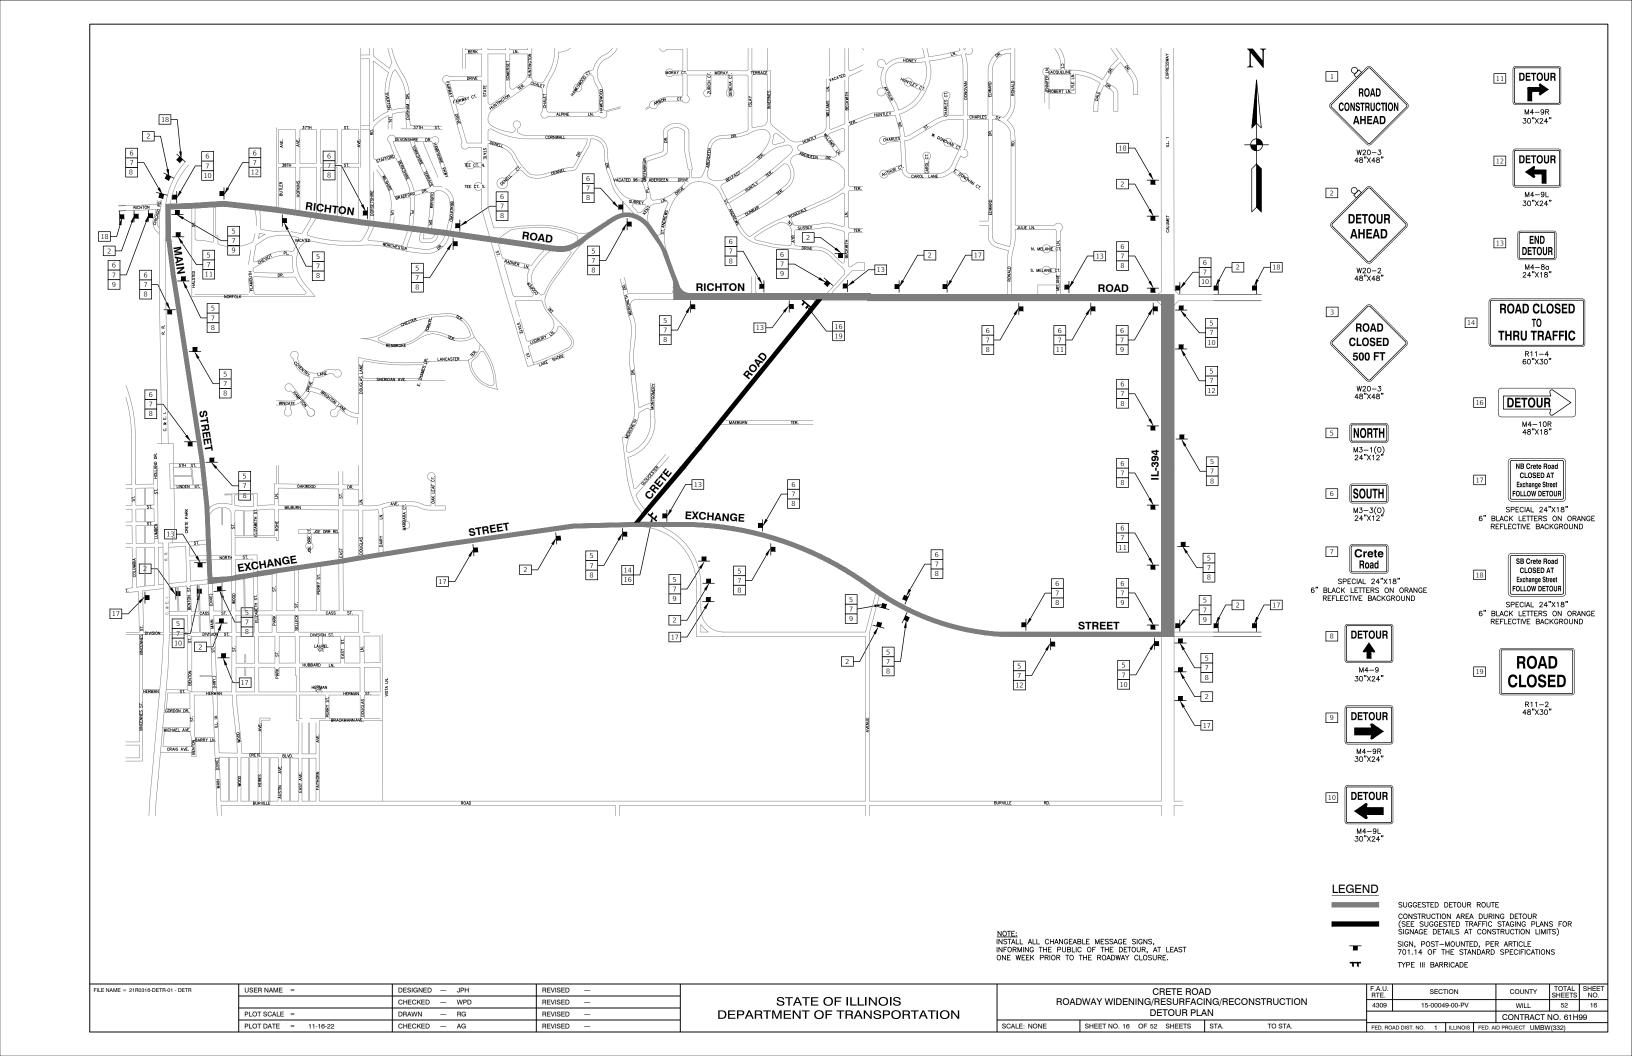


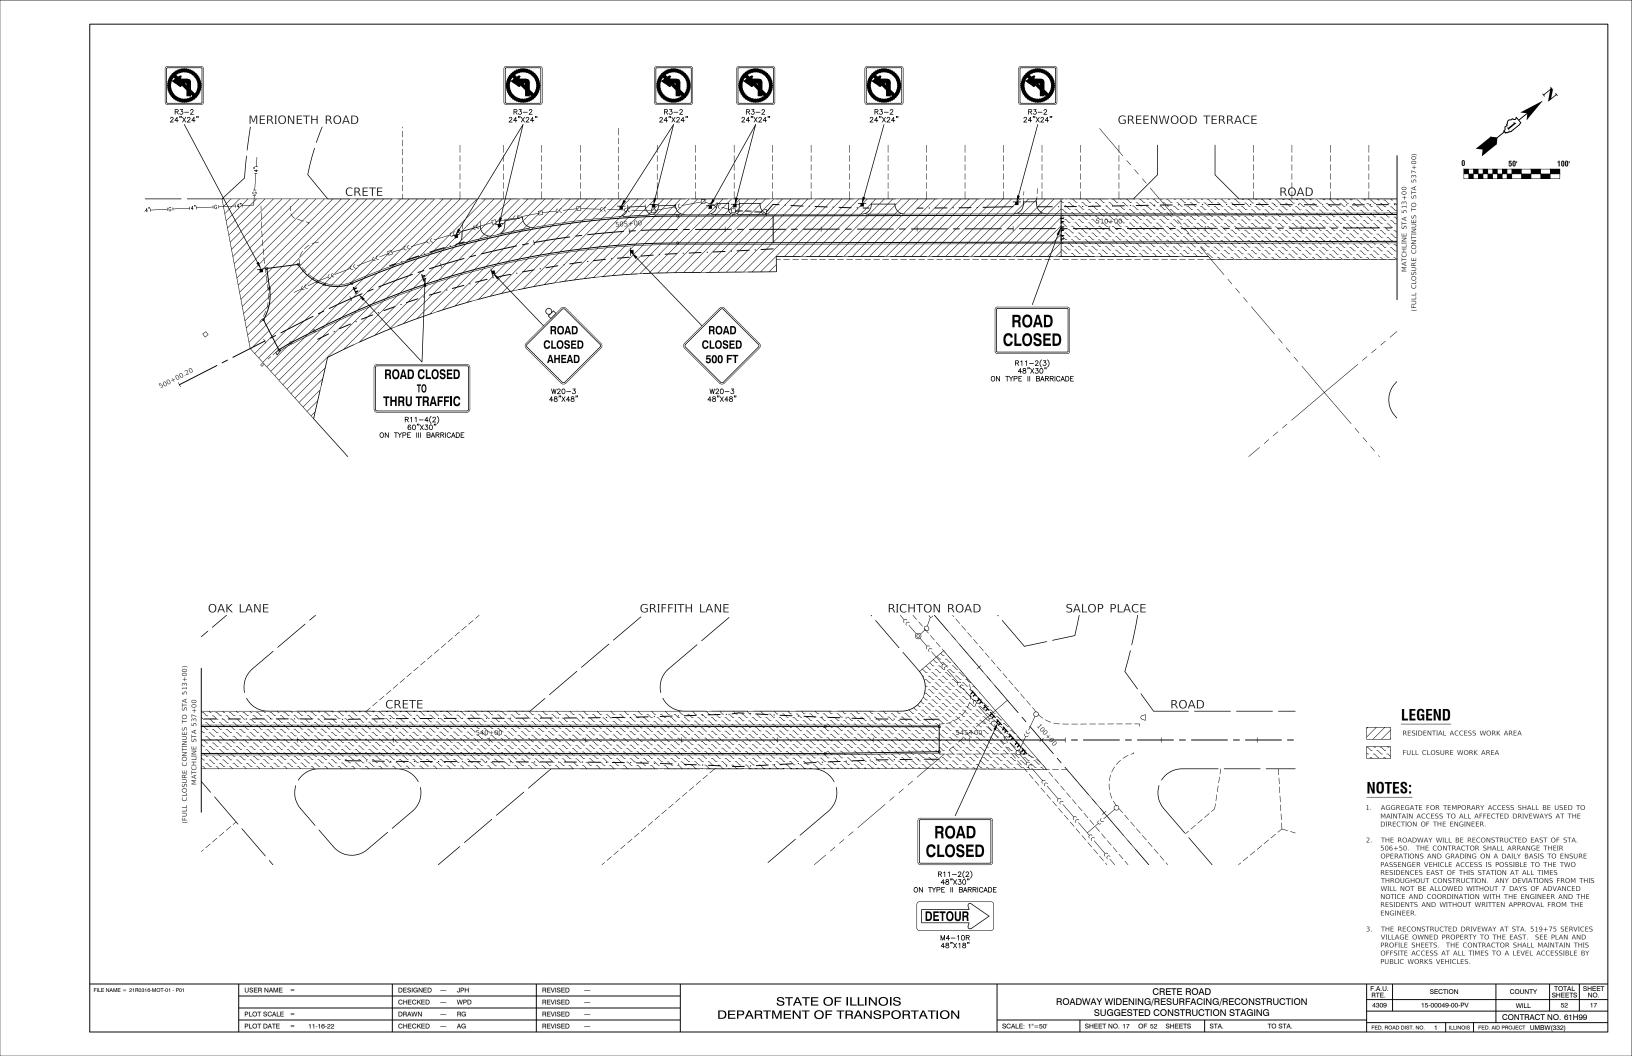


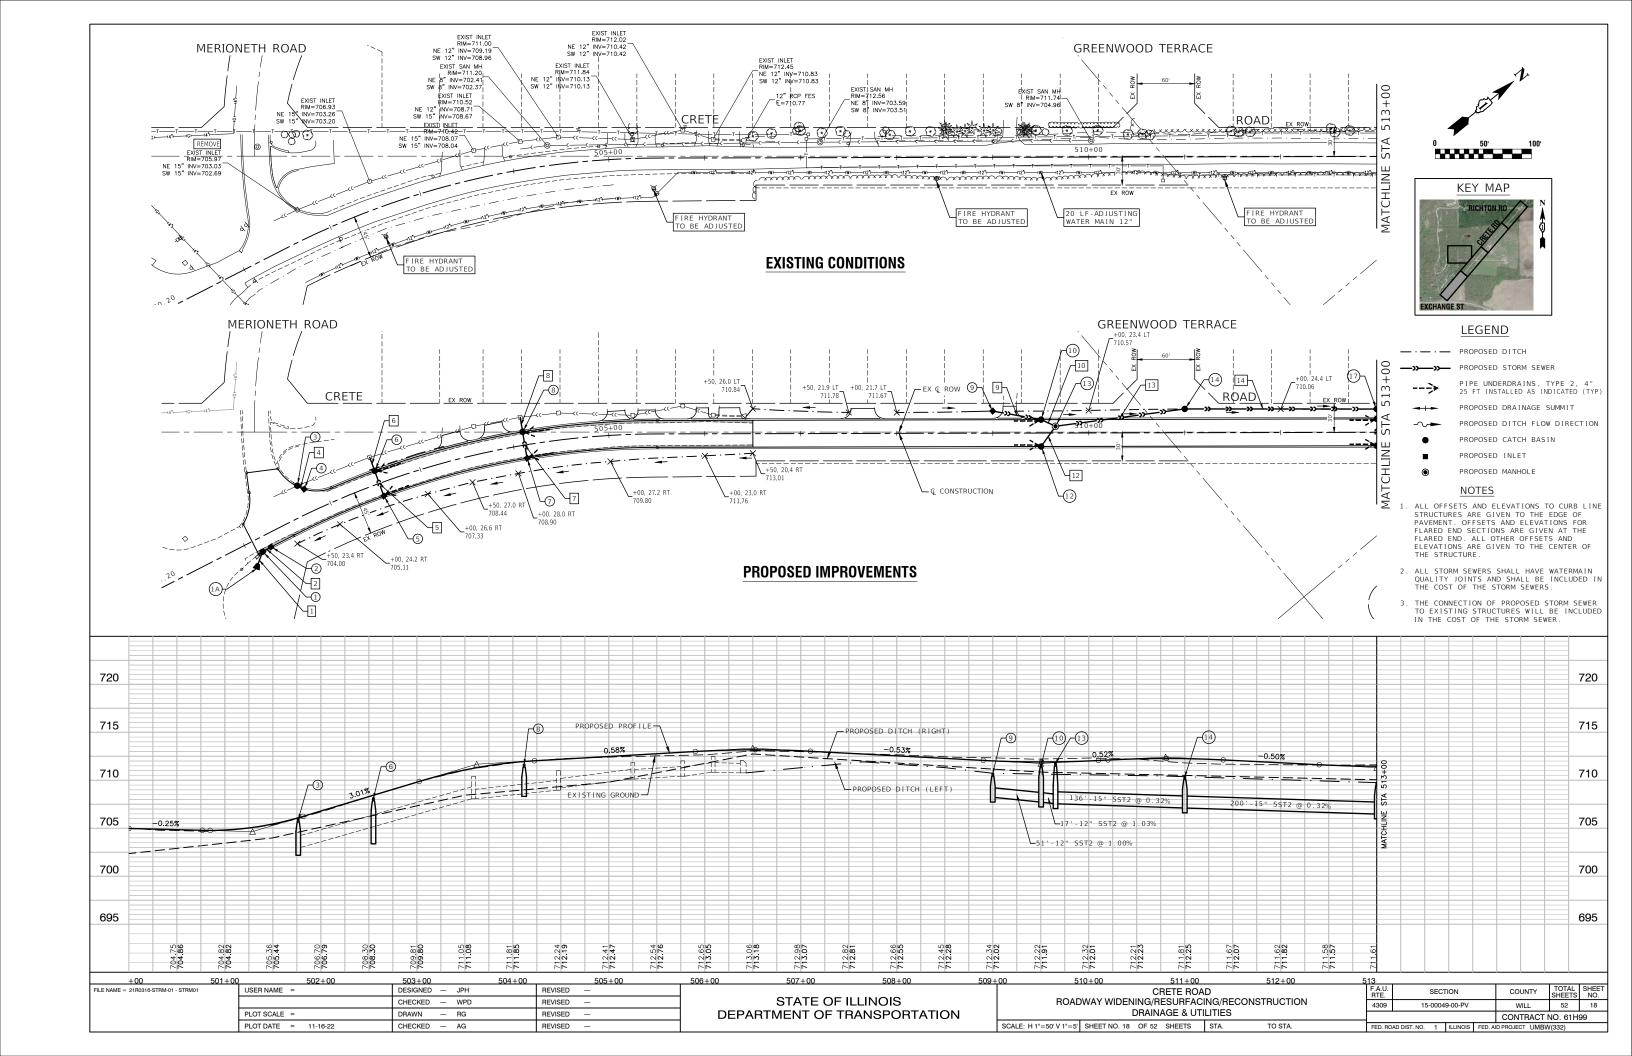

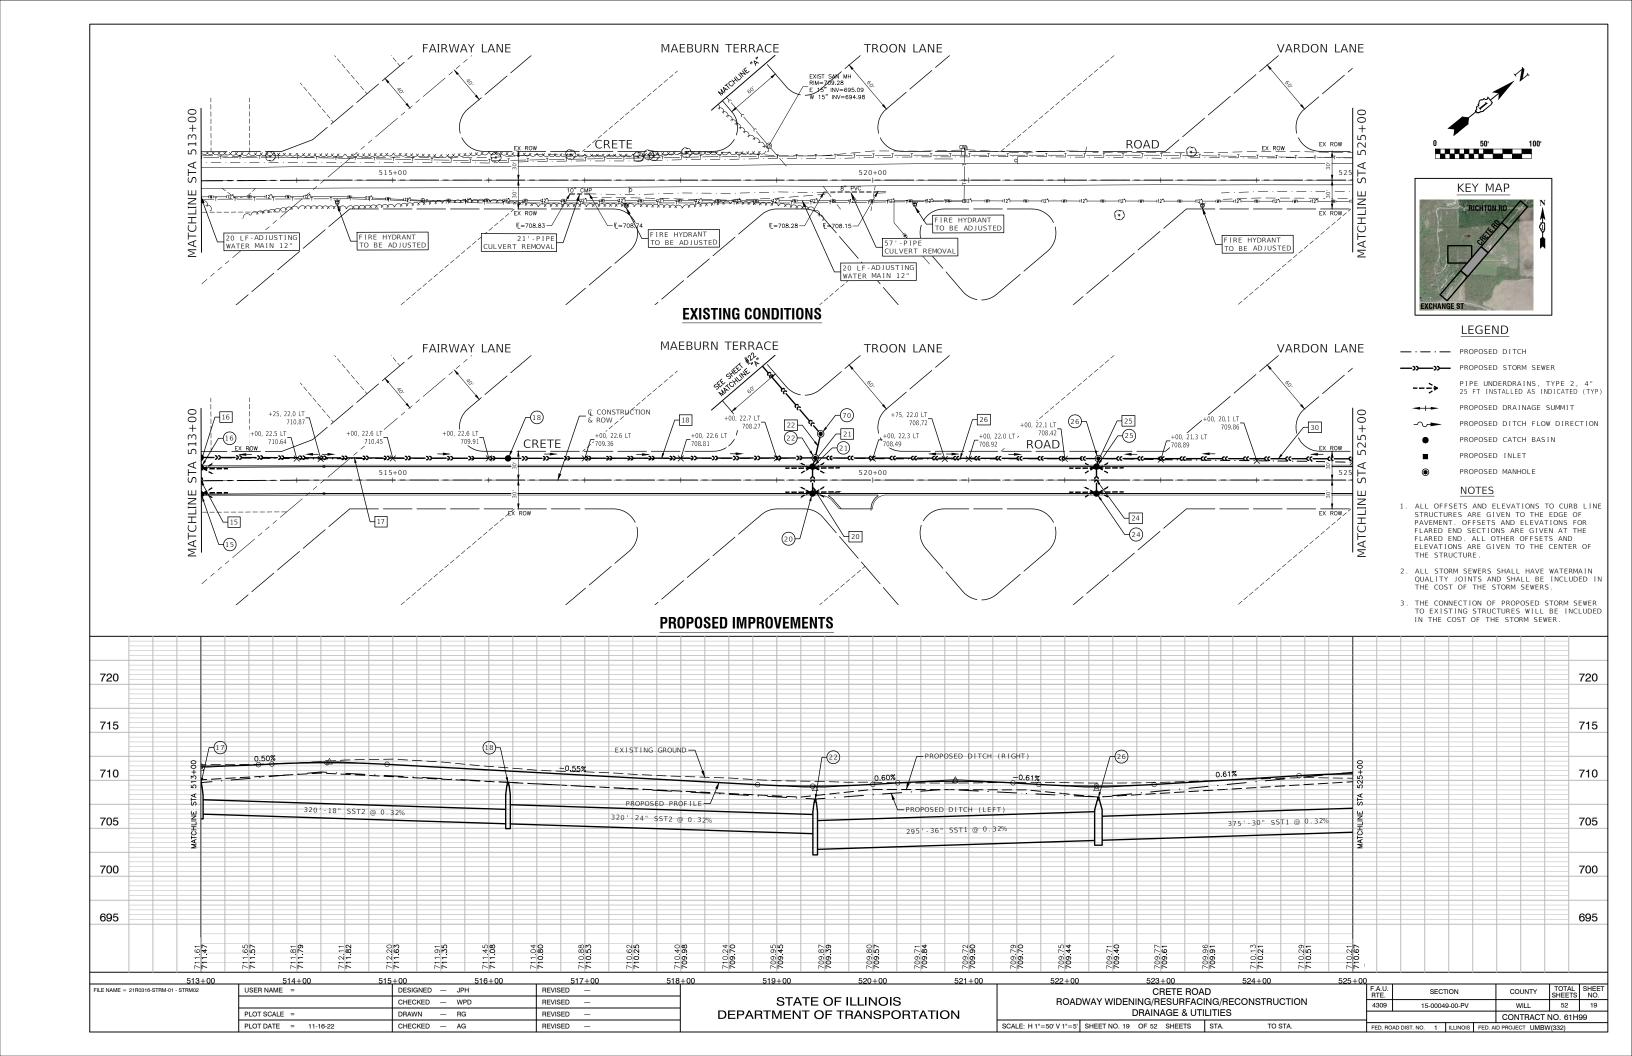

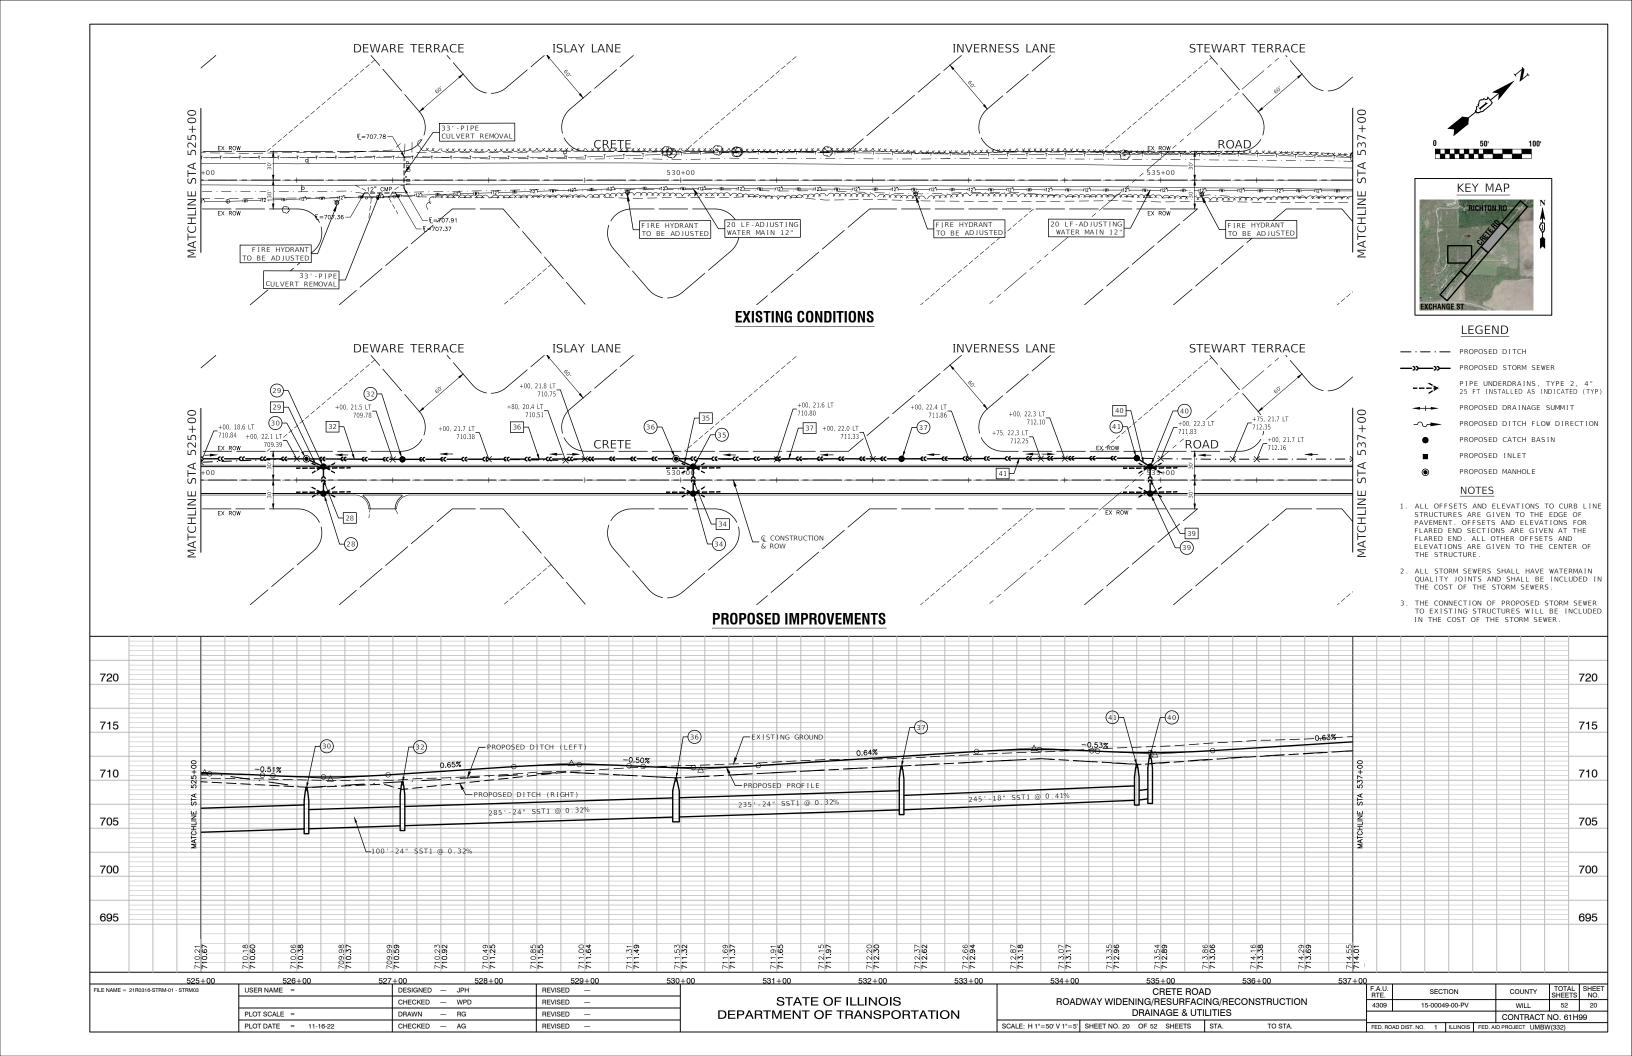

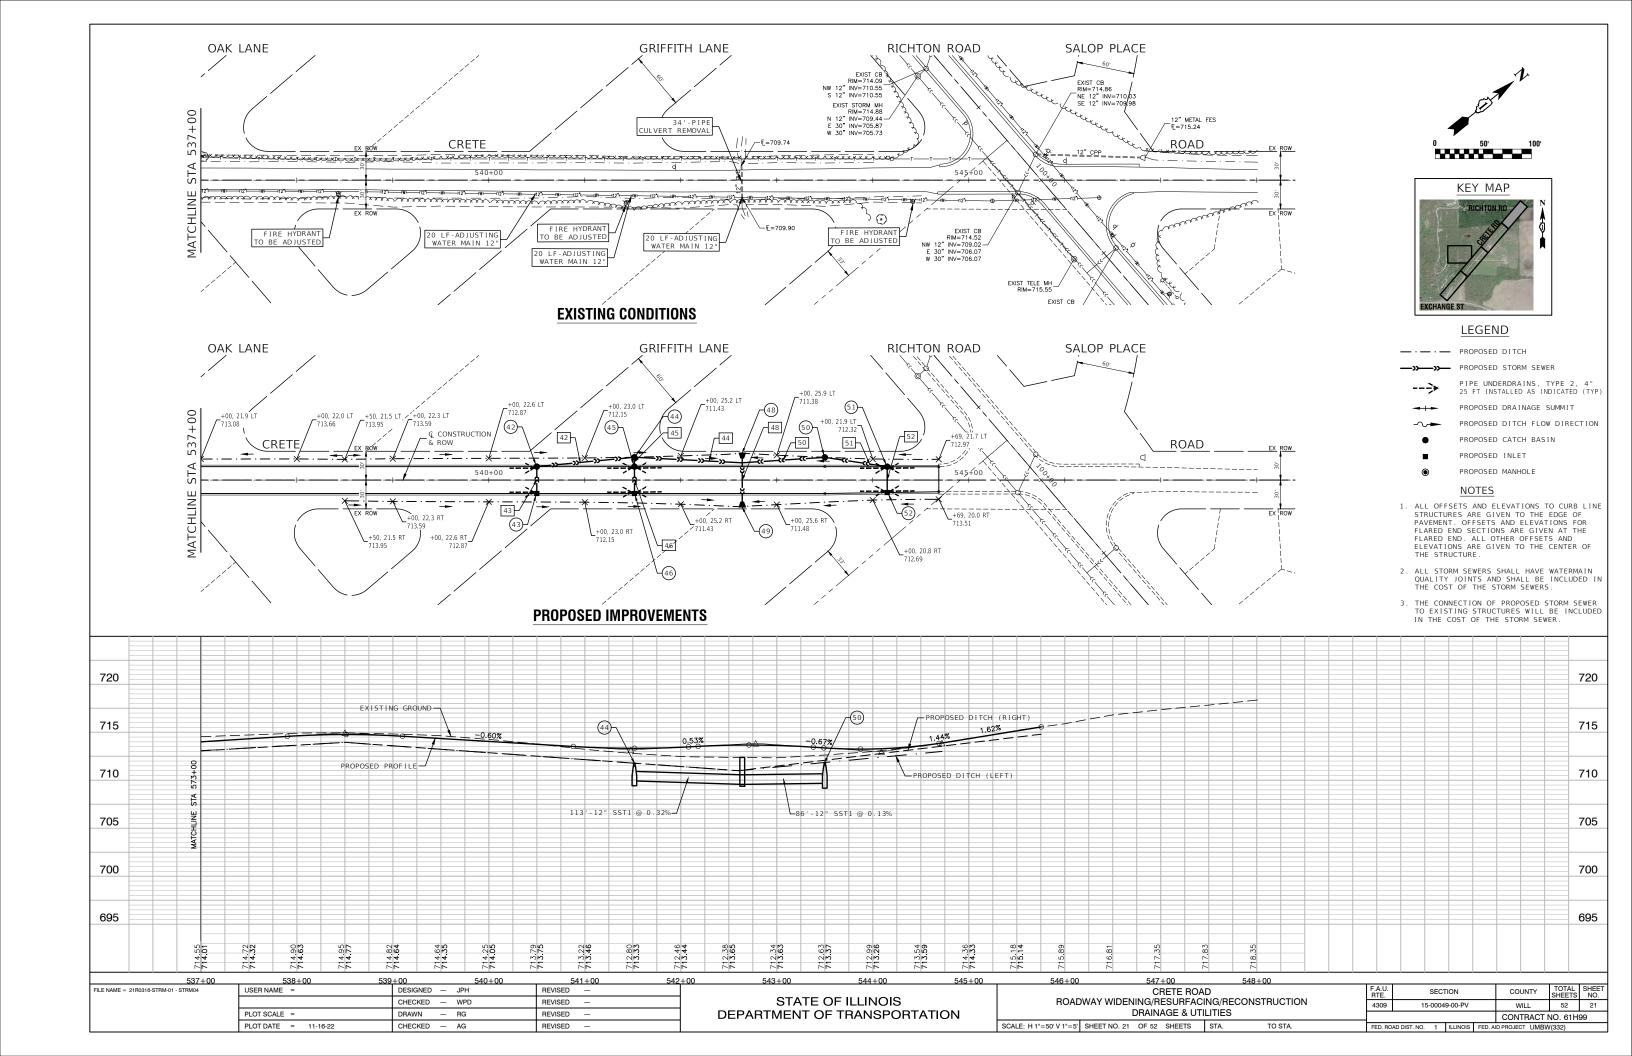

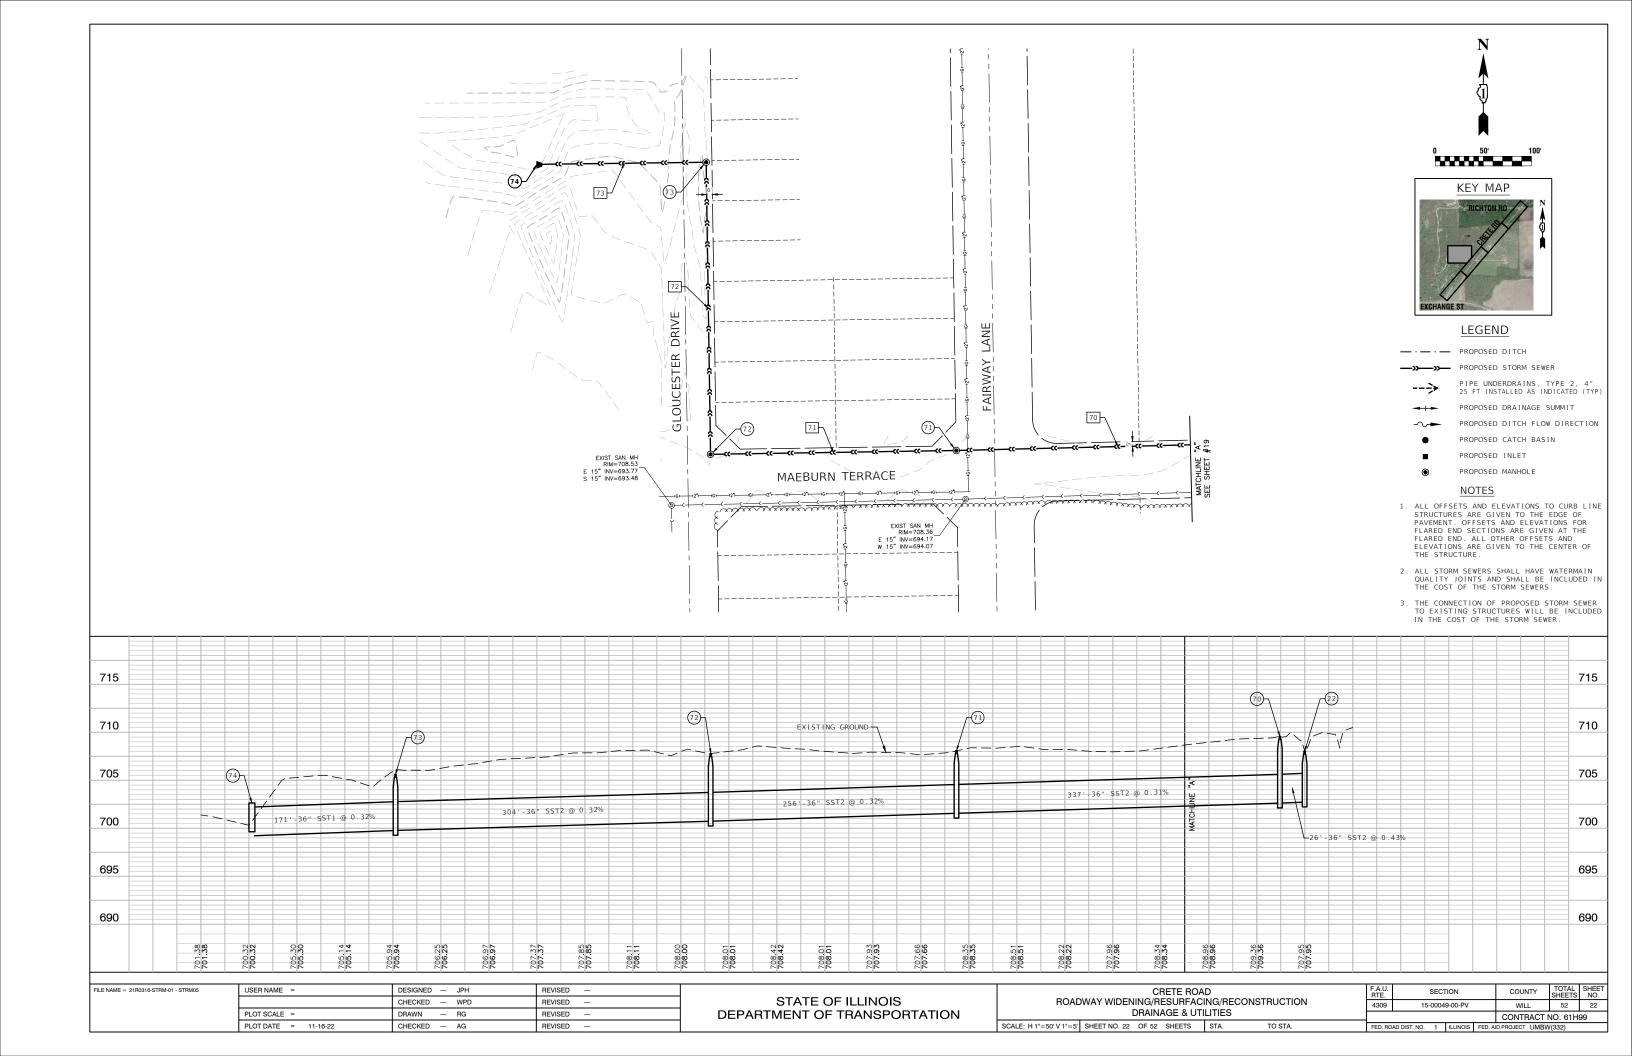

STA=501+14.00, 14.45' RT CB TYP C T11G RIM EL=705.09 12" SE INV=702.59 12" N INV=702.59 (1A) STA=500+99.92, 27.28' RT 12" FES 12" NW INV=702.40 STA=501+24.00, 14.00' RT INLET TYP A T11G RIM EL=705.19 12" S INV=702.69 STA=501+76.45, 30.80' LT CB TYP A 5' T11G RIM EL=705.97 EX 15" S INV=702.69 PR 12" NE INV=703.07 EX 15" N INV=703.03 (4) STA=501+81.23, 24.50' LT INLET TYP A T11G RIM EL=706.15 12" SW INV=703.15 (5) STA=502+54.78, 14.00' RT INLET TYP A T11G RIM EL=708.16 12" W INV=704.16 (6) STA=502+54.78, 14.00' LT CB TYP C T11G RIM EL=708.16 12" W INV=703.88 12" E INV=703.88 STA=504+11.83, 14.00' RT INLET TYP A T11G RIM EL=711.67 12" NW INV=709.10 (8) STA=504+11.83, 14.00' LT CB TYP C T11G RIM EL=711.67 12" NW INV=708.82 12" SE INV=708.82 (9) STA=509+00.00, 23.00' LT INLET TYP A T8G RIM EL=710.73 12" NE INV=708.23 (10) STA=509+50.32, 14.00' LT CB TYP C T11G RIM EL=711.63 12" NE INV=707.72 12" SW INV=707.72 (12)

STA=509+50.32, 14.00' RT CB TYP C T11G RIM EL=711.63 12" N INV=707.81

(13) STA=509+65.32, 7.00' LT MH TYP A 5' T1FCL 15" NE INV=707.55 12" SW INV=707.55 12" S INV=707.55

(14) STA=511+00.00, 24.80' LT CB TA 5' T8G RIM EL=710.37 15" NE INV=707.11 15" SW INV=707.11

FILE NAME = 21R0316-STRM-01 - TABLES

(15) STA=512+99.97, 14.00' RT CB TYP C T11G RIM EL=711.19 12" NW INV=706.96

(16) STA=513+00.00, 14.00' LT CB TYP C T11G RIM EL=711.19 12" NW INV=706.68 12" SE INV=706.68

(17) STA=513+00.00, 24.28' LT CB TYP A 5' T8G RIM EL=709.75 18" NE INV=706.48 15" SW INV=706.48 12" SE INV=706.58

(18) STA=516+20.00, 22.60' LT CB TYP A 5' T8G RIM EL=709.80 24" NE INV=705.46 18" SW INV=705.46

(20) STA=519+37.22, 14.00' RT CB TYP C T11G RIM EL=709.10 15" NW INV=705.10

(21) STA=519+37.22, 14.00' LT CB TYP A 4' T11G RIM EL=709.10 18" NW INV=704.82 15" SE INV=704.82

22 STA=519+40.00, 23.07' LT MH TYP A 8' T8G RIM EL=708.04 36" NW INV=702.73 24" SW INV=704.43 18" SE INV=704.73 36" NE INV=702.80

(24) STA=522+33.01, 14.00' RT CB TYP A 4' T11G RIM FI = 709.10 12" NW INV=704.66

(25) STA=522+33.01, 14.00' LT CB TYP A 4' T11G 12" NW INV=704.38

12" SE INV=704.38 (26) STA=522+35.00, 22.43' LT MH TYP A 7' T8G RIM FI = 708.25

36" SW INV=703.7 30" NE INV=703.74 12" SE INV=704.29

(28) STA=526+27.69, 14.00' RT CB TYP C T11G RIM FI = 710.06 12" NW INV=705.60

29) STA=526+27.69, 14.00' LT CB TYP C T11G RIM EL=710.06 12" SW INV=705.32 12" SE INV=705.32

(30) STA=526+10.00, 22.08' LT MH TYP A 7' T8G RIM EL=709.25 30" SW INV=704.94 24" NF INV=704 94 12" NE INV=705.13

(32) STA=527+10.00, 21.57' LT CB TYP A 5' T8G RIM EL=709.84 24" SW INV=705.26 24" NE INV=705.26

(34) STA=530+12.91, 14.00' RT CB TYP C T11G RIM EL=711.03 12" NW INV=706.80

(35) STA=530+12.91, 14.00' LT CB TYP C T11G RIM EL=711.03 12" SW INV=706.52 12" SE INV=706.52

(36) STA=529+95.00, 22.21' LT MH TYP A 6' T8G RIM EL=710.25 24" SW INV=706.17 24" NE INV=706.17 12" NE INV=706.32

(37) STA=532+30.00, 22.12' LT CB TYP A 5' T8G RIM EL=711.48 24" SW INV=706.92 18" NE INV=706.92

(39) STA=534+88.96, 14.00' RT CB TYP C T11G RIM EL=712.60 12" NW INV=708.37

(40) STA=534+88.96, 14.00' LT CB TYP C T11G RIM EL=712.60 12" W INV=708.09 12" SE INV=708.09

STA=534+75.00, 22.83' LT CB TYP A 4' T11G RIM FI = 711.65 18" SW INV=707.92 12" F INV=707.92

(42) STA=540+50.00, 14.00' LT CB TYP A 4' T11G RIM EL=713.47 12" NE INV=710.26 12" SE INV=710.26

(43) STA=540+50.00, 14.00' RT INLET TYP A TIIG RIM EL=713.47 12" NW INV=710.47

(44) STA=541+51.61, 23.77' LT CB TYP A 5' T8G RIM EL=711.78 12" NE INV=709.93 12" SW INV=709.93 12" SE INV=709.93

(45) STA=541+51.71, 14.00' LT CB TYP C T11G RIM EL=713.05 12" NW INV=709 96 12" SE INV=709.96

(46) STA=541+51.71, 14.00' RT INLET TYP A T11G RIM EL=713.05 12" NW INV=710.05

(48) STA=542+64.00, 28.25' LT 3'x2' PCC BOX CULVERT END SECTION 36" ₹ EL=709.59

(49) STA=542+64.00, 28.25' RT 3'x2' PCC BOX CULVERT END SECTION 36" ₹ EL=709.35

(50) STA=543+50.00, 23.67' LT CB TYP C T8G RIM EL=711.85

12" SW INV=709.68 12" NE INV=709.68 (51)

STA=544+15.02, 13.92' LT CB TYP A 4' T11G RIM EL=713.03 12" SW INV=709 76 12" SE INV=709.76

(52) STA=544+14.98, 12.99' RT INLET TYP A T11G RIM EL=713.03 12" NW INV=710.03

(70) STA=519+45.70, 48.13' LT MH TYP A 6' T1FCL RIM EL=709.58 36" W INV=702.62 36" SE INV=702.62

(71) STA=517+25.84, 303.49' LT MH TYP A 6' T1FCL RIM EL=708.09 " W INV=701.56 36" E INV=701.56

STA=515+60.41, 498.94' LT MH TYP A 6' T1FCL RIM EL=707.79 36" N INV=700.74 36" E INV=700.74

(73) STA=517+92.79, 695.38' LT MH TYP A 6' T1FCL RIM EL=705.62 36" W INV=699.77 36" S INV=699.77

(74)STA=516+78.84, 830.29' LT 36" FES 36" E INV=699.22

1 19'-12" RCCP, T1 @ 1.00% (0.1)

2

113'-12" RCCP, T1 @ 0.32% (15.0) 10'-12" RCCP. T1 @ 0.31% (3.0)

45 10'-12" RCCP, T1 @ 1.00% (0.1) 46 8'-12" RCCP, T1 @ 1.00% (0.5) 28'-12" RCCP, T1 @ 0.32% (3.0)

44

4 5 48 28'-12" RCCP, T1 @ 1.00% (5.2) 57'-3'x2' PCC BOX CULVERT @ 0.42% (4.2)

6 15'-12" RCCP, T1 @ 1.00% (3.0) 86'-12" RCCP, T1 @ 0.13% (15.0)

50 7 28'-12" RCCP, T1 @ 1.00% (1.0) 51 66'-12" RCCP, T1 @ 0.12% (10.0)

8 15'-12" RCCP, T1 @ 0.98% (0.8) 52 27'-12" RCCP, T1 @ 1.00% (1.3)

9 70 51'-12" RCCP, T1 @ 1.00% (4.5) 337'-36" RCCP, T2 @ 0.31%

17'-12" RCCP, T1 @ 1.03% (3.0) 256'-36" RCCP, T2 @ 0.32%

12 72 304'-36" RCCP, T2 @ 0.32% 26'-12" RCCP, T1 @ 1.01% (8.6) 13 73 136'-15" RCCP. T1 @ 0.32% (18.3) 171'-36" RCCP, T2 @ 0.32%

14 200'-15" RCCP. T1 @ 0.32% (27.0)

15 28'-12" RCCP, T1 @ 1.00% (5.9)

16 10'-12" RCCP, T1 @ 0.97% (1.5)

17 320'-18" RCCP, T1 @ 0.32% (40.8)

320'-24" RCCP, T1 @ 0.32% (34.9)

28'-15" RCCP, T1 @ 1.00% (5.0)

21 9'-18" RCCP, T1 @ 0.95% (1.1)

22 26'-36" RCCP, T2 @ 0.43% (14.2)

24 28'-12" RCCP, T1 @ 1.00% (6.5)

25 9'-12" RCCP, T1 @ 1.04% (1.9)

26 295'-36" RCCP, T2 @ 0.32% (41.1)

28'-12" RCCP, T1 @ 1.00% (6.5)

29 19'-12" RCCP, T1 @ 0.98% (4.1)

30 375'-30" RCCP, T1 @ 0.32% (45.9)

32 100'-24" RCCP, T1 @ 0.32% (17.9)

28'-12" RCCP, T1 @ 1.00% (5.9)

20'-12" RCCP, T1 @ 1.02% (3.9)

36 285'-24" RCCP. T1 @ 0.32% (46.1)

37 235'-24" RCCP, T1 @ 0.32% (37.6)

28'-12" RCCP, T1 @ 1.00% (5.9)


40 17'-12" RCCP, T1 @ 1.03% (3.1)


41 245'-18" RCCP, T1 @ 0.41% (41.8)

42 102'-12" RCCP, T1 @ 0.32% (14.0)

43 28'-12" RCCP, T1 @ 0.75% (3.0)

USER NAME = DESIGNED - JPH REVISED CRETE ROAD SECTION COUNTY STATE OF ILLINOIS ROADWAY WIDENING/RESURFACING/RECONSTRUCTION CHECKED — WPD REVISED 4309 15-00049-00-PV WILL 52 23 PLOT SCALE = REVISED DEPARTMENT OF TRANSPORTATION STORM SEWER STRUCTURE AND PIPE SCHEDULES CONTRACT NO. 61H99 SCALE: H 1"=50' V 1"=5' SHEET NO. 23 OF 52 SHEETS STA. PLOT DATE = 11-16-22 CHECKED - AG REVISED

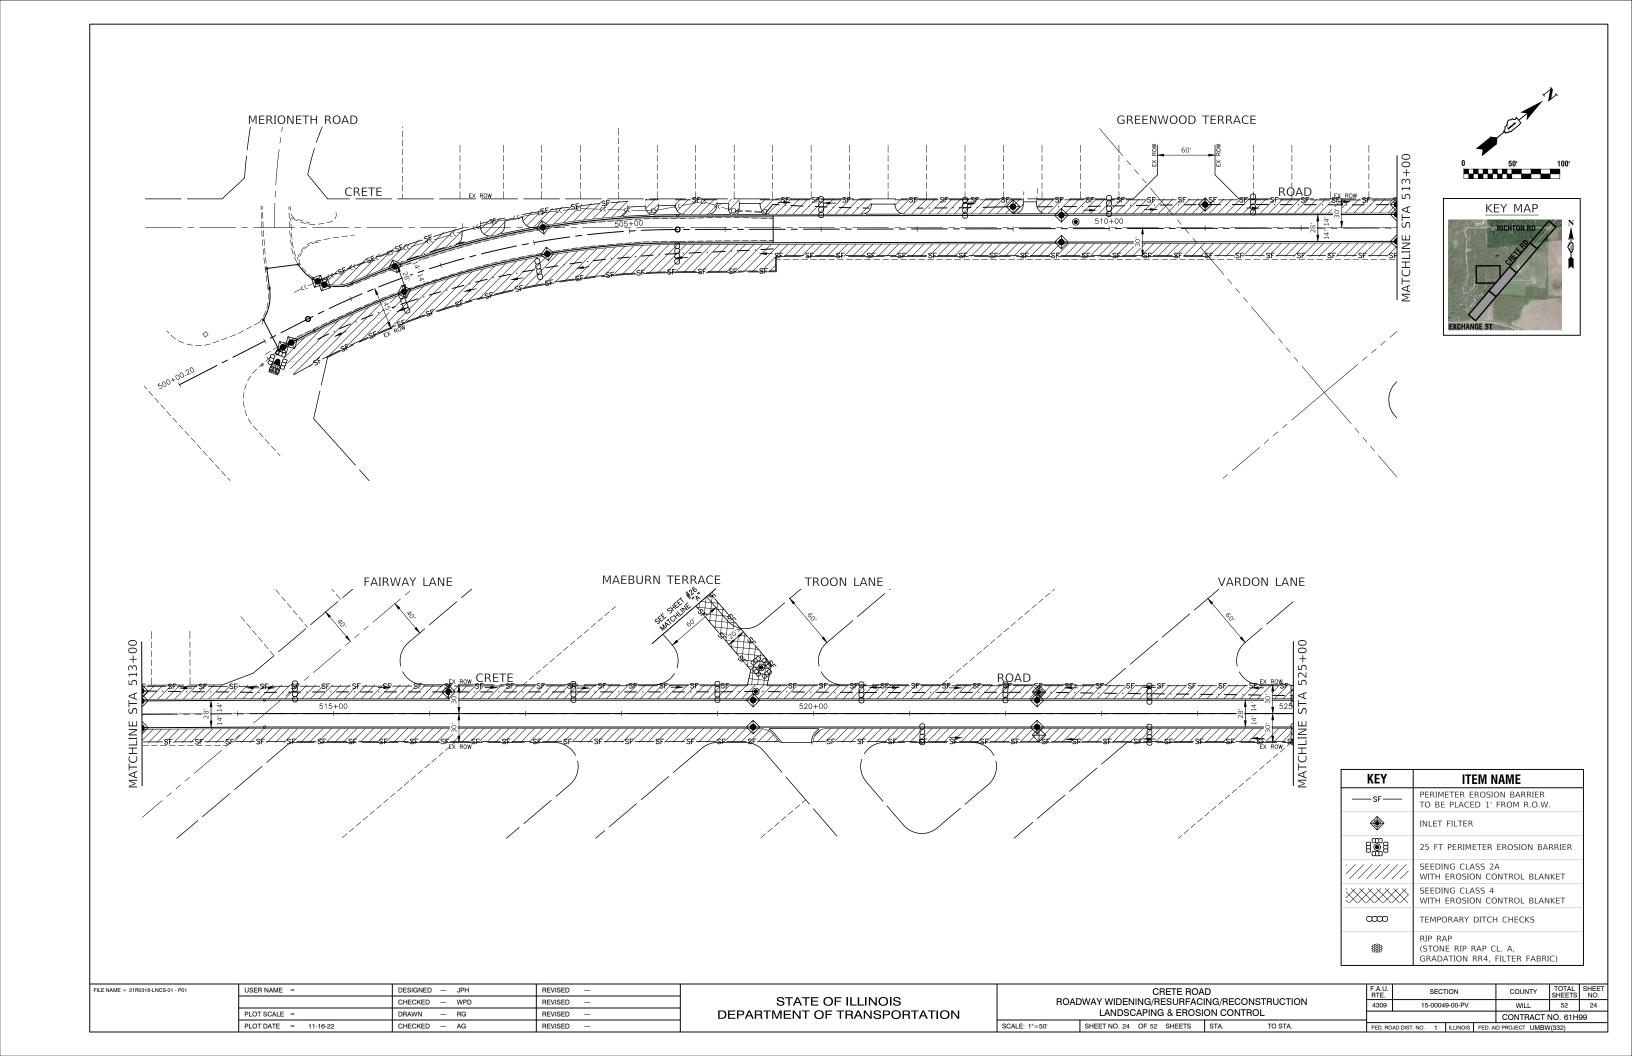

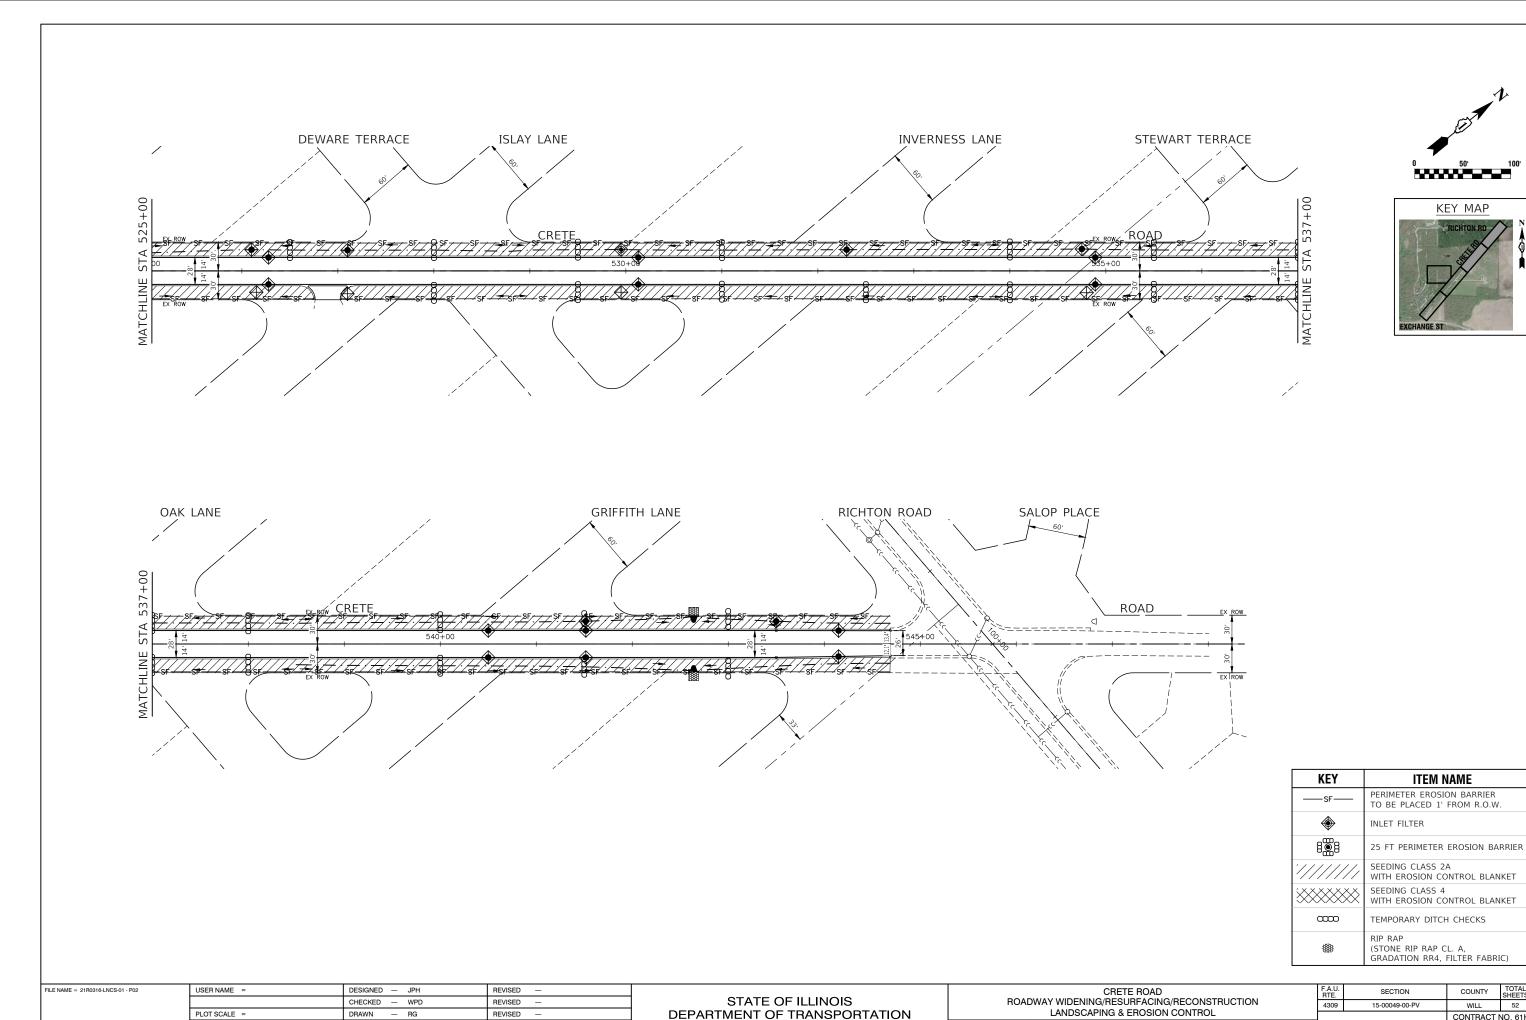

SCALE: 1"=50'

SHEET NO. 25 OF 52 SHEETS STA.


PLOT DATE = 11-16-22


REVISED


CHECKED - AG


COUNTY TOTAL SHEET NO.
WILL 52 25

CONTRACT NO. 61H99

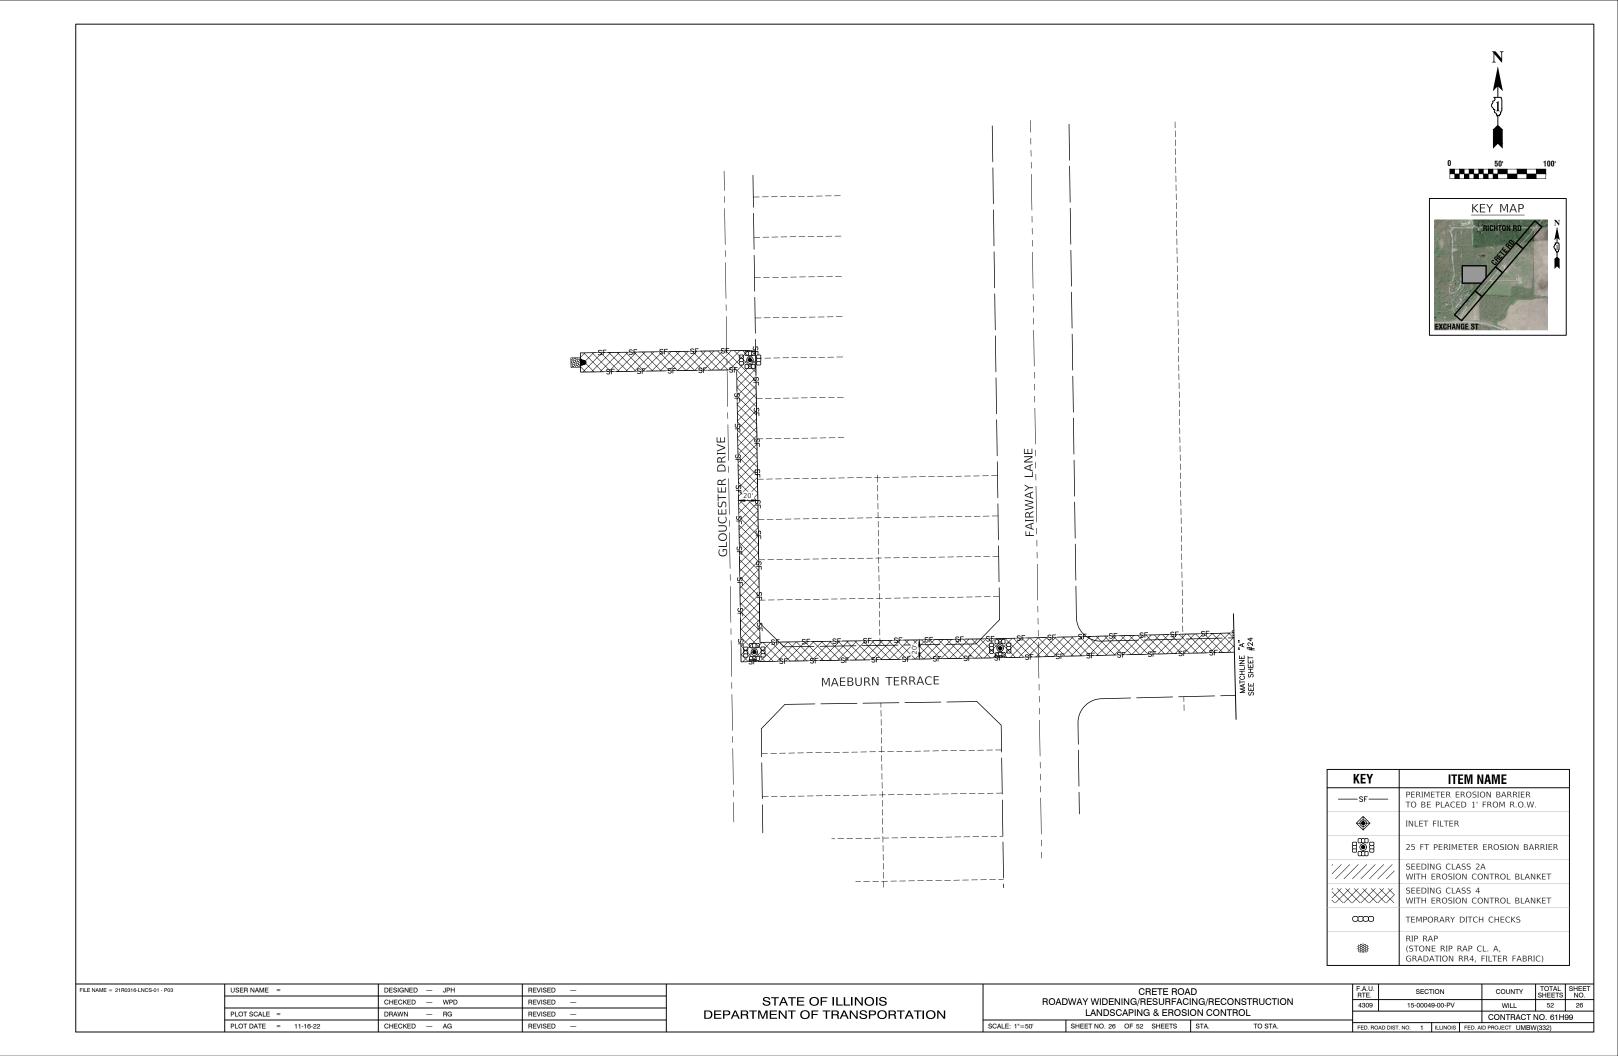


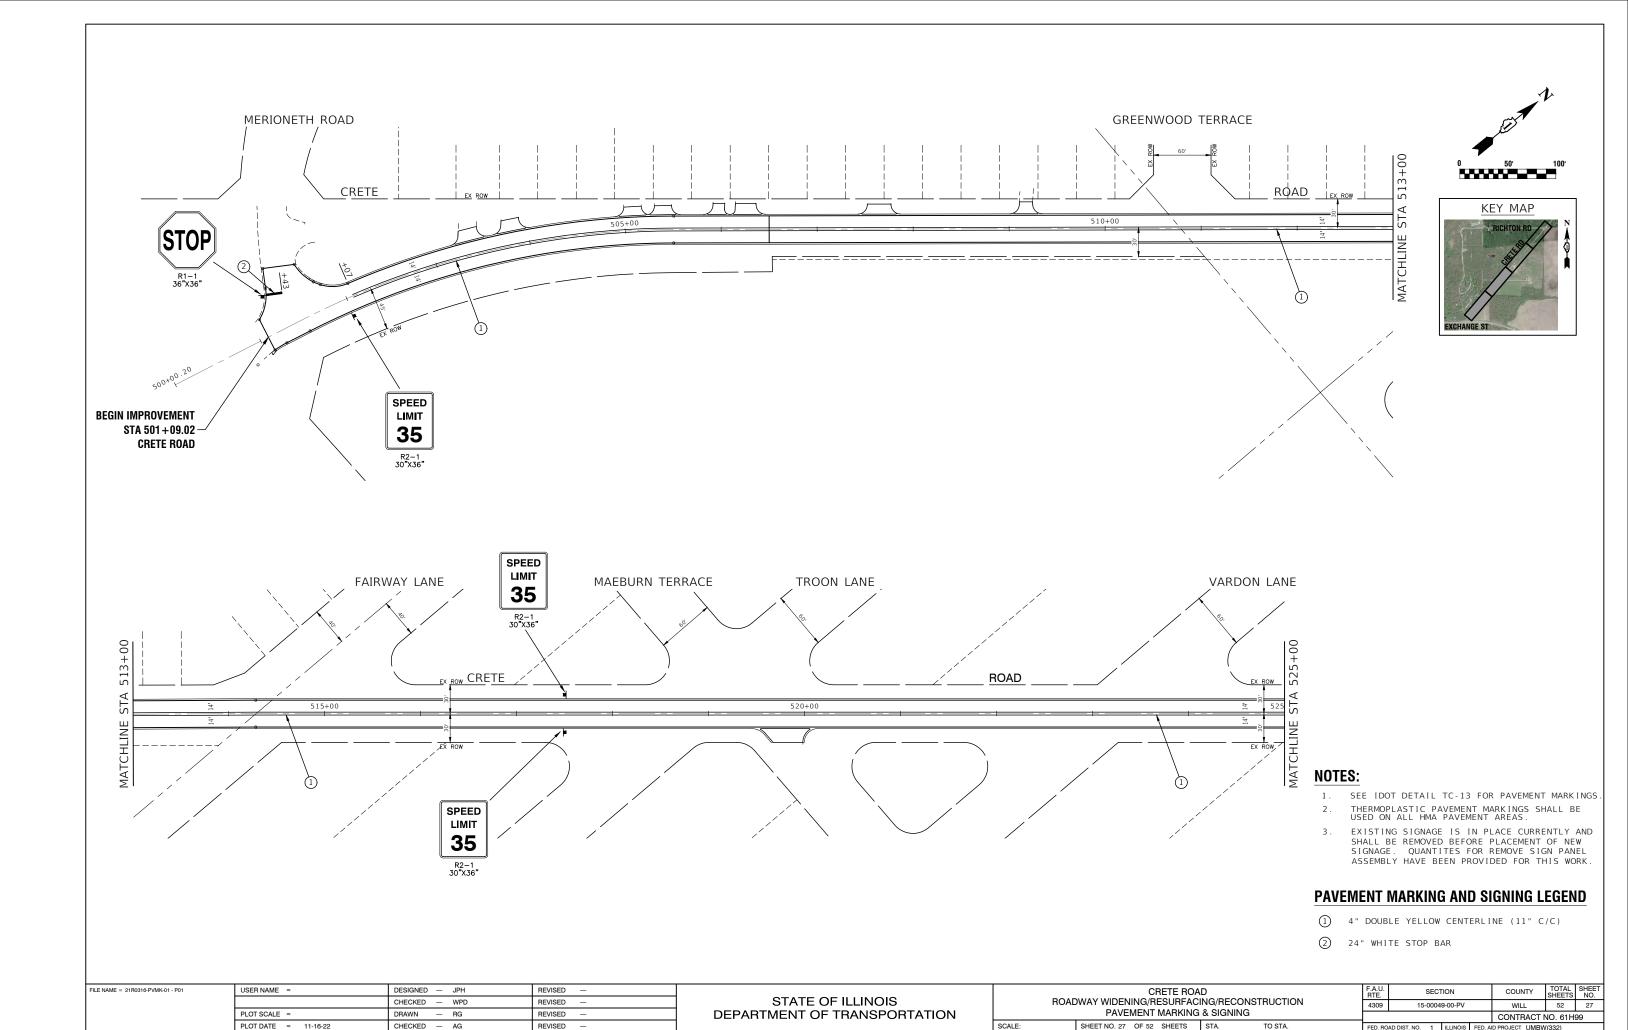

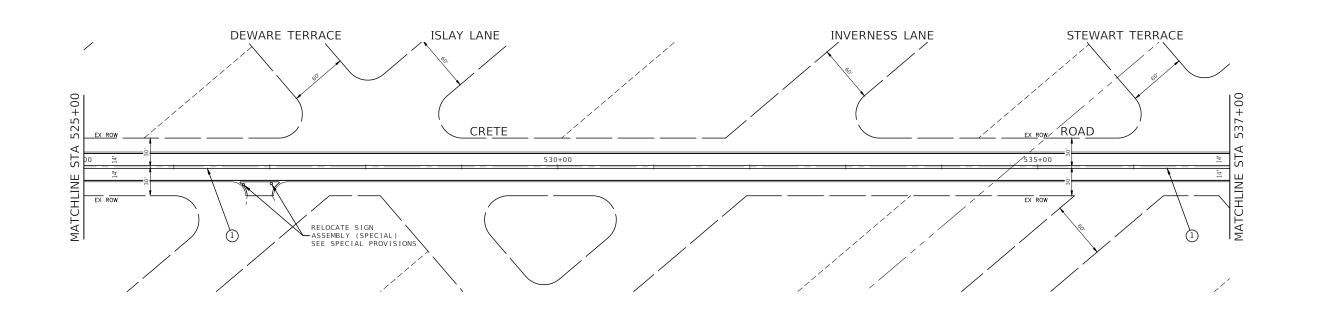

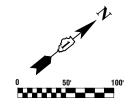



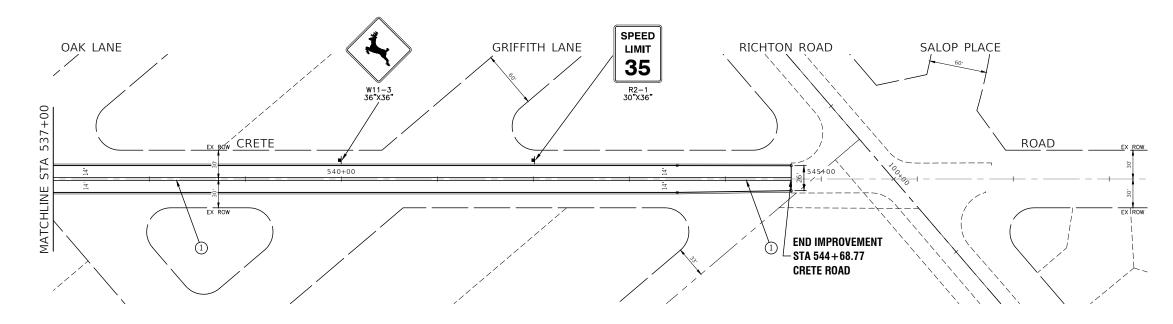


NOTES:


- . SEE IDOT DETAIL TC-13 FOR PAVEMENT MARKINGS.
- 2. THERMOPLASTIC PAVEMENT MARKINGS SHALL BE USED ON ALL HMA PAVEMENT AREAS.
- 3. EXISTING SIGNAGE IS IN PLACE CURRENTLY AND SHALL BE REMOVED BEFORE PLACEMENT OF NEW SIGNAGE. QUANTITES FOR REMOVE SIGN PANEL ASSEMBLY HAVE BEEN PROVIDED FOR THIS WORK.

PAVEMENT MARKING AND SIGNING LEGEND

- 1 4" DOUBLE YELLOW CENTERLINE (11" C/C)
- 2 24" WHITE STOP BAR

FILE NAME = 21R0316-PVMK-01 - P02	USER NAME =	DESIGNED — JPH	REVISED —			F.A.U.	SECTION	ı co	INTY SHEE	L SHEET			
		CHECKED — WPD	REVISED —	STATE OF ILLINOIS	ROADWAY WIDENING/RESURFACING/RECONSTRUCTION PAVEMENT MARKING & SIGNING			4309	15-00049-00-)-PV V	ILL 52	28	
	PLOT SCALE =	DRAWN — RG	REVISED —	DEPARTMENT OF TRANSPORTATION						CON	RACT NO. 61	1H99	
	PLOT DATE = 11-16-22	CHECKED — AG	REVISED —		SCALE: SHEET NO. 28 OF 52 SHEETS STA. TO STA.		SCALE: SHEET NO. 28 OF 52 SHEETS STA. TO STA.		FED. ROAD DI	IST. NO. 1 ILLIN	NOIS FED. AID PROJE	T UMBW(332)	$\neg \neg$

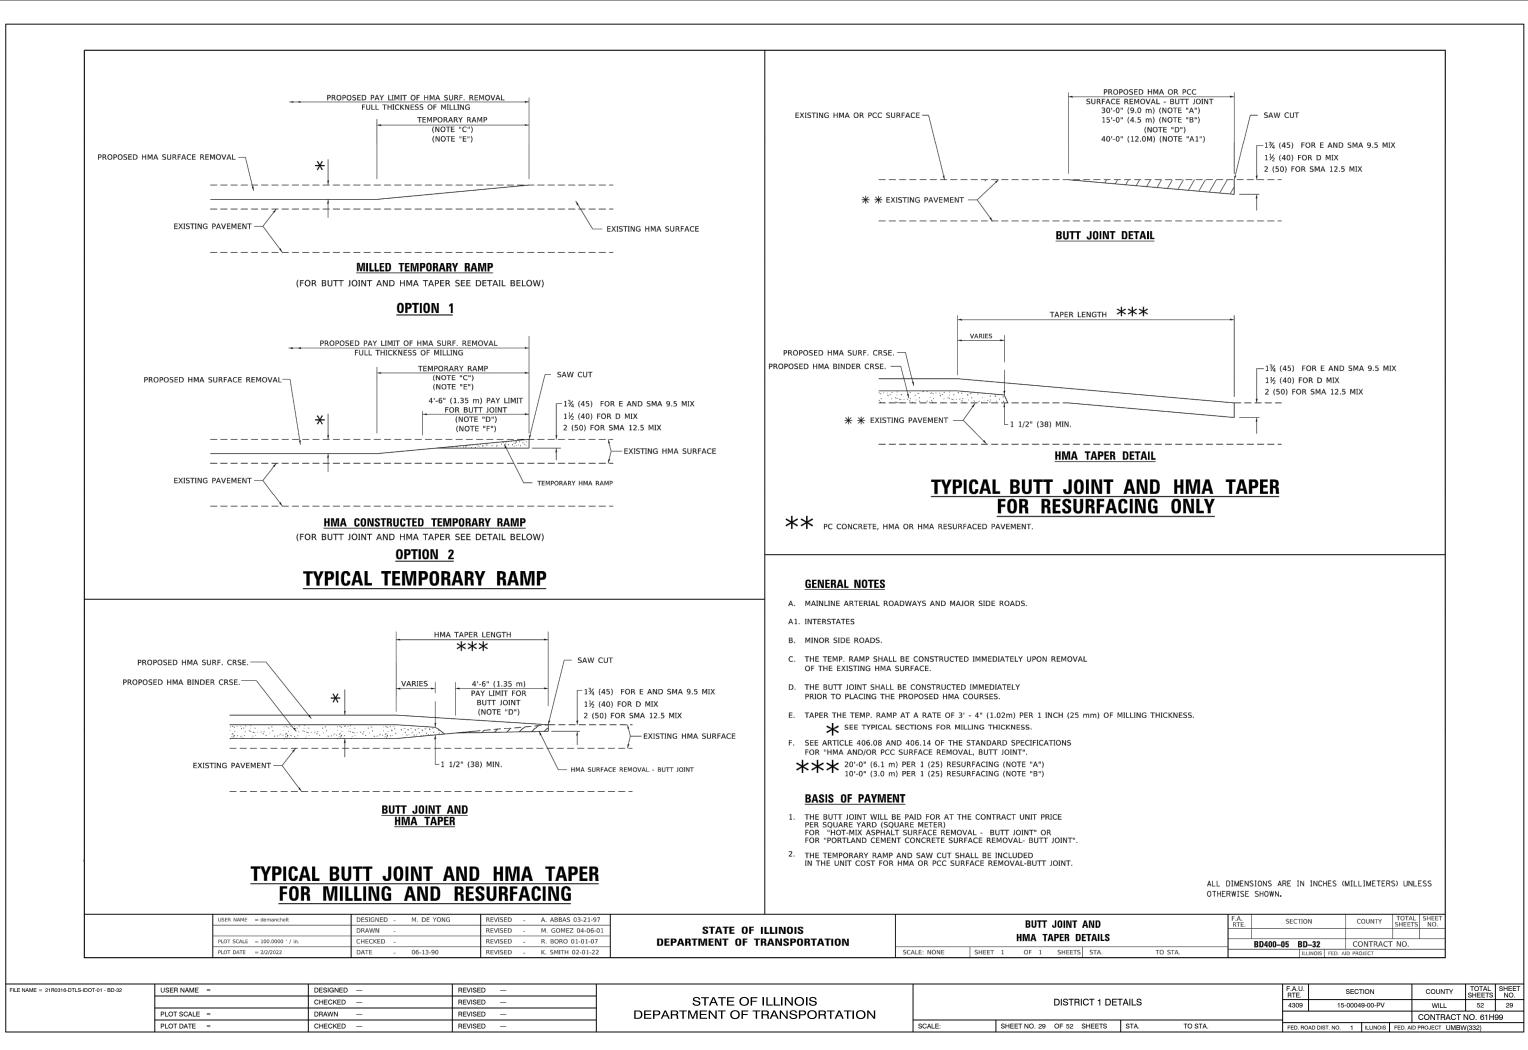

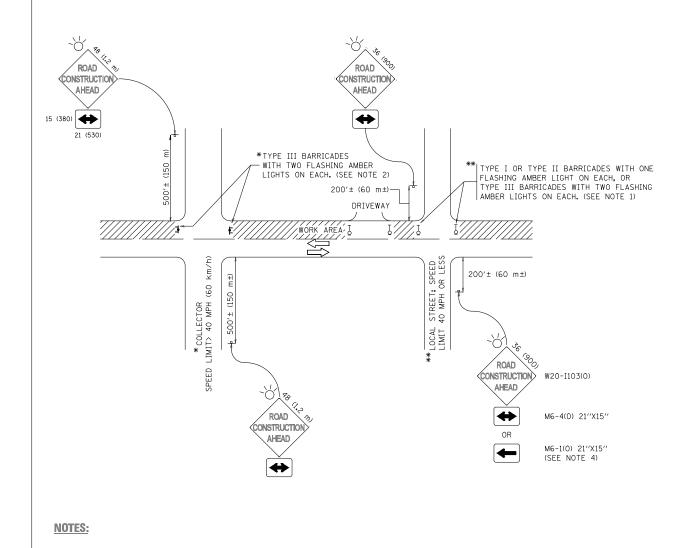

- 1. SIDE ROAD WITH A SPEED LIMIT OF 40 MPH (60 km/h) OR LESS AS SHOWN ON THE DRAWING AND AS DIRECTED BY THE ENGINEER:
 - a) ONE "ROAD CONSTRUCTION AHEAD" SIGN 36 x 36 (900x900) WITH A FLASHER MOUNTED ON IT APPROXIMATELY 200' (60 m) IN ADVANCE OF THE MAIN ROUTE.
 - b) THE CLOSED PORTION OF THE MAIN ROUTE SHALL BE PROTECTED BY BLOCKING WITH TYPE I, TYPE II OR TYPE III BARRICADES, 1/3 OF THE CROSS SECTION OF THE CLOSED PORTION.
- 2. SIDE ROAD WITH A SPEED LIMIT GREATER THAN 40 MPH (60 km/h) AS SHOWN ON THE DRAWING AND AS DIRECTED BY THE ENGINEER:
 - a) ONE "ROAD CONSTRUCTION AHEAD" SIGN 48 x 48 (1.2 m x 1.2 m) WITH A FLASHER MOUNTED ON IT APPROXIMATELY 500" (150 m) IN ADVANCE OF THE MAIN ROUTE.
 - b) THE CLOSED PORTION OF THE MAIN ROUTE SHALL BE PROTECTED BY BLOCKING WITH TYPE III BARRICADES, 1/2 OF THE CROSS SECTION OF THE CLOSED PORTION.
- 3. CONES MAY BE SUBSTITUTED FOR BARRICADES OR DRUMS AT HALF THE SPACING DURING DAY OPERATIONS. CONES SHALL BE A MINIMUM OF 28 (710) IN HFIGHT.
- 4. WHEN THE SIDE ROAD LIES BETWEEN THE BEGINNING OF THE MAINLINE SIGNING AND THE WORK ZONE, A SINGLE HEADED ARROW (MG-1) SHALL BE USED IN LIEU OF THE DOUBLE HEADED ARROW (MG-4).

- 5. WHEN WORK IS BEING PERFORMED ON A SIDE ROAD OR DRIVEWAY, FOLLOW THE APPLICABLE STANDARD(S). THE DIRECTIONAL ARROW (M6-1 OR M6-4) SHALL BE COVERED OR REMOVED WHEN NO LONGER CONSISTENT WITH THE TRAFFIC CONTROL SET-UP.
- 6. ADVANCE WARNING SIGNS ARE TO BE OMITTED ON DRIVEWAYS UNLESS OTHERWISE SPECIFIED IN THE PLANS OR BY THE ENGINEER.
- 7. THE TRAFFIC CONTROL AND PROTECTION FOR SIDE ROADS, INTERSECTIONS, AND DRIVEWAYS SHALL BE INCLUDED IN THE COST OF SPECIFIED TRAFFIC CONTROL STANDARDS OR ITEMS.

All dimensions are in inches (millimeters) unless otherwise shown.

FILE NAME =	USER NAME = footemj	DESIGNED - L.H.A.	REVISED - A. HOUSEH 10-15-96			TRAFFIC CONTROL AND PROTECTION FOR	F.A. SECTION	COUNTY TOTAL SHEET
pw:\\ILØ84EBIDINTEG.ıllınoıs.gov:PWIDOT\Do	6.11linois.gov:PWIDOT\Documents\IDOT Offices\District 1\Projects\Dist talkawww\CADDeta\CADsheets\tc10.dgn		REVISED -T. RAMMACHER 01-06-00	STATE OF ILLINOIS			10124	511213 1101
	PLOT SCALE = 50.000 ' / in.	CHECKED -	REVISED - A. SCHUETZE 07-01-13	DEPARTMENT OF TRANSPORTATION	2	IDE ROADS, INTERSECTIONS, AND DRIVEWAYS	TC-10	CONTRACT NO.
Default	PLOT DATE = 9/15/2016	DATE - 06-89	REVISED - A. SCHUETZE 09-15-16		SCALE: NONE	SHEET 1 OF 1 SHEETS STA. TO STA.	ILLINOIS FED.	AID PROJECT

FILE NAME = 21R0316-DTLS-IDOT-01 - TC-10	USER NAME =	DESIGNED —	REVISED —						F.A.U. RTE.	SECTION	COUNTY	TOTAL SHEETS	SHEET NO.
		CHECKED —	REVISED —	STATE OF ILLINOIS	DISTRICT 1 DETAILS			4309	15-00049-00-PV	WILL	52	30	
	PLOT SCALE =	DRAWN —	REVISED —	DEPARTMENT OF TRANSPORTATION						CONTRACT I	NO 61H	19	
	PLOT DATE =	CHECKED —	REVISED —		SCALE:	SHEET NO. 30 OF 52 SHEETS	STA.	TO STA.	FED. ROAD		D PROJECT UMBW		

