01-20-2023 LETTING ITEM 108

STATE OF ILLINOIS DEPARTMENT OF TRANSPORTATION


SECTION COOK 22 20-00060-00-RS 2955 ILLINOIS CONTRACT NO. 61J23

FOR INDEX OF SHEETS, SEE SHEET NO. 2 FOR LISTING OF HIGHWAY STANDARDS, SEE SHEET NO. 2

PLANS FOR PROPOSED FEDERAL AID HIGHWAY

FAU ROUTE 2955 (OAK PARK AVENUE) RESURFACING SECTION NO. 20-00060-00-RS PROJECT NO. QLYX(575) **VILLAGE OF CHICAGO RIDGE COOK COUNTY**

107TH STREET TO SOUTHWEST HWY JOB NO. C-91-236-22

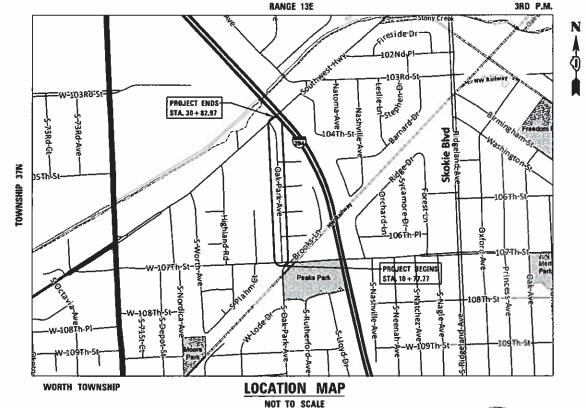


GROSS & NET LENGTH = 2005.4 FT. = 0.38 MILE



OAK PARK AVENUE FUNCTIONAL CLASSIFICATION MINOR COLLECTOR 20 M.P.H.

TRAFFIC DATA ADT (YEAR) = 1000 (2018)

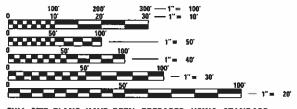

FULL SIZE PLANS HAVE BEEN PREPARED USING STANDARD ENGINEERING SCALES. REDUCED SIZED PLANS WILL NOT CONFORM TO STANDARD SCALES. IN MAKING MEASUREMENTS ON REDUCED PLANS, THE ABOVE SCALES MAY BE USED,


JOINT UTILITY LOCATION INFORMATION FOR EXCAVATION 1-800-892-0123 OR 811



PROFESSIONAL DESIGN FIRM NO.: 184-00175 EXPIRATION DATE: APRIL 30, 2023

CONTRACT NO. 61J23



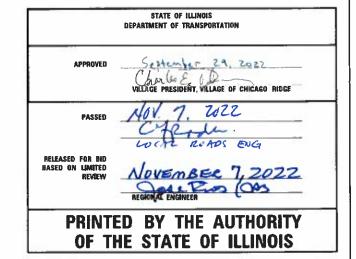

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HIGHWAY STANDARDS SHEET NO. DESCRIPTION 000001-08 - STANDARD SYMBOLS, ABBREVIATIONS, AND PATTERNS TITLE SHEET 1 424001-11 - PERPENDICULAR CURB RAMPS FOR SIDEWALKS INDEX OF SHEETS, HIGHWAY STANDARDS, 2 442201-03 - CLASS C AND D PATCHES D1 STANDARDS, & COMMITMENTS 604001-05 - FRAMES AND LIDS TYPE 1 **GENERAL NOTES** 3 606001-08 - CONCRETE CURB TYPE B AND COMBINATION CONCRETE CURB **SUMMARY OF QUANTITIES** 4-7 AND GUTTER **TYPICAL SECTIONS** 701006-05 – OFF RD OPERATIONS, 2L, 2W, 15' (4.5 M) TO 24" (600 mm) ALIGNMENT, TIES AND BENCHMARKS 9-10 FROM PAVEMENT EDGE PROPOSED PLAN 11-12 701301-04 - LANE CLOSURE, 2L, 2W, SHORT TIME OPERATIONS **CONSTRUCTION DETAILS** 13 701311-03 - LANE CLOSURE 2L, 2W MOVING OPERATIONS-DAY ONLY **DETAILS FOR FRAMES AND LIDS** 701501-06 - URBAN LANE CLOSURE, 2L, 2W, UNDIVIDED 14 ADJUSTMENT WITH MILLING (BD-8) 701701-10 - URBAN LANE CLOSURE, MULTILANE INTERSECTION PAVEMENT PATCHING FOR HMA 15 701801-06 - SIDEWALK, CORNER OR CROSSWALK CLOSURE SURFACED PAVEMENT (BD-22) 701901-08 - TRAFFIC CONTROL DEVICES CURB OR CURB AND GUTTER REMOVAL 16 780001-05 - TYPICAL PAVEMENT MARKINGS AND REPLACEMENT (BD-24) BUTT JOINT AND HMA TAPER DETAILS (BD-32) 17 **DISTRICT 1 STANDARD DETAILS** TRAFFIC CONTROL AND PROTECTION FOR SIDE 18 ROADS, INTERSECTIONS, AND DRIVEWAYS (TC-10) BD-8 – DETAILS FOR FRAMES AND LIDS ADJUSTMENT WITH MILLING DISTRICT ONE TYPICAL PAVEMENT 19 BD-22 - PAVEMENT PATCHING FOR HMA SURFACED PAVEMENT MARKINGS (TC-13) BD-24 - CURB OR CURB AND GUTTER REMOVAL AND REPLACEMENT ARTERIAL ROAD INFORMATION SIGN (TC-22) 20 BD-32 – BUTT JOINT AND HMA TAPER DETAILS DISTRICT 1 – DETECTOR LOOP INSTALLATION 21 TC-10 - TRAFFIC CONTROL AND PROTECTION FOR SIDE ROADS, **DETAILS FOR ROADWAY RESURFACING (TS-07)** INTERSECTIONS, AND DRIVEWAYS **EXISTING TRAFFIC SIGNAL PLAN** 22 TC-13 – DISTRICT ONE TYPICAL PAVEMENT MARKINGS (FOR REFERENCE ONLY) TC-22 – ARTERIAL ROAD INFORMATION SIGN TS-07 - DISTRICT 1 - DETECTOR LOOP INSTALLATION DETAILS FOR ROADWAY

COMMITMENTS

RESURFACING

NONE

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INDEX OF SHEETS

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		ILLINOIS FED. A	ID PROJECT		
19			CONTRAC	T NO. (61J23
TS	2955	20-00060-00-RS	COOK	22	2
	F.A.U. RTE.	SECTION	COUNTY	TOTAL SHEETS	SHEET NO.

GENERAL NOTES

SPECIFICATIONS, STANDARDS AND SPECIAL PROVISIONS

- 1. ALL CONSTRUCTION SHALL BE DONE IN ACCORDANCE WITH THE "STANDARD SPECIFICATIONS FOR ROAD AND BRIDGE CONSTRUCTION", ADOPTED JANUARY 1, 2022; THE "SUPPLEMENTAL SPECIFICATIONS AND RECURRING SPECIAL PROVISIONS", ADOPTED JANUARY 1, 2023; REVISION 3, NOVEMBER 2021 OF THE "ILLINOIS MANUAL ON UNIFORM TRAFFIC CONTROL DEVICES FOR STREETS AND HIGHWAYS" (IMUTCD) AND "THE STANDARD SPECIFICATIONS FOR WATER AND SEWER MAIN CONSTRUCTION IN ILLINOIS" EIGTH EDITION; THE "DETAILS" IN THE PLANS; AND THE "SPECIAL PROVISIONS" INCLUDED IN THE CONTRACT DOCUMENTS.
- ANY REFERENCE TO STANDARDS THROUGHOUT THE PLANS OR SPECIAL PROVISIONS SHALL BE INTERPRETED AS THE LATEST IDOT STANDARD.
- ALL TRAFFIC CONTROL AND OTHER ADVISORY SIGNS NEEDED FOR CONSTRUCTION
 ARE TO BE FURNISHED BY THE CONTRACTOR IN ACCORDANCE WITH SECTION 700
 OF THE STANDARD SPECIFICATIONS.

UTILITIES

- 4. THE CONTRACTOR SHALL BE RESPONSIBLE FOR CONTACTING THE OWNERS OF ALL EXISTING FACILITIES SO THAT THE UTILITIES AND THEIR APPURTENANCES MAY BE LOCATED AND ADJUSTED OR MOVED, IF NECESSARY, PRIOR TO THE START OF CONSTRUCTION OPERATIONS. THE CONTRACTOR SHALL COOPERATE WITH ALL UTILITY OWNERS AS PROVIDED FOR IN THE STANDARD SPECIFICATIONS.
- 5. THE LOCATIONS OF EXISTING DRAINAGE STRUCTURES, STORM AND SANITARY SEWERS, WATER SERVICE LINES AND OTHER UTILITY LINES ARE APPROXIMATE, AND THE VILLAGE AND ENGINEER DO NOT GUARANTEE THEIR ACCURACY. THEIR EXACT HORIZONTAL AND VERTICAL LOCATIONS ARE TO BE DETERMINED IN THE FIELD BY THE CONTRACTOR.
- 6. THE CONTRACTOR SHALL BE RESPONSIBLE FOR THE PROTECTION OF ALL UNDERGROUND OR SURFACE UTILITIES EVEN THOUGH THEY MAY NOT BE SHOWN ON THE PLANS. ANY UTILITY THAT IS DAMAGED DURING CONSTRUCTION SHALL BE REPAIRED OR REPLACED TO THE SATISFACTION OF THE ENGINEER.
- 7. BEFORE STARTING ANY EXCAVATION, THE CONTRACTOR SHALL CALL "JULIE" AT 8-1-1 FOR FIELD LOCATIONS OF BURIED ELECTRIC, TELEPHONE, GAS AND CABLE TELEVISION FACILITIES (48 HOURS NOTIFICATIONS IS REQUIRED).
- 8. THE CONTRACTOR SHALL CONTACT IDOT'S BUREAU OF MATERIALS (PHONE 847-705-4337) AT LEAST 24 HOURS BEFORE PLACING HOT MIX ASPHALT OR PORTLAND CEMENT CONCRETE.

WATER, STORM SEWER AND SANITARY SEWER

- 9. THE CONTRACTOR SHALL NOT OPEN OR SHUT ANY WATER VALVES OR FIRE HYDRANTS. CONTACT THE VILLAGE OF CHICAGO RIDGE PUBLIC WORKS DEPARTMENT (TEL. NO. 708-857-4457) FOR THEM TO TURN VALVES OR OPERATE HYDRANTS. UNAUTHORIZED USE SHALL SUBJECT THE OFFENDER TO ARREST AND PROSECUTION.
- 10. WHENEVER DURING CONSTRUCTION OPERATIONS ANY LOOSE MATERIAL IS DEPOSITED IN THE FLOW LINE OF DRAINAGE STRUCTURES SUCH THAT THE NATURAL FLOW OF WATER IS OBSTRUCTED, IT SHALL BE REMOVED AT THE CLOSE OF EACH WORKING DAY. AT THE CONCLUSION OF CONSTRUCTION OPERATIONS, ALL UTILITY STRUCTURES SHALL BE FREE FROM DIRT AND DEBRIS. THE WORK SPECIFIED ABOVE SHALL BE COMPLETED PER ARTICLE 107.15 OF THE STANDARD SPECIFICATIONS.

- 11. ALL EXISTING OR PROPOSED STORM SEWER DAMAGED BY THE CONTRACTOR DURING CONSTRUCTION SHALL BE REPLACED BY THE CONTRACTOR.
- 12. WHEN EXISTING DRAINAGE FACILITIES ARE DISTURBED, THE CONTRACTOR SHALL PROVIDE AND MAINTAIN TEMPORARY OUTLETS AND CONNECTIONS FOR ALL PRIVATE OR PUBLIC DRAINS, SEWERS OR CATCH BASINS. HE/SHE SHALL PROVIDE FACILITIES TO TAKE IN ALL STORM WATER WHICH WILL BE RECEIVED BY THESE DRAINS AND SEWERS AND DISCHARGE THE SAME. HE/SHE SHALL PROVIDE AND MAINTAIN AN EFFICIENT PUMPING PLAN, IF NECESSARY, AND A TEMPORARY OUTLET AND BE PREPARED AT ALL TIMES TO DISPOSE OF THE WATER RECEIVED FROM THESE TEMPORARY CONNECTIONS UNTIL SUCH TIME AS THE PERMANENT CONNECTIONS WITH SEWERS ARE BUILT AND IN SERVICE.
- 13. THE CONTRACTOR SHALL CONFIRM ALL EXISTING STORM SEWER PIPE SIZES AND INVERTS PRIOR TO ORDERING STRUCTURES. ANY MODIFICATIONS OF STRUCTURES DUE TO THE FAILURE OF THE CONTRACTOR TO PERFORM THIS TASK MAY LED TO THE REJECTION OF THE STRUCTURE IN THE FIELD.
- 14. STRUCTURE ADJUSTMENTS: PRECAST CONCRETE ADJUSTMENT RINGS ARE NOT TO EXCEED 12 INCHES IN OVERALL HEIGHT AND SHALL BE USED IF AN ADJUSTMENT TO THE FINISHED GRADE ESTABLISHED BY THE ENGINEER IS NECESSARY. MAXIMUM TWO RINGS.

MISCELLANEOUS

- 15. ACCESS: THE CONTRACTOR SHALL PROVIDE ACCESS TO ABUTTING PROPERTY AT ALL TIMES DURING THE CONSTRUCTION OF THIS PROJECT, EXCEPT FOR PERIODS OF SHORT DURATION.
- 16. DIMENSIONS: THE CONTRACTOR SHALL VERIFY ALL DIMENSIONS AND CONDITIONS EXISTING IN THE FIELD PRIOR TO ORDERING MATERIALS AND BEGINNING CONSTRUCTION.
- 17. LIMITS OF PATCHING, CURB AND GUTTER REMOVAL AND REPLACEMENT, SIDEWALK REMOVAL AND REPLACEMENT, DRIVEWAY REMOVAL AND REPLACEMENT, AND STRUCTURES TO BE ADJUSTED WILL BE DETERMINED BY THE ENGINEER IN THE FIELD.
- 18. THE THICKNESSES OF HOT-MIX ASPHALT MIXTURES SHOWN IN THE PLANS ARE NOMINAL. DEVIATIONS MAY OCCUR DUE TO IRREGULARITIES IN THE SURFACES OR BASES ON WHICH THEY ARE TO BE PLACED.
- 19. DETECTABLE WARNINGS FOR THE HANDICAPPED SHALL BE INSTALLED AT ALL INTERSECTING STREETS, DRIVEWAYS, AND ALLEYS AS SHOWN ON THE PLANS.
- 20. DEPRESSED CURB: RAMPS AND DEPRESSED CURBS ACCESSIBLE TO THE HANDICAPPED SHALL BE PROVIDED AT CROSSWALK LOCATIONS SHOWN ON THE PLANS.
- 21. ALL UNDERGROUND, DRIVEWAY, CONCRETE, AND LANDSCAPE RESTORATION WORK IS TO BE COMPLETED BEFORE THE SURFACE COURSE CAN BE INSTALLED.
- 22. FOR HOT-MIX ASPHALT SURFACE REMOVAL, THE EXISTING ASPHALT SURFACE SHALL BE REMOVED TO THE DEPTH SPECIFIED. THE GRINDINGS SHALL BE REMOVED FROM THE SITE AND THE SURFACE MECHANICALLY BROOMED UNTIL THE SURFACE IS COMPLETELY FREE OF ANY LOOSE MATERIAL AND DEBRIS.

- 23. NO CONSTRUCTION SHALL BEGIN UNTIL ALL PROPER TEMPORARY SIGNS AND BARRICADES HAVE BEEN INSTALLED.
- 24. ANY ADDITIONAL COST FOR TESTING REQUIRED TO SECURE APPROVAL OF DISPOSAL OF CLEAN CONSTRUCTION AND DEMOLTION DEBRIS (CCDD) AT A CCDD FILL OPERATION IS THE CONTRACTOR'S RESPONSIBILITY. THE CONTRACTOR SHALL OBTAIN ALL NECSSARY FIELD AND LABORATORY ANALYSIS TO OBTAIN THE LICENSED PROFESSIONAL ENGINEER'S CERTIFICATION REQUIRED AS PER PUBLIC ACT 96-1416 TO USE THE SITE.
- 25. THE CONTRACTOR SHALL BE SOLELY RESPONSIBLE FOR JOB SITE SAFETY AS WELL AS SUPERVISION/DIRECTION AND MEANS/METHODS OF CONSTRUCTION.
- 26. SOIL EROSION PROTECTION SHALL BE IN ACCORDANCE WITH IEPA STANDARDS AND SPECIFICATIONS FOR SOIL EROSION AND SEDIMENT CONTROL. ALL DISTURBED AREAS (NOT IMPERVIOUS IN NATURE) SHALL BE FINE GRADED, TOP SOIL RESTORED (MIN 4 INCHES) AND SOD APPLIED UNLESS OTHERWISE SPECIFIED ON THE PLANS.
- 27. ANY DEFACED WORK SHALL BE CORRECTED OR REPLACED BY THE CONTRACTOR. THE VILLAGE WILL COOPERATE WITH THE CONTRACTOR TO MINIMIZE VANDALISM, BUT THE CONTRACTOR SHALL BE ULTIMATELY RESPONSIBLE TO CORRECT ANY DAMAGE PER CONDITIONS OF ARTICLE 107.30 OF THE STANDARD SPECIFICATIONS.
- 28. THE CONTRACTOR SHALL KEEP ONE LANE IN EACH DIRECTION OPEN TO TRAFFIC AT ALL TIMES DURING CONSTRUCTION. THE CONTRACTOR SHALL COMPLETE ALL MILLING OPERATIONS BEFORE INSTALLING ANY HOT-MIX ASPHALT PAVEMENT.
- 29. THE CONTRACTOR MUST PROVIDE AND MAINTAIN SUFFICIENT WASHROOMS FOR THE PROJECT.
- 30. ADVANCE WARNING SIGNS NEED TO BE ERECTED AT LEAST 7 DAYS PRIOR TO START OF CONSTRUCTION.
- 31. PRIOR TO INSTALLING SURFACE COURSE AND AT THE ENGINEER'S DISCRETION, THE CONTRACTOR SHALL SAWCUT THE EXISTING PAVEMENT TO PROVIDE A NEW BUTT JOINT TO PAVE AGAINST.
- 32. CONTRACTOR SHALL TAKE PRECAUTION BY PRESERVING EXISTING TREES WITHIN THE RIGHT OF WAY. IF ANY DAMAGE OCCURS, TREE SHALL BE REPLACED IN KIND PER ARTILCE 201.07 REPAIR OR REPLACEMENT OF EXISTING PLANT MATERIAL REQUIREMENTS STATED HEREIN.

TO STA.

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		STP				
		FUNDING SOURCE			80% FED 20% LOCA	
		CONSTRUCTION TYPE CODE			0005	0042
	CODE NO.	ITEM	TOTAL QUANTITY	ROADWAY	TRAINEES	
	20101100	TREE TRUNK PROTECTION	EACH	10	10	
~	20101200	TREE ROOT PRUNING	EACH	5	5	
~	20101300	TREE PRUNING (1 TO 10 INCH DIAMETER)	EACH	5	5	
~	20101350	TREE PRUNING (OVER 10 INCH DIAMETER)	EACH	5	5	
	20201200	REMOVAL AND DISPOSAL OF UNSUITABLE MATERIAL	CU YD	100	100	
	20800150	TRENCH BACKFILL	CU YD	65	65	
	21001000	GEOTECHNICAL FABRIC FOR GROUND STABILIZATION	SQ YD	495	495	
	21101615	TOPSOIL FURNISH AND PLACE, 4"	SQ YD	700	700	
	21301060	EXPLORATION TRENCH 60" DEPTH	FOOT	20	20	
	25200110	SODDING, SALT TOLERANT	SQ YD	700	700	
	* 25200200	SUPPLEMENTAL WATERING	UNIT	20	20	
	28000250	TEMPORARY EROSION CONTROL SEEDING	POUND	14	14	
	28000400	PERIMETER EROSION BARRIER (TEMPORARY)	FOOT	185	185	
	28001100	TEMPORARY EROSION CONTROL BLANKET	SQ YD	30	30	
	28000510	INLET FILTERS	EACH	36	36	
	* 30300001	AGGREGATE SUBGRADE IMPROVEMENT	CU YD	100	100	
	35800100	PREPARATION OF BASE	SQ YD	1200	1200	
	35800200	AGGREGATE BASE REPAIR	TON	50	50	
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STATI	E OI	FILLINOIS
DEPARTMENT	OF	TRANSPORTATION

OAK PARK AVENUE RESURFACING						SECTION	COUNTY	TOTAL SHEETS	
SUMMARY OF QUANTITIES					2955	20-00060-00 - RS	COOK	22	
		O III III III II	Or COMMITTEE				CONTRAC	NO.	Ĝ
SCALE: N.T.S. SHEET 4 OF 22 SHEETS STA. TO STA.						ILLINOIS FED. AI	D PROJECT		

	FUNDING SOURCE						
	20% LOC 0005	0042					
 CODE NO.	ITEM	TOTAL QUANTITY	ROADWAY	TRAINEES			
40600290	BITUMINOUS MATERIALS (TACK COAT)	POUND	5635	5635			
40600982	HOT-MIX ASPHALT SURFACE REMOVAL - BUTT JOINT	SQ YD	100	100			
40603080	HOT-MIX ASPHALT BINDER COURSE, IL-19.0, N50	TON	1755	1755			
40604060	HOT-MIX ASPHALT SURFACE COURSE, IL-9.5, MIX "D", N50	TON	705	705			
* 42400200	PORTLAND CEMENT CONCRETE SIDEWALK 5 INCH	SQ FT	1820	1820			
* 42400800	DETECTABLE WARNINGS	SQ FT	90	90			
* 44000169	HOT-MIX ASPHALT SURFACE REMOVAL, 5"	SQ YD	7950	7950			
44000600	SIDEWALK REMOVAL	SQ FT	1820	1820			
44201690	CLASS D PATCHES, TYPE I, 4 INCH	SQ YD	110	110			
44201692	CLASS D PATCHES, TYPE II, 4 INCH	SQ YD	110	110			
44201694	CLASS D PATCHES, TYPE III, 4 INCH	SQ YD	110	110			
44201696	CLASS D PATCHES, TYPE IV, 4 INCH	SQ YD	165	165			
50102400	CONCRETE REMOVAL	CU YD	7	7			
50105220	PIPE CULVERT REMOVAL	FOOT	120	120			
* 542A5485	PIPE CULVERTS, CLASS A, TYPE 1 EQUIVALENT ROUND-SIZE 30"	FOOT	120	120			
60406000	FRAMES AND LIDS, TYPE 1, OPEN LID	EACH	2	2			
60406100	FRAMES AND LIDS, TYPE 1, CLOSED LID	EACH	2	2			
67100100	MOBILIZATION	LSUM	1	1			

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	OAK PARK AVENUE RESURFACING					F.A.U. RTE.	SECTION	COUNTY	TOTAL SHEETS	SHEET NO.
						2955	20-00060-00-RS	соок	22	5
-						_		CONTRAC	T NO.	61J23
-	SCALE: N.T.S. SHEET 5 OF 22 SHEETS STA. TO STA.					ILLINOIS FED. A	ID PROJECT			

		FUNDING SOURCE		-	STP 80% FED. 20% LOCAL		
		CONSTRUCTION TYPE CODE			0005	0042	
	CODE NO.	ITEM	UNIT	TOTAL QUANTITY	ROADWAY	TRAINEES	
7	70102620	TRAFFIC CONTROL AND PROTECTION, STANDARD 701501	LSUM	1 1	1		
*	70102635	TRAFFIC CONTROL AND PROTECTION, STANDARD 701701	LSUM	1	1		
*	70102640	TRAFFIC CONTROL AND PROTECTION, STANDARD 701801	LSUM	1	1		
~	72000100	SIGN PANEL - TYPE 1	SQ FT	215	215		
~	72900100	METAL POST - TYPE A	FOOT	324	324		
~	78000100	THERMOPLASTIC PAVEMENT MARKING - LETTERS AND SYMBOLS	SQ FT	73	73		
~	78000200	THERMOPLASTIC PAVEMENT MARKING - LINE 4"	FOOT	1080	1080		
~	78000400	THERMOPLASTIC PAVEMENT MARKING - LINE 6"	FOOT	260	260		
~	78000650	THERMOPLASTIC PAVEMENT MARKING - LINE 24"	FOOT	135	135		
~	78005110	EPOXY PAVEMENT MARKING - LINE 4"	FOOT	60	60		
~	78005130	EPOXY PAVEMENT MARKING - LINE 6"	FOOT	110	110		
~	78005180	EPOXY PAVEMENT MARKING - LINE 24"	FOOT	28	28		
~ *	85000400	MAINTENANCE OF EXISTING TRAFFIC SIGNAL INSTALLATION	EACH	1	1		
~ *	88600600	DETECTOR LOOP REPLACEMENT	FOOT	200	200		
*	X4021000	TEMPORARY ACCESS (PRIVATE ENTRANCE)	EACH	49	49		
*	X4022000	TEMPORARY ACCESS (COMMERCIAL ENTRANCE)	EACH	2	2		
*	X4023000	TEMPORARY ACCESS (ROAD)	EACH	6	6		
*	XX003435	PORTLAND CEMENT CONCRETE DRIVEWAY REMOVAL AND REPLACEMENT	SQ YD	150	150		

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DEPARTMENT OF	TRANSPORTATION

OAK PARK AVENUE RESURFACING SUMMARY OF QUANTITIES											
SCALE:	N.T.S.	SHEET 6	0F	22	SHEETS	STA.	TO ST	Α.			


RTE.	SECTION	COUNTY	SHEET
2955	20-00060-00 - RS	COOK	55
		CONTRAC	T NO.
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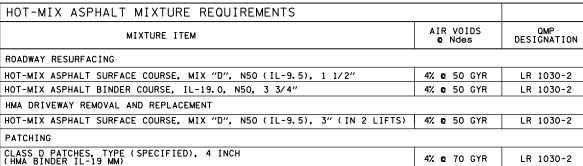
		FUNDING SOURCE			STP 80% FED. 20% LOCAL		
		CONSTRUCTION TYPE CODE			0005	0042	
	CODE NO.	ITEM	UNIT	TOTAL QUANTITY	ROADWAY	TRAINEES	
*	XX006947	HOT-MIX ASPHALT DRIVEWAY REMOVAL AND REPLACEMENT	SQ YD	365	365		
*	X4400501	COMBINATION CURB AND GUTTER REMOVAL AND REPLACEMENT LESS THAN OR EQUAL TO 10 FEET	FOOT	145	145		
*	X4400503	COMBINATION CURB AND GUTTER REMOVAL AND REPLACEMENT GREATER THAN 10 FEET	FOOT	835	835		
*	Z0013798	CONSTRUCTION LAYOUT	LSUM	1	1		
*	Z0017400	DRAINAGE & UTILITY STRUCTURES TO BE ADJUSTED	EACH	35	35		
*	Z0017500	DRAINAGE & UTILITY STRUCTURE ADJUSTMENT (SPECIAL)	EACH	14	14		
*	Z0030850	TEMPORARY INFORMATION SIGNING	SQ FT	52	52		
*	Z0076600	TRAINEES	HOUR	500		500	
*	Z0076604	TRAINEES TRAINING PROGRAM GRADUATE	HOUR	500		500	

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N:\CHICAGDRIDGE\9861T\122\C:v:1\0UA_T81	22_Ø4.sht	DRAWN - BRL	REVISED -	STATE OF ILLINOIS	DAK PARK AVENUE RESURFACING	2955 20-00060-00-RS COOK 22 7
<u> </u>	PLOT SCALE = 48'	CHECKEO - AMP	REVISED -	DEPARTMENT OF TRANSPORTATION	SUMMARY OF QUANTITIES	CONTRACT NO. 61J23
Default	PLOT DATE = 11/17/2022	DATE +	REVISED -		SCALE: N.T.S. SHEET 7 OF 22 SHEETS STA. TO STA.	ILLINOIS FEO. AID PROJECT

^{*} INDICATES SPECIAL PROVISION

[~] INDICATES SPECIALTY ITEM



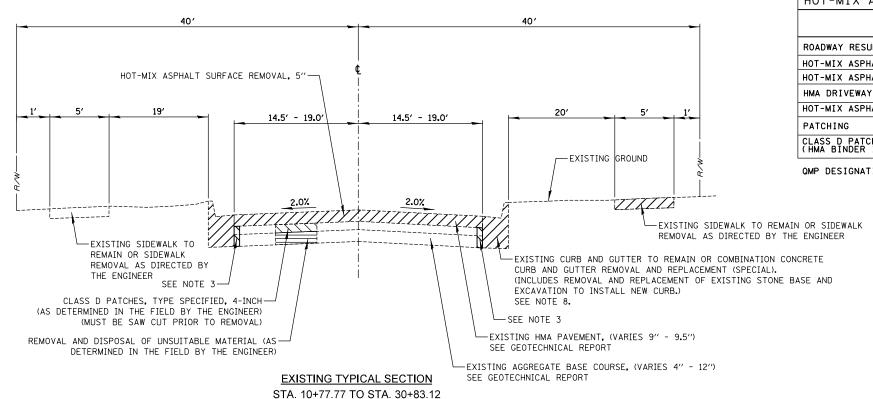


QMP DESIGNATION: QUALITY CONTROL/QUALITY ASSURANCE (QA/QC) PER LR 1030-2

- THE UNIT WEIGHT USED TO CALCULATE ALL HMA SURFACE MIXTURE QUANTITIES IS 112 LBS/SQ YD/IN.
- THE "AC TYPE" FOR POLYMERIZED HMA MIXES SHALL BE "SBS/SBR PG 76-22" AND FOR NON-POLYMERIZED HMA THE "AC TYPE" SHALL BE "PG 64-22" UNLESS MODIFIED BY RECLAIMED MATERIALS SPECIFICATIONS.

SCALE: N.T.S.

- CLASS SI PCC, VIBRATED IN PLACE SHALL BE POURED WITHIN 48 HOURS AND INCLUDED IN THE COST OF COMBINATION CONCRETE CURB AND GUTTER.
- 2. CONTRACTOR SHALL SAWCUT PAVEMENT PRIOR TO REMOVING THE CURB.
- PAVEMENT REMOVAL ADJACENT TO PROPOSED CURB AND GUTTER SHALL BE INCLUDED IN THE COST OF THE PROPOSED CURB AND GUTTER.
- FOR ROADWAYS WITH DIFFERING ELEVATIONS AT THE EDGE OF PAVEMENT, CONTRACTOR SHALL PAVE THE SIDE WITH THE HIGHER ELEVATION FIRST.
- ENGINEER TO VERIFY MINIMUM 2% CROSS SLOPE PRIOR TO PLACING SURFACE COURSE. ANY CORRECTIONS MUST BE MADE BY THE CONTRACTOR AT HIS OWN
- NO ADDITIONAL COMPENSATION SHALL BE CONSIDERED FOR PETROMAT (FABRIC) ENCOUNTERED DURING GRINDING OPERATIONS. REMOVAL AND DISPOSAL OF PETROMAT SHALL BE INCLUDED IN THE COST OF HOT-MIX ASPHALT SURFACE REMOVAL. CONTRACTOR SHALL MILL PRIOR TO PATCHING.
- LIMITS OF CURB AND GUTTER REMOVAL AND REPLACEMENT TO BE MARKED IN THE FIELD BY THE ENGINEER.

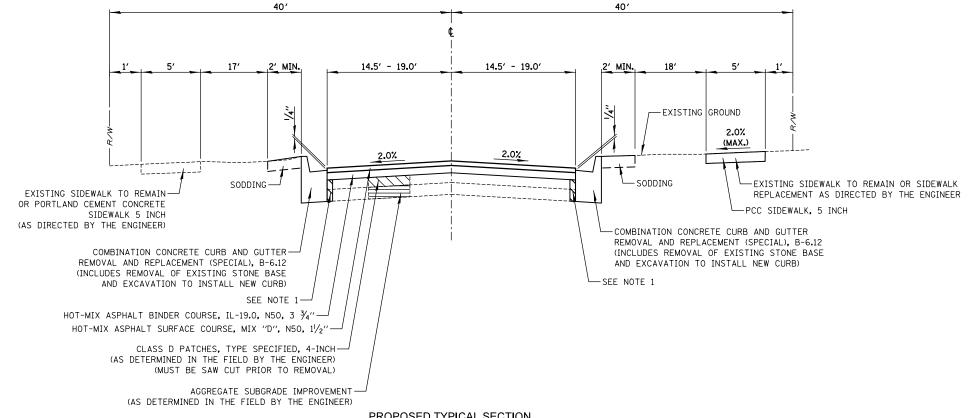



PROPOSED TYPICAL SECTION STA. 10+77.77 TO STA. 30+83.12


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N:\CHICAGORIDGE\9061T\122\C1v1\\TYP_T0122	_01.sht	DRAWN - BRL	REVISED -
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Default	PLOT DATE = 11/17/2022	DATE -	REVISED -


STATE OF ILLINOIS **DEPARTMENT OF TRANSPORTATION**


OAK PARK AVENUE RESURFACING						F.A.U. RTE.	SECTION	COUNTY	TOTAL SHEETS	SHEET NO.
TYPICAL SECTIONS			2955	20-00060-00-RS	соок	22	8			
								CONTRAC	T NO.	61J23
SHEET 8	OF	22	SHEETS	STA.	TO STA.		ILLINOIS FED.	AID PROJECT		

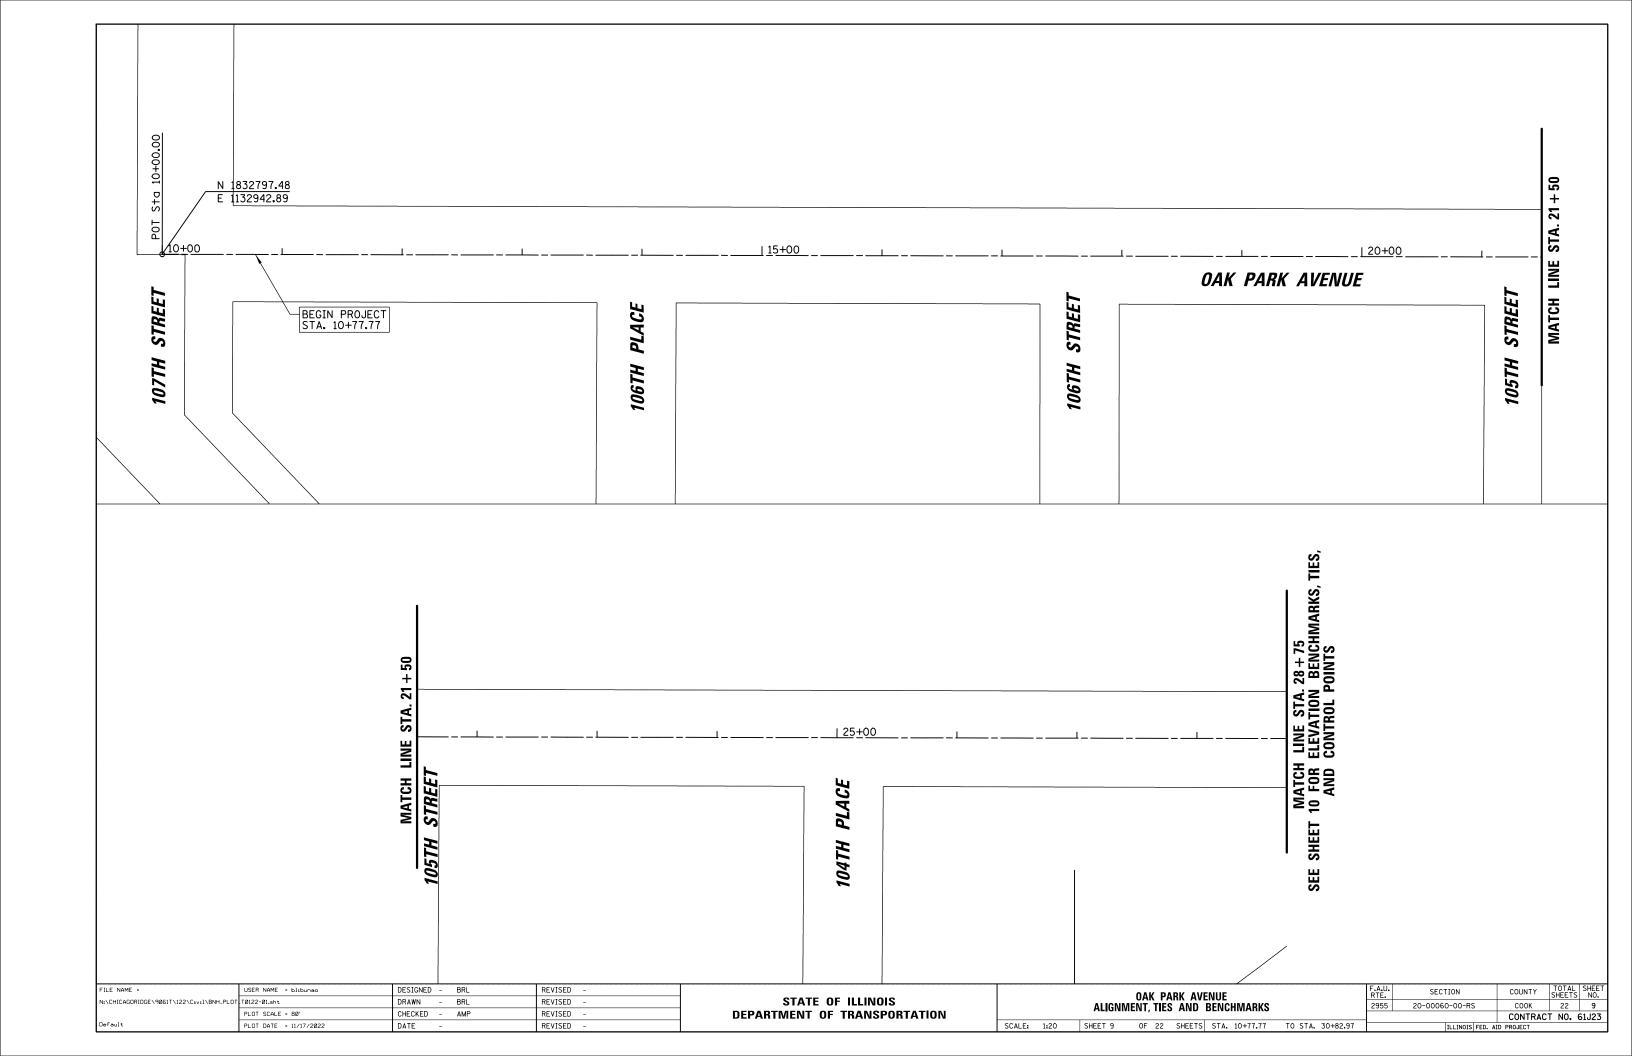

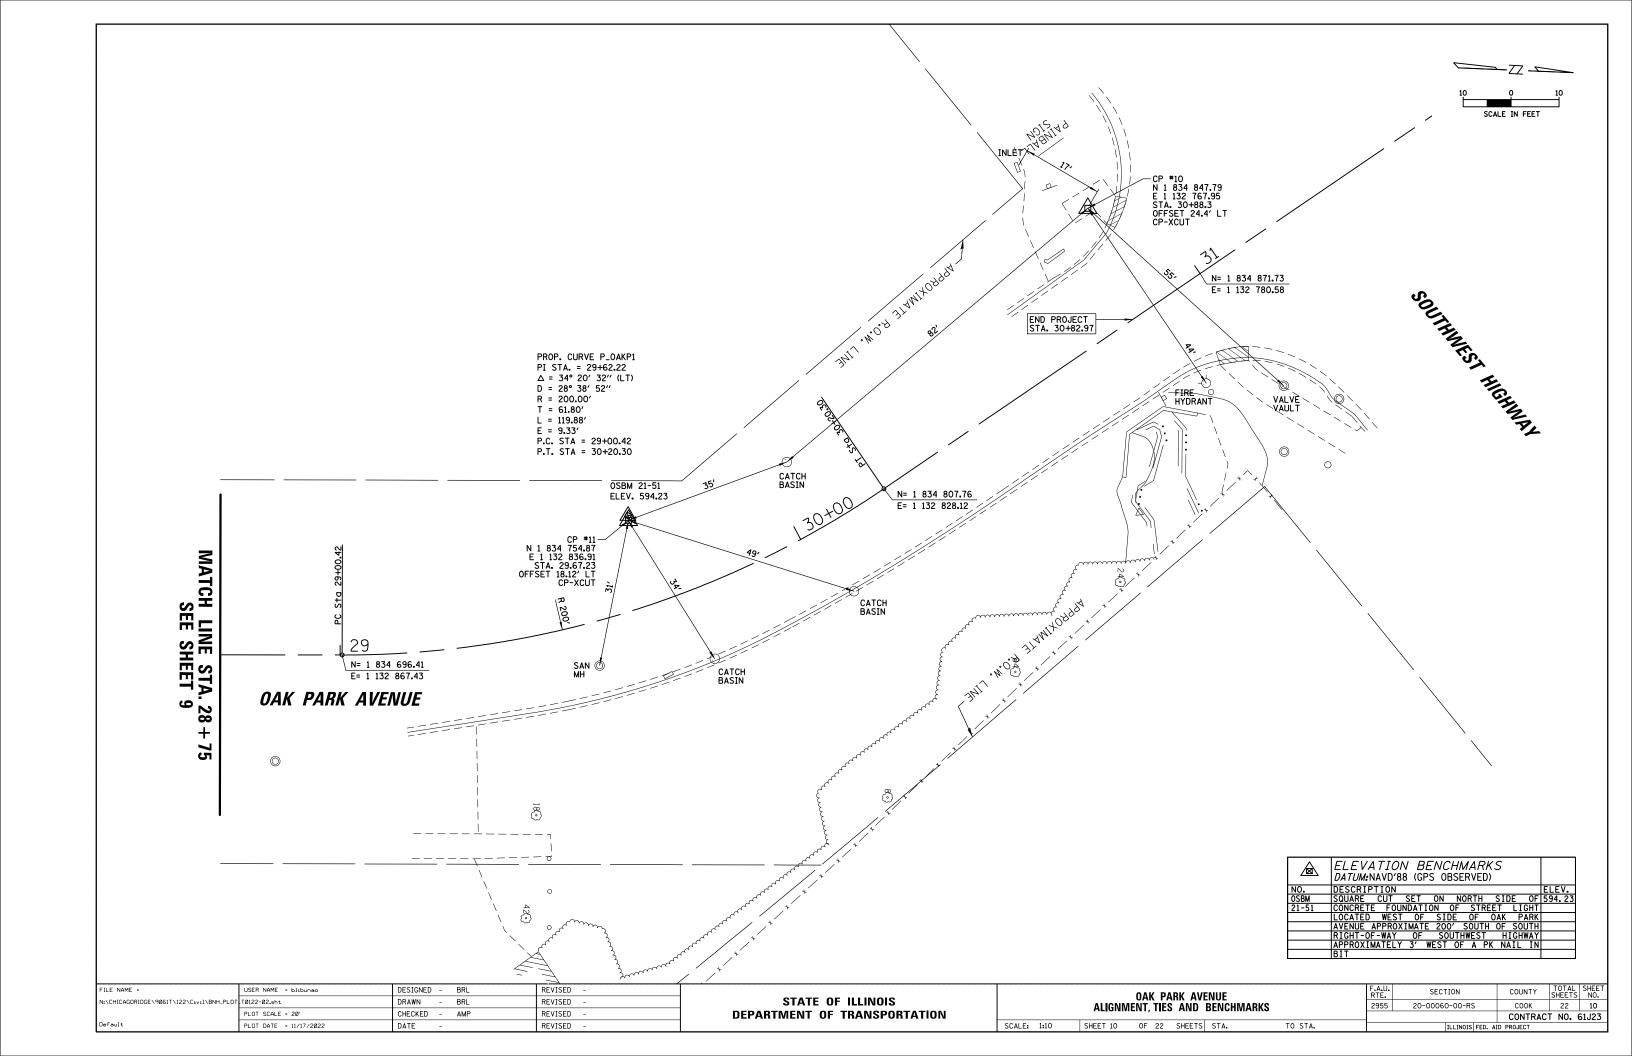

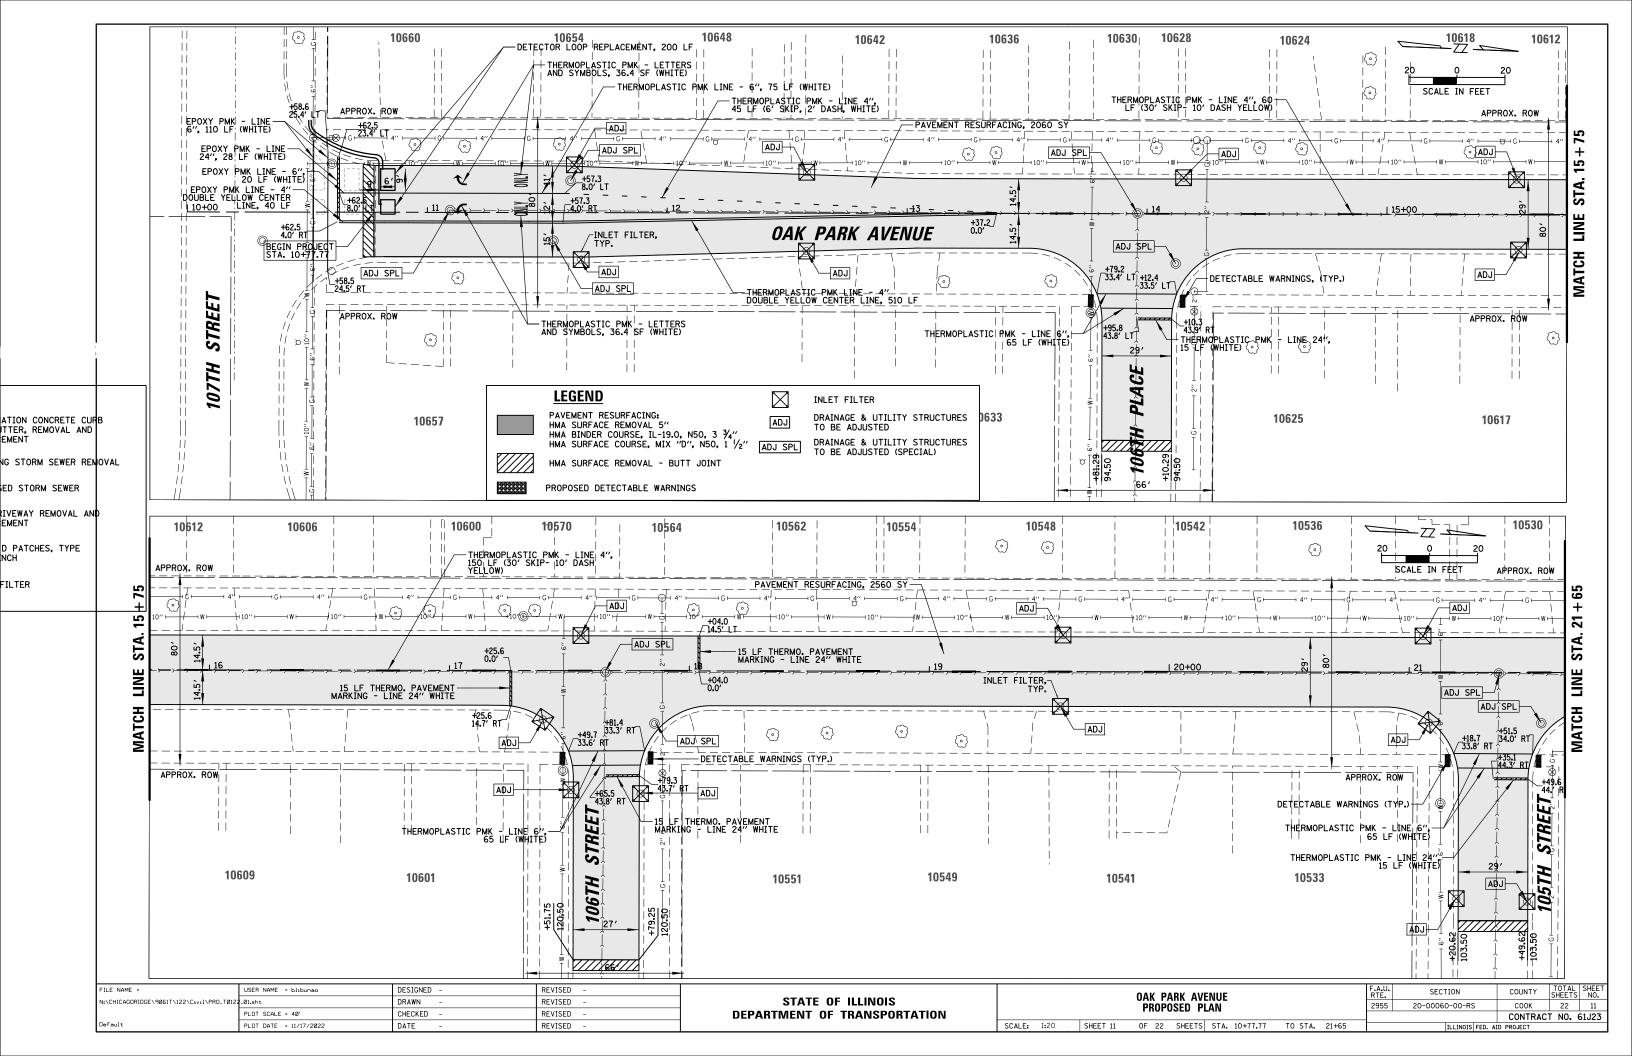

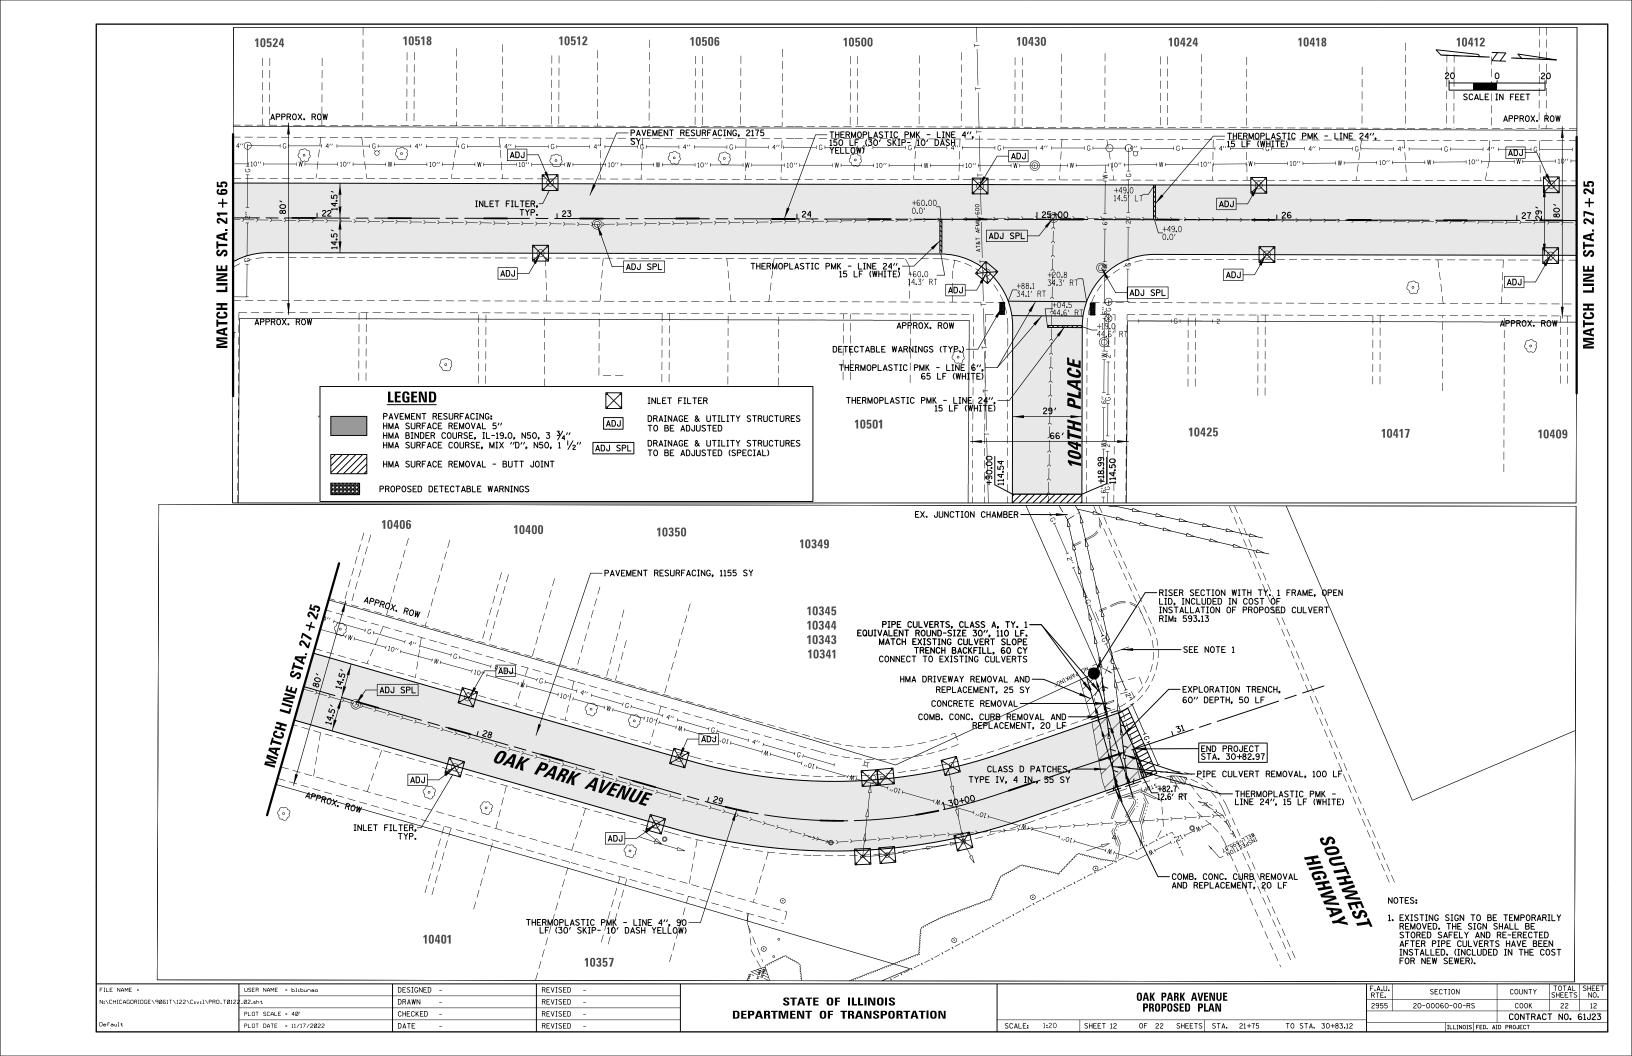


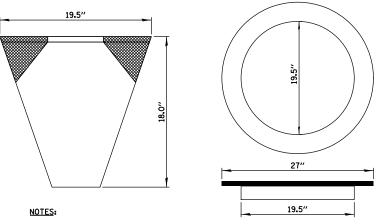

FRAME: FLANGE SHALL BE FABRICATED FROM $1/8^{\prime\prime}$ FLAT STACK. BASE RING SHALL BE FABRICATED FROM $11/2^{\prime\prime}\times11/2^{\prime\prime}\times1/8^{\prime\prime}$ CHANNEL. DOMESTIC STEEL CONFORMING TO ASTM-A36.


SEDIMENT BAG: SHALL BE FABRICATED FROM 4 0Z/SQ YD NON-WAVEN POLYPROPYLENE GEOTEXTILE AND SHALL BE REINFORCED WITH POLYESTER MESH. THE BAG SHALL BE SECURED TO THE BASE RING WITH STAINLESS STEEL STRAP AND LOCK.


CATCH BASIN AND INLET FILTER

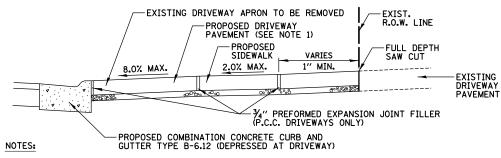

- 1. THE PROPOSED DRIVEWAY PAVEMENT SHALL CONSIST OF:
 - A. 7" PORTLAND CEMENT CONCRETE AND 3" OF AGGREGATE BASE COURSE TYPE B IF THE EXISTING DRIVEWAY IS P.C. CONCRETE, OR
 - B. 3" HOT-MIX ASPHALT SURFACE COURSE, MIX "D", N50, AND 6" AGGREGATE BASE COURSE TYPE B IF THE EXISTING DRIVEWAY IS HMA OR AGGREGATE.
- 2. PREFORMED EXPANSION JOINT FILLER SHALL BE INCLUDED IN THE COST OF P.C.C. DRIVEWAY PAVEMENT.
- 3. ALL REQUIRED EARTH EXCAVATION AND DRIVEWAY REMOVAL REQUIRED TO CONSTRUCT DRIVES SHALL BE INCLUDED IN THE COST OF DRIVEWAY REMOVAL & REPLACEMENT, OF THE TYPE SPECIFIED.

DRIVEWAY REMOVAL AND REPLACEMENT

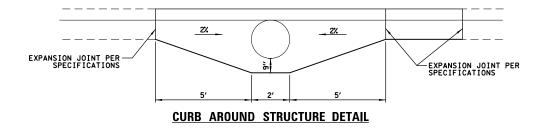

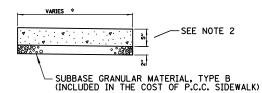


* CROSS SLOPE 0.5% (MIN.) TO 2% (MAX.)

NOTES:

- ALL REQUIRED EARTH EXCAVATION TO CONSTRUCT P.C.C. SIDEWALK SHALL BE INCLUDED IN COST OF P.C.C. SIDEWALK 5 INCH.
- THICKNESS SHALL BE INCREASED TO 7" WHERE SIDEWALK IS ADJACENT TO A DRIVEWAY (NO WIRE MESH). (INCLUDED IN COST OF SIDEWALK).
- 3. IN LOCATIONS WHERE SIDEWALK IS REMOVED AND REPLACED THROUGH DRIVEWAYS, DRIVEWAYS SHALL BE SAWCUT AND PATCHED A MINIMUM OF 1' ON EITHER SIDE OF THE WALK. THIS WORK SHALL BE PAID FOR PER SOUARE YARD AT THE CONTRACT UNIT PRICE FOR P.C.C. CONCRETE DRIVEWAY REMOVAL AND REPLACEMENT OR HOT-MIX ASPHALT DRIVEWAY REMOVAL AND REPLACEMENT.
- 4. WHEN FORMS ARE REMOVED FROM THE SIDEWALK, THE SIDEWALK SHALL BE BARRICADED OR BACKFILLED WITHIN 24 HOURS.

P.C.C. SIDEWALK, 5 INCH DETAIL

FILE NAME =	USER NAME = blibunao	DESIGNED - BRL	REVISED -		OAK PARK AVENUE RESURFACING			F.A.U.	SECTION	COUNTY	TOTAL SHEET
N:\CHICAGORIDGE\9061T\122\C1v1\CDET_T01	22_01.sht	DRAWN - BRL	REVISED -	STATE OF ILLINOIS		CONSTRUCTION DETAILS		2955	20-00060-00-RS	соок	22 13
	PLOT SCALE = 40'	CHECKED - AMP	REVISED -	DEPARTMENT OF TRANSPORTATION	CONSTRUCTION DETAILS						T NO. 61J23
Default	PLOT DATE = 11/17/2022	DATE -	REVISED -		SCALE: N.T.S.	SHEET 13 OF 22 SHEETS STA.	TO STA.		ILLINOIS FED, AI	ID PROJECT	

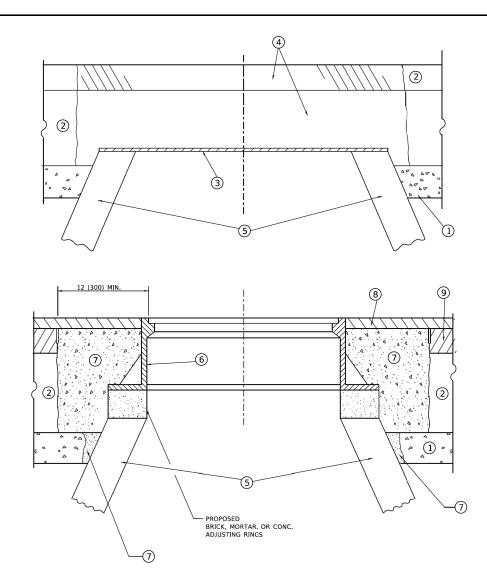

DETAILS FOR FRAMES AND LIDS ADJUSTMENT WITH MILLING

NOTES

- 1. EXISTING BROKEN FRAMES AND LIDS SHALL BE REMOVED AND DISPOSED OF BY THE CONTRACTOR AND SHALL BE REPLACED AS DIRECTED BY THE ENGINEER. REPLACEMENT FRAMES AND LIDS WILL BE PAID FOR IN ACCORDANCE WITH ARTICLE 109.04 OF THE STANDARD SPECIFICATIONS UNLESS A SEPARATE PAY ITEM HAS BEEN PROVIDED.
- IF THE EXISTING LIDS ARE OPEN, THE FRAME WILL BE ADJUSTED TO THE ELEVATION OF THE MILLED PAVEMENT SURFACE PRIOR TO THE MILLING OPERATION. THE FRAME WILL NOT BE REMOVED AND COVERED BY THE METAL PLATE.
- CITY OF CHICAGO CASTINGS ARE THE PROPERTY OF THE CITY AND THE CONTRACTOR SHALL NOTIFY THE CITY FOR REMOVAL AND DISPOSITION OF THE CASTINGS.
- 4. THE METAL PLATE USED TO COVER THE STRUCTURE SHALL REMAIN THE PROPERTY OF THE CONTRACTOR.

CONSTRUCTION PROCEDURES

- STAGE 1 (BEFORE PAVEMENT MILLING)
 - A) REMOVE A MINIMUM OF 12 (300) OF THE PAVEMENT FROM AROUND THE STRUCTURE.
 - B) REMOVE THE EXISTING FRAME AND LID FROM THE STRUCTURE.
 - C) COVER THE STRUCTURE OPENING WITH A 36 (900) DIAMETER METAL PLATE.
 - D) BACKFILL WITH CRUSHED STONE AND HMA SURFACE MIX APPROVED BY THE ENGINEER. (MIN. 1 1/2 (40) HMA TO REMAIN AFTER MILLING).

STAGE 2 (AFTER PAVEMENT MILLING)

- A) REMOVE THE HMA SURFACE MIX AND CRUSHED STONE.
- B) INSTALL THE FRAME AND LID; ADJUST THE FRAME TO ITS FINAL SURFACE ELEVATION.
- C) THE SURROUNDING SPACE SHALL BE FILLED WITH CLASS*PP-1 CONCRETE TO THE ELEVATION OF THE SURFACE OF THE EXISTING BASE COURSE OR THE BINDER COURSE.
- *UNLESS OTHERWISE SPECIFIED IN THE PLANS.

THE PROCEDURE EXPLAINED ABOVE SHALL CONFORM TO THE APPLICABLE PORTIONS OF SECTIONS 353, 406, 602, AND 603 OF THE STANDARD SPECIFICATIONS EXCEPT THAT "THE CONTRACTOR SHALL ADJUST THE STRUCTURES TO THE FINISHED PAVEMENT ELEVATION NO MORE THAN 5 CALENDAR DAYS PRIOR TO PLACEMENT OF THE FINAL LIFT OF SURFACE UNLESS APPROVED BY THE ENGINEER."

LEGEN

① SUB-BASE GRANULAR MATERIAL

(6) FRAME AND LID (SEE NOTES)

2 EXISTING PAVEMENT

7 CLASS*PP-1 CONCRETE

3 36 (900) DIAMETER METAL PLATE

8 PROPOSED HMA SURFACE COURSE

4 PROPOSED CRUSHED STONE AND HMA SURFACE MIX

_

(5) EXISTING STRUCTURE

PROPOSED HMA BINDER COURSE

LOCATION OF STRUCTURES

THE CONTRACTOR WILL BE REQUIRED TO KEEP A RECORD OF THE LOCATIONS OF THE BURIED STRUCTURES ACCORDING TO THE STATION AND DISTANCE LEFT OR RIGHT OF THE CENTERLINE OF PAVEMENT. UPON COMPLETION OF THE WORK, THE CONTRACTOR WILL DELIVER THE RECORD TO THE ENGINEER.

BASIS OF PAYMENT

- REMOVING FRAMES AND LIDS ON DRAINAGE AND UTILITY STRUCTURES IN THE PAVEMENT PRIOR TO MILLING, AND ADJUSTING TO FINAL GRADE PRIOR TO PLACING THE SURFACE COURSE, WILL BE PAID FOR AT THE CONTRACT UNIT PRICE EACH FOR "FRAMES AND LIDS TO BE ADJUSTED (SPECIAL)."
- 2. THIS WORK WILL NOT BE PAID FOR WHEN DRAINAGE AND UTILITY STRUCTURES ARE SPECIFIED FOR PAYMENT AS STRUCTURE RECONSTRUCTION.
- 3. NEW FRAMES AND LIDS, WHEN SPECIFIED, WILL BE PAID FOR SEPARATELY.
- 4. WHEN STRUCTURES ARE TO BE ADJUSTED OR RECONSTRUCTED, THE LOWERING AND RAISING OF THE FRAMES AND LIDS WILL NOT BE PAID FOR SEPARATELY BUT WILL BE INCLUDED IN THE COST OF THE CORRESPONDING PAY ITEM.

ALL DIMENSIONS ARE IN INCHES (MILLIMETERS) UNLESS OTHERWISE SHOWN

STATE OF ILLINOIS
DEPARTMENT OF TRANSPORTATION

FRAMES AND LIDS ADJUSTMENT WITH MILLING

SCALE: NONE SHEET 1 OF 1 SHEETS STA. TO STA.

BD600-03 (BD-08) CONTRACT NO.

STATE OF ILLINOIS
DEPARTMENT OF TRANSPORTATION

FRAMES AND LIDS ADJUSTMENT WITH MILLING

SCALE: NONE SHEET 14 OF 22 SHEETS STA. TO STA.

F.A.U. SECTION COUNTY TOTAL SHEETS NO.

2955 20-00060-00-RS COOK 22 14

CONTRACT NO. 61J23

METHOD OF MEASUREMENT

REFER TO SECTION 442 OF THE STANDARD SPECIFICATIONS FOR ROAD AND BRIDGE CONSTRUCTION AND THE RECURRING SPECIAL PROVISION "PATCHING WITH HOT-MIX ASPHALT OVERLAY REMOVAL."

BASIS OF PAYMENT

- 1. REFER TO SECTION 442 OF THE STANDARD SPECIFICATIONS FOR ROAD AND BRIDGE CONSTRUCTION AND THE RECURRING SPECIAL PROVISION "PATCHING WITH HOT-MIX ASPHALT OVERLAY REMOVAL."
- SAW CUT/SCORING OF EXISTING HMA OVERLAY IS INCLUDED IN THE COST OF PAVEMENT PATCHING.
- 3. SAW CUT/SCORING OF EXISTING PAVEMENT IS INCLUDED IN THE COST OF PAVEMENT PATCHING.

★ SEE TYPICAL SECTIONS FOR

THICKNESS AND MATERIALS

AND HMA REPLACEMENT OVER PATCHES FOR PATCHING FIRST CONSTRUCTION 6 (150) MIN. -FOR PATCHING FIRST CONSTRUCTION SAW CUT/SCORING EXIST. HMA OVERLAY, TYPICAL. TOP OF EXIST. HMA — OR MILLED SURFACE CLASS C OR CLASS D PATCH OF THE THICKNESS SPECIFIED 12 (300) SAW CUT/SCORING, TYPICAL **EXISTING PAVEMENT** PROPOSED UNSUITABLE SUBGRADE REMOVAL AND REPLACEMENT UTILITY OR STORM SEWER TRENCH
(IF PATCH IS DUE TO UTILITY OR SEWER
WORK, THE WIDTH OF THE FULL DEPTH
PATCH SHALL BE 12 (300) WIDER ON EACH
SIDE OF THE TRENCH).

HMA REMOVAL OVER PATCHES *

SEQUENCE OF CONSTRUCTION (PATCHING FIRST)

- 1. REMOVE THE EXISTING HMA MATERIAL OVER THE AREA TO BE PATCHED.
- 2. REMOVE AND REPLACE WITH CLASS C OR D PATCH.
- 3. REPLACE HMA MATERIAL OVER THE AREA TO BE PATCHED.


SEQUENCE OF CONSTRUCTION (MILLING FIRST)

- 1. MILL HMA FIRST IF THERE IS AT LEAST 4½ INCHES OR MORE OF HMA MATERIAL ON TOP OF THE EXISTING PAVEMENT OR IF THE PAVEMENT IS FULL DEPTH HMA. A MINIMUM OF 2 INCHES OF HMA MATERIAL SHALL BE IN PLACE AFTER MILLING.
- 2. REMOVE AND REPLACE WITH FULL DEPTH CLASS D PATCHES TO TOP OF MILLED SURFACE.

ALL DIMENSIONS ARE IN INCHES (MILLIMETERS) UNLESS OTHERWISE SHOWN.

USER NAME = demanchelt	DESIGNED - R. SHAH	REVISED - R. BORO 01-01-07		PAVEMENT PATCHING FOR	F.A. SECTION	COUNTY TOTAL SHEET
	DRAWN -	REVISED - R. BORO 09-04-07	STATE OF ILLINOIS		11121	SHEETS NO.
PLOT SCALE = 100.0000 ' / in.	CHECKED -	REVISED - K. ENG 10-27-08	DEPARTMENT OF TRANSPORTATION	HMA SURFACED PAVEMENT	BD400-04 (BD-22)	CONTRACT NO.
PLOT DATE = 2/2/2022	DATE - 10-25-94	REVISED - K. SMITH 02-01-22		SCALE: NONE SHEET 1 OF 1 SHEETS STA. TO STA.	ILLINOIS FED. A	ID PROJECT

FILE NAME =	USER NAME = blibunao	DESIGNED - BRL	REVISED -		PAVEMENT PATCHING FOR	F.A.U. RTE.	SECTION	COUNTY	TOTAL SHEET SHEETS NO.
N:\CHICAGORIDGE\9061T\122\C1v1\ST[_BD22_T0122_01.sht	DRAWN - BRL	REVISED -	STATE OF ILLINOIS	HMA SURFACED PAVEMENT	2955	20-00060-00-RS	соок	22 15
	PLOT SCALE = 40'	CHECKED - AMP	REVISED -	DEPARTMENT OF TRANSPORTATION				CONTRACT	NO. 61J23
Default	PLOT DATE = 11/17/2022	DATE -	REVISED -		SCALE: NONE SHEET 15 OF 22 SHEETS STA. TO STA.		ILLINOIS FED. A	ID PROJECT	

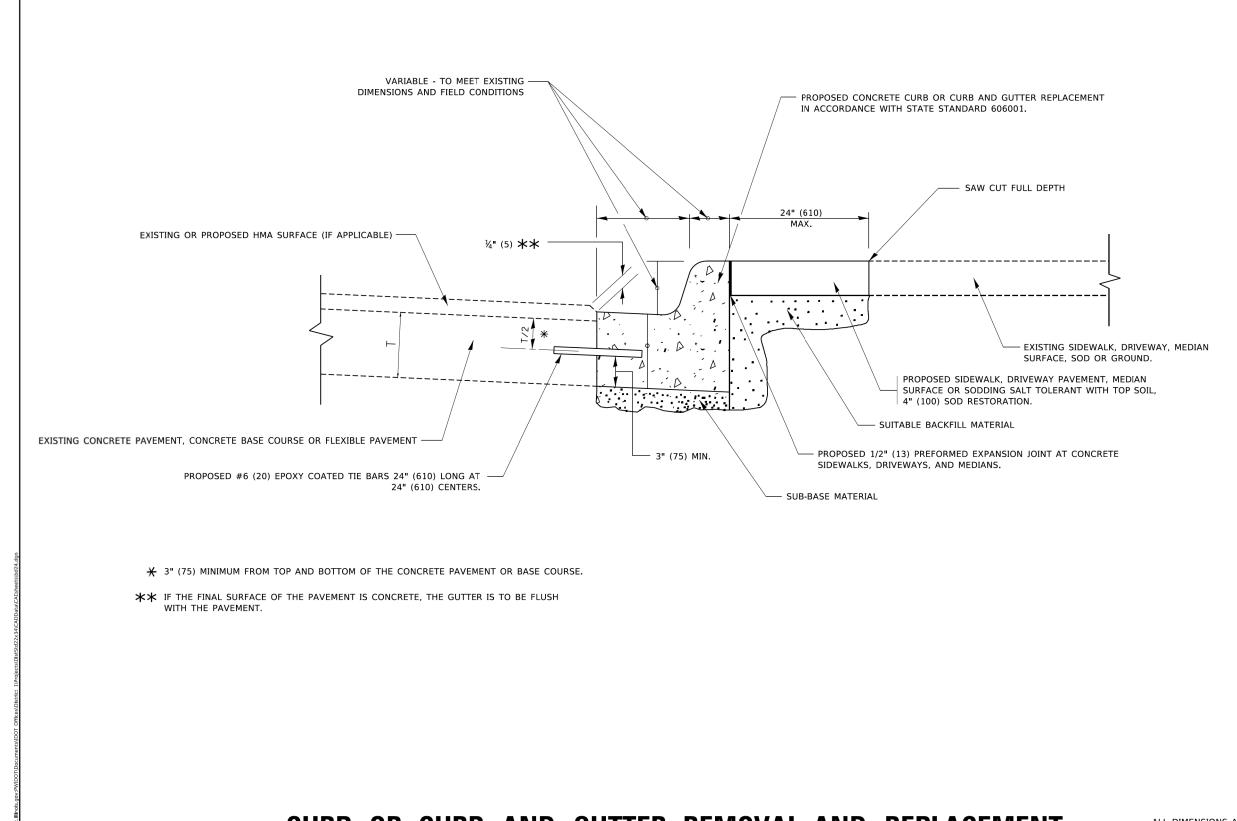



CURB OR CURB AND GUTTER REMOVAL AND REPLACEMENT


ALL DIMENSIONS ARE IN INCHES (MILLIMETERS) UNLESS OTHERWISE SHOWN.


USER NAME = footemj	DESIGNED - A. HOUSEH	REVISED - A. ABBAS 03-21-97		CURB OR CURB AND GUTTER	F.A. SECTION	COUNTY TOTAL SHEET
	DRAWN -	REVISED - M. GOMEZ 01-22-01	STATE OF ILLINOIS	REMOVAL AND REPLACEMENT	TO LE	SHEETS NO.
PLOT SCALE = 50.0000 ' / in.	CHECKED -	REVISED - R. BORO 12-15-09	DEPARTMENT OF TRANSPORTATION	KEWIUVAL AND KEPLAGEWEN I	BD600-06 (BD-24)	CONTRACT NO.
PLOT DATE = 7/11/2019	DATE - 03-11-94	REVISED - K, SMITH 07-11-19		SCALE: NONE SHEET 1 OF 1 SHEETS STA. TO STA.	ILLINOIS FED.	AID PROJECT

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N:\CHICAGORIDGE\9061T\122\C1v1\STD_BD24	.T0122_01.sht	DRAWN - BRL	REVISED -	STATE OF ILLINOIS	FRAMES AND LIDS ADJUSTMENT WITH MILLING	2955	20-00060-00-RS	соок	22	16
	PLOT SCALE = 40'	CHECKED - AMP	REVISED -	DEPARTMENT OF TRANSPORTATION	FRANCES AND LIDS ADJUSTIVIENT WITH WILLING			CONTRAC	CT NO.	61J23
Default	PLOT DATE = 11/17/2022	DATE -	REVISED -		SCALE: NONE SHEET 16 OF 22 SHEETS STA. TO STA.		ILLINOIS FED. AI	ID PROJECT		
						-	I COLLINOIS COLUMN	<u> </u>		_

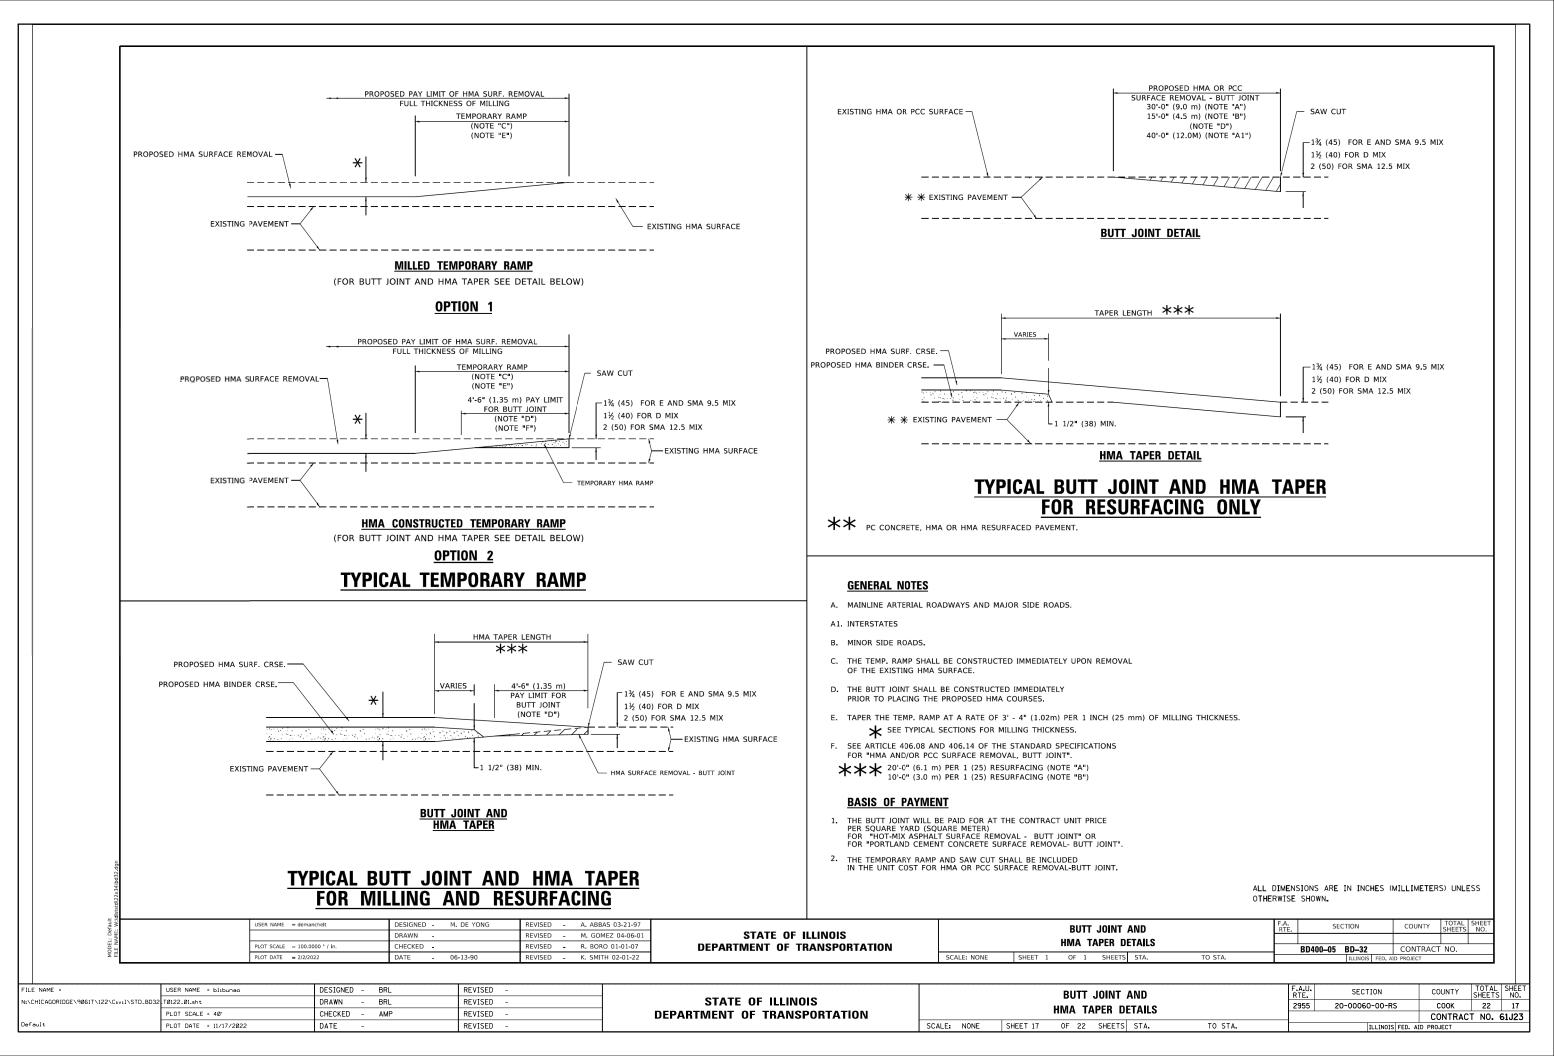

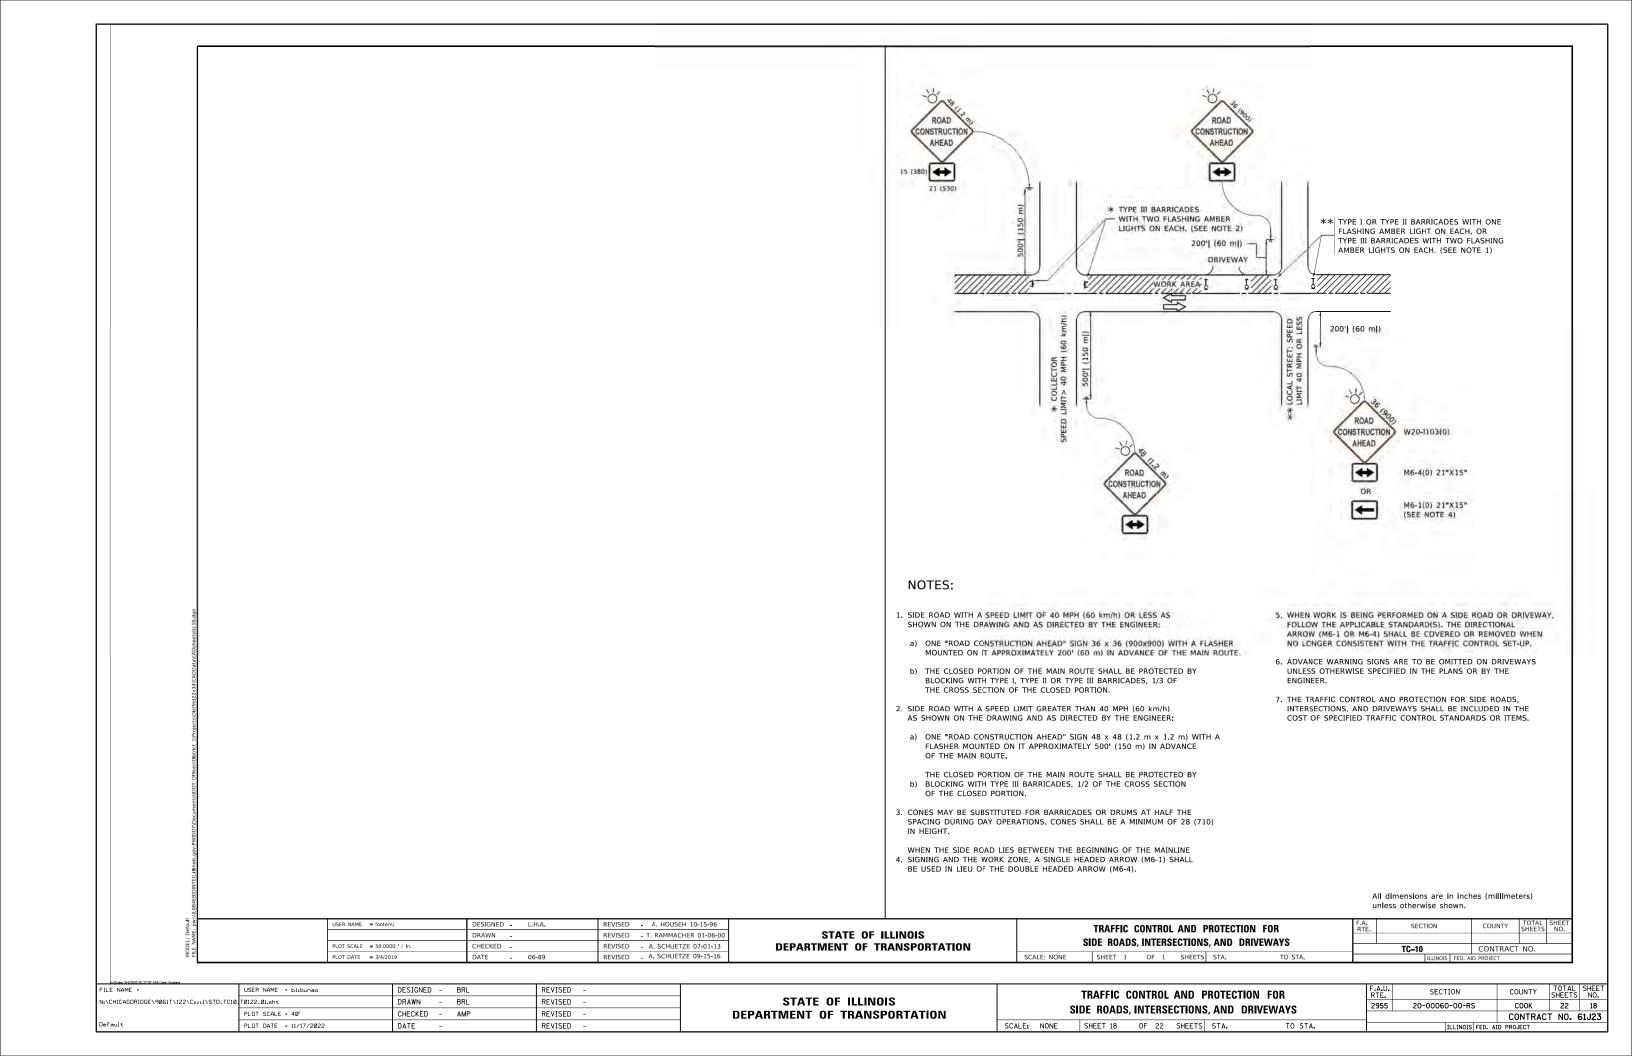

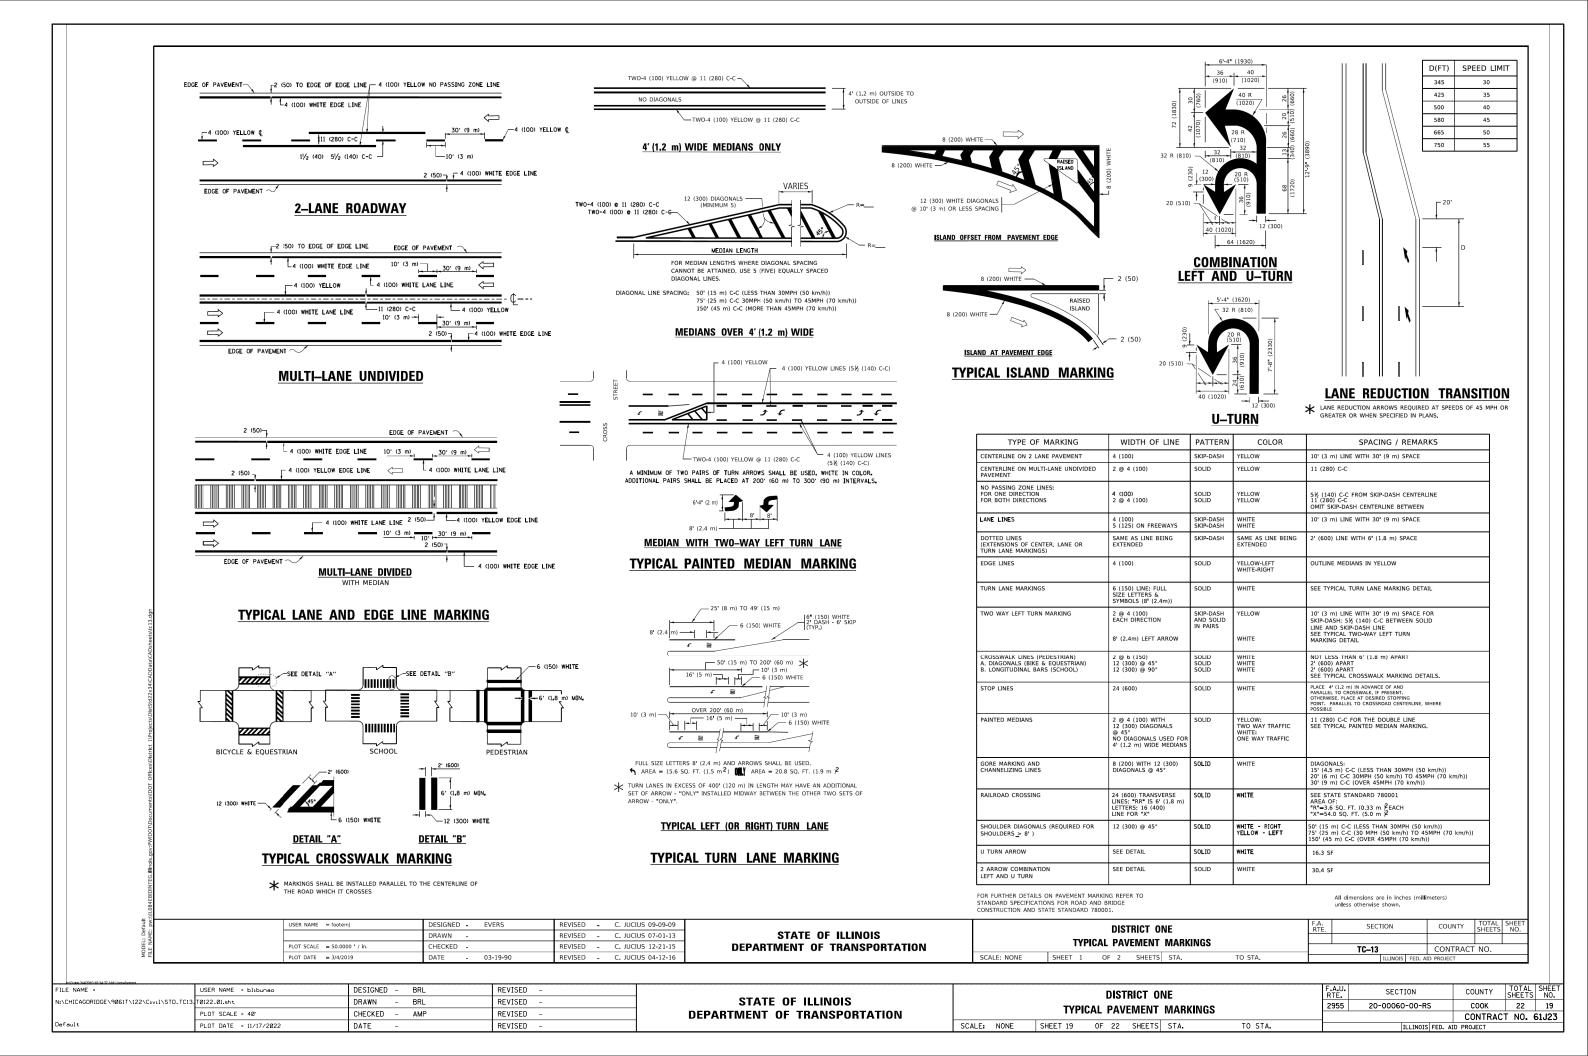

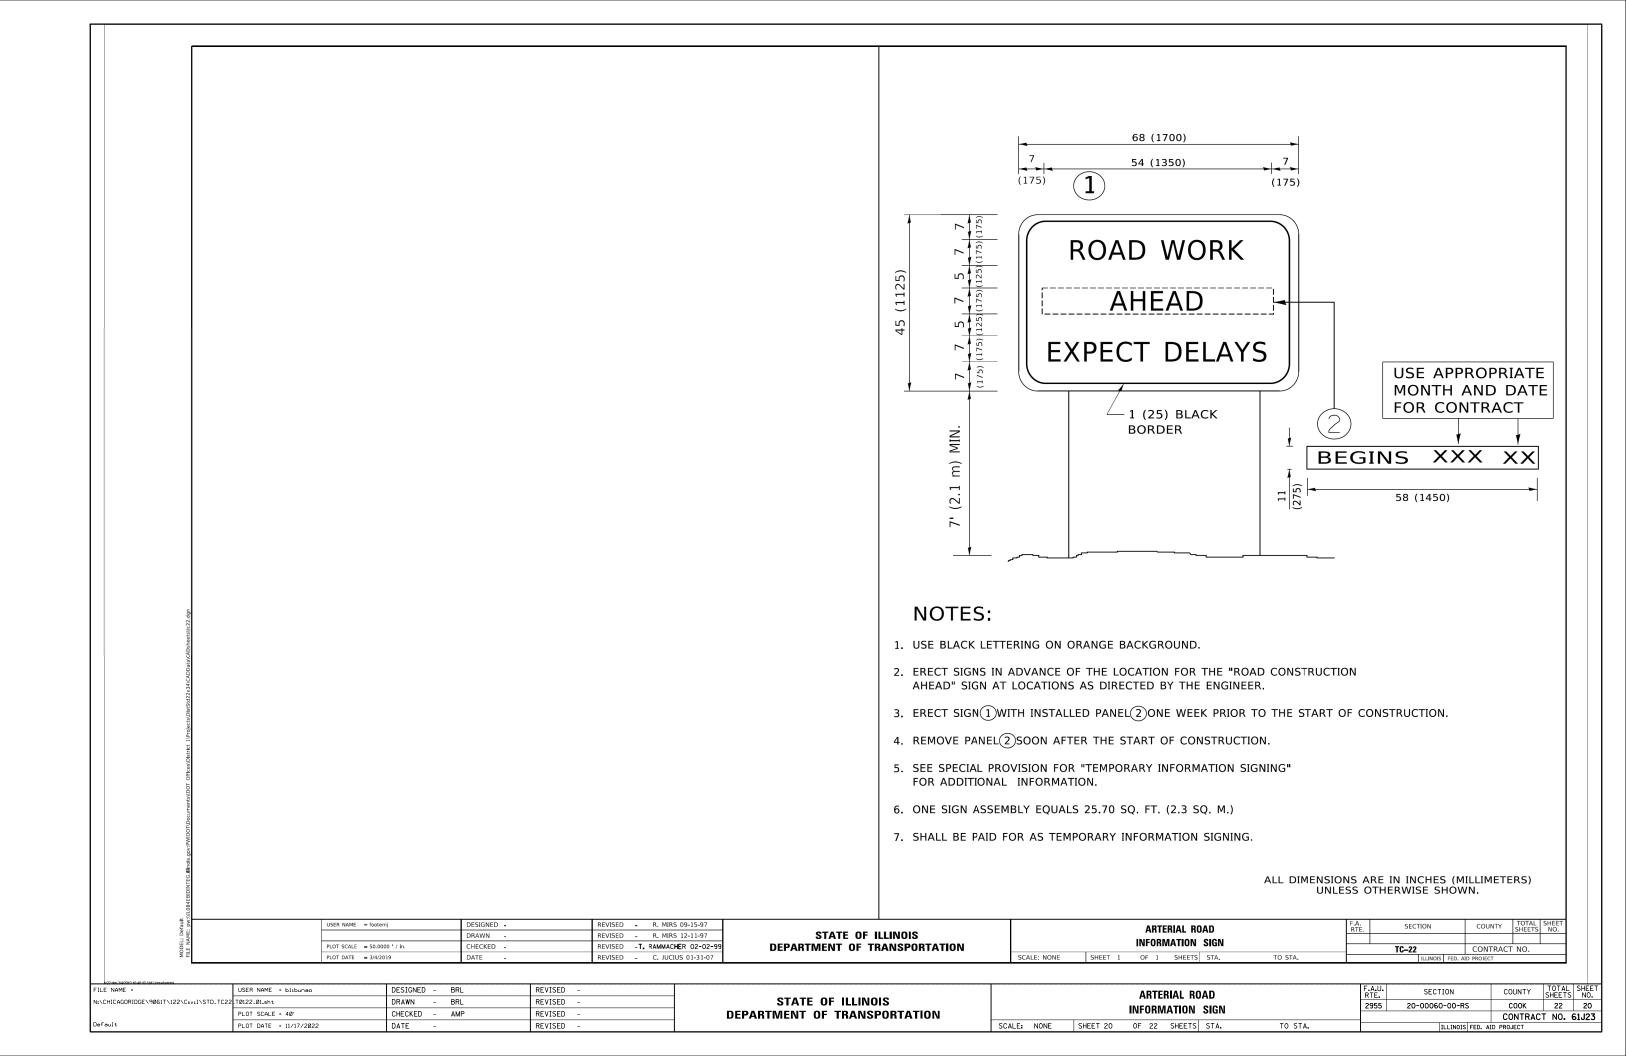

LOOPS NEXT TO SHOULDERS PROVIDE A PAVEMENT REPLACEMENT NOTE WHICH SHOULD EQUAL 3' (900 mm) X WIDTH OF PAVED SHOULDER. NON-PAVED SHOULDER (1.5 m) (1.8 m) (1.5 m) X DUCT-TRENCHED (3.0 m) (3.0 m) TO E/P ** * * LINIT DUCT IS TO BE SHOWN ON PLAN SHEETS BUT SHALL NOT BE INCLUDED IN THE PAY ITEMS ARTERIAL-VOLUME DENSITY ("FAR OUT" DETECTION) CROSS STREET-NON VOLUME DENSITY ("FAR OUT" DETECTION) CALLING LOOP IN RIGHT TURN LANE

CROSS STREET

LOOPS ARE SAW-CUT TO THE EDGE OF PAVEMENT. 1" (25 mm) UNIT

EDGE OF PAVEMENT

OUTSIDE PAVEMENT)

AND HANDHOLE.
(TYP. FOR LOOPS
THAT TERMINATE

IN HANDHOLES

DUCT IS RUN BETWEEN

(600mn

OFF SET LOOPS BY

STRAIGHT SAW CUTS

REVISED -

REVISED


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1' (300mm) FOR

[TYP.-12 (3.6m) LANES]

LEFT TURN LANES WITH MEDIANS VOLUME DENSITY ("FAR OUT" DETECTION) ON SAME APPROACH (PROTECTED / PERMITTED LEFT TURN PHASING)


HANDHOLE LOCATION MAY VARY DEPENDING ON GEOMETRICS AND DESIGN OF TRAFFIC SIGNALS. HEAVY-DUTY HANDHOLES TO BE USED WHEN THE MEDIAN IS MOUNTABLE. REFER TO STANDARD 814001 TO ENSURE THAT HANDHOLE FITS IN MEDIAN.

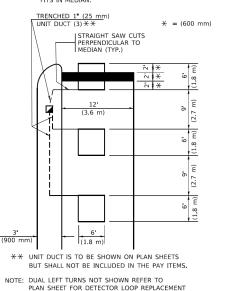

LEFT TURN LANES WITHOUT MEDIANS

VOLUME DENSITY ("FAR OUT" DETECTION) ON SAME APPROACH


(PROTECTED / PERMITTED LEFT TURN PHASING)

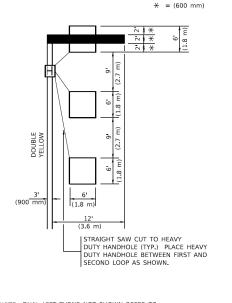

NOTE: DUAL LEFT TURNS NOT SHOWN REFER TO PLAN SHEET FOR DETECTOR LOOP REPLACEMENT

SCALE: NONE

ARTERIAL-VOLUME DENSITY ("FAR OUT" DETECTION) CROSS STREET-NON VOLUME DENSITY ("UPTIGHT" PRESENCE DETECTION)

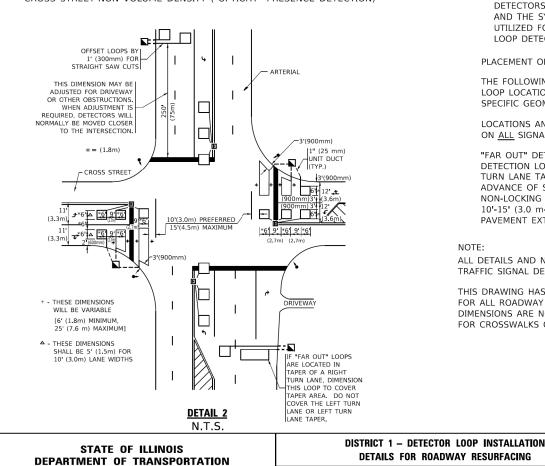

NOTES

VEHICLES LOOP DETECTORS

- * ALL LEAD IN CABLE SHALL BE TWO CONDUCTOR NO. 14 TWISTED, SHIELDED.
- * FACH DETECTOR LOOP SHALL HAVE ITS OWN SAW CUT FROM THE LOOP TO THE EDGE OF PAVEMENT OR TO A HANDHOLE IN THE **PAVEMENT**
- * EACH DETECTOR LOOP SHALL HAVE ITS OWN ONE INCH (25 mm) UNIT DUCT BETWEEN THE EDGE OF PAVEMENT AND THE FIRST HANDHOLE OR JUNCTION BOX. EACH UNIT DUCT RUN SHALL BE SHOWN ON THE PLANS BY THE DESIGNER, BUT SHALL NOT BE PAID FOR SEPARATLY. THIS ITEM IS INCIDENTAL TO THE PAY ITEM FOR DETECTOR LOOPS.
- st ONE DIMENSION OF <u>ALL</u> DETECTOR LOOPS SHALL BE SIX FEET
- st EACH LANE OF NON-LOCKING, PRESENCE DETECTION AND EACH LANE OF A DOUBLE LEFT TURN LANE REQUIRES A SEPARATE INDUCTIVE LOOP DETECTOR AND LEAD IN CABLE.
- * WHEN NON-LOCKING, PRESENCE DETECTION IS USED, MORE THAN ONE LOOP PER LANE IS REQUIRED BEHIND THE STOP BAR (i.e. 1-1/2, 1-3/4, 2).
- st When system loops are required on an approach of an INTERSECTION, THE LOOPS USED FOR VOLUME DENSITY AND INTERSECTION TIMING SHALL ALSO BE USED AS SYSTEM DETECTORS. EACH ONE OF THESE TYPE OF LOOPS REQUIRES A SEPARATE TWO CONDUCTOR NO. 14 TWISTED SHIELDED CABLE AND A SEPARATE INDUCTIVE LOOP DETECTOR WHEN NEW CONTROLLERS ARE UTILIZED. THE DESIGNER SHALL LABEL THESE TYPES OF LOOPS AS "INTERSECTION AND SAMPLING (SYSTEM) DETECTORS" ON THE SIGNAL LAYOUT, THE INTERCONNECT PLAN AND THE SYSTEM CABLE PLAN. WHEN AN EXISTING CONTROLLER IS UTILIZED FOR THIS TYPE OF DETECTION, THE PAY ITEM "INDUCTIVE LOOP DETECTOR WITH SYSTEM OUTPUT" SHOULD BE USED.

PLACEMENT OF DETECTORS

THE FOLLOWING FIGURES REPRESENT THE MOST COMMON DETECTOR LOOP LOCATIONS AND SIZES. ADJUSTMENTS WILL BE NECESSARY FOR SPECIFIC GEOMETRIC CONSIDERATIONS.

LOCATIONS AND DEMENSIONS OF DETECTOR LOOPS ARE REQUIRED ON ALL SIGNAL LAYOUT PLAN SHEETS.

"FAR OUT" DETECTION REFERS TO LOCKING, PRESENCE TYPE DETECTION LOCATED IN THRU LANES, RIGHT TURN LANES, AND RIGHT TURN LANE TAPER AREAS (IF APPLICABLE), USUALLY 250' (75 m) IN ADVANCE OF STOP BARS. "UPTIGHT" DETECTION REFERS TO NON-LOCKING PRESENCE TYPE DETECTION LOCATED IN ALL LANES AND 10'-15' (3.0 m-4.5 m) BEHIND THE CROSSING STREET'S EDGE OF PAVEMENT EXTENDED.

ALL DETAILS AND NOTES SHOWN ARE FROM THE I.D.O.T. DISTRICT 1 TRAFFIC SIGNAL DESIGN GUIDELINES DATED JANUARY 1995

THIS DRAWING HAS BEEN PREPARED TO ASSIST THE RESIDENT ENGINEER FOR ALL ROADWAY RESURFACING OR S.M.A.R.T. PROJECTS WHERE THE DIMENSIONS ARE NOT SHOWN ON THE PLANS AND THE FINAL LOCATIONS FOR CROSSWALKS OR STOP BARS ARE NOT DETERMINED.

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		PLOT SCALE = 40'	CHECKED - AM	IP	REVISED -	
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JSER NAME = footem

PLOT SCALE = 50.0000 ' / ir

STRAIGHT SAW

IN PAVEMENT

(TYP.)

DETAIL 1

N.T.S.

DESIGNED -

HECKED - R.K.F.

DRAWN

CUTS TO HEAVY-DUTY HANDHOLE

STATE OF ILLINOIS **DEPARTMENT OF TRANSPORTATION**

		DISTRICT 1 DETAILS			OP INSTA Resurfa	
SCALE:	NONE	SHEET 21	0F 22	SHEETS	STA.	TO STA.

F.A.U. RTE.	SECTION	COUNTY	TOTAL SHEETS	SHEET NO.
2955	20-00060-00-RS	COOK	22	21
		CONTRAC	T NO. 6	51J23
	TI I TNOTE EED	ATD PROJECT		

CONTRACT NO.

SECTION

TS-07

