

449-MH STA. 1024+50/1.5' LT MANHOLES, TYPE A, 5'-DIA WITH TYPE 20 FRAME AND GRATE H=718.90 INV.=711.10 (E)(W)(S)

450-CB STA. 1024+50/1.5' RT CATCH BASINS, TYPE A, 4'-DIA WITH TYPE 20 FRAME AND GRATE H=718.83 INV.=711.15 (N)

451-MH STA. 1027+00/1.5' LT MANHOLES, TYPE A, 5'-DIA WITH TYPE 20 FRAME AND GRATE H=717.74 INV.=710.35 (E)(W)(S)

452-CB STA. 1027+00/1.5' RT CATCH BASINS, TYPE A, 4'-DIA WITH TYPE 20 FRAME AND GRATE H=717.73 INV.=710.40 (N)


453-MH STA. 1029+00/1.5' LT MANHOLES, TYPE A, 5'-DIA WITH TYPE 20 FRAME AND GRATE H=716.84 INV.=709.75 (E)(W)(S)

454-CB STA. 1029+00/1.5' RT CATCH BASINS, TYPE A, 4'-DIA WITH TYPE 20 FRAME AND GRATE H=716.84 INV.=709.80 (N)

455-MH STA. 1029+43/1.5' LT MANHOLES, TYPE A, 6'-DIA WITH TYPE 20 FRAME AND GRATE H=716.69 INV.=709.62 (W)(N)(S)

456-MH STA. 1030+00/1.5' LT MANHOLES, TYPE A, 4'-DIA WITH TYPE 20 FRAME AND GRATE H=716.44 INV.=709.73 (E)(S)

457-CB STA. 1030+00/1.5' RT CATCH BASINS, TYPE A, 4'-DIA WITH TYPE 20 FRAME AND GRATE H=716.43 INV.=709.78 (N)

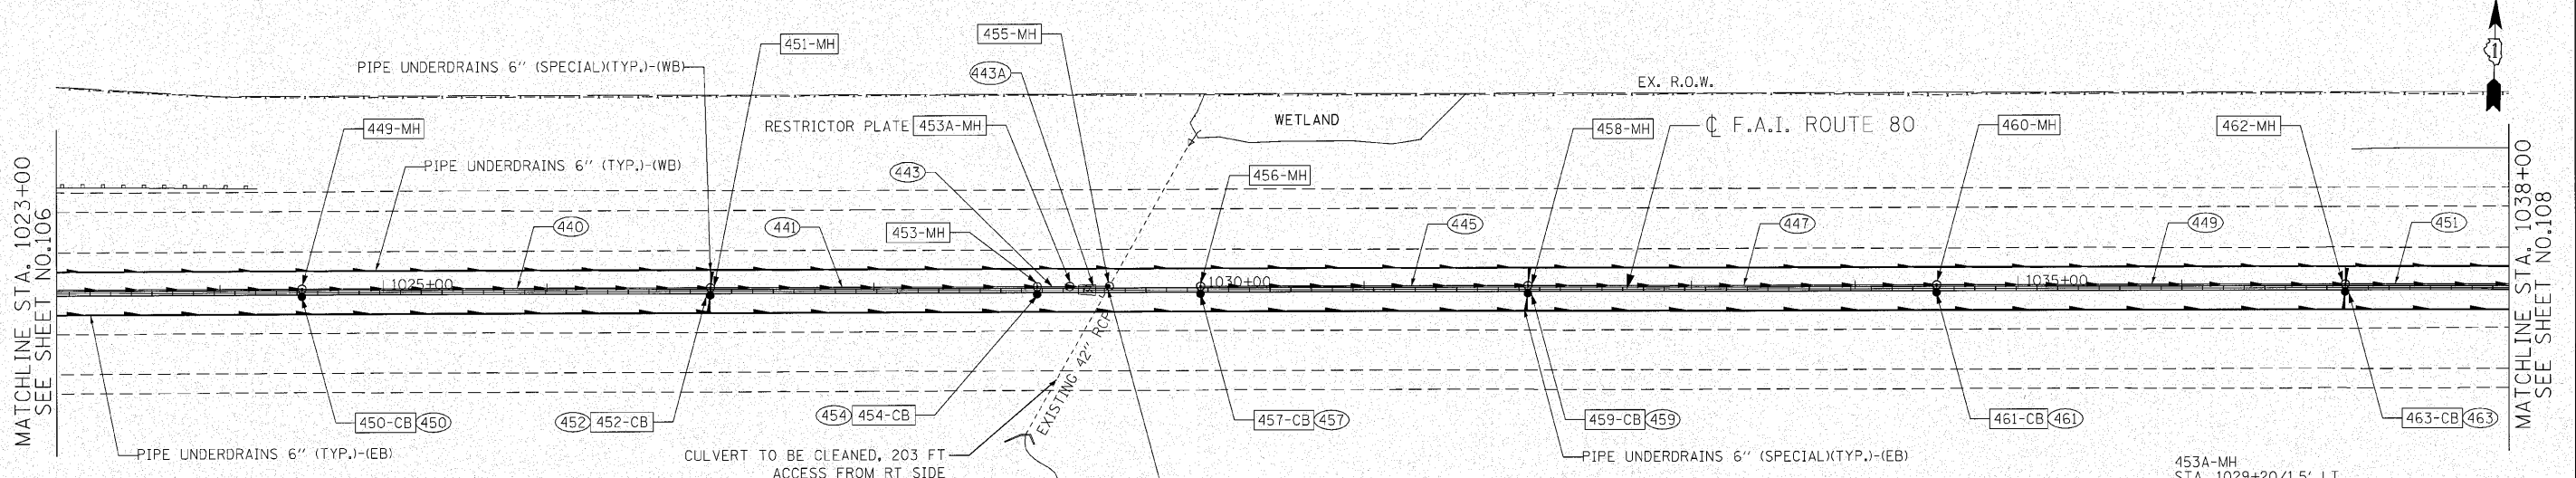

440 STORM SEWERS, CLASS A, TYPE 2, 36" 250' @ 0.30% TBF=182 CY

441 STORM SEWERS, CLASS A, TYPE 2, 36" 200' @ 0.30% TBF=128 CY

443 STORM SEWERS, CLASS A, TYPE 2, 36" 20' @ 0.30% TBF=12 CY

444 STORM SEWERS, CLASS A, TYPE 2, 15" 200' @ 0.30% TBF=75 CY

447 STORM SEWERS, CLASS A, TYPE 2, 18" 250' @ 0.30% TBF=93 CY

449 STORM SEWERS, CLASS A, TYPE 2, 18" 250' @ 0.30% TBF=82 CY

451 STORM SEWERS, CLASS A, TYPE 2, 24" 250' @ 0.30% TBF=201 CY

453A STORM SEWERS, CLASS A, TYPE 2, 36" 23' @ 0.30% TBF=14 CY

455-MH STA. 1032+00/1.5' LT MANHOLES, TYPE A, 4'-DIA WITH TYPE 20 FRAME AND GRATE H=715.51 INV.=708.88 (E) INV.=709.13 (W)(S)


459-CB STA. 1032+00/1.5' RT CATCH BASINS, TYPE A, 4'-DIA WITH TYPE 20 FRAME AND GRATE H=715.56 INV.=709.18 (N)

460-MH STA. 1034+50/1.5' LT MANHOLES, TYPE A, 4'-DIA WITH TYPE 20 FRAME AND GRATE H=714.42 INV.=708.13 (E)(W)(S)

461-CB STA. 1034+50/1.5' RT CATCH BASINS, TYPE A, 4'-DIA WITH TYPE 20 FRAME AND GRATE H=714.43 INV.=708.18 (N)

462-MH STA. 1037+00/1.5' LT MANHOLES, TYPE A, 5'-DIA WITH TYPE 20 FRAME AND GRATE H=713.30 INV.=705.38 (E) INV.=707.38 (W)(S)

463-CB STA. 1037+00/1.5' RT CATCH BASINS, TYPE A, 4'-DIA WITH TYPE 20 FRAME AND GRATE H=713.37 INV.=707.43 (N)

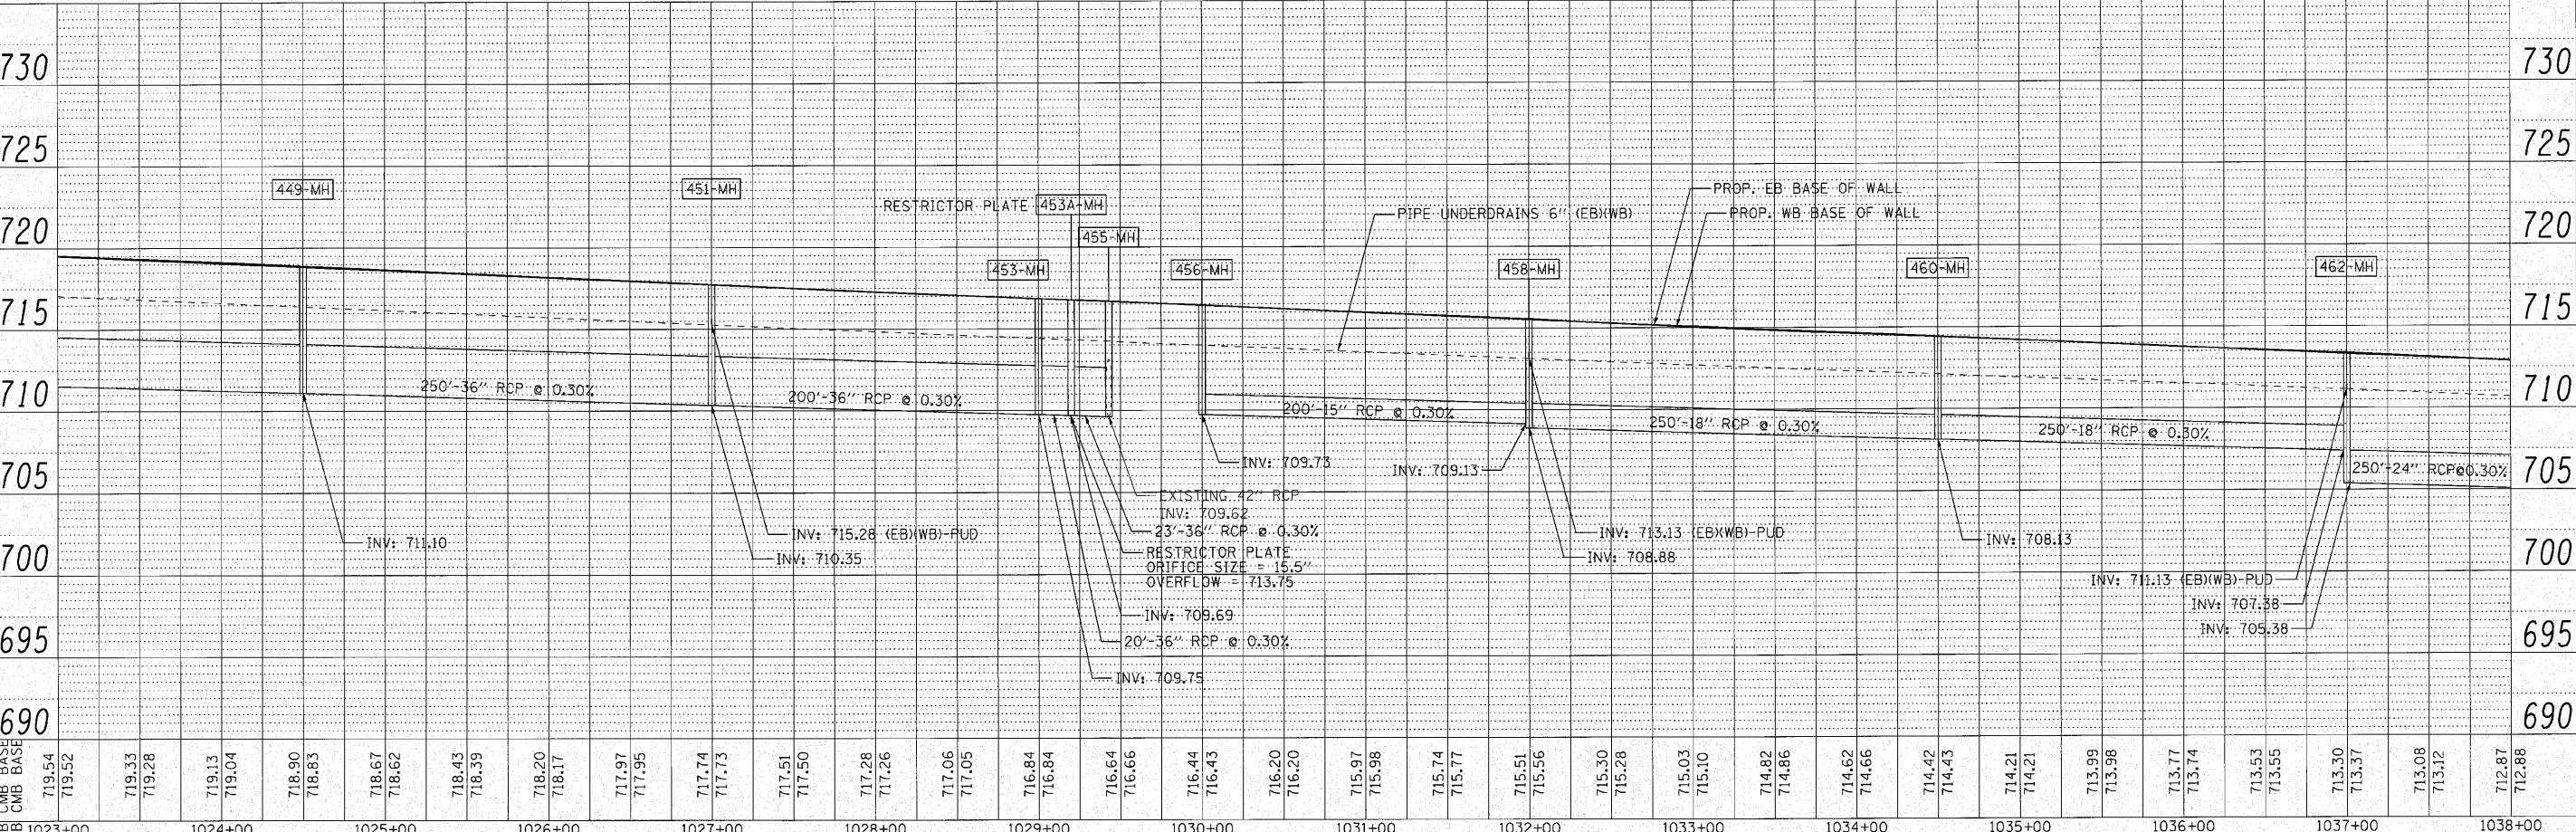

ENGINEERING CONSULTANT	USER NAME = jkjoellman	DESIGNED - CRC	REVISED -	STATE OF ILLINOIS DEPARTMENT OF TRANSPORTATION F.A.I. 80 FROM NS RAILROAD TO US 45 PROPOSED DRAINAGE PLAN AND PROFILE	F.A.I. RTE. 80	SECTION 99(5&S-1) Y-1	COUNTY WILL	TOTAL SHEETS 309	SHEET NO. 107
CONTRACTOR	PLOT SCALE = 50.0000' / IN.	CHECKED - MRJ	REVISED -		SCALE: 1" = 50'	CONTRACT NO. 60M59		ILLINOIS FED. AID PROJECT	
DATE = 10/28/2010		DATE = 10/27/2010	REVISED -		SHEET NO. 107 OF SHEETS		STA. 1023+00 TO STA. 1038+00		



PLAN	REVISIONS	DATE
NO.		

PROFILE	REVISIONS	DATE
NO.		

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 jkjoellman