


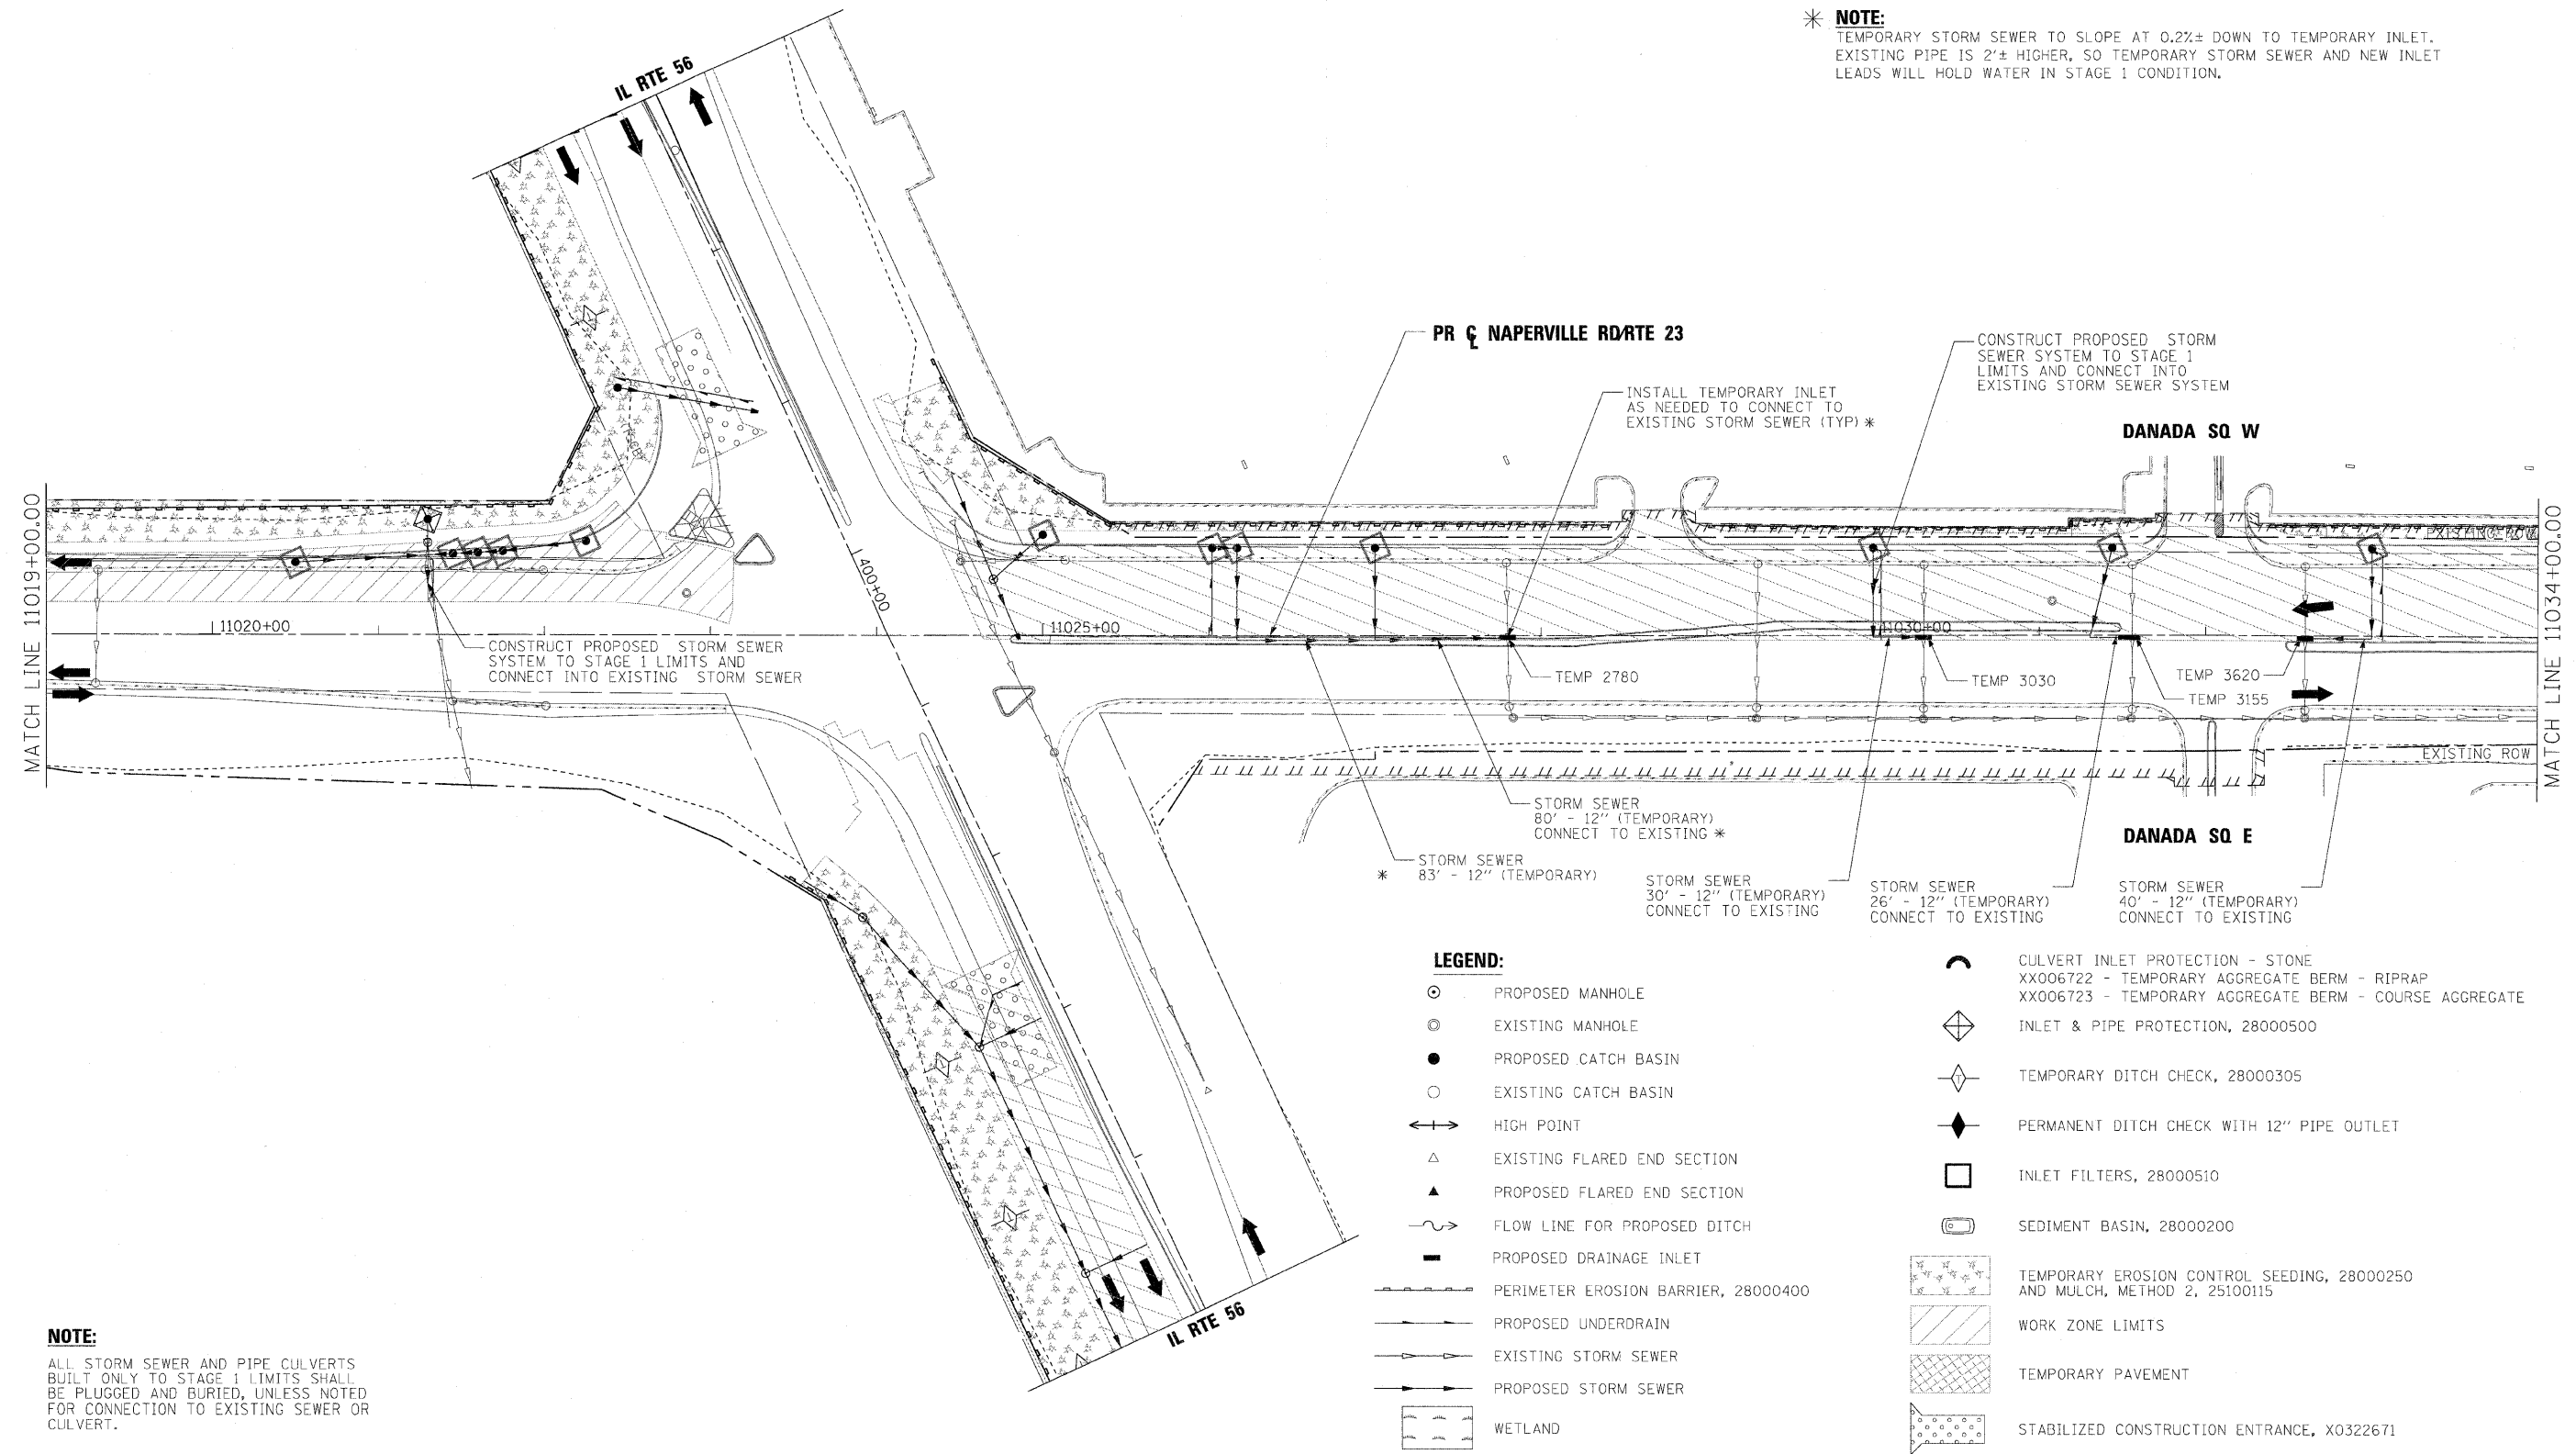

*** NOTE:**
 TEMPORARY STORM SEWER TO SLOPE AT 0.2%± DOWN TO TEMPORARY INLET.
 EXISTING PIPE IS 2'± HIGHER, SO TEMPORARY STORM SEWER AND NEW INLET
 LEADS WILL HOLD WATER IN STAGE 1 CONDITION.



NOTE:
 ALL STORM SEWER AND PIPE CULVERTS
 BUILT ONLY TO STAGE 1 LIMITS SHALL
 BE PLUGGED AND BURIED, UNLESS NOTED
 FOR CONNECTION TO EXISTING SEWER OR
 CULVERT.

- LEGEND:**
- ⊙ PROPOSED MANHOLE
 - ⊙ EXISTING MANHOLE
 - PROPOSED CATCH BASIN
 - EXISTING CATCH BASIN
 - ↔ HIGH POINT
 - △ EXISTING FLARED END SECTION
 - ▲ PROPOSED FLARED END SECTION
 - ~ FLOW LINE FOR PROPOSED DITCH
 - PROPOSED DRAINAGE INLET
 - ▬ PERIMETER EROSION BARRIER, 28000400
 - ▬ PROPOSED UNDERDRAIN
 - ▬ EXISTING STORM SEWER
 - ▬ PROPOSED STORM SEWER
 - ▬ WETLAND
 - ⌒ CULVERT INLET PROTECTION - STONE
 - XX006722 - TEMPORARY AGGREGATE BERM - RIPRAP
 - XX006723 - TEMPORARY AGGREGATE BERM - COURSE AGGREGATE
 - ◇ INLET & PIPE PROTECTION, 28000500
 - ◇ TEMPORARY DITCH CHECK, 28000305
 - ◆ PERMANENT DITCH CHECK WITH 12" PIPE OUTLET
 - INLET FILTERS, 28000510
 - ⊕ SEDIMENT BASIN, 28000200
 - TEMPORARY EROSION CONTROL SEEDING, 28000250 AND MULCH, METHOD 2, 25100115
 - WORK ZONE LIMITS
 - TEMPORARY PAVEMENT
 - STABILIZED CONSTRUCTION ENTRANCE, X0322671

FILE NAME =	DESIGNED - AAF	REVISED -	benesch	STATE OF ILLINOIS DEPARTMENT OF TRANSPORTATION	TEMPORARY DRAINAGE AND EROSION CONTROL PLANS STAGE 1			F.A.P. RTE.	SECTION	COUNTY	TOTAL SHEETS	SHEET NO.
...ND162419-sh1-EC-18-MAP_staging1-1-19.dgn	DRAWN - TMB	REVISED -						365	(57 & 58)WRS-2	DUPAGE	681	221
USER NAME = tblank	CHECKED - RMT	REVISED -						CONTRACT NO. 62419				
PLOT DATE = 12/7/2010	DATE - 12/6/10	REVISED -						ILLINOIS FED. AID PROJECT				
			SCALE: 1"=50'			SHEET NO. 17 OF 36 SHEETS		STA. 11019+00 TO STA. 11034+00				