


\* **NOTE:**  
 TEMPORARY STORM SEWER TO SLOPE AT 0.2%± DOWN TO TEMPORARY INLET.  
 EXISTING PIPE IS 2'± HIGHER, SO TEMPORARY STORM SEWER AND NEW INLET  
 LEADS WILL HOLD WATER IN STAGE 1 CONDITION.

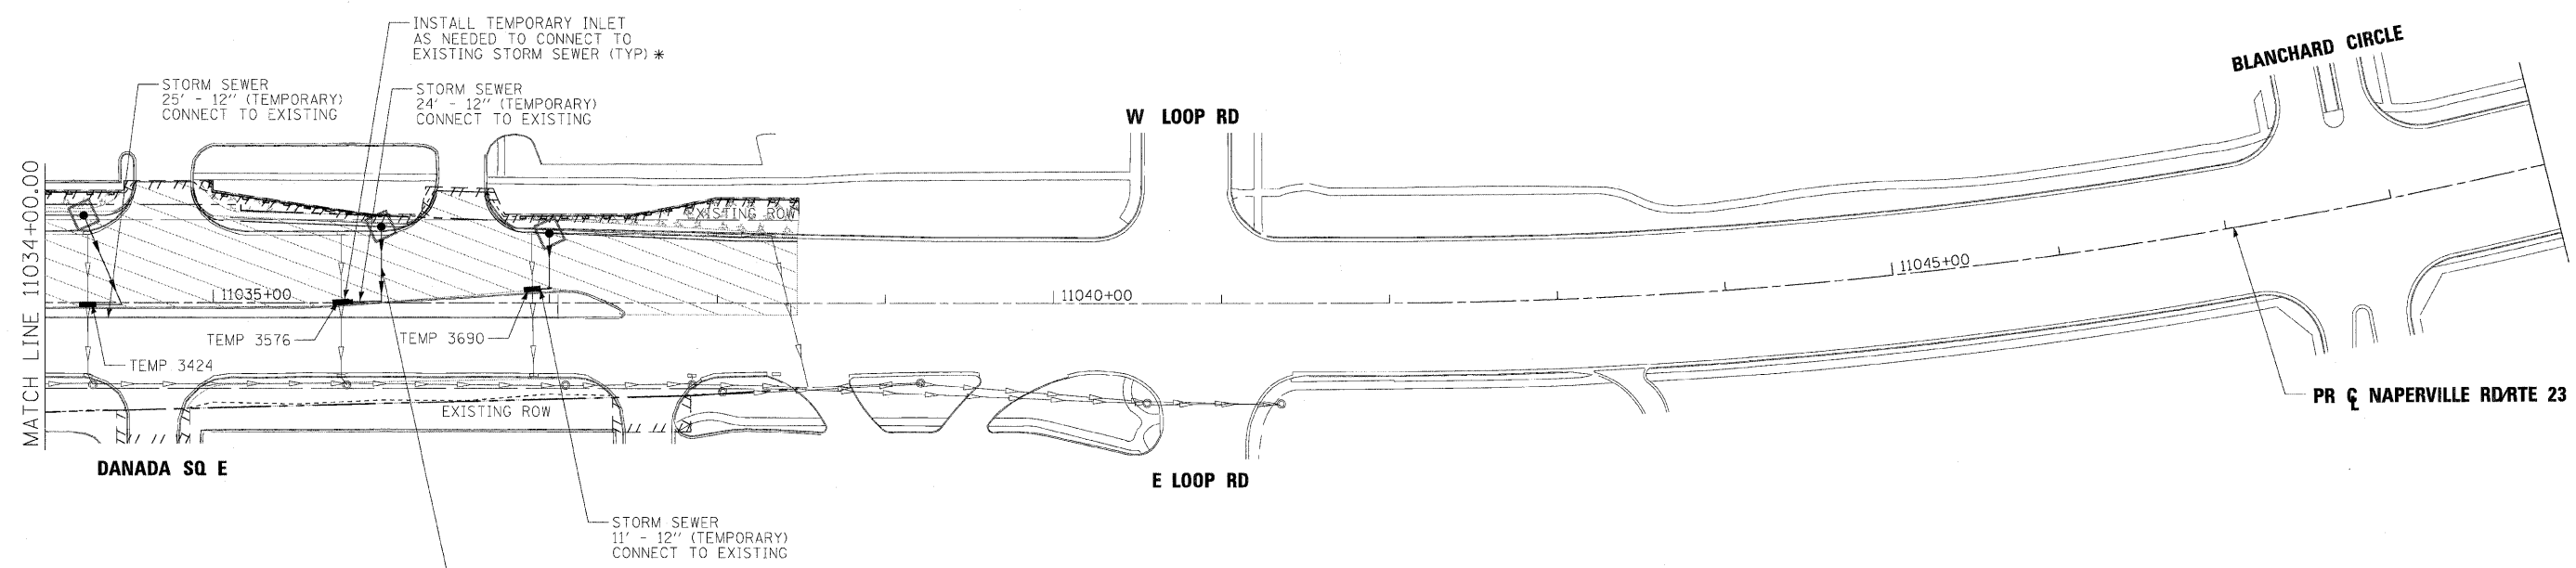

**NOTE:**  
 ALL STORM SEWER AND PIPE CULVERTS  
 BUILT ONLY TO STAGE 1 LIMITS SHALL  
 BE PLUGGED AND BURIED, UNLESS NOTED  
 FOR CONNECTION TO EXISTING SEWER OR  
 CULVERT.

- LEGEND:**
- ⊙ PROPOSED MANHOLE
  - ⊙ EXISTING MANHOLE
  - PROPOSED CATCH BASIN
  - EXISTING CATCH BASIN
  - ↔ HIGH POINT
  - △ EXISTING FLARED END SECTION
  - ▲ PROPOSED FLARED END SECTION
  - ~ FLOW LINE FOR PROPOSED DITCH
  - PROPOSED DRAINAGE INLET
  - PERIMETER EROSION BARRIER, 28000400
  - PROPOSED UNDERDRAIN
  - EXISTING STORM SEWER
  - PROPOSED STORM SEWER
  - WETLAND
  - ⤵ CULVERT INLET PROTECTION - STONE
  - XX006722 - TEMPORARY AGGREGATE BERM - RIPRAP
  - XX006723 - TEMPORARY AGGREGATE BERM - COURSE AGGREGATE
  - ◇ INLET & PIPE PROTECTION, 28000500
  - ◇ TEMPORARY DITCH CHECK, 28000305
  - ◆ PERMANENT DITCH CHECK WITH 12" PIPE OUTLET
  - INLET FILTERS, 28000510
  - ⊞ SEDIMENT BASIN, 28000200
  - TEMPORARY EROSION CONTROL SEEDING, 28000250 AND MULCH, METHOD 2, 25100115
  - WORK ZONE LIMITS
  - TEMPORARY PAVEMENT
  - STABILIZED CONSTRUCTION ENTRANCE, X0322671

FILE NAME =	DESIGNED - AAF	REVISED -
...ND162419-sh-EC-19-NAP.staging1-1-22.dgn	DRAWN - TMB	REVISED -
USER NAME = tblank	CHECKED - RMT	REVISED -
PLOT DATE = 12/7/20:0	DATE - 12/6/10	REVISED -

**benesch**

**STATE OF ILLINOIS  
 DEPARTMENT OF TRANSPORTATION**

**TEMPORARY DRAINAGE AND EROSION CONTROL PLANS  
 STAGE 1**

F.A.P. RTE.	SECTION	COUNTY	TOTAL SHEETS	SHEET NO.
365	(57 & 58)WRS-2	DUPAGE	681	222
CONTRACT NO. 62419				
ILLINOIS FED. AID PROJECT				

SCALE: 1"=50' SHEET NO.18 OF 36 SHEETS STA. TO STA.