INDEX OF SHEETS FOR INDEX OF SHEETS, SEE SHEET NO. 2

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STATE OF ILLINOIS

DEPARTMENT OF TRANSPORTATION **DIVISION OF HIGHWAYS**

PLANS FOR PROPOSED FEDERAL AID HIGHWAY


FAP ROUTE 344 (IL ROUTE 83 - BUSSE ROAD) AT PRATT BOULEVARD SECTION 09-00057-00-CH PROJECT M-9003(660) ROADWAY RECONSTRUCTION AND TRAFFIC SIGNAL MODERNIZATION VILLAGE OF ELK GROVE VILLAGE **COOK COUNTY**

DESIGN SPEED: IL ROUTE 83 - 50 MPH PRATT BOULEVARD - 35 MPH

POSTED SPEED: IL ROUTE 83 - 45 MPH PRATT BOULEVARD - 30 MPH

DESIGN DESIGNATIONS:

IL ROUTE 83 - 53,000 (2030) ARTERIAL 10.11 (HMA OVERLAY-15) PRATT BOULEVARD - 9,000 (2030) COLLECTOR 5.08 (PCC-20)

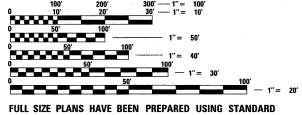

ENGINEERING SCALES. REDUCED SIZED PLANS WILL NOT CONFORM TO STANDARD SCALES. IN MAKING MEASUREMENTS ON REDUCED PLANS, THE ABOVE SCALES MAY BE USED.

RIDDLE, P.E. CIVILTECH

CHARLES I

OFFICE ENGINEER: ENGINEER: DAVID

JOINT UTILITY LOCATION INFORMATION FOR EXCAVATION 1-800-892-0123 OR 811

CONTRACT NO. 63523

IMPROVEMENT BEGINS STA. 401+27.62 PRATT BOULEVARD

IL ROUTE 83 - 1,155.43 FT. (0.219 MILE) (NET AND GROSS) PRATT BOULEVARD- 1,441.20 FT. (0.273 MILE) (NET AND GROSS)

NOT TO SCALE

NOVEMBER 4 HOLA CHRISTONIAN OF LOCAL ROADS & STREETS RELEASING FOR BID PRINTED BY THE AUTHORITY OF THE STATE OF ILLINOIS

450 E. Devon Ave, Suite 300 - Itasca, Illinois 60143 Tel: 630.773.3900 - Fax: 630.773.3975 www.civiltechinc.com

LOCATION MAP

EXPIRES 11-30-2011 DATE 10-21-10 FOR DRAWINGS 1-51, 70-103

Jarvis Ave Estes Ave Arthur Ave

IMPROVEMENT ENDS STA. 82+50.53 **ILLINOIS ROUTE 83**

> IMPROVEMENT ENDS STA. 415+68.82 PRATT BOULEVARD

IMPROVEMENT BEGINS STA. 70+95.10 ILLINOIS ROUTE 83

3RD P.M., ELK GROVE TOWNSHIP

PROJECT LENGTH:

TOTAL - 2.596.63 FT (0.492 MILE) (NET AND GROSS)

C-91-617-10

Louis Ave

COOK

ILLINOIS CONTRACT NO. 63523

103

SECTION

09-00057-00-CH

LOCATION OF SECTION INDICATED THUS: -

STATE OF ILLINOIS DEPARTMENT OF TRANSPORTATION DIVISION OF HIGHWAYS

APPROVED OCTOBER



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FILE NAME =

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ISER NAME = jat

PLOT SCALE = 50.0000 '/ IN

PLOT DATE = 10/21/2010

- 878001-08 CONCRETE FOUNDATION DETAILS
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DESIGNED - JAT

JAT

DJK

10-22-10

DRAWN

CHECKED

REVISED

REVISED

REVISED

REVISED

- DETECTOR LOOP INSTALLATIONS 886001-01
- TYPICAL LAYOUTS FOR DETECTION LOOPS 886006-01

SPECIFICATIONS, STANDARDS AND SPECIAL PROVISIONS

- ALL CONSTRUCTION SHALL BE IN ACCORDANCE WITH THE "STANDARD SPECIFICATIONS FOR ROAD AND BRIDGE CONSTRUCTION" ("STANDARD SPECIFICATIONS"), ADOPTED JANUARY 1, 2007; THE "SUPPLEMENTAL SPECIFICATIONS AND RECURRING SPECIAL PROVISIONS", ADOPTED JANUARY 1, 2011; THE LATEST EDITION OF THE "ILLINOIS MANUAL ON UNIFORM TRAFFIC CONTROL DEVICES FOR STREETS AND HIGHWAYS", (IMUTCD); "THE STANDARD SPECIFICATIONS FOR WATER AND SEWER MAIN CONSTRUCTION IN ILLINOIS" JULY 2009 SIXTH EDITION, THE DETAILS IN THE PLANS, AND THE SPECIAL PROVISIONS AND IDOT STANDARD DRAWINGS INCLUDED IN THE
- 2. NO WORK SHALL COMMENCE UNTIL TRAFFIC CONTROL REQUIREMENTS ARE MET AND APPROPRIATE
- THE ENGINEER AND ALL UTILITY COMPANIES, SCHOOL DISTRICTS, AND LOCAL POLICE AND FIRE DEPARTMENTS HALL BE NOTIFIED BY THE CONTRACTOR AT LEAST 72 HOURS PRIOR TO THE START OF CONSTRUCTION.
- 4. IT SHALL BE THE CONTRACTOR'S RESPONSIBILITY TO VERIFY ALL DIMENSIONS AND CONDITIONS EXISTING IN THE FIELD PRIOR TO ORDERING MATERIALS AND BEGINNING CONSTRUCTION
- 5. WHEN REMOVING CURB AND GUTTER, PAVEMENT OR ANY OTHER STRUCTURE, THE CONTRACTOR SHALL TAKE PRECAUTIONS NECESSARY TO AVOID DAMAGE TO UNDERGROUND PUBLIC OR PRIVATE UTILITIES IN ACCORDANCE WITH ARTICLES 105.07, 107.20, AND 107.31. UNDER NO CIRCUMSTANCES WILL THE USE OF A FROST BALL CONCRETE
- THE CONTRACTOR IS PROHIBITED FROM BURNING ANY MATERIAL WITHIN OR ADJACENT TO THE PROJECT LIMITS. ALL EXCESS OR WASTE MATERIAL SHALL BE EITHER HAULED AWAY FROM THE PROJECT SITE BY THE CONTRACTOR AND DEPOSITED AT LOCATIONS PROVIDED BY HIM, OR DISPOSED OF WITHIN THE RIGHT-OF-WAY IN A MANNER OTHER THAN BURNING, SUBJECT TO THE APPROVAL OF THE ENGINEER. NO EXTRA COMPENSATION WILL BE ALLOWED THE CONTRACTOR FOR ANY EXPENSE INCURRED BY COMPLYING WITH THE REQUIREMENTS OF THIS NOTE.

PAVING, SHOULDERS, CURB & GUTTER AND SIDEWALK

THE CONTRACTOR SHALL SAW CUT PAVEMENT, CURB & GUTTER, MEDIAN, SHOULDER, AND SIDEWALK AS INDICATED ON THE PLANS TO SEPARATE THE EXISTING MATERIAL TO BE REMOVED BY MEANS OF AN APPROVED CONCRETE SAW TO A DEPTH AS SHOWN ON THE PLANS OR AS DIRECTED BY THE ENGINEER. THIS WORK SHALL BE INCLUDED IN THE COST OF THE ITEM BEING REMOVED.

THE CONTRACTOR SHALL BE REQUIRED TO SAW VERTICAL CUTS SO AS TO FORM CLEAN VERTICAL JOINTS. SHOULD THE CONTRACTOR DEFACE ANY EDGE, A NEW SAWED JOINT SHALL BE PROVIDED AND ANY ADDITIONAL WORK, INCLUDING REMOVAL AND REPLACEMENT, SHALL BE DONE AT THE CONTRACTOR'S EXPENSE.

- REMOVAL OF ALL REINFORCEMENT WITHIN THE EXISTING PAVEMENT SHALL BE INCLUDED IN THE COST OF "PAVEMENT REMOVAL".
- HOT-MIX ASPHALT BINDER COURSE SHALL NOT BE PLACED ADJACENT TO CURB AND GUTTER UNTIL THE CURB AND GUTTER HAS BEEN PROPERLY CURED AND BACKFILLED TO THE SATISFACTION OF THE ENGINEER.
- 4. HOT-MIX ASPHALT SURFACE COURSE SHALL NOT BE PLACED UNTIL ALL EARTH EXCAVATION, TOPSOIL PLACEMENT, AND HOT-MIX ASPHALT BINDER COURSE HAVE BEEN COMPLETED TO
- THE THICKNESSES OF HOT-MIX ASPHALT MIXTURES SHOWN ON THE PLANS ARE NOMINAL. DEVIATIONS MAY OCCUR DUE TO IRREGULARITIES IN THE SURFACE, BINDER, OR BASE UPON WHICH THE HOT-MIX ASPHALT
- ALL RAISED REFLECTIVE PAVEMENT MARKERS IN THE RESURFACING AREA SHALL BE REMOVED PRIOR TO MILLING AND REPLACED WHEN PAVING IS COMPLETE. THE REMOVAL OF ALL RAISED REFLECTIVE PAVEMENT MARKERS SHALL BE PAID FOR AS "RAISED REFLECTIVE PAVEMENT MARKER REMOVAL".
- ALL SIDEWALK CONSTRUCTED OVER A UTILITY TRENCH SHALL BE REINFORCED WITH THREE #4 REBARS WHICH EXTEND 5 FEET BEYOND THE TRENCH WALLS. AT LOCATIONS WHERE THE SIDEWALK IS ADJACENT TO THE BACK OF CURB. A 1" PREFORMED EXPANSION JOINT FILLER SHALL BE INSTALLED BETWEEN THE CURB AND SIDEWALK. THIS WORK SHALL BE INCLUDED IN THE COST OF "PCC SIDEWALK 5 INCH".
- ALL FORMS USED FOR SIDEWALK SHALL BE 2" X 6" LUMBER, 2" X 8" LUMBER, OR APPROVED METAL FORMS, AND ALL FORMS USED FOR DRIVEWAY PAVEMENT SHALL BE 2" X 8" LUMBER OR APPROVED METAL FORMS, EXCEPT WITHIN AREAS WITH RADII WHEN 1" X 6" FORMS SHALL BE UTILIZED. THE ENGINEER MUST INSPECT AND APPROVE THE BASE AND FORMWORK BEFORE ANY CONCRETE IS POURED. A MINIMUM 24 HOUR NOTICE SHALL BE PROVIDED FOR FORM WORK INSPECTION. THIS WORK SHALL BE INCLUDED IN THE COST OF THE SIDEWALK OR DRIVEWAY PAVEMENT BEING CONSTRUCTED.
- THE EXISTING CURB AND GUTTER SHALL BE SAW CUT AT EACH LIMIT OF REMOVAL AND THE NEW CURB AND GUTTER SHALL BE TIED IN TO THE EXISTING WITH TWO 1/4 INCH STEEL DOWEL BARS (18" LONG) DRILLED INTO THE EXISTING CURB AND GUTTER END. THE ENGINEER MUST INSPECT AND APPROVE THE BASE AND FORMWORK BEFORE ANY CONCRETE IS POURED. A MINIMUM 24 HOUR NOTICE SHALL BE PROVIDED FOR FORM WORK INSPECTION. THIS WORK SHALL BE INCLUDED IN THE COST OF THE CURB AND GUTTER BEING

TREE REMOVAL, CLEARING AND HEDGE REMOVAL

- THE CONTRACTOR'S ATTENTION IS CALLED TO THE FACT THAT THE PRESERVATION OF EXISTING TREES IS OF THE UTMOST IMPORTANCE TO THE VILLAGE. ALL TREE PROTECTION, TREE REMOVAL, TREE PRUNING AND ROOT PRUNING SHALL BE COMPLETED BEFORE CONSTRUCTION OPERATIONS COMMENCE IN ANY AREA. AT NO TIME SHALL THE CONTRACTOR PRUNE OR REMOVE ANY TREES UNLESS SPECIFICALLY DIRECTED BY THE ENGINEER.
- TEMPORARY FENCE SHALL BE ERECTED ALONG THE DRIP LINE OF EXISTING TREES TO REMAIN WHEN DIRECTED BY THE ENGINEER. AFTER TREES ARE SAFELY FENCED NOTHING IS TO BE STORED, DRIVEN, OR DISTURBED INSIDE THE FENCE. REMOVE PROTECTIVE TEMPORARY FENCE ONLY AFTER ALL CONSTRUCTION WORK HAS BEEN COMPLETED.

ROADWAY EXCAVATION

- POROUS GRANULAR EMBANKMENT, SUBGRADE (PGES) HAS BEEN INCLUDED IN THE CONTRACT TO REPLACE SOILS WHICH TEND TO BE UNSTABLE WHEN WET. THE ACTUAL NEED FOR REMOVAL AND REPLACEMENT WITH PGES WILL BE DETERMINED IN THE FIELD AT THE TIME OF CONSTRUCTION BY THE ENGINEER. IF UNSUITABLE SOILS ARE ENCOUNTERED THE SOILS SHALL BE REMOVED AND REPLACED WITH PGES. THESE LIMITS MAY BE ALTERED BY THE ENGINEER IF FIELD CONDITIONS SO WARRANT. REMOVAL OF THESE UNSUITABLE SOILS SHALL BE PAID FOR AS "REMOVAL AND DISPOSAL OF UNSUITABLE MATERIAL."
- THE QUANTITIES OF FURNISHED EXCAVATION HAVE BEEN CALCULATED ASSUMING THAT ALL MATERIAL THE QUANTITIES OF FORNISHED EXCAVATION HAVE BEEN CALCULATED ASSUMING THAT ALL MATERIAL EXCAVATED UNDER THE PAY ITEM EARTH EXCAVATION WILL BE REMOVED FROM THE JOB SITE. IF THE CONTRACTOR EXCAVATES SUITABLE MATERIAL AND PLACES IT IN AREAS OF THE PROJECT REQUIRING EMBANKMENT UNDER THE PAY ITEM EARTH EXCAVATION, AS DESCRIBED IN SECTION 202 OF THE STANDARD SPECIFICATIONS AND AS APPROVED BY THE ENGINEER, THE APPLICABLE DEDUCTION TO THE FURNISHED EXCAVATION QUANTITY SHALL BE MADE AS DEFINED BY ARTICLE 204.07(B), EXCEPT THAT A SHRINKAGE FACTOR OF 15% SHALL BE USED. THE CONTRACTOR SHALL NOT BE ALLOWED A CHANGE IN THE UNIT PRICES FOR EARTH EXCAVATION OR FURNISHED EXCAVATION BASED ON THESE CHANGES TO THE QUANTITIES. THE VOLUMES OF FURNISHED EXCAVATION SHOWN ON THE PLANS ARE THE COMPACTED VOLUMES. THE VOLUMES SHOWN ON THE PLANS HAVE NOT BEEN ADJUSTED TO ACCOUNT FOR SHRINKAGE DUE TO COMPACTION.
- USE OF CCDD FILL OPERATIONS IF THE CONTRACTOR CHOOSES TO DISPOSE OF UNCONTAMINATED SOIL OR UNCONTAMINATED SOIL MIXED WITH CLEAN CONSTRUCTION AND DEMOLITION DEBRIS (CCDD) AT A CCDD FILL OPERATION, IT SHALL BE THE CONTRACTOR'S RESPONSIBILITY TO PERFORM ALL NECESSARY FIELD AND LABORATORY ANALYSIS AND TO OBTAIN THE LICENSED PROFESSIONAL ENGINEER'S CERTIFICATION REQUIRED AS PER PUBLIC ACT 96-1416 TO USE THE SITE. NO ADDITIONAL COMPENSATION WILL BE PROVIDED.

UTILITIES

- THE CONTRACTOR SHALL COORDINATE CONSTRUCTION ACTIVITIES WITH UTILITY COMPANIES. THE LOCATION OF PUBLIC OR PRIVATE UTILITIES SHOWN ON THE PLANS ARE APPROXIMATE AND THE ENGINEER DOES NOT GUARANTEE THEIR ACCURACY.
- COORDINATION OF ANY UTILITY WORK INVOLVED IN THE CONSTRUCTION AREA WILL BE DISCUSSED AT THE PRECONSTRUCTION CONFERENCE.
- BEFORE STARTING ANY EXCAVATION, THE CONTRACTOR SHALL CALL "JULIE" AT 1-800-892-0123 FOR FIELD LOCATIONS OF BURIED ELECTRIC, TELEPHONE, GAS, WATER, SEWER AND CABLE TELEVISION FACILITIES. (48 HOURS NOTIFICATION IS REQUIRED.)
- WHENEVER DURING CONSTRUCTION OPERATIONS ANY LOOSE MATERIAL IS DEPOSITED IN THE FLOW LINE OF DRAINAGE STRUCTURES SUCH THAT THE NATURAL FLOW OF WATER IS OBSTRUCTED, IT SHALL BE REMOVED AT THE CLOSE OF EACH WORKING DAY. AT THE CONCLUSION OF CONSTRUCTION OPERATIONS, ALL UTILITY STRUCTURES SHALL BE FREE FROM DIRT AND DEBRIS. THE COST OF ALL MATERIALS REQUIRED AND ALL LABOR NECESSARY TO COMPLY WITH THE ABOVE PROVISIONS WILL NOT BE PAID FOR SEPARATELY, BUT SHALL BE CONSIDERED AS INCLUDED IN THE COST OF THE STORM SEWERS AND DRAINAGE STRUCTURES INSTALLED AS PART OF THIS PROJECT.
- ANY EXISTING OR PROPOSED SEWER DAMAGED BY THE CONTRACTOR DURING CONSTRUCTION SHALL BE REPLACED BY THE CONTRACTOR TO THE SATISFACTION OF THE ENGINEER AT NO COST TO THE DEPARTMENT, IN ACCORDANCE WITH ARTICLES 105.07, 107.20, AND 107.31,
- THE CONTRACTOR SHALL RECEIVE NO ADDITIONAL COMPENSATION FOR CONSTRUCTION STAGING NECESSARY TO ACCOMMODATE UTILITY RELOCATION OR ADJUSTMENT CAUSED BY UTILITY RELOCATION OR ADJUSTMENT.
- THE CONTRACTOR SHALL FURNISH ALL LABOR. EQUIPMENT AND MATERIAL NECESSARY FOR DEWATERING TRENCH EXCAVATIONS AS WELL AS SHORING TRENCH WALLS DURING UTILITY OPERATIONS. THE COST TO COMPLY WITH THE ABOVE SHALL BE INCLUDED IN THE COST OF THE STORM SEWERS AND DRAINAGE STRUCTURES INSTALLED AS PART OF THIS PROJECT.
- SANITARY SEWER REQUIRED FOR THE ITEM "ADJUSTING SANITARY SEWERS, 8-INCH DIAMETER OR LESS" SHALL MEET THE FOLLOWING MATERIAL REQUIREMENTS: PIPE SHALL BE PVC PLASTIC PIPE. ALL PIPE AND FITTINGS SHALL CONFORM TO ASTM D3034 SDR 26 PS=115. THE SDR SHALL BE 26 AS A MINIMUM. ALL PIPE SHALL BE MADE FROM QUALITY PVC RESIN, COMPOUNDED TO PROVIDE PHYSICAL AND MECHANICAL PROPERTIES THAT EQUAL OR EXCEED CELL CLASS 12454 AS DEFINED

	OFFICE AND THE STATE OF THE STA	F.A.P. RTE.	SECTION	COUNTY	TOTAL	SHEET NO.
STATE OF ILLINOIS DEPARTMENT OF TRANSPORTATION	GENERAL NOTES	334	09-00057-00-CH	соок	103	2
DEPARTMENT OF TRANSPORTATION	SHEET NO. 1 OF 2 SHEETS		DAD DIST. NO. 1 ILLINOIS FED. A	CONTRAC	T NO. 6	63523

STORM & SANITARY SEWER

- THE COST OF MAKING SEWER CONNECTIONS TO EXISTING OR PROPOSED SEWER OR DRAINAGE STRUCTURES SHALL BE INCLUDED IN THE COST OF THE SEWER OR STRUCTURE BEING CONSTRUCTED.
- 2. UNLESS OTHERWISE NOTED ON THE PLANS, THE EXISTING DRAINAGE FACILITIES SHALL REMAIN IN USE DURING THE PERIOD OF CONSTRUCTION. LOCATIONS OF EXISTING DRAINAGE STRUCTURES AND SEWERS AS SHOWN ON THE PLANS ARE APPROXIMATE. PRIOR TO COMMENCING WORK THE CONTRACTOR, AT HIS OWN EXPENSE, SHALL DETERMINE THE EXACT LOCATIONS OF EXISTING STRUCTURES WHICH ARE WITHIN THE PROPOSED CONSTRUCTION

DURING CONSTRUCTION, IF THE CONTRACTOR ENCOUNTERS OR OTHERWISE BECOMES AWARE OF ANY SEWERS, UNDERDRAINS OR FIELD DRAINS WITHIN THE RIGHT-OF-WAY OTHER THAN THOSE SHOWN ON THE PLANS, HE SHALL SO INFORM THE ENGINEER, WHO SHALL DIRECT THE WORK NECESSARY TO MAINTAIN OR REPLACE THE FACILITIES IN SERVICE AND TO PROTECT THEM FROM DAMAGE DURING CONSTRUCTION IF MAINTAINED. EXISTING FACILITIES TO BE MAINTAINED THAT ARE DAMAGED BECAUSE OF THE NON-COMPLIANCE WITH THIS PROVISION SHALL BE REPLACED AT THE CONTRACTOR'S OWN EXPENSE. SHOULD THE ENGINEER HAVE DIRECTED THE REPLACEMENT OF A FACILITY, THE NECESSARY WORK AND PAYMENT SHALL BE IN ACCORDANCE WITH SECTIONS 550 AND 601, AND ARTICLE 104.02 OF THE STANDARD SPECIFICATIONS.

- 3. WHEN EXISTING DRAINAGE FACILITIES ARE DISTURBED, THE CONTRACTOR SHALL PROVIDE AND MAINTAIN TEMPORARY OUTLETS AND CONNECTIONS FOR ALL PRIVATE OR PUBLIC DRAINS, SEWERS OR CATCH BASINS. THE CONTRACTOR SHALL PROVIDE FACILITIES TO TAKE IN ALL STORM WATER WHICH WILL BE RECEIVED BY THESE DRAINS AND SEWERS AND DISCHARGE THE SAME. HE SHALL PROVIDE AND MAINTAIN AN EFFICIENT PUMPING PLANT, IF NECESSARY, AND A TEMPORARY OUTLET. HE SHALL BE PREPARED AT ALL TIMES TO DISPOSE OF THE WATER RECEIVED FROM TEMPORARY CONNECTIONS UNTIL SUCH TIME AS THE PERMANENT CONNECTIONS WITH SEWER ARE BUILT AND IN SERVICE. THIS WORK WILL NOT BE PAID FOR SEPARATELY, BUT SHALL BE INCLUDED IN THE COST OF THE STORM SEWERS AND DRAINAGE STRUCTURES INSTALLED AS PART OF THIS PROJECT.
- 4. TOP OF FRAME ("RIM") ELEVATIONS GIVEN ON THE PLANS ARE ONLY TO ASSIST THE CONTRACTOR IN DETERMINING THE APPROXIMATE OVERALL HEIGHT OF EACH STRUCTURE. FRAMES ON ALL NEW STRUCTURES SHALL BE ADJUSTED TO THE FINAL ELEVATIONS OF THE AREAS IN WHICH THEY ARE LOCATED, AS PART OF THE STRUCTURE COST.
- 5. DRAINAGE STRUCTURE FLAT-TOPS AND CONES SHALL BE TURNED SO THAT THE FRAMES ARE CLOSEST TO THE CENTERLINE OF THE LANE. ALL FLAT-TOPS AND CONES ARE ASSUMED TO BE ECCENTRIC.
- 6. ALL SEWER AND WATER SERVICES CROSSED BY NEW STORM SEWERS SHALL BE PROPERLY LOCATED AND PROTECTED DURING CONSTRUCTION. ANY DAMAGE TO SAID SERVICES NOT CONSIDERED TO BE IN CONFLICT WITH THE PROPOSED STORM SEWER SHALL BE REPAIRED BY THE CONTRACTOR AT HIS OWN EXPENSE.
- 7. THE REMOVAL OF END SECTIONS SHALL BE PAID FOR PER FOOT AS "STORM SEWER REMOVAL" OF THE DIAMETER INDICATED.
- ONLY METHOD 1 UNDER SECTION 550.07 OF THE STANDARD SPECIFICATIONS SHALL BE ALLOWED FOR THE PLACEMENT OF TRENCH BACKFILL.
- 9. THE CONTRACTOR SHALL BE AWARE THAT AT TIMES THE ENGINEER MAY REQUIRE A CHANGE IN STORM SEWER ELEVATION DUE TO A UTILITY LINE OR OTHER OBSTRUCTION. IF SUCH A GRADE CHANGE DOES NOT ALTER THE PIPE CLASSIFICATION, THE ADDITIONAL EXCAVATION OR SHEETING REQUIRED SHALL BE INCLUDED IN THE COST OF THE STORM SEWER BEING INSTALLED. IF THE REVISED GRADE RESULTS IN A CHANGE IN PIPE CLASSIFICATION, PAYMENT WILL BE MADE FOR THE REVISED TYPE OF STORM SEWER.
- IO. ALL ABANDONED PIPE AND STRUCTURE INVERTS SHALL BE PLUGGED WITH CONCRETE BRICKS AND NON-SHRINK MORTAR FOR A LENGTH OF 2' MEASURED FROM THE END OF THE PIPE. THIS WORK SHALL BE INCLUDED IN THE COST OF THE STORM OR SANITARY SEWER ITEMS BEING REMOVED.

LANDSCAPING

- . WHEN DIRECTED BY THE ENGINEER, SUPPLEMENTAL WATERING SHALL BE APPLIED TO ALL SODDED AREAS PRIOR TO FINAL ACCEPTANCE AT A RATE SPECIFIED BY THE ENGINEER.
- THE CONTRACTOR SHALL ADHERE TO LIMITS OF RESTORATION SHOWN. AREAS OUTSIDE THESE LIMITS THAT ARE DAMAGED OR DISTURBED BY THE CONTRACTOR SHALL BE RESTORED BY THE CONTRACTOR AT HIS EXPENSE, AND NO ADDITIONAL COMPENSATION WILL BE ALLOWED.

EROSION CONTROL

- ALL VEGETATIVE AND STRUCTURAL EROSION CONTROL PRACTICES SHALL BE CONSTRUCTED AND MAINTAINED IN ACCORDANCE WITH THE MINIMUM STANDARDS AND SPECIFICATIONS OF THE "ILLINOIS PROCEDURES AND STANDARDS FOR URBAN SOIL EROSION AND SEDIMENTATION CONTROL" AND THE "STANDARDS AND SPECIFICATIONS FOR SOIL EROSION AND SEDIMENT CONTROL" OF THE ILLINOIS ENVIRONMENTAL PROTECTION AGENCY.
- SOIL DISTURBANCE SHALL BE CONDUCTED IN SUCH A MANNER AS TO MINIMIZE EROSION. SOIL STABILIZATION
 MEASURES SHALL CONSIDER THE TIME OF YEAR, SITE CONDITIONS AND THE USE OF TEMPORARY OR PERMANENT
 MEASURES SHALL CONSIDER THE TIME OF YEAR, SITE CONDITIONS AND THE USE OF TEMPORARY OR PERMANENT
 MEASURES SHALL CONSIDER THE TIME OF YEAR, SITE CONDITIONS AND THE USE OF TEMPORARY OR PERMANENT
 MEASURES SHALL CONSIDER THE TIME OF YEAR.
- 3. THE CONTRACTOR SHALL INSPECT ALL EROSION CONTROL MEASURES PERIODICALLY AND AFTER EACH RUNOFF-PRODUCING RAINFALL EVENT. ANY NECESSARY REPAIRS OR CLEANUP TO MAINTAIN THE EFFECTIVENESS OF SAID MEASURES SHALL BE MADE IMMEDIATELY.
- 4. ALL STORM SEWER FACILITIES THAT ARE OR WILL BE FUNCTIONING DURING CONSTRUCTION SHALL BE PROTECTED, FILTERED OR OTHERWISE TREATED TO REMOVE SEDIMENT. MUD AND SEDIMENT DEPOSITS SHALL BE REMOVED FROM THE ROADWAY AT THE END OF EACH WORK DAY BY SHOVELING AND/OR SWEEPING.
- ALL SLOPES SHALL BE COVERED WITH SOD AS GRADING AND PLACEMENT OF TOPSOIL HAS BEEN COMPLETED. THE LIMITS OF THE SOD SHALL BE THE LIMITS OF GRADING.
- INLET FILTERS SHALL BE PLACED ON ALL CATCH BASINS, INLETS, AND MANHOLES WITH OPEN GRATES IN THE CURB AND GUTTER AND SHOULDERS.
- 7. THE EROSION CONTROL MEASURES INDICATED ON THE PLANS ARE THE MINIMUM REQUIREMENTS. ADDITIONAL MEASURES MAY BE REQUIRED, AS DIRECTED BY THE ENGINEER.
- 8. SEE STANDARD 280001-05 FOR ADDITIONAL SOIL EROSION AND SEDIMENT CONTROL DETAILS AND REQUIREMENTS.
- WHEN A TOPSOIL STOCKPILE IS TO REMAIN IN PLACE FOR MORE THAN THREE DAYS, EROSION CONTROL MEASURES MEETING THE APPROVAL OF THE ENGINEER SHALL BE PROVIDED. THIS WORK SHALL BE PAID FOR AT THE UNIT PRICE FOR THE INDIVIDUAL ITEMS USED.
- 10. THE SURFACE OF ALL STRIPPED AREAS SHALL BE PERMANENTLY OR TEMPORARILY PROTECTED FROM SOIL EROSION WITHIN 14 DAYS AFTER FINAL GRADE IS REACHED. STRIPPED AREAS THAT WILL REMAIN UNDISTURBED FOR MORE THAN 14 DAYS AFTER INITIAL DISTURBANCE SHALL BE PROTECTED FROM EROSION WITH THE USE OF TEMPORARY EROSION CONTROL SEEDING. TEMPORARY SEDIMENT AND EROSION CONTROL MEASURES SHALL BE MAINTAINED CONTINUOUSLY UNTIL PERMANENT COVER IS ESTABLISHED.

MISCELLANEOUS COMMITMENTS

- SITE OBJECTS: REMOVAL OF MISCELLANEOUS PARKWAY IMPROVEMENTS INCLUDING, BUT NOT LIMITED TO, BLOCK RETAINING WALLS, CONCRETE RETAINING WALLS, LANDSCAPE TIMBERS, LANDSCAPE ROCKS, FENCES, FENCE POSTS, PLANTERS, VEGETATION, BRICK OR BRICK PAVER WALKWAYS WITHIN R.O.W. LIMITS SHALL BE INCLUDED IN THE COST OF "EARTH EXCAVATION." THE CONTRACTOR SHALL CONTACT THE ADJACENT PROPERTY OWNER TO DETERMINE IF SUCH ITEMS SHALL BE RETURNED TO THE PROPERTY OWNER OR BE DISPOSED OF PROPERLY.
- 2. UNLESS OTHERWISE AUTHORIZED BY THE ENGINEER, ALL EXISTING ACCESS POINTS SHALL BE MAINTAINED AT ALL TIMES BY THE CONTRACTOR.
- THE CONTRACTOR SHALL NOT CROSS COMPLETED BINDER COURSE, OR EXISTING PAVEMENT NOT SCHEDULED TO BE REMOVED, WITH CONSTRUCTION EQUIPMENT WHICH MAY DAMAGE THE PAVEMENT.
- 4. THE RESIDENT ENGINEER SHALL CONTACT WALTER CZARNY, IDOT AREA TRAFFIC FIELD ENGINEER AT 847-705-8419 AT LEAST TWO (2) WEEKS PRIOR TO PLACING PERMANENT PAVEMENT MARKINGS.
- 5. THE RESIDENT ENGINEER SHALL CONTACT THE ENGINEER AND TRAFFIC CONTROL SUPERVISOR AT (847) 705-4470 A MINIMUM OF 72 HOURS PRIOR TO THE PLACEMENT OF ANY TRAFFIC CONTROL DEVICES.

STAKING

STATE OF ILLINOIS

DEPARTMENT OF TRANSPORTATION

- THE CONTRACTOR SHALL PROTECT AND CAREFULLY PRESERVE ALL SECTION OR SUBSECTION MONUMENTS OR PROPERTY OR REFERENCE MARKERS UNTIL THE ENGINEER, HIS/HER AGENT OR AN AUTHORIZED SURVEYOR HAS WITNESSED OR OTHERWISE REFERENCED THEIR LOCATIONS.
- 2. ALL RADII FOR PROPOSED CURB AND GUTTER ARE TO THE EDGE OF PAVEMENT UNLESS OTHERWISE NOTED.
- 3. THE STATION/OFFSET/ELEVATIONS NOTED FOR ALL DRAINAGE STRUCTURES LOCATED IN THE CURB LINE REFER TO THE POSITION OF THE ADJACENT PROPOSED EDGE OF PAVEMENT. THE CONTRACTOR SHALL BE RESPONSIBLE FOR DETERMINING THE OFFSET NECESSARY FOR EACH STRUCTURE TO SET THE FRAME AND GRATE IN THE PROPER LOCATION. ALL OTHER STRUCTURES ARE DIMENSIONED TO THE CENTER OF STRUCTURE.
- 4. PAVEMENT GRADES: THE ELEVATIONS INDICATED ON THE PLANS ARE FINISHED GRADES OF PROPOSED PAVEMENT, UNLESS OTHERWISE INDICATED.
- 5. ESTIMATED LOCATIONS OF SIDEWALK REMOVAL AND REPLACEMENT HAVE BEEN SHOWN ON THE PLANS. THE ENGINEER WILL DETERMINE THE EXACT LIMITS IN THE FIELD DURING CONSTRUCTION.

GENERAL NOTES

SHEET NO. 2 OF 2 SHEETS

6. THE CONSTRUCTION BASELINE HAS BEEN ESTABLISHED FOR STAKING PURPOSES ONLY AND IS NOT INTENDED TO BE A CENTERLINE OF RIGHT-OF-WAY. UTILITY CONTACTS

ABOVENET TIM PAYMENT 810 JORIE BOULEVARD SUITE 110 OAKBROOK, IL 60523 PH. 630-203-8003

AT&T MICHAEL CARNEY 1000 COMMERCE DRIVE FLOOR 2 OAKBROOK, IL 60523 PH. 630-573-5450

AT&T LOCAL NETWORK SERVICES BOBBY AKHTER 4513 WESTERN AVENUE ROOM 227 LISLE, IL 60532 P.H. 630-810-6274

BUCKEYE PARTNERS JOMARIE JENKINS 5 TEK PARK 9999 HAMILTON BOULEVARD BREINIGSVILLE, PA 18031 PH. 610-904-4138 BILL O'MALLEY PH. 847-878-3428

COMCAST THOMAS MUNAR 688 INDUSTRIAL DRIVE ELMHURST, IL 60126 PH. 630-600-6316

COMED TERRI BLECK 1500 FRANKLIN BOULEVARD LIBERTYVILLE, IL 60048 847-816-5239

LEVEL 3 COMMUNICATIONS JIM MARTIN 2101 ROBERTS DRIVE BROADVIEW, IL 60155 P.H. 708-410-1684

MCI/VERIZON
JIM TODD
P.O. BOX 387
SUMMIT, IL 60501
708-458-6410

SECTION

09-00057-00-CH

COUNTY

COOK

CONTRACT NO. 63523

NICOR CONSTANCE LANE 1844 FERRY ROAD NAPERVILLE, IL 60563 PH. 630-983-8676

CODED PAY ITEM NO.	ITEM	UNIT	TOTAL QUANTITY	0004	0005	0021	0021	0021	0031	0043
-				RECONSTRUCTION, NO CAPACITY ADDED	SYSTEM PRESERVATION, RESURFACING	SAFETY (TRAFFIC SIGNALS)	SAFETY (LIGHTING)	SAFETY (SIDEWALKS)	LANDSCAPING AND OTHER SCENIC BEAUTIFICATION	NON-PARTICIPAT
20101000	TEMPORARY FENCE	FOOT	400	400						
20101100	TREE TRUNK PROTECTION	EACH	10	10						
	TREE ROOT PRUNING	EACH	10	10						
	TREE PRUNING (1 TO 10 INCH DIAMETER)	EACH	9	9						
	TREE PRUNING (OVER 10 INCH DIAMETER)	EACH	1	1						
	EARTH EXCAVATION	CU YD	2548	1643	905				-	
					303					
	REMOVAL AND DISPOSAL OF UNSUITABLE MATERIAL	CU YD	1200	1200						
	FURNISHED EXCAVATION	CU YD	1108	1039	69					
20800150	TRENCH BACKFILL	.CU YD	1223	128	1					1
21101615	TOPSOIL FURNISH AND PLACE, 4"	SQ YD	3933						3933	
25000400	NITROGEN FERTILIZER NUTRIENT	POUND	49				, i		49	
25000500	PHOSPHORUS FERTILIZER NUTRIENT	POUND	49						49	
25000600	POTASSIUM FERTILIZER NUTRIENT	POUND	49						49	
25200100	SODDING	SQ YD	3933						3933	
25200200	SUPPLEMENTAL WATERING	UNIT	59						59	
28000250	TEMPORARY EROSION CONTROL SEEDING	POUND	81	81		·				
28000305	TEMPORARY DITCH CHECKS	FOOT	36	12	24					
28000400	PERIMETER EROSION BARRIER	FOOT	313	313		n n				
		EACH	37	33	4					
(2800 520	ABOVE GRADE INLET FILTERS	EACH	6							
				3						
	SUBBASE GRANULAR MATERIAL, TYPE B	CU YD	487		487					
31101180	SUBBASE GRANULAR MATERIAL, TYPE B 2"	SQ YD	1212					1212		
31101400	SUBBASE GRANULAR MATERIAL, TYPE B 6"	SQ YD	11511	9725	1786					<u> </u>
35102000	AGGREGATE BASE COURSE, TYPE B 8"	SQ YD	1387	1387						
35300500	PORTLAND CEMENT CONCRETE BASE COURSE 10"	SQ YD	241		241					
40600100	BITUMINOUS MATERIALS (PRIME COAT)	GALLON	2344		2344			>		
40600300	AGGREGATE (PRIME COAT)	TON	23		23					
40600400	MIXTURE FOR CRACKS, JOINTS, AND FLANGEWAYS	TON	40		40					
40600635	LEVELING BINDER (MACHINE METHOD), N70	TON	1591		1591					
40600895	CONSTRUCTING TEST STRIP	EACH	1		1					
	HOT-MIX ASPHALT SURFACE REMOVAL - BUTT JOINT	.SQ YD	208		208					
-	HOT-MIX ASPHALT BINDER COURSE, IL-19.0, N50	TON	178		178					
	POLYMERIZED HOT-MIX ASPHALT SURFACE COURSE, MIX "F", N90					·				
		TON	1149		1149					
40800050 I	INCIDENTAL HOT-MIX ASPHALT SURFACING	TON	36	33	3					

1	FILE NAME =	USER NAME = blg	DESIGNED - BLG	REVISED -			F.A.P.	SECTION	COUNTY	TOTAL SHEET
	\cad\sheet\2363_Sum_Guant.dgn		DRAWN - BLG	REVISED -	STATE OF ILLINOIS	SUMMARY OF QUANTITIES	334	09-00057-00-CH	соок	103 4
- 1		PLOT SCALE = 50.0000 '/ IN.	CHECKED - DJK	REVISED -	DEPARTMENT OF TRANSPORTATION				CONTRAC	CT NO. 63523
- 1		PLOT DATE ≈ 11/3/2010	DATE - 10-22-10	REVISED -		SHEET NO. 1 OF 7 SHEETS	FED. ROAD	DIST. NO. 1 ILLINOIS FED.	AID PROJECT M-	-9003(660)

CODED PAY ITEM NO.	ITEM	UNIT	TOTAL QUANTITY	0004	0005	0021	0021	0021	0031	∞43
-		.*		RECONSTRUCTION, NO CAPACITY ADDED	SYSTEM PRESERVATION, RESURFACING	SAFETY (TRAFFIC SIGNALS)	SAFETY (LIGHTING)	SAFETY (SIDEWALKS)	LANDSCAPING AND OTHER SCENIC BEAUTIFICATION	NON-PARTICIPATING
42001300	PROTECTIVE COAT	SQ YD	12770	11073	485			1212		
42400200	PORTLAND CEMENT CONCRETE SIDEWALK 5 INCH	SQ FT	10909					10909		
42400800	DETECTABLE WARNINGS	SQ FT	94			-		94		
44000100	PAVEMENT REMOVAL	SQ YD	10546	10532	14					
44000159	HOT-MIX ASPHALT SURFACE REMOVAL, 2 1/2"	SQ YD	12729		12729	-				
44000200	DRIVEWAY PAVEMENT REMOVAL	SQ YD	1240	1240	· · · · · · · · · · · · · · · · · · ·					
44000300	CURB REMOVAL	FOOT	244	244						
44000500	COMBINATION CURB AND GUTTER REMOVAL	FOOT	6047	4076	1971					
44000600	SIDEWALK REMOVAL	SQ FT	8226	8183	43					
44003100	MEDIAN REMOVAL	SQ FT	13869	3439	10430					
44004250	PAVED SHOULDER REMOVAL	SQ YD	982		982					
44201761	CLASS D PATCHES, TYPE I, 10 INCH	SQ YD	115	49	66					
44201765	CLASS D PATCHES, TYPE II, 10 INCH	SQ YD	460	142	318					
44201769	CLASS D PATCHES, TYPE III, 10 INCH	SQ YD	406	24	382					
44201771	CLASS D PATCHES, TYPE IV, 10 INCH	SQ YD	382	>	382	*				
44300200	STRIP REFLECTIVE CRACK CONTROL TREATMENT	FOOT	17000		17000					
45200100	JOINT OR CRACK ROUTING (PC CONCRETE PAVEMENT AND SHOULDER)	FOOT	18040		18040					
45200300	JOINT OR CRACK FILLING	POUND	4228		4228					
48203037	HOT-MIX ASPHALT SHOULDERS, 10"	SQ YD	940		940					
550A0050	STORM SEWERS, CLASS A, TYPE 1 12"	FOOT	259	259	`					
550A0120	STORM SEWERS, CLASS A, TYPE 1 24"	FOOT	52	52			***************************************			
550A0340	STORM SEWERS, CLASS A, TYPE 2 12"	FOOT	4		4					
55100400	STORM SEWER REMOVAL 10"	FOOT	48	45	3					
55100500	STORM SEWER REMOVAL 12"	FOOT	420	420						
55101200	STORM SEWER REMOVAL 24"	FOOT	62	62						
56100600	WATER MAIN 6"	FOOT	220							220
56100700	WATER MAIN 8"	FOOT	75							75
56100900	WATER MAIN 12"	FOOT	1411							1411
56200700	WATER SERVICE LINE 2"	FOOT	34							34
56300100	ADJUSTING SANITARY SEWERS, 8-INCH DIAMETER OR LESS	FOOT	150							150
56400810	FIRE HYDRANT EXTENSION	FOOT	3							3
56400820	FIRE HYDRANT WITH AUXILIARY VALVE AND VALVE BOX	EACH	3			1				3
56500800	DOMESTIC WATER SERVICE BOXES	EACH	1							1
60109510	PIPE UNDERDRAINS, FABRIC LINED TRENCH 4"	FOOT	250	250			X %			
60201105	CATCH BASINS, TYPE A, 4'-DIAMETER, TYPE 11 FRAME AND GRATE	EACH	1		1					

FILE	NAME =	USER NAME = blg	DESIGNED - BLG	REVISED -		· · · · · · · · · · · · · · · · · · ·	F.A.P.	SECTION	COUNTY	TOTAL SH	IEET
\ca	d\sheet\2363_Sum_Guant.dgn		DRAWN - BLG	REVISED -	STATE OF ILLINOIS	SUMMARY OF QUANTITIES	334	09-00057-00-CH	СООК	103	5
· I		PLOT SCALE = 50.0000 '/ IN.	CHECKED - DJK	REVISED -	DEPARTMENT OF TRANSPORTATION	CUEST NO 2 OF 7 CHESTS				CT NO. 635	
ı	·	PLOT DATE = 11/3/2010	DATE ~ 10-22-10	REVISED -		SHEET NO. 2 OF 7 SHEETS	FED. RO.	AD DIST. NO. 1 ILLINOIS FED.	AID PROJECT M-	9003(660)	

CODED PAY ITEM NO.	ITEM	UNIT	TOTAL QUANTITY	0004	0005	0021	0021	0021	0031	0043
· .				RECONSTRUCTION, NO CAPACITY ADDED	SYSTEM PRESERVATION, RESURFACING	SAFETY (TRAFFIC SIGNALS)	SAFETY (LIGHTING)	SAFETY (SIDEWALKS)	LANDSCAPING AND OTHER SCENIC BEAUTIFICATION	NON-PARTICIPAT
60201340	CATCH BASINS, TYPE A, 4'-DIAMETER, TYPE 24 FRAME AND GRATE	EACH	6	6						
60219540	MANHOLES, TYPE A, 4'-DIAMETER, TYPE 24 FRAME AND GRATE	EACH	2	2						
60221100	MANHOLES, TYPE A, 5'-DIAMETER, TYPE 1 FRAME, CLOSED LID	EACH	3	-3				<i>t</i>		
60237470	INLETS, TYPE A, TYPE 24 FRAME AND GRATE	EACH	9	9						
60240210	INLETS, TYPE B, TYPE 1 FRAME, OPEN LID	EACH	1	1						
60250500	CATCH BASINS TO BE ADJUSTED WITH NEW TYPE 1 FRAME, CLOSED LID	EACH	1	1						
60251740	CATCH BASINS TO BE ADJUSTED WITH NEW TYPE 24 FRAME AND GRATE	EACH	1	1						
60260300	INLETS TO BE ADJUSTED WITH NEW TYPE 1 FRAME, OPEN LID	EACH	1		1				-	
	INLETS TO BE ADJUSTED WITH NEW TYPE 24 FRAME AND GRATE	EACH	1	1						
	VALVE VAULTS TO BE REMOVED	EACH	1							
	VALVE BOXES TO BE ADJUSTED	EACH	1							
	REMOVING CATCH BASINS	EACH	1					s		i
60500060		EACH	14		1					
	CLASS SI CONCRETE (OUTLET)	CU YD	4							
60600605		FOOT	279	279						
60603800	COMBINATION CONCRETE CURB AND GUTTER, TYPE B-6.12	FOOT	298	288	10					
60605000	COMBINATION CONCRETE CURB AND GUTTER, TYPE B-6.24	FOOT	1743	1743	:	3				
60605400	COMBINATION CONCRETE CURB AND GUTTER, TYPE B-6,24 (SPECIAL)	FOOT	1023	1023						-
60605900	COMBINATION CONCRETE CURB AND GUTTER, TYPE B-9.12	FOOT	1803		1803					:
60618300	CONCRETE MEDIAN SURFACE, 4 INCH	SQ FT	1397		1397					7
(6061900	CONCRETE MEDIAN, TYPE SB-6.12 (SPECIAL)	SQ FT	1783	1783						
60620800	CONCRETE MEDIAN, TYPE SB-9.12	SQ FT	146		146					
60624600	CORRUGATED MEDIAN	SQ FT	119	119						
66900205	SPECIAL WASTE DISPOSAL	CU YD	322	322		, , , , , , , , , , , , , , , , , , ,				
66900450	SPECIAL WASTE PLANS AND REPORT	L SUM	1	1						
	SOIL DISPOSAL ANALYSIS	EACH	2					·		
	PNAS SOIL ANALYSIS	EACH	2							
	RCRA METALS TCLP SOIL ANALYSIS									
		EACH	1							
	ENGINEER'S FIELD OFFICE, TYPE A	CAL MO			•					
	MOBILIZATION	L SUM	1	1						
(7010216	TRAFFIC CONTROL AND PROTECTION, (SPECIAL)	L SUM	1	1						
(X008 43 8	TRAFFIC CONTROL AND PROTECTION FOR TEMPORARY DETOUR	EACH	1	1						
70106800	CHANGEABLE MESSAGE SIGN	CAL MO	36	36						
70300100	SHORT-TERM PAVEMENT MARKING	FOOT	8177	2623	5554					
70300210	TEMPORARY PAVEMENT MARKING- LETTERS AND SYMBOLS	SQ FT	290	73	217			 	1	

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\cad\sheet\2363_Sum_Quant.dgn		DRAWN - BLG	REVISED -	STATE OF ILLINOIS	SUMMARY OF QUANTITIES	334	09-00057-00-CH	СООК	103 6
	PLOT SCALE = 50.0000 '/ IN.	CHECKED - DJK	REVISED -	DEPARTMENT OF TRANSPORTATION		-		CONTRAC	CT NO. 63523
	PLOT DATE = 11/3/2010	DATE - 10-22-10	REVISED -	•	SHEET NO. 3 OF 7 SHEETS	FED. ROAD D	DIST. NO. 1 ILLINOIS FED. A	ID PROJECT M-	9003(660)

CODED PAY ITEM ITEM	UNIT	TOTAL	0004	0005	0021	0021	0021	0031	0043
			RECONSTRUCTION, NO CAPACITY ADDED	SYSTEM PRESERVATION, RESURFACING	SAFETY (TRAFFIC SIGNALS)	SAFETY (LIGHTING)	SAFETY (SIDEWALKS)	LANDSCAPING AND OTHER SCENIC BEAUTIFICATION	NON-PARTICIPAT
70300220 TEMPORARY PAVEMENT MARKING- LINE 4"	FOOT	11328	7525	3803					
70300240 TEMPORARY PAVEMENT MARKING- LINE 6"	FOOT	1150	450	700					-
70300280 TEMPORARY PAVEMENT MARKING- LINE 24"	FOOT	178	44	134					
70301000 WORK ZONE PAVEMENT MARKING REMOVAL	SQ FT	11446	9595	1851		•			
72000100 SIGN PANEL - TYPE 1	SQ FT	289	101	159	29				
72000200 SIGN PANEL - TYPE 2	SQ FT	25			25				
72400100 REMOVE SIGN PANEL ASSEMBLY - TYPE A	EACH	27	13	14					
72400200 REMOVE SIGN PANEL ASSEMBLY - TYPE B	EACH	3	1	2			·.		
72800100 TELESCOPING STEEL SIGN SUPPORT	FOOT	555	264	291			ÿ.		
78000100 THERMOPLASTIC PAVEMENT MARKING - LETTERS AND SYMBOLS	SQ FT	439		439					
78000200 THERMOPLASTIC PAVEMENT MARKING - LINE 4"	FOOT	2746		2746		1	,		
78000400 THERMOPLASTIC PAVEMENT MARKING - LINE 6"	FOOT	1355		1355					
78000650 THERMOPLASTIC PAVEMENT MARKING - LINE 24"	FOOT	243		243					
78008200 POLYUREA PAVEMENT MARKING TYPE I - LETTERS AND SYMBOLS	SQ FT	110	110					:	
78008210 POLYUREA PAVEMENT MARKING TYPE I - LINE 4"	FOOT	3741	3741						
78008230 POLYUREA PAVEMENT MARKING TYPE I - LINE 6"	FOOT	1488	1488						
78008250 POLYUREA PAVEMENT MARKING TYPE I - LINE 12"	FOOT	144	144						
78008270 POLYUREA PAVEMENT MARKING TYPE I - LINE 24"	FOOT	82	82						
78100100 RAISED REFLECTIVE PAVEMENT MARKER	EACH	114		114					
78300100 PAVEMENT MARKING REMOVAL	SQ FT	2425	438	1987					
78300200 RAISED REFLECTIVE PAVEMENT MARKER REMOVAL	EACH	114		. 114					
81000600 CONDUIT IN TRENCH, 2" DIA., GALVANIZED STEEL	FOOT	693			693				
81000700 CONDUIT IN TRENCH, 2 1/2" DIA., GALVANIZED STEEL	FOOT	262			262				
81000800 CONDUIT IN TRENCH, 3" DIA., GALVANIZED STEEL	FOOT	120	,		120				
81001000 CONDUIT IN TRENCH, 4" DIA., GALVANIZED STEEL	FOOT				60				
81018500 CONDUIT PUSHED, 2" DIA., GALVANIZED STEEL									
	FOOT		,		531				
81018600 CONDUIT PUSHED, 2 1/2" DIA., GALVANIZED STEEL	FOOT	30			30				
81018900 CONDUIT PUSHED, 4" DIA., GALVANIZED STEEL	FOOT	512			512				
81400100 HANDHOLE	EACH	3			3				
81400200 HEAVY-DUTY HANDHOLE	EACH	5			5				
81400300 DOUBLE HANDHOLE	EACH	2			2				
81603085 UNIT DUCT, 600V, 3-1C NO.4, 1/C NO.4 GROUND, (XLP-TYPE USE), 1 1/4" DIA. POLYETHYLENE	FOOT	406				406			
81900200 TRENCH AND BACKFILL FOR ELECTRICAL WORK	FOOT	1180			1120	60			
81900302 TRENCH AND BACKFILL WITH SCREENINGS OR SAND	FOOT	310				310			-
83600200 LIGHT POLE FOUNDATION, 24" DIAMETER	FOOT	20				20	,		

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\cad\sheet\2363_Sum_Quant.dgn		DRAWN - BLG	REVISED -	STATE OF ILLINOIS	SUMMARY OF QUANTITIES	334 09-00057-00-CH	COOK 103 7
	PLOT SCALE = 50.0000 '/ IN.	CHECKED - DJK	REVISED -	DEPARTMENT OF TRANSPORTATION			CONTRACT NO. 63523
	PLOT DATE = 11/3/2010	DATE - 10-22-10	REVISED -		SHEET NO. 4 OF 7 SHEETS	FED. ROAD DIST. NO. 1 ILLINOIS FED.	. AID PROJECT M-9003(660)

ITEM NO.	ITEM	UNIT	TOTAL QUANTITY	0004	0005	0021	0021	0021	0031	0043
				RECONSTRUCTION, NO CAPACITY ADDED	SYSTEM PRESERVATION, RESURFACING	SAFETY (TRAFFIC SIGNALS)	SAFETY (LIGHTING)	SAFETY (SIDEWALKS)	LANDSCAPING AND OTHER SCENIC BEAUTIFICATION	NON-PARTICIPAT
84400105	RELOCATE EXISTING LIGHTING UNIT	EACH	2				2			
35000200	MAINTENANCE OF EXISTING TRAFFIC SIGNAL INSTALLATION	EACH	1			1				
35700205	FULL-ACTUATED CONTROLLER AND TYPE IV CABINET, SPECIAL	EACH	1			1			-	
86400100	TRANSCEIVER - FIBER OPTIC	EACH	1			1				
87301215	ELECTRIC CABLE IN CONDUIT, SIGNAL NO. 14 2C	FOOT	1554			1554				
87301225	ELECTRIC CABLE IN CONDUIT, SIGNAL NO. 14 3C	FOOT	2275			2275				
87301245	ELECTRIC CABLE IN CONDUIT, SIGNAL NO. 14 5C	FOOT	2385			2385				
87301255	ELECTRIC CABLE IN CONDUIT, SIGNAL NO. 14 7C	FOOT	2842			2842				
87301305	ELECTRIC CABLE IN CONDUIT, LEAD-IN, NO. 14 1 PAIR	FOOT	4253			4253				
87301805	ELECTRIC CABLE IN CONDUIT, SERVICE, NO. 6 2C	FOOT	112			112			1.	
87502500	TRAFFIC SIGNAL POST, GALVANIZED STEEL 16 FT.	EACH	2			2			· · · · · · · · · · · · · · · · · · ·	
87700170	STEEL MAST ARM ASSEMBLY AND POLE, 26 FT.	EACH	1			1				
87700200	STEEL MAST ARM ASSEMBLY AND POLE, 32 FT.	EACH	1			1				
87700250	STEEL MAST ARM ASSEMBLY AND POLE, 42 FT.	EACH	1			1		-		
87700290	STEEL MAST ARM ASSEMBLY AND POLE, 50 FT.	EACH	1			1		*		
87700300	STEEL MAST ARM ASSEMBLY AND POLE, 52 FT.	EACH	1			1	:			
87700400	STEEL MAST ARM ASSEMBLY AND POLE, 60 FT.	EACH	1		1	1				
87800100	CONCRETE FOUNDATION, TYPE A	FOOT	8			8				
87800150	CONCRETE FOUNDATION, TYPE C	FOOT	. 4			4				
87800400	CONCRETE FOUNDATION, TYPE E 30-INCH DIAMETER	FOOT	30			30				
87800415	CONCRETE FOUNDATION, TYPE E 36-INCH DIAMETER	FOOT	45			45				
87800420	CONCRETE FOUNDATION, TYPE E 42-INCH DIAMETER	FOOT	21			21				
87900200	DRILL EXISTING HANDHOLE	EACH	2			2		· ·	I.	
88030020	SIGNAL HEAD, LED, 1-FACE, 3-SECTION, MAST-ARM MOUNTED	EACH	8			8		V		
88030110	SIGNAL HEAD, LED, 1-FACE, 5-SECTION, MAST-ARM MOUNTED	EACH	10			10				
88030240	SIGNAL HEAD, LED, 2-FACE, 1-3 SECTION, 1-5 SECTION, BRACKET MOUNTED	EACH	2.			2				
88102747	PEDESTRIAN SIGNAL HEAD, LED, 2-FACE, BRACKET MOUNTED WITH COUNTDOWN TIMER	EACH	4			4			1	
88200210	TRAFFIC SIGNAL BACKPLATE, LOUVERED, ALUMINUM	EACH	18			18				
88500100	INDUCTIVE LOOP DETECTOR	EACH	15	-		15				
88600100	DETECTOR LOOP, TYPE I	FOOT	652		WWW. 47 - 14	652				
88700200	LIGHT DETECTOR	EACH	3							
88700300	LIGHT DETECTOR AMPLIFIER	EACH	1							
88800100	PEDESTRIAN PUSH-BUTTON	EACH	8			. 8				
89000100	TEMPORARY TRAFFIC SIGNAL INSTALLATION	EACH	1			1				
00502700	REMOVE ELECTRIC CABLE FROM CONDUIT	FOOT	3513		`	1923	1590			

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\cad\sheet\2363_Sum_Guánt.dgn	75	DRAWN	- BLG	REVISED -	STATE OF ILLINOIS	SUMMARY OF QU	ANTITIES	334	09-00057-00-CH	соок	103	8
	PLOT SCALE = 50.00000 '/ IN.	CHECKED	- DJK	REVISED -	DEPARTMENT OF TRANSPORTATION					CONTRAC	CT NO.	3523
	PLOT DATE = 11/3/2010	DATE	- 10-22-10	REVISED -		SHEET NO. 5 OF 7 SHEETS	^	FED. RO	AD DIST. NO. 1 ILLINOIS FED.	AID PROJECT M-S		

CODED PAY ITEM NO.	ITEM	UNIT	TOTAL QUANTITY	0004	0005	0021	0021	0021	0031	0043
				RECONSTRUCTION, NO CAPACITY ADDED	SYSTEM PRESERVATION, RESURFACING	SAFETY (TRAFFIC SIGNALS)	SAFETY (LIGHTING)	SAFETY (SIDEWALKS)	LANDSCAPING AND OTHER SCENIC BEAUTIFICATION	NON-PARTICIPATI
89502375	REMOVE EXISTING TRAFFIC SIGNAL EQUIPMENT	EACH	1			1				
,89502380	REMOVE EXISTING HANDHOLE	EACH	10			10				
89502385	REMOVE EXISTING CONCRETE FOUNDATION	EACH	9			9		*		
A2001228	TREE, ACER RUBRUM RED SUNSET (RED SUNSET RED MAPLE), 4" CALIPER, BALLED AND BURLAPPED	EACH	3						3	
A2008132	. TREE, TILIA CORDATA GREENSPIRE (GREENSPIRE LITTLE LEAF LINDEN), 4" CALIPER, BALLED AND BURLAPPED	EACH	2						2	
Z0018500	DRAINAGE STRUCTURES TO BE CLEANED	EACH	8		8					
Z0018911	DRILL AND GROUT *6 TIE BARS	EACH	1033		1033		-			
Z0030850	TEMPORARY INFORMATION SIGNING	SQ FT	278	227	51					
Z0033028	MAINTENANCE OF LIGHTING SYSTEM	CAL MO	9				9			
Z0033060	PREFORMED DETECTOR LOOP	FOOT	. 891		***	891				
Z0033090	ELECTRIC CABLE IN CONDUIT, TRACER, NO. 14 1C	FOOT	2367			2367				
Z0042002	POROUS GRANULAR EMBANKMENT, SUBGRADE	CU YD	1200	1200				7		
Z0048665		L SUM	1	1						
		FOOT	250	250	•					
			2037							
Z0062456		SQ YD		2037						
	STEEL CASINGS 24"	FOOT	45				,			
	TEMPORARY TRAFFIC SIGNAL TIMING	EACH	1			1				
	TRAINEES	HOUR	1500	1500	-					
X0300020		EACH	1		1			4.	*	
X0323857	EXISTING LIGHT POLE FOUNDATION ADJUSTMENT	EACH	5	·		: 1×	5			
X0325134	WIRELESS INTERCONNECT (COMPLETE)	EACH	1			1				
X0325207	TELEVISION INSPECTION OF SEWER	FOOT	3018	*	3018					
X2130010	EXPLORATION TRENCH, SPECIAL	FOOT	150	150		.,				
X4022000	TEMPORARY ACCESS (COMMERCIAL ENTRANCE)	EACH	14	14				.,		
X4023000	TEMPORARY ACCESS (ROAD)	EACH	4	4						
X4200110	HIGH-EARLY-STRENGTH PORTLAND CEMENT CONCRETE PAVEMENT 10" (JOINTED)	SQ YD	2304	- 2304						
X4230800	PORTLAND CEMENT CONCRETE DRIVEWAY PAVEMENT, 8 INCH, SPECIAL	SQ YD	1279	1279					,	1 1
X5539700	STORM SEWERS TO BE CLEANED	F00T	1509		1509					<u> </u>
X5630706	CONNECTION TO EXISTING WATER MAIN 6"	EACH	3			-		3		
X5630708	CONNECTION TO EXISTING WATER MAIN 8"	EACH	2							
X5630712	CONNECTION TO EXISTING WATER MAIN 12"	EACH	. 6					× ·		
X6026050	SANITARY MANHOLES TO BE ADJUSTED	EACH	3	3						
X6063401	COMBINATION CONCRETE CURB AND GUTTER, TYPE M-4.12	FOOT	186		186					
X703003Ö	WET REFLECTIVE TEMPORARY TAPE, TYPE III, 4 INCH	FOOT	9931	7311	2620					
	WET REFLECTIVE TEMPORARY TAPE, TYPE III, 6 INCH	FOOT	300	300						


△ 0042 • SPECIALTY ITEM


4									
FILE NAME =	USER NAME = blg	DESIGNED - BLG	REVISED -			F.A.P.	SECTION	COUNTY	TOTAL SHEET
\cad\sheet\2363_Sum_Quant.dgn		DRAWN ~ BLG	REVISED -	STATE OF ILLINOIS	SUMMARY OF QUANTITIES	334	09-00057-00-CH	соок	103 9
	PLOT SCALE = 50.0000 '/ IN.	CHECKED - DJK	REVISED -	DEPARTMENT OF TRANSPORTATION	The state of the s		00 00007 00 011		T NO. 63523
	PLOT DATE = 11/3/2010	DATE - 10-22-10	REVISED -		SHEET NO. 6 OF 7 SHEETS	FED. ROAD	DIST. NO. 1 ILLINOIS FED.	AID PROJECT M-9	

CODED PAY ITEM NO.	ITEM	UNIT	TOTAL QUANTITY	0004	0005	0021	0021	0021	. 0031	0043
				RECONSTRUCTION, NO CAPACITY ADDED	SYSTEM PRESERVATION, RESURFACING	SAFETY (TRAFFIC SIGNALS)	SAFETY (LIGHTING)	SAFETY (SIDEWALKS)	LANDSCAPING AND OTHER SCENIC BEAUTIFICATION	NON-PARTICIPATING
X7030025	WET REFAECTIVE TEMPORARY TAPE, TYPE III, LETTERS AND SYMBOLS	SQ FT	109	109						
X7030055	WETREFLECTIVE TEMPORARY TAPE, TYPE III, 24 INCH	FOOT	77	77						
X8050015	SERVICE INSTALLATION - POLE MOUNTED	EACH	1			1				
X8440116	RELOCATE EXISTING LIGHTING UNIT, SPECIAL	EACH	2				2			
X8620020	UNINTERRUPTIBLE POWER SUPPLY	EACH	1			1				
X8710020	FIBER OPTIC CABLE IN CONDUIT, NO. 62.5/125, MM12F SM12F	FOOT	2390			2390				
X8730027	ELECTRIC CABLE IN CONDUIT, GROUNDING, NO. 6 1C	FOOT	983			983				
X8730250	ELECTRIC CABLE IN CONDUIT NO. 20 3/C, TWISTED, SHIELDED	FOOT	665		*			2		665
XX004907	GATE VALVE 12" WITH VAULT, 5' DIAMETER	EACH	4							4
XX004913	REMOVE FIBER OPTIC CABLE FROM CONDUIT	FOOT	1935			1935				
XX006077	GATE VALVE AND BOX 6"	EACH	3							- 3
XX006241	GATE VALVE AND BOX 8"	EACH	2							2
XX006633	DUCTILE IRON PIPE INSTALLED IN STEEL CASING, 12"	FOOT	45			<u> </u>				45
XX006826	REMOVE AND RELOCATE LAWN SPRINKLER SYSTEM	FOOT	50	50						
XX006827	SIDEWALK RAILROAD CROSSING	EACH	1	1						
XX007090	VALVE VAULT, 5' DIA., WITH 12" VALVE	EACH	3							3
XX008361	WATER MAIN TO BE ABANDONED	L SUM	1							1
XX011700	WATER MAIN FITTINGS	POUND	4236				-			4236
XX008439	HOT SYNTHETIC PATTERNED TEXTURED PAVING, 3/4"	SQ FT	7794			- Acceptance of the Control of the C				7794
	TREE, ACER PLATANOIDES CRIMSON KING (CRIMSON KING NORWAY MAPLE), 4" CALIPER, BALLED AND BURLAPPED	EACH	3						3	

SPECIALTY ITEM ...


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\cad\sheet\2363_Sum_Quant.dgn		DRAWN - BLG	REVISED -	STATE OF ILLINOIS	SUMMARY OF QUANTITIES	334	09-00057-00-CH	соок	103 10
	PLOT SCALE = 50.0000 '/ IN.	CHECKED - DJK	REVISED -	DEPARTMENT OF TRANSPORTATION				CONTRACT	T NO. 63523
	PLOT DATE # 11/3/2010	DATE ~ 10-22-10	REVISED -		SHEET NO. 7 OF 7 SHEETS	FED. ROAD DIS	ST. NO. 1 ILLINOIS FED. A	ID PROJECT M-90	003(660)

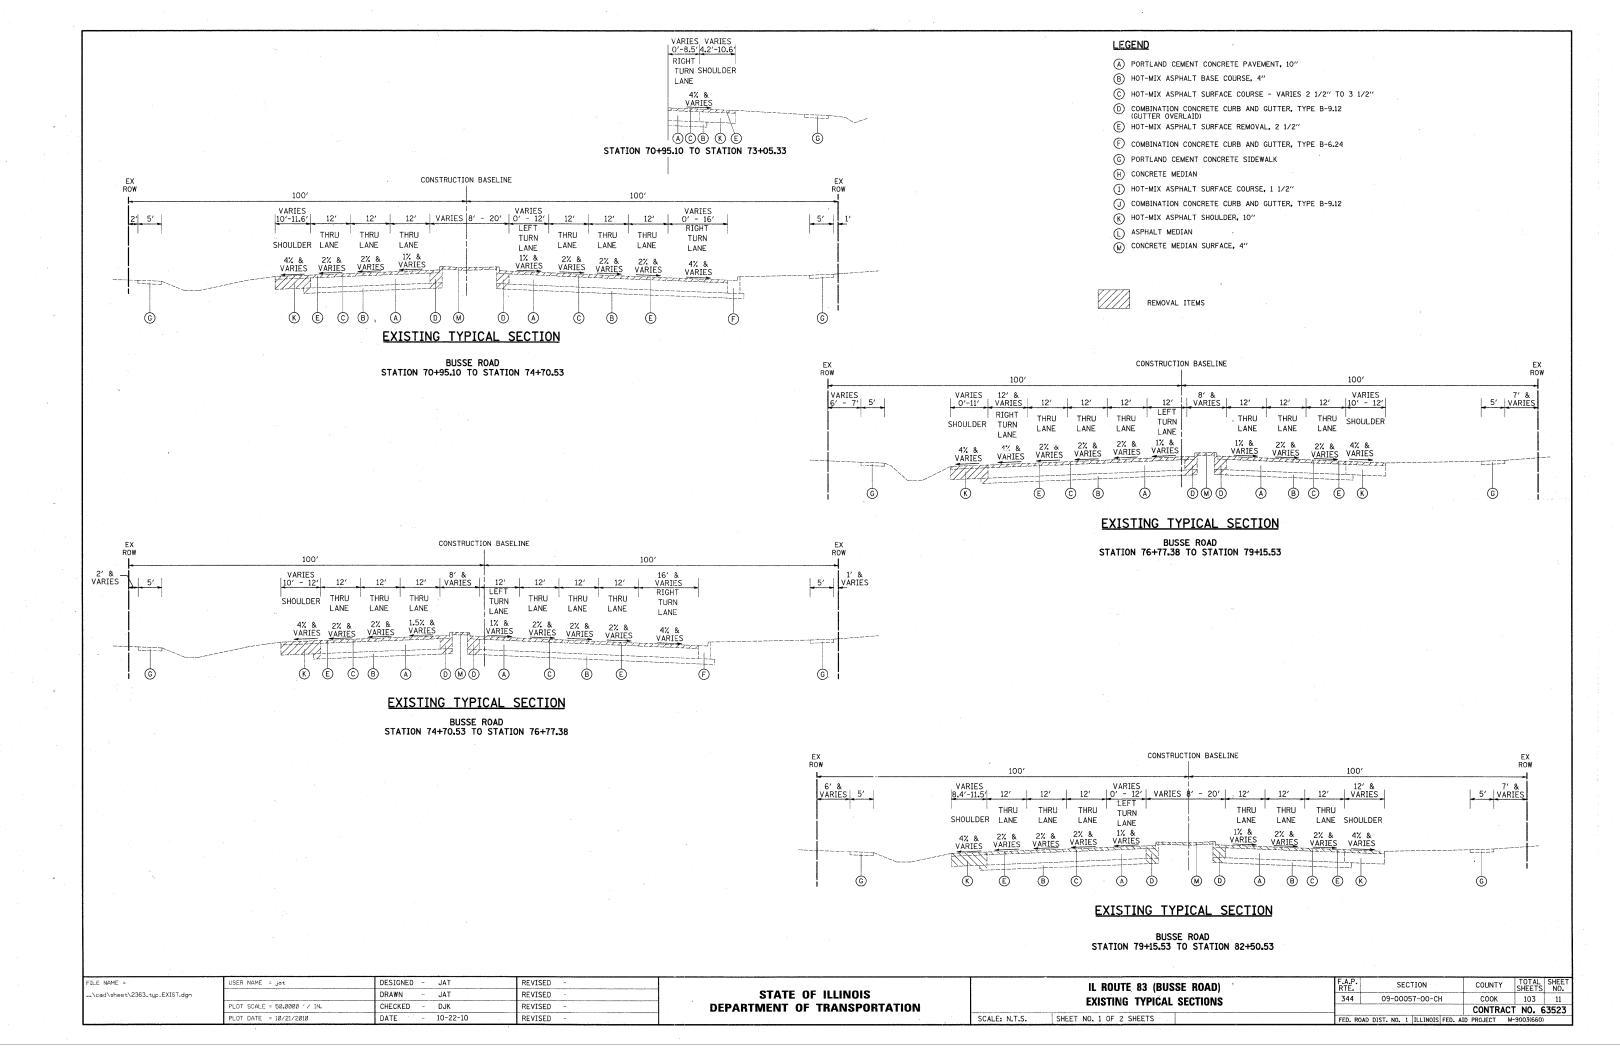

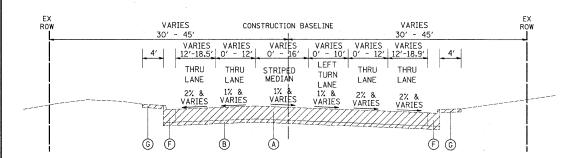

EXISTING TYPICAL SECTION


PRATT BOULEVARD STATION 401+27.62 TO STATION 407+65.42

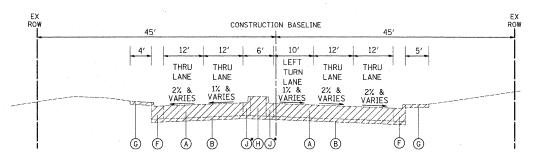

*GUTTER OVERLAID STATION 408+21.95 TO STATION 408+72.84


EXISTING TYPICAL SECTION

PRATT BOULEVARD
STATION 407+65.42 TO STATION 409+05.58

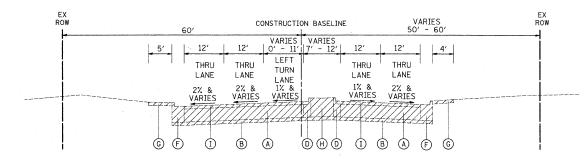

EXISTING TYPICAL SECTION

PRATT BOULEVARD STATION 410+33.74 TO STATION 412+99.78

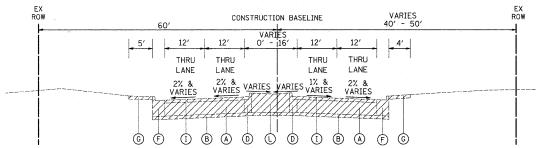

EXISTING TYPICAL SECTION

PRATT BOULEVARD STATION 412+99.78 TO STATION 415+68.82

LEGEND

- (A) PORTLAND CEMENT CONCRETE PAVEMENT, 10"
- (B) HOT-MIX ASPHALT BASE COURSE, 4"
- C HOT-MIX ASPHALT SURFACE COURSE VARIES 2 1/2" TO 3 1/2"
- (GUTTER OVERLAID)
- (E) HOT-MIX ASPHALT SURFACE REMOVAL, 2 1/2"
- F COMBINATION CONCRETE CURB AND GUTTER, TYPE B-6.24
- (G) PORTLAND CEMENT CONCRETE SIDEWALK
- (H) CONCRETE MEDIAN
- (I) HOT-MIX ASPHALT SURFACE COURSE, 1 1/2"
- ① COMBINATION CONCRETE CURB AND GUTTER, TYPE B-9.12
- K HOT-MIX ASPHALT SHOULDER, 10"
- ASPHALT MEDIAN
- M CONCRETE MEDIAN SURFACE, 4"



SCALE: N.T.S.


REMOVAL ITEMS

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	PLOT DATE = 10/21/2010	DATE - 10-22-10	REVISED -

STATE OF ILLINOIS
DEPARTMENT OF TRANSPORTATION


PRATT BOULEVARD	
EXISTING TYPICAL SECTIONS	
NO. 2 OF 2 SHEETS	ŀ

F.A.P. RTE.		SI	EC.	TION				COUNT	Υ	TOTAL SHEET	s	SHEET NO.
344 09-00057-00-CH					T	COOK		103		12		
			T	CONTR	ACT	NO.	6	3523				
FFD. RI	DAD DIST.	NO.	1	THE	MOTS	FFD	ΔID	PROJECT	M-	9003/66	O)	

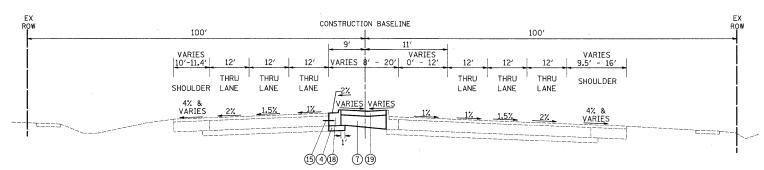


PROPOSED TYPICAL SECTION

BUSSE ROAD STATION 70+95.10 TO STATION 71+94.48

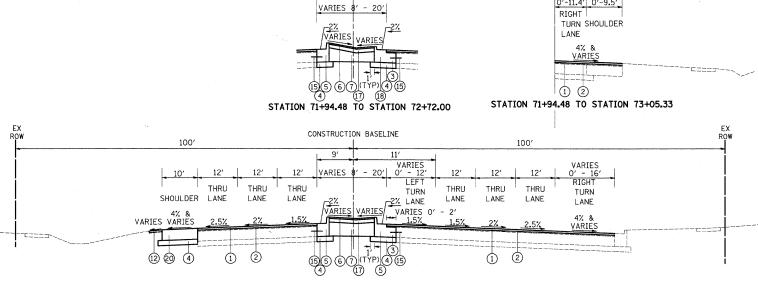

PROPOSED TYPICAL SECTION

BUSSE ROAD STATION 71+94.48 TO STATION 74+15.20

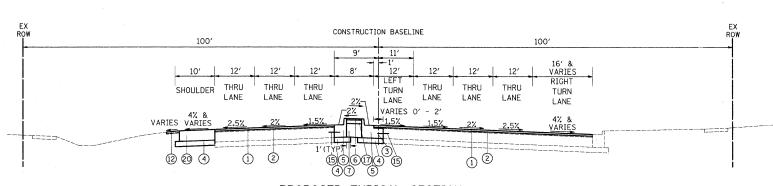

PROPOSED TYPICAL SECTION

BUSSE ROAD STATION 74+15.20 TO STATION 76+77.38

FILE NAME =	USER NAME = djk	DESIGNED - JAT	REVISED -
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	PLOT SCALE = 50.0000 '/ IN.	CHECKED - DJK	REVISED -
	PLOT DATE = 10/21/2010	DATE - 10-22-10	REVISED -

STATE OF ILLINOIS **DEPARTMENT OF TRANSPORTATION**

VARIES VARIES 0'-11.4' 0'-9.5'

IMERIZE	

LEGEND

- 1 POLYMERIZED HOT-MIX ASPHALT SURFACE COURSE, MIX F, N90, 1 3/4"
- (2) LEVELING BINDER (MACHINE METHOD), N70, 3/4" (MIN. & VARIES)
- (3) PORTLAND CEMENT CONCRETE BASE COURSE WIDENING, 10"
- 4 SUBBASE GRANULAR MATERIAL, TYPE B, 6"
- (5) COMBINATION CONCRETE CURB AND GUTTER, TYPE B-9.12
- (6) HOT SYNTHETIC PATTERNED TEXTURED PAVING, 3/4"
- 7 SUBBASE GRANULAR MATERIAL, TYPE B
- (8) PORTLAND CEMENT CONCRETE PAVEMENT, 10" (JOINTED)
- (9) COMBINATION CONCRETE CURB AND GUTTER, TYPE B-6.24
- 10 PORTLAND CEMENT CONCRETE SIDEWALK, 5" 11) SUBBASE GRANULAR MATERIAL, TYPE B 2"
- 12 TOPSOIL FURNISH AND PLACE, 4" SODDING
- (3) CONCRETE MEDIAN, TYPE SB-6.12 (SPECIAL)
- 14 NO. 6 EPOXY COATED, DEFORMED TIE BAR @ 24" C-C (PER STANDARD 606001) (INCLUDED IN THE COST OF COMBINATION CONCRETE CURB AND GUTTER, TYPE B-9.12 OR COMBINATION CONCRETE CURB AND GUTTER, TYPE B-6.24)
- (15) NO. 6 EPOXY COATED, DEFORMED TIE BAR, 24" LONG @ 24" C-C (DRILLED AND GROUTED) (EMBED 8" MINIMUM)
- (6) LONGITUDINAL JOINT (SEE JOINTING PLAN FOR REINFORCEMENT DETAILS)
- (17) HOT-MIX ASPHALT BINDER COURSE, IL-19.0, N50, 4"
- (8) COMBINATION CONCRETE CURB AND GUTTER, TYPE M-4.12
- (19) CONCRETE MEDIAN SURFACE, 4 INCH
- @ HOT-MIX ASPHALT SHOULDERS, 10"

CONTRACTOR SHALL MILL BEFORE PATCHING


HOT-MIX ASPHALT MIXTURE REQUIREMENTS

PAY ITEM	AIR VOIDS • Ndes
PAVEMENT RESURFACING	
POLYMERIZED HOT-MIX ASPHALT SURFACE COURSE, MIX "F", N9O (IL-9.5mm); 1 3/4"	4% @ 90 GYR.
LEVELING BINDER (MACHINE METHOD), N70; 3/4" (MIN. & VARIES)	4% @ 70 GYR.
TEMPORARY PAVEMENT	
HOT-MIX ASPHALT SURFACE COURSE, MIX "D", N50 (IL-9.5mm); 1 1/2"	4% e 50 GYR.
TEMPORARY PAVEMENT (HMA BINDER IL-19mm); 8 1/2"	4% © 50 GYR.
PATCHING	
CLASS D PATCHES (HMA BINDER IL-19mm); 10"	4% © 70 GYR.
MEDIAN	4
HOT-MIX ASPHALT BINDER COURSE, IL-19.0, N50; 4"	4% © 50 GYR.
INCIDENTAL HOT-MIX ASPHALT SURFACING	
HOT-MIX ASPHALT SURFACE, COURSE, IL-9.5, MIX "C", N5O (IL-9.5mm)	4% © 50 GYR.
SHOULDER	
HMA SHOULDER (HMA BINDER IL-19mm); 10"	2% @ 30 GYR.


SCALE: N.T.S.

- 1. THE UNIT WEIGHT TO CALCULATE ALL HOT-MIX ASPHALT SURFACE MIXTURES IS 112 LB/SY-IN.
- THE "AC TYPE" FOR POLYMERIZED HMA MIXES SHALL BE "SBS/SBR PG 70-22" AND FOR NON-POLYMERIZED HMA THE "AC TYPE" SHALL BE "PG 64-22" UNLESS MODIFIED BY DISTRICT ONE SPECIAL PROVISIONS. FOR "PERCENT OF RAP" SEE DISTRICT ONE SPECIAL PROVISIONS.

IL ROUTE 83 (BUSSE ROAD)	F.A.P. RTE.	SE	CTION		COUNTY	TOTAL SHEETS	SHEE NO.
PROPOSED TYPICAL SECTIONS	344	09-00	057-00-CH	ł	СООК	103	13
					CONTRAC	CT NO.	63523
SHEET NO. 1 OF 2 SHEETS	FED. RO	OAD DIST. NO.	1 ILLINOIS	FED. A	ID PROJECT	M-9003(660))

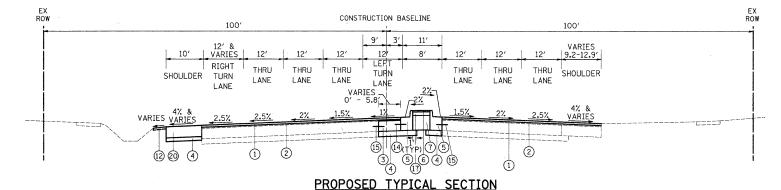


BUSSE ROAD STATION 76+77.38 TO STATION 80+30.53

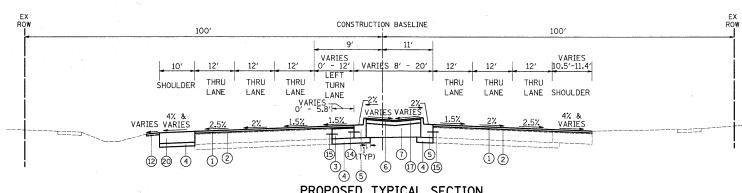

PROPOSED TYPICAL SECTION


BUSSE ROAD STATION 80+30.53 TO STATION 82+50.53

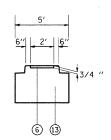


CONCRETE MEDIAN, TYPE SB-6.12 (SPECIAL) DETAIL

LEGEND


- 1) POLYMERIZED HOT-MIX ASPHALT SURFACE COURSE, MIX F, N90, 1 3/4"
- (2) LEVELING BINDER (MACHINE METHOD), N70, 3/4" (MIN. & VARIES)
- 3 PORTLAND CEMENT CONCRETE BASE COURSE WIDENING, 10"
- (4) SUBBASE GRANULAR MATERIAL, TYPE B, 6"
- 5 COMBINATION CONCRETE CURB AND GUTTER, TYPE B-9.12
- (6) HOT SYNTHETIC PATTERNED TEXTURED PAVING, 3/4"
- (7) SUBBASE GRANULAR MATERIAL, TYPE B
- (8) PORTLAND CEMENT CONCRETE PAVEMENT, 10" (JOINTED)
- (9) COMBINATION CONCRETE CURB AND GUTTER, TYPE B-6.24
- 10 PORTLAND CEMENT CONCRETE SIDEWALK, 5"
- (11) SUBBASE GRANULAR MATERIAL, TYPE B 2"
- 12 TOPSOIL FURNISH AND PLACE, 4"
- (13) CONCRETE MEDIAN, TYPE SB-6.12 (SPECIAL)
- 14 NO. 6 EPOXY COATED, DEFORMED TIE BAR @ 24" C-C (PER STANDARD 606001) (INCLUDED IN THE COST OF COMBINATION CONCRETE CURB AND GUTTER, TYPE B-9.12 OR COMBINATION CONCRETE CURB AND GUTTER, TYPE B-6.24)
- (15) NO. 6 EPOXY COATED, DEFORMED TIE BAR, 24" LONG @ 24" C-C (DRILLED AND GROUTED) (EMBED 8" MINIMUM)
- (6) LONGITUDINAL JOINT (SEE JOINTING PLAN FOR REINFORCEMENT DETAILS)
- 17 HOT-MIX ASPHALT BINDER COURSE, IL-19.0, N50, 4"
- (18) COMBINATION CONCRETE CURB AND GUTTER, TYPE M-4.12
- (19) CONCRETE MEDIAN SURFACE, 4 INCH
- (0) HOT-MIX ASPHALT SHOULDERS, 10"

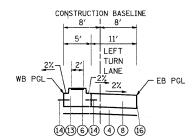

STATION 407+68.00 TO STATION 408+75.58

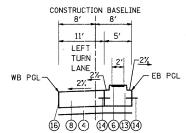

STATION 410+63.82 TO STATION 412+98.74

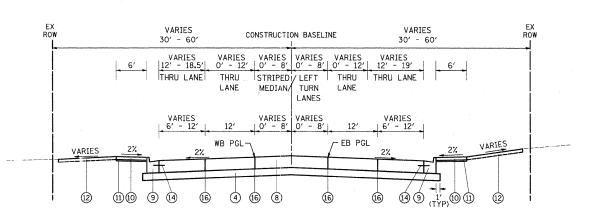

PROPOSED TYPICAL SECTION

PRATT BOULEVARD
STATION 401+27.62 TO STATION 415+68.82

FILE NAME =	USER NAME = djk	DESIGNED -	JAT	REVISED -			PRATT BOULEVARD		F.A.P. RTE.	SECTION	COUNTY	TOTAL	SHEET NO.	
\cad\sheet\2363_typ_PROP_2.dgn		DRAWN -	JAT	REVISED -	STATE OF ILLINOIS	PROPOSED TYPICAL SECTIONS			344	09-00057-00-CH	COOK	103	14	
	PLOT SCALE = 50,0000 '/ IN.	CHECKED	DJK	REVISED -	DEPARTMENT OF TRANSPORTATION		FROTOSED TIFICAL SECTIONS	Ī	CONTRACT NO. 63					
	PLOT DATE = 10/21/2010	DATE -	10-22-10	REVISED -		SCALE: N.T.S. SHEET NO. 2 OF 2 SHEETS			FED. ROAD	DIST. NO. 1 ILLINOIS FED.	ILLINOIS FED. AID PROJECT M-9003(660)			

EAR	EARTHWORK SCHEDULE - GREENLEAF AVENUE										
		STAGE 1	STAGE 2	STAGE 3							
ITEM	UNIT										
EARTH EXCAVATION	C.Y.	457	540	646							
EARTH EXCAVATION ADJUSTED FOR SHRINKAGE	C.Y.	389	459	549							
EMBANKMENT REQUIRED	C.Y.	246	785	9							
EARTHWORK BALANCE WASTE (+) OR SHORTAGE (-)	C.Y.	+143	-326	+540							

EARTHWO	RK SCHEDULE -	IL ROUTE 83 (BI	JSSE ROAD)	
		STAGE 1	STAGE 2	STAGE 3
ITEM	UNIT	·		V - 1
EARTH EXCAVATION	C.Y.	***	-	905
EARTH EXCAVATION ADJUSTED FOR SHRINKAGE	C.Y.	-	-	769
EMBANKMENT REQUIRED .	C.Y.	-	. –	69
EARTHWORK BALANCE WASTE (+) OR SHORTAGE (-)	C.Y.	-	-	+700


SHRINKAGE CALCULATED USING 15% SHRINKAGE FACTOR


A PAY ITEM FOR "FURNISHED EXCAVATION" HAS BEEN INCLUDED ON THE ASSUMPTION THAT, DUE TO LIMITED WORKING SPACE, ALL EMBANKMENT MAY HAVE TO BE BROUGHT IN FROM OUTSIDE THE PROJECT LIMITS.


SCHEDULE	OF DRIVEWAY PAVEMENT REM	MOVAL & REPLACEMENT
STATION	DRIVEWAY	PCC DW, 8",
	PAVEMENT REMOVAL	SPECIAL
402+12, LT	103 SY	106 SY
402+19, RT	112 SY	176 SY
402+87, RT*	38 SY	0 SY
403+50, RT	62 SY	64 SY
404+66, LT	75 SY	75 SY
405+08, RT	112 SY	113 SY
406+70, RT	. 109 SY	120 SY
407+65, RT	31 SY	34 SY
410+95, LT	127 SY	109 SY.
412+15, RT	52 SY	61 SY
413+25, LT	117 SY	113 SY
413+38, RT	58 SY	65 SY
415+05, RT	103 SY	115 SY
415+34, LT	141 SY	128 SY


^{*}PROPOSED DRIVEWAY AREA COMBINED WITH DRIVEWAY AT 402+19, RT


- 1	FILE NAME =	USER NAME = 61a	DESIGNED - JAT	REVISED -			F.A.P.	CECTION	COUNTY	TOTAL	SHEET
	\cad\sheet\2363_schedule.dgn		DRAWN - JAT	REVISED -	STATE OF ILLINOIS	SCHEDULE OF QUANTITIES	RTE.	SECTION	COUNTY	SHEETS	NO.
		PLOT SCALE = 50.0000 '/ IN.	CHECKED - DJK	REVISED -	DEPARTMENT OF TRANSPORTATION		334	09-00057-00-CH	CONTRAC	103	15
L		PLOT DATE = 10/22/2010	DATE - 10-22-10	REVISED		SHEET NO. 1 OF 1 SHEETS	FED. ROAD	DIST. NO. 1 ILLINOIS FED. A	ID PROJECT M-		3323

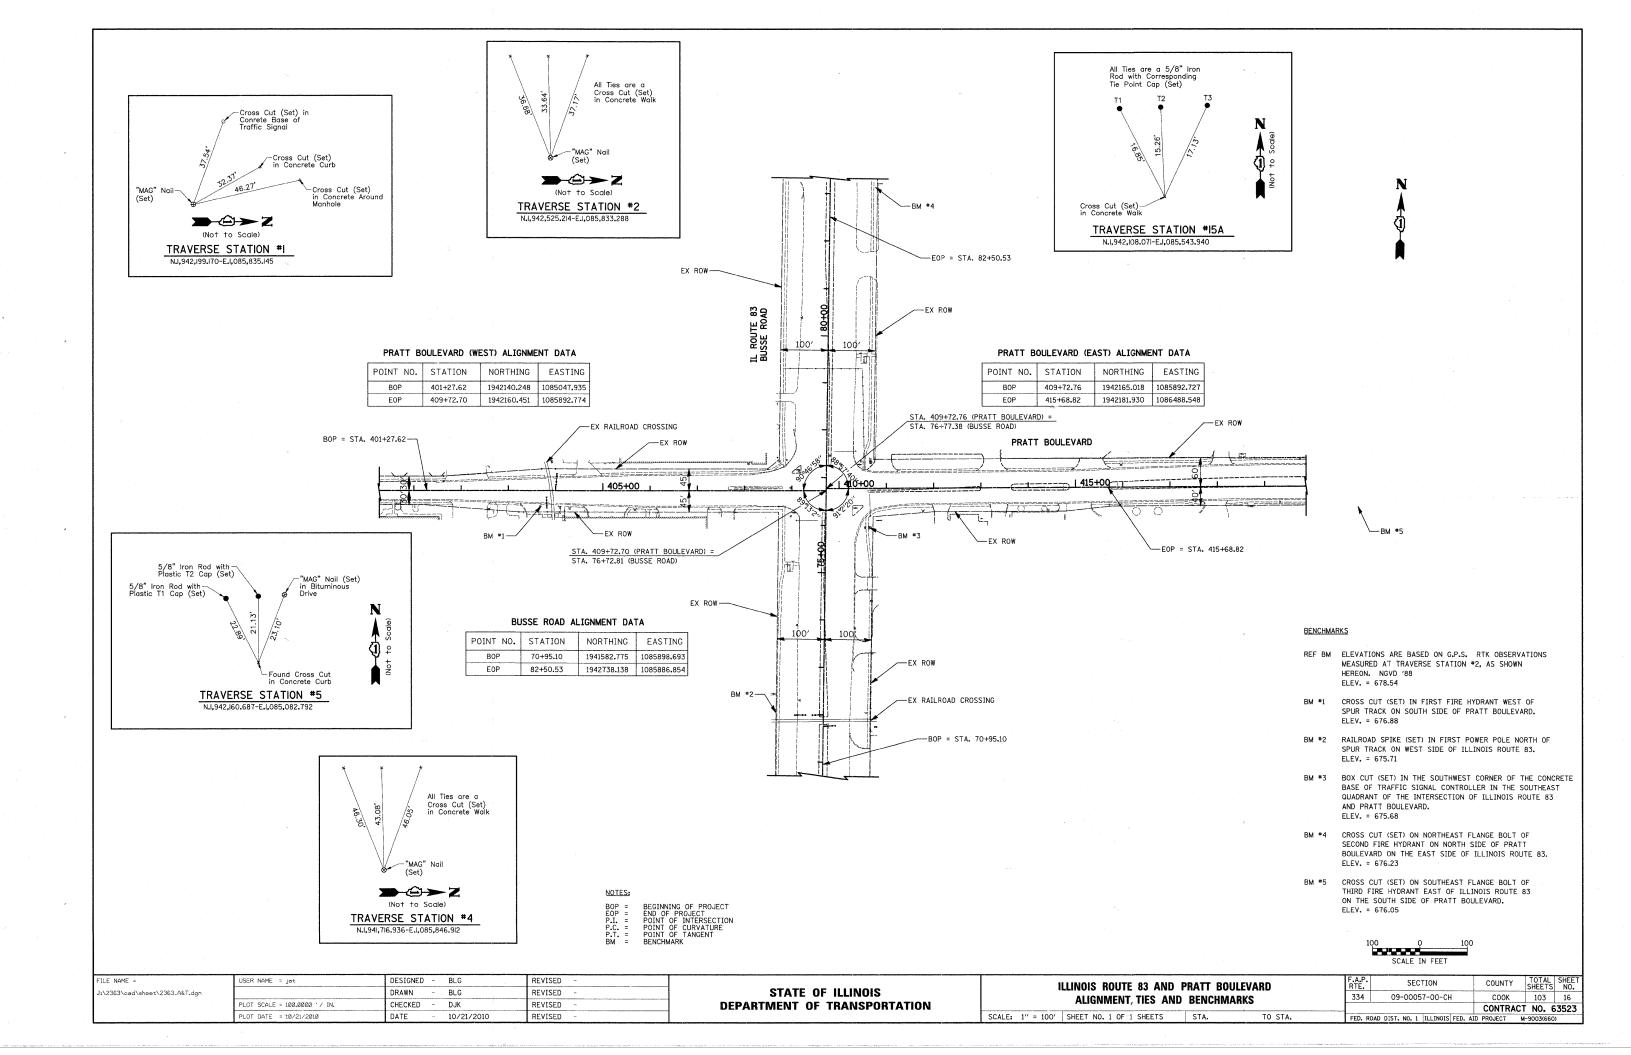


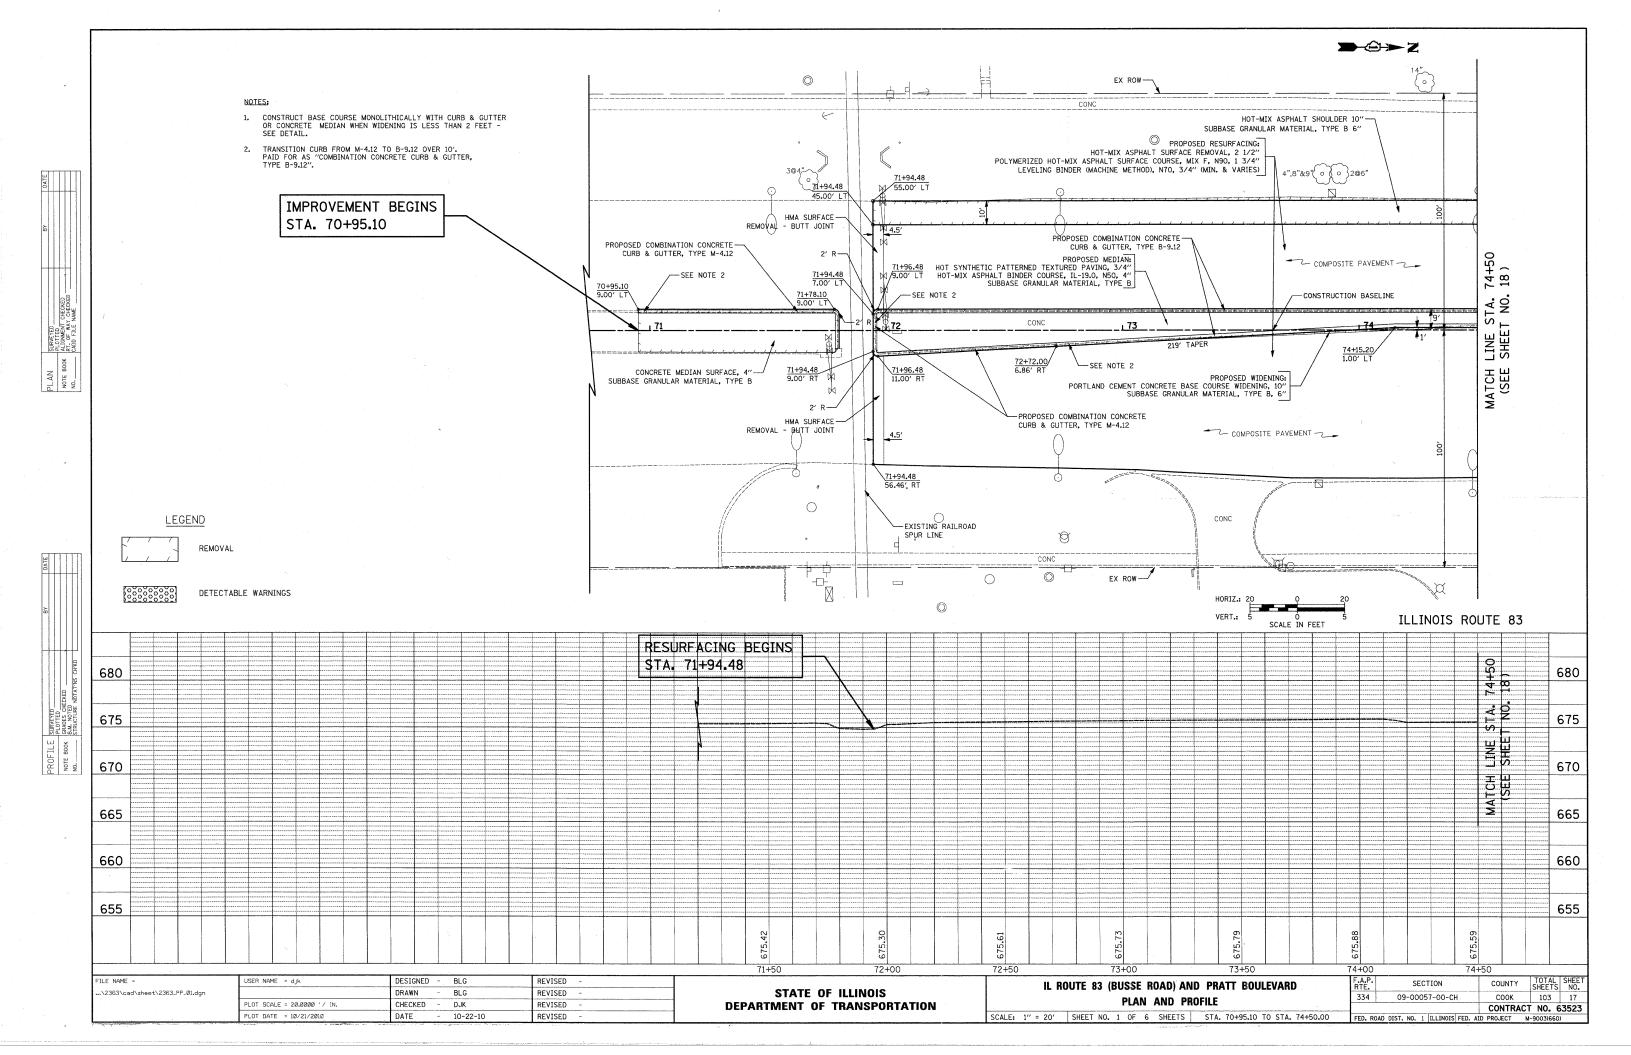


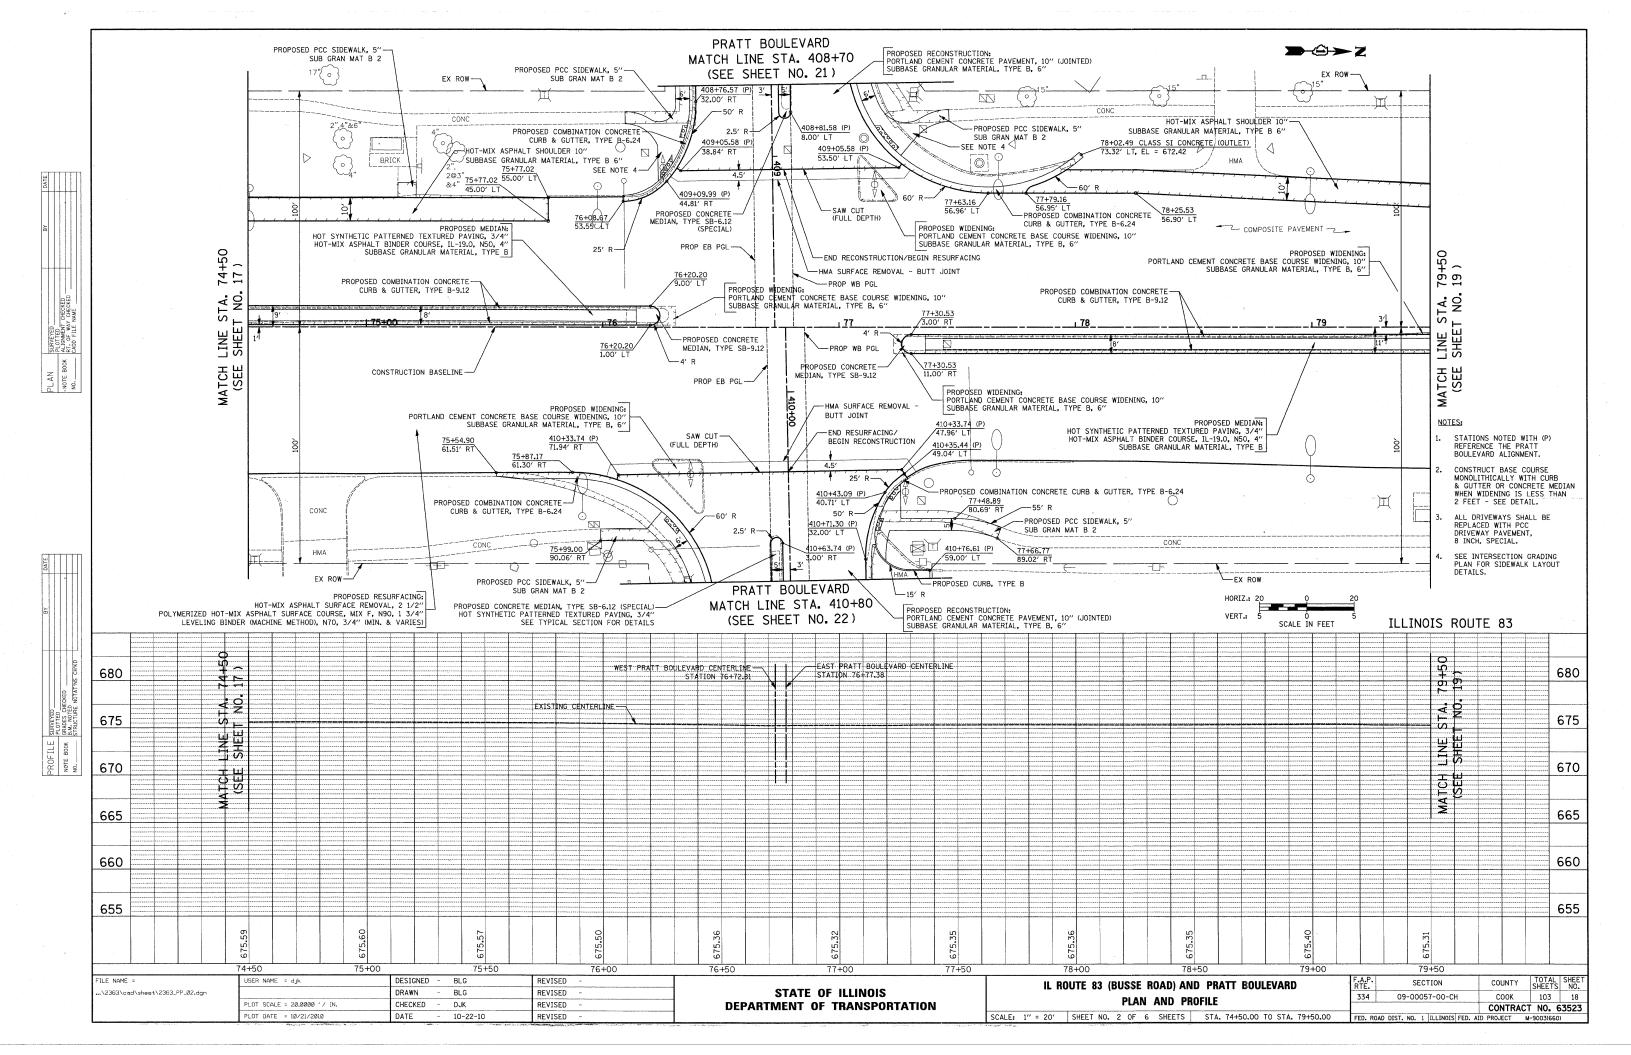

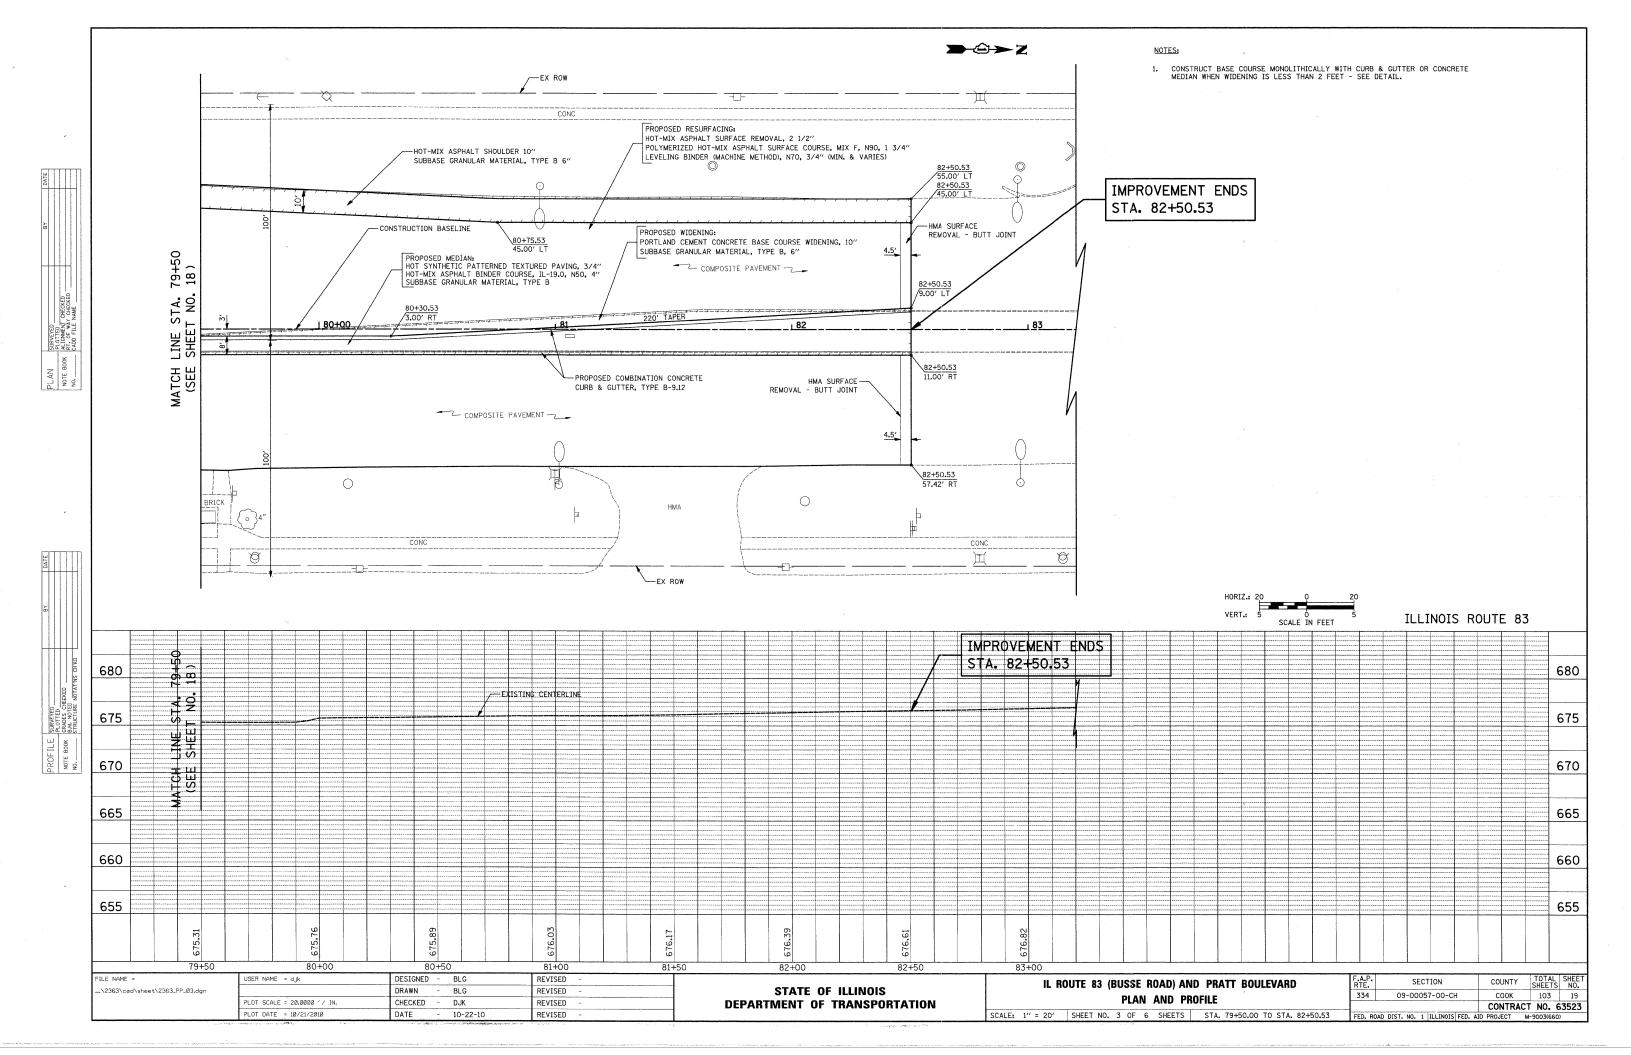

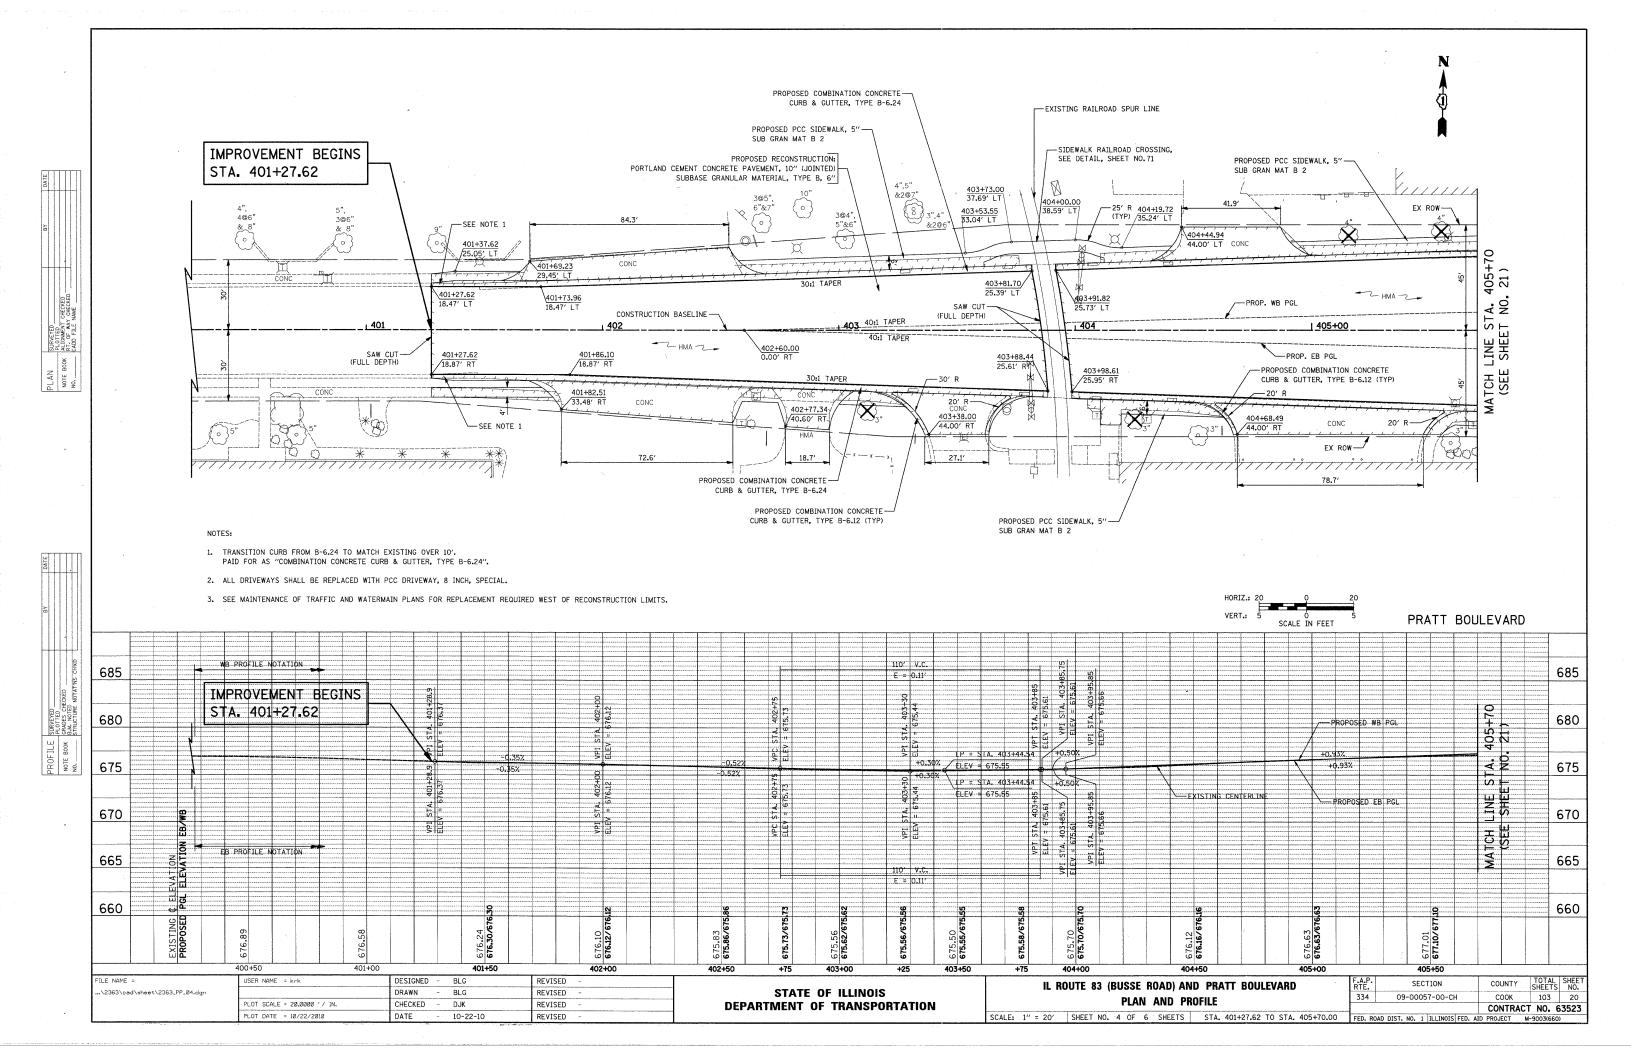

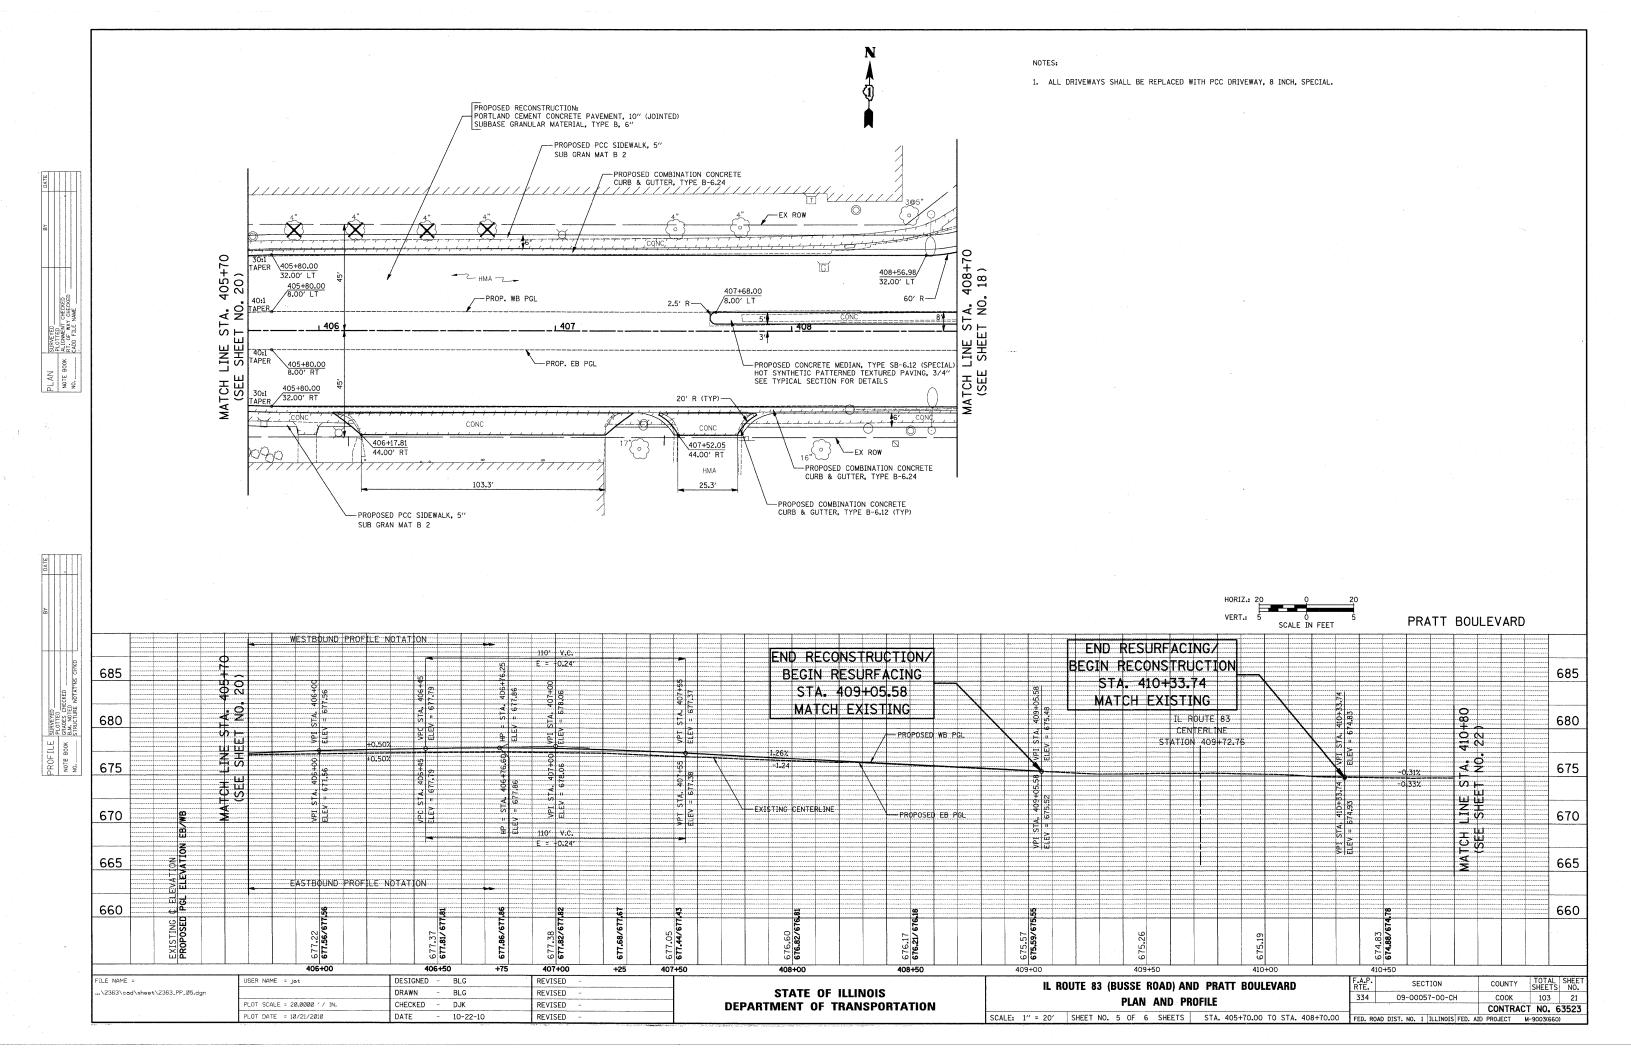

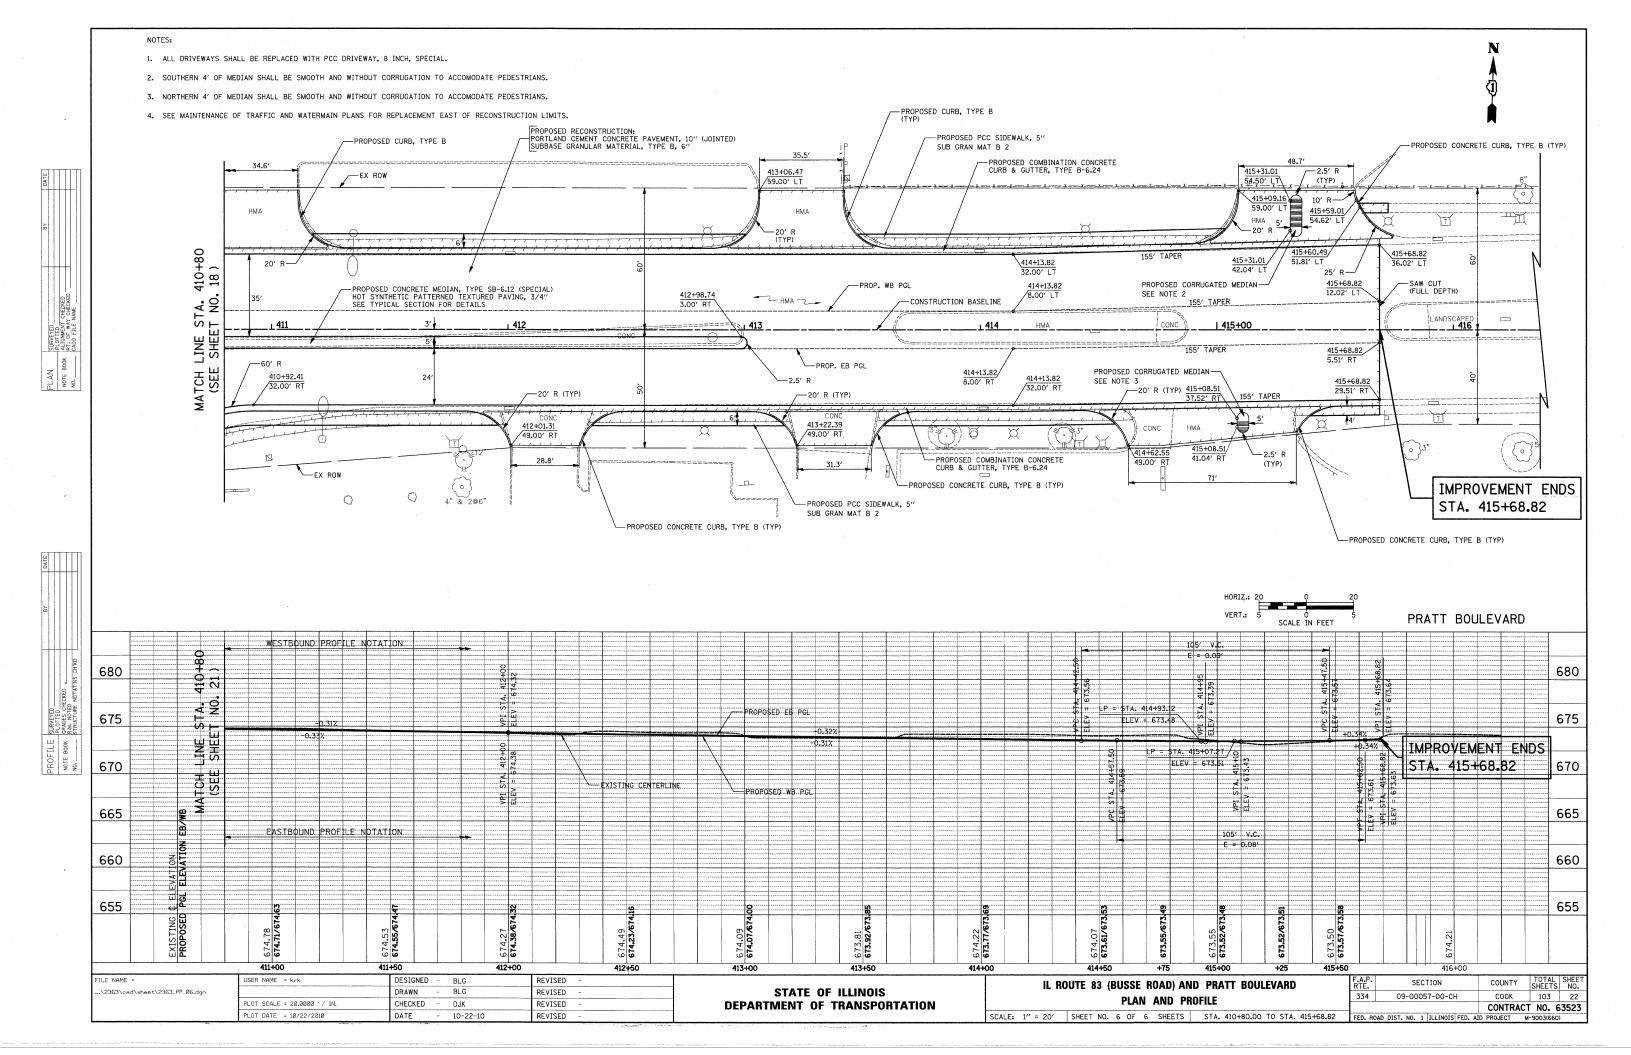

ACCESS MAINTENANCE NOTES

MAINTAINING ACCESS TO PRIVATE DRIVEWAYS IS OF THE UTMOST IMPORTANCE. ACCESS TO ALL PROPERTIES SHALL BE MAINTAINED AT ALL TIMES. THE CONTRACTOR SHALL BE RESPONSIBLE FOR SUB-STAGING THE CONSTRUCTION OF DRIVEWAYS. THE CONTRACTOR SHALL FOLLOW THESE PROCEDURES TO ENSURE PROPER DRIVEWAY ACCESS:

- THE CONTRACTOR SHALL WORK WITH ADJACENT BUSINESS OWNERS TO DETERMINE DRIVEWAY RECONSTRUCTION SCHEDULING. ALL DRIVEWAY CLOSURES SHALL BE APPROVED BY THE ENGINEER.
- TEMPORARY DRIVES SHALL BE CONSTRUCTED USING 100% RECYCLED ASPHALT PAVEMENT. THE WIDTH OF THE DRIVE SHALL BE DETERMINED BY THE ENGINEER. THE CONTRACTOR SHALL NOTE THAT THE TEMPORARY DRIVEWAY WIDTH MAY EXCEED THE WIDTH OF THE EXISTING DRIVEWAY IN ORDER TO ALLOW FOR SEMI-TRAILERS TO BACK INTO THE

THE COST OF PLACING, MAINTAINING AND REMOVING TEMPORARY DRIVES SHALL BE INCLUDED IN THE COST OF "TEMPORARY ACCESS (COMMERCIAL ENTRANCE)".

IT MAY BE NECESSARY TO CONSTRUCT TEMPORARY PADS IN THE CONSTRUCTION ZONE FOR DRIVEWAYS ON THE OPPOSITE SIDE OF THE ROAD. THESE PADS MAY BE NECESSARY FOR SEMI-TRAILERS TO BACK INTO THE LOADING DOCKS. THE ENGINEER SHALL DIRECT THE CONTRACTOR AS TO THE LOCATIONS AND SIZES OF THESE PADS. THE COST OF PLACING THESE TEMPORARY PADS SHALL NOT BE PADID FOR SEPARATIELY BUT INCLUDED IN THE COST OF THE TEMPORARY ACCESS FOR THE LOADING DOCK OR DRIVEWAY.

- A 4" PVC DRAIN SHALL BE PLACED UNDER TEMPORARY DRIVES TO PROVIDE POSITIVE DRAINAGE WHEN THE ROADWAY IS EXCAVATED. THE COST OF THIS WORK SHALL BE INCLUDED IN THE COST OF "DRIVEWAY PAVEMENT REMOVAL".
- OUANTITIES FOR HIGH-EARLY-STRENGTH PORTLAND CEMENT CONCRETE PAVEMENT 10" (JOINTED) AND COMBINATION CONCRETE CURB AND GUTTER, TYPE B-6.24 (SPECIAL) HAVE BEEN INCLUDED FOR USE IN FRONT OF THE DRIVEWAYS IN ORDER TO EXPEDITE THE COMPLETION OF THIS WORK. THESE ITEMS SHALL ONLY BE USED WHEN APPROVED BY THE
- ALL BARRICADES REQUIRED TO SUB-STAGE DRIVEWAY CONSTRUCTION AND MAINTAIN ACCESS TO DRIVEWAYS SHALL BE INCLUDED IN THE COST OF "TRAFFIC CONTROL AND PROTECTION, (SPECIAL)".

EXCEPT FOR APPROVED CLOSURES AS DEPICTED ON THE MAINTENANCE OF TRAFFIC PLANS, ALL ROADS SHALL BE KEPT OPEN TO TRAFFIC DURING THE ENTIRE CONSTRUCTION PERIOD. THE CONTRACTOR MAY CLOSE ONE LANE OF TRAFFIC (BECAUSE OF CONSTRUCTION) ONLY BETWEEN THE HOURS OF 9:00 A.M. AND 3:00 P.M.

WHEN NECESSARY TO CLOSE ONE LANE OF THE ROADWAY ON TWO-LANE ROADS, THE CONTRACTOR SHALL MAINTAIN TWO-WAY TRAFFIC DURING THE RESTRICTED HOURS WITH THE USE OF SIGNS AND FLAGEGRS AS SHOWN ON THE TRAFFIC CONTROL STANDARDS. WHEN NECESSARY TO CLOSE ONE LANE OF THE ROADWAY ON FOUR-LANE ROADS, THE CONTRACTOR SHALL MAINTAIN TWO-WAY TRAFFIC DURING THE RESTRICTED HOURS WITH THE USE OF SIGNS AND BARRICADES AS SHOWN ON THE TRAFFIC CONTROL STANDARDS. ALL EXISTING LANES OF TRAFFIC IN EACH DIRECTION WILL BE MAINTAINED BETWEEN 3:00 P.M. AND 9:00 A.M. AND WHEN NO CONSTRUCTION ACTIVITIES ARE BEING CARRIED ON. THE ENGINEER MAY WAIVE THE LANE CLOSURE TIME RESTRICTION AT HIS DISCRETION.


THE CONTRACTOR SHALL LIMIT ANY DROP-OFF BETWEEN LANES TO 1-1/2" DURING ANY

TEMPORARY PAVEMENT FOR ALL STAGES SHALL CONSIST OF THE FOLLOWING:

HOT-MIX ASPHALT SURFACE COURSE, MIX "D", N50 (IL-9.5 mm 8.5" TEMP PAVEMENT (HMA BINDER IL-19 mm)

8" PORTLAND CEMENT CONCRETE BASE COURSE

FRESH W21-2 OIL 48"X48" DATE XX-XX-XX 9"X30"

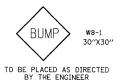

PRE-STAGE 1 (NOT SHOWN)

- 1. INSTALL AND ACTIVATE TEMPORARY TRAFFIC SIGNALS AT THE INTERSECTION OF IL ROUTE 83 AND PRATT BOULEVARD. (NOTE: THE EXISTING SIGNALS SHALL BE TURNED OFF AT THE SAME TIME THE TEMPORARY SIGNALS ARE ACTIVATED.)
- 2. REMOVE EXISTING SIGNAL POLES AND EQUIPMENT.

3. REMOVE EXISTING BARRIER MEDIANS ON PRATT BOULEVARD, AND CURB AND GUTTER, SIDEWALKS, AND DRIVEWAYS IN AREAS REQUIRING TEMPORARY PAVEMENT. PLACE TEMPORARY PAVEMENT. THIS WORK SHALL BE PERFORMED USING DAILY LANE CLOSURES IN ACCORDANCE WITH IDOT HIGHWAY STANDARDS 701501 AND 701601.

STAGE 1

1. PLACE ALL CONSTRUCTION SIGNS, TEMPORARY PAVEMENT MARKINGS, AND BARRICADES. SHIFT TRAFFIC AS INDICATED.

2. REMOVE EXISTING PAVEMENT, CURB AND GUTTER AND DRIVEWAYS ON THE SOUTH SIDE OF PRATT BOULEVARD.

4. CONSTRUCT WATERMAIN AND STORM SEWER LATERALS ACROSS PRATT BOULEVARD. DAILY LANE CLOSURES IN ACCORDANCE WITH IDOT STANDARD 701501 SHALL BE ALLOWED BETWEEN THE HOURS OF 9:00 AM AND 3:00 PM. TRENCHES SHALL NOT BE LEFT IN STONE OVERNIGHT. THE CONTRACTOR SHALL CONSTRUCT, REPAIR AND MAINTAIN THE TRENCHES WITH CLASS D PATCHES, 10 INCH. THE CONTRACTOR SHALL ENSURE POSITIVE DRAINAGE IS PROVIDED TO THE NEW STORM SEWER STRUCTURES ON BOTH SIDES OF PRATT BOULEVARD.

3. CONSTRUCT CURB AND GUTTER, CONCRETE PAVEMENT, SIDEWALK AND ENTRANCES AS SHOWN.

4. REDUCE RADIUS AT THE SOUTHEAST CORNER TO COMPLETE CONSTRUCTION AT THE INTERSECTION. THE RADIUS SHALL ONLY BE REDUCED FOR A MAXIMUM OF 7 CALENDAR

5. CONSTRUCT TEMPORARY PAVEMENT REQUIRED FOR STAGE 2 CONSTRUCTION USING DAILY LANE CLOSURES IN ACCORDANCE WITH IDOT HIGHWAY STANDARDS 701501.

1. PLACE ALL CONSTRUCTION SIGNS, TEMPORARY PAVEMENT MARKINGS, AND BARRICADES AND SHIFT EASTBOUND TRAFFIC AS INDICATED.

- 2. CONSTRUCT CONCRETE PAVEMENT AS SHOWN.
- 3. THE MAXIMUM DURATION FOR THIS STAGE SHALL BE 7 CALENDAR DAYS.

1. PLACE ALL CONSTRUCTION SIGNS, TEMPORARY PAVEMENT MARKINGS, AND BARRICADES. ADJUST TEMPORARY TRAFFIC SIGNALS AND SHIFT TRAFFIC AS INDICATED.

REMOVE EXISTING PAVEMENT, CURB AND GUTTER AND DRIVEWAYS ON THE NORTH SIDE OF

3. CONSTRUCT CURB AND GUTTER, CONCRETE PAVEMENT, SIDEWALK AND ENTRANCES AS SHOWN.

4. REDUCE RADIUS AT THE NORTHWEST CORNER TO COMPLETE CONSTRUCTION AT THE INTERSECTION. THE RADIUS SHALL ONLY BE REDUCED FOR A MAXIMUM OF 7 CALENDAR

STAGE 3

1. PLACE ALL CONSTRUCTION SIGNS, TEMPORARY PAVEMENT MARKINGS, AND BARRICADES. ADJUST TEMPORARY TRAFFIC SIGNALS AND SHIFT TRAFFIC AS INDICATED.

3. CONSTRUCT TURN LANE AND MEDIAN ON PRATT BOULEVARD. RESTORE AREAS BEYOND RECONSTRUCTION LIMIT AFFECTED BY THE TEMPORARY PAVEMENT.

- 4. REMOVE EXISTING MEDIAN AND CURB AND GUTTER ON IL ROUTE 83.
- 5. CONSTRUCT CURB AND GUTTER AND BASE COURSE WIDENING ON IL ROUTE 83. DAILY LANE CLOSURES WILL BE ALLOWED BETWEEN THE HOURS OF 9:00 AM AND 3:00 PM IN ACCORDANCE WITH IDOT HIGHWAY STANDARDS 701421.

6. REMOVE AND REPLACE SHOULDERS AT LOCATIONS SHOWN ON THE PLAN AND PROFILE SHEETS ON IL ROUTE 83. DAILY LANE CLOSURES WILL BE ALLOWED BETWEEN THE HOURS OF 9:00 AM AND 3:00 PM IN ACCORDANCE WITH IDOT HIGHWAY STANDARDS 701421.

- 8. MILL EXISTING PAVEMENT ON IL ROUTE 83.

9. PLACE LEVEL BINDER AND SURFACE COURSE ON IL ROUTE 83 MAINTAINING TRAFFIC PER STANDARD 701421.

10. PLACE PERMANENT PAVEMENT MARKINGS, RAISED REFLECTIVE PAVEMENT MARKERS AND SIGNS.

11. INSTALL AND ACTIVATE TRAFFIC SIGNALS AT THE INTERSECTION OF IL ROUTE 83 AND PRATT BOULEVARD. (NOTE: THE TEMPORARY SIGNALS SHALL BE TURNED OFF AT THE SAME TIME THE PERMANENT SIGNALS ARE ACTIVATED.)

12. REMOVE CONSTRUCTION SIGNS AND OPEN ALL LANES TO TRAFFIC.

MAINTENANCE OF TRAFFIC GENERAL NOTES

- TRAFFIC CONTROL DEPICTED IN THESE PLANS AND THE APPLICABLE IDOT DETAILS AND STANDARDS ARE THE MINIMUM REQUIREMENTS. OTHER WORK OR SIGNING MAY BE REQUIRED BY THE ENGINEER. TRAFFIC CONTROL AND PROTECTION SHALL BE PERFORMED IN ACCORDANCE WITH THE STANDARD SPECIFICATIONS, DIVISION 700, APPLICABLE GUIDELINES IN THE ILLINOIS MANUAL ON UNIFORM TRAFFIC CONTROL DEVICES FOR STREETS AND HIGHWAYS; AND APPLICABLE HIGHWAY STANDARDS FOR TRAFFIC CONTROL, INJECSE HEPEIN DEVICED
- THE EXACT NUMBER, LOCATION AND SPACING OF ALL SIGNS AND TRAFFIC CONTROL DEVICES SHALL FIT FIELD CONDITIONS AS DIRECTED BY THE ENGINEER.
- 3. ALL CONSTRUCTION SIGNS SHALL HAVE FLUORESCENT ORANGE BACKGROUNDS
- 4. ALL SIGNS SHALL BE MOUNTED ON METAL POSTS, 7 FEET ABOVE THE EXISTING GROUND AND DRIVEN A MINIMUM OF 3 FEET INTO THE GROUND. A J.U.L.I.E. LOCATE SHALL BE PERFORMED PRIOR TO THE INSTALLATION OF THE POSTS.
- 5. BARRICADES WITH MONO-DIRECTIONAL STEADY-BURN LIGHTS WILL BE REQUIRED ADJACENT TO PAVEMENT EDGES WHERE WIDENING, CURB AND GUTTER OR OVERLAYING WORK IS BEING DONE, AS SPECIFIED IN SECTION 701 OF THE STANDARD SPECIFICATIONS. SPACING SHALL BE AS SHOWN ON THE CONSTRUCTION STAGING PLANS UNLESS OTHERWISE DIRECTED BY THE ENGINEER. BARRICADES THAT MUST BE PLACED IN EXCAVATED AREAS SHALL HAVE LEG EXTENSIONS INSTALLED SUCH THAT THE TOPS OF THE BARRICADES ARE IN COMPLIANCE WITH THE HEIGHT REQUIREMENTS OF STANDARD 701901. WITH THE HEIGHT REQUIREMENTS OF STANDARD 701901.
- ALL BARRICADES OR DRUMS AT LANE DIVERSIONS WITHIN TAPER SECTIONS SHALL HAVE DIRECTION INDICATOR PANELS.
- BARRICADES OR DRUMS EQUIPPED WITH ONE-WAY FLASHING LIGHTS WILL BE REQUIRED AT ALL OPEN TRENCHES, EXCAVATIONS, OPEN OR EXPOSED SEWER STRUCTURES, AND AT ANY OTHER LOCATIONS DESIGNATED BY THE ENGINEER OR LAW ENFORCEMENT AGENCIES. BARRICADES SHALL BE PLACED AT 50' CENTERS ALONG TANGENTS, 25' ALONG TAPERS AND 10' AROUND RADII.
- DRUMS SHALL HAVE ALTERNATING REFLECTORIZED TYPE AA OR TYPE AP FLUORESCENT ORANGE AND REFLECTORIZED WHITE HORIZONTAL, CIRCUMFERENTIAL STRIPES.
- DRUMS AND BARRICADES SHALL MEET THE REQUIREMENTS OF THE NATIONAL COOPERATIVE HIGHWAY RESEARCH PROGRAM (NCHRP) REPORT 350 AND THE SUPPLEMENTAL SPECIAL PROVISION "WORK ZONE TRAFFIC CONTROL DEVICES".
- 10. TYPE III BARRICADES ARE TO BE PLACED IN ACCORDANCE WITH STANDARD 701901 UNLESS AUTHORIZED BY THE ENGINEER TO USE AN ALTERNATE ARRANGEMENT.
- 11. THE CONTRACTOR SHALL INFORM THE ENGINEER OF ANY STAGE CHANGE AT LEAST TWO WEEKS IN ADVANCE OF THE CHANGE.
- 12. EXISTING TRAFFIC CONTROL SIGNS AND DEVICES SHALL BE REMOVED OR RELOCATED BY THE CONTRACTOR AFTER THE TRAFFIC CONTROL REQUIREMENTS ARE MET OR AS AUTHORIZED BY THE ENGINEER; ANY SIGNS OR DEVICES LEFT IN PLACE ARE TO BE PROTECTED FROM DAMAGE AND MAINTAINED. ANY DAMAGE CAUSED BY HIS WORK SHALL BE REPAIRED TO THE SATISFACTION OF THE ENGINEER AT THE EXPENSE OF THE CONTRACTOR.
- 13. THE FIRST TWO WARNING SIGNS IN EACH DIRECTION OF TRAVEL SHALL BE EQUIPPED WITH MONO-DIRECTIONAL AMBER FLASHING LIGHTS DURING HOURS OF DARKNESS, FLAGS ARE OPTIONAL.
- 14. EXCEPT FOR APPROVED CLOSURES AS DEPICTED ON THE MAINTENANCE OF TRAFFIC PLANS, ALL ROADS SHALL BE KEPT OPEN TO TRAFFIC DURING THE ENTIRE CONSTRUCTION PERIOD. THE CONTRACTOR MAY CLOSE ONE LANE OF TRAFFIC (BECAUSE OF CONSTRUCTION) ONLY BETWEEN THE HOURS OF 9:00 AM AND 3:00 PM.

WHEN NECESSARY TO CLOSE ONE LANE OF THE ROADWAY ON TWO-LANE ROADS, THE CONTRACTOR SHALL MAINTAIN TWO-WAY TRAFFIC DURING THE RESTRICTED HOURS WITH THE USE OF SIGNS AND FLAGGERS AS SHOWN ON THE TRAFFIC CONTROL STANDARDS. WHEN NECESSARY TO CLOSE ONE LANE OF THE ROADWAY ON FOUR-LANE ROADS, THE CONTRACTOR SHALL MAINTAIN TWO-WAY TRAFFIC DURING THE RESTRICTED HOURS WITH THE USE OF SIGNS AND BARRICADES AS SHOWN ON THE TRAFFIC CONTROL STANDARDS. ALL EXISTING LANES OF TRAFFIC IN EACH DIRECTION SHALL BE MAINTAINED BETWEEN 3:00 PM AND 9:00 AM WHEN NO CONSTRUCTION ACTIVITIES ARE BEING CARRIED ON. THE ENGINEER MAY WAIVE THE LANE CLOSURE TIME RESTRICTION AT HIS DISCRETION.


- 15. "WORKERS" SIGNS SHALL ONLY BE ERECTED WHEN WORKERS ARE PRESENT. SIGN MUST BE COVERED OR REMOVED WHEN NO WORKERS ARE PRESENT.
- 16. "FRESH OIL" SIGNS (W21-2-4848) WITH DATE SIGNS SHALL BE ERECTED 48 HOURS PRIOR TO PRIMING ALONG IL ROUTE 83. THE COST OF THESE SIGNS SHALL BE INCLUDED IN THE PAY ITEM "TRAFFIC CONTROL AND PROTECTION, (SPECIAL)".
- 17. THE CONTRACTOR SHALL ERECT TEMPORARY STREET NAME SIGNS ON METAL POSTS THROUGHOUT CONSTRUCTION TO THE SATISFACTION OF THE ENGINEER. THE COST OF THESE SIGNS SHALL BE INCLUDED IN THE PAY ITEM "TRAFFIC CONTROL AND PROTECTION, (SPECIAL)".
- 18. TEMPORARY PAVEMENT MARKING TAPE SHALL BE USED ON ALL SURFACES OUTSIDE OF THE PROJECT LIMITS AND ON THE FINAL PAVEMENT SURFACE. THIS WORK SHALL BE PAID FOR AS "WET TEMPORARY PAVEMENT MARKING TAPE, TYPE III" OF THE SIZE SPECIFIED.
- 19. ARROW BOARDS WILL BE REQUIRED WHEN IMPLEMENTING ALL LANE CLOSURES, AND SHALL BE INCLUDED IN THE PAY ITEM "TRAFFIC CONTROL AND PROTECTION, (SPECIAL)"
- 20. THE COST OF SUPPLYING, ERECTING, AND MAINTAINING BARRICADES, DRUMS,
 WARNING LIGHTS, AND SIGNS SHALL BE INCLUDED IN THE COST OF "TRAFFIC CONTROL
 AND PROTECTION, (SPECIAL)". QUANTITIES FOR SHORT-TERM PAKEMENT MARKINGS,
 TEMPORARY PAYEMENT MARKINGS, AND WORK ZONE PAYEMENT MARKING REMOVAL ARE NOT
 INCLUDED IN THE ITEM "TRAFFIC CONTROL AND PROTECTION, (SPECIAL)" AND SHALL BE
 MEASURED SEPARATELY END PAYMENT MEASURED SEPARATELY FOR PAYMENT.
- 21. A TOTAL QUANTITY OF FOUR EACH FOR "TEMPORARY ACCESS (ROAD)" HAS BEEN INCLUDED FOR USE IN PROVIDING PEDESTRIAN ACCESS ACROSS THE INTERSECTION OF IL ROUTE 83 AND PRATT BOULEVARD.
- 22. ALL TYPE III BARRICADES SHALL HAVE 2 AMBER TYPE A-LOW INTENSITY FLASHING LIGHTS SPACED NEAR THE CENTERLINES OF THE SUPPORTS.
- 23. DROP-OFFS ADJACENT TO THE TRAVEL LANES SHALL BE KEPT TO A MINIMUM. DROP-OFFS GREATER THAN 18" WILL NOT BE ALLOWED WHEN TRAFFIC IS PRESENT IN THE ADJACENT LANE. THE CONTRACTOR WILL BE REQUIRED TO PERFORM THE EXCAVATION REQUIRED FOR THE CONSTRUCTION OF THE WIDENING DURING THE HOURS THAT THE ADJACENT LANE IS CLOSED, AS NOTED ABOVE. PRIOR TO RE-OPENING THE LANE TO TRAFFIC THE CONTRACTOR SHALL PLACE SUFFICIENT MATERIAL TO REDUCE THE DROP-OFF TO LESS THAN 18". THE CONTRACTOR SHALL BE RESPONSIBLE TO DETERMINE THE AMOUNT OF WORK THAT CAN BE COMPLETED WITHIN THE TIME LIMIT OF THE DAILY LANE CLOSURE. NO ADDITONAL COMPENSATION SHALL BE ALLOWED TO COMPLY WITH THIS REQUIREMENT.

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STATE OF ILLINOIS DEPARTMENT OF TRANSPORTATION IL ROUTE 83 (BUSSE ROAD) AND PRATT BOULEVARD MAINTENANCE OF TRAFFIC - GENERAL NOTES


SHEET NO. 1 OF 2 SHEETS

TOTAL SHEE SHEETS NO. COUNTY 09-00057-00-CH соок CONTRACT NO. 63523

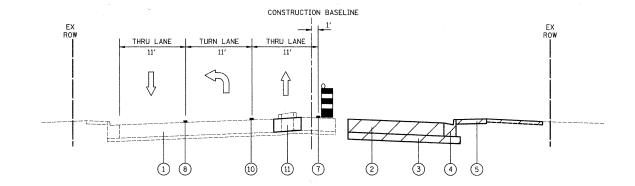

STAGE 1 TYPICAL SECTION

PRATT BOULEVARD

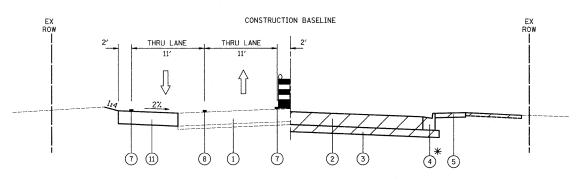

STAGE 1 TYPICAL SECTION PRATT BOULEVARD

SECTION B-B


* SEE MOT PLAN VIEW FOR LIMITS OF CURB AND GUTTER TO BE CONSTRUCTED DURING STAGE 1

SECTION A-A

CONSTRUCTION BASELINE TURN LANE THRU LANE

STAGE 2 TYPICAL SECTION PRATT BOULEVARD

SECTION A-A

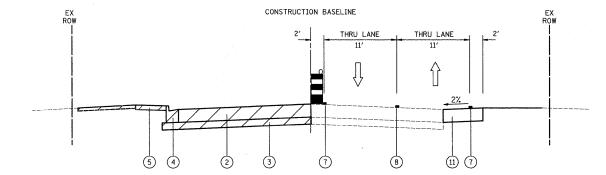

STAGE 2 TYPICAL SECTION

PRATT BOULEVARD

SECTION B-B

LEGEND

- 1 EXISTING PAVEMENT
- 2 PROPOSED PCC PAVEMENT
- 3 PROPOSED SUB-BASE GRANULAR MATERIAL
- 4 PROPOSED COMB. CONC. CURB AND GUTTER
- 5 PROPOSED PCC SIDEWALK
- 6 PROPOSED CONCRETE MEDIAN
- 7 LINE 4" (WHITE EDGE LINE)
- 8 LINE 4" (DOUBLE YELLOW)
- 9 LINE 4" (WHITE- 10' DASH 30' SKIP)
- 10 LINE 6" (WHITE LANE LINE, SOLID OR DOTTED)
- 11) TEMPORARY PAVEMENT
- 12) LINE 4" (YELLOW EDGE LINE)

CONSTRUCTION ZONE | TRAFFIC FLOW

DRUMS WITH MONO DIRECTIONAL STEADY BURN LIGHT


STATE OF ILLINOIS **DEPARTMENT OF TRANSPORTATION**

IL	ROUTE	83 (E	USSE	ROAD) AN	D PRATT	BOULEVARD	
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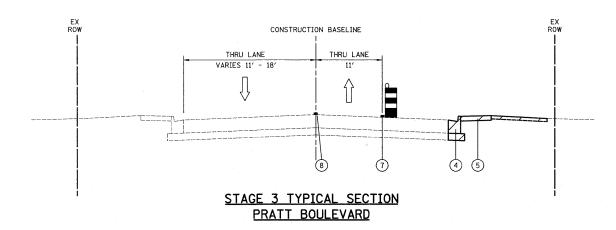
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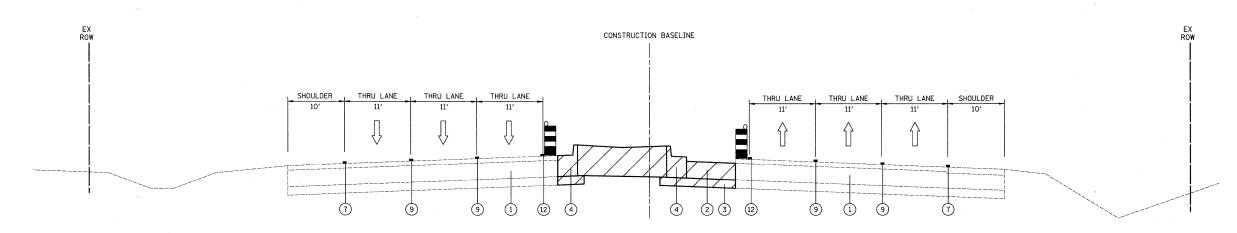


STAGE 3 TYPICAL SECTION
PRATT BOULEVARD

SECTION A-A

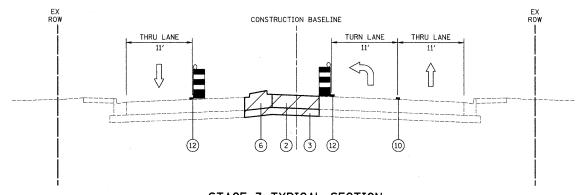

SECTION B-B



STAGE 3 TYPICAL SECTION IL ROUTE 83 (BUSSE ROAD)

SECTION C-C

LEGEND

- 1 EXISTING PAVEMENT
- 2 PROPOSED PCC PAVEMENT
- 3 PROPOSED SUB-BASE GRANULAR MATERIAL
- (4) PROPOSED COMB. CONC. CURB AND GUTTER
- 5 PROPOSED PCC SIDEWALK
- 6 PROPOSED CONCRETE MEDIAN
- 7) LINE 4" (WHITE EDGE LINE)
- 8 LINE 4" (DOUBLE YELLOW)
- (9) LINE 4" (WHITE 10' DASH 30' SKIP)
- 10 LINE 6" (WHITE LANE LINE, SOLID OR DOTTED)
- 11) TEMPORARY PAVEMENT
- 12) LINE 4" (YELLOW EDGE LINE)




DRUMS WITH MONO DIRECTIONAL STEADY BURN LIGHT


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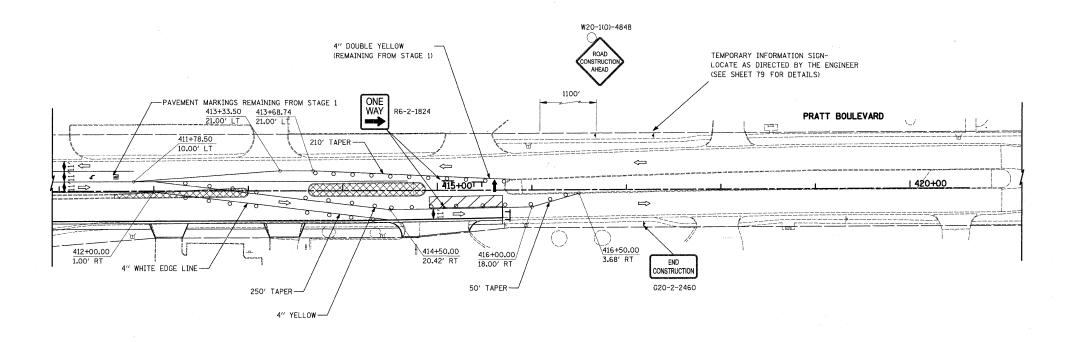
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<u>LEGEND</u>

- O TYPE II DRUM
- □ DIRECTION OF TRAFFIC
- b TEMPORARY TRAFFIC SIGN ON PERMANENT SUPPORT
- TYPE III BARRICADE
- ARROW BOARD
- WORK ZONE

- NOTE:
- 1. ALL TAPE PAVEMENT MARKINGS SHALL BE PAID FOR AS "WET TEMPORARY PAVEMENT MARKING TAPE, TYPE III".
- ADDITIONAL SIGNS WILL BE REQUIRED FOR LANE CLOSURES WHICH ARE NOT SHOWN ON THE PLANS BUT WILL BE REQUIRED AS PER I.D.O.T. STANDARD 701701.
- * SEE SHEET NO. 80 FOR SIGN DETAILS.


TEMPORARY PAVEMENT

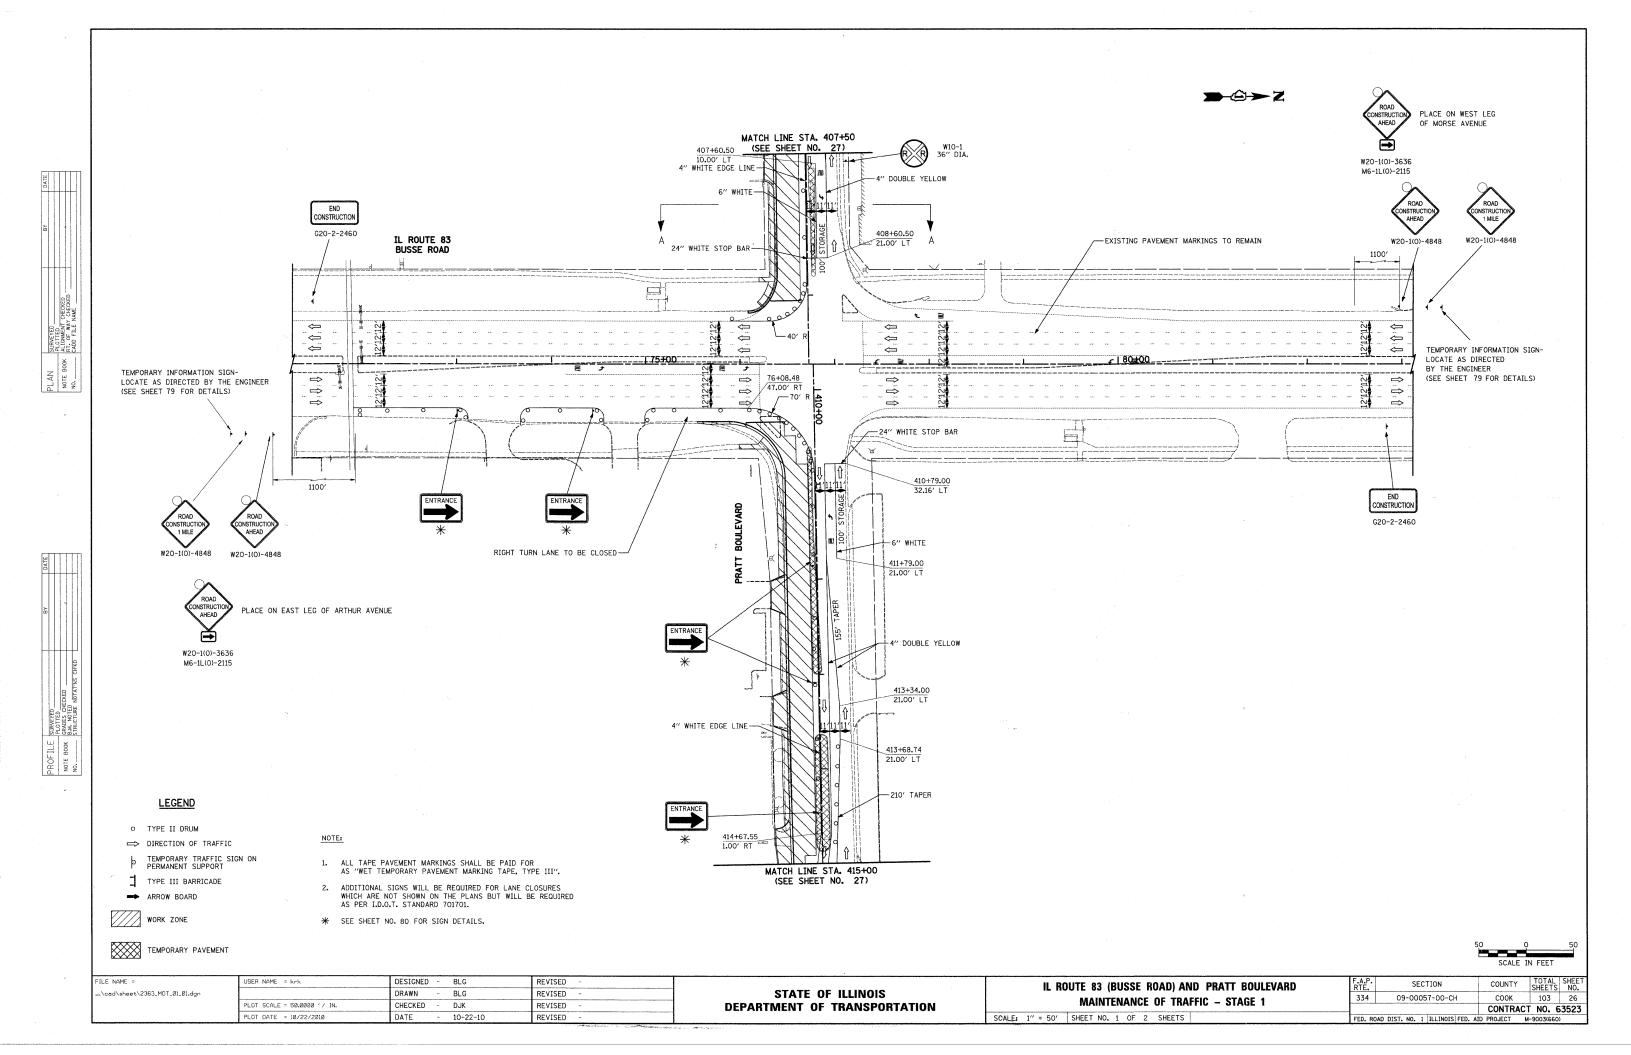
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STATE OF ILLINOIS
DEPARTMENT OF TRANSPORTATION

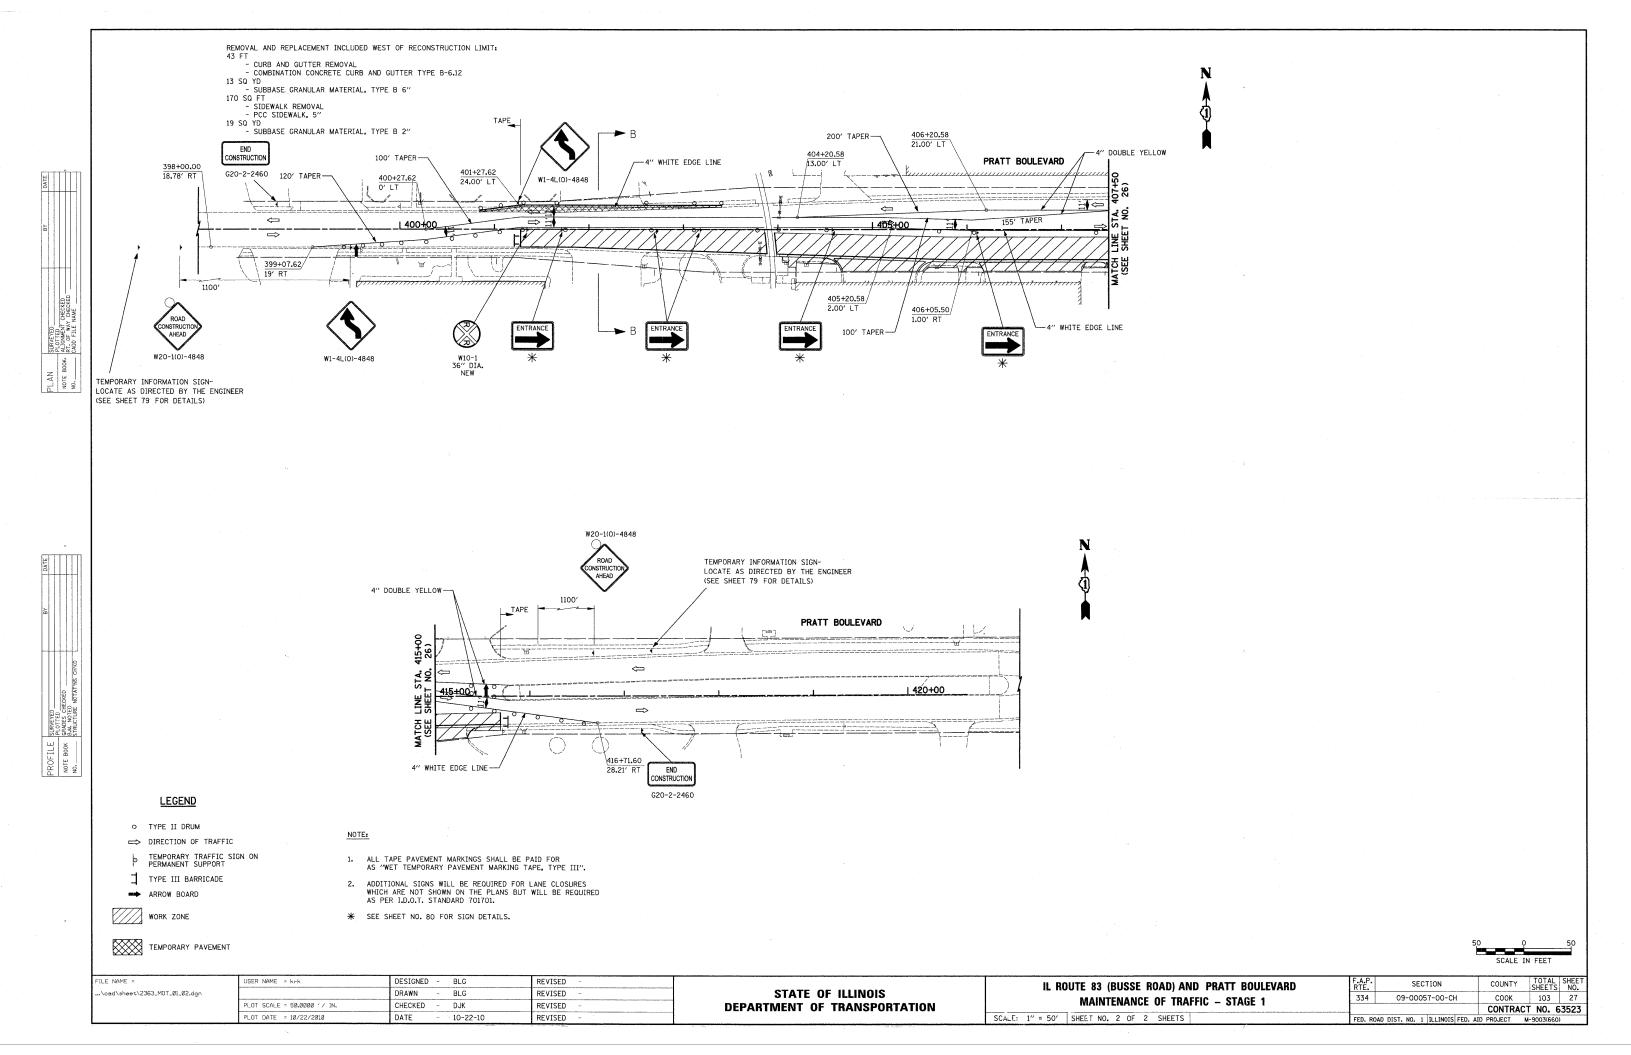IL RO	•	ROAD) AND PRATT BOULEVARD E OF TRAFFIC — STAGE 1A	
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STATE OF ILLINOIS

DEPARTMENT OF TRANSPORTATION

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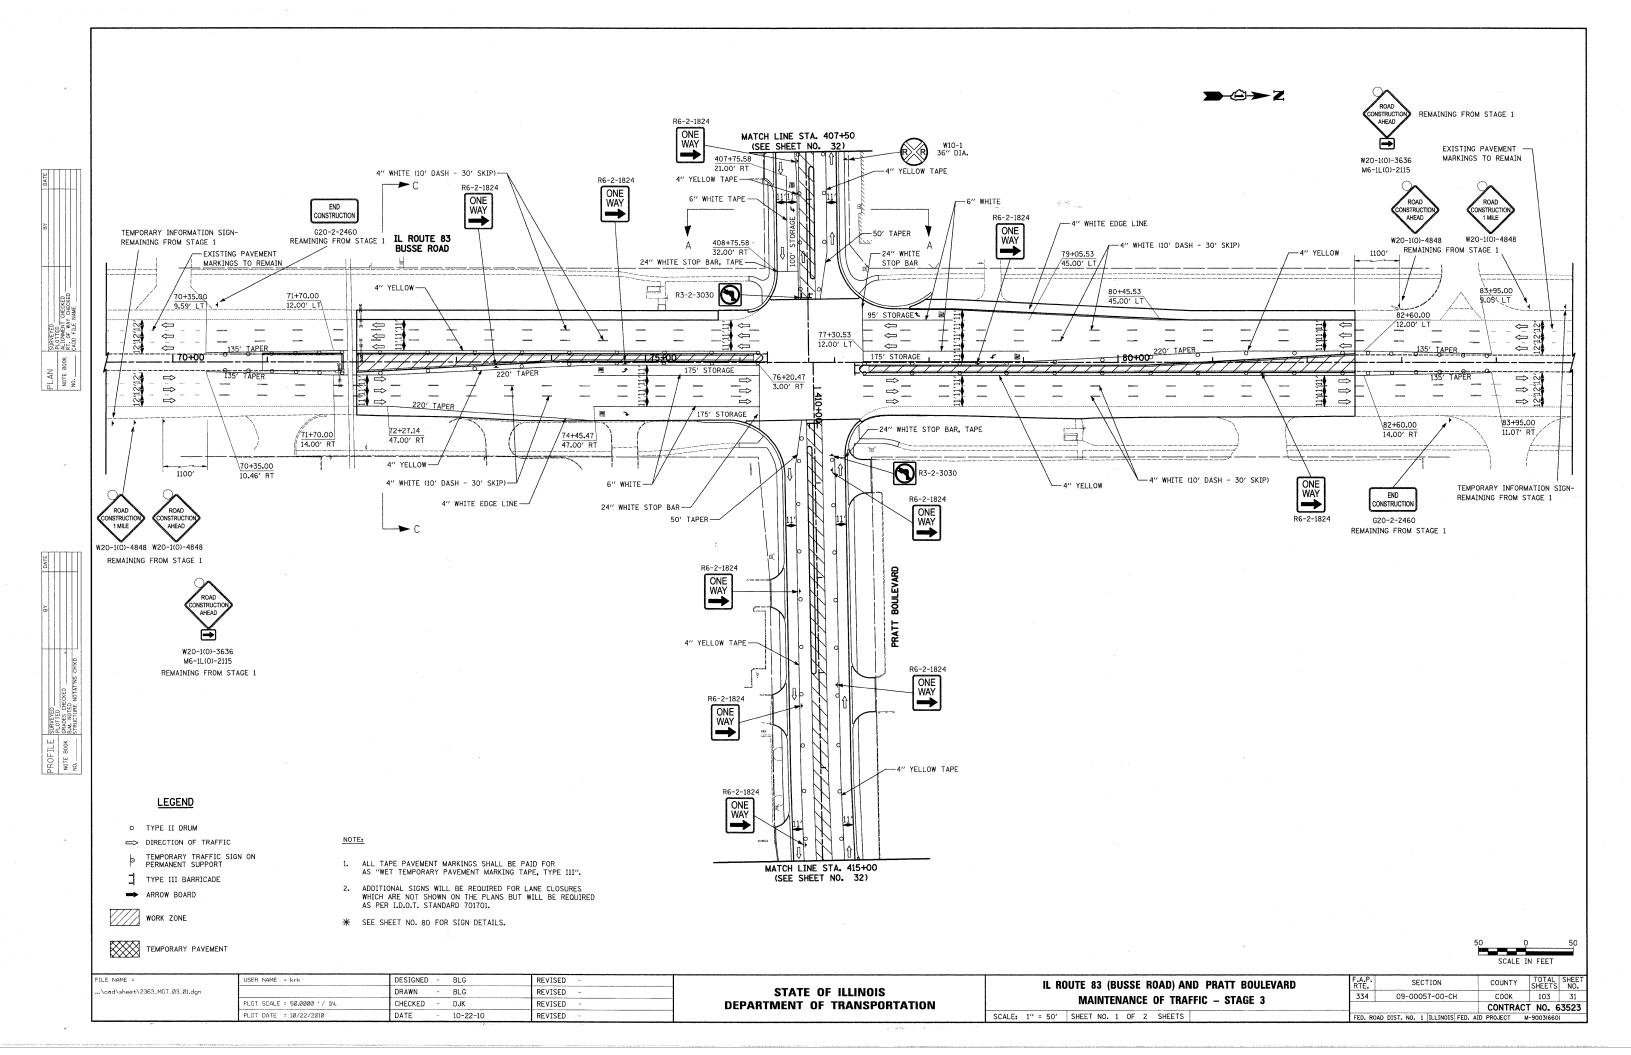
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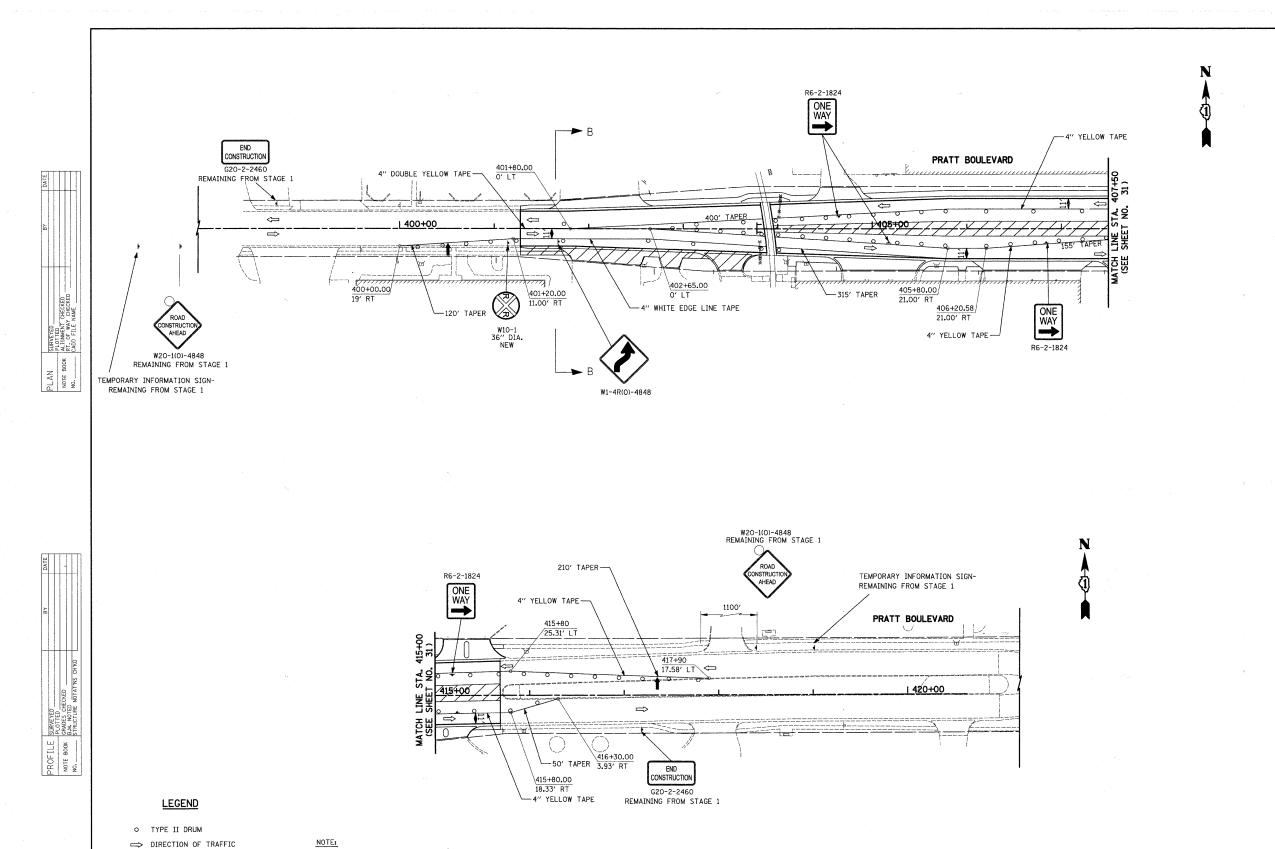
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TEMPORARY TRAFFIC SIGN ON PERMANENT SUPPORT

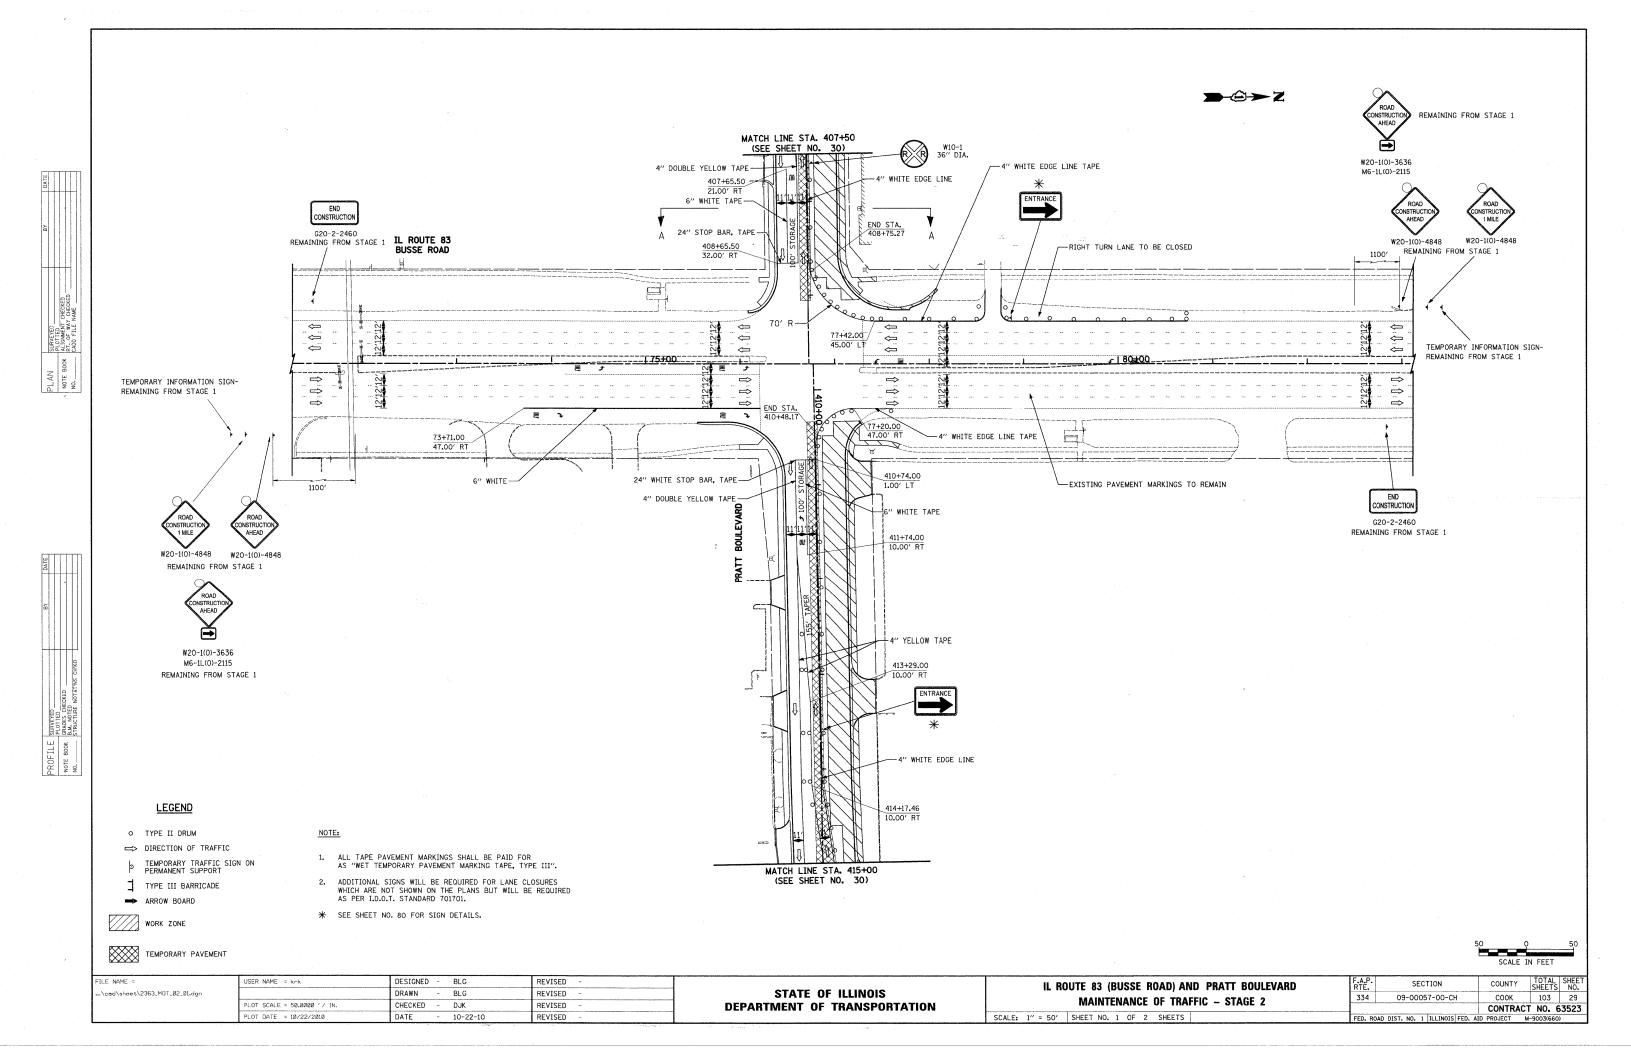TYPE III BARRICADE

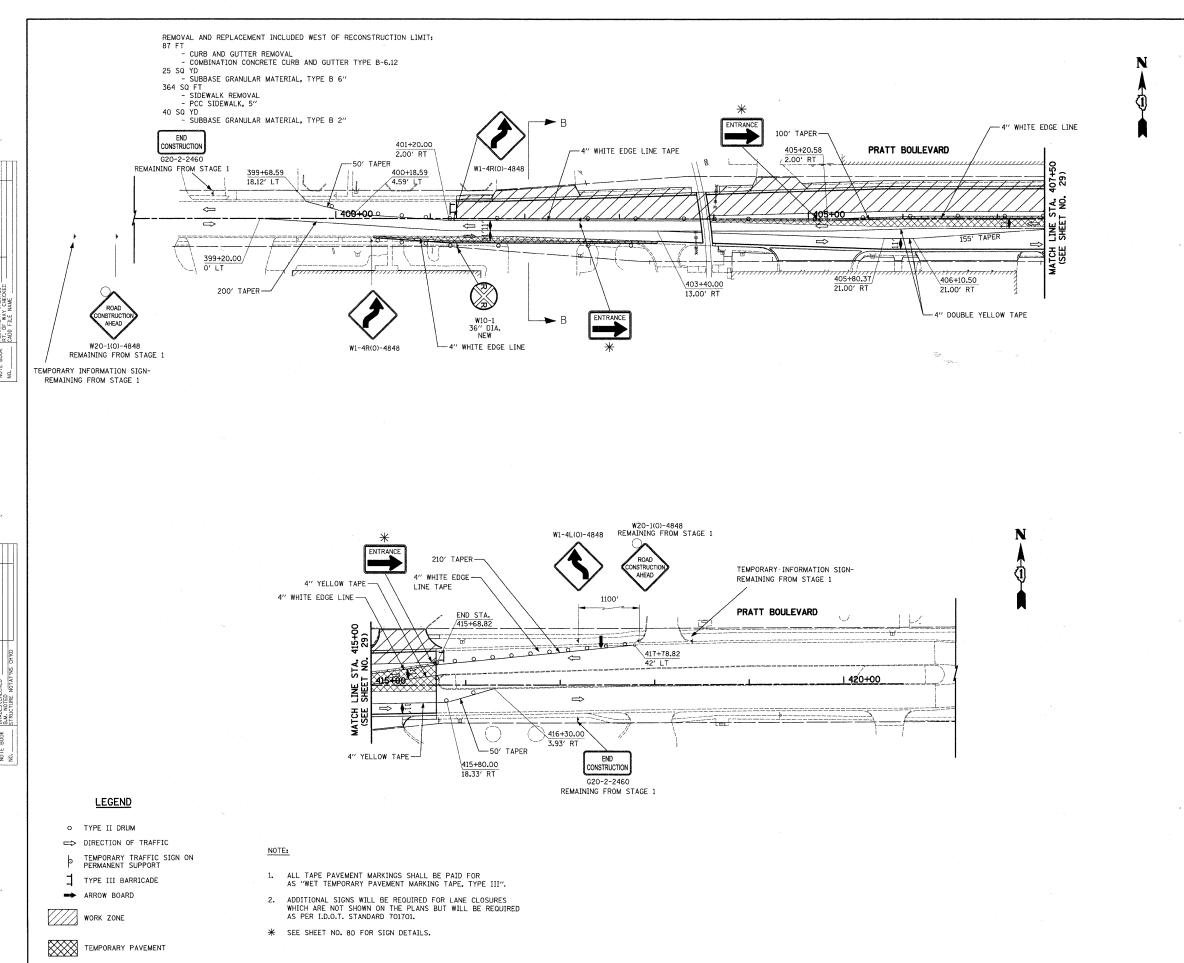TEMPORARY PAVEMENT

WORK ZONE


1. ALL TAPE PAVEMENT MARKINGS SHALL BE PAID FOR AS "WET TEMPORARY PAVEMENT MARKING TAPE, TYPE III".

 $oldsymbol{st}$ SEE SHEET NO. 80 FOR SIGN DETAILS.

2. ADDITIONAL SIGNS WILL BE REQUIRED FOR LANE CLOSURES WHICH ARE NOT SHOWN ON THE PLANS BUT WILL BE REQUIRED AS PER I.D.O.T. STANDARD 701701.

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LEGEND

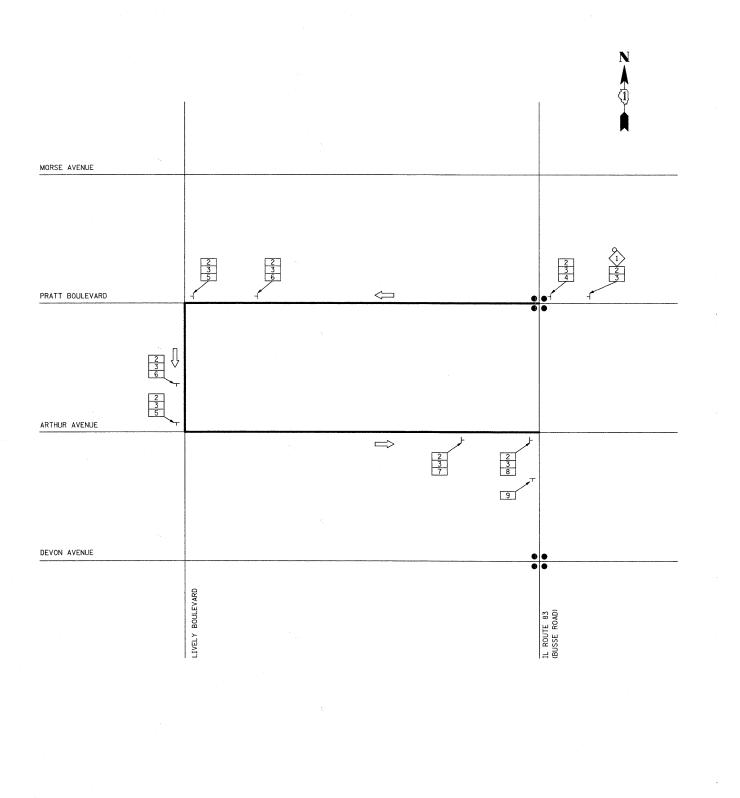

SIGNALIZED INTERSECTION



48" X 48" CONSTRUCTION WARNING SIGN WITH AMBER FLASHING LIGHT (NUMBER DENOTES TYPE)



M4-9 SERIES DETOUR SIGN WITH ROAD NAME & DIRECTION PLATES (NUMBER DENOTES TYPE)



OTHER DETOUR SIGN (NUMBER DENOTES TYPE)



DETOUR ROUTE DIRECTION

SIGN POST

DETOUR ROUTE

SCHEDULE OF SIGNS

SIGN NO.

SIGN TYPE



W20-2(0)-4848





M3-2(0)-2412



W17-I100-2412





M4-9(0)-3030





M4-9L(0)-3024





M4-9L(0)-3030





M4-9R(0)-3030

M4-9R(0)-3024



9



END DETOUR

M4-8a(0)-2418

TYPICAL SIGN ORIENTATION




DETOUR GENERAL NOTES

- THE ENGINEER SHALL BE NOTIFIED IN WRITING AT LEAST THREE WEEKS PRIOR TO THE DAY THE DETOUR IS TO BE IN EFFECT. THE CONTRACTOR SHALL ALSO CONTACT THE ELK GROVE VILLAGE POLICE DEPARTMENT (847-357-4100) AND ELK GROVE VILLAGE
- ALL SIGNING SHALL BE IN ACCORDANCE WITH THE APPLICABLE PROVISIONS OF THE STANDARD SPECIFICATIONS, THE DETAILS IN THESE PLANS, THE LATEST EDITION OF THE STATE OF ILLINOIS "MANUAL ON UNIFORM TRAFFIC CONTROL DEVICES," AND AS DIRECTED BY THE ENGINEER.
- 3. THE SIZES OF ALL SIGNS NOT SPECIFIED IN THESE PLANS SHALL BE AS REQUIRED BY THE ILLINOIS "MANUAL ON UNIFORM TRAFFIC CONTRL DEVICES."
- 4. ADDITIONAL SIGNING AND/OR BARRICADES DEEMED NECESSARY BY THE ENGINEER SHALL BE PROVIDED AND INSTALLED AT NO ADDITIONAL COST.
- THE CONTRACTOR SHALL PROVIDE THE ENGINEER WITH THE NAMES AND PHONE NUMBERS OF HIS REPRESENTATIVES ON THE CONSTRUCTION SITE, AND HIS REPRESENTATIVE RESPONSIBLE FOR THE DETOUR SIGNING, PRIOR TO THE START OF WORK.
- 6. THE CONTRACTOR SHALL BE RESPONSIBLE FOR THE FIELD LOCATION OF ALL DETOUR AND CONSTRUCTION SIGNING. THE CONTRACTOR MAY REQUEST THE ENGINEER TO FIELD VERIFY THE POSITIONS OF ANY SIGNS.
- 7. ACTUAL LOCATIONS FOR SIGNING SHOWN ON THE DETOUR PLANS MAY BE ADJUSTED TO FIT FIELD CONDITIONS.
- 8. ALL EXISTING SIGNING THAT IS NOT APPLICABLE WHILE THE DETOUR IS IN EFFECT SHALL BE COMPLETELY COVERED BY THE CONTRACTOR IN A MANNER MEETING THE APPROVAL OF THE ENGINEER.
- 9. ALL DETOUR SIGNING SHALL BE POST MOUNTED.
- 10. ALL DETOUR SIGNING EXCEPT REGULATORY SIGNS SHALL HAVE BLACK LEGENDS ON FLUORESCENT ORANGE SHEETING AND STANDARD BLACK BORDERS. THE FLUORESCENT ORANGE REFLECTIVE SHEETING SHALL MEET THE REQUIREMENTS OF ARTICLE 1106.01 OF THE STANDARD SPECIFICATIONS. ALL DETOUR SIGNING SHALL BE NEW OR IN LIKE-NEW CONDITION. THE ENGINEER SHALL BE THE SOLE JUDGE OF THE CONDITION OF THE SIGNS.
- 11. THE ROAD NAME SIGN SHALL BE A BLACK LEGEND ON ORANGE REFLECTIVE SHEETING.
 THE SIGN BLANK SHALL BE VARIABLE WITH DESIGN SERIES C LETTERS. THE CAPITAL LETTERS SHALL BE 6".
- 12. AT A MINIMUM, ALL AMBER FLASHING LIGHTS THAT ARE REQUIRED FOR THE DETOUR SIGNING SHALL MEET THE REQUIREMENTS FOR TYPE A-LOW INTENSITY FLASHING LIGHTS IN ARTICLE 1106.02 OF THE STANDARD SPECIFICATIONS. ALL LIGHTS SHALL OPERATE DURING HOURS OF DARKNESS. ONLY LIGHTS THAT HAVE BEEN APPROVED BY THE ILLINOIS DEPARTMENT OF TRANSPORTATION SHALL BE USED.
- 13. THE CONTRACTOR SHALL BE RESPONSIBLE FOR ENSURING THAT ALL BARRICADES, SIGNS, LIGHTS AND OTHER DEVICES INSTALLED BY HIM ARE IN PLACE AND OPERATING 24 HOURS EACH DAY, INCLUDING SUNDAYS AND HOLIDAYS.
- 14. THE TYPE III BARRICADES USED AT POINTS OF CLOSURE TO THRU TRAFFIC ONLY SHALL NOT EXCEED 8 FEET IN WIDTH EACH FOR A SINGLE APPROACH LANE, ALL BARRICADES AT THESE LOCATIONS SHALL HAVE REFLECTORIZED STRIPING ON THE BACK SIDES OF
- 15. CONSTRUCTION EQUIPMENT SHALL NOT BE PARKED IMMEDIATELY BEHIND THE TYPE III BARRICADES DURING NON-WORKING HOURS. IN ANY EVENT, ARTICLE 701.11 OF THE STANDARD SPECIFICATIONS SHALL APPLY.
- 16. DURING NON-WORKING HOURS THE CONTRACTOR SHALL PROVIDE A MEANS TO RESTRAIN THE TYPE III BARRICADES FROM EASY MOVEMENT BY VANDALS. THE CHOSEN METHOD SHALL BE APPROVED BY THE ENGINEER.
- 17. THE CONTRACTOR SHALL BE RESPONSIBLE FOR MAINTAINING THE VISIBILITY OF ALL DETOUR AND CONSTRUCTION SIGNS, INCLUDING BRUSHING BACK VEGETATION IF DEEMED NECESSARY BY THE ENGINEER.
- 18. THE ENGINEER SHALL BE NOTIFIED AT LEAST 24 HOURS BEFORE THE ROAD IS TO BE REOPENED TO TRAFFIC. THE CONTRACTOR WILL CONTACT THE APPROPRIATE LOCAL AGENCIES AND INTERESTED PARTIES.
- 19. THE COST OF THIS WORK FOR THE DETOUR SHALL BE INCLUDED IN THE UNIT PRICE FOR "TRAFFIC CONTROL AND PROTECTION FOR TEMPORARY DETOUR".

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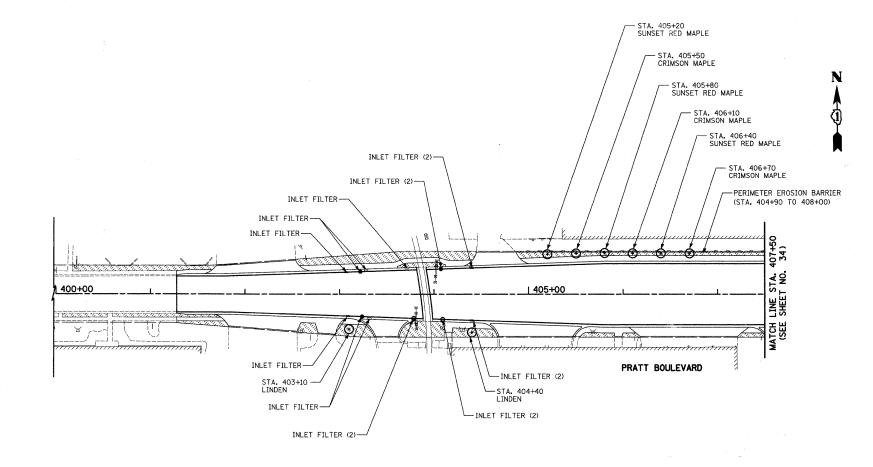
STATE OF ILLINOIS **DEPARTMENT OF TRANSPORTATION** IL ROUTE 83 (BUSSE ROAD) AND PRATT BOULEVARD **DETOUR PLAN - STAGE 3** SHEET NO. 1 OF 1 SHEETS

SHEETS NO. SECTION COUNTY 344 09-00057-00-CH COOK 103 CONTRACT NO. 63523 FED. ROAD DIST. NO. 1 ILLINOIS FED. AID PROJECT M-9003(660)

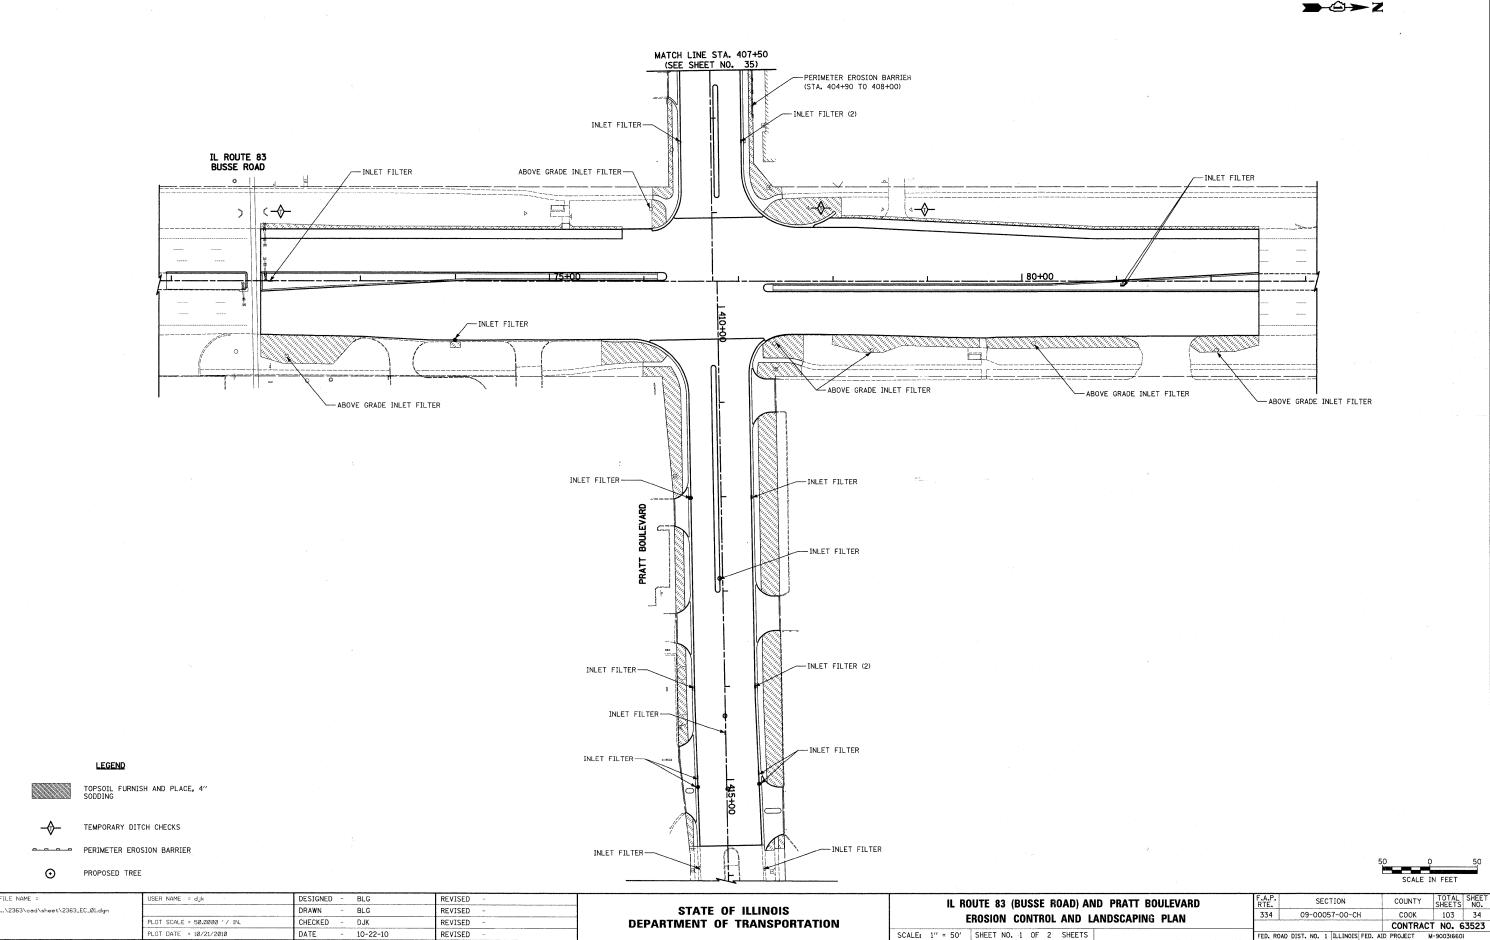

| PLAN | SIGNETED | BY DATE | DATE |

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| PLOTTE CONTINUE CO



LEGEND

TOPSOIL FURNISH AND PLACE, 4" SODDING



TEMPORARY DITCH CHECKS




PERIMETER EROSION BARRIER


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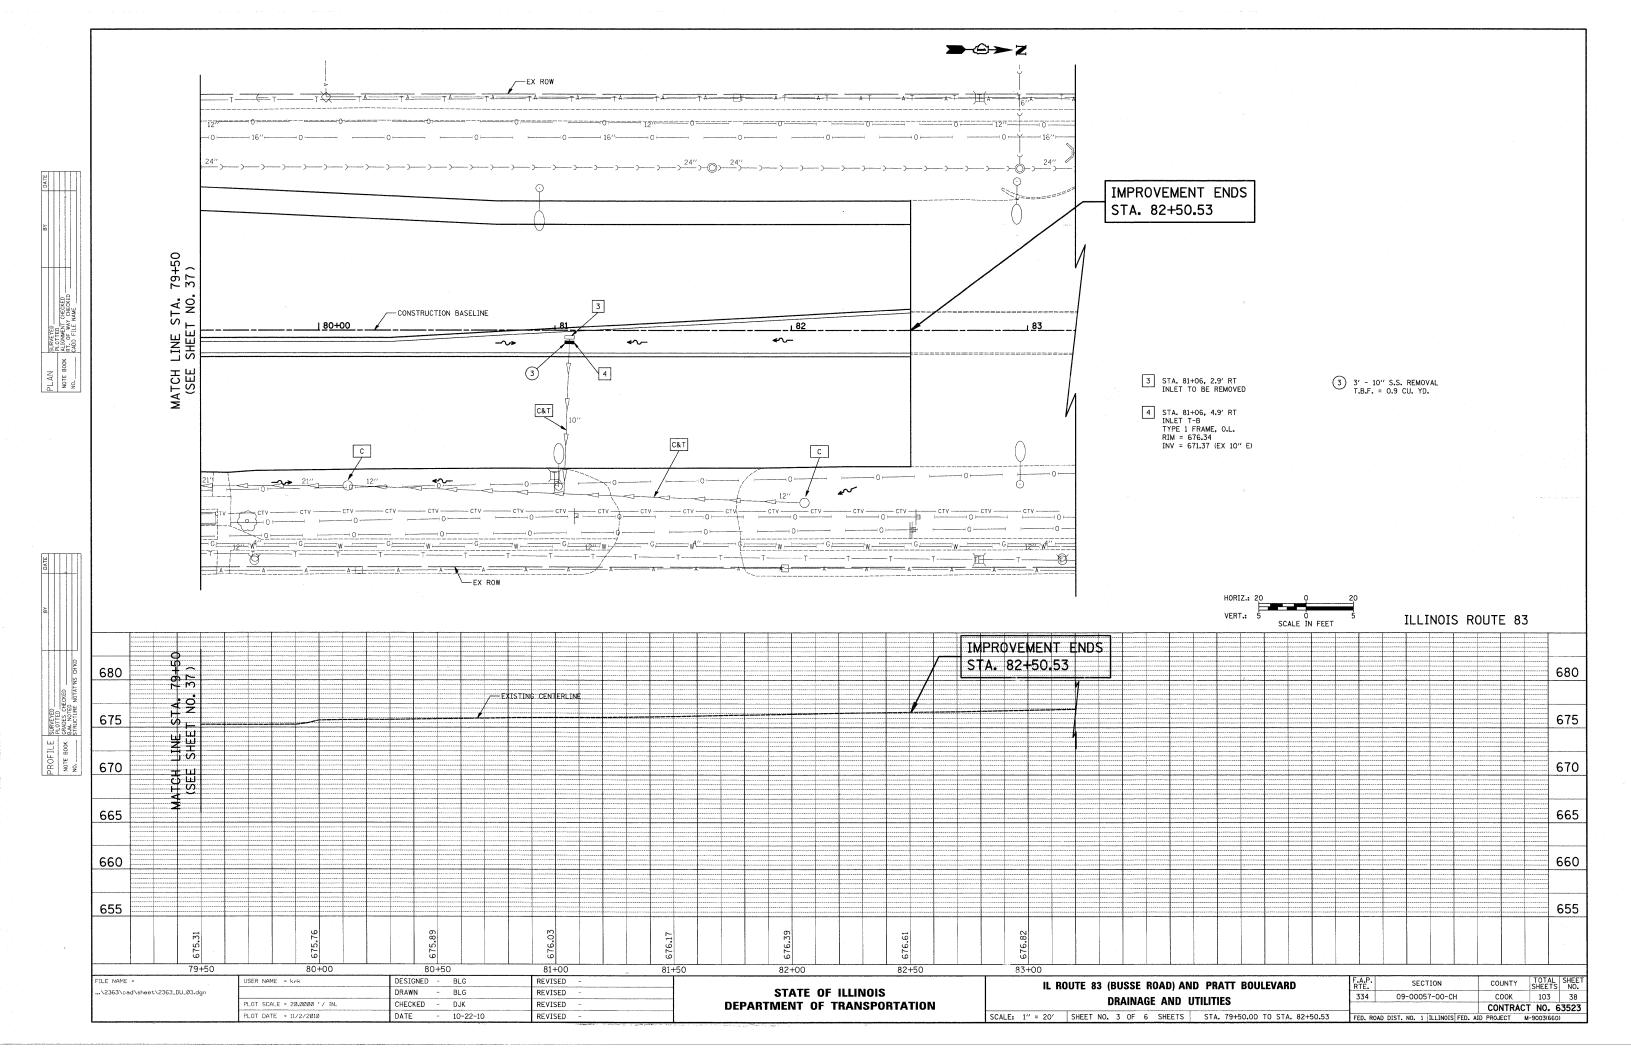
PROPOSED TREE


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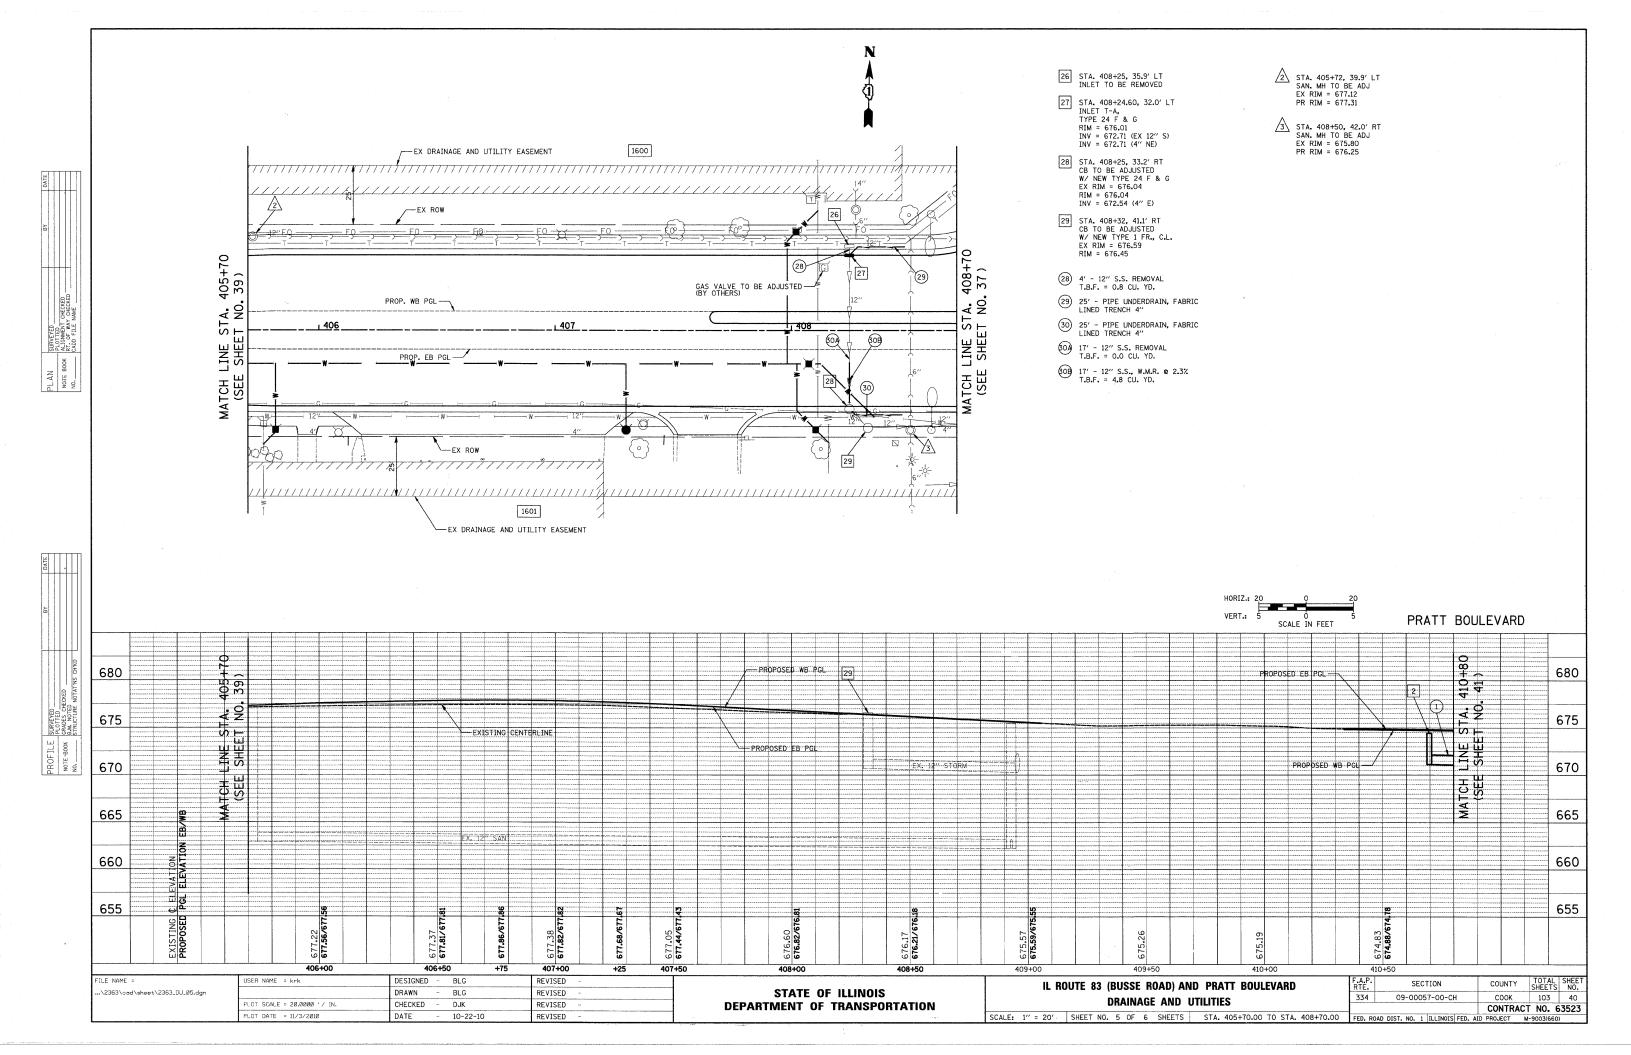
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i	PLOT SCALE = 50.0000 '/ IN.	CHECKED -	DJK	REVISED -	DEPARTMENT OF TRANSPORTATION	ENUSION CONTROL AND LANDSCAPING	CONTRACT NO. 63			
	PLOT DATE = 10/21/2010	DATE -	10-22-10	REVISED -		SCALE: 1" = 50' SHEET NO. 2 OF 2 SHEETS	FED. ROAD	DIST. NO. 1 ILLINOIS FED. AI		M-9003(660)







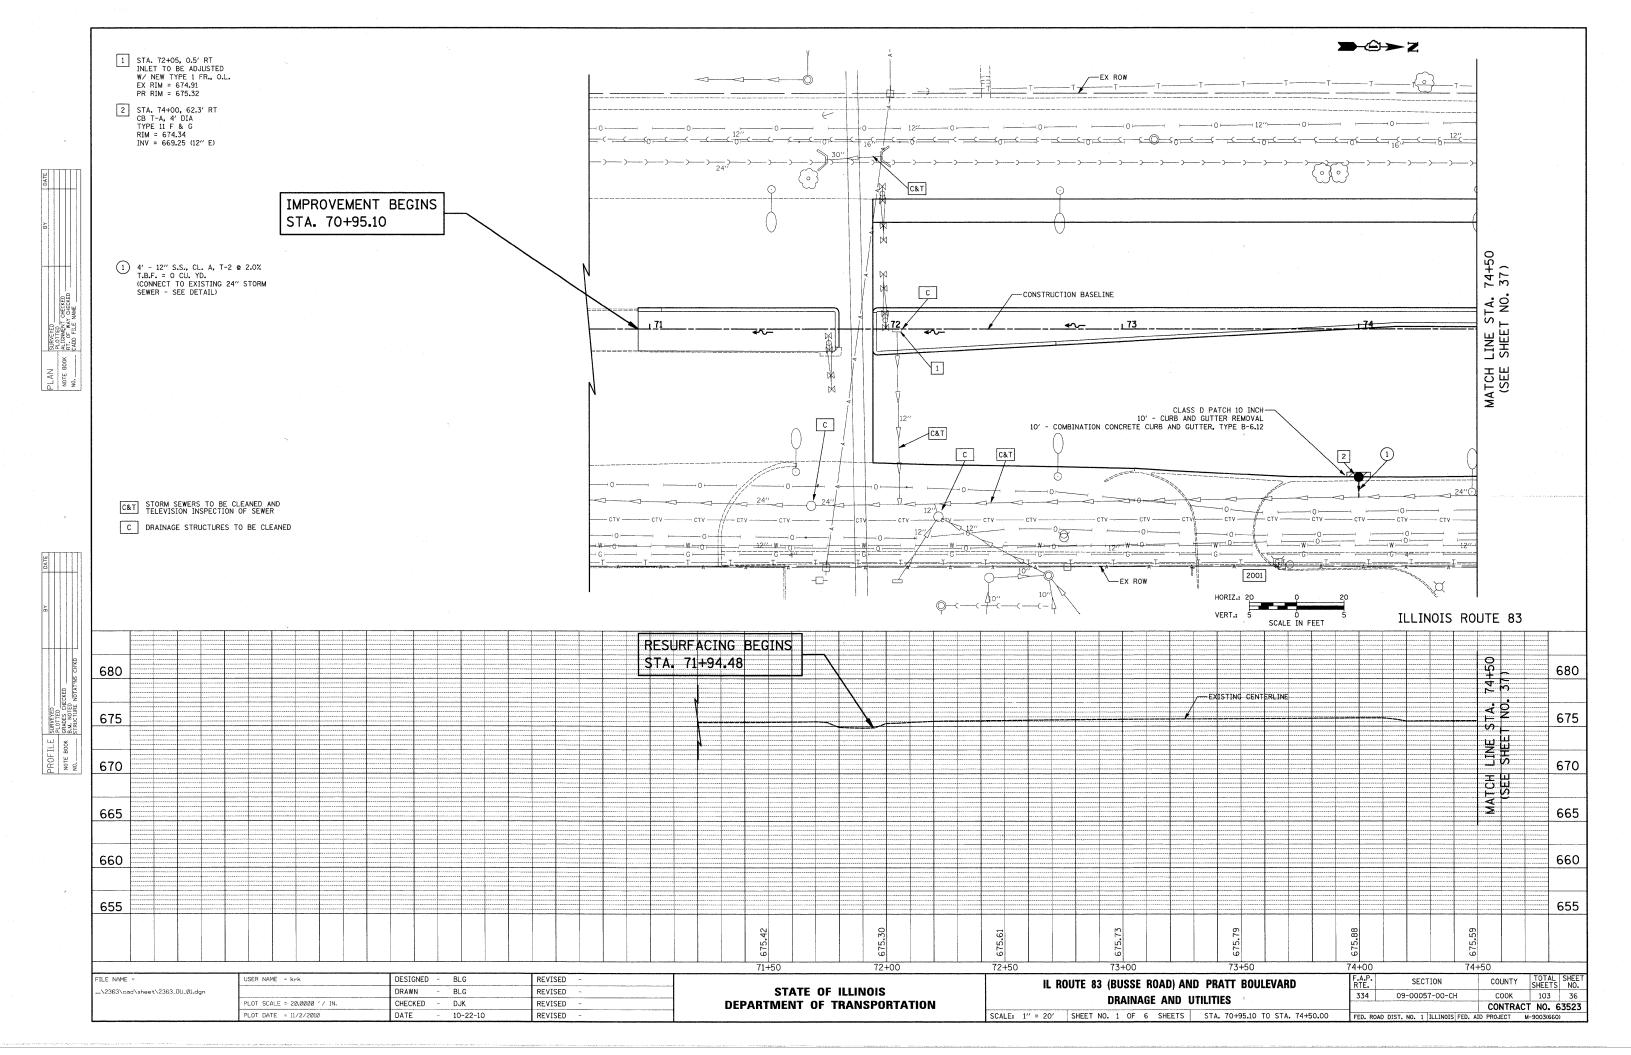


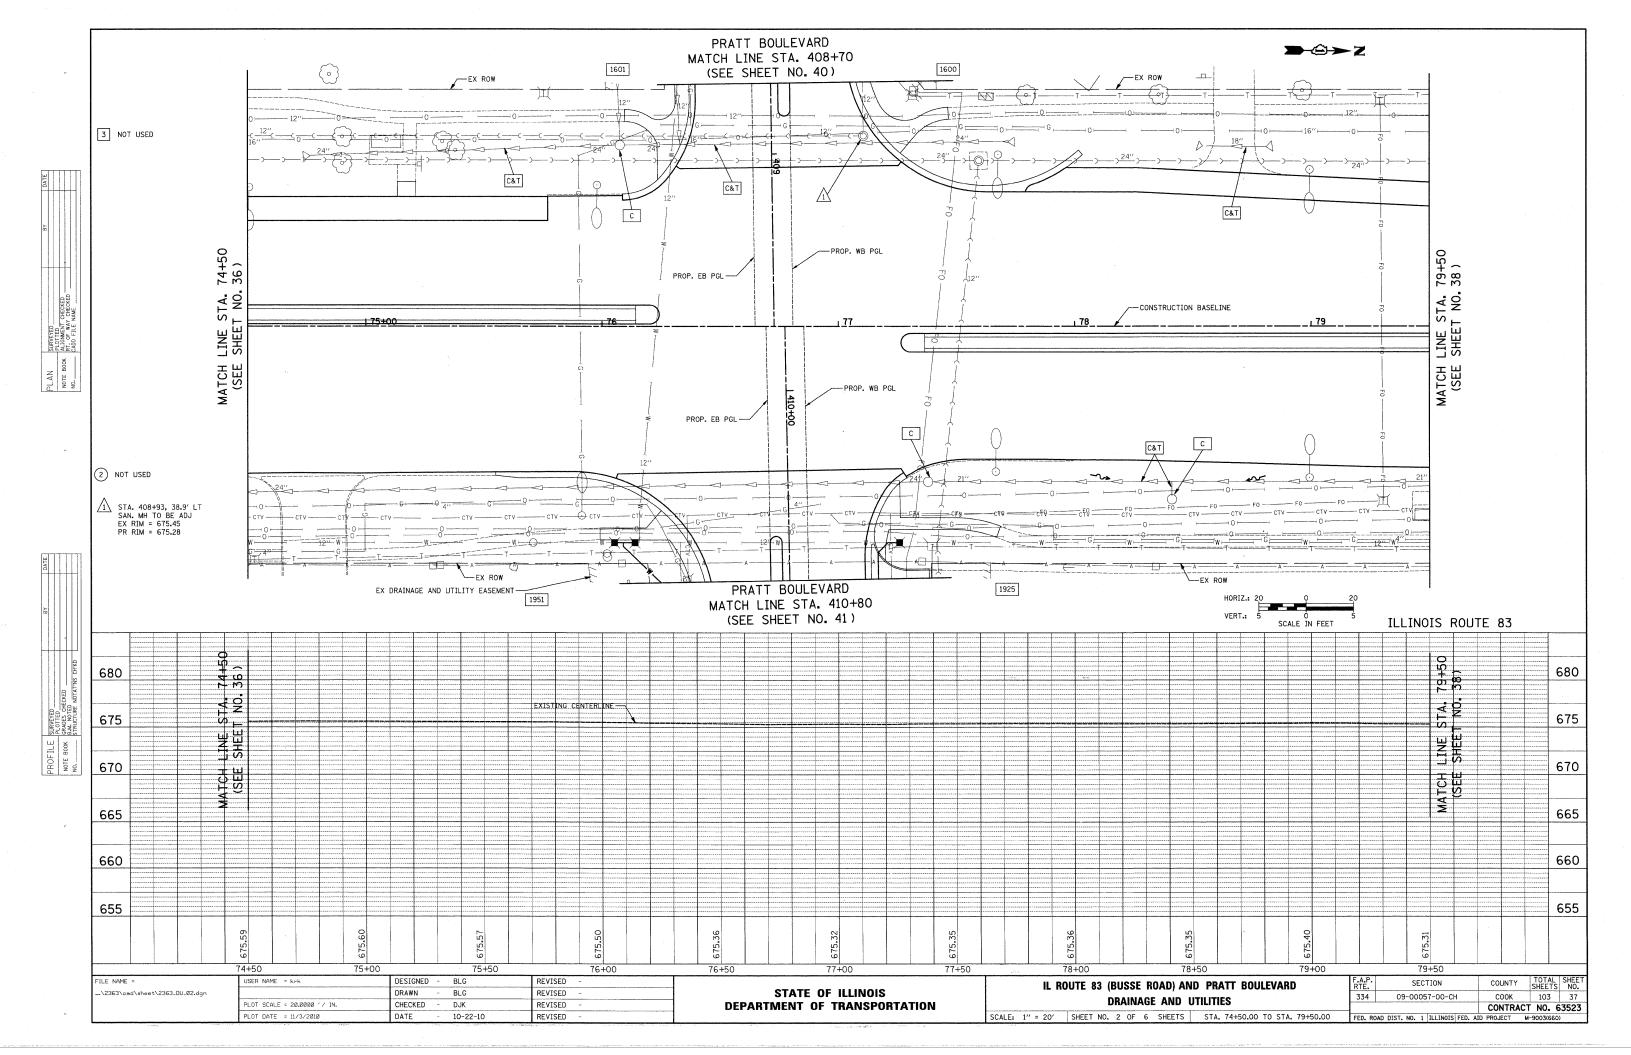


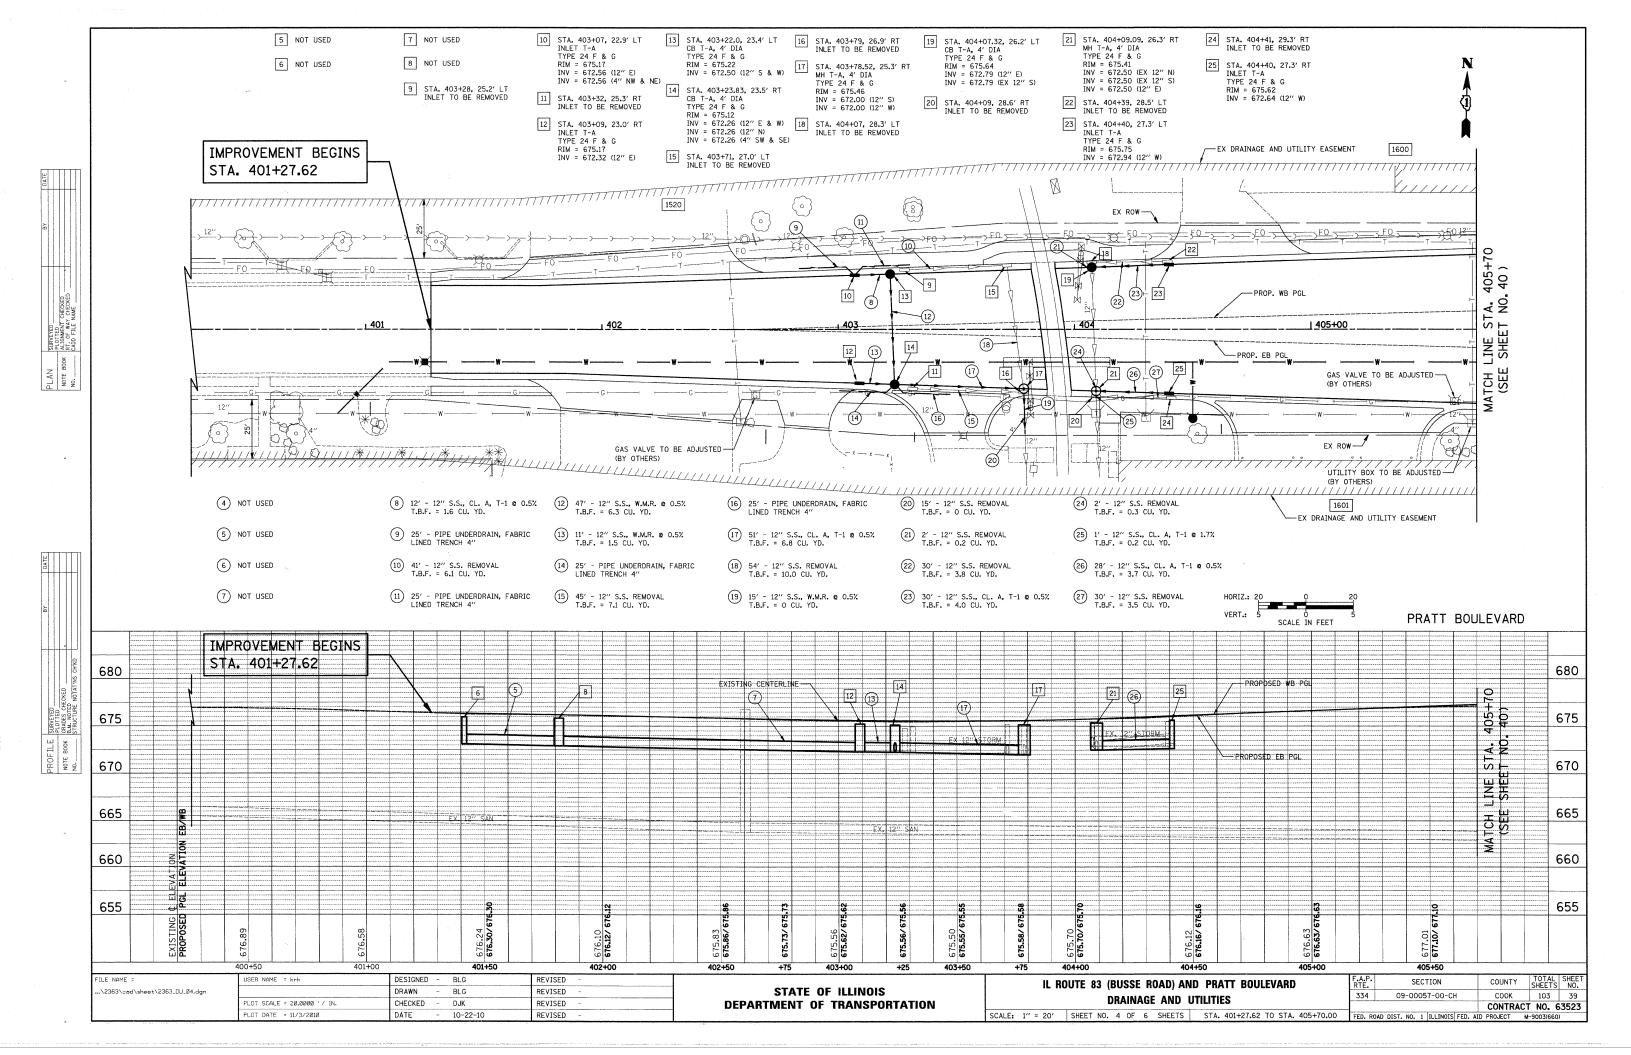


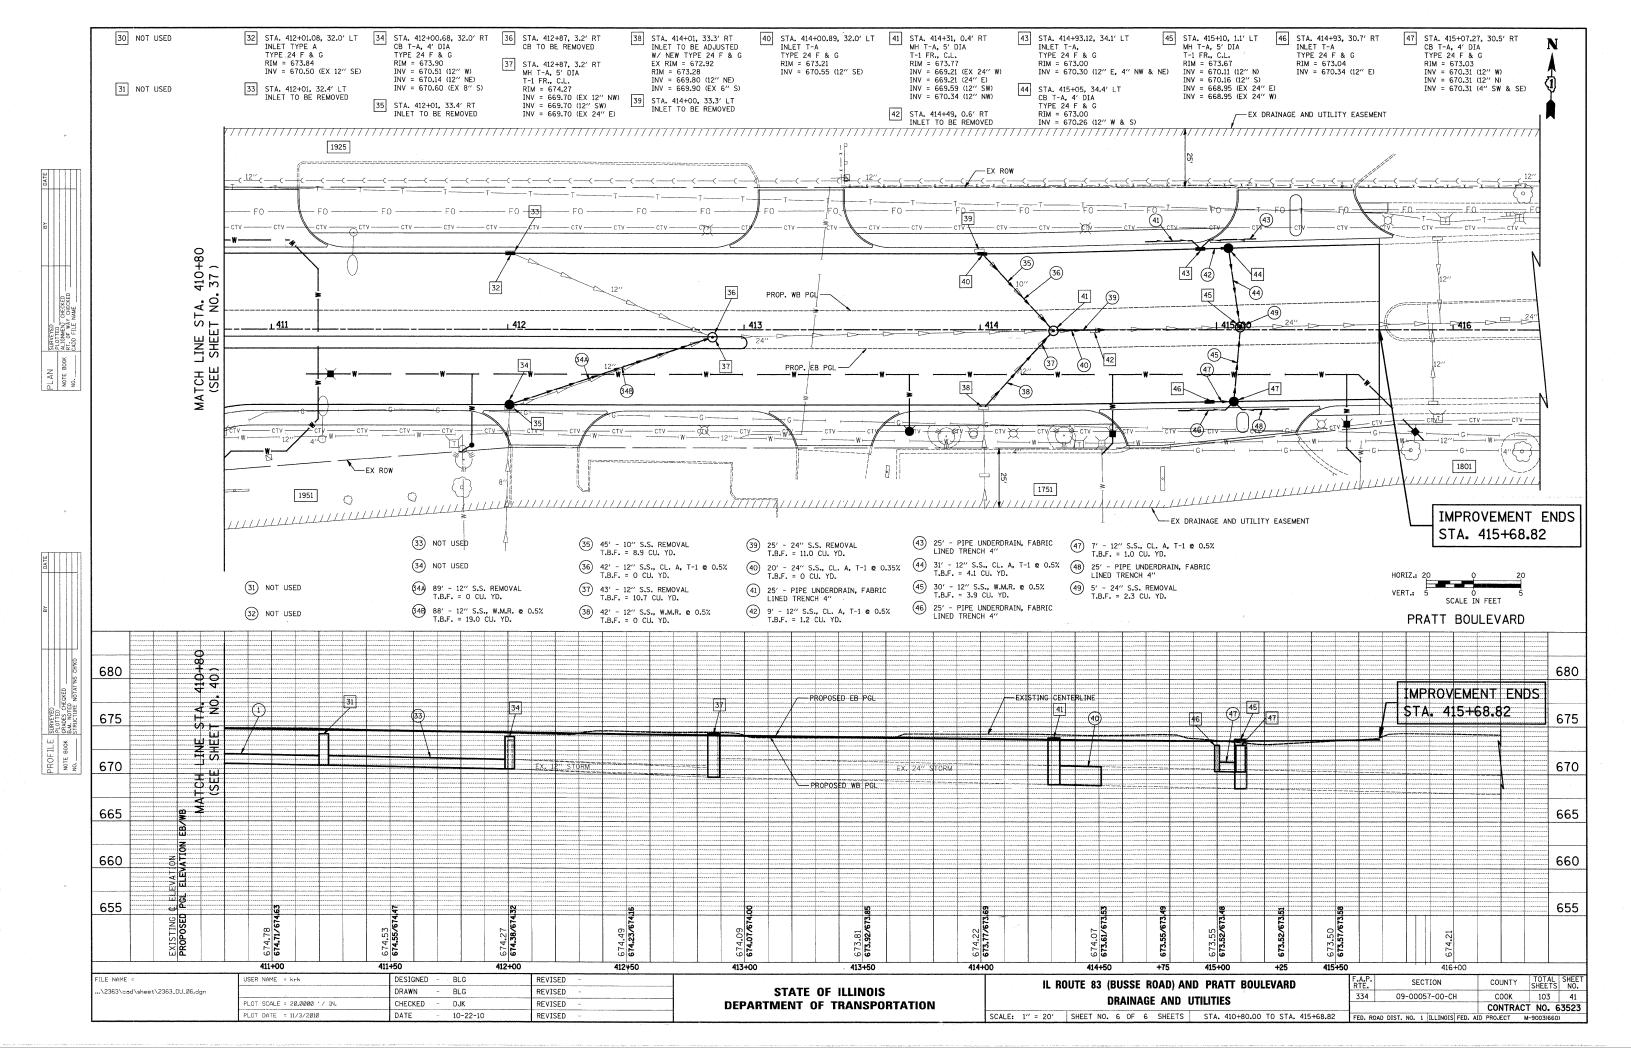


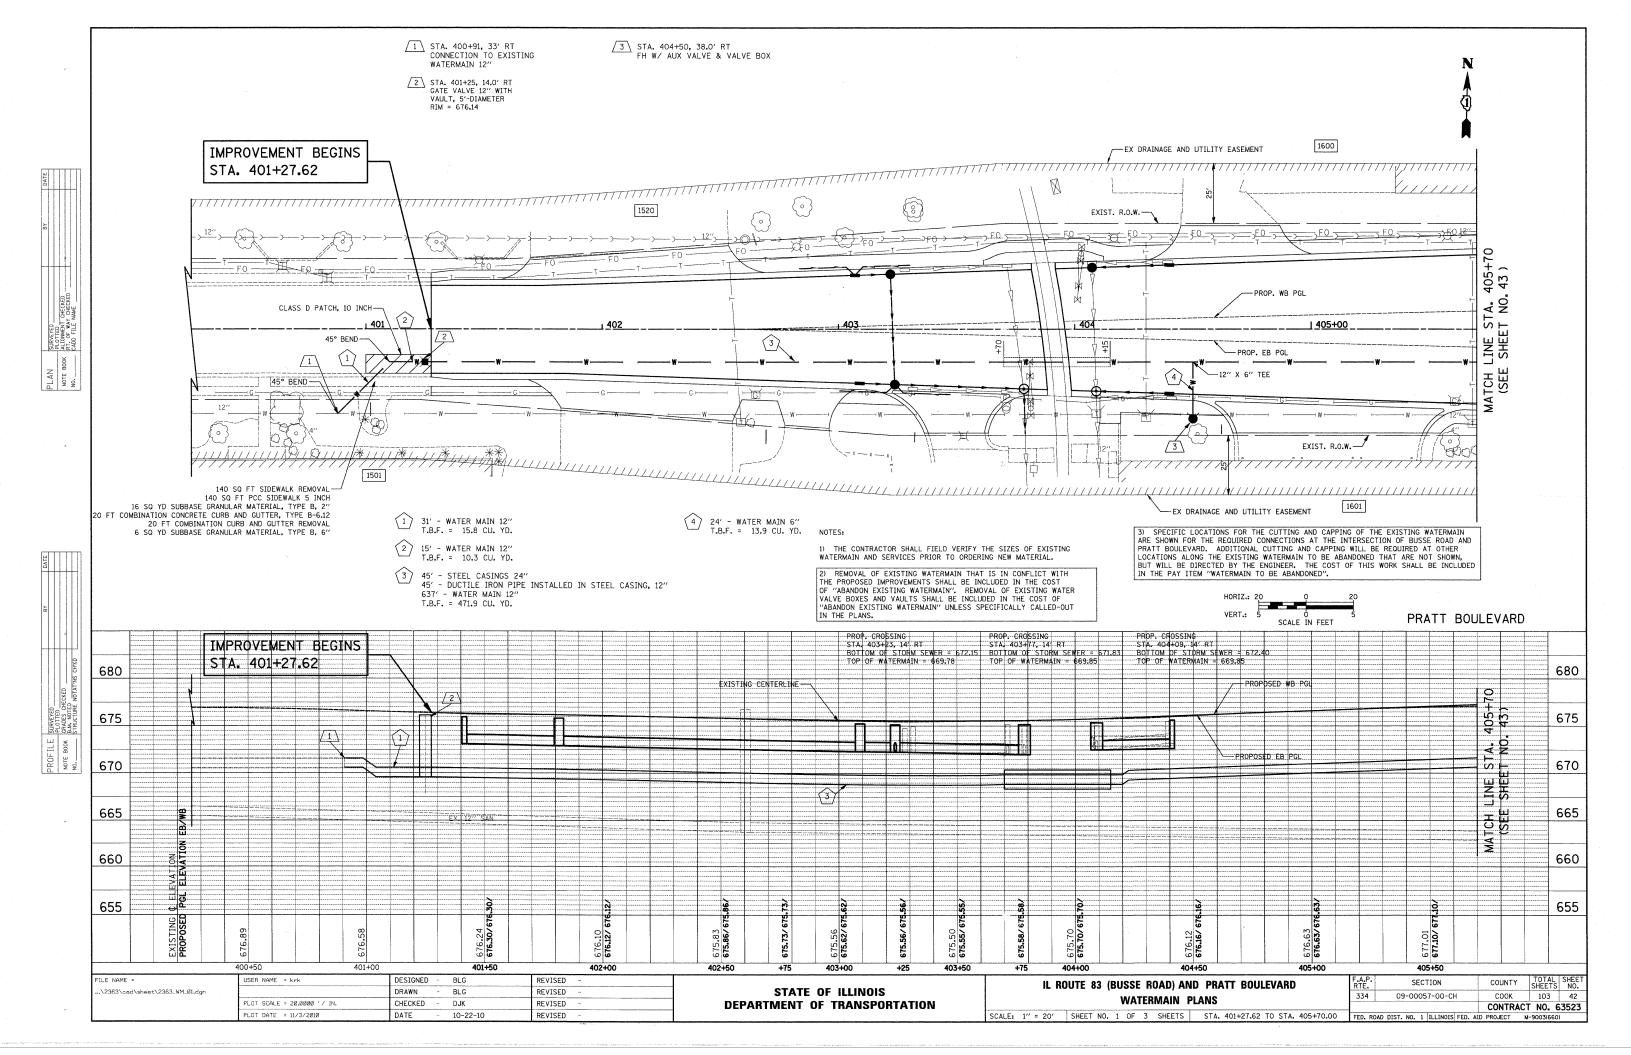

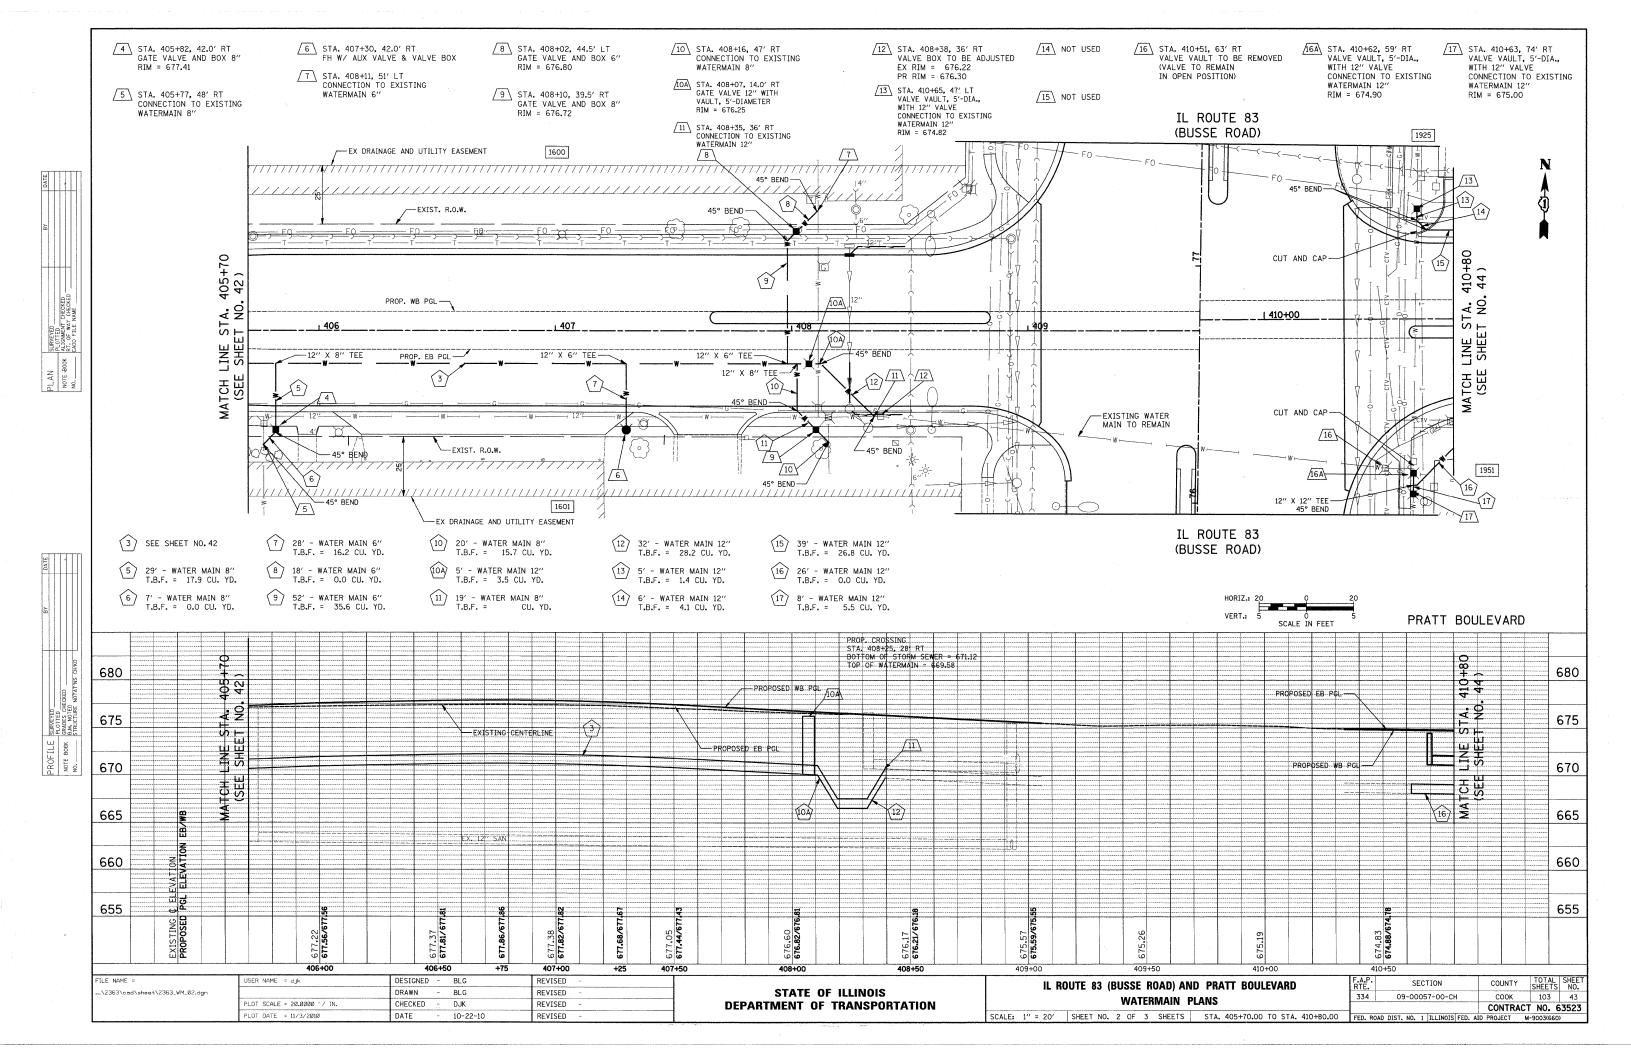

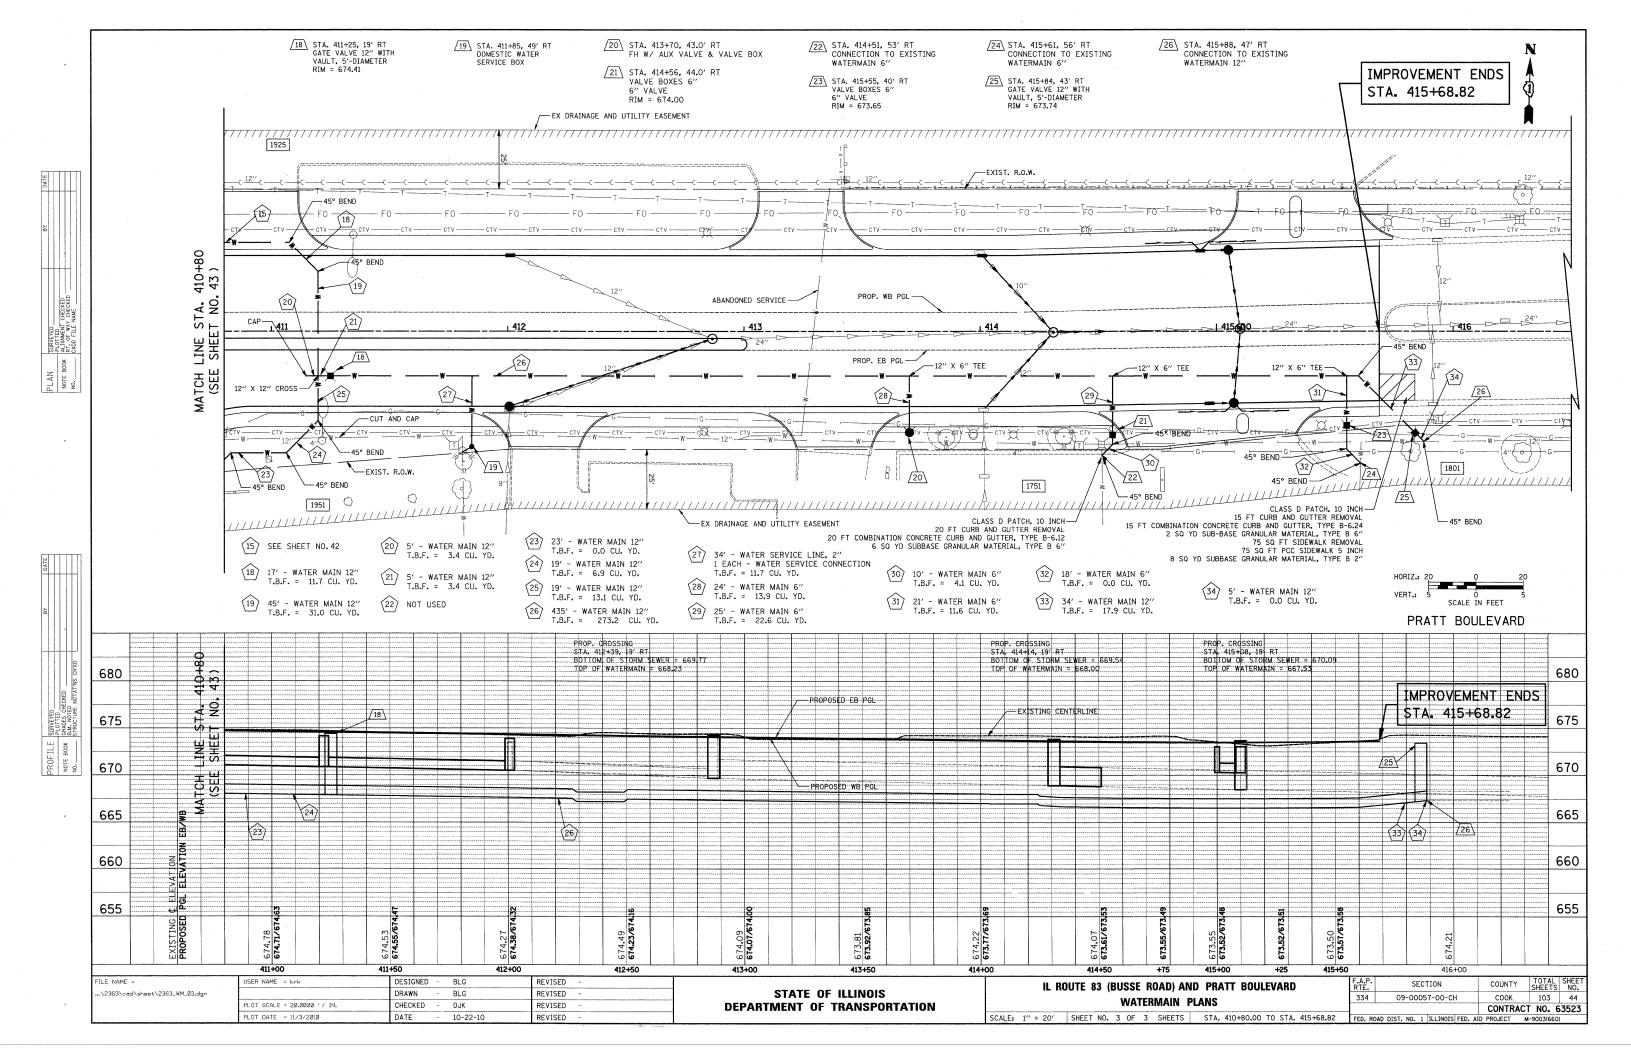

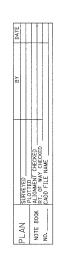

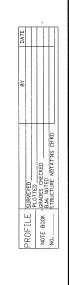

LEGEND

LONGITUDINAL JOINT (SEE CALL-OUTS FOR TYPE AND BAR SPACING)

SAWED TRANSVERSE CONSTRACTION JOINT WITH SMOOTH DOWEL BARS (EPOXY COATED), 1 1/2" DIA., 18" LONG @ 12" C-C (INCLUDED IN THE COST OF "PCC PAVEMENT 10" (JOINTED)")


LENGTH OF PAVEMENT PANEL BETWEEN SAWED CONTRACTION JOINTS

CONSTRUCTION JOINT, NO. 6 X 24" DEFORMED TIE BARS (EPOXY COATED) GROUTED IN PLACE AT 24" C-C (INCLUDED IN COST OF "COMBINATION CONCRETE CURB AND GUTTER, TYPE B-6.24")

CONSTRUCTION JOINT, NO. 6 X 24" DEFORMED TIE BARS (EPOXY COATED) GROUTED IN PLACE AT 24" C-C (INCLUDED IN COST OF "CONCRETE MEDIAN, TYPE SB-6.12")

LONGITUDINAL CONSTRUCTION JOINT - NO. 6 X 24" DEFORMED TIE BARS
(EPOXY COATED) AT 24" C-C (INCLUDED IN COST OF "PCC PAVT 10" (JOINTED)")

PRATT BOULEVARD

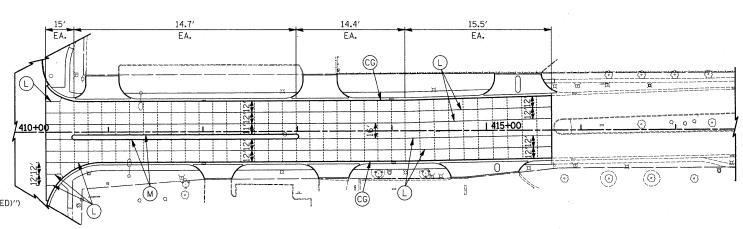

NOTES

- 1. TRANSVERSE CONTRACTION JOINTS SHALL BE ALIGNED ACROSS SOLID BARRIER MEDIANS.
 JOINT LAYOUT MAY BE MODIFIED (+/- 3 FT PER STANDARD 420101) UPON APPROVAL BY THE ENGINEER
 TO INCORPORATE CHANGES DURING CONSTRUCTION.
- 2. PAVEMENT ROUND-OUTS FOR MANHOLES AND VALVE VAULTS SHALL BE CONSTRUCTED IN ACCORDANCE WITH HIGHWAY STANDARD 420111.
- 3. SEE IDOT STANDARDS 420001, 420101, AND 420111 FOR ADDITIONAL DETAILS.


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IL ROUTE 83 (BUSSE ROAD) AND PRATT BOULEVARD	F.A.P. RTE.	SECTION	COUNTY	TOTAL SHEETS	SHEET NO.
JOINTING PLAN	334	09-00057-00-CH	COOK	103	45
OUNTING LAN			CONTRAC	T NO. 6	63523
NLE: 1" = 50' SHEET NO. 1 OF 1 SHEETS	FED. RO	DAD DIST. NO. 1 ILLINOIS FED. AI	D PROJECT I	M-9003(660))

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*ADD 670' TO ALL ELEVATIONS

20 0 20 SCALE IN FEET

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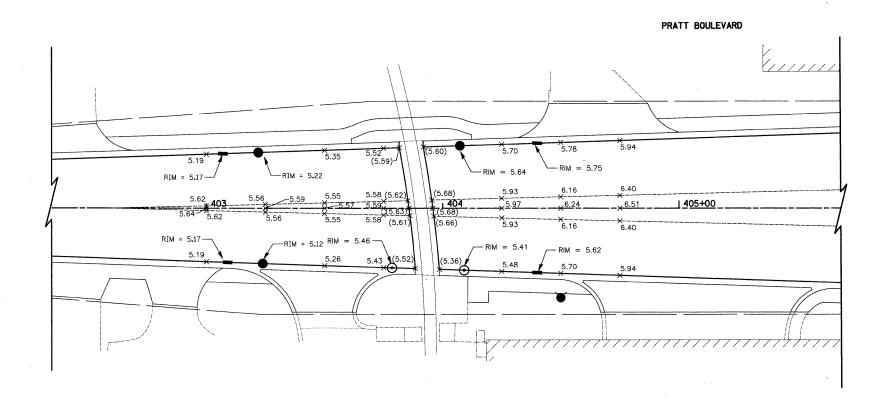
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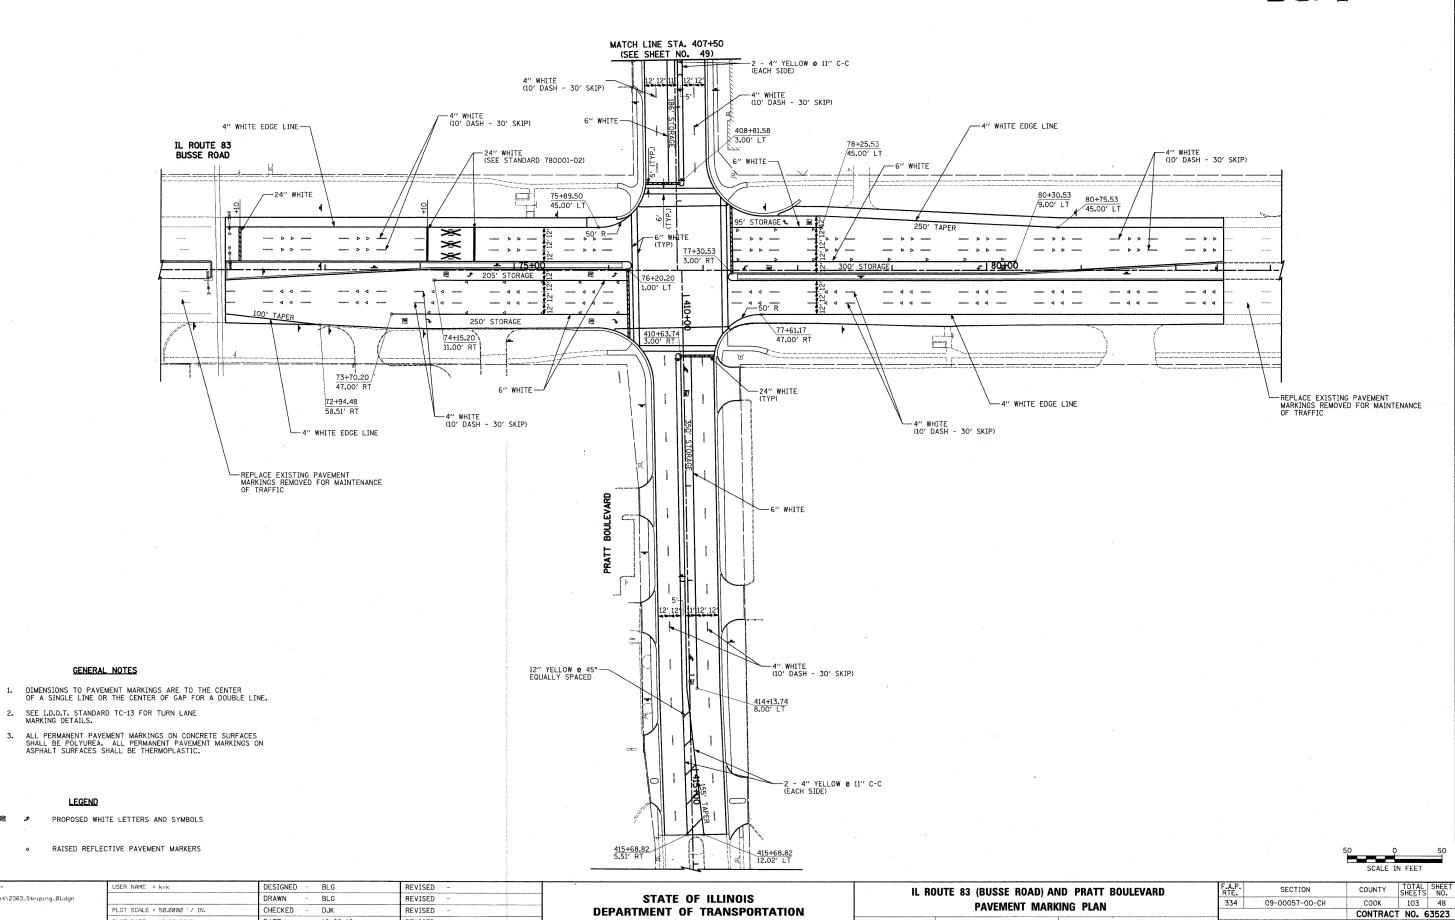
*ADD 670' TO ALL ELEVATIONS

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\2363\cad\sheet\2363_IGP_02.dgn		DRAWN - BLG	REVISED -	STATE OF ILLINOIS	RAILROAD CROSSING GRADING PLAN	334 09-00057-00-CH	COOK 103 47
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FED. ROAD DIST. NO. 1 ILLINOIS FED. AID PROJECT M-9003(660)

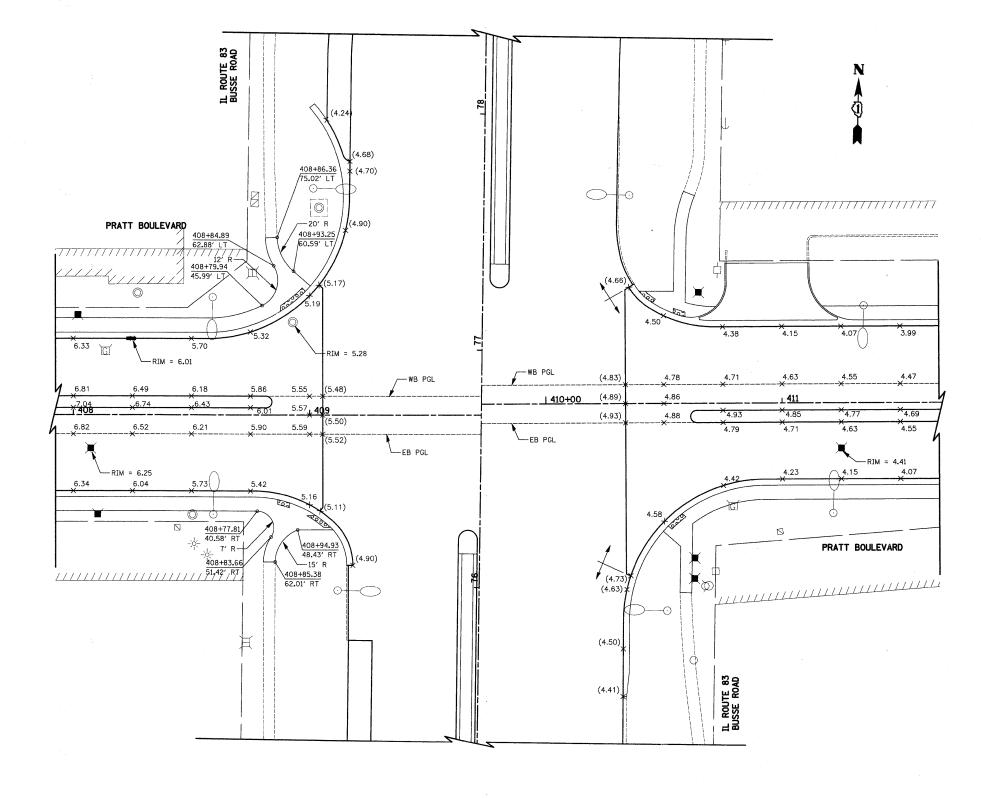

SCALE: 1" = 50' SHEET NO. 1 OF 2 SHEETS

SURVEYED PLOTTED ALIGNMENT CHECKED RT, OF WAY CHECKED CADD FILE NAME


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PLOT DATE = 10/22/2010

REVISED

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GENERAL NOTES


- 1. DIMENSIONS TO PAVEMENT MARKINGS ARE TO THE CENTER OF A SINGLE LINE OR THE CENTER OF GAP FOR A DOUBLE LINE.
- 2. SEE I.D.O.T. STANDARD TC-13 FOR TURN LANE MARKING DETAILS.
- 3. ALL PERMANENT PAVEMENT MARKINGS ON CONCRETE SURFACES SHALL BE POLYUREA. ALL PERMANENT PAVEMENT MARKINGS ON ASPHALT SURFACES SHALL BE THERMOPLASTIC.

LEGEND

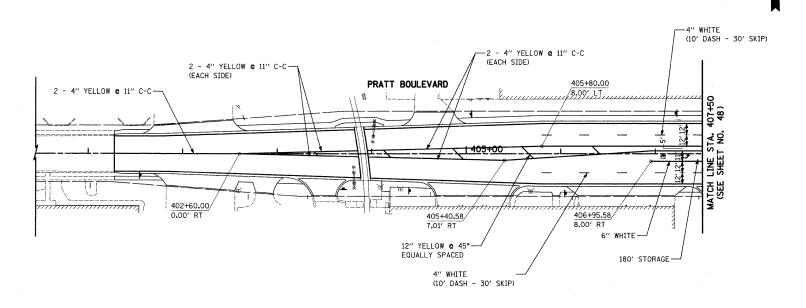- PROPOSED WHITE LETTERS AND SYMBOLS
 - RAISED REFLECTIVE PAVEMENT MARKERS

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	PLOT DATE = 10/22/2010	DATE -	10-22-10	REVISED -		SCALE: 1" = 50' SHEET NO. 2 OF 2 SHEETS	FED. ROAD	DIST. NO. 1 ILLINOIS FED.		M-9003(660)

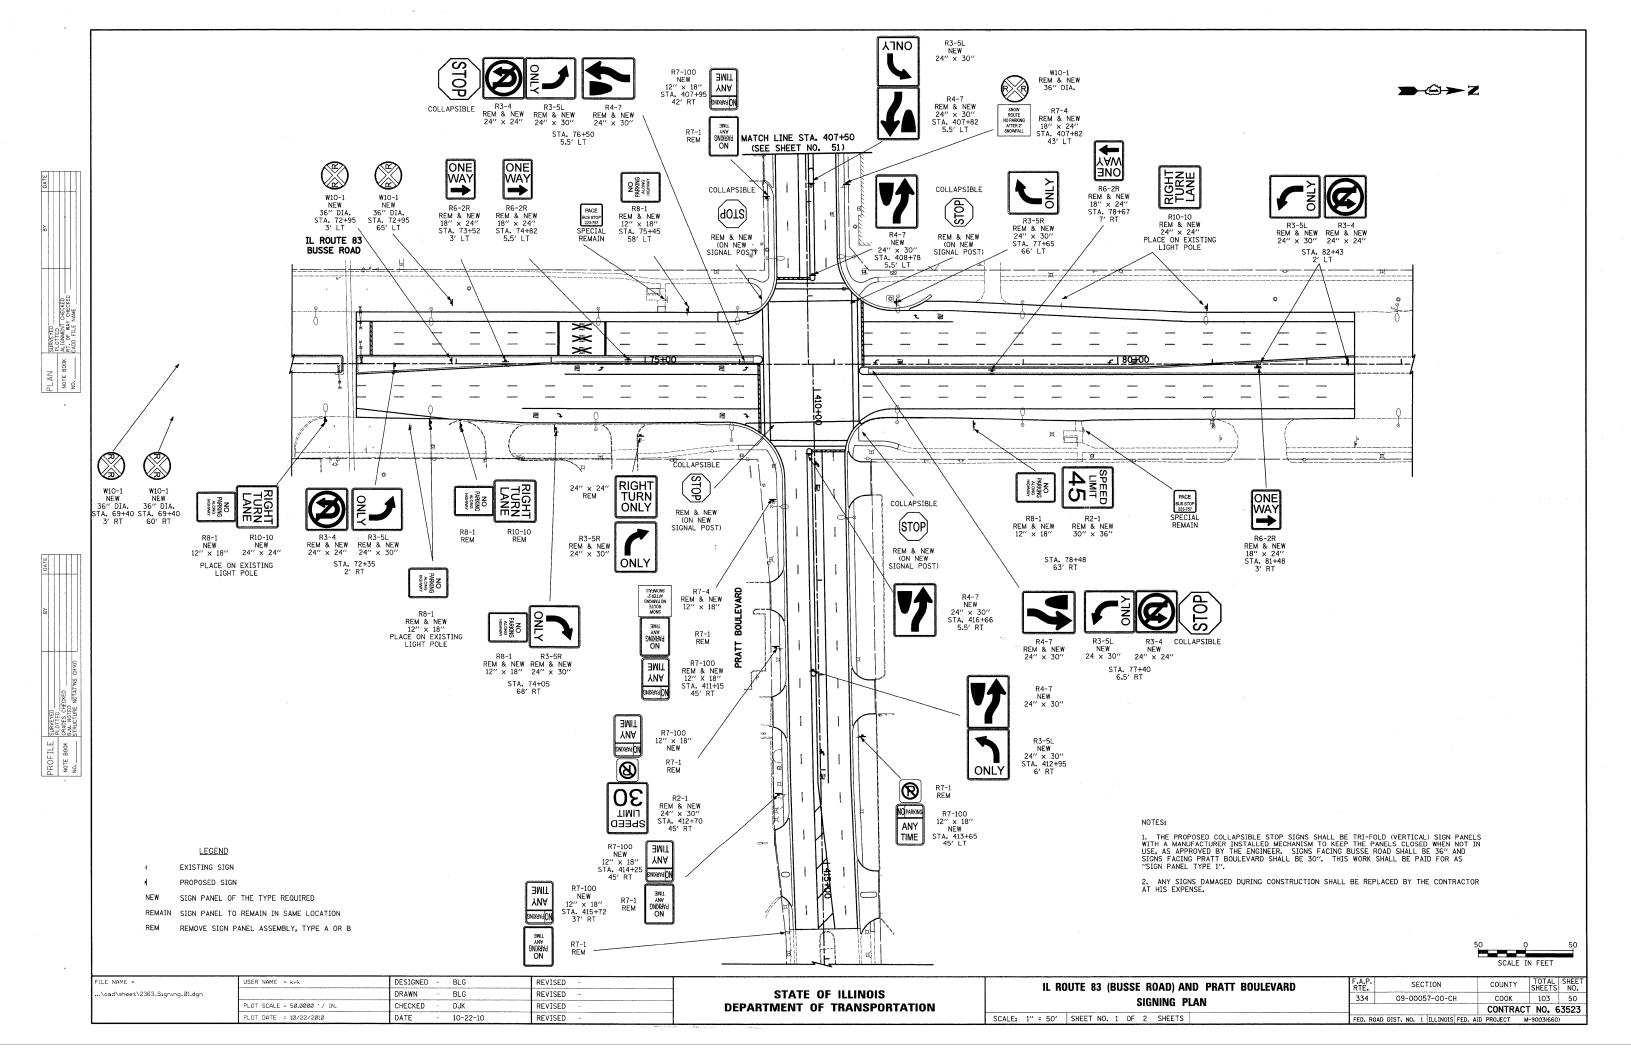


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LEGEND

EXISTING SIGN

PROPOSED SIGN


NEW SIGN PANEL OF THE TYPE REQUIRED


REMAIN SIGN PANEL TO REMAIN IN SAME LOCATION

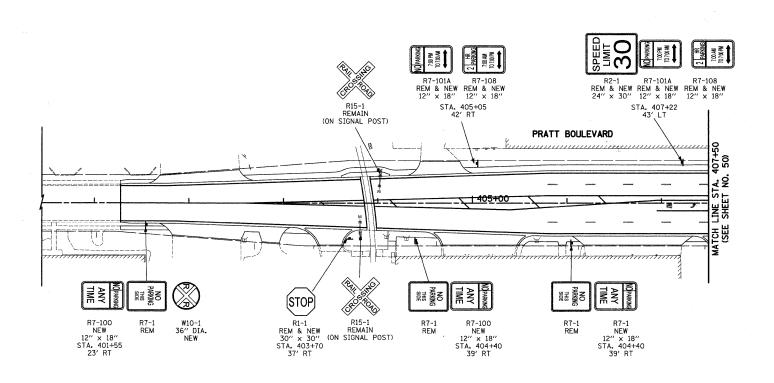REM REMOVE SIGN PANEL ASSEMBLY, TYPE A OR B

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	SCALE	IN	FEET

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\oad\sheet\2363_Signing_02.dgn		DRAWN - BLG	REVISED -	STATE OF ILLINOIS	SIGNING PLAN	334	09-00057-00-CH	COOK	103	51
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	PLOT DATE = 10/22/2010	DATE - 10-22-10	REVISED -		SCALE: 1" = 50' SHEET NO. 2 OF 2 SHEETS	FED. ROAD	DIST. NO. 1 ILLINOIS FED. AI	D PROJECT N	M-9003(660	J)

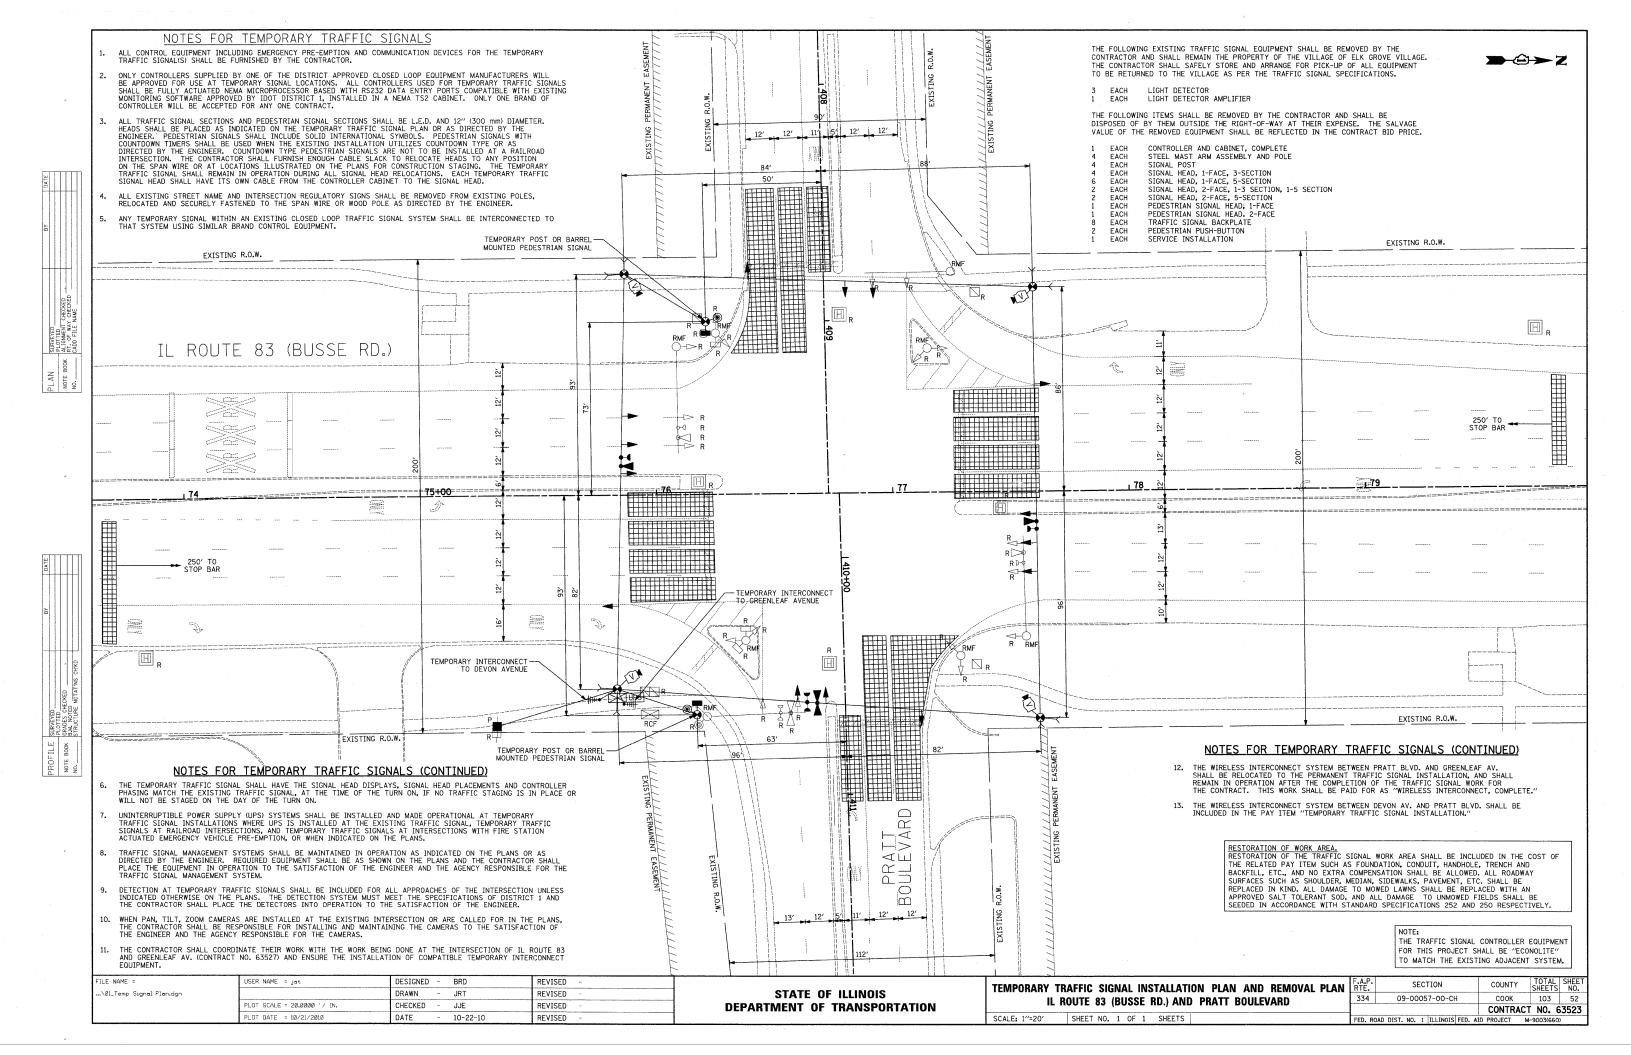

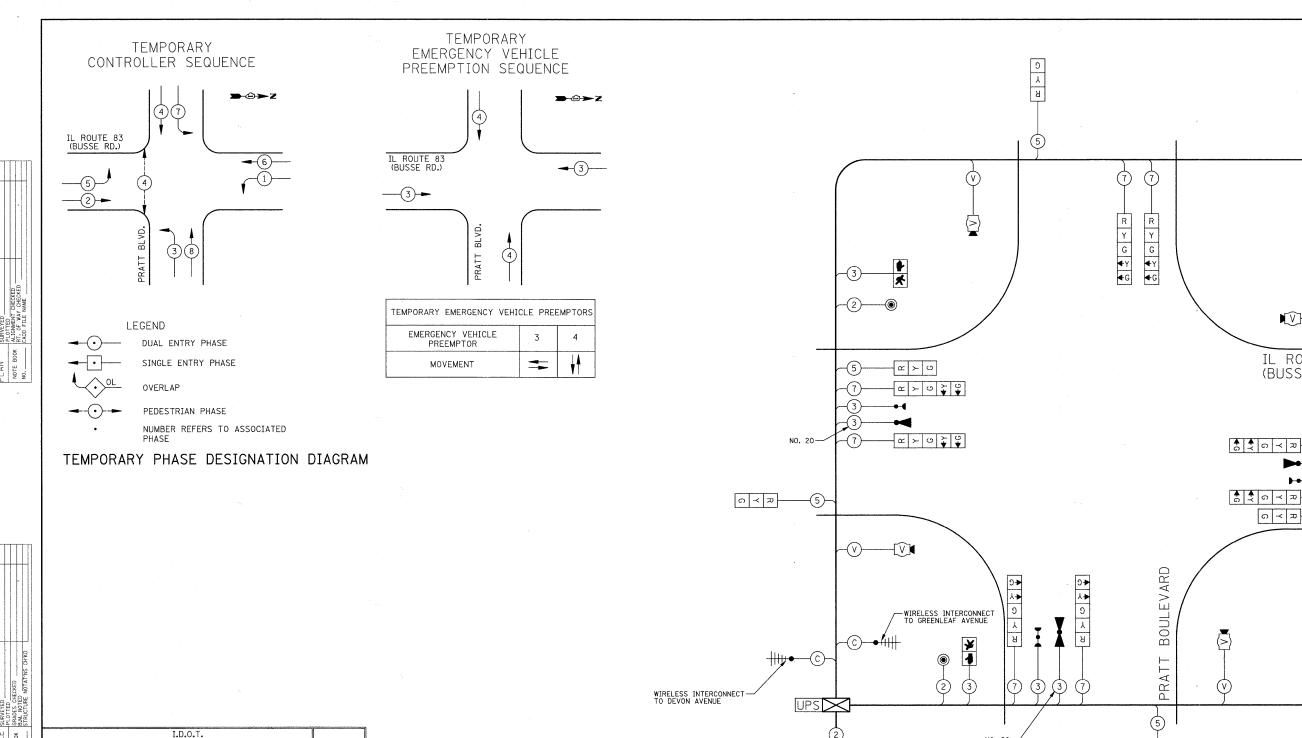

STATE OF ILLINOIS

DEPARTMENT OF TRANSPORTATION

I.D.O.T.
TRAFFIC SIGNAL INSTALLATION
ELECTRICAL SERVICE REQUIREMENTS TOTAL WATTAGE X OPERATION SIGNAL (RED) (GREEN) TOTAL = 579

ENERGY COSTS TO: ILLINOIS DEPARTMENT OF TRANSPORTATION
201 WEST CENTER COURT
SCHAUMBURG, IL 60196-1096
ENERGY SUPPLY: CONTACT: ELEANOR SARALLO
PHONE: (630) 424-5124
COMPANY: COM ED

FILE NAME =

...\02_Temp Cable Plan.dgn

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TEMPORARY CABLE PLAN, TEMPORARY SEQUENCE OF OPERATION, & TEMPORARY EMERGENCY VEHICLE PREEMPTION SEQUENCE IL ROUTE 83 (BUSSE RD.) AND PRATT BOULEVARD NOT TO SCALE SHEET NO. 1 OF 1 SHEETS

TEMPORARY CABLE PLAN NOT TO SCALE

> 334 09-00057-00-CH CONTRACT NO. 63523

NOTE: THE TRAFFIC SIGNAL CONTROLLER EQUIPMENT FOR THIS PROJECT SHALL BE "ECONOLITE" TO MATCH THE EXISTING ADJACENT SYSTEM.


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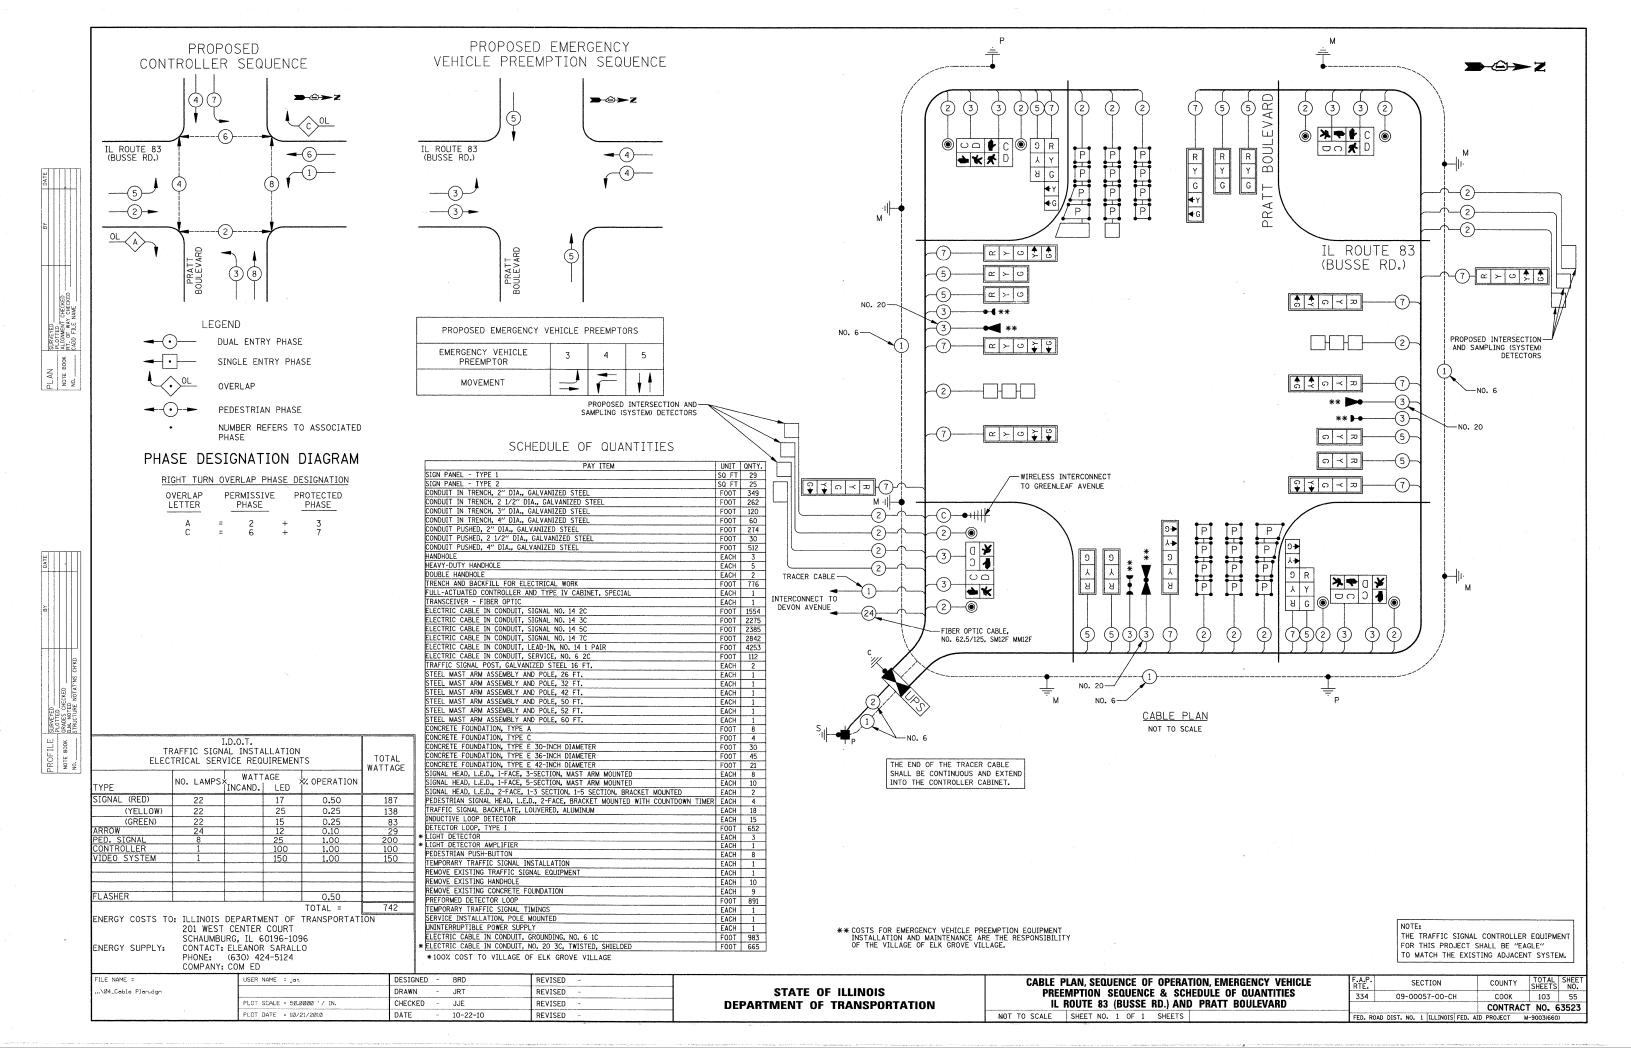
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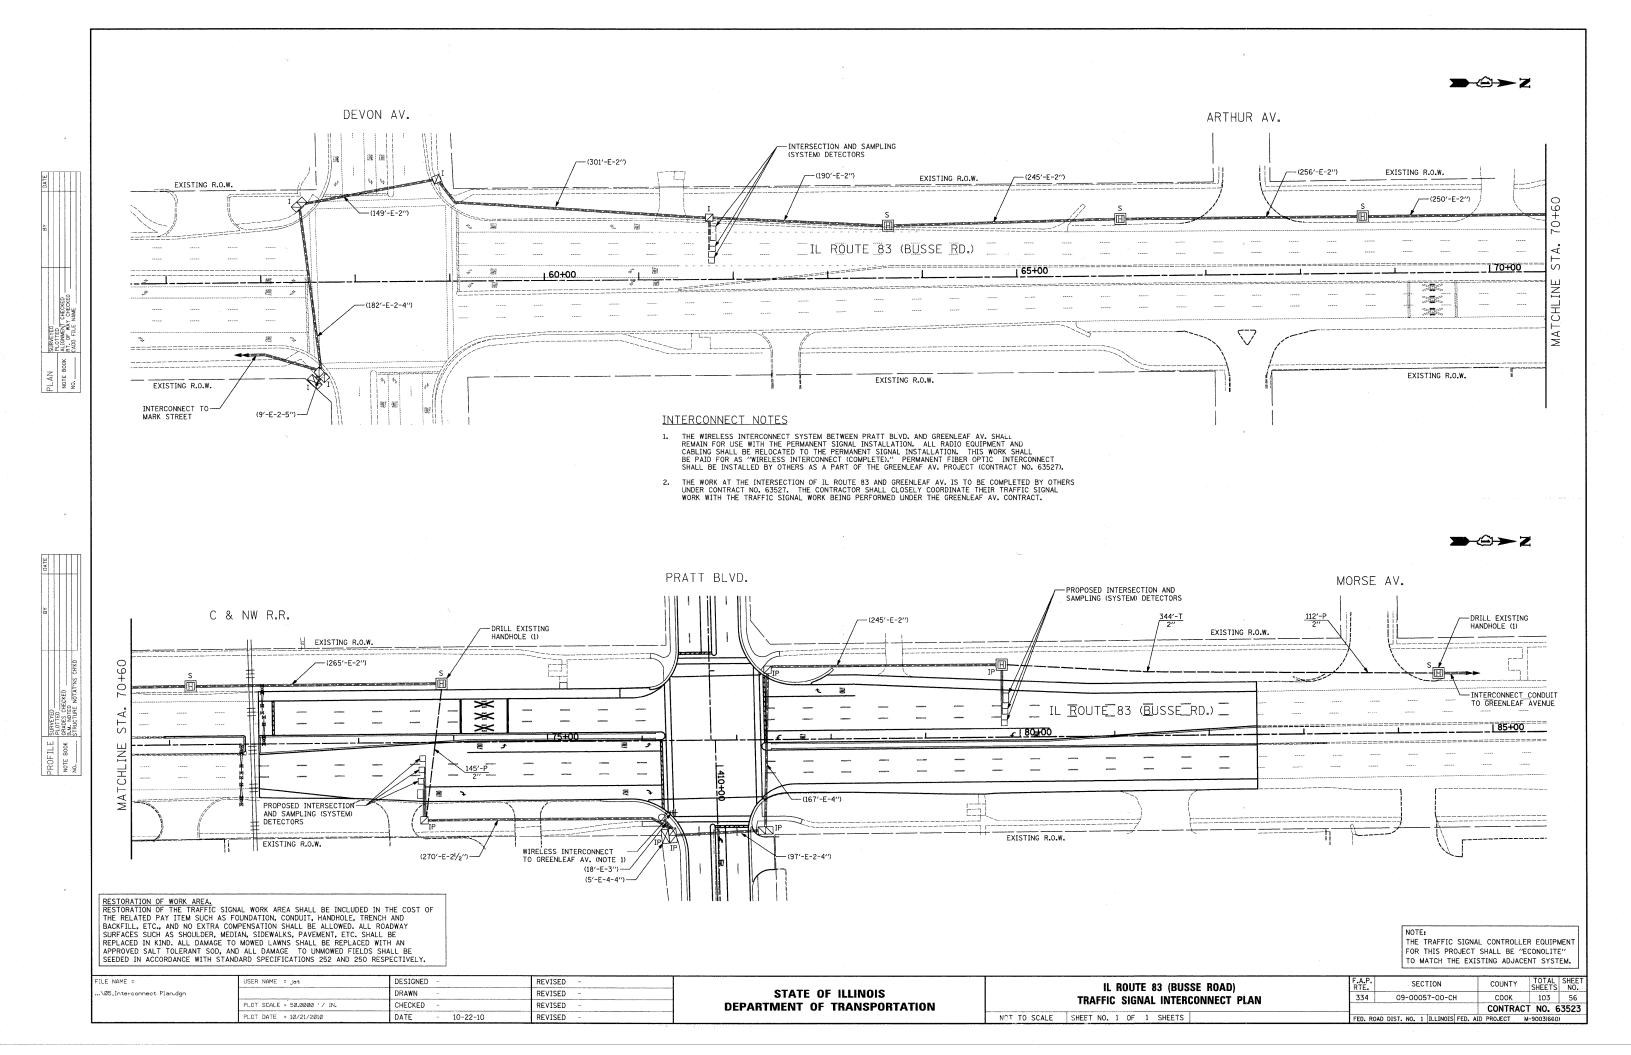
IL ROUTE 83


(BUSSE RD.)


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NOTE: SIGN DIMENSIONS ARE IN ENGLISH UNITS.

GENERAL NOTES

- WHERE MAST ARM MOUNTED STREET SIGNS ARE SPECIFIED, THE MAST ARM ASSEMBLY AND POLES SHALL BE DESIGNED TO SUPPORT THE LOADINGS CALLED FOR ON STANDARDS 8877001, 877002, 877006, 877011, 877012, AS APPLICABLE. PLUS TWO (2) SIGN PANELS 2'-6" X 8'-0" MOUNTED AS SHOWN. THE DESIGN SHALL BE IN ACCCORDANCE WITH THE REQUIREMENTS OF THE CURRENT "STANDARD SPECIFICATIONS FOR THE STRUCTURAL SUPPORTS FOR HIGHWAY SIGNS, LUMINAIRES, AND TRAFFIC SIGNALS" AS PUBLISHED BY THE AMERICAN ASSOCIATION OF STATE HIGHWAY AND TRANSPORTATION OFFICIALS FOR 80 M.P.H. WIND VELOCITIES.
- ALL SIGNS SHALL HAVE A WHITE REFLECTORIZED LEGEND AND BORDER ON A GREEN REFLECTORIZED BACKGROUND, TYPE A SHEETING.
- 3. THE SIGN LENGTH SHOULD BE INCREASED IN 6-INCH INCREMENTS, BUT THE OVERALL LENGTH SHALL NOT EXCEED 8'0".
- ALL BORDERS SHALL BE 3/4" WIDE AND CORNER RADIUS SHALL BE 2-1/4".
- SIGNFIX ALUMINUM CHANNEL FRAMING SYSTEM SHALL BE USED FOR ALL SIGNS ATTACHED TO SIGNAL POLES AND POSTS. LOCAL SUPPLIERS OF THE SIGNFIX ALUMINUM CHANNEL FRAMING SYSTEM ARE:
 - *J.O. HERBERT CO. MIDLOTHIAN, VA

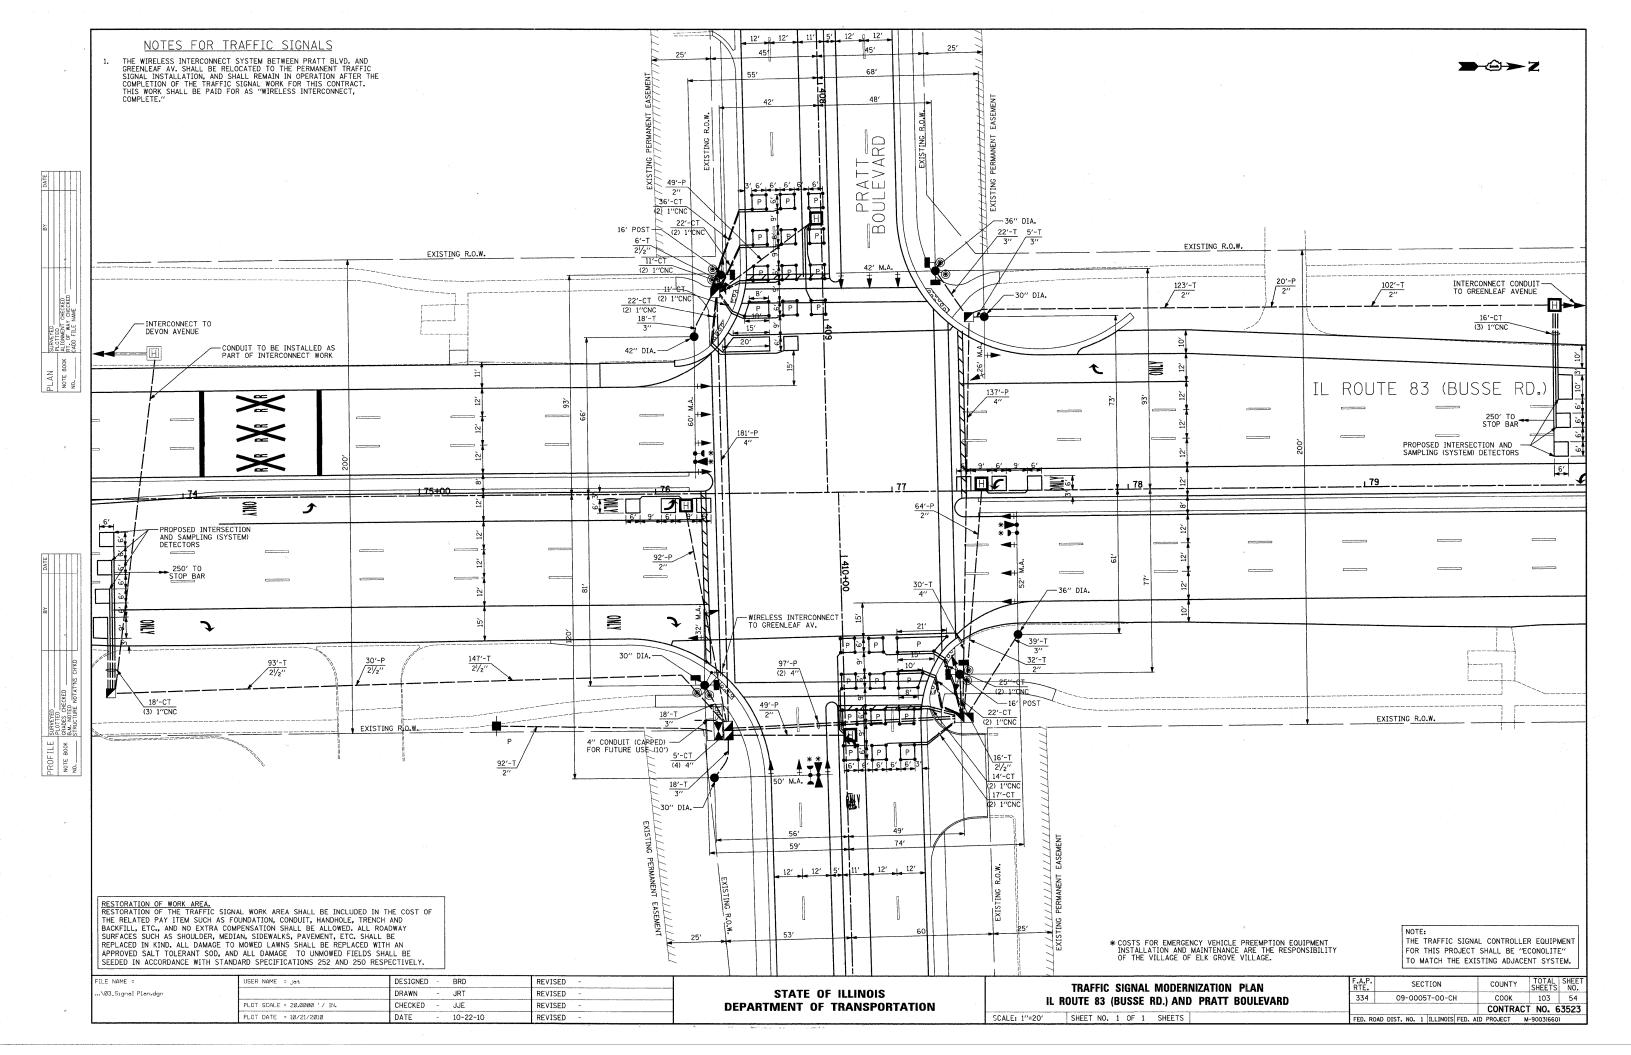* WESTERN REMAC INC. WOODRIDGE, IL

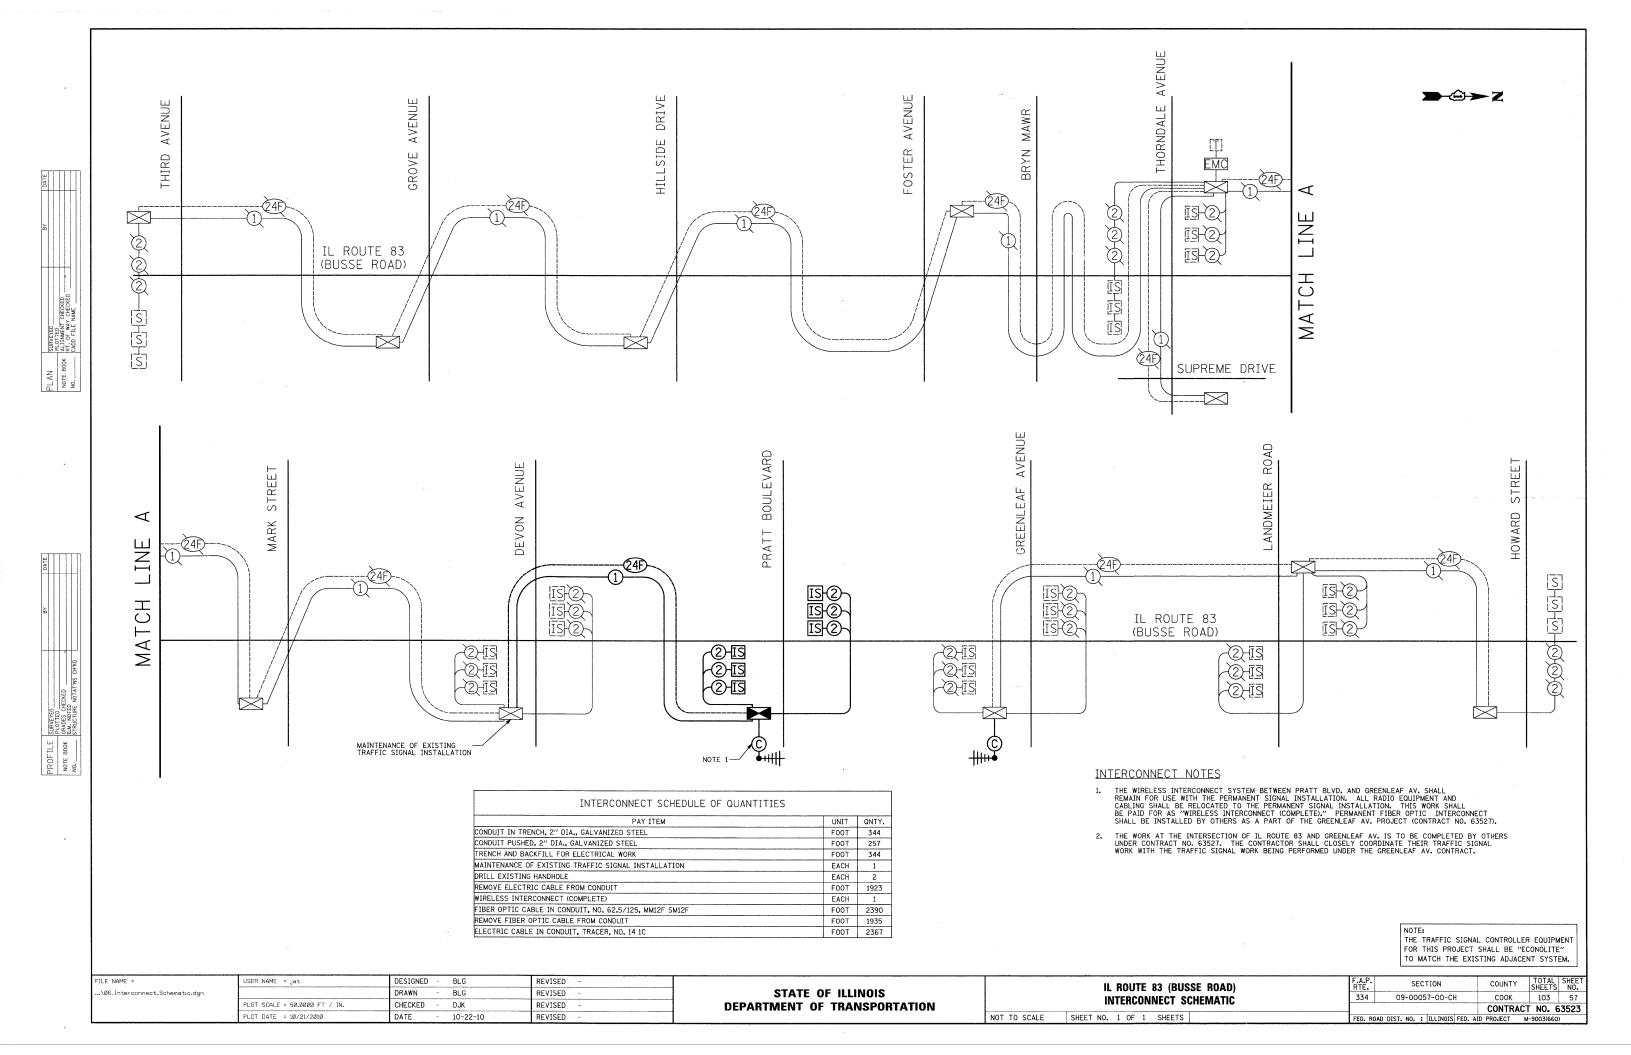PARTS LISTING:

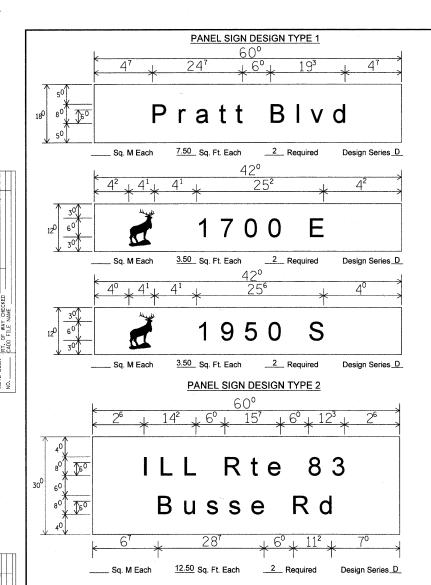SIGN CHANNEL PART #HPN053 (MED. CHANNEL) 1/4 " x 14 x 1" H.W.H #3

SIGN SCREWS

SELF TAPPING WITH NEOPRENE WASHER

BRACKETS

FILE NAME =

PART #HPN034 (UNIVERSAL)

CHANNEL CLAMPS WITH STAINLESS STEEL STRAPPING

OTHER BRANDS OF MOUNTING HARDWARE ARE ACCEPTABLE, BASED UPON THE DEPARTMENT'S APPROVAL AND COMPATIBILITY WITH THE CHANNEL/BRACKET OF THE ABOVE PRODUCT.

PLOT DATE = 10/21/2010


ARM BRD DESIGNED -REVISED ...\07_Mast Arm Mounted Street Name Sign DRAWN - JRT REVISED PLOT SCALE = 50.0000 '/ IN. CHECKED REVISED


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DATE


SUPPORTING CHANNELS



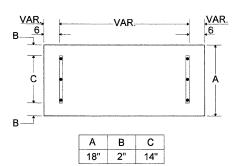

SIGNFIX ALUMINUM CHANNEL FRAMING SYSTEM shall be used. See Note #5.

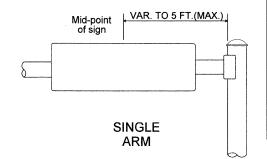SUPPORTING CHANNELS

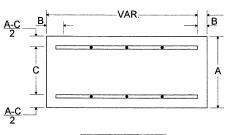

Α	В	С
18"	2"	12"
30"	2"	22"

Secure Sign to Mast Arm

DUAL

UPPER TO LOWER CASE

SPACING CHART 8-6 INCH SERIES "C & D"

						SE	CON	D LE	TTE	R						
	a c		bh Im r	nр	fw		j		S	t	v -y		X		Z	<u>'</u>
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CEG	14	15	2 ⁰	2 ¹	12		06				1 ²		14	1 ⁵		
DOQR	14	1 ⁵	2 ⁰	21	14		06			14			14	1 ⁵	14	
F	0 ⁵	06	14	1 ⁵	06	10	0 ⁵						06	10	11	1 ²
HIMN	2 ⁰	2 ¹	2 ²	2 ⁴	2 ⁰	2 ¹	14							2 ¹	2 ⁰	2 ¹
JU	2 ⁰	2 ¹	2 ⁰	2 ¹	1 ⁶	17				17	16	17	16	17	2 ⁰	2 ¹
K L	11	1 ²			11	1 ²	0 ⁵		11	1 ²	11	1 ²	11	1 ²	12	14
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LOWER CASE TO LOWER CASE

SPACING CHART 6 INCH SERIES "C" & "D"

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T	bfkops	1 ²	14	16	17	11	1 ²	- 1	06	11	1 ²	11	1 ²	1 ²	14	12	14		
L	се	12	14	16	17	1 ²	14	06		1 ²	14	12	14	1 ²	14	1 ²	14		
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NUMBER TO NUMBER

SPACING CHART 8 INCH SERIES "C" & "D"

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UPPER AND LOWER CASE LETTER WIDTHS

EXAMPLE, 23 DENOTES 3/8"

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5	3 ²	40	43	53	
6	3 ²	40	43	5 ³	
7	3 ²	40	43	5 ³	
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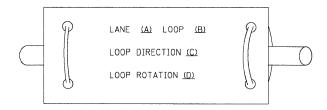
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F.A.P. RTE.	SECTION	COUNTY	TOTAL SHEET SHEETS NO.
334	09-00057-00-CH	COOK	103 58
		CONTRACT	NO. 63523
FED. R	DAD DIST. NO. 1 ILLINOIS FED. A	ID PROJECT M	-9003(660)


LOOP DETECTOR NOTES

- 1. EACH PAIR OF LOOP WIRES SHALL BE PLACED IN A SEPARATE EMPTY COILABLE NONMETALLIC CONDUIT FROM THE EDGE OF PAVEMENT TO THE HANDHOLE. SPACING BETWEEN THE HOLES DRILLED IN THE PAVEMENT SHALL NOT BE LESS THAN 6" (150 mm). EMPTY COILABLE NONMETALLIC CONDUIT SHALL BE INCLUDED IN THE COST OF THE LOOP WIRE.
- 2. THE NUMBER OF LOOP TURNS SHALL BE AS RECOMMENDED BY THE AMPLIFIER MANUFACTURER. ALL ADJACENT SIDES OF THE LOOPS SHALL BE INSTALLED IN SUCH A WAY THAT THE CURRENT FLOW IS IN THE SAME DIRECTION TO REINFORCE ITS MAGNETIC FIELDS FOR SMALL VEHICLE DETECTION.
- 3. EACH LOOP LEAD-IN SHALL BE IDENTIFIED AND PERMANENTLY TAGGED IN THE HANDHOLE. EACH LEAD-IN CABLE TAG SHALL INDICATE THE LOCATION OF THE LOOP, LOOP ROTATION (CLOCKWISE/COUNTERCLOCKWISE), LOOP LEAD-IN DIRECTION (IN OR OUT), LOOP CABLE NUMBER AND LOCATION IN CABINET, AND NUMBER OF TURNS IN THE DETECTOR LOOPS IN WATER PROOF INK AS INDICATED ON THE DISTRICT 1 STANDARD TRAFFIC SIGNAL DESIGN DETAIL. THE CONTRACTOR SHALL MARK LOOP LOCATIONS ON RECORD DRAWINGS AND PRESENT TO THE ENGINEER AFTER FINAL INSPECTION. LOOPS SHALL BE MARKED BY LANE AND LOOP NUMBER. SEE DETAIL BELOW.
- 4. ALL LOOP CABLE SHALL BE FASTENED WITH PLASTIC TIE WRAP TO THE HANDHOLE HOOKS.
- 5. IN ASPHALT PAVEMENT, LOOPS SHOULD BE PLACED IN THE BINDER AND DIVEHOLES MARKED AT THE CURB WITH A SAW-CUT. THE SAW-CUT SHALL BE CUT IN ACCORDANCE WITH LOCAL AND E.P.A. DUST CONTROL REQUIREMENTS. DETECTOR LOOP(S) SHALL NOT BE INSTALLED IN WET CONDITIONS AND THE SAW-CUTS MUST BE FREE OF DEBRIS AND RESIDUE SUCH AS DUST AND WATER WHICH IS TO BE ACHIEVED BY THE USE OF COMPRESSED AIR, WIRE BRUSHING AND HEAT DRYING ACCORDING TO SEALANT MANUFACTURER REQUIREMENTS. THE DETECTOR WIRE SHALL BE HELD IN PLACE BY THE USE OF FORM WEDGES. WEDGES SHALL BE SPACED NO MORE THAN 18" (450 mm) APART.
- 6. LOOP SPLICES SHALL BE SOLDERED USING A SOLDERING IRON. BLOW TORCHES OR OTHER DEVICES WHICH OXIDIZE COPPER CABLE SHALL NOT BE ALLOWED FOR SOLDERING OPERATIONS. SEE DETAIL BELOW RIGHT.
- 7. PREFORMED DETECTOR LOOPS SHALL BE USED, AS SHOWN ON THE PLANS, WHERE NEW CONCRETE PAVEMENT IS PROPOSED. THE INSTALLATION OF PREFORMED LOOPS SHALL BE IN ACCORDANCE WITH THE DISTRICT 1 SPECIFICATIONS OR AS DIRECTED BY THE ENGINEER.

LOOP LEAD-IN CABLE TAG




- A. LANE 1 IS THE LANE CLOSEST TO THE CENTERLINE OF THE ROADWAY
- B. LOOP #1 IS THE LOOP IN THE LANE CLOSEST TO THE INTERSECTION.
- C. LABEL LOOP CABLE "IN" OR LOOP CABLE "OUT".
- D. LABEL LOOP CABLE CLOCKWISE OR LOOP CABLE COUNTERCLOCKWISE.

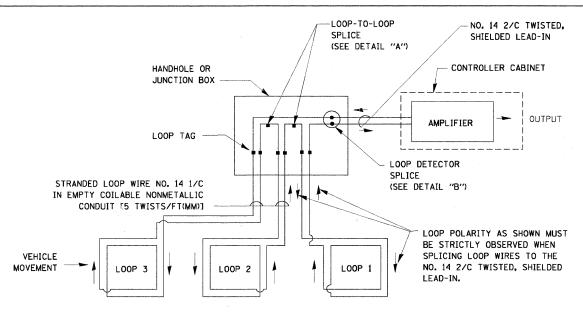

DETECTOR LOOP WIRING SCHEMATIC

- LOOPS SHALL BE SPLICED IN SERIES.
- " SAW-CUTS SHALL BE A MINIMUM WIDTH OF 5/16" (8 mm).
- SAW-CUT DEPTHS SHALL BE 3" (75 mm). IF IN CONCRETE, THE SAW-CUT DEPTH SHALL BE TO THE TOP OF THE REINFORCEMENT.
- LOOP CORNERS SHALL BE DRILLED WITH A 2" (50 mm) DIAMETER CORE.

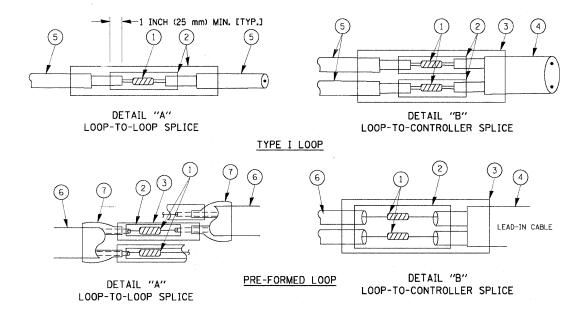

LOOP DETECTOR SPLICE

- WESTERN UNION SPLICE SOLDERED WITH ROSIN CORE FLUX. ALL EXPOSED SURFACES OF THE SOLDER SHALL BE SMOOTH.
- (2) WCSMW 30/100 HEAT SHRINK TUBE, MINIMUM LENGTH 3" (75 mm), UNDERWATER GRADE.
- (3) WCS 200/750 HEAT SHRINK TUBE, MINIMUM LENGHT 6" (150 mm), UNDERWATER GRADE.
- (4) NO. 14 2/C TWISTED, SHIELDED CABLE.
- (5) LOOP CONDUCTOR WITH FLEXIBLE PLASTIC TUBE.
- (6) PRE-FORMED LOOP

SCALE:

TL POLYOLEFIN 2 CONDUCTOR
BREAKOUT SEALS. TYCO CBR-2 OR APPROVED EQUAL

FILE NAME =	USER NAME = kanthaphixaybo	DESIGNED -	DAD	REVISED	-
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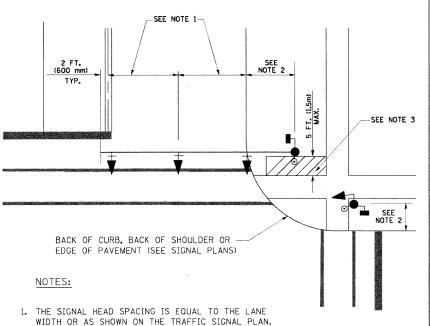
STATE OF ILLINOIS
DEPARTMENT OF TRANSPORTATION

STANDARD TR

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DISTRICT	F.A.P. RTE.	SECTION	COUNTY	TOTAL SHEETS	SHEET NO.	
TANDARD TRAFFIC SIGNA	344	09-00057-00-CH	COOK	103	59	
7111871118 111711 110 01011	L BEGION BETTHE			CONTRACT	NO. F	63523
SHEET NO. 1 OF 6 SHEETS	STA. TO STA.	FED. RO	DAD DIST. NO. 1 ILLINOIS FED. A	ID PROJECT M-90	03(660)	


TRAFFIC SIGNAL MAST ARM AND SIGNAL POST

MAST ARM MOUNTED SIGNALS IN EXISTING, PROPOSED OR FUTURE SIDEWALK/BICYCLE PATH AREA. INTERSECTION SHOWN WITH PEDESTRIAN SIGNALS AND PEDESTRIAN PUSHBUTTON DETECTORS.




- 2. REFER TO THE TRAFFIC SIGNAL EQUIPMENT OFFSET TABLE.
- 3. PROVIDE A LEVEL ALL-WEATHER SURFACE (CONCRETE SIDEWALK, ASPHALT BICYCLE PATH SURFACE OR MATCHING MATERIAL TO THE ADJACENT SURFACE) UP TO THE MAST ARM SHAFT OR THE SIGNAL POST.
- 4. THE FACE OF THE PEDESTRIAN PUSHBUTTON SHALL BE PARALLEL TO THE CROSSWALK TO BE USED.
- 5. THE LOCATIONS AND INSTALLATION OF PEDESTRIAN SIGNAL HEADS AND PEDESTRIAN PUSHBUTTONS SHALL MEET THE REQUIREMENTS OF THE MUTCD AND INFORMATION FOUND IN THE "AMERICANS WITH DISABILITIES ACT ACCESSIBILITY GUIDELINES FOR BUILDINGS AND FACILITIES."

PEDESTRIAN SIGNAL POST AND PEDESTRIAN PUSH BUTTON POST

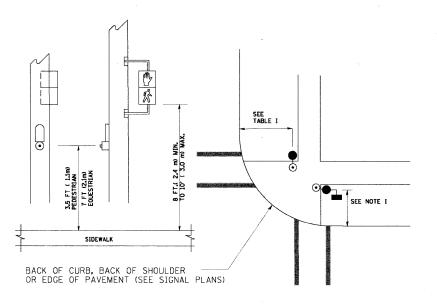

NOTES:

- 1. REFER TO THE TRAFFIC SIGNAL EQUIPMENT OFFSET TABLE.
- PROVIDE A LEVEL ALL-WEATHER SURFACE (CONCRETE SIDEWALK, ASPHALT BICYCLE PATH SURFACE OR MATCHING MATERIAL TO THE ADJACENT SURFACE) UP TO THE PEDESTRIAN SIGNAL POST OR THE PEDESTRIAN PUSH BUTTON POST.
- 3. THE FACE OF THE PEDESTRIAN PUSHBUTTON SHALL BE PARALLEL TO THE CROSSWALK TO BE USED.
- 4. THE LOCATIONS AND INSTALLATION OF PEDESTRIAN SIGNAL HEADS AND PEDESTRIAN PUSHBUTTONS SHALL MEET THE REQUIREMENTS OF THE MUTCD AND INFORMATION FOUND IN THE "AMERICANS WITH DISABILITIES ACT ACCESSIBILITY GUIDELINES FOR BUILDINGS AND FACILITIES."

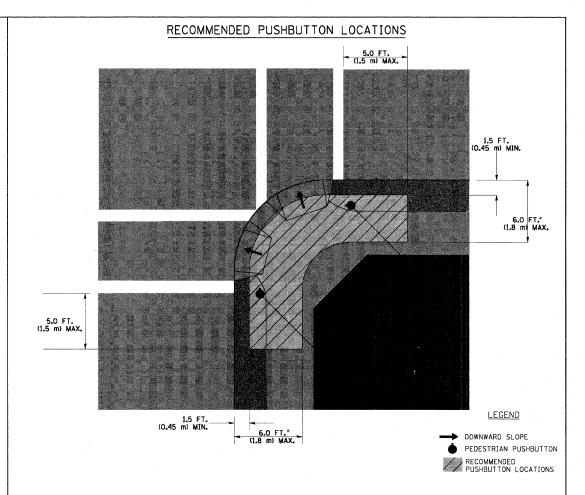

- * WHERE THERE ARE CONSTRAINTS THAT MAKE IT IMPRACTICAL TO PLACE THE PEDESTRIAN PUSHBUTTON BETWEEN 1.5 FT (0.45 m) AND 6 FT (1.8 m) FROM THE EDGE OF THE CURB, SHOULDER, OR PAVEMENT, IT SHOULD NOT BE FURTHER THAN 10 FT (3 m) FROM THE EDGE OF CURB, SHOULDER, OR PAVEMENT.
- •• WHERE THERE ARE CONSTRAINTS ON A PARTICULAR CORNER THAT MAKE IT IMPRACTICAL TO PROVIDE THE 10 FT (3 m) SEPERATION BETWEEN THE TWO PEDESTRIAN PUSHBUTTONS, THE PUSHBUTTONS MAY BE PLACED CLOSER TOGETHER OR ON THE SAME POLE.

NOTES:

- . PEDESTRIAN SIGNAL HEADS SHALL BE MOUNTED WITH THE BOTTOM OF THE SIGNAL HOUSING INCLUDING BRACKETS NOT LESS THAN 8 FT (2.4 m) OR MORE THAN 10 FT (3 m) ABOVE SIDEWALK LEVEL, AND SHALL BE POSITIONED AND ADJUSTED TO PROVIDE MAXIMUM VISIBILITY AT THE BEGINNING OF THE CONTROLLED CROSSWALK.
- 2. THE BOTTOM OF THE SIGNAL HOUSING (INCLUDING BRACKETS) OF A VEHICULAR SIGNAL FACE THAT IS NOT LOCATED OVER A HIGHWAY SHALL BE AT LEAST 8 FT (2.4 m) BUT NOT MORE THAN 19 FT (5.8 m) ABOVE THE SIDEWALK OR, IF THERE IS NO SIDEWALK, ABOVE THE PAVEMENT GRADE AT THE CENTER OF THE ROADWAY.
- 3. THE BOTTOM OF THE SIGNAL HOUSING AND ANY RELATED ATTACHMENTS TO A SIGNAL FACE LOCATED OVER ANY PORTION OF A HIGHWAY SHALL BE ACCORDING TO CURRENT STATE STANDARDS 877001, 877002, 877006, 877011 AND 877012 WITH A MINIMUM OF 16 FT (5.0 m) AND A MAXIMUM OF 18 FT. (5.5 m) FROM THE HIGHEST POINT OF PAVEMENT
- 4. THE BOTTOM OF THE TEMPORARY SPAN WIRE MOUNTED SIGNAL HOUSING AND ANY RELATED ATTACHMENTS TO A SIGNAL FACE LOCATED OVER ANY PORTION OF A HIGHWAY SHALL BE ACCORDING TO CURRENT STATE STANDARD 880001 WITH A MINIMUM OF 17 FT (5.18 m) FROM THE HIGHEST POINT OF PAVEMENT.
- 5. THE TOP OF THE SIGNAL HOUSING OF A SIGNAL FACE LOCATED OVER ANY PORTION OF A HIGHWAY SHALL NOT BE MORE THAN 25.6 FT (7.8 m) ABOVE THE PAVEMENT.

TRAFFIC SIGNAL EQUIPMENT OFFSET


TRAFFIC SIGNAL EQUIPMENT	COMBINATION CONCRETE CURB AND GUTTER (MINIMUM DISTANCE FROM BACK OF CURB TO CENTERLINE OF FOUNDATION)	SHOULDER/NON-CURBED AREA (MINIMUM DISTANCE FROM EDGE OF PAVEMENT TO CENTERLINE OF FOUNDATION)
TRAFFIC SIGNAL MAST ARM POLE	6 FT (1.8m)	SHOULDER WIDTH + 2 FT (0.6m), MINIMUM 10 FT (3.0m)
TRAFFIC SIGNAL POST	4 FT (1.2m)	SHOULDER WIDTH + 2 FT (0.6m), MINIMUM 10 FT (3.0m)
PEDESTRIAN SIGNAL POST	4 FT (1.2m)	SHOULDER WIDTH + 2 FT (0.6m), MINIMUM 10 FT (3.0m)
PEDESTRIAN PUSHBUTTON POST	4 FT (1.2m)	SHOULDER WIDTH + 2 FT (0.6m), MINIMUM 10 FT (3.0m)
TEMPORARY WOOD POLE	6 FT (1.8m)	SHOULDER WIDTH + 2 FT (0.6m), MINIMUM 10 FT (3.0m)
CONTROLLER CABINET	6 FT (1.8m) MINIMUM DISTANCE SEE NOTE 2	SHOULDER WIDTH + 6 FT (1.8m), MINIMUM 16 FT (4.9m) SEE NOTE 3.
SERVICE INSTALLATION, GROUND MOUNT	6 FT (1.8m) MINIMUM DISTANCE SEE NOTE 2	SHOULDER WIDTH + 6 FT (1.8m), MINIMUM 16 FT (4.9m) SEE NOTE 3.


NOTES


- 1. CONTACT THE "AREA TRAFFIC SIGNAL MAINTENANCE AND OPERATIONS ENGINEER" FOR ASSISTANCE IN LOCATING THE TRAFFIC SIGNAL EQUIPMENT WHEN THERE ARE CONFLICTS WITH DITCHES OR THE MINIMUM OFFSET DISTANCES CANNOT BE MET.
- 2. MINIMUM DISTANCE FROM THE BACK OF CURB TO THE ROADWAY SIDE OF THE FOUNDATION.
- 3. MINIMUM DISTANCE FROM THE EDGE OF PAVEMENT TO THE ROADWAY SIDE OF THE FOUNDATION.
- 4. ANY CHANGES TO THE OFFSETS OF THE FOUNDATIONS, FROM THE MINIMUM DISTANCES LISTED IN THE "TRAFFIC SIGNAL EQUIPMENT OFFSET" CHART AND THE TRAFFIC SIGNAL INSTALLATION PLAN, COULD EFFECT THE PLACEMENT OF THE SIGNAL HEADS, PEDESTRIAN SIGNAL HEADS AND THE PEDESTRIAN PUSHBUTTONS. THE SIGNAL HEAD PLACEMENT ON THE MAST ARMS SHALL REMAIN AS PER THE TRAFFIC SIGNAL INSTALLATION PLAN AND THE "TRAFFIC SIGNAL MAST ARM AND SIGNAL POST" DETAIL ABOVE. THE PROPOSED MAST ARM LENGTHS MAY NEED TO BE REVISED TO MEET THE ABOVE REQUIREMENTS. THE PEDESTRIAN SIGNAL HEADS AND PEDESTRIAN PUSHBUTTONS MUST MEET THE REQUIREMENTS UNDER THE DETAILS ON THIS SHEET.

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	PLOT DATE = 10/6/2009	DATE ~	10/28/09	REVISED -	

DISTRICT 1					F.A.P. SECTION		TOTAL SHEETS	SHEET NO.
STANDARD	TRAFFIC SIGNA	I DESIGN	DETAILS	344	09-00057-00-CH	COOK	103	60
STANDARL	J TRAFFIC SIGNA	r DESIGN	DETAILS			CONTRACT	NO. 6	3523
SCALE:	SHEET NO. 2 OF 6 SHEETS	STA.	TO STA.	FED. ROA	D DIST. NO. 1 ILLINOIS FED. AI	D PROJECT M-9	003(660)	

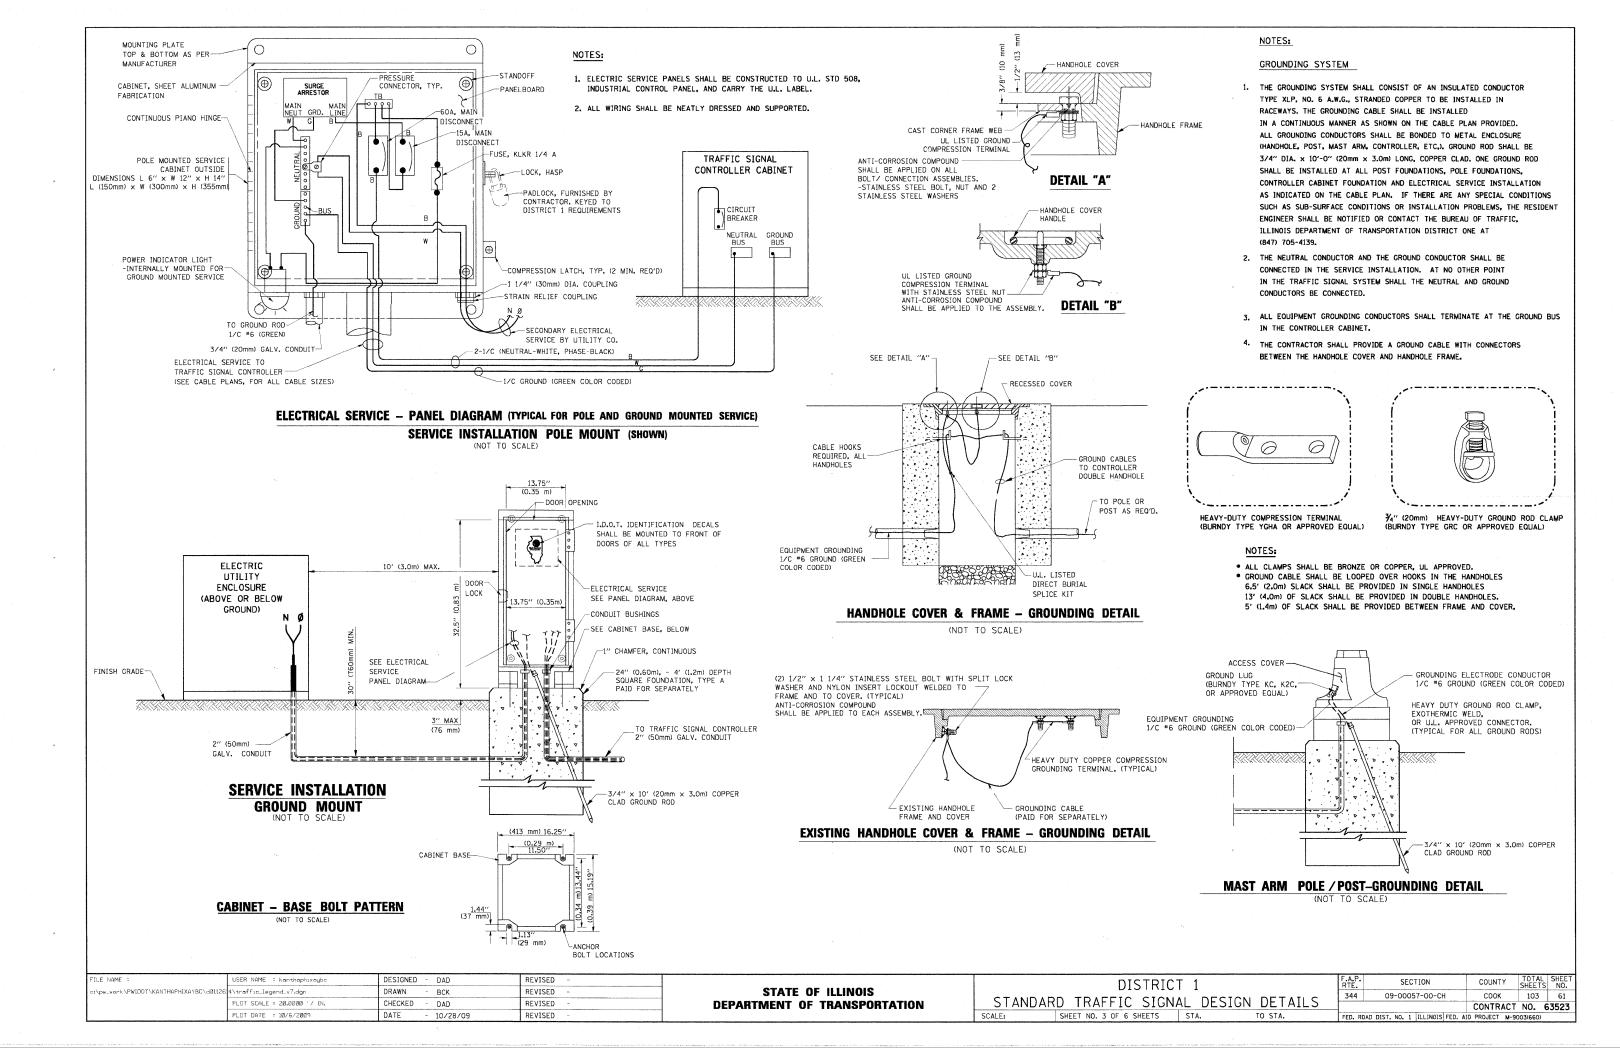

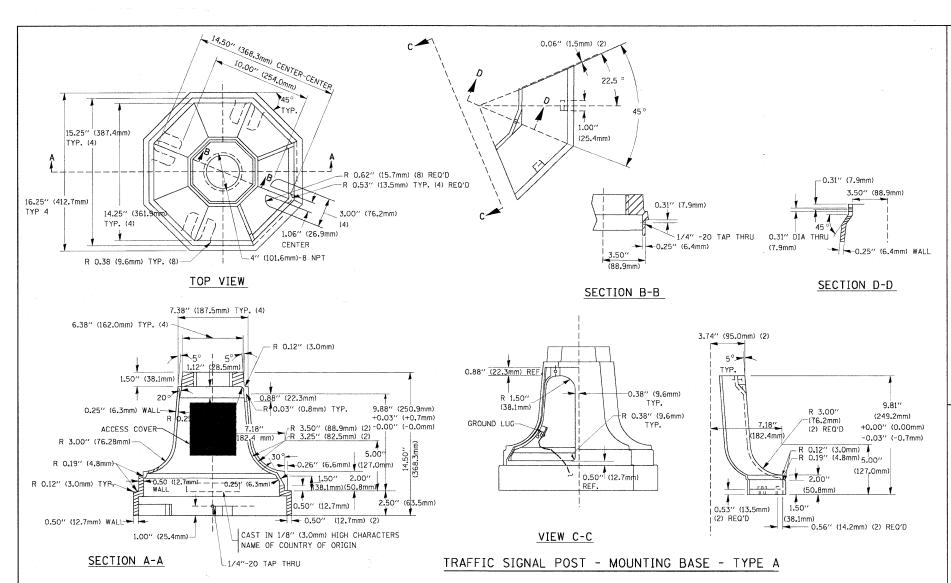

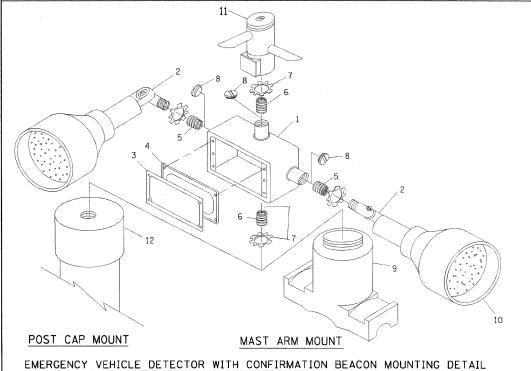


ITEM	NO	IDENTIFICATION
1	01	JTLET BOX- GALV. 21 CU.IN. (0.000344 CU-M)
2	L	AMP HOLDER AND COVER
3	01	JTLET BOX COVER
4	RI	JBBER COVER GASKET
5	RI	EDUCING BUSHING
6	3/,	4"(19 mm) CLOSE NIPPLE
7	3/,	4''(19 mm) LOCKNUT
8	3/	4"(19 mm) HOLE PLUG
9	S	ADDLE BRACKET - GALV.
10	6	WATT PAR 38 LED FLOOD LAMP
11	DI	TECTOR UNIT
12	PI	OST CAP [18 FT. (5.4 m) POST MIN.]

NOTES:

- ALL ELECTRICAL ITEMS, EXCEPT ITEMS #2 AND #11 SHALL BE ALUMINUM OR GALVANIZED
- 2. ITEM *1- OZ/GEDNEY FSX-1-50 OR EQUIVALENT
 ITEM *2- MULBERRY CON-O-SHADE LAMP SHIELD OR EQUIVALENT
 ITEM *9- "BAND-IT" SADDLE BRACKET OR EQUIVALENT
- 3. WHEN POST MOUNTING IS SPECIFIED, ITEM *9 SHALL NOT BE REQUIRED. THE DETECTION UNIT SHALL BE MOUNTED DIRECTLY ON TOP OF THE CAP BY DRILLING AND TAPPING A 3/119 mm) HOLE WITH PIPE THREADS. THE POST CAP SHALL EITHER BE SCREWED TO THE TOP OF THE POST OR A MINIMUM OF 3 TIGHTENING SCREWS SHALL BE REQUIRED ON EACH CAP.

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STATE OF ILLINOIS DEPARTMENT OF TRANSPORTATION

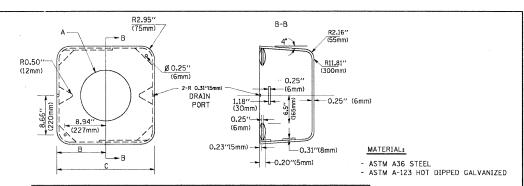


Α	В	С	HEIGHT	WEIGHT
VARIES	9.5"(241mm)	19"(483mm)	7" (178mm) - 12" (300mm)	53 lbs (24kg)
VARIES	10.75"(273mm)	21.5"(546mm)	7" (178mm) - 12" (300mm)	68 lbs (31 kg)
VARIES	13.0"(330mm)	26"(660mm)	7" (178mm) - 12" (300mm)	81 lbs (37 kg)
VARIES	18.5"(470mm)	37''(940mm)	7" (178mm) - 12" (300mm)	126 lbs (57 kg)

SHROUD

NOTES:

- DIMENSION "A" IS EQUAL TO THE DIAMETER OF THE MAST ARM POLE AT THE TOP OF THE SHROUD.
 THE SHROUD SHALL BE TIGHT TO THE MAST ARM POLE.
- 2. THE SUPPLIER SHALL VERIFIED THE ABOVE DIMENSIONS BASED ON MAST ARM REQUIREMENTS.
- 3. THE HEIGHT OF THE SHROUD SHALL COVER THE ANCHOR BOLTS, NUTS AND MAST ARM POLE BASE.

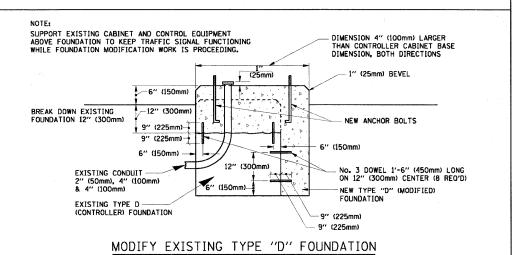


GALVANIZED STEEL HOOKS 21 ½" MIN. (545mm) CONDUIT BUSHING EXISTING CONDUIT TO BE REMOVED CONDUIT BUSHING EXISTING CONDUIT TO REMAIN EXISTING CONDUIT TO REMAIN FRENCH DRAIN PLAN


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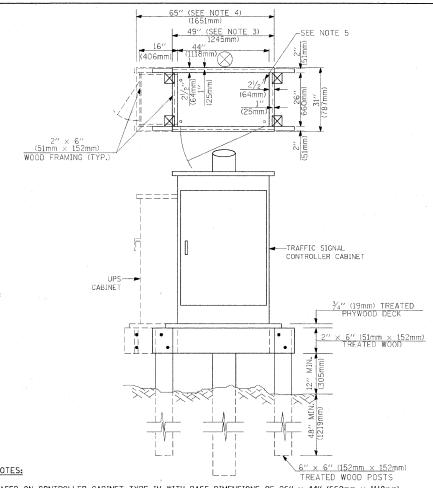
- 1. HANDHOLE CONSTRUCTED PER STATE STANDARD 814001.
- 2. REMOVAL OF THE EXISTING CONDUIT FROM THE HANDHOLE AND THE INSTALLATION OF THE CONDUIT BUSHINGS SHALL BE INCIDENTAL TO THE HANDHOLE.

HANDHOLE TO INTERCEPT EXISTING CONDUIT

L								
	DISTRIC	⁻ 1		F.A.P. RTE.	SECTION	COUNTY	TOTAL SHEETS	SHEET NO.
STANDAI	RD TRAFFIC SIGNA	NI DES	IGN DETAILS	344	09-00057-00-CH	COOK	103	62
3 / / / / / / / /	(B) (100 (100 (100))		TOIT DETAILS			CONTRACT	NO. E	53523
SCALE:	SHEET NO. 4 OF 6 SHEETS	STA.	TO STA.	FED. ROA	AD DIST. NO. 1 ILLINOIS FED. A	ID PROJECT M-9	003(660)	



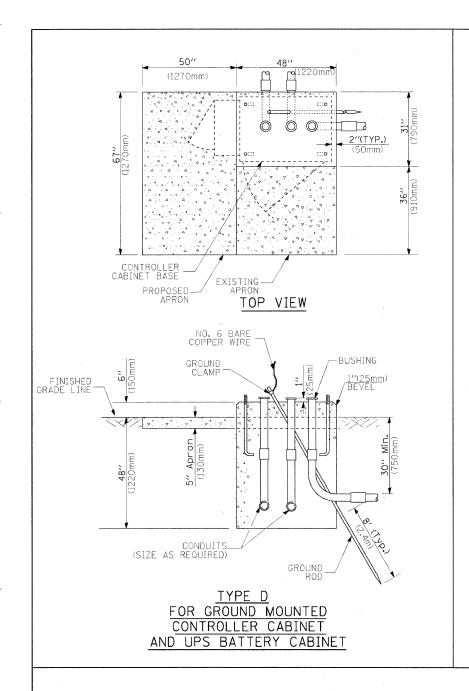

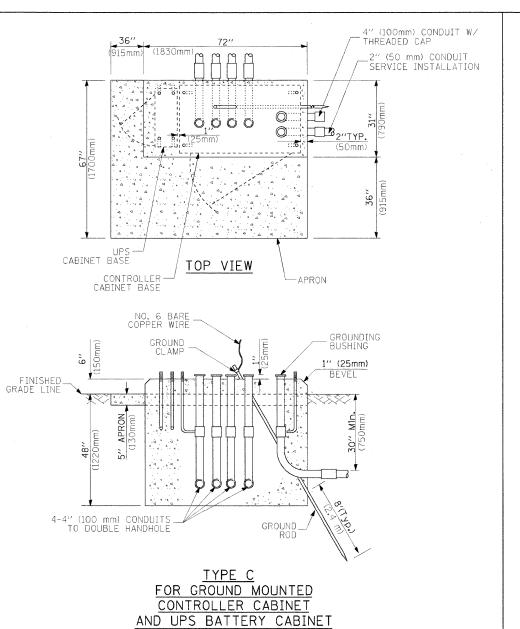

1. BASED ON CONTROLLER CABINET TYPE IV WITH BASE DIMENSIONS OF 26" x 44" (660mm x 1118mm). ADJUST PLATFORM SIZE TO FIT CABINET BASE DIMENSIONS BEING SUPPLIED.

BASED ON UNINTERRUPTIBLE POWER SUPPLY CABINET WITH BASE DIMENSIONS OF 16" x 25" (406mm x 635mm).
 ADJUST PLATFORM SIZE TO FIT CABINET BASE DIMENSIONS BEING SUPPLIED.

3. PLATFORM SIZE FOR CONTROLLER CABINET TYPE IV.

4. PLATFORM SIZE FOR CONTROLLER CABINET TYPE IV AND UNINTERRUPTIBLE POWER SUPPLY CABINET.

5. DRILLED HOLES THROUGH THE PLATFORM BASE TO MATCH THE CONTROLLER CABINET BOLT TEMPLATE. FASTEN THE CONTROLLER CABINET TO THE PLATFORM WITH CARRIAGE BOLTS, WASHERS AND NUTS.

6. FASTEN ALL SUPPORT WOOD FRAMING TO THE WOOD POSTS WITH 2 LAG SCREWS FOR EACH CONNECTION.

TEMPORARY SIGNAL CONTROLLER WOOD SUPPORT PLATFORM

CABLE SLACK LENGTH	FEET	METER
HANDHOLE	6.5	2.0
DOUBLE HANDHOLE	13.0	4.0
SIGNAL POST	2.0	0.6
MAST ARM	2.0	0.6
CONTROLLER CABINET	1.5	0.5
FIBER OPTIC AT CABINET	13.0	4.0
ELECTRIC SERVICE AT (CABINET OR SERVICE LOCATION)	1.5	0.5
GROUND CABLE (SIGNAL POST, MAST ARM, CABINET)	1,5	0.5
GROUND CABLE (BETWEEN FRAME AND COVER)	5.0	1.6

CABLE SLACK

VERTICAL CABLE LENGTH	FEET	METER
MAST ARM POLE (MAST ARM MOUNTED SIGNAL HEAD) (L = MAST ARM LENGTH - DISTANCE TO SIGNAL HEAD FROM END OF ARM)	20.0+L	6.0+L
BRACKET MOUNTED (MAST ARM POLE OR SIGNAL POLE)	13.0	4.0
PEDESTRIAN PUSH BUTTON	6.0	2.0
SERVICE INSTALLATION POLE MOUNT TO SERVICE DROP	13.5	4.1
SERVICE INSTALLATION POLE MOUNT TO GROUND	13.5	4.1
SERVICE INSTALLATION GROUND MOUNT	6.0	2.0
FOUNDATION (SIGNAL POST, MAST ARM POLE, CONTROLLER CABINET, SERVICE-GROUND MOUNT)	3.0	1.0

VERTICAL	

TYPE A - Signal Post	4'-0''	(1.2m)
TYPE C - CONTROLLER W/ L	JPS 4'-0"	(1.2m
TYPE D - CONTROLLER	4'-0"	(1.2m
SERVICE INSTALLATION, GROUND MOUNT, TYPE A - SQUARE	4'-0''	(1.2m

FOUNDATION

DEPTH OF FOUNDATION

Mast Arm Length	① Foundation Depth	Foundation Diameter	Spiral Diameter	Quantity of Rebars	Size of Rebars
Less than 30′ (9.1 m)	10'-0" (3.0 m)	30" (750mm)	24" (600mm)	8	6(19)
Greater than or equal to	13'-6" (4.1 m)	30" (750mm)	24" (600mm)	8	6(19)
30' (9.1 m) and less than 40' (12.2 m)	11'-0" (3.4 m)	36" (900mm)	30" (750mm)	12	7(22)
Greater than or equal to 40' (12.2 m) and less than 50' (15.2 m)	13'-0" (4.0 m)	36" (900mm)	30" (750mm)	12	7(22)
Greater than or equal to 50' (15.2 m) and up to 55' (16.8 m)	15'-0'' (4.6 m)	36" (900mm)	30" (750mm)	12	7(22)
Greater than or equal to 56′ (16.8 m) and less than 65′ (19.8 m)	21'-0" (6.4 m)	42" (1060mm)	36" (900mm)	16	8(25)
Greater than or equal to 65' (19.8 m) and up to 75' (22.9 m)	25'-0" (7.6 m)	42" (1060mm)	36" (900mm)	16	8(25)
NOTEC.					

NOTES:

- These foundation depths are for sites which have cohesive soils (clayey silt, sandy clay, etc.) along
 the length of the shaft, with an average Unconfined Compressive Strength (Qu) > 1.0 tsf (100 kpa).
 This strength shall be verified by boring data prior to construction or with testing by the Engineer
 during foundation drilling. The Bureau of Bridges & structures should be contacted for a revised
 design if other conditions are encountered.
- 2. Combination mast arm assemblies under 55 feet (16.8 m) shall use 36" (900 mm) diameter foundations.
- 3. Combination mast arm assemblies under 56 feet (16.8 m) through 75 feet (22.9 m) shall use 42" (1060 mm diameter foundations.
- 4. For most arm assemblies with dual arms refer to state standard 878001.


DEPTH OF MAST ARM FOUNDATIONS, TYPE E

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	PLOT SCALE = 20.0000 ′/ IN.	CHECKED -	DAD	REVISED		
·	PLOT DATE = 10/6/2009	DATE -	10/28/09	REVISED	-	


STATE OF ILLINOIS
DEPARTMENT OF TRANSPORTATION

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		· L	112	IKICI	1				_
STANDAR	RD T	RAFF	IC	SIGNA	٩L	DESIGN	DETAILS	S	
ALE:	SHEET	NO. 5 OF	6 SH	EETS	STA.		TO STA.		-

				TRAFFIC	SIGNAL	L LEGEN	<u>ID</u>				
ITEM	REMOVAL	EXISTING	PROPOSED	ITEM	REMOVAL	EXISTING	PROPOSED	ITEM	REMOVAL	EXISTING	PROPOSED
CONTROLLER CABINET	R R			EMERGENCY VEHICLE LIGHT DETECTOR	R≪	\bowtie	~	ELECTRIC CABLE IN CONDUIT, TRACER, NO. 14 1/C, UNLESS NOTED OTHERWISE		1)——	
RAILROAD CONTROL CABINET	·	R R	₽✓₽	CONFIRMATION BEACON	Ro-0	0-()	⊷ (NO. 14 1/C, UNLESS NOTED OTHERWISE		,	
COMMUNICATIONS CABINET	C C	ECC	СС		R		-	COAXIAL CABLE		_ ©	<u> </u>
MASTER CONTROLLER		EMC	MC	HANDHOLE	_					-/	
MASTER MASTER CONTROLLER		EMMC	MMC	HEAVY DUTY HANDHOLE	K	H	H	VENDOR CABLE FOR CAMERA			 V
UNINTERRUPTIBLE POWER SUPPLY	UPS	EUPS	UPS	DOUBLE HANDHOLE	R			COPPER INTERCONNECT CABLE, NO. 18 3 PAIR TWISTED, SHIELDED			-6-
SERVICE INSTALLATION, (P) POLE OR (G) GROUND MOUNT	- <u>R</u>	- <u></u> -	- -	JUNCTION BOX GALVANIZED STEEL CONDUIT	R			FIBER OPTIC CABLE NO. 62.5/125, MM12F		— <u>12</u> F—	
TELEPHONE CONNECTION (P) POLE OR (G) GROUND MOUNT	R	P	P	IN TRENCH (T) OR PUSHED (P)				FIBER OPTIC CABLE		— <u>24</u> F—	(24F)
STEEL MAST ARM ASSEMBLY AND POLE	R	O	•	TEMPORARY SPAN WIRE, TETHER WIRE, AND CABLE	<u>R</u>			NO. 62.5/125, MM12F SM12F			
ALUMINUM MAST ARM ASSEMBLY AND POLE	R			COMMON TRENCH			СТ	FIBER OFTIC CABLE NO. 62,5/125, (NUMBER OF FIBERS & TYPE TO BE			
STEEL COMBINATION MAST ARM	n:	· . O→X	• ×	COILABLE NONMETALLIC CONDUIT (EMPTY)			CNC	NOTED ON PLANS)			
ASSEMBLY AND POLE WITH LUMINAIRE	~~~~			SYSTEM ITEM		S	S	GROUND ROD AT (C) CONTROLLER, (H) HANDHOLE, (P) POST, (M) MAST ARM,		C _{II}	c _{il}
STEEL COMBINATION MAST ARM ASSEMBLY AND POLE WITH PTZ CAMERA	R P[Z]1	PIZ JI	FIZ	INTERSECTION ITEM		I	IP	OR (S) SERVICE CONTROLLER CABINET AND	RCF		,1
SIGNAL POST	R _O	0	•	REMOVE ITEM RELOCATE ITEM	R			FOUNDATION TO BE REMOVED			
TEMPORARY WOOD POLE (CLASS 5 OR BETTER) 45 FOOT (13.7m) MINIMUM	^R ⊗	\otimes	•	ABANDON ITEM	A	_		STEEL MAST ARM POLE AND FOUNDATION TO BE REMOVED	ORMF		
GUY WIRE	>R	>	>	12" (300mm) TRAFFIC SIGNAL SECTION		R	R	ALUMINUM MAST ARM POLE AND	RMF		
SIGNAL HEAD	R	~~-		12" (300mm) RED WITH 8" (200mm)		R		FOUNDATION TO BE REMOVED	O		
SIGNAL HEAD CONSTRUCTION STAGES (NUMBERS INDICATE THE CONSTRUCTION STAGE)			2	YELLOW AND GREEN TRAFFIC SIGNAL FACE				STEEL COMBINATION MAST ARM ASSEMBLY AND POLE WITH LUMINAIRE AND	RMF		a de la companya de l
SIGNAL HEAD WITH BACKPLATE	+₽ ^R	+->	+			(R)	R	FOUNDATION TO BE REMOVED			
SIGNAL HEAD OPTICALLY PROGRAMMED	R ▷′′P′′	−D′′P′′	→ "P"	SIGNAL FACE		(G)	G ◆Y	SIGNAL POST AND FOUNDATION TO BE REMOVED	RMF		
FLASHER INSTALLATION (S DENOTES SOLAR POWER)	O-(>''F''	O-D ^{"F"}	●→ "F"			€ 5	∢ G	INTERSECTION & SAMPLING (SYSTEM) DETECTOR		IS	IS
PEDESTRIAN SIGNAL HEAD	R	- Ū	-11	SIGNAL FACE WITH BACKPLATE.		R	R	SAMPLING (SYSTEM) DETECTOR		S	S
PEDESTRIAN PUSHBUTTON DETECTOR	(a)	©	•	"P" INDICATES PROGRAMMED HEAD			G	EXISTING INTERSECTION LOOP DETECTOR PROPOSED INTERSECTION AND SAMPLING (SYSTEM) DETECTOR	TECTOR	P	
ACCESSIBLE PEDESTRIAN PUSHBUTTON DETECTOR	R APS	@APS	APS O APS O O O O O O O O O O O O O			(P)	◆ Y ◆ G	EXISTING PREFORMED INTERSECTION LOOP DETECTOR		[PP]	
ILLUMINATED SIGN "NO LEFT TURN"	R		•				p	PROPOSED INTERSECTION AND SAMPLING (SYSTEM) DE	TECTOR	-	
	R			12" (300mm) PEDESTRIAN SIGNAL HEAD WALK/DON'T WALK SYMBOL		ÓW W		PREFORMED INTERSECTION AND SAMPLING (SYSTEM) DETECTOR		PIS	PIS
ILLUMINATED SIGN "NO RIGHT TURN"	0	<u></u>		12" (300mm) PEDESTRIAN SIGNAL HEAD INTERNATIONAL SYMBOL, OUTLINED				PREFORMED SAMPLING (SYSTEM) DETECTOR		PS	PS
DETECTOR LOOP, TYPE I				12" (300mm) PEDESTRIAN SIGNAL HEAD	•		•				
PREFORMED DETECTOR LOOP		[P]	Р	INTERNATIONAL SYMBOL, SOLID		(*	RAILROAI	D SYMB	OLS	
MICROWAVE VEHICLE SENSOR	R (M)(1)	[M]b	M	PEDESTRIAN SIGNAL HEAD, INTERNATIONAL SYMBOL, WITH COUNTDOWN TIMER		() C (() D	₽ C ★ D	1. 12°		EXISTING	PROPOSED
VIDEO DETECTION CAMERA	R (V) ∫	Ŷ	V ■	RADIO INTERCONNECT	- + ^R -○	##+0		RAILROAD CONTROL CABINET		R F	₽ <
VIDEO DETECTION ZONE				DADIO DEDEATED	1.			RAILROAD CANTILEVER MAST ARM		XOX X	X ex x x
	R.			RADIO REPEATER	RERR	ERR	RR	FLASHING SIGNAL		ZoZ	X⊕X
PAN, TILT, ZOOM CAMERA WIRELESS DETECTOR SENSOR	FED 13		₩)	DENOTES NUMBER OF CONDUCTORS, ELECTRIC CABLE NO. 14, UNLESS NOTED OTHERWISE, ALL DETECTOR LOOP CABLE TO BE SHIELDED				CROSSING GATE		X0X	XOX-
WIRELESS ACCESS POINT	R		W	GROUND CABLE IN CONDUIT NO. 6 SOLID COPPER (GREEN)				CROSSBUCK		*	*
FILE NAME = USER NAME = Jat\13.Standard Traffic Signal Detail_6.dgp		DESIGNED - DAG/BCK DRAWN - BCK	REVISED REVISED		E OF ILLINOIS	s		DISTRICT 1	F.A.P. RTE.	SECTION 09-00057-00-CH	COUNTY TOTAL SHEE SHEETS NO.
PLOT SCALE = 20.0000 '/ PLOT DATE = 10/21/2010		CHECKED - DAD DATE - 10/28/09	REVISED REVISED	DEPARTMENT			SCALE: NO	STANDARD TRAFFIC SIGNAL DESIGN DET	AILS		CONTRACT NO. 63523 D. AID PROJECT M-9003(660)

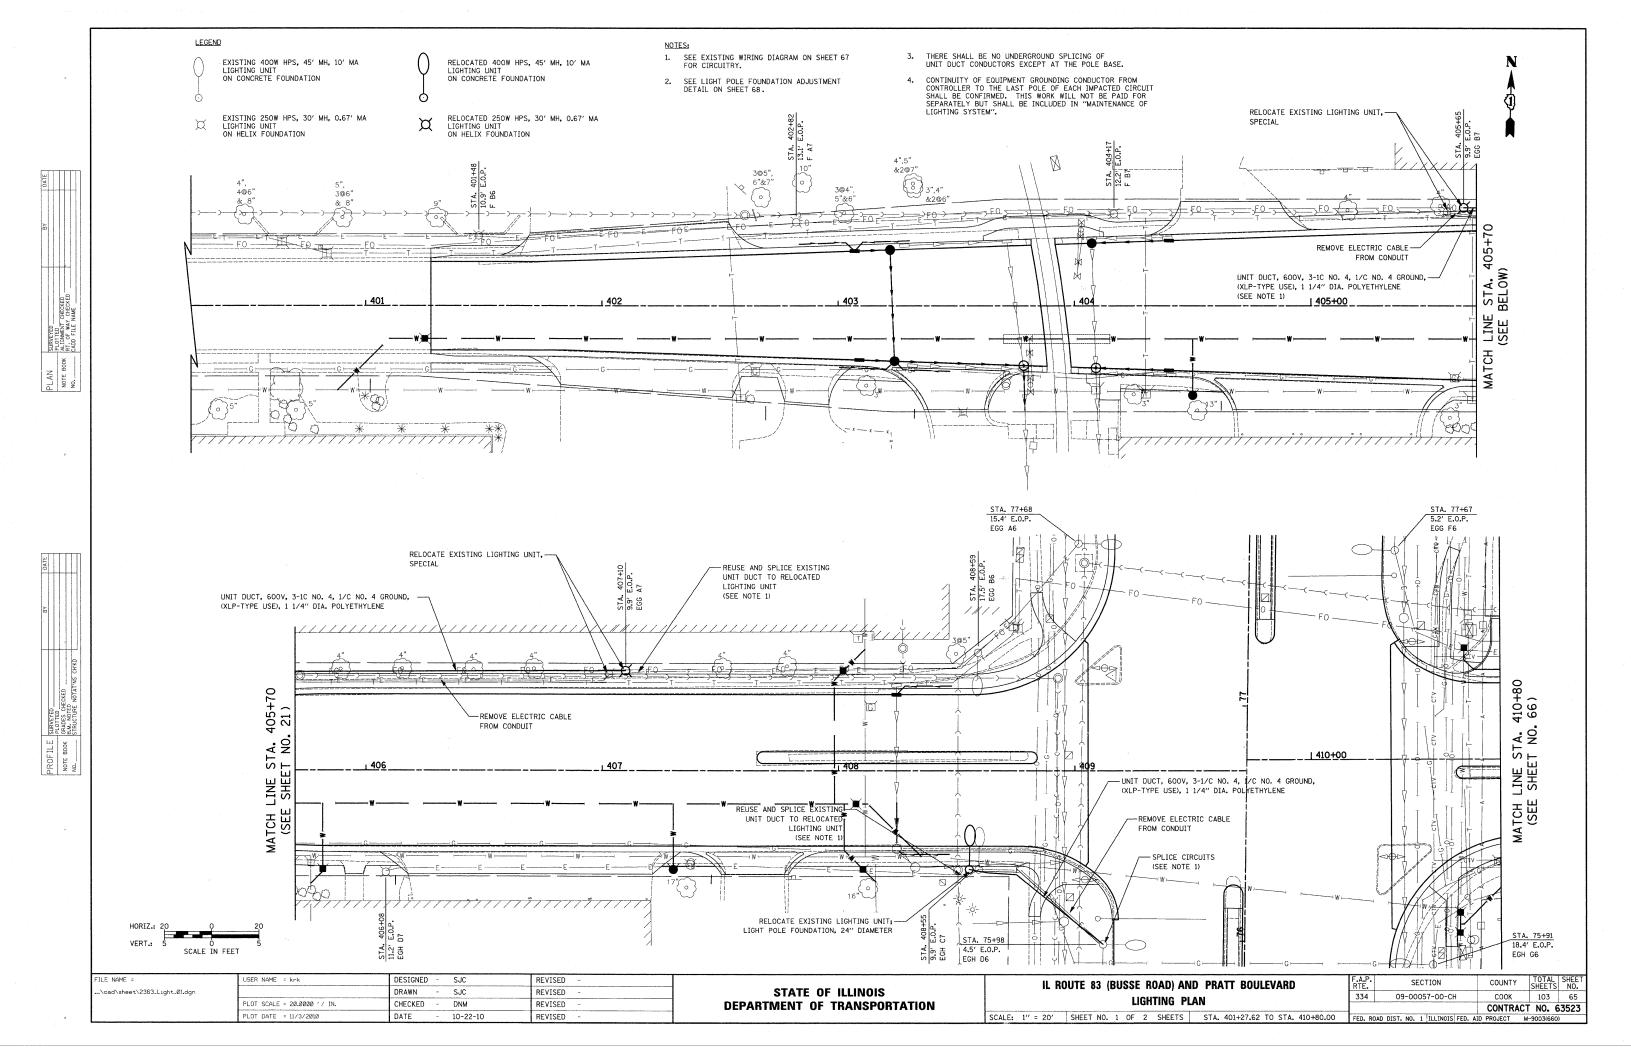



- NOTES:
- 1. SEE EXISTING WIRING DIAGRAM ON SHEET 67 FOR CIRCUITRY.
- 2. SEE LIGHT POLE FOUNDATION ADJUSTMENT DETAIL ON SHEET 68.
- 3. THERE SHALL BE NO UNDERGROUND SPLICING OF UNIT DUCT CONDUCTORS EXCEPT AT THE POLE BASE.
- 4. CONTINUITY OF EQUIPMENT GROUNDING CONDUCTOR FROM CONTROLLER TO THE LAST POLE OF EACH IMPACTED CIRCUIT SHALL BE CONFIRMED. THIS WORK WILL NOT BE PAID FOR SEPARATELY BUT SHALL BE INCLUDED IN "MAINTENANCE OF LIGHTING SYSTEM".

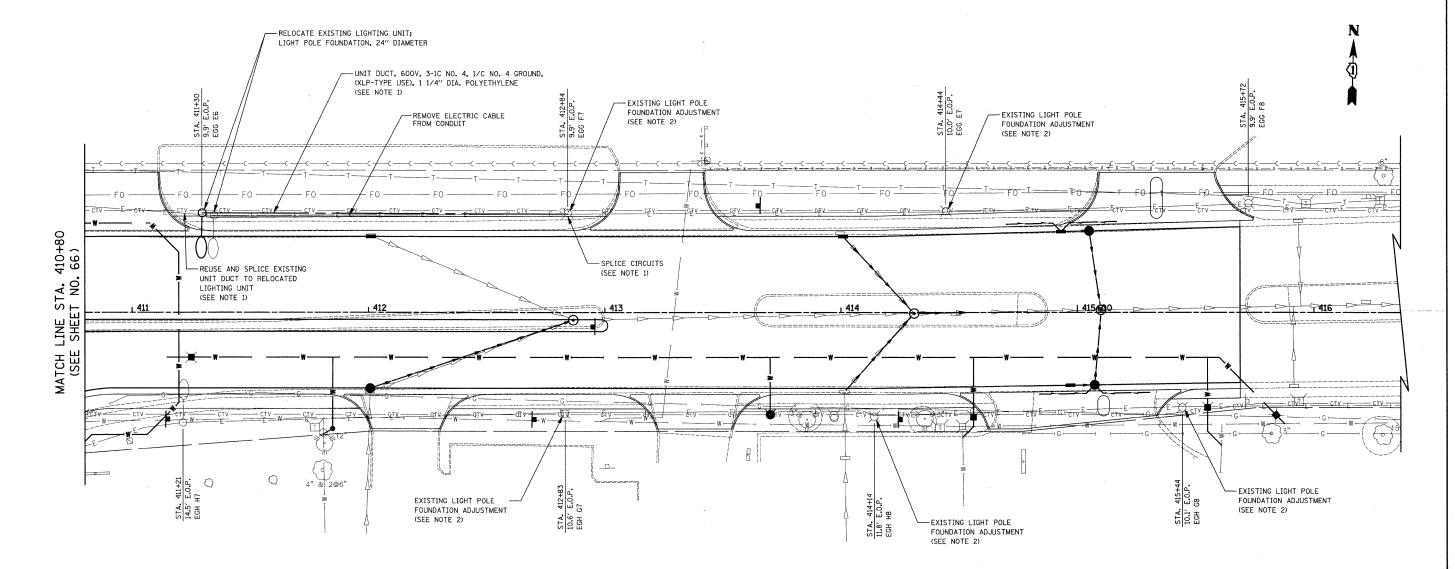


HORIZ.:	20	0	- 20
	- Line		
VERT.:	5	0	-5
	SC	ALE IN FEET	Ī

FILE NAME =	USER NAME = krk	DESIGNED -	SJC	REVISED -		IL ROUTE 83 (BUSSE ROAD) AF	ND PRATT BOULEVARD	F.A.P.	SECTION	COUNTY	TOTAL SHEET
\cad\sheet\2363_Light_02.dgn	DI OT COME - DRAGGE / / IN	DRAWN -	SJC	REVISED -	STATE OF ILLINOIS	LIGHTING P		334	09-00057-00-CH	соок	103 66
,	PLOT DATE = 11/3/2010	DATE -	10-22-10	REVISED -	DEPARTMENT OF TRANSPORTATION	SCALE: 1" = 20' SHEET NO. 2 OF 2 SHEETS	STA. 410+80.00 TO STA. 415+68.82	FED. ROA	D DIST. NO. 1 ILLINOIS FED.		N-9003(660)

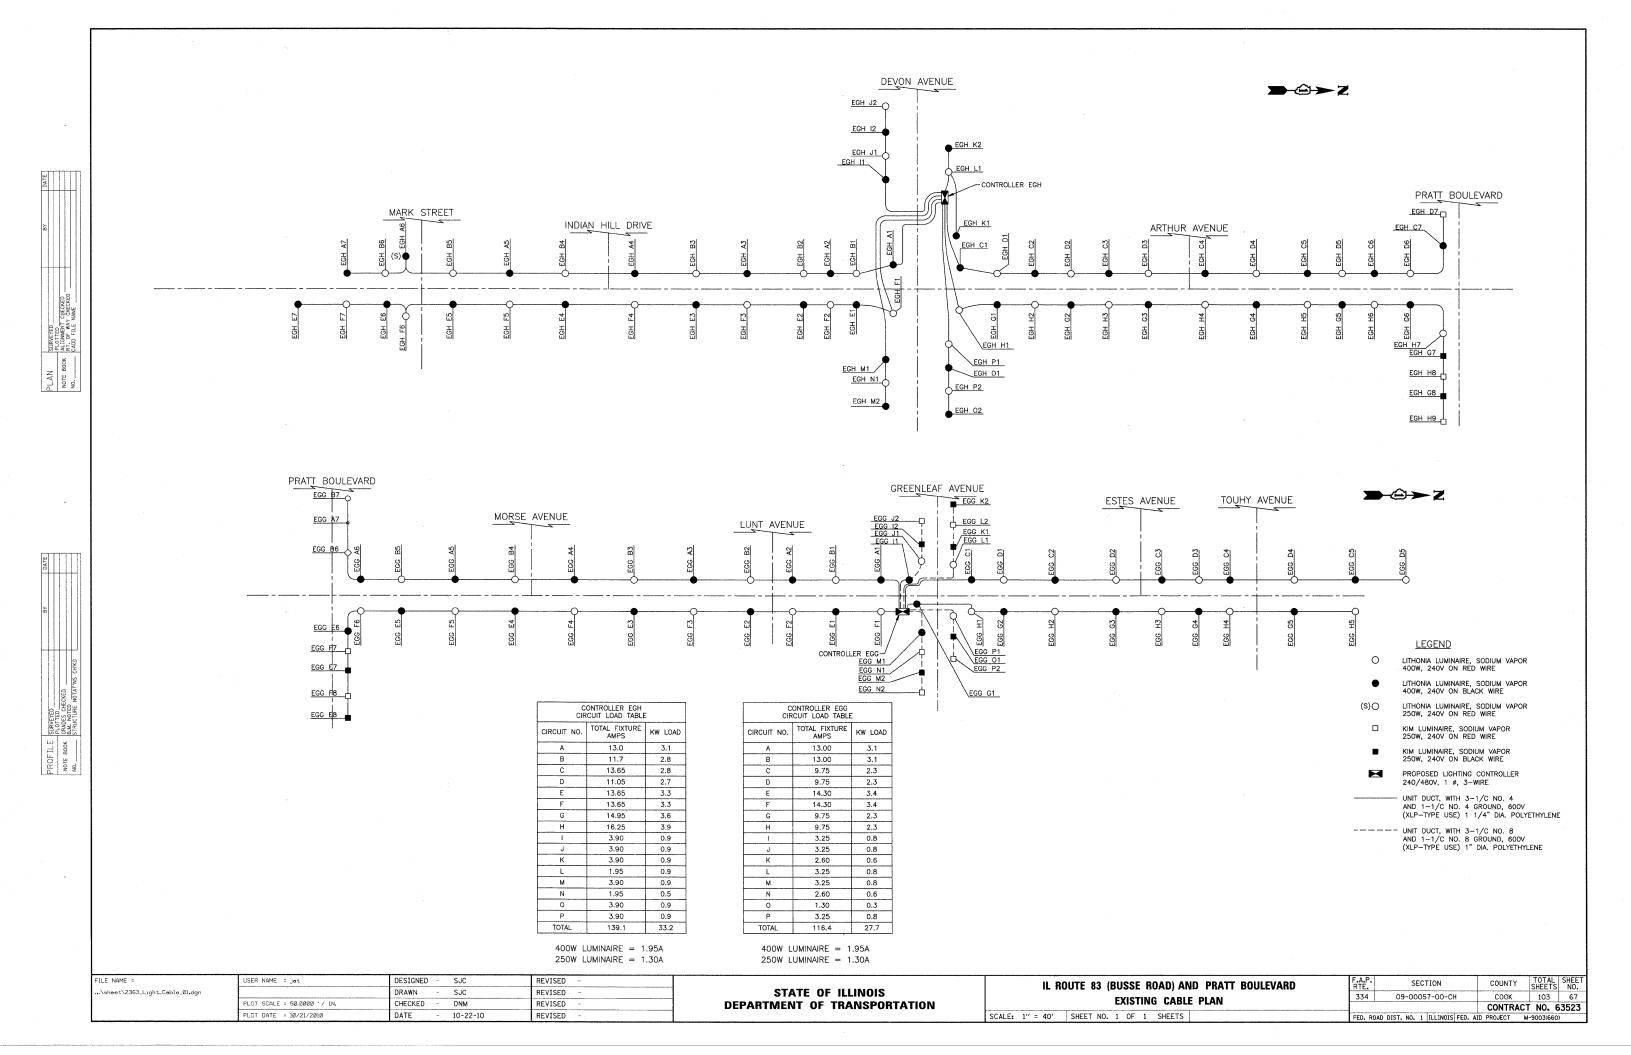

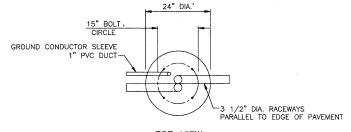


TOP VIEW

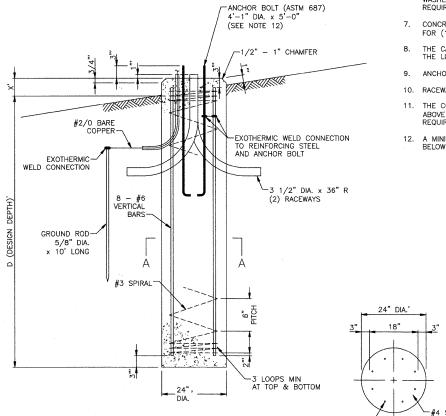

NOTES:

- THE ENGINEER SHALL DETERMINE THE CLASS OF SOIL DURING EXCAVATION AND SELECT THE DESIGN DEPTH OF FOUNDATION FROM THE DESIGN TABLE. THE CONTRACTOR SHALL NOT ORDER REINFORCEMENT BARS UNTIL THE OFFSET AND DIMENSION D ARE DETERMINED.
- 2. EXCAVATION OF THE POLE FOUNDATION SHALL BE MADE WITH AN AUGER, 24" OR 30" IN DIAMETER.
- 3. THE CONTRACTOR SHALL USE #3 SPIRAL AT 6" PITCH OR AT HIS OPTION MAY SUBSTITUTE #3 TIES AT 12" CENTER.
- 4. THE ANCHOR SHALL BE A TACK WELDED TYPE BOLT OR HOOK TYPE BOLT. COLD BENDING OF THE HOOK BOLT WILL NOT BE ALLOWED.
- 5. THE ANCHOR BOLTS AND RACEWAYS SHALL BE PROPERLY SECURED IN PLACE BEFORE THE CONRETE IS PLACED IN THE FORM.
- 6. THE ENTIRE LENGTH OF THE ANCHOR BOLTS AS WELL AS THE NUTS AND WASHERS SHALL BE HOT DIP GALVANIZED IN ACCORDANCE WITH THE REQUIREMENTS OF ASTM DESIGNATION A 153.
- CONCRETE SHALL BE CLASS "DS". CONCRETE FOUNDATION MUST BE CURED FOR (10) TEN DAYS BEFORE THE LIGHT STANDARD IS ERECTED.
- 8. THE CABLE TRENCH SHALL BE BACKFILLED AND FIRMLY COMPACTED BEFORE THE LIGHT IS ERECTED.
- 9. ANCHOR BOLTS SHALL PROJECT 3" ABOVE THE TOP OF THE FOUNDATION.
- 10. RACEWAYS SHALL PROJECT 1" ABOVE THE TOP OF THE FOUNDATION.
- 11. THE CONTRACTOR SHALL COORDINATE THE EXTENSION OF ANCHOR BOLTS ABOVE TOP OF FOUNDATION WITH THE BREAKAWAY DEVICE MANUFACTURER'S REQUIREMENTS.
- 12. A MINIMUM OF 3" OF THE THREADING ON THE ANCHOR BOLTS SHALL REMAIN BELOW THE TOP OF THE FOUNDATION.

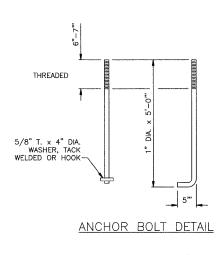


SECTION A-A


DESIGN TABLE - LIGHT POLE FOUNDATION, 24" DIAMETER

	DESIGN DEPTH	OF FOUNDATION	REINFORCEMENT IN FOUNDATION									
TYPE OF SOIL	SINGLE ARM	TWIN ARM	SINGLI	E ARM	TWIN ARM							
	D	D	VERT. BARS	SPIRAL	VERT. BARS	SPIRAL						
SOFT CLAY	13'-0"	15'-0"	8-#6 x 12'-6"	#3 × 122'	8-#6 x 14'-3"	#3 x 141'						
MEDIUM CLAY	9'-6"	10'-9"	8-#6 x 9'-0"	#3 × 90'	8-#6 x 10'-0"	#3 x 100°						
STIFF CLAY	7'-0"	8'-0"	8-#6 × 6'-6"	#3 × 66'	8-#6 x 7'-6"	#3 × 76'						
LOOSE SAND	10'-0"	11'-0"	8-#6 x 9'-6"	#3 x 94'	8-#6 x 10'-6"	#3 x103'						
MEDIUM SAND	8'-3"	9'-0"	8-#6 x 8'-0"	#3 × 78'	8-#6 x 8'-6"	#3 x 85'						
DENSE SAND	7'-9"	9'-0"	8-#6 x 7'-6"	#3 × 73'	8-#6 x 8'-6"	#3 × 85'						
ROCK OR SOLIDIFIED SLAG	5'-0"	5'-0"	NONE	NONE	NONE	NONE						

LIGHT POLE FOUNDATION, 24" DIAMETER

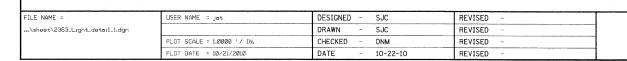


STATE OF ILLINOIS
DEPARTMENT OF TRANSPORTATION

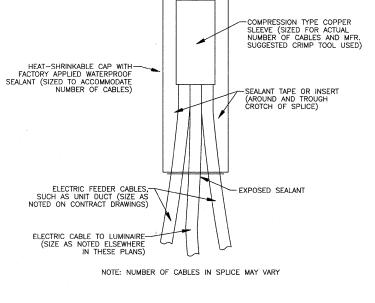


TRIMMED CABLES

SPLICING ELECTRIC CABLES
BASIC MATERIALS AND METHODS

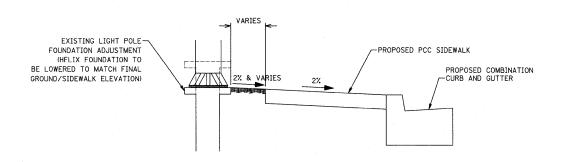

EXISTING LIGHT POLE FOUNDATION ADJUSTMENT

IL ROUTE 83 (BUSSE ROAD) @ PRATT BOULEVARD LIGHTING DETAILS		SECTION	COUNTY	TOTAL	SHEE NO.
		09-00057-00-CH	COOK	103	68
			CONTRACT	NO.	63523
SHEET NO. 1 OF 2 SHEETS	FED. F	ROAD DIST. NO. 1 ILLINOIS FED. A	ID PROJECT M	-9003(660))

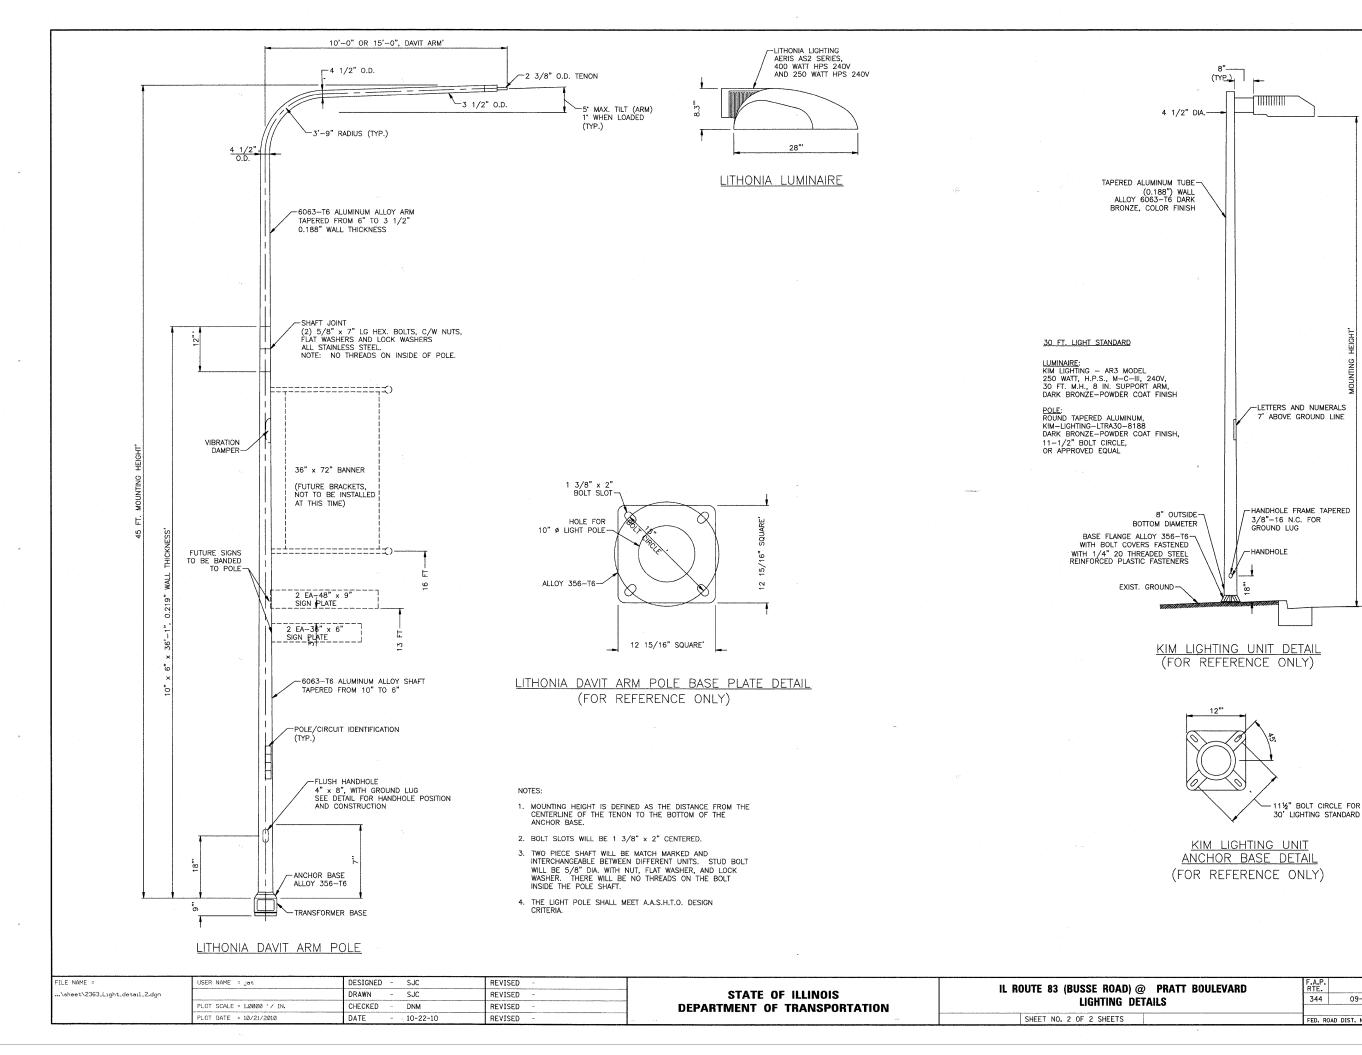

SECTION


09-00057-00-CH

TOTAL SHEE SHEETS NO.

CONTRACT NO. 63523

COUNTY


СООК

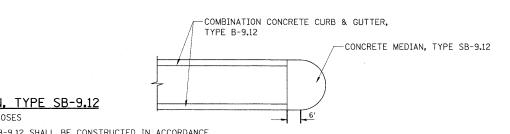


CONCRETE MEDIAN, TYPE SB-9.12


AT MEDIAN NOSES

NOTE: CONCRETE MEDIAN, TYPE SB-9.12 SHALL BE CONSTRUCTED IN ACCORDANCE WITH APPLICABLE PORTIONS OF STANDARD 606301

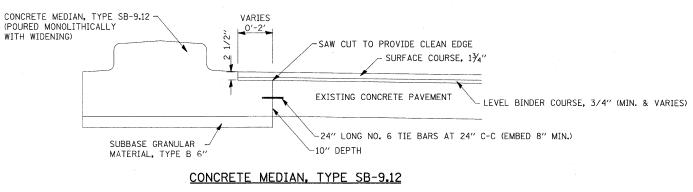


AT LOCATIONS WHERE WIDENING IS 2' OR LESS

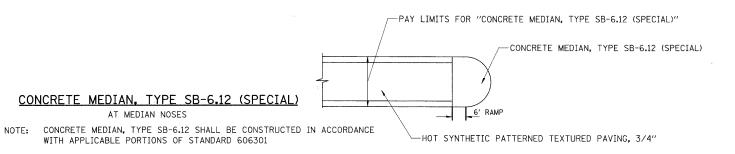

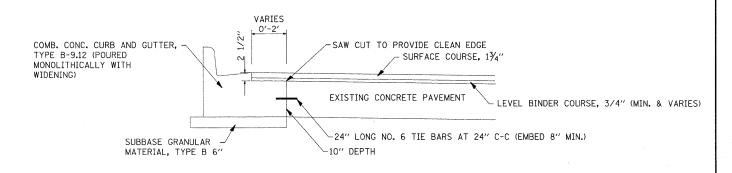

COMBINATION CONCRETE CURB AND GUTTER, TYPE B-9.12


AT LOCATIONS WHERE WIDENING IS 2' OR LESS

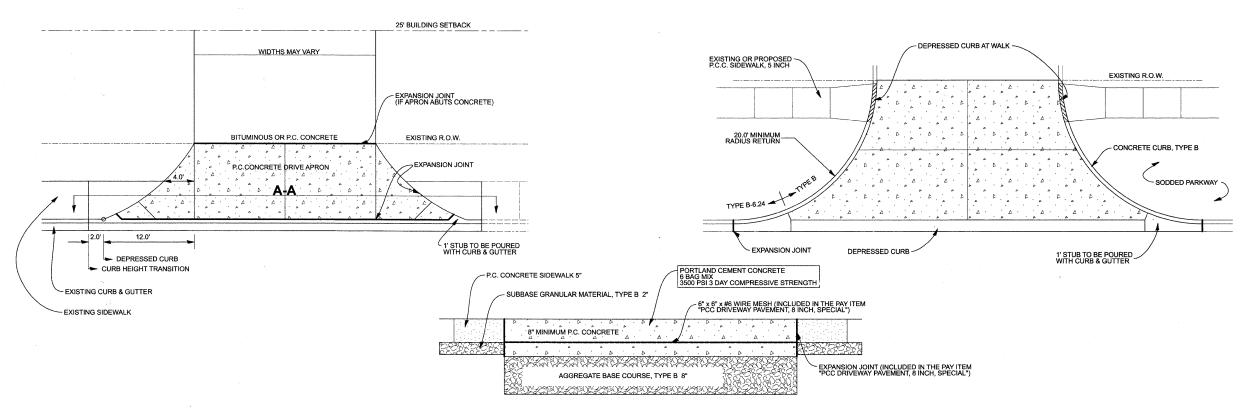

SECTION A-A

DRIVEWAY DETAIL NOT TO SCALE

	FILE NAME =	USER NAME = djk	DESIGNED - BLG	REVISED ~			F.A.P.	SECTION	COUNTY	TOTAL	SHEET
	\cad\sheet\2363_detail_01.dgn		DRAWN ~ BLG	REVISED -	STATE OF ILLINOIS	ROADWAY DETAILS	334	09-00057-00-CH	COOK	103	70
		PLOT SCALE = 50.0000 '/ IN.	CHECKED DJK	REVISED -	DEPARTMENT OF TRANSPORTATION			03 00001 00 011	CONTRACT	T NO. F	3523
· ·	PLOT DATE = 10/21/2010 DATE - 10-22-10 REVISED -		SHEET NO. 1 OF 4 SHEETS	FED. ROAD	DIST. NO. 1 ILLINOIS FED. AIR						

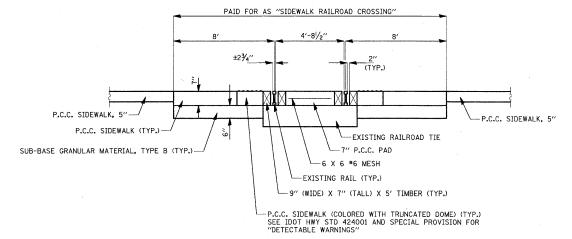

NOTES:


- 1. ALL SURFACES SHALL BE FLUSH WITH EXISTING RAILS.
- 2. THE PAY ITEM "SIDEWALK RAILROAD CROSSING" SHALL INCLUDE THE CONSTRUCTION OF THE 7" P.C.C. PAD BETWEEN THE RAILS AND THE CONSTRUCTION OF THE 7" P.C.C. SIDEWALK, DETECTABLE WARNINGS, AND 6" SUB-BASE GRANULAR MATERIAL AS SHOWN ABOVE.
- 3. ANY BALLAST REMOVAL REQUIRED TO CONSTRUCT THE RAILROAD CROSSING SHALL BE INCLUDED IN THE COST OF THE PAY ITEM "SIDEWALK RAILROAD CROSSING".
- 4. ALL MATERIAL SHALL BE APPROVED BY THE ENGINEER PRIOR TO THEIR INSTALLATION.
- 5. THE CONTRACTOR SHALL COORDINATE ALL CONSTRUCTION ACTIVITIES RELATED TO THE CONSTRUCTION OF THE RAILROAD CROSSING WITH THE RAILROAD COMPANY.


SIDEWALK RAILROAD CROSSING DETAIL


FILE NAME =	USER NAME = djk	DESIGNED -	BLG	REVISED -
\cad\sheet\2363_detail_02.dgn		DRAWN -	BLG	REVISED -
•	PLOT SCALE = 50.0000 '/ IN.	CHECKED -	DJK	REVISED -
	PLOT DATE = 11/3/2010	DATE ~	10-22-10	REVISED

STATE	OF	ILLINOIS	
DEPARTMENT (OF '	TRANSPORTATION	

		SECTION	COUNTY	TOTAL	SHEE S NO.	
ROADWAY DETAILS	334	09-00057-00-CH	COOK	103	71	
			CONTRACT	NO. (63523	
SHEET NO. 2 OF 3 SHEETS	FED. RC	DAD DIST. NO. 1 ILLINOIS FED. A	D PROJECT M-90	003(660)		

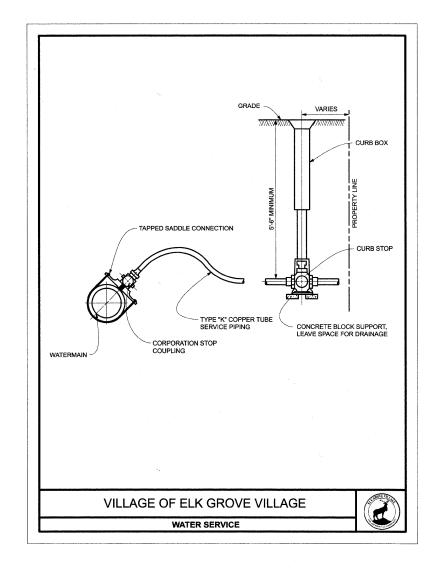


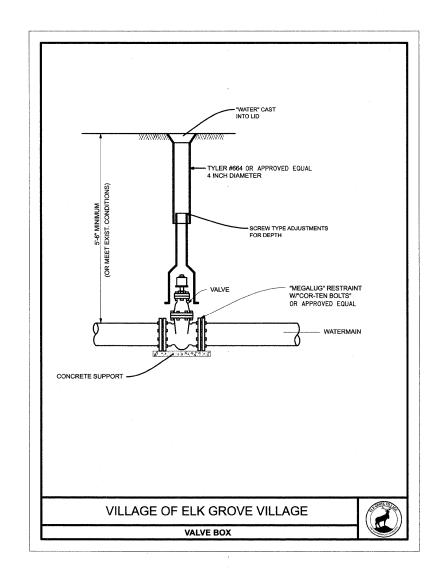

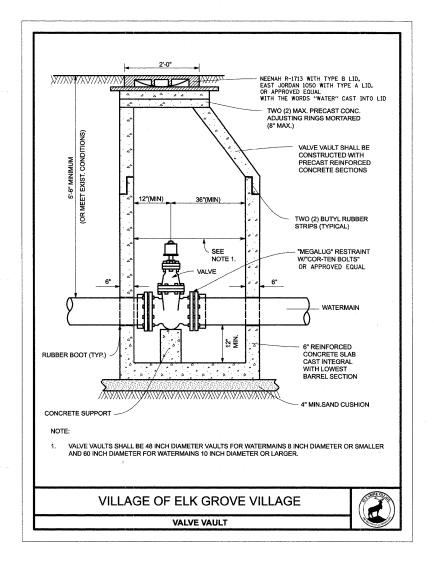


FILE NAME =	USER NAME = djk	DESIGNED - BLO	G	REVISED -	
\cad\sheet\2363_detail_03.dgn		DRAWN - BLO	G	REVISED -	
	PLOT SCALE = 50.0000 '/ IN.	CHECKED - DJK	K	REVISED -	
	PLOT DATE = 11/1/2010	DATE - 10-	-22-10	REVISED -	•

		F.A.F RTE	P.		SE	CTIO	N			COUNTY		TOTAL	SHE
	ROADWAY DETAILS		4	0	9-000	057-0	0-CH	1		COOK	.	103	72
		_							-	CONTR	RACT	NO.	6352
	SHEET NO. 3 OF 3 SHEETS	FED.	ROA	D DIST.	NO.	1 ILL	INOIS	FED.	AID	PROJECT	M-90	03(660)	
			-										

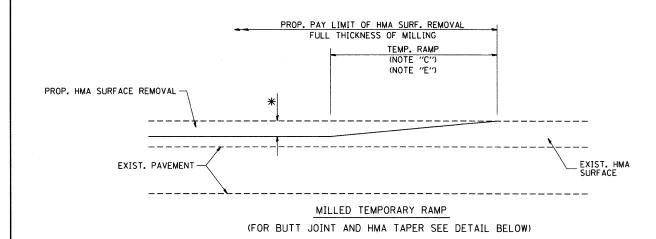


OPTION 1

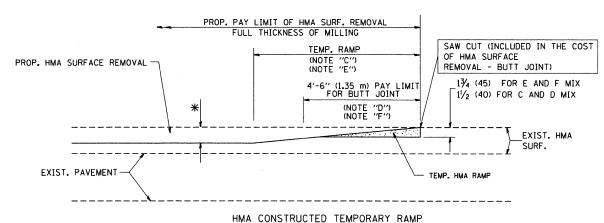


(FOR BUTT JOINT AND HMA TAPER SEE DETAIL BELOW)


OPTION 2

TYPICAL TEMPORARY RAMP

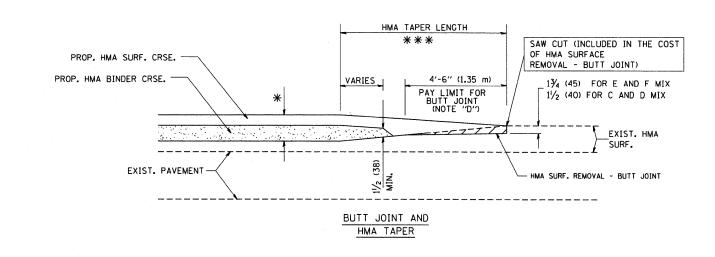

TYPICAL BUTT JOINT AND HMA TAPER FOR MILLING AND RESURFACING

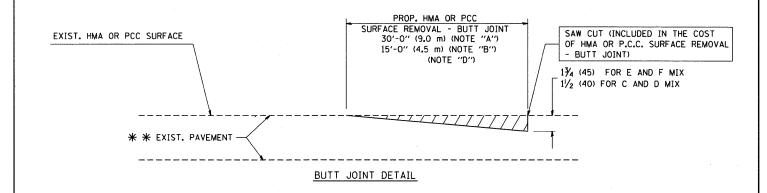

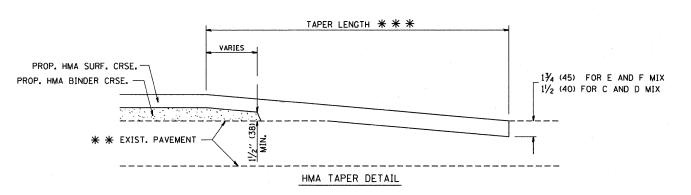

TYPICAL BUTT JOINT AND HMA TAPER FOR RESURFACING ONLY

 $***$ PC CONCRETE, HMA OR HMA RESURFACED PAVEMENT.

NOTES

- A: MAINLINE ROADWAYS AND MAJOR SIDE ROADS.
- B: MINOR SIDE ROADS.
- C: THE TEMP. RAMP SHALL BE CONSTRUCTED IMMEDIATELY UPON REMOVAL OF THE EXISTING HMA SURFACE.
- D: THE BUTT JOINT SHALL BE CONSTRUCTED IMMEDIATELY PRIOR TO PLACING THE PROPOSED HMA COURSES.
- E: TAPER THE TEMP. RAMP AT A RATE OF 3'-O" (900 mm) PER 1 INCH (25 mm) OF MILLING THICKNESS.
- F: INSTALLATION AND REMOVAL OF THE 4'-6" (1.35 m) TEMP. RAMP IS INCLUDED IN COST OF HMA SURFACE REMOVAL BUTT JOINT
- G: SEE ARTICLE 406.08 AND 406.14 OF THE STANDARD SPECIFICATIONS FOR "HMA AND/OR PCC SURFACE REMOVAL, BUTT JOINT".
- * SEE TYPICAL SECTIONS FOR MILLING THICKNESS.

BASIS OF PAYMENT:


THE BUTT JOINT WILL BE PAID FOR AT THE CONTRACT UNIT PRICE PER SOUARE YARD (SOUARE METER) FOR "HOT-MIX ASPHALT SURFACE REMOVAL - BUTT JOINT" OR FOR "PORTLAND CEMENT CONCRETE SURFACE REMOVAL - BUTT JOINT".

ALL DIMENSIONS ARE IN INCHES (MILLIMETERS) UNLESS OTHERWISE SHOWN.

FILE NAME = USER NAME = geglanobt DESIGNED - M. DE YONG REVISED - R. SHAH 10-25-94
W:\distatd\22x34\bd32.dgn - DRAWN - REVISED - A. ABBAS 03-21-97
PLOT SCALE = 58.0000 '/ IN. CHECKED - REVISED - M. COMEZ 04-06-01
PLOT DATE = 1/4/2008 DATE - 06-13-90 REVISED - R. BORO 01-01-07

STATE OF ILLINOIS
DEPARTMENT OF TRANSPORTATION

BUTT JOINT AND					SECTION	COUNTY	TOTAL SHEETS	SHEET NO.
	HMA TAPER DETAILS				09-00057-00-CH	COOK	103	73
					BD400-05 BD32	CONTRACT	NO. 63	3523
SCALE: NONE	SHEET NO. 1 OF 1 SHEETS	STA.	TO STA.	FED. RO	DAD DIST. NO. 1 ILLINOIS FED. A	D PROJECT M-9	9003(660)

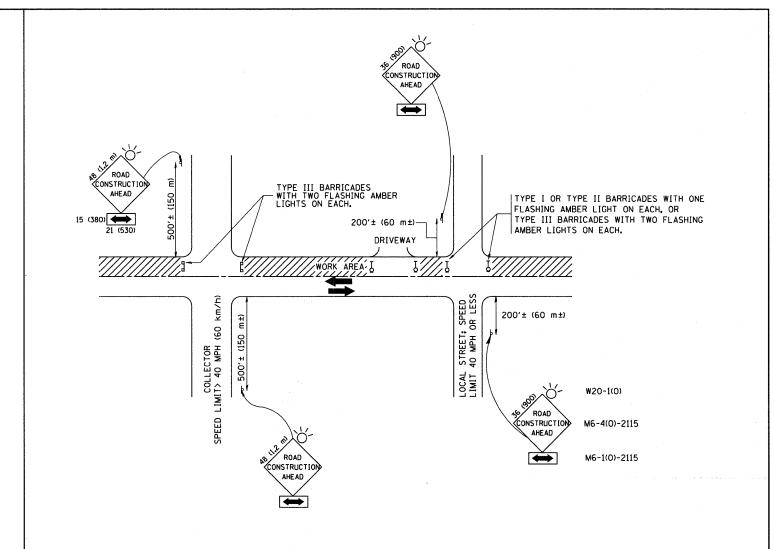

TRAFFIC CONTROL AND PROTECTION FOR SIDE ROADS, INTERSECTIONS, AND DRIVEWAYS

NOTES:

- A. FOR NO LANE RESTRICTION ON THE SIDE ROAD OR DRIVEWAYS
- 1. SIDE ROAD WITH A SPEED LIMIT OF 40 MPH (60 km/h) OR LESS AS SHOWN ON THE DRAWING AND AS DIRECTED BY THE ENGINEER:
- 0) ONE ROAD CONSTRUCTION AHEAD SIGN 36×36 (900x900) WITH A FLASHER AND FLAG MOUNTED ON IT APPROXIMATELY 200' (60 m) IN ADVANCE OF THE MAIN ROUTE.
- b) THE CLOSED PORTION OF THE MAIN ROUTE SHALL BE PROTECTED BY BLOCKING WITH TYPE I, TYPE II OR TYPE III BARRICADES, 1/3 OF THE CROSS SECTION OF THE CLOSED PORTION.
- 2. SIDE ROAD WITH A SPEED LIMIT CREATER THAN 40 MPH (60 km/h) AS SHOWN ON THE DRAWING AND AS DIRECTED BY THE ENGINEER:
- 0) ONE ROAD CONSTRUCTION AHEAD SIGN 48 \times 48 (1,2 m \times 1,2 m) WITH A FLASHER MOUNTED ON IT APPROXIMATELY 500' (150 m) IN ADVANCE OF THE MAIN ROUTE.
- b) THE CLOSED PORTION OF THE MAIN ROUTE SHALL BE PROTECTED BY BLOCKING WITH TYPE III BARRICADES, 1/2 OF THE CROSS SECTION OF THE CLOSED PORTION.
- 3. WHEN THE SIDE ROAD LIES BETWEEN THE BEGINNING OF THE MAINLINE SIGNING AND THE WORK ZONE, A SINGLE HEADED ARROW (MG-1) SHALL BE USED IN LIEU OF THE DOUBLE HEADED ARROW (MG-4).


- B. FOR A LANE CLOSURE ON A SIDE ROAD OR DRIVEWAY:
- USE APPLICABLE PORTIONS OF THE TYPICAL APPLICATION OF TRAFFIC CONTROL DEVICES (STD. 701501, STD. 701606 OR THE APPROPRIATE STANDARD). THE SPACING OF SIGNS AND BARRICADES SHALL BE ADJUSTED FOR FIELD CONDITIONS AS DIRECTED BY THE ENGINEER. THE DIRECTIONAL ARROW SHALL BE COVERED OR REMOVED WHEN NO LONGER CONSISTENT WITH THE SIDE ROAD LANE CLOSURE.
- C. ADVANCE WARNING SIGNS ARE TO BE OMITTED ON DRIVEWAY UNLESS OTHERWISE NOTED.
- D. THE TRAFFIC CONTROL AND PROTECTION FOR SIDE ROADS, INTERSECTIONS, AND DRIVEWAYS SHALL BE INCIDENTAL TO THE COST OF SPECIFIED TRAFFIC CONTROL STANDARDS OR ITEMS.

All dimensions are in millimeters (inches) unless otherwise shown.

FILE NAME = USER NAME = gaglionobt DESIGNED - LHA REVISED - J. OBERLE 10-18-95
Wi\distatd\22x34\to18.dgo - DRAWN - REVISED - A. HOUSEH 03-06-96
PLOT SCALE = 58.000 '/ IN. CHECKED - REVISED - A. HOUSEH 10-15-96
PLOT DATE = 1/4/2008 DATE - 06-89 REVISED - T. RAMMACHER 01-06-00


STATE OF ILLINOIS DEPARTMENT OF TRANSPORTATION


	TRAFFIC CONTROL AND PROT	ECTION FOR
	SIDE ROADS, INTERSECTIONS, AN	D DRIVEWAYS
SCALE: NONE	SHEET NO. 1 OF 1 SHEETS ST	A. TO STA.

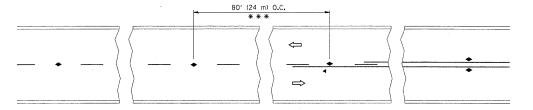


*** REDUCE TO 40' (12 m) O.C. ON CURVES WITH POSTED OR ADVISORY SPEED 45 M.P.H. (70 km/h) OR LESS.

TWO-LANE/TWO-WAY

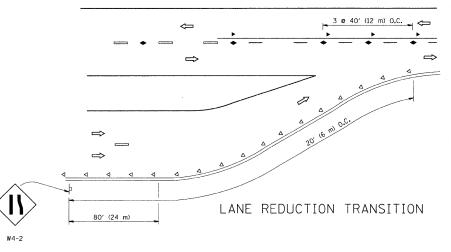


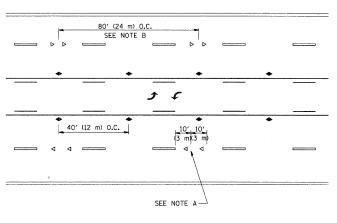

TWO-WAY LEFT TURN

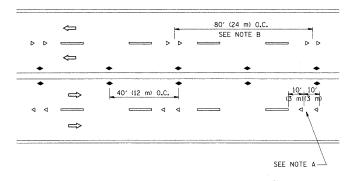

MULTI-LANE/UNDIVIDED

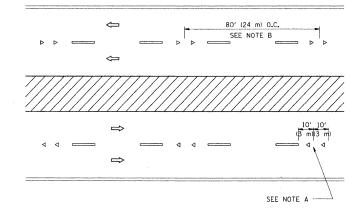

MULTI-LANE/DIVIDED

GENERAL NOTES

- 1. MARKERS USED WITH DASHED LINES SHALL BE CENTERED IN THE GAP BETWEEN SEGMENTS.
- 2. MARKERS USED ADJACENT TO SOLID LINES SHALL BE OFFSET 2 TO 3 (50 TO 75) TOWARD TRAFFIC AS SHOWN.
- 3. MARKERS THROUGH TANGENTS LESS THAN 500' (150 m) IN LENGTH BETWEEN CURVES SHALL BE INSTALLED AT THE LESSER OF THE TWO CURVE SPACINGS.

LANE MARKER NOTES

- A. USE DOUBLE LANE LINE MARKERS SPACED AS SHOWN.
- B. REDUCE TO 40' (12 m) O.C. ON CURVES WHERE ADVISORY SPEEDS ARE 10 M.P.H (20 km/h) LOWER THAN POSTED SPEEDS.

SYMBOLS

- ----- YELLOW STRIPE
- WHITE STRIPE
- ONE-WAY AMBER MARKER
- ONE-WAY CRYSTAL MARKER (₩/O)
- ◆ TWO-WAY AMBER MARKER

DESIGN NOTES

- 1. DOUBLE LANE LINE MARKERS SHALL BE USED UNLESS SPECIFIED OTHERWISE.
- 2. EXCEPT AS SHOWN ON THE LANE REDUCTION TRANSITION AND FREEWAY EXIT RAMP DETAIL, MARKERS ARE NOT TO BE SPECIFIED ON RIGHT EDGE
- 3. THE EXACT MARKER LIMITS, SPACING, AND COLOR SHOULD BE INCLUDED IN THE PLANS.
- MARKERS SHOULD NOT BE USED ALONGSIDE CURBS EXCEPT FOR EXTREMELY SHORT SECTIONS OF CURBS WHERE NOT MORE THAN TWO MARKERS WOULD BE INVOLVED.


LEFT TURN


All dimensions are in inches (millimeters) unless otherwise shown.


FILE NAME =	USER NAME = drivakosgn	DESIGNED -	REVISED	T. RAMMACHER	09-19-94
c:\pw_work\pwidot\drivakosgn\d0108315\tc	1.dgn	DRAWN -	REVISED	T. RAMMACHER	03-12-99
	PLOT SCALE = 50.000 '/ IN.	CHECKED ~	REVISED	T. RAMMACHER	01-06-00
	PLOT DATE = 9/9/2009	DATE ~	REVISED	- C. JUCIUS	09-09-09

STATE OF ILLINOIS
DEPARTMENT OF TRANSPORTATION


TYPICAL APPLIC	CATIONS		F. R
RAISED REFLECTIVE PAVEMENT MARKI	ERS (SNOW-PLOW	RESISTANT)	34
SCALE: NONE SHEET NO. 1 OF 1 SHEETS	STA.	TO STA.	FI

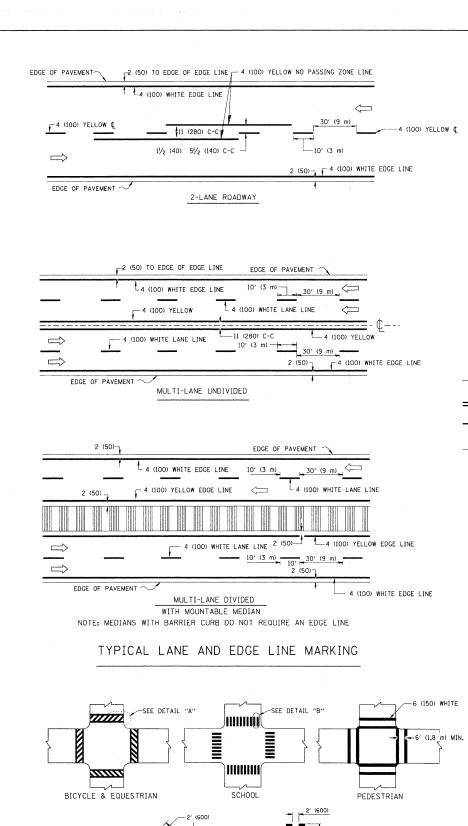

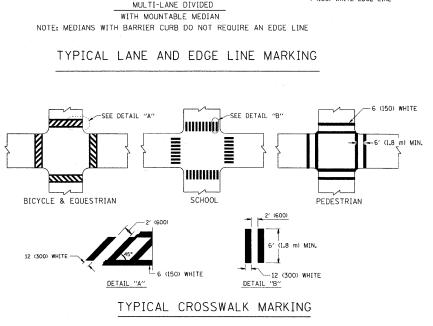

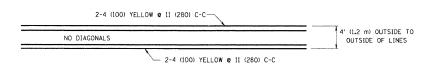


4' (1.2 m) WIDE MEDIANS ONLY

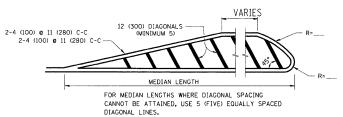


DIAGONAL LINE SPACING: 50' (15 m) C-C (LESS THAN 30MPH (50 km/h))
75' (25 m) C-C 30MPH (50 km/h) TO 45MPH (70 km/h)) 150' (45 m) C-C (MORE THAN 45MPH (70 km/h))

MEDIANS OVER 4' (1.2 m) WIDE

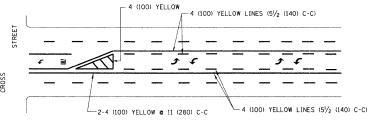


A MINIMUM OF TWO PAIRS OF TURN ARROWS SHALL BE USED, WHITE IN COLOR. ADDITIONAL PAIRS SHALL BE PLACED AT 200' (60 m) TO 300' (90 m) INTERVALS.

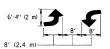

MEDIAN WITH TWO-WAY LEFT TURN LANE

TYPICAL PAINTED MEDIAN MARKING

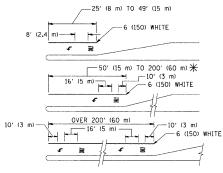



FULL SIZE LETTERS 8' (2.4 m) AND ARROWS SHALL BE USED. \P AREA = 15.6 SO. FT. (1.5 m²) \P AREA = 20.8 SO. FT. (1.9 m²)

* TURN LANES IN EXCESS OF 400' (120 m) IN LENGTH MAY HAVE AN ADDITIONAL SET OF ARROW - "ONLY" INSTALLED MIDWAY BETWEEN THE OTHER TWO SETS OF

TYPICAL LEFT (OR RIGHT) TURN LANE

TYPICAL TURN LANE MARKING

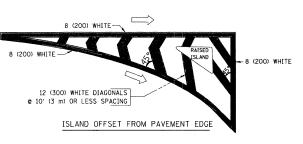

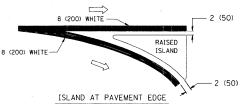

TYPICAL ISLAND MARKING

TYPE OF MARKING	WIDTH OF LINE	PATTERN	COLOR	SPACING / REMARKS
CENTERLINE ON 2 LANE PAVEMENT	4 (100)	SKIP-DASH	YELLOW	10' (3 m) LINE WITH 30' (9 m) SPACE
CENTERLINE ON MULTI-LANE UNDIVIDED PAVEMENT	2 @ 4 (100)	SOLID ,	YELLOW	11 (280) C-C
NO PASSING ZONE LINES: FOR ONE DIRECTION FOR BOTH DIRECTIONS	4 (100) 2 @ 4 (100)	SOLID SOLID	YELLOW YELLOW	5½ (140) C-C FROM SKIP-DASH CENTERLINE 11 1280) C-C OMIT SKIP-DASH CENTERLINE BETWEEN
LANE LINES	4 (100) 5 (125) ON FREEWAYS	SKIP-DASH SKIP-DASH	WHITE WHITE	10' (3 m) LINE WITH 30' (9 m) SPACE
DOTTED LINES (EXTENSIONS OF CENTER, LANE OR TURN LANE MARKINGS)	SAME AS LINE BEING EXTENDED	SKIP-DASH	SAME AS LINE BEING EXTENDED	2' (600) LINE WITH 6' (1.8 m) SPACE
EDGE LINES	4 (100)	SOLID	YELLOW-LEFT WHITE-RIGHT	OUTLINE MOUNTABLE MEDIANS IN YELLOW; EDGE LINES ARE NOT USED NEXT TO BARRIER CURB
TURN LANE MARKINGS	6 (150) LINE; FULL SIZE LETTERS & SYMBOLS (8' (2.4m))	SOLID	WHITE	SEE TYPICAL TURN LANE MARKING DETAIL
TWO WAY LEFT TURN MARKING	2 @ 4 (100) EACH DIRECTION	SKIP-DASH AND SOLID	YELLOW	10' (3 m) LINE WITH 30' (9 m) SPACE FOR SKIP-DASH; 5½ (140) C-C BETWEEN SOLID LINE AND SKIP-DASH LINE
	8' (2.4m) LEFT ARROW	IN PAIRS	WHITE	SEE TYPICAL TWO-WAY LEFT TURN MARKING DETAIL
CROSSWALK LINES (PEDESTRIAN) A. DIAGONALS (BIKE & EQUESTRIAN) B. LONGITUDINAL BARS (SCHOOL)	2 @ 6 (150) 12 (300) @ 45° 12 (300) @ 90°	SOLID SOLID SOLID	WHITE WHITE WHITE	NOT LESS THAN 6' (1.8 m) APART 2' (600) APART 2' (600) APART SEE TYPICAL CROSSWALK MARKING DETAILS.
STOP LINES	24 (600)	SOLID	WHITE	PLACE 4' (1.2 m) IN ADVANCE OF AND PARALLEL TO CROSSWALK, IF PRESENT. OTHERWISE, PLACE AT DESIRED STOPPING POINT. PARALLEL TO CROSSROAD CENTERLINE, WHERE POSSIBLE
PAINTED MEDIANS	2 @ 4 (100) WITH 12 (300) DIAGONALS @ 45° NO DIAGONALS USED FOR 4' (1.2 m) WIDE MEDIANS	SOLID	YELLOW: TWO WAY TRAFFIC WHITE: ONE WAY TRAFFIC	11 (280) C-C FOR THE DOUBLE LINE SEE TYPICAL PAINTED MEDIAN MARKING.
GORE MARKING AND CHANNELIZING LINES	8 (200) WITH 12 (300) DIAGONALS @ 45°	SOLID	WHITE	DIAGONALS: 15' (4.5 m) C-C (LESS THAN 30MPH (50 km/h)) 20' (6 m) C-C 30MPH (50 km/h) TO 45MPH (70 km/h)) 30' (9 m) C-C (0VER 45MPH (70 km/h))
RAILROAD CROSSING	24 (600) TRANSVERSE LINES; "RR" IS 6' (1.8 ml LETTERS; 16 (400) LINE FOR "X"	SOLID	WHITE	SEE STATE STANDARD 780001 AREA OF: "R"=3.6 SQ. FT. (0.33 m²) EACH "X"=54.0 SQ. FT. (5.0 m²)
SHOULDER DIAGONALS	12 (300) © 45°	SOLID	WHITE - RIGHT YELLOW - LEFT	50' (15 m) C-C (LESS THAN 30MPH (50 km/h)) 75' (25 m) C-C (30 MPH (50 km/h) T0 45MPH (70 km/h)) 150' (45 m) C-C (0VER 45MPH (70 km/h))


FOR FURTHER DETAILS ON PAVEMENT MARKING REFER TO STANDARD SPECIFICATIONS FOR ROAD AND BRIDGE CONSTRUCTION AND STATE STANDARD 780001.


All dimensions are in inches (millimeters) unless otherwise shown.


FILE NAME =	USER NAME = drivakosgn	DESIGNED - EVERS	REVISED	-T. RAMMACHER	10-27-94
c:\pw_work\pwidot\drivakosgn\d0108315\tc	3.dgn	DRAWN -	REVISED	-C. JUCIUS	09-09-09
	PLOT SCALE = 50.000 '/ IN.	CHECKED ~	REVISED	**	
-	PLOT DATE = 9/9/2009	DATE ~ 03-19-90	REVISED	-	

STATE OF ILLINOIS **DEPARTMENT OF TRANSPORTATION**


	DISTRICT ONE TYPICAL PAVEMENT MARKINGS					F.A.P. RTE.	SECTION	COUNTY		SHEET NO.
						344	09-00057-00-CH	COOK	103	76
- 1		ITFIGAL FA	A CIAICIA I	WANKINGS			TC-13	CONTRACT	NO. 63	3523
	SCALE, NONE	SHEET NO. 1 OF 1	SHEETS	STA.	TO STA.	FED. RO	AD DIST. NO. 1 ILLINOIS FED. AL	D PROJECT M-90	003(660)	

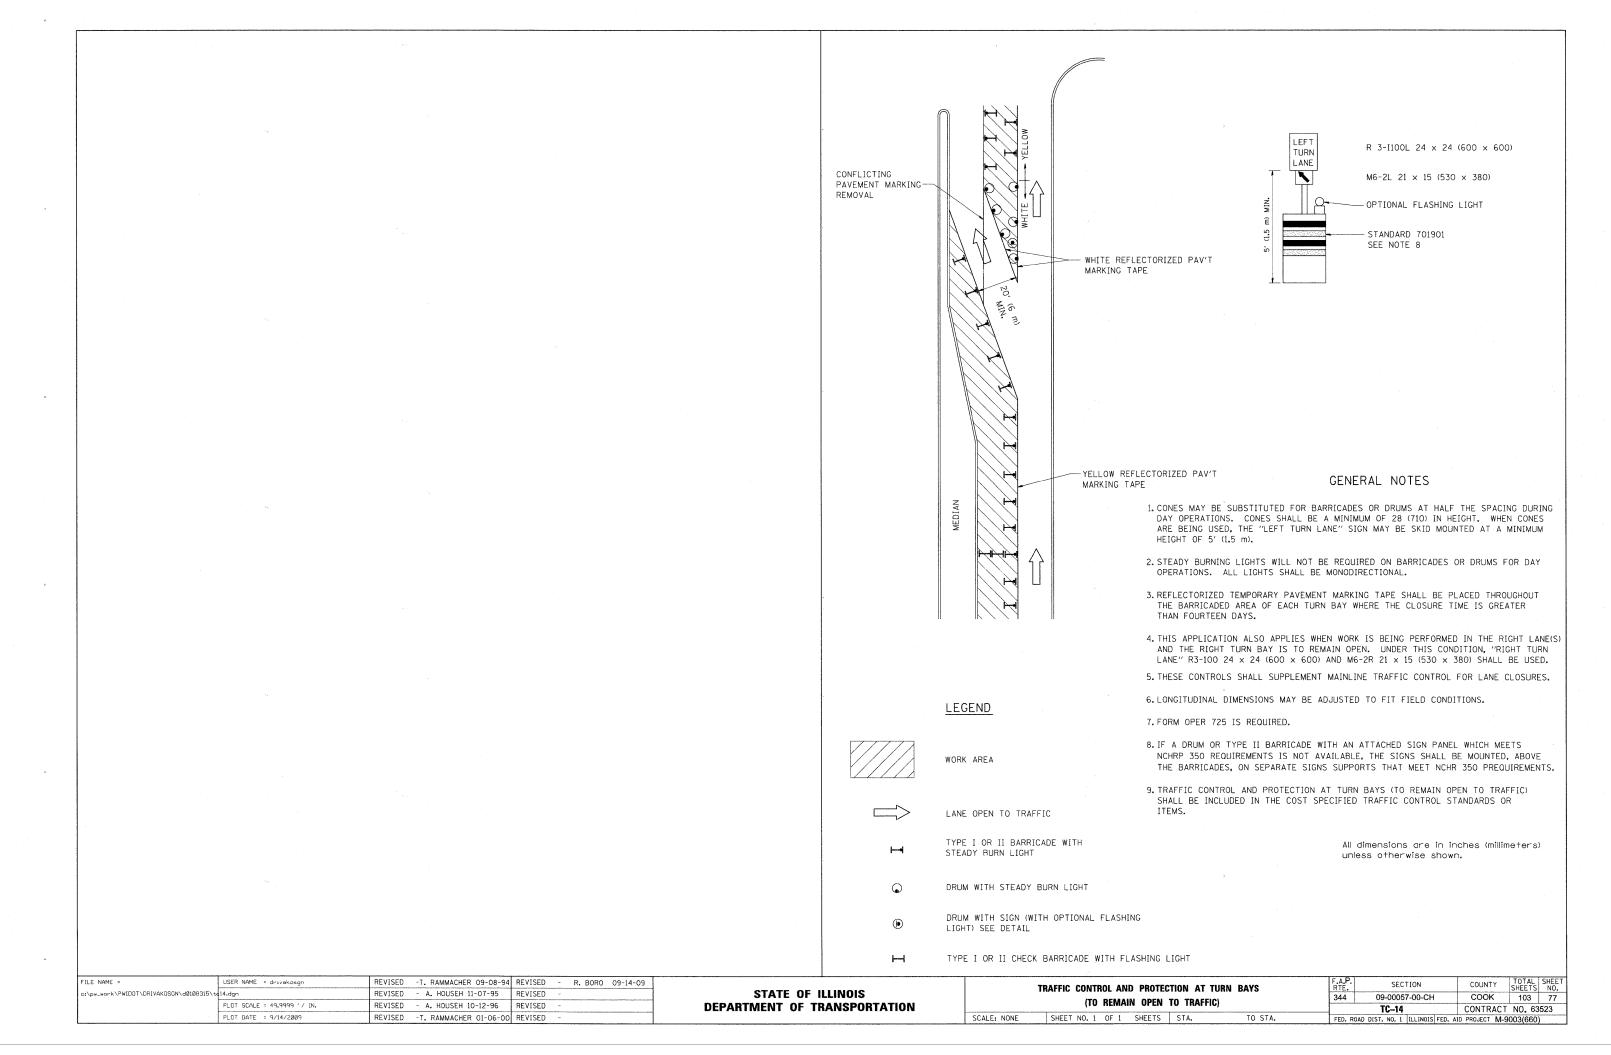

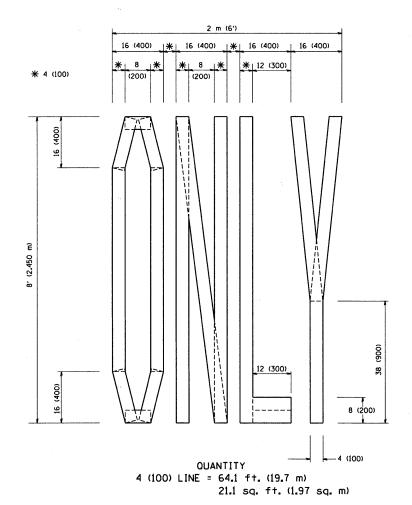

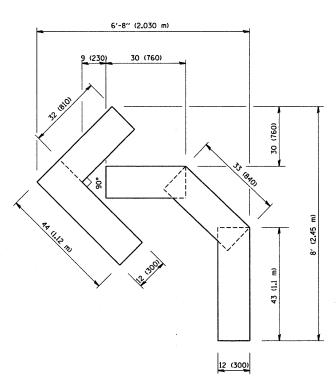

OUANTITY 4 (100) LINE = 45.5 ft. (13.9 m) 15.2 sq. ft. (1.39 sq. m)

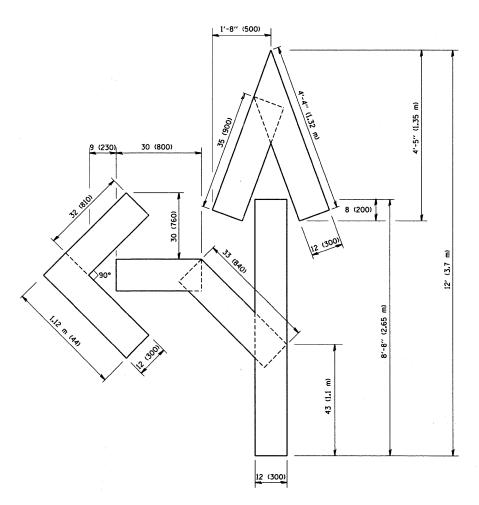


OUANTITY 4 (100) LINE = 82.5 ft. (25.3 m) 27.5 sq. ft. (2.53 sq. m)

All dimensions are in inches (millimeters) unless otherwise shown.

FILE NAME =	USER NAME = gaglianobt	DESIGNED -	REVISED -T. RAMMACHER 06-05-96
W:\diststd\22x34\tc16.dgn		DRAWN	REVISED -T. RAMMACHER 11-04-97
	PLOT SCALE = 50.0000 '/ IN.	CHECKED -	REVISED -T. RAMMACHER 03-02-98
	PLOT DATE = 1/4/2008	DATE - 09-18-94	REVISED - E. GOMEZ 08-28-00

STATE OF ILLINOIS
DEPARTMENT OF TRANSPORTATION

PAVEMENT MARKING LETTE	RS AND	SYMBOLS	F.A.P. RTE.	SECTION	COUNTY	TOTAL SHEETS	SHEET NO.
FOR TRAFFIC STAGING				09-00057-00-CH	COOK	103	78
				TC-16	CONTRACT	NO. 63	3523
SCALE: NONE SHEET NO. 1 OF 1 SHEETS	STA.	TO STA.	FED. R	OAD DIST. NO. 1 ILLINOIS FED. A	ID PROJECT M-9	003(660)	

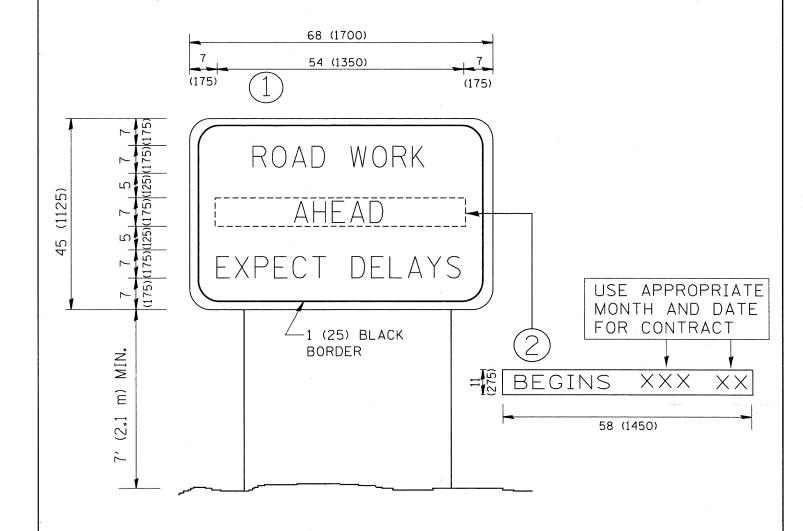


NOTES:

- 1. USE BLACK LETTERING ON ORANGE BACKGROUND.
- 2. ERECT SIGNS IN ADVANCE OF THE LOCATION FOR THE "ROAD CONSTRUCTION AHEAD" SIGN AT LOCATIONS AS DIRECTED BY THE ENGINEER.
- 3. ERECT SIGN (1) WITH INSTALLED PANEL (2) ONE WEEK PRIOR TO THE START OF CONSTRUCTION.
- 4. REMOVE PANEL 2 SOON AFTER THE START OF CONSTRUCTION.
- 5. SEE SPECIAL PROVISION FOR "TEMPORARY INFORMATION SIGNING" FOR ADDITIONAL INFORMATION.
- 6. ONE SIGN ASSEMBLY EQUALS 25.70 SQ. FT. (2.3 SQ. M.)
- 7. SHALL BE PAID FOR AS TEMPORARY INFORMATION SIGNING.

ALL DIMENSIONS ARE IN INCHES (MILLIMETERS) UNLESS OTHERWISE SHOWN.

FILE NAME =	USER NAME = gaglianobt	DESIGNED -	REVISED - R. MIRS 09-15-97			ARTERIAL BOAR		F.A.P.	SECTION	COUNTY	TOTAL SHEET
W:\diststd\22x34\tc22.dgn		DRAWN -	REVISED - R. MIRS 12-11-97	STATE OF ILLINOIS		ARTERIAL ROAD		344	09-00057-00-CH	COOK	103 79
	PLOT SCALE = 50.000 '/ IN.	CHECKED -	REVISED -T. RAMMACHER 02-02-99	DEPARTMENT OF TRANSPORTATION		INFORMATION SIGN			TC-22	CONTRACT	NO. 63523
	PLOT DATE = 1/4/2008	DATE ~	REVISED - C. JUCIUS 01-31-07		SCALE: NONE	SHEET NO. 1 OF 1 SHEETS STA.	TO STA.	FED. ROAD			9003(660)

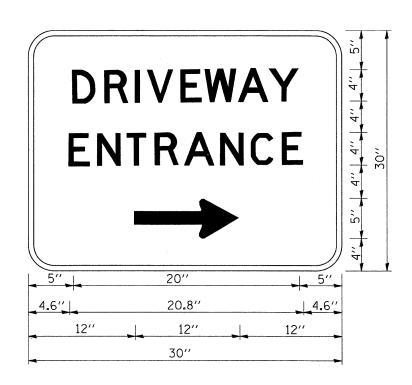

3.0" RADIUS, 0.5" BORDER, WHITE ON GREEN; REFLECTORIZED "ORIVEWAY" D; "ENTRANCE" D; STANDARD ARROW CUSTOM 12.0" x 5.0"

NOTES:

- 1. HALF OF THE SIGNS WILL REQUIRE A LEFT HAND FACING ARROW.
- 2. TWO SIGNS SHALL BE USED AT EACH COMMERCIAL ENTRANCE PLACED BACK-TO-BACK: ONE WITH A RIGHT HAND ARROW (SHOWN) SHALL BE PLACED ON THE NEAR RIGHT SIDE THE DRIVEWAY AND ONE WITH A LEFT HAND ARROW SHALL BE PLACED ON THE FAR LEFT SIDE OF THE DRIVEWAY.
- 3. SIGNS TO BE PAID FOR AS ITEM "TEMPORARY INFORMATION SIGNING".

FILE NAME =	USER NAME = gaglianobt	DESIGNED -	REVISED - C. JUCIUS 02-15-07
W:\diststd\22x34\tc26.dgn		DRAWN -	REVISED ~
	PLOT SCALE = 50.000 '/ IN.	CHECKED -	REVISED -
	PLOT DATE = 1/4/2008	DATE -	REVISED -

STATE	OF	ILLINOIS
DEPARTMENT	OF	TRANSPORTATION

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DRIVEWAY ENTRANCE SIGNING						SECTION	COUNTY	TOTAL	SHEET NO.
,					344	09-00057-00-CH	COOK	103	80
					TC-26		CONTRACT NO. 63523		
SCALE: NONE	SHEET NO. 1 OF 1	SHEETS	STA.	TO STA.	FED. ROAD DIST. NO. 1 ILLINOIS FED. AID PROJECT M-9003(660)				

