FOR INDEX OF SHEETS SEE SHEET 2

FOR LIST OF APPLICABLE HIGHWAY STANDARDS SEE SHEET 2

FULL SIZE PLANS HAVE BEEN PREPARED USING STANDARD ENGINEERING SCALES. REDUCED SIZED PLANS WILL NOT CONFORM TO STANDARD SCALES. IN MAKING MEASUREMENTS ON REDUCED PLANS, THE ABOVE SCALES MAY BE USED.

JOINT UTILITY LOCATION INFORMATION FOR EXCAVATION 1-800-892-0123


OR 811

STATE OF ILLINOIS


**DEPARTMENT OF TRANSPORTATION** 


# PLANS FOR PROPOSED FEDERAL AID HIGHWAY

**MUN 1079 (SPRING STREET)** NORTH OF SPRING STREET TO EAST ATC **PARKING LOT IMPROVEMENT SECTION NO.: 18-00325-00-PK** PROJECT NO.: DI3U(058) CITY OF AURORA KANE COUNTY C-91-165-20

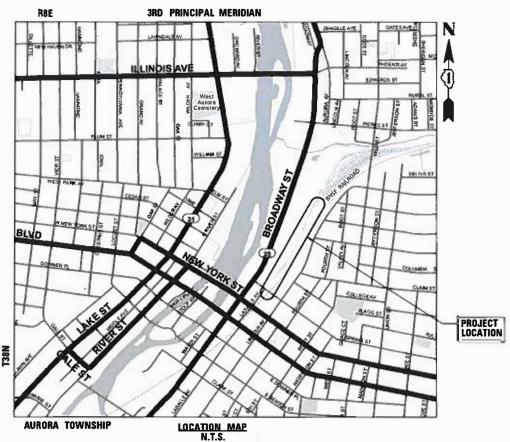

GROSS LENGTH = 1,700 FT = 0.32 MILE NET LENGTH = 1,700 FT = 0.32 MILE

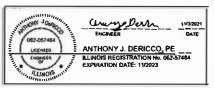

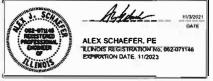



PRINTED BY THE AUTHORITY OF THE STATE OF ILLINOIS

STATE OF ILLINOIS DEPARTMENT OF TRANSPORTATION


LOCATION OF SECTION INDICATED THUS: - -

RELEASED FOR BID BASED ON LIMITED

SECTION

M/A | 18-00325-00-PK | KANE | 48 |

|ILLINOIS| CONTRACT NO. 61H35

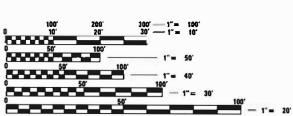

OFFICE ENGINEER: CARMEN

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**CONTRACT NO. 61H35** 

#### **GENERAL NOTES**

#### SPECIFICATIONS, STANDARDS AND SPECIAL PROVISIONS

DESCRIPTION SHEET NO. 1. ALL CONSTRUCTION SHALL BE DONE IN ACCORDANCE WITH THE "STANDARD TITLE SHEET SPECIFICATIONS FOR ROAD AND BRIDGE CONSTRUCTION". ADOPTED JANUARY 1 1, 2022; THE "SUPPLEMENTAL SPECIFICATIONS AND RECURRING SPECIAL INDEX OF SHEETS, HIGHWAY STANDARDS, AND PROVISIONS", ADOPTED JANUARY 1, 2022; THE LATEST EDITIONS OF THE **GENERAL NOTES** "MANUAL ON UNIFORM TRAFFIC CONTROL DEVICES FOR STREETS AND SUMMARY OF QUANTITIES 3-8 HIGHWAYS" (MUTCD) AND "THE STANDARD SPECIFICATIONS FOR WATER AND TYPICAL SECTIONS SEWER MAIN CONSTRUCTION IN ILLINOIS"; CITY OF AURORA STANDARD DETAILS AND SPECIFICATIONS; THE "DETAILS" IN THE PLANS; AND THE "SPECIAL **EARTHWORK SCHEDULE** 10 PROVISIONS" INCLUDED IN THE CONTRACT DOCUMENTS. REMOVAL SCHEDULE 11 ALIGNMENT, TIES, AND BENCHMARKS 12 2. ANY REFERENCE TO STANDARDS THROUGHOUT THE PLANS AND SPECIAL PROVISIONS SHALL BE INTERPRETED AS THE LATEST IDOT HIGHWAY STANDARD. **EXISTING CONDITIONS AND REMOVAL PLAN** 13-14 PROPOSED SITE PLAN 15-16 3. ALL TRAFFIC CONTROL AND OTHER ADVISORY SIGNS NEEDED FOR **EROSION CONTROL AND RESTORATION PLAN** 17-18 CONSTRUCTION ARE TO BE FURNISHED BY THE CONTRACTOR IN ACCORDANCE WITH SECTION 700 OF THE STANDARD SPECIFICATIONS. 19-20

#### **UTILITIES**

21-22

23-26

27-28

30-31

32-33

35-40

41-44

45

46

47

48

34

29

- 4. BEFORE STARTING ANY EXCAVATION, THE CONTRACTOR SHALL CALL "JULIE" AT (800) 892-0123 OR 811, METRA, BNSF AND THE CITY OF AURORA FOR FIELD LOCATIONS OF BURIED UTILITIES (48 HOURS NOTIFICATION REQUIRED).
- 5. THE CONTRACTOR SHALL BE RESPONSIBLE FOR CONTACTING THE OWNERS OF ALL EXISTING FACILITIES SO THAT THE UTILITIES AND THEIR APPURTENANCES MAY BE LOCATED AND ADJUSTED OR MOVED, IF NECESSARY, PRIOR TO THE START OF CONSTRUCTION OPERATIONS. THE CONTRACTOR SHALL COOPERATE WITH ALL UTILITY OWNERS AS PROVIDED FOR IN THE STANDARD SPECIFICATIONS.
- 6. THE LOCATIONS OF EXISTING DRAINAGE STRUCTURES, STORM AND SANITARY SEWERS. WATER SERVICE LINES AND OTHER UTILITY LINES ARE APPROXIMATE. AND THE CITY DOES NOT GUARANTEE THEIR ACCURACY. THEIR EXACT HORIZONTAL AND VERTICAL LOCATIONS ARE TO BE DETERMINED IN THE FIELD BY THE CONTRACTOR AT THE CONTRACTOR'S OWN EXPENSE.

#### MISCELLANEOUS

- 7. DIMENSIONS: IT SHALL BE THE CONTRACTOR'S RESPONSIBILITY TO VERIFY ALL DIMENSIONS AND CONDITIONS EXISTING IN THE FIELD PRIOR TO ORDERING MATERIALS AND BEGINNING CONSTRUCTION. CONTRACTOR SHALL NOTIFY THE PROJECT ENGINEER OF ANY DISCREPANCIES IMMEDIATELY.
- 8. THE SAFE AND ORDERLY PASSAGE OF TRAFFIC AND PEDESTRIANS SHALL BE MAINTAINED AT ALL TIMES.
- 9. NO CONSTRUCTION ACTIVITY SHALL BEGIN UNTIL ALL PROPER SIGNS AND BARRICADES HAVE BEEN INSTALLED. THIS SHALL INCLUDE INSTALLING EROSION AND SEDIMENT CONTROL DEVICES.
- 10. AT THE END OF EACH DAY, IT SHALL BE THE CONTRACTOR'S RESPONSIBILITY TO ASSURE THAT ALL STREETS, SIDEWALKS, AND PARKING LOTS ADJACENT TO THE PROJECT ARE FREE OF ALL CONSTRUCTION RELATED DEBRIS INCLUDING DIRT, STONE, NAILS, ETC. THE WORK SHALL BE DONE TO THE SATISFACTION OF THE 21. IT IS THE CONTRACTOR'S SOLE RESPONSIBILITY TO COORDINATE WITH THE ENGINEER AND THE CITY OF AURORA.
- 11. PRIOR TO CONSTRUCTION, IT SHALL BE THE CONTRACTOR'S RESPONSIBILITY TO FIELD CHECK ALL DIMENSIONS AND ELEVATIONS AND TO VERIFY THE LOCATION AND ELEVATION OF EXISTING UTILITY LINES AND STRUCTURES THAT MAY BE IMPACTED BY THE PROPOSED WORK PRIOR TO ORDERING MATERIAL OR BEGINNING CONSTRUCTION. ANY DISCREPANCIES FROM THE PLANS SHALL BE REPORTED TO THE ENGINEER IMMEDIATELY.

- 12. THE LOCATION AND ELEVATION OF EXISTING UTILITIES ARE APPROXIMATE. THE DRAINAGE AND UTILITIES GENERAL NOTES **EXACT LOCATIONS AND ELEVATIONS ARE TO BE VERIFIED BY THE CONTRACTOR** THE CONTRACTOR SHALL COORDINATE CONSTRUCTION ACTIVITIES WITH ALL 22. WHEN EXISTING DRAINAGE FACILITIES ARE DISTURBED, THE CONTRACTOR SHALL UTILITY COMPANIES AND GOVERNMENT AGENCIES AFFECTED BY THE WORK.
- 13. PAVEMENT AND CURBS TO REMAIN SHALL BE PROTECTED FROM DAMAGE, AND, IF DAMAGED, SHALL BE REPLACED PROMPTLY BY THE CONTRACTOR AT THE CONTRACTOR'S EXPENSE AND IN CONFORMANCE WITH IDOT STANDARD SPECIFICATIONS IN MATERIALS AND WORKMANSHIP.
- 14. WHENEVER, DURING CONSTRUCTION OPERATIONS, LOOSE MATERIAL IS DEPOSITED IN THE FLOW LINE OF GUTTERS, DRAINAGE STRUCTURES, DITCHES ETC., SUCH THAT THE NATURAL FLOW LINE OF WATER IS OBSTRUCTED. THE LOOSE 23. THE CONTRACTOR SHALL CONFIRM ALL SEWER PIPE SIZES AND INVERTS PRIOR TO MATERIAL SHALL BE REMOVED AT THE CLOSE OF EACH WORKING DAY. AT THE CONCLUSION OF THE CONSTRUCTION OPERATION, All DRAINAGE STRUCTURES AND FLOW LINES SHALL BE FREE FROM DIRT AND DEBRIS.
- 15. ALL DIMENSIONS, INCLUDING RADII, ARE GIVEN TO THE EDGE OF PAVEMENT 24. ANY EXISTING DRAINAGE FACILITIES DISTURBED OR DAMAGED DURING UNLESS OTHERWISE NOTED.
- 16. FULL-DEPTH SAW CUTS SHALL BE USED TO REMOVE EXISTING PAVEMENT, SIDEWALK, CURB AND OTHER APPURTENANCES FROM MATERIAL TO REMAIN IN 25. THE EXISTING STORM SEWER TO REMAIN SHALL BE INSPECTED BY THE ACCORDANCE WITH SECTION 440 OF THE STANDARD SPECIFICATIONS.
- WHERE SECTION OR SUBSECTION MONUMENTS ARE ENCOUNTERED, THE ENGINEER SHALL BE NOTIFIED BEFORE SUCH MONUMENTS ARE DISTURBED. THE CONTRACTOR SHALL CAREFULLY PRESERVE ALL PROPERTY MARKERS AND MONUMENTS UNTIL THE OWNER, AN AUTHORIZED SURVEYOR OR AGENT HAS 26. WITNESSED OR OTHERWISE REFERENCED EACH LOCATION.
- 18. ALL AREAS OF PLANNED SUBGRADE TREATMENT SHOULD BE VERIFIED IN THE FIELD AT THE TIME OF CONSTRUCTION BY A QUALIFIED SOILS INSPECTOR, ALL POTENTIALLY UNSTABLE/ UNSUITABLE SOILS SHOULD BE TESTED WITH A STATIC 27. THE CONTRACTOR SHALL BE RESPONSIBLE FOR THE PROTECTION OF ALL CONE PENETROMETER AND TREATED IN ACCORDANCE WITH ARTICLE 301.04 OF THE STANDARD SPECIFICATIONS FOR ROAD AND BRIDGE CONSTRUCTION AND THE UNDERCUT GUIDELINES IN THE IDOT SUBGRADE STABILITY MANUAL (SSM). ANY AGGREGATE SUBGRADE IMPROVEMENTS (CY) QUANTITIES NOT USED DURING CONSTRUCTION SHOULD BE DELETED FROM THE CONTRACT.
- 19. THE CONTRACTOR SHALL USE ALL NECESSARY PRECAUTIONARY AND PROTECTIVE MEASURES REQUIRED TO MAINTAIN AND PROTECT EXISTING UTILITIES, SEWERS, MAINS AND APPURTENANCES THAT MUST BE KEPT IN OPERATION. IN PARTICULAR, THE CONTRACTOR SHALL TAKE ADEQUATE MEASURES TO PREVENT THE UNDERMINING OF UTILITIES. SEWERS AND MAINS WHICH WILL REMAIN IN SERVICE. THE CONTRACTOR SHALL COORDINATE WITH THE ENGINEER AND UTILITY COMPANY IF IT IS DETERMINED THAT TEMPORARY BRACING OR SUPPORT OF THE UTILITIES IS REQUIRED.
- 20. THE CONTRACTOR SHALL REMOVE ONLY THOSE TREES AND SHRUBS AS SHOWN TO BE REMOVED ON THE PLANS, AS DIRECTED BY THE ENGINEER, OR WITH ENGINEER'S APPROVAL, THOSE TREES WHICH DIRECTLY INTERFERE WITH THE SAFETY OR QUALITY OF CONSTRUCTION PRACTICES. THE CONTRACTOR SHALL EXERCISE EXTREME CARE WHEN WORKING NEAR EXISTING TREES AND SHRUBS TO AVOID DAMAGING THOSE NOT SCHEDULED FOR REMOVAL AND SHALL REPLACE IN-KIND ANY DAMAGED PLANTS.
- BNSF/METRA RAILROAD WHENEVER CONSTRUCTION ACTIVITY IS WITHIN 25 FEET OF THE RAILROAD RIGHT-OF-WAY. THE CONTRACTOR SHALL RETAIN FLAGMEN EMPLOYED AND DESIGNATED BY THE BNSF/METRA RAILROAD TO MONITOR ON-COMING TRAIN TRAFFIC AND ADVISE CONTRACTOR PERSONNEL WHEN ACTIVITY ON OR NEAR THE RAILROAD RIGHT-OF-WAY MAY PROCEED. THIS ITEM WILL BE PAID FOR ACCORDING TO ARTICLE 107.12 AND WILL BE REIMBURSED ACCORDING TO ARTICLE 109.05.

SCALE: N.T.S.

- PROVIDE AND MAINTAIN TEMPORARY OUTLETS AND CONNECTIONS FOR ALL PRIVATE OR PUBLIC DRAINS, SEWERS OR CATCH BASINS. THE CONTRACTOR SHALL PROVIDE FACILITIES TO TAKE IN ALL STORM WATER WHICH WILL BE RECEIVED BY THESE DRAINS AND SEWERS AND DISCHARGE THE SAME. THE CONTRACTOR SHALL PROVIDE AND MAINTAIN AN EFFICIENT PUMPING PLAN, IF NECESSARY, AND A TEMPORARY OUTLET AND BE PREPARED AT ALL TIMES TO DISPOSE OF THE WATER RECEIVED FROM THESE TEMPORARY CONNECTIONS UNTIL SUCH TIME AS THE PERMANENT CONNECTIONS WITH SEWERS ARE BUILT AND IN SERVICE.
- ORDERING STRUCTURES. ANY MODIFICATIONS OF STRUCTURES DUE TO THE FAILURE OF THE CONTRACTOR TO PERFORM THIS TASK MAY LEAD TO THE REJECTION OF THE STRUCTURE IN THE FIELD.
- CONSTRUCTION SHALL BE REPAIRED OR REPLACED BY THE CONTRACTOR. THIS WORK SHALL BE PERFORMED TO THE SATISFACTION OF THE ENGINEER.
- CONTRACTOR BEFORE CONSTRUCTION STARTS. ANY EXISTING ACCUMULATED MATERIAL SHALL BE DOCUMENTED BY THE CONTRACTOR. ANY UNDOCUMENTED ACCUMULATION OF MATERIAL FOUND IN THE STRUCTURES OR PIPES AFTER CONSTRUCTION IS COMPLETED SHALL BE REMOVED BY THE CONTRACTOR.
- TOP OF FRAME ("RIM") ELEVATIONS GIVEN ON THE PLANS ARE ONLY TO ASSIST THE CONTRACTOR IN OF DETERMINING THE APPROXIMATE OVERALL HEIGHT OF EACH STRUCTURE, FRAMES ON ALL NEW STRUCTURES SHALL BE ADJUSTED TO THE FINAL ELEVATIONS OF THE AREAS IN WHICH THEY ARE LOCATED.
- UNDERGROUND OR SURFACE UTILITIES AND SEWER EVEN THOUGH THEY MAY NOT BE SHOWN ON THE PLANS. ANY SEWER OR UTILITY THAT IS DAMAGED DURING CONSTRUCTION SHALL BE REPAIRED OR REPLACED TO THE SATISFACTION OF THE ENGINEER OR CITY.

#### GEOTECHNICAL REPORT AND PRELIMINARY SITE INVESTIGATION

28. THOSE SEEKING THE FULL GEOTECHNICAL REPORT OR PRELIMINARY SITE INVESTIGATION SHOULD CONTACT THE OWNER OF RECORD. TO MAKE ARRANGEMENTS FOR ACCESS TO THIS INFORMATION, PLEASE CONTACT:

> ALEX SCHAEFER, PE CHRISTOPHER B. BURKE ENGINEERING, LTD. (CBBEL) 815-770-2850 ASCHAEFER@CBBEL.COM

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CONSTRUCTION DETAILS

**HIGHWAY STANDARDS** 

LIGHTING DETAILS

SEWER (BD-7)

		FUNDING SOURCE		FUNDING SOURCE			
						80% FED 20% LOCAL	
		CONSTRUCTION TYPE CODE	0005	0021	0042		
	CODE NO.	ITEM	UNIT	TOTAL QUANTITY	ROADWAY	LIGHTING	TRAINEES
~	20100110	TREE REMOVAL (6 TO 15 UNITS DIAMETER)	UNIT	92	92	0	0
* ~	20101100	TREE TRUNK PROTECTION	EACH	15	15	0	0
* ~	20101200	TREE ROOT PRUNING	EACH	15	15	0	0
	20101200						
* ~	20101300	TREE PRUNING (1 TO 10 INCH DIAMETER)	EACH	9	9	0	0
							0
*   ~	20101350	TREE PRUNING (OVER 10 INCH DIAMETER)	EACH	6	6	0	U
	20101400	NITROGEN FERTILIZER NUTRIENT	POUND	5	5	0	0
~	20101500	PHOSPHORUS FERTILIZER NUTRIENT	POUND	5	5	0	0
			BOLLID			0	0
	20101600	POTASSIUM FERTILIZER NUTRIENT	POUND	5	5	0	<u> </u>
* ~	20101700	SUPPLEMENTAL WATERING	UNIT	2	2	0	0
*	20200100	EARTH EXCAVATION	CU YD	539	539	0	0
	00004000	DEMOVAL AND DIODOCAL OF UNIQUITABLE MATERIAL	CU YD	23	23	0	0
	20201200	REMOVAL AND DISPOSAL OF UNSUITABLE MATERIAL		23	25		
	20400800	FURNISHED EXCAVATION	CU YD	180	180	0	0
	20800150	TRENCH BACKFILL	CU YD	6	5	1	0
	20000440	POROUS GRANULAR BACKFILL	CUYD	10	10	0	1 0
	20900110	FURUUS GRANULAR BACKFILL		10	fU	0	
	21001000	GEOTECHNICAL FABRIC FOR GROUND STABILIZATION	SQ YD	869	869	0	0
	21101615	TOPSOIL FURNISH AND PLACE, 4"	SQ YD	1210	1210	0	0
	25002442	SEEDING CLASS 1A	ACRE	0.25	0.25	0	0
	25000110	SEEDING, CLASS 1A	AURE	0.20	0.20	0	1
~	25000400	NITROGEN FERTILIZER NUTRIENT	POUND	23	23	0	0
~	25000500	PHOSPHORUS FERTILIZER NUTRIENT	POUND	23	23	0	0
	25000600	POTASSIUM FERTILIZER NUTRIENT	POUND	23	23	0	0
~	2000000	POTASSICIVI FERTILIZER NOTRIENT	FOUND	20	20		

- ~ DENOTES SPECIALTY ITEM
- \* DENOTES SPECIAL PROVISION

USER NAME = aschaefer	DESIGNED - AJS	REVISED -
	DRAWN - JRS	REVISED -
PLOT SCALE = N.T.S.	CHECKED - BMW	REVISED -
PLOT DATE = 10/7/2021	DATE - 10/7/2021	REVISED -

	ATC EAS	r Parkin	IG LOT	IMPROVI	EMENTS	F.A.P. RTE.	SECTION
	N/A	18-00325-00-PK					
SCALE: N.T.S.	SHEET 1	0F 6	SHEETS	STA.	TO STA.	-	ILLINOIS

	N/A 18-00325-00-PK KANE 48 3				CONTRAC	T NO.	61H35
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						ACCESS TO TRANSIT				
	FUNDING SOURCE  CONSTRUCTION TYPE CODE					80% FED 20% LOCAL				
		CONSTRUCTION TYPE CODE	0005	0021	0042					
	CODE NO.	ITEM	UNIT	TOTAL QUANTITY	ROADWAY	LIGHTING	TRAINEES			
	25100630	EROSION CONTROL BLANKET	SQ YD	1210	1210	0	0			
	28000400	PERIMETER EROSION BARRIER	FOOT	440	440	0	0			
	28000510	INLET FILTERS	EACH	17	17	0	0			
*	30300001	AGGREGATE SUBGRADE IMPROVEMENT	CU YD	23	23	0	0			
*	30300112	AGGREGATE SUBGRADE IMPROVEMENT 12"	SQ YD	772	772	0	0			
	31101200	SUBBASE GRANULAR MATERIAL, TYPE B 4"	SQ YD	2060	2060	0	0			
	35101800	AGGREGATE BASE COURSE, TYPE B 6"	SQ YD	16	16	0	0			
	35300215	PORTLAND CEMENT CONCRETE BASE COURSE 7 3/4"	SQ YD	97	97	0	0			
	40600290	BITUMINOUS MATERIALS (TACK COAT)	POUND	3430	3430	0	0			
	40600982	HOT-MIX ASPHALT SURFACE REMOVAL - BUTT JOINT	SQ YD	31	31	0	0			
	40603080	HOT-MIX ASPHALT BINDER COURSE, IL-19.0, N50	TON	106	106	0	0			
	40604060	HOT-MIX ASPHALT SURFACE COURSE, IL-9.5, MIX "D", N50	TON	700	700	0	0			
	42400200	PORTLAND CEMENT CONCRETE SIDEWALK 5 INCH	SQ FT	7055	7055	0	0			
*	42400800	DETECTABLE WARNINGS	SQ FT	707	707	0	0			
	44000100	PAVEMENT REMOVAL	SQ YD	495	495	0	0			
	44000154	HOT-MIX ASPHALT SURFACE REMOVAL, 1 1/4"	SQ YD	6815	6815	0	0			
	44000500	COMBINATION CURB AND GUTTER REMOVAL	FOOT	1780	1780	0	0			
	44000600	SIDEWALK REMOVAL	SQ FT	3185	3185	0	0			
*	52200800	SEGMENTAL CONCRETE BLOCK WALL	SQ FT	215	215	0	0			
	550A0380	STORM SEWERS, CLASS A, TYPE 2 18"	FOOT	6	6	0	0			

- ~ DENOTES SPECIALTY ITEM
- \* DENOTES SPECIAL PROVISION

e <sub>D</sub>	CHRISTOPHER B. BURKE ENGINEERING, LTD. 18221 W. 159th Street, Suite 201	ŀ
	Lockport, Illinois 60441 (815) 770-2850	Γ

USER NAME = aschaefer	DESIGNED	-	AJS	REVISED -
nt a	DRAWN	-	JRS	REVISED
PLOT SCALE = N.T.S.	CHECKED	-	BMW	REVISED -
PLOT DATE = 10/7/2021	DATE		10/7/2021	REVISED -

	ATC EAS	r Parkin	IG LOT	IMPROVE	MENTS	F.A.P. RTE.	SECTI	
	SUMMARY OF QUANTITIES							
SCALE: N.T.S.	SHEET 2	0F 6	SHEETS	STA.	TO STA.		II	

CODE NO. 60108104	CONSTRUCTION TYPE CODE  ITEM		-		80% FED 20% LOCAL	
60108104					MO /0 MO O / 1M	
60108104	ITEM			0005	0021	0042
		UNIT	TOTAL QUANTITY	ROADWAY	LIGHTING	TRAINEES
60207605	PIPE UNDERDRAINS, TYPE 1, 4"	FOOT	50	50	0	0
	CATCH BASINS, TYPE C, TYPE 8 GRATE	EACH	1	1	0	0
60260100	INLETS TO BE ADJUSTED	EACH	2	2	0	0
60500060	REMOVING INLETS	EACH	1	1	0	0
	NON-SPECIAL WASTE DISPOSAL	CU YD	773	773	0	0
66900530	SOIL DISPOSAL ANALYSIS	EACH	1	1	0	0
66901001	REGULATED SUBSTANCES PRE-CONSTRUCTION PLAN	L SUM	1	1	0	0
66901003	REGULATED SUBSTANCES FINAL CONSTRUCTION REPORT	L SUM	1	1	0	0
66901006	REGULATED SUBSTANCES MONITORING	CAL DA	30	30	0	0
67100100	MOBILIZATION	L SUM	1	1	0	0
72000100	SIGN PANEL - TYPE 1	SQ FT	58	58	0	0
72400310	REMOVE SIGN PANEL - TYPE 1	SQ FT	8	8	0	0
72400500	RELOCATE SIGN PANEL ASSEMBLY - TYPE A	EACH	3	3	0	0
72900100	METAL POST - TYPE A	FOOT	205	205	0	0
78000100	THERMOPLASTIC PAVEMENT MARKING - LETTERS AND SYMBOLS	SQ FT	335	335	0	0
78000200	THERMOPLASTIC PAVEMENT MARKING - LINE 4"	FOOT	7180	7180	0	0
78000400	THERMOPLASTIC PAVEMENT MARKING - LINE 6"	FOOT	45	45	0	0
78000600	THERMOPLASTIC PAVEMENT MARKING - LINE 12"	FOOT	330	330	0	0
78000650	THERMOPLASTIC PAVEMENT MARKING - LINE 24"	FOOT	15	15	0	0
80400100	ELECTRIC SERVICE INSTALLATION	EACH	1	0	1	0
	66900200 66900200 66901001 66901003 66901006 67100100 72000100 72400310 72400500 72900100 78000100 78000200 78000400 78000650	66900200 NON-SPECIAL WASTE DISPOSAL 66900530 SOIL DISPOSAL ANALYSIS 66901001 REGULATED SUBSTANCES PRE-CONSTRUCTION PLAN 66901003 REGULATED SUBSTANCES FINAL CONSTRUCTION REPORT 66901006 REGULATED SUBSTANCES MONITORING 67100100 MOBILIZATION 72000100 SIGN PANEL - TYPE 1 72400310 REMOVE SIGN PANEL - TYPE 1 72400500 RELOCATE SIGN PANEL ASSEMBLY - TYPE A 72900100 METAL POST - TYPE A 78000100 THERMOPLASTIC PAVEMENT MARKING - LINE 4" 78000400 THERMOPLASTIC PAVEMENT MARKING - LINE 6" 78000600 THERMOPLASTIC PAVEMENT MARKING - LINE 6" 78000650 THERMOPLASTIC PAVEMENT MARKING - LINE 12"	COUNT   COUN	CU YD   773	CHAPTER   CHAP	669002000 NON-SPECIAL WASTE DISPOSAL   CU YD   773   773   0   0   1   0   0   1   0   0   0   0

- ~ DENOTES SPECIALTY ITEM
- \* DENOTES SPECIAL PROVISION

CHRISTOPHER B, BURKE ENGINEERING, LTD, 6221 W. 158th Street, Suite 201 ackport, Illinois 60441 615) 770-285

USER NAME = aschaefer	DESIGNED	-	AJS	REVISED
	DRAWN	~	JRS	REVISED -
PLOT SCALE = N.T.S.	CHECKED	-	ВМЖ	REVISED -
PLOT DATE = 10/7/2021	DATE	_	10/7/2021	REVISED -

	ATC EAS	r Parkin	NG LOT	IMPROVE	MENTS	F.A.P. RTE.	SECTION
	SI	JMMARY	OF QU	ANTITIES		N/A	18-00325-00-F
SCALE: N.T.S.	SHEET 3	0F 6	SHEETS	STA.	TO STA.		ILLINOI

	ſ		FUNDING COURSE		ACCESS TO TRANSI	Т		
			FUNDING SOURCE				80% FED 20% LOCAL	
			CONSTRUCTION TYPE CODE	0005	0021	0042		
	-	CODE NO.	ITEM	UNIT	TOTAL QUANTITY	ROADWAY	LIGHTING	TRAINEES
*	~	80400200	ELECTRIC UTILITY SERVICE CONNECTION	L SUM	1	0	1	0
*	~	81028190	UNDERGROUND CONDUIT, GALVANIZED STEEL, 1 1/2" DIA.	FOOT	145	0	145	0
*	~	81028330	UNDERGROUND CONDUIT, PVC, 1 1/4" DIA.	FOOT	155	0	155	0
*	~	81028340	UNDERGROUND CONDUIT, PVC, 1 1/2" DIA.	FOOT	145	0	145	0
*	~	81028350	UNDERGROUND CONDUIT, PVC, 2" DIA.	FOOT	645	0	645	0
	~	81400730	HANDHOLE, COMPOSITE CONCRETE	EACH	3	0	3	0
*	~	81702101	ELECTRIC CABLE IN CONDUIT, 600V (XLP-TYPE USE) 1/C NO. 14	FOOT	1885	0	1885	0
*	~	81702110	ELECTRIC CABLE IN CONDUIT, 600V (XLP-TYPE USE) 1/C NO. 10	FOOT	3135	0	3135	0
*	~	81702130	ELECTRIC CABLE IN CONDUIT, 600V (XLP-TYPE USE) 1/C NO. 6	FOOT	410	0	410	0
*	~	81702140	ELECTRIC CABLE IN CONDUIT, 600V (XLP-TYPE USE) 1/C NO. 4	FOOT	690	0	690	0
*	~	81702150	ELECTRIC CABLE IN CONDUIT, 600V (XLP-TYPE USE) 1/C NO. 2	FOOT	640	0	640	0
	~	82500330	LIGHTING CONTROLLER, PEDESTAL MOUNTED, 240VOLT, 60AMP	EACH	1	0	1	0
	~	83600300	LIGHT POLE FOUNDATION, 30" DIAMETER	FOOT	10	0	10	0
	~	84200500	REMOVAL OF LIGHTING UNIT, SALVAGE	EACH	18	0	18	0
	~	84200804	REMOVAL OF POLE FOUNDATION	EACH	1	0	1	0
*	~	A2000220	TREE, ACER X FREEMANII MARMO (MARMO FREEMAN MAPLE), 2-1/2" CALIPER, BALLED AND BURLAPPED	EACH	4	4	0	0
*	<u>~</u>	A2005020	TREE, GYMNOCLADUS DIOICUS (KENTUCKY COFFEETREE), 2-1/2" CALIPER, BALLED AND BURLAPPED	EACH	2	2	0	0
*	~	A2018720	TREE, ULMUS CARPINIFOLIA MORTON, (ACCOLADE ELM), 2-1/2" CALIPER, BALLED AND BURLAPPED	EACH	4	4	0	0
*	~	K0036120	MULCH PLACEMENT 4"	SQ YD	76	76	0	0
*	~	X0320031	SIGN LIGHTING UNIT COMPLETE	EACH	3	0	3	0
								1

- ~ DENOTES SPECIALTY ITEM
- \* DENOTES SPECIAL PROVISION

1	
100000	CHRISTOPHER B, BURKE ENGINEERING, UTD.
	16221 W, 158th Street, Suite 201
I SSE ID	Lockport, Illinois 60441
Silente.	(815) 770-2850

USER NAME = aschaefer	DESIGNED	-	AJS	REVISED -	
4.	DRAWN	-	JRS	REVISED	
PLOT SCALE = N.T.S.	CHECKED	-	BMW	REVISED -	
PLOT DATE = 10/7/2021	DATE	-	10/7/2021	REVISED -	

STATE	0F	ILLINOIS
DEPARTMENT (	OF 1	<b>TRANSPORTATION</b>

				IMPROVEI ANTITIES	MENTS	F.A.F RTE
SCALE: N.T.S.	SHEET 4	0F 6	SHEETS	STA.	TO STA.	

							ACCESS TO TRANSI	Γ
			FUNDING SOURCE				80% FED 20% LOCAL	
			CONSTRUCTION TYPE CODE			0005	0021	0042
		CODE NO.	ITEM	UNIT	TOTAL QUANTITY	ROADWAY	LIGHTING	TRAINEES
*		X0321309	CONCRETE PAD	SQ YD	65	65	0	0
*		X0322916	PROPOSED STORM SEWER CONNECTION TO EXISTING STORM SEWER	EACH	1	1	0	0
*	~	X0325815	REMOVE EXISTING CABLE	FOOT	275	0	275	0
*		X0326806	WASHOUT BASIN	L SUM	1	1	0	0
*	~	X0327739	MISCELLANEOUS ELECTRICAL WORK	L SUM	1	0	1	0
*		X0350810	BOLLARD REMOVAL	EACH	18	18	0	0
*	~	X1400403	LUMINAIRE REPLACEMENT SPECIAL	EACH	12	0	12	0
*		X2111000	TOPSOIL EXCAVATION	CU YD	222	222	0	0
*		X6061005	CONCRETE CURB, TYPE B (SPECIAL)	FOOT	550	550	0	0
*		X6064200	COMBINATION CONCRETE CURB AND GUTTER, TYPE B-6.12 (SPECIAL)	FOOT	1660	1660	0	0
*		X7010216	TRAFFIC CONTROL AND PROTECTION, (SPECIAL)	L SUM	1	1	0	0
*	~	X7200105	SIGN PANEL - TYPE 1 (SPECIAL)	SQ FT	44	44	0	0
*	~	X7240205	REMOVE SIGN COMPLETE	EACH	16	16	0	0
*	~	X7330064	SIGN SUPPORT SPECIAL	EACH	3	3	0	0
*	~	X8250500	LIGHTING UNIT COMPLETE, SPECIAL	EACH	18	0	18	0
*	~	X8780100	CONCRETE FOUNDATIONS (SPECIAL)	CUYD	1	1	0	0
*	~	XX004101	ORNAMENTAL METAL FENCE	FOOT	49	49	0	0
*	~	XX005642	GATEWAY MONUMENT SIGN COMPLETE	EACH	1	1	0	0
*	~	XX006213	METAL POST, SPECIAL	EACH	4	4	0	0
*	~	XX006614	MODIFY EXISTING CABINET EQUIPMENT AND APPURTENANCES	EACH	1	0	1	0

- ~ DENOTES SPECIALTY ITEM
- \* DENOTES SPECIAL PROVISION

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	Lockport, Illinois 60441
100	JR151 770-2850

٦	USER NAME = aschaefer	DESIGNED	-	AJS	REVISED -	Γ
٥.	*;	DRAWN	-	JRS	REVISED , -	1
	PLOT SCALE = N.T.S.	CHECKED	-	BMW	REVISED -	
-	PLOT DATE = 10/7/2021	DATE	-	10/7/2021	REVISED -	ĺ

STATE	OF	ILLINOIS
DEPARTMENT	0F	TRANSPORTATION

	ATC EAS	T PARKIN	IG LOT	IMPROVE	MENTS	F.A.P. RTE.	SECTION
	S	UMMARY	OF QU	ANTITIES		N/A	18-00325-00-F
SCALE: N.T.S.	SHEET 5	0F 6	SHEETS	STA.	TO STA.	<u> </u>	ILLINOI

			FINDING COURSE				ACCESS TO TRANSI	Γ
			FUNDING SOURCE		•		80% FED 20% LOCAL	
			CONSTRUCTION TYPE CODE	0005	0021	0042		
		CODE NO.	ITEM	UNIT	TOTAL QUANTITY	ROADWAY	LIGHTING	TRAINEES
*	~	XX008269	WAYFINDING SIGN	EACH	2	2	0	0
*		XX008686	BIKE SHELTER	EACH	1	1	0	0
*		XX008694	HOT-MIX ASPHALT SIDEWALK REMOVAL	SQ YD	94	94	0	0
*		XX009158	BIKE SHELTER TYPE 2	EACH	1	1	0	0
*		XX009477	COMMUTER SHELTER	EACH	2	2	0	0
*	~	Z0003855	BICYCLE RACKS	EACH	4	4	0	0
*		Z0004002	BOLLARDS	EACH	20	20	0	0
*		Z0013798	CONSTRUCTION LAYOUT	L SUM	1	1	0	0
*		Z0022800	FENCE REMOVAL	FOOT	40	40	0	0
*	~	Z0033028	MAINTENANCE OF LIGHTING SYSTEM	CAL MO	6	0	6	0
*		Z0048665	RAILROAD PROTECTIVE LIABILITY INSURANCE	L SUM	1	1	0	0
*		Z0076600	TRAINEES	HOUR	500	0	0	500
*		Z0076604	TRAINEES TRAINING PROGRAM GRADUATE	HOUR	500	0	0	500


<sup>~</sup> DENOTES SPECIALTY ITEM

СD	CHRISTOPHER B. BURKE ENGINEERING, LTD. 16221 W. 159th Street, Suite 201	
ED D	Lockport, Illinois 60441 (815) 770-2850	Ī


USER NAME = aschaefer	DESIGNED	-	AJS	REVISED -	Г
- 4	DRAWN	-	JRS	REVISED 4 -	
PLOT SCALE = N.T.S.	CHECKED	-	вмм	REVISED -	
PLOT DATE = 10/7/2021	DATE	~	10/7/2021	REVISED -	ı

	ATC EAS	T PARK	(ING LOT	IMPROVE	MENTS	F./ R1
	S	ΙΙΜΜΔΙ	RY OF OIL	ANTITIES		N.
		OWNER		7,141111120		
SCALE: N.T.S.	SHEET 6	0F 6	SHEETS	STA.	TO STA.	


<sup>\*</sup> DENOTES SPECIAL PROVISION

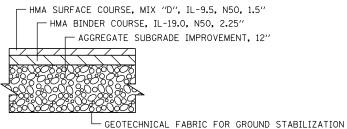


## PROPOSED PARKING LOT PAVEMENT RECONSTRUCTION & WIDENING (2' WIDE OR GREATER)

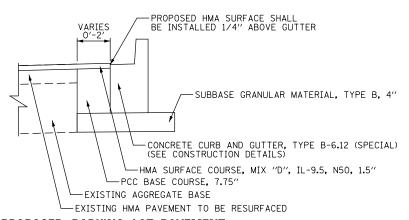


## PROPOSED PARKING LOT PAVEMENT RECONSTRUCTION & WIDENING (LESS THAN 2' WIDE)

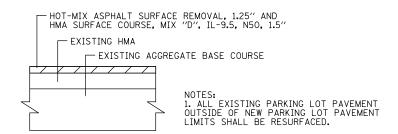


#### PROPOSED PARKING LOT RESURFACING

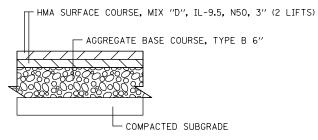



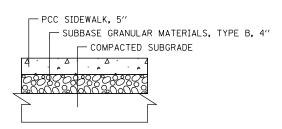


#### PCC SIDEWALK, 5"

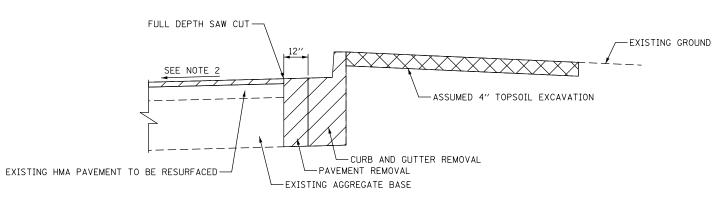

#### **EXISTING TYPICAL SECTION**

PAVEMENT RECONSTRUCTION/WIDENING

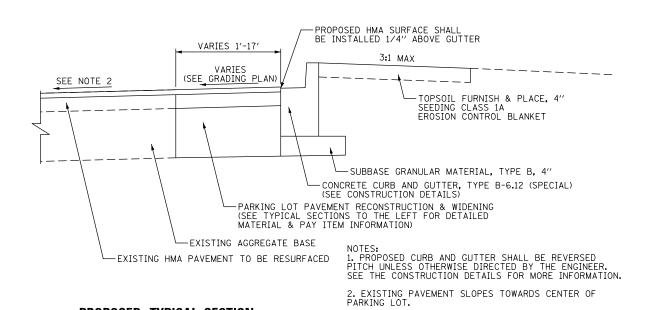

#### PROPOSED TYPICAL SECTION

PAVEMENT RECONSTRUCTION/WIDENING

HOT-MIX ASPHALT MIXTURE REQUIREMENTS		
MIXTURE ITEM	AIR VOIDS @ Ndes	QMP
PARKING LOT PAVEMENT RECONSTRUCTION & WIDENING		
HOT-MIX ASPHALT SURFACE COURSE, MIX "D", IL-9.5, N50, 1 1/2"	4% <b>©</b> 50 GYR	LR 1030-2
HOT-MIX ASPHALT BINDER COURSE, IL-19.0, N50, 2 1/4"	4% <b>©</b> 50 GYR	LR 1030-2
PARKING LOT RESURFACING		
HOT-MIX ASPHALT SURFACE COURSE, MIX "D", IL-9.5, N50, 1 1/2"	4% <b>©</b> 50 GYR	LR 1030-2
HOT-MIX ASPHALT SIDEWALK		
HOT-MIX ASPHALT SURFACE COURSE, MIX "D", IL-9.5, N50, 3" (2 LIFTS)	4% <b>©</b> 50 GYR	LR 1030-2
QMP DESIGNATION: QUALITY CONTROL/QUALITY ASSURANCE (QC/QA) PER LR 1030	-2	

#### NOTES:

- THE UNIT WEIGHT USED TO CALCULATE ALL HMA SURFACE MIXTURE QUANTITIES IS 112 LBS/SQ YD/IN.
- 2. THE "AC TYPE" SHALL BE "PG 64-22" UNLESS MODIFIED BY RECLAIMED MATERIALS SPECIFICATIONS.

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	USER NAME = aschaefer	DESIGNED	-	AJS	REVISED	=
D.		DRAWN	-	JRS	REVISED	=
	PLOT SCALE = 40'	CHECKED	-	BMW	REVISED	=
	PLOT DATE = 12/1/2021	DATE	-	12/1/2021	REVISED	=

STATE	OF	ILLINOIS
DEPARTMENT	0F	TRANSPORTATION

ATC EAST PARKING LOT IMPROVEMENTS							SECTION	COUNTY	TOTAL	SHEET NO.
TYPICAL SECTIONS						N/A	18-00325-00-PK	KANE	48	9
								CONTRAC	T NO.	61H35
SCALE: N.T.S.	SHEET 1	OF 1	SHEETS	STA.	TO STA.		ILLINOIS FED. A	ID PROJECT		

				EARTHV	VORK SCHEDU	ILE		
				X2111000	20200100	20400800	20201200	66900200
STATION		OFFSET (RT/LT)	TOPSOIL EXCAVATION	EARTH EXCAVATION	FURNISHED EXCAVATION (SEE NOTE 4)	REMOVAL & DISPOSAL OF UNSUITABLE MATERIAL (UNDERCUTS)	NON-SPECIAL WASTE DISPOSAL	
				(CU YD)	(CU YD)	(CU YD)	(CU YD)	(CU YD)
09+86	TO	10+26	21' TO 145' RT	42	46	3	0	88
10+18	TO	10+66	11' TO 33' LT	1	6	1	0	7
11+50	TO	15+29	11' TO 34' RT	89	130	99	12	231
15+54	ТО	18+58	11' TO 39' RT	56	126	26	10	192
19+14	TO	19+72	85' TO 97' LT	11	0	13	0	0
19+51	TO	25+49	11' TO 43' LT	0	202	40	0	202
23+80	TO	25+51	45' TO 67' RT	23	29	11	1	53
		TOTAL		222	539	193	23	773

#### NOTES:

- 1. IT IS ASSUMED THAT ALL EXISTING TOPSOIL WILL BE STRIPPED AND HAULED OFF SITE. FOR QUANTITY CALCULATIONS, THE EXISTING TOPSOIL WAS ESTIMATED TO BE 4-INCHES THICK.
- 2. NON-SPECIAL WASTE DISPOSAL SHALL INCLUDE THE HAULING AND DISPOSAL OF REGULATED SUBSTANCES ONLY. EARTH EXCAVATION AND REMOVAL AND DISPOSAL OF UNSUITABLE MATERIALS (AS APPLICABLE) SHALL BE PAID FOR SEPARATELY.
- 3. ADDITIONAL QUANTITY FOR REMOVAL AND DISPOSAL OF UNSUITABLE MATERIAL HAS BEEN INCLUDED FOR UNDERCUTS BENEATH PROPOSED PAVEMENT AREAS AS DETERMINED TO BE NECESSARY BY THE ENGINEER. THE REMOVED SOILS SHALL BE REPLACED WITH AGGREGATE SUBGRADE IMPROVEMENT.
- 4. BASED ON FINDINGS OF THE PRELIMINARY SITE INVESTIGATION REPORT PREPARED BY HUFF & HUFF MAY 10, 2021, IT IS ASSUMED MOST DISTURBED SOIL WILL NEED TO BE REMOVED, DISPOSED OF AT A LANDFILL AND REPLACED WITH FURNISHED EXCAVATION OR OTHER PROPOSED ITEMS OF WORK. THE CONTRACTOR SHALL RE-USE ANY MATERIAL DEEMED ACCEPTABLE USING ON-SITE MONITORING OF REGULATED SUBSTANCES.
- 5. ALL EXCAVATION AND EMBANKMENT LOCATIONS REQUIRING SEEDING SHALL BE CONSTRUCTED TO 4-INCHES BELOW FINISHED GRADE TO ALLOW FOR TOPSOIL PLACEMENT.

		USER
GD 162	CHRISTOPHER B. BURKE ENGINEERING, LTD. 16221 W. 15981 Street, Suite 201 Lockport, Illinois 60441 (815) 770-2850	
		PLOT

	USED HAVE - I C	DECTONED		A IC	DEVICED	_
	USER NAME = aschaefer	DESIGNED	-	AJS	REVISED -	
D.		DRAWN	-	JRS	REVISED -	
	PLOT SCALE = N.T.S.	CHECKED	-	BMW	REVISED -	
	PLOT DATE = 12/1/2021	DATE	-	12/1/2021	REVISED -	

STATE OF	ILLINOIS
DEPARTMENT OF T	RANSPORTATION

ATC EAST PARKING LOT IMPROVEMENTS	F.A.P. RTE.	SECTION	COUNTY	TOTAL SHEETS	SHEET NO.
EARTHWORK SCHEDULE	N/A	18-00325-00-PK	KANE	48	10
LAITHWOIK JUILDULL			CONTRAC	T NO.	61H35
SCALE: N.T.S.   SHEET 1 OF 1 SHEETS   STA. TO STA.		ILLINOIS FED. AI	ID PROJECT		

## **REMOVAL SCHEDULE**

	TATIO		OFFSET (RT/LT)	QUANTITY	UNIT	
TREE	REM	10VAL (6 T	O 15 UNITS DIAME	ETER) (20100		
10+13.8	ТО		RT	12	UNIT	
13+27.9	ТО		RT	15	UNIT	
13+70.5	ТО		RT	15	UNIT	
14+10.4	ТО		RT	15	UNIT	
14+58.0	ТО		RT	15	UNIT	
14+99.5	ТО		RT	15	UNIT	
16+04.5	ТО		RT	4	UNIT	
		PAVEMEN	IT REMOVAL (4400	00100)		
09+86.4	ТО	10+09.9	RT	3	SQ YD	
10+19.1	ТО	10+25.6	RT	2	SQ YD	
10+21.0	ТО	10+61.6	LT	3	SQ YD	
11+50.1	ТО	15+28.7	RT	42	SQ YD	
15+54.3	ТО	18+57.7	RT	36	SQ YD	
19+51.6	ТО	25+47.5	LT	281	SQ YD	
23+85.4	ТО	25+47.4	RT	80	SQ YD	
24+10.8	ТО	24+22.5	RT	11	SQ YD	
25+10.3	ТО	25+21.5	RT	11	SQ YD	
COMBI	NAT	ION CURB	AND GUTTER REM	ЛOVAL (4400)	0500)	
09+86.4	ТО	10+10.0	RT	28	FOOT	
10+19.5	ТО	10+25.6	RT	12	FOOT	
10+21.2	ТО	10+61.6	LT	27	FOOT	
11+50.1	ТО	15+28.7	RT	380	FOOT	
15+54.3	ТО	18+57.7	RT	323	FOOT	
19+51.6	ТО	25+47.5	LT	648	FOOT	
23+85.4	4 TO 25+47.4		25+47.4 RT		FOOT	
24+11.9	ТО	24+21.4	RT	52	FOOT	
25+11.5	ТО	25+20.5	RT	47	FOOT	

ST	ATIO	ON	OFFSET (RT/LT)	QUANTITY	UNIT			
	SII	DEWALK R	REMOVAL (	4400600)				
09+97.4 TO 10+22.5 TO		10+18.7	RT	266	FOOT			
		10+61.5	LT	107	FOOT			
19+83.3	TO	20+09.9	LT	235	FOOT			
21+97.8	ТО	25+48.9	LT	2400	FOOT			
24+13.5	ТО	24+20.0	RT	94	FOOT			
25+12.8	ТО	25+18.9	RT	77	FOOT			
	NLE.	TS TO BE A	ADJUSTED	(60260100)				
10+08.4	ТО		RT	1	EACH			
12+89.4	TO		RT	1	EACH			
	R	EMOVING	INLETS (60	0500060)				
17+00.9	ТО		RT	1	EACH			
	BC	DLLARD RE	MOVAL (X	(0350810)				
20+68.8	ТО	21+75.6	LT	7	EACH			
22+08.7	О	22+16.2	LT	4	EACH			
22+55.5	ТО	23+52.3	LT	7	EACH			
R	REMC	OVE SIGN (	COMPLETE	E (X7240205)				
10+00.4	ТО	10+03.9	RT	1	EACH			
10+16.3	ТО		RT	1	EACH			
20+68.8	TO	21+75.6	LT	7	EACH			
22+55.5	ТО	23+52.3	LT	7	EACH			
24+64.6	TO		RT	1	EACH			
25+34.0	О		RT	1	EACH			
HOT-MIX ASPHALT SIDEWALK REMOVAL (XX008694)								
10+17.0	ТО	10+25.5	RT	78	SQ YD			
10+25.0	TO	10+65.1	LT	16	SQ YD			
	F	ENCE REN	ЛOVAL (Z0	022800)				
19+22.8	ТО	19+62.8	LT	40	FOOT			

SCALE: N.T.S.


### NOTES:


1. ADDITIONAL QUANTITIES HAVE BEEN INCLUDE FOR SOME PAY ITEMS FOR SPOT REPAIRS WITHIN THE PROJECT LIMITS TO BE DETERMINED BY THE ENGINEER IN THE FIELD.


	USER NAME = aschaefer	DESIGNED	-	AJS	REVISED -	
D.		DRAWN	-	JRS	REVISED -	
	PLOT SCALE = N.T.S.	CHECKED	-	BMW	REVISED -	
	PLOT DATE = 12/1/2021	DATE	-	12/1/2021	REVISED -	ı


STATE OF ILLINOIS
DEPARTMENT OF TRANSPORTATION


ATC EAS	T PARKII	F.A.P. RTE.	SECTION			
REMOVAL SCHEDULE						18-00325-00-PK
	ILLIVIOV	AL JUIL	DOLL			
CHEET 1	OF 1	CHEETE	CTA	TO CTA		

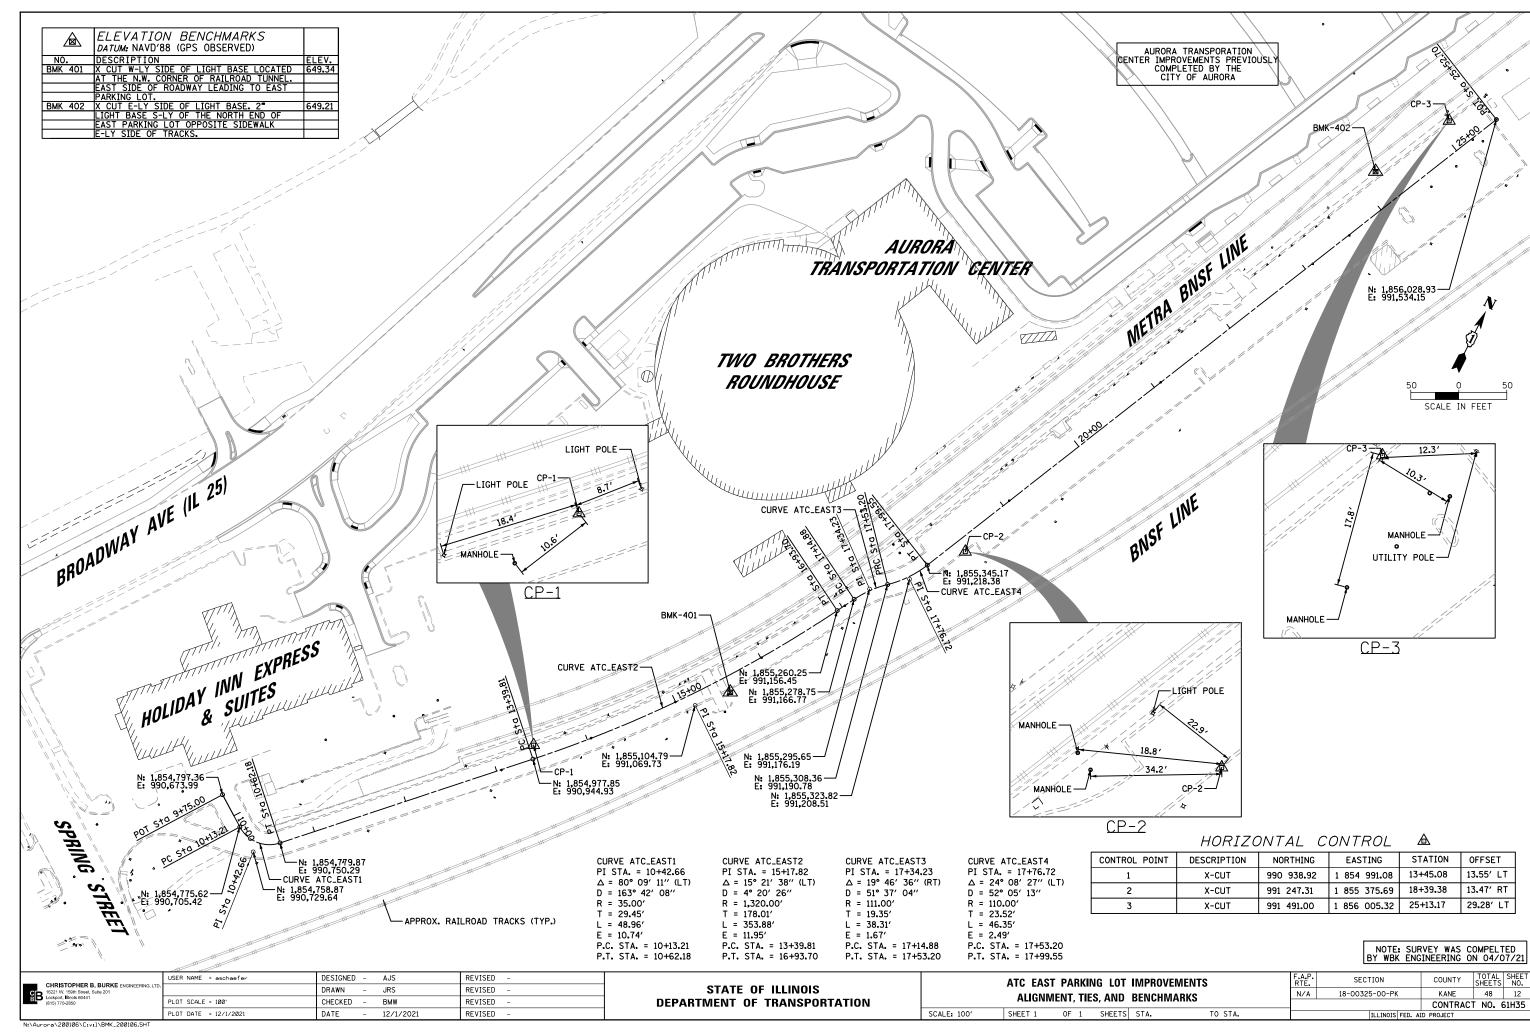


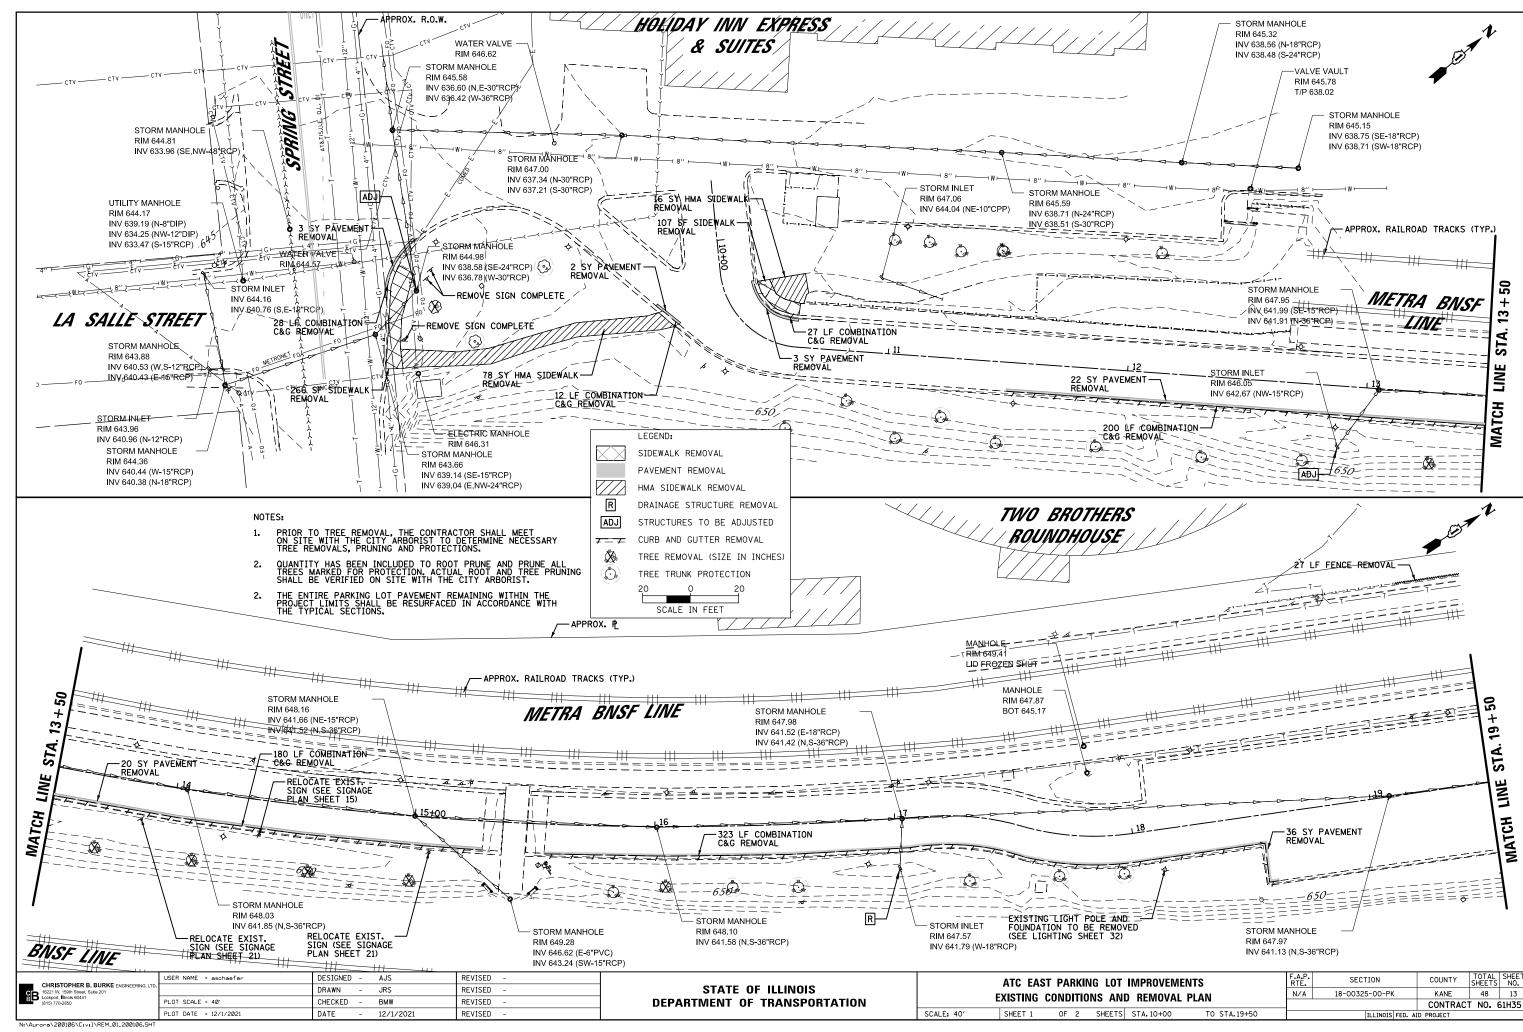


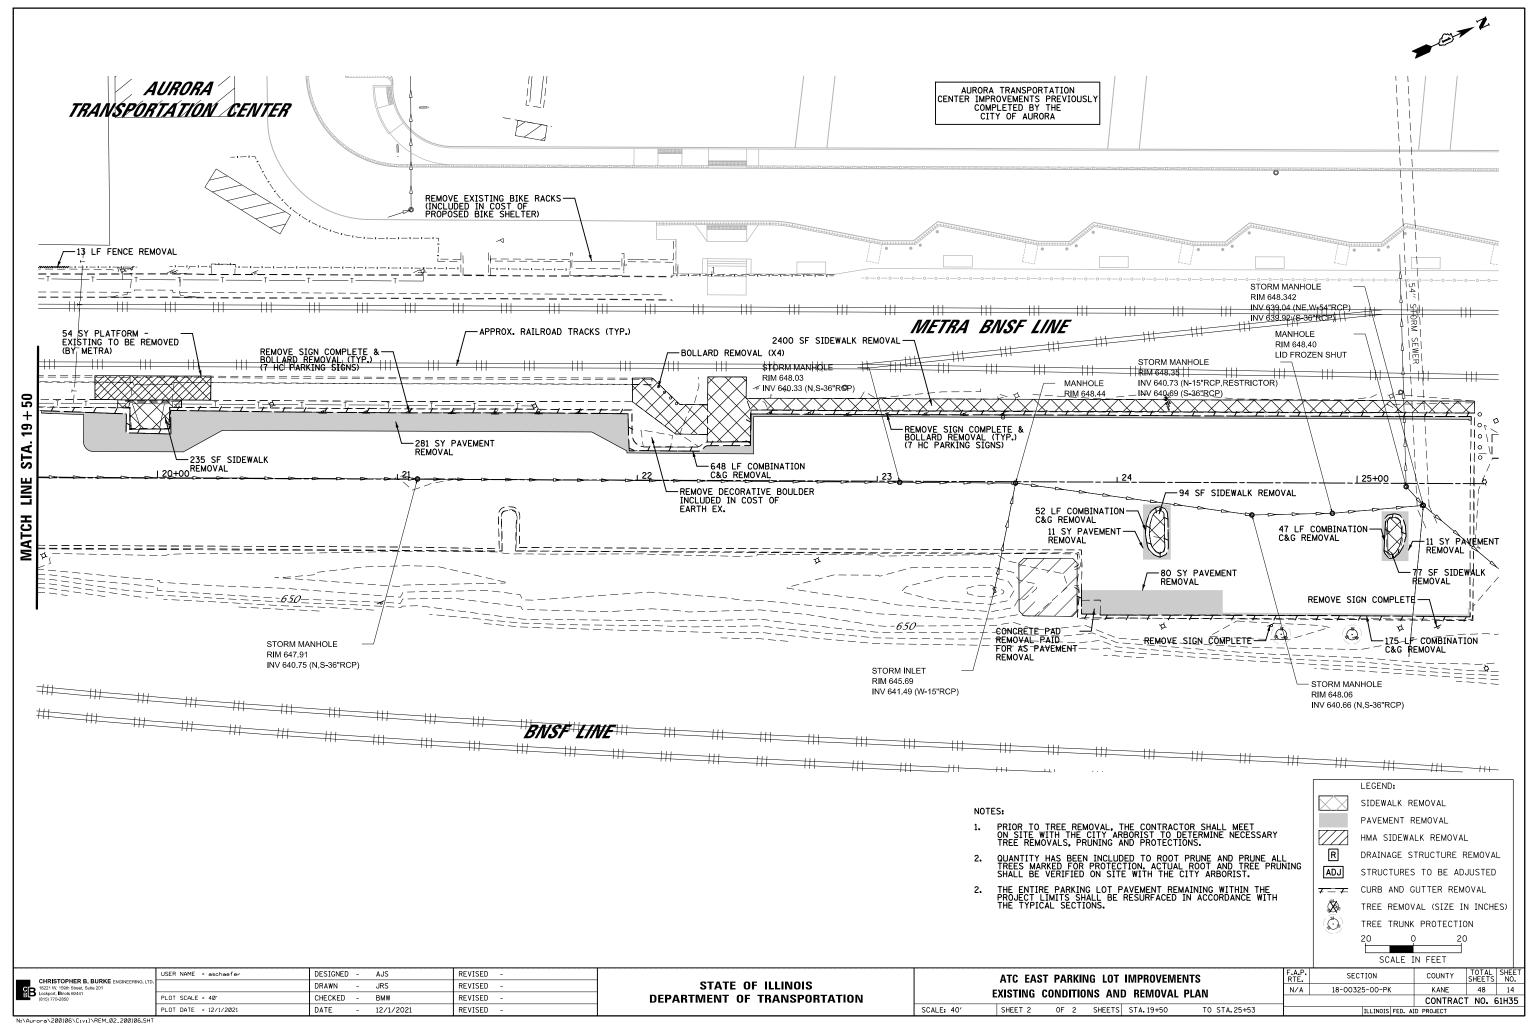


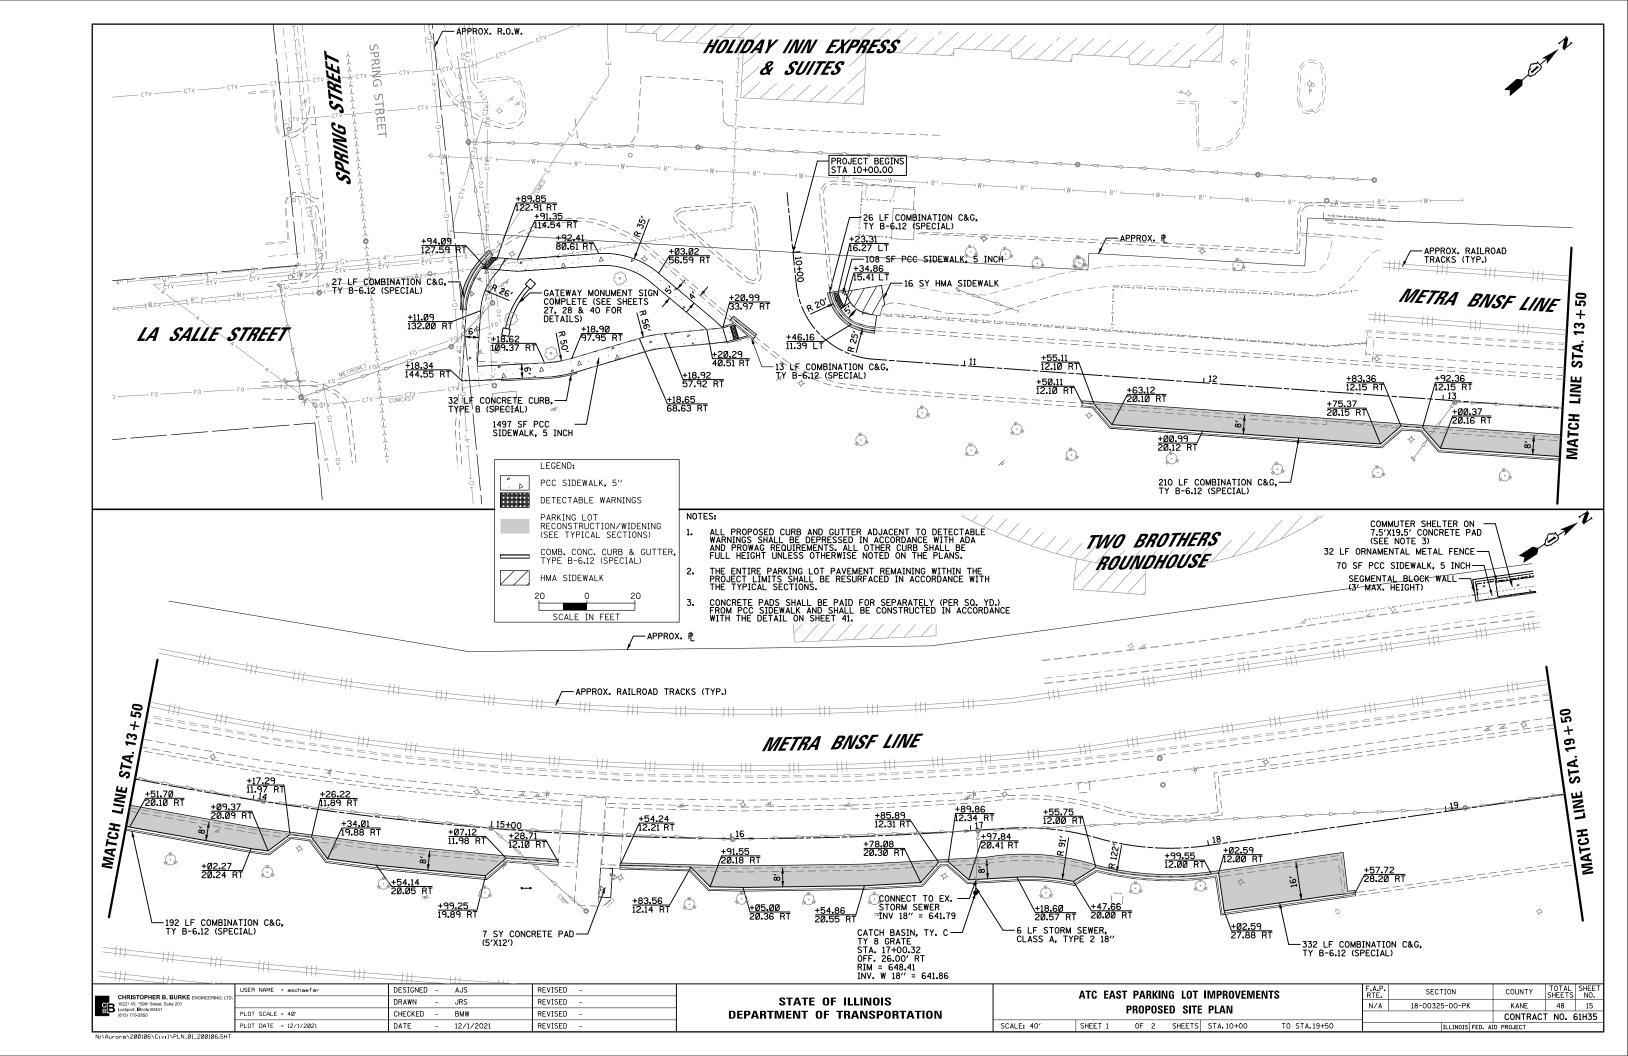


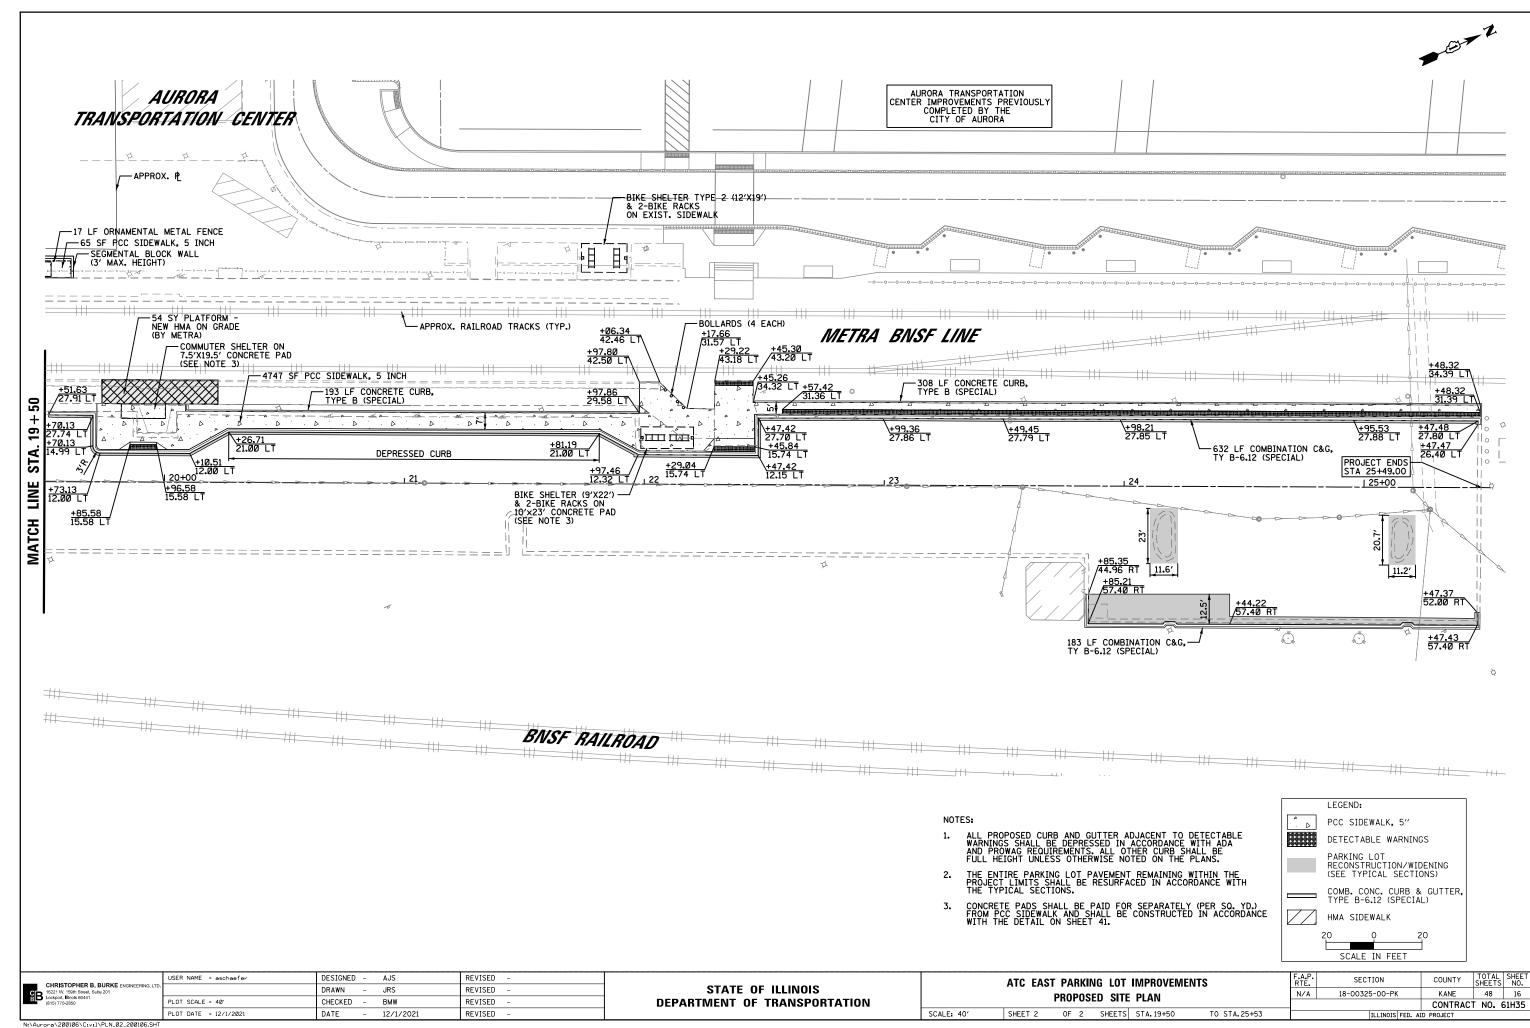


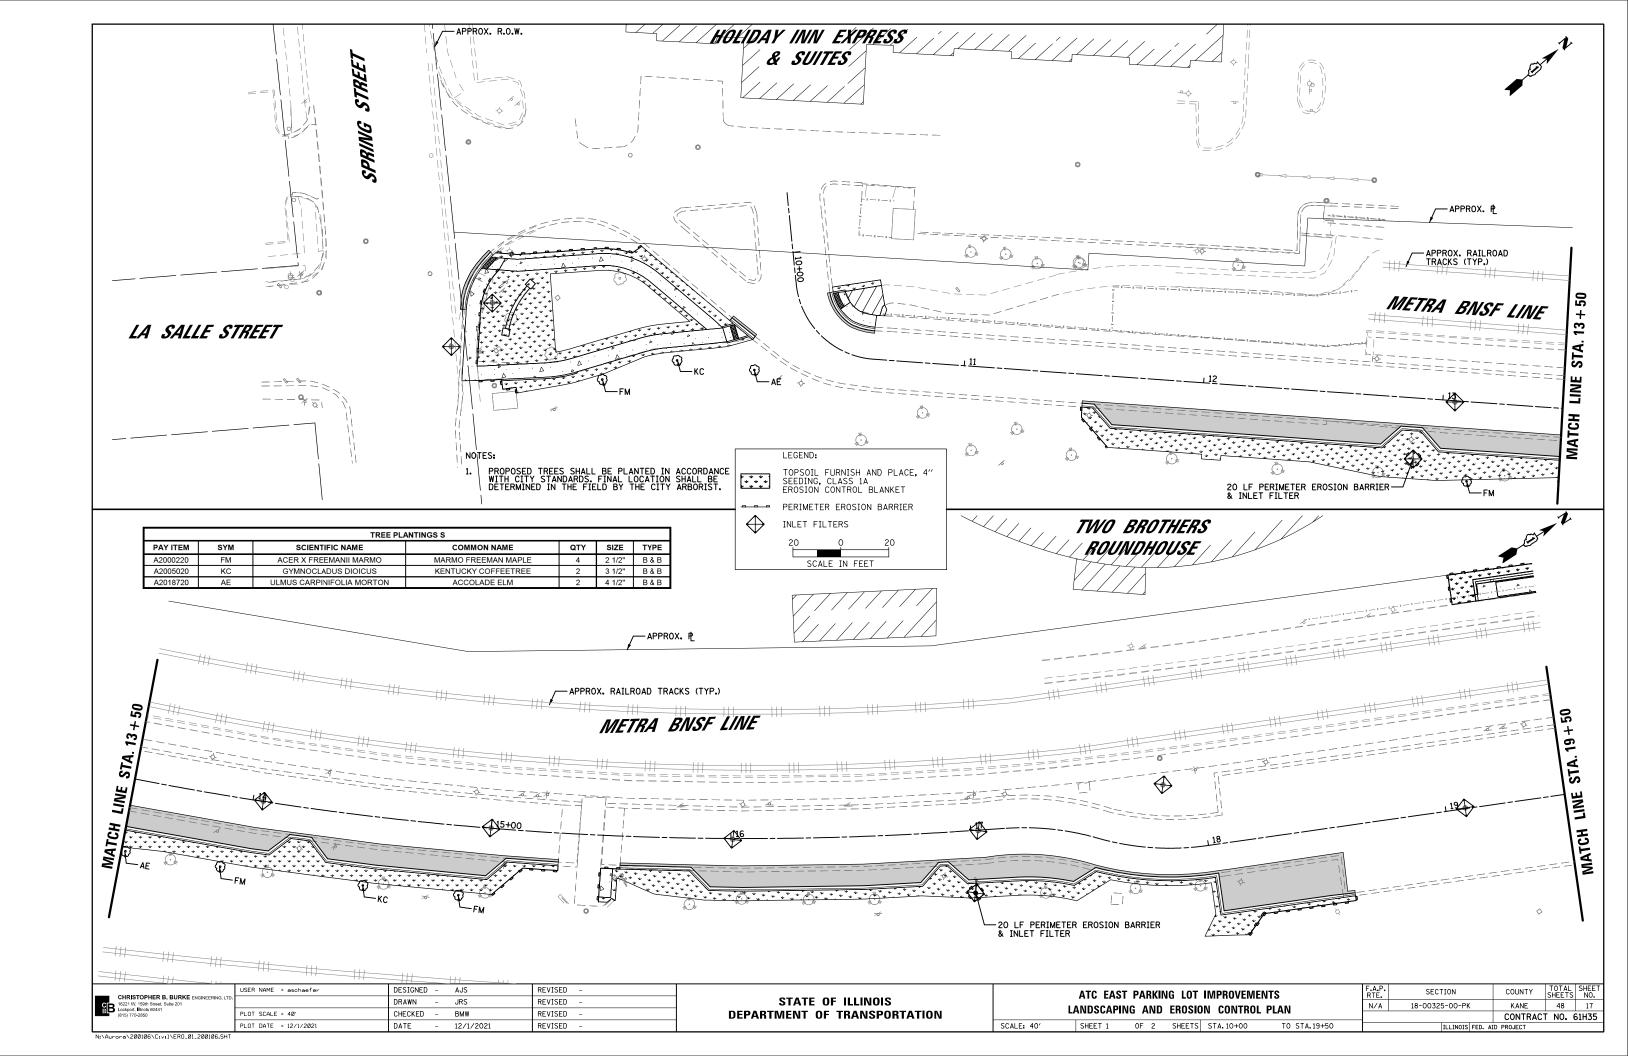


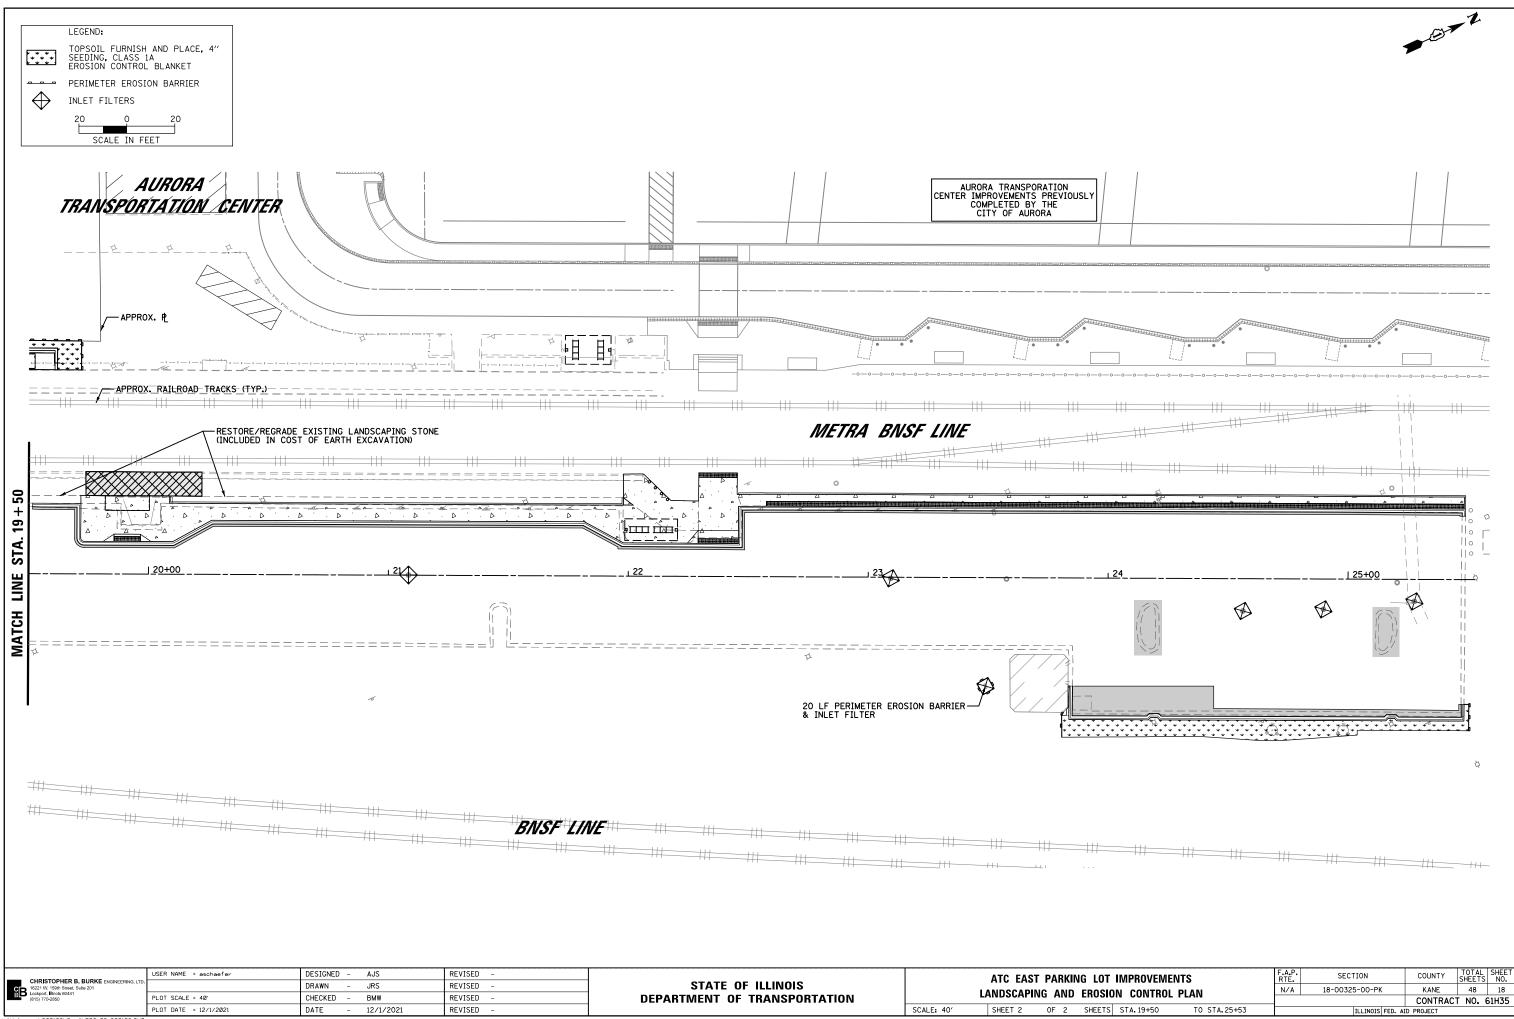


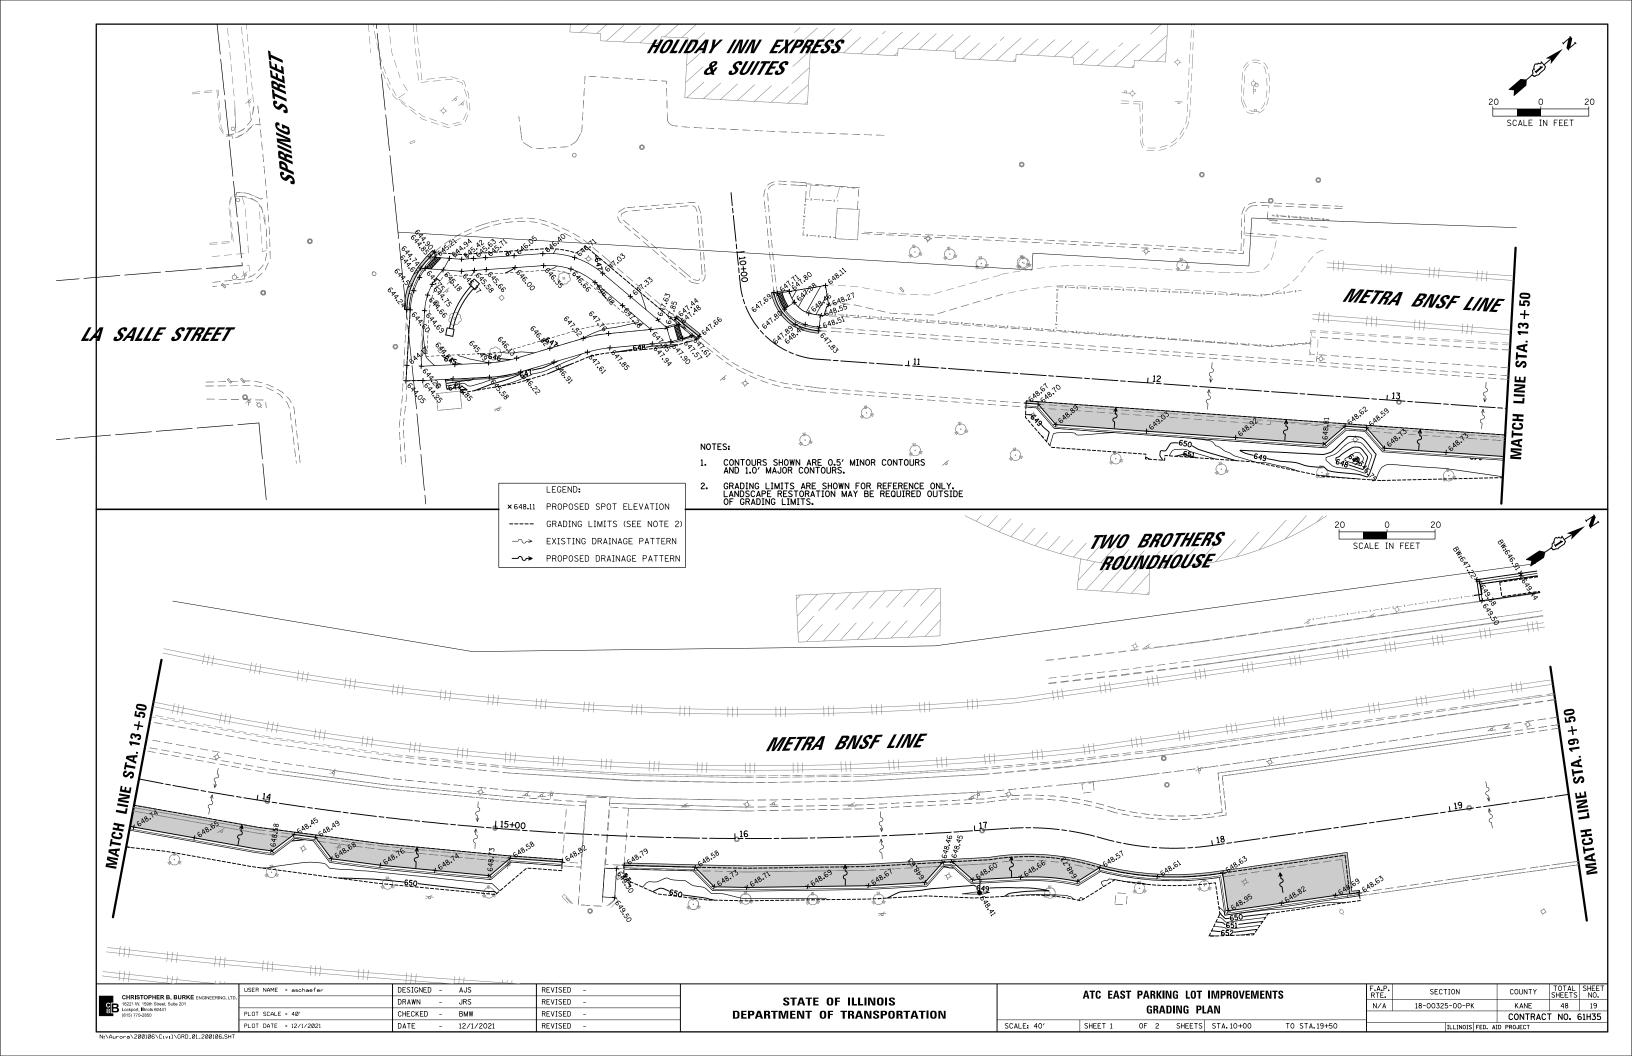


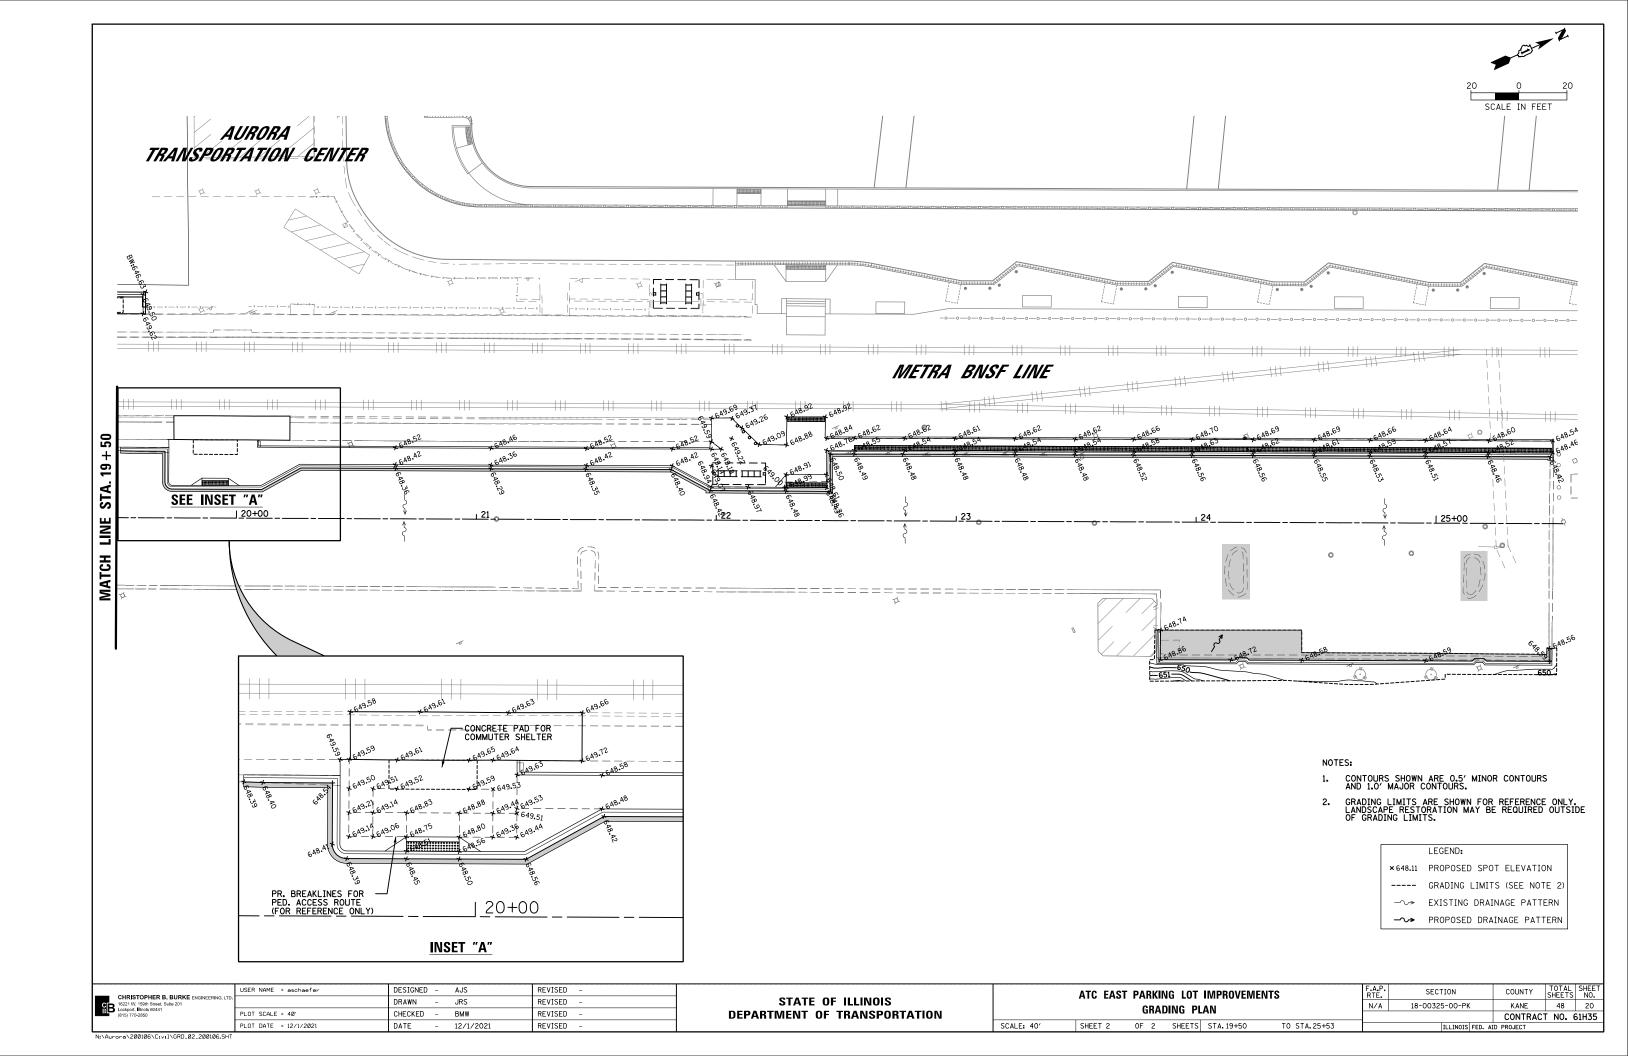


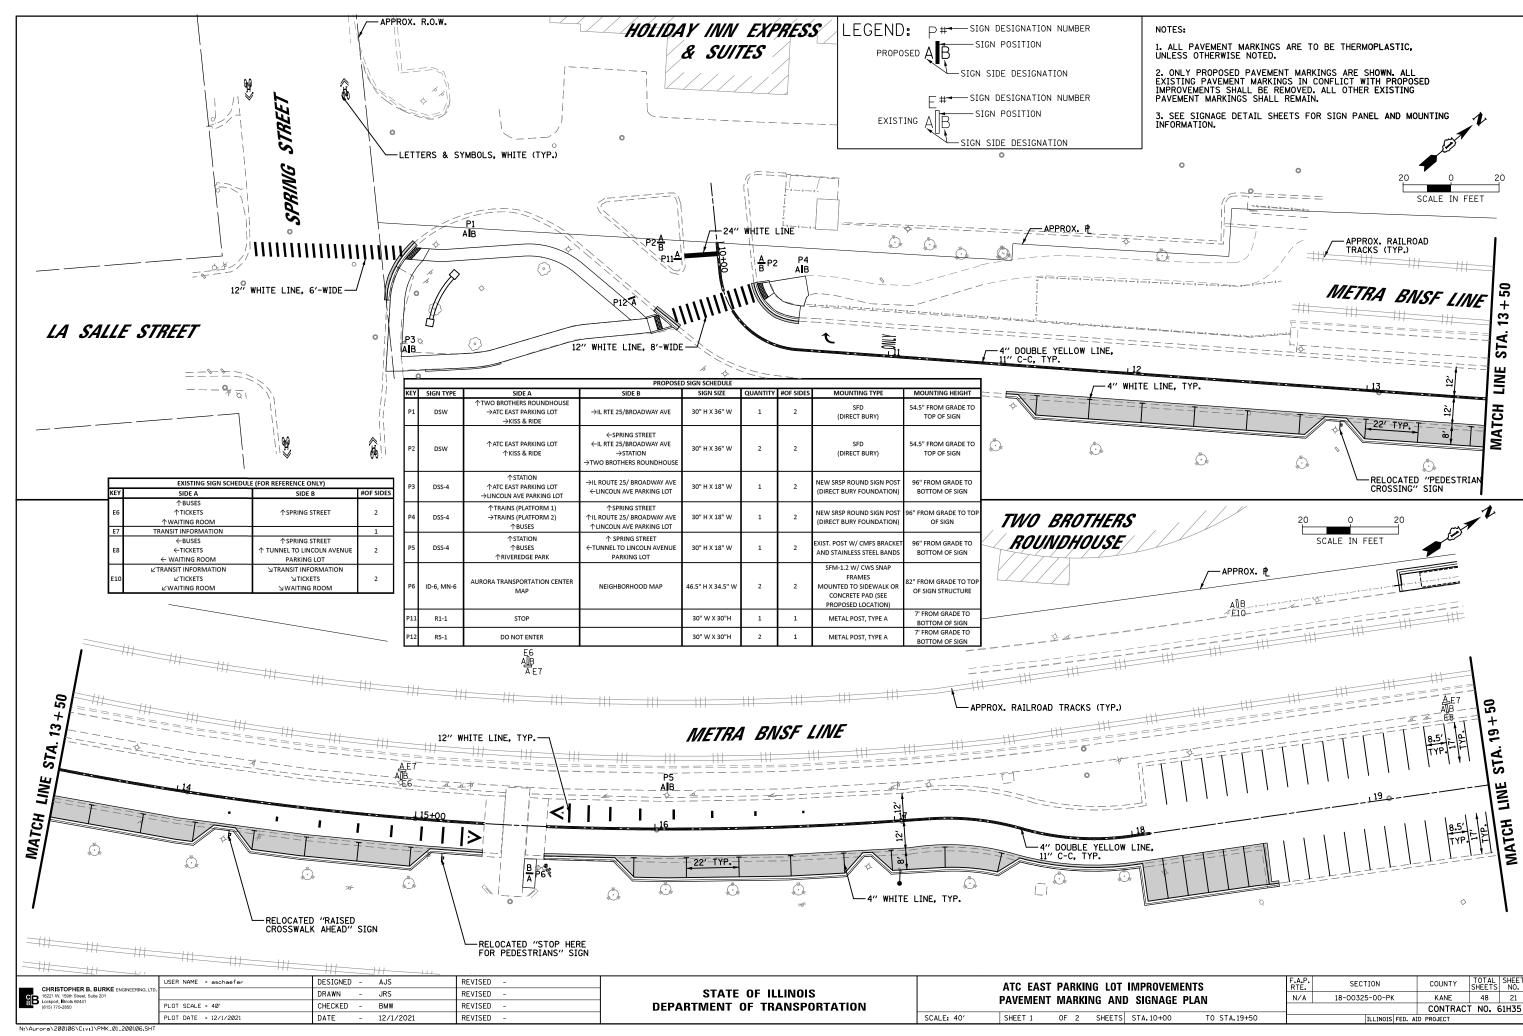


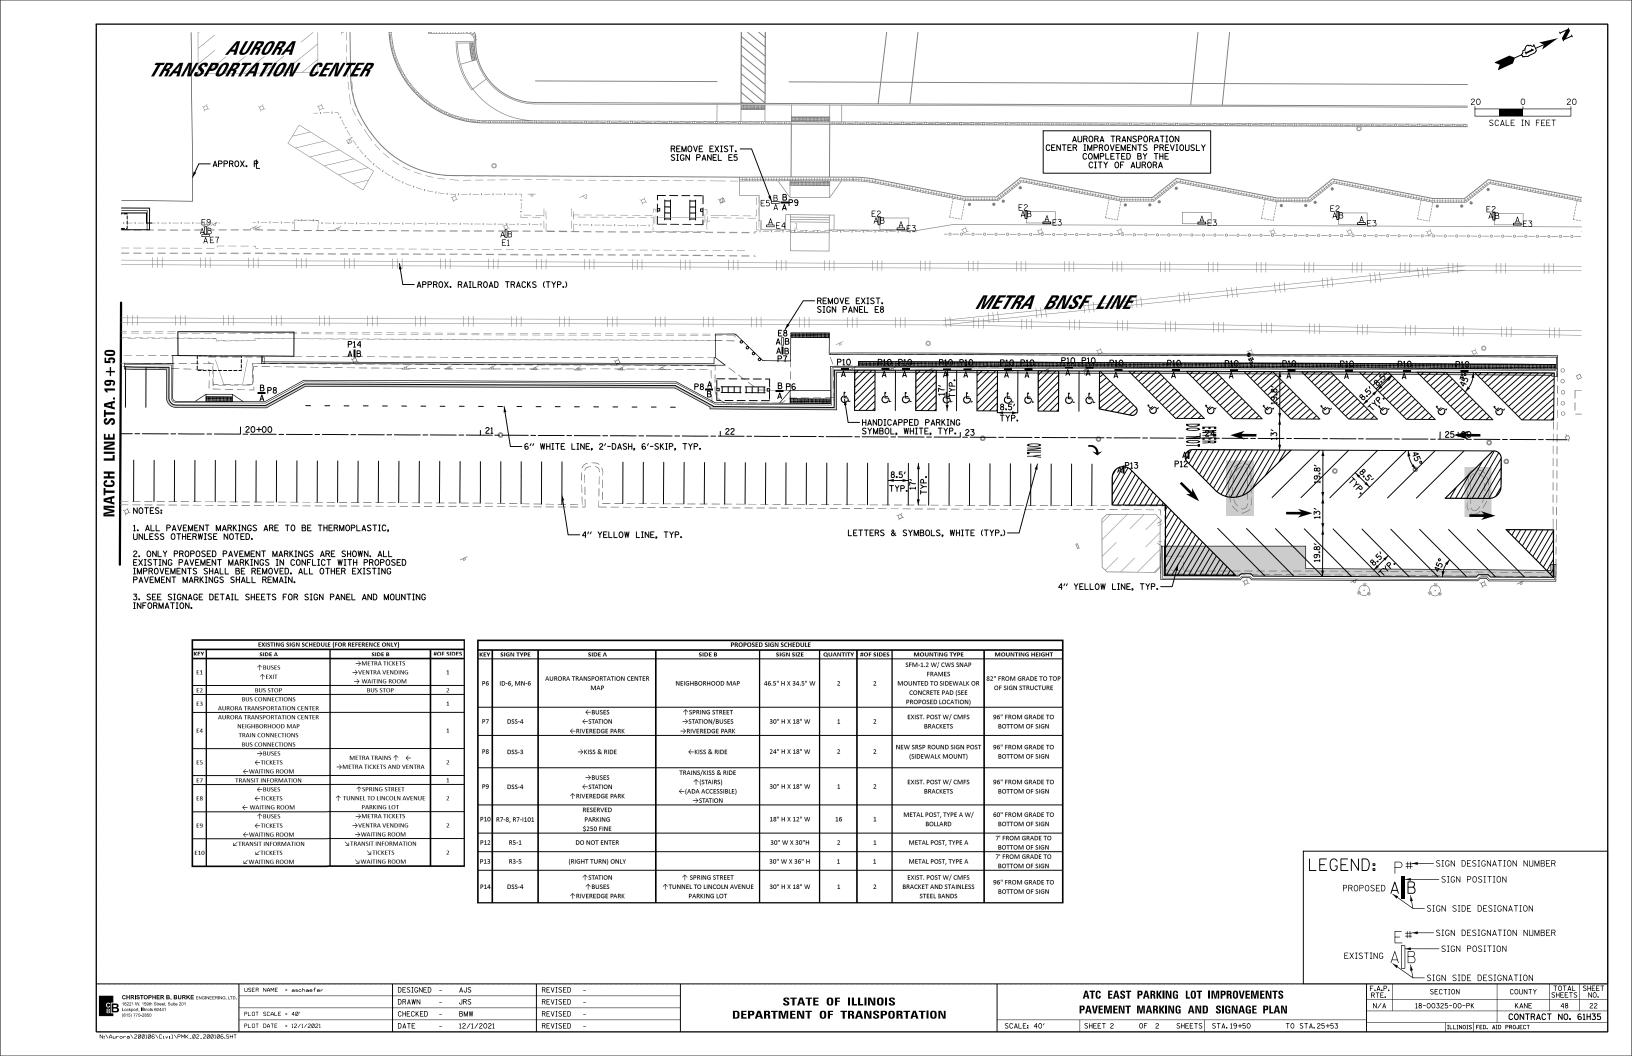


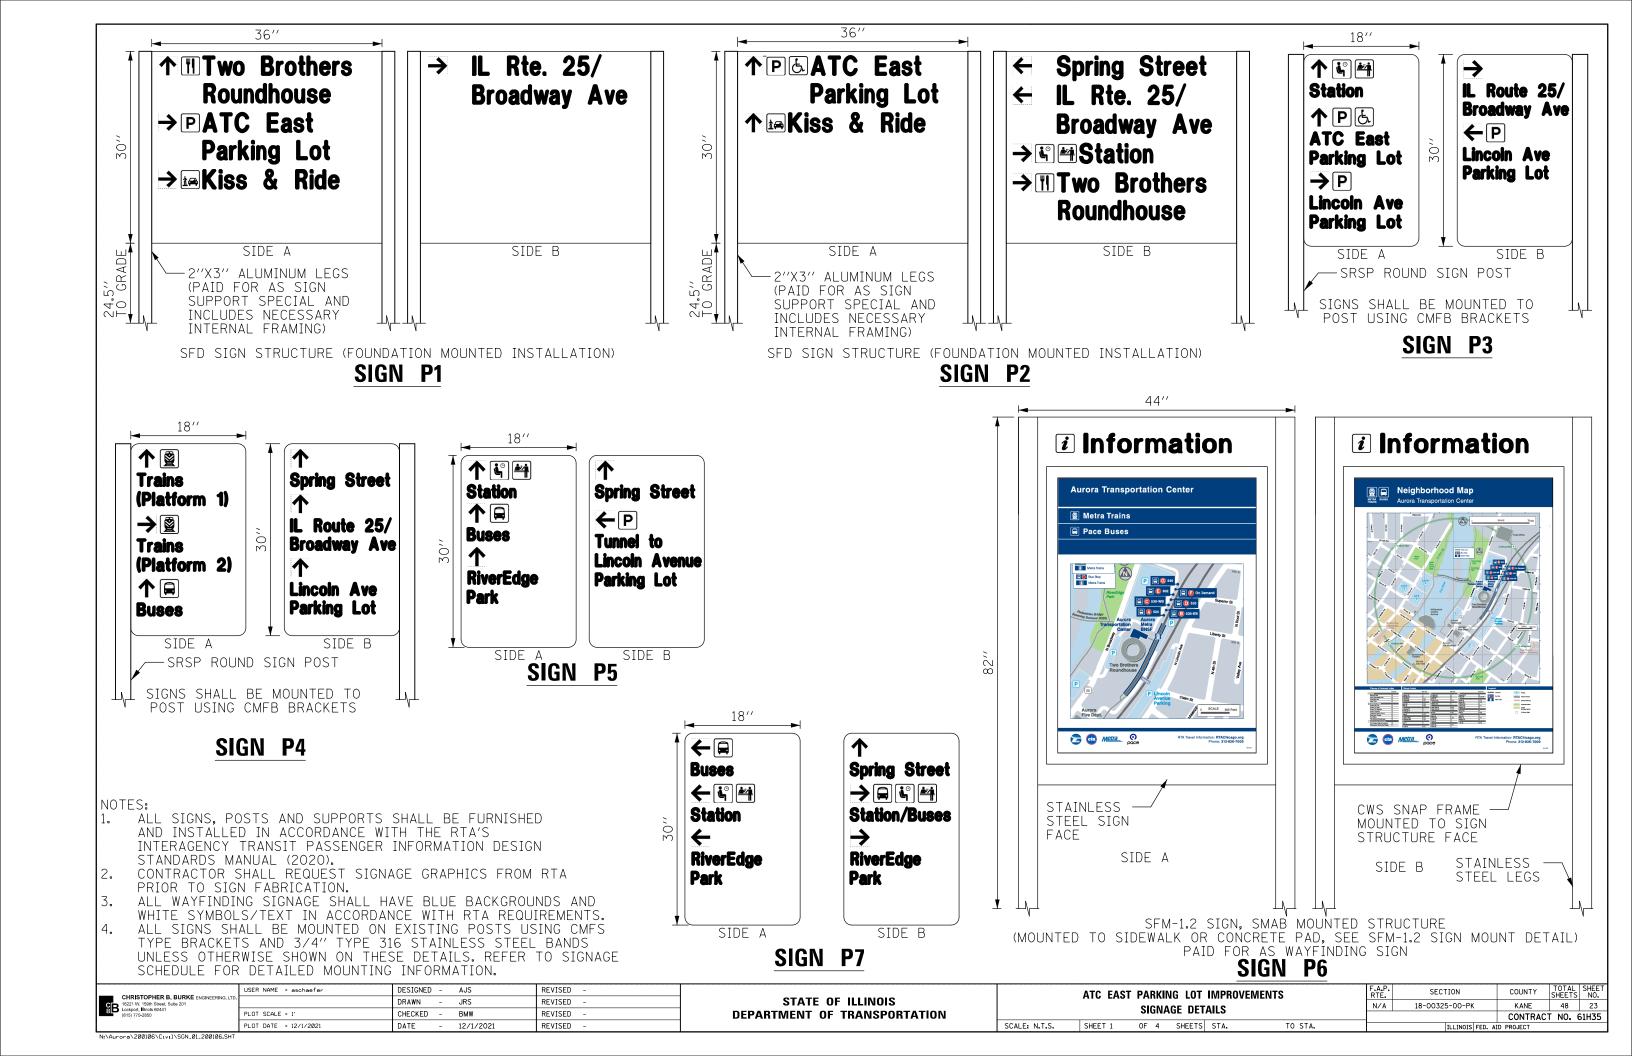


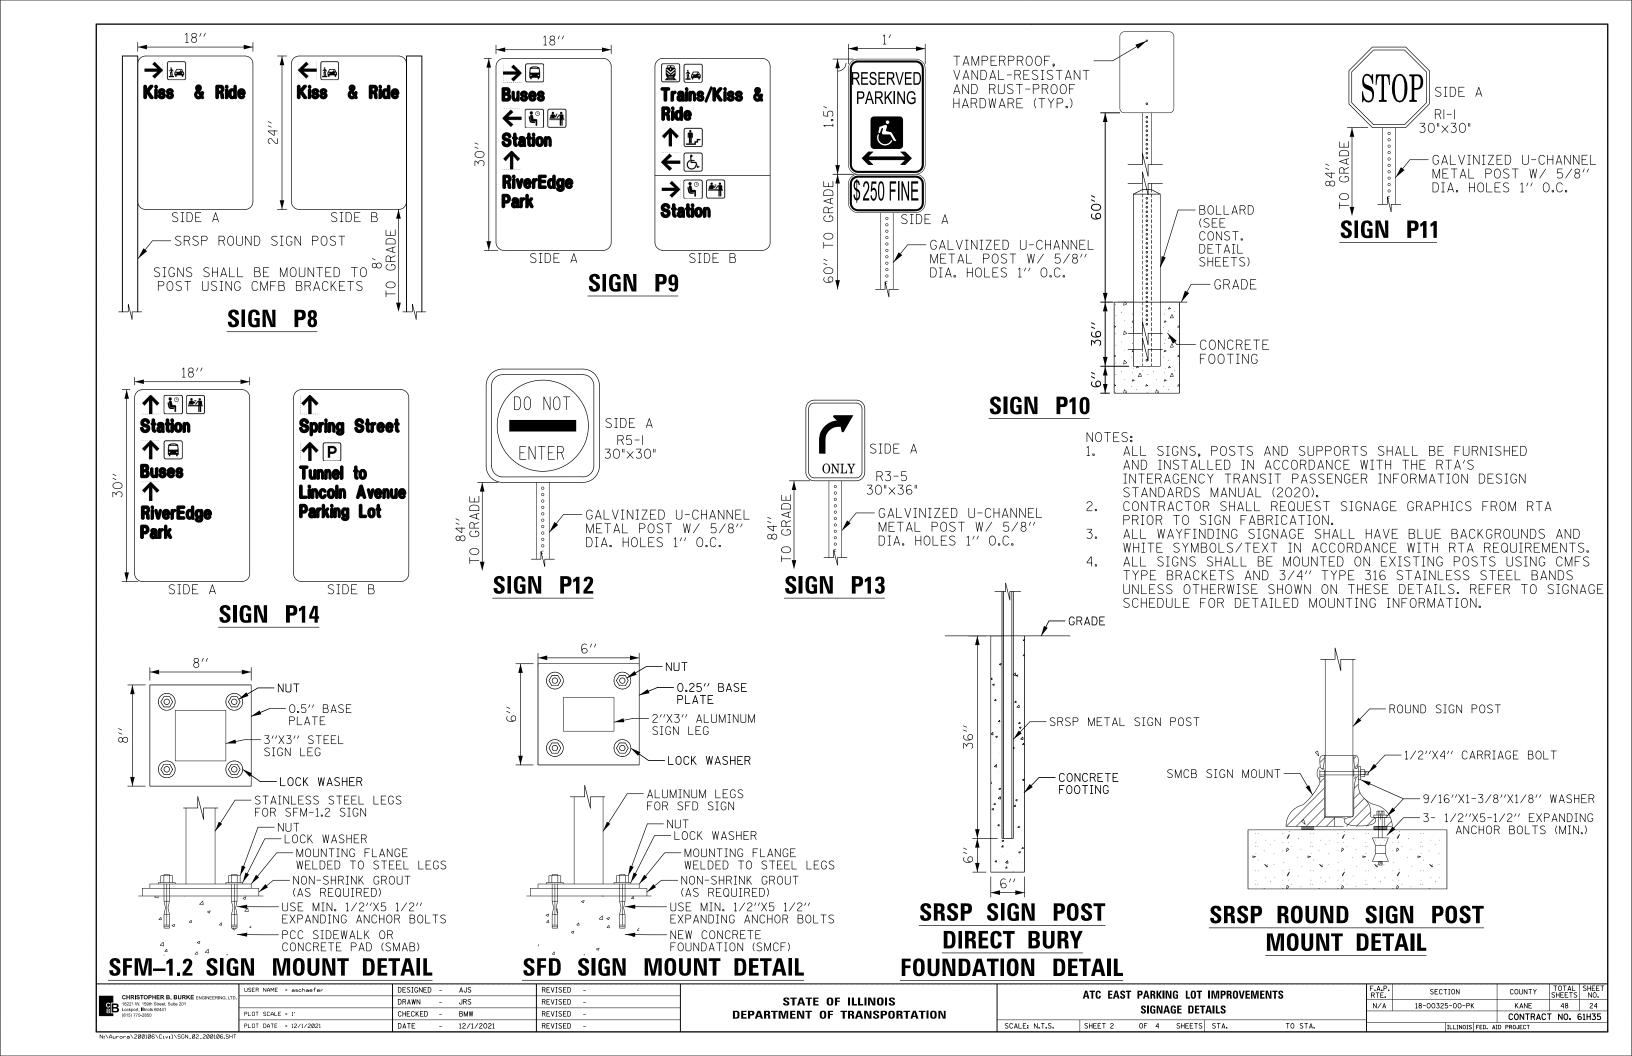

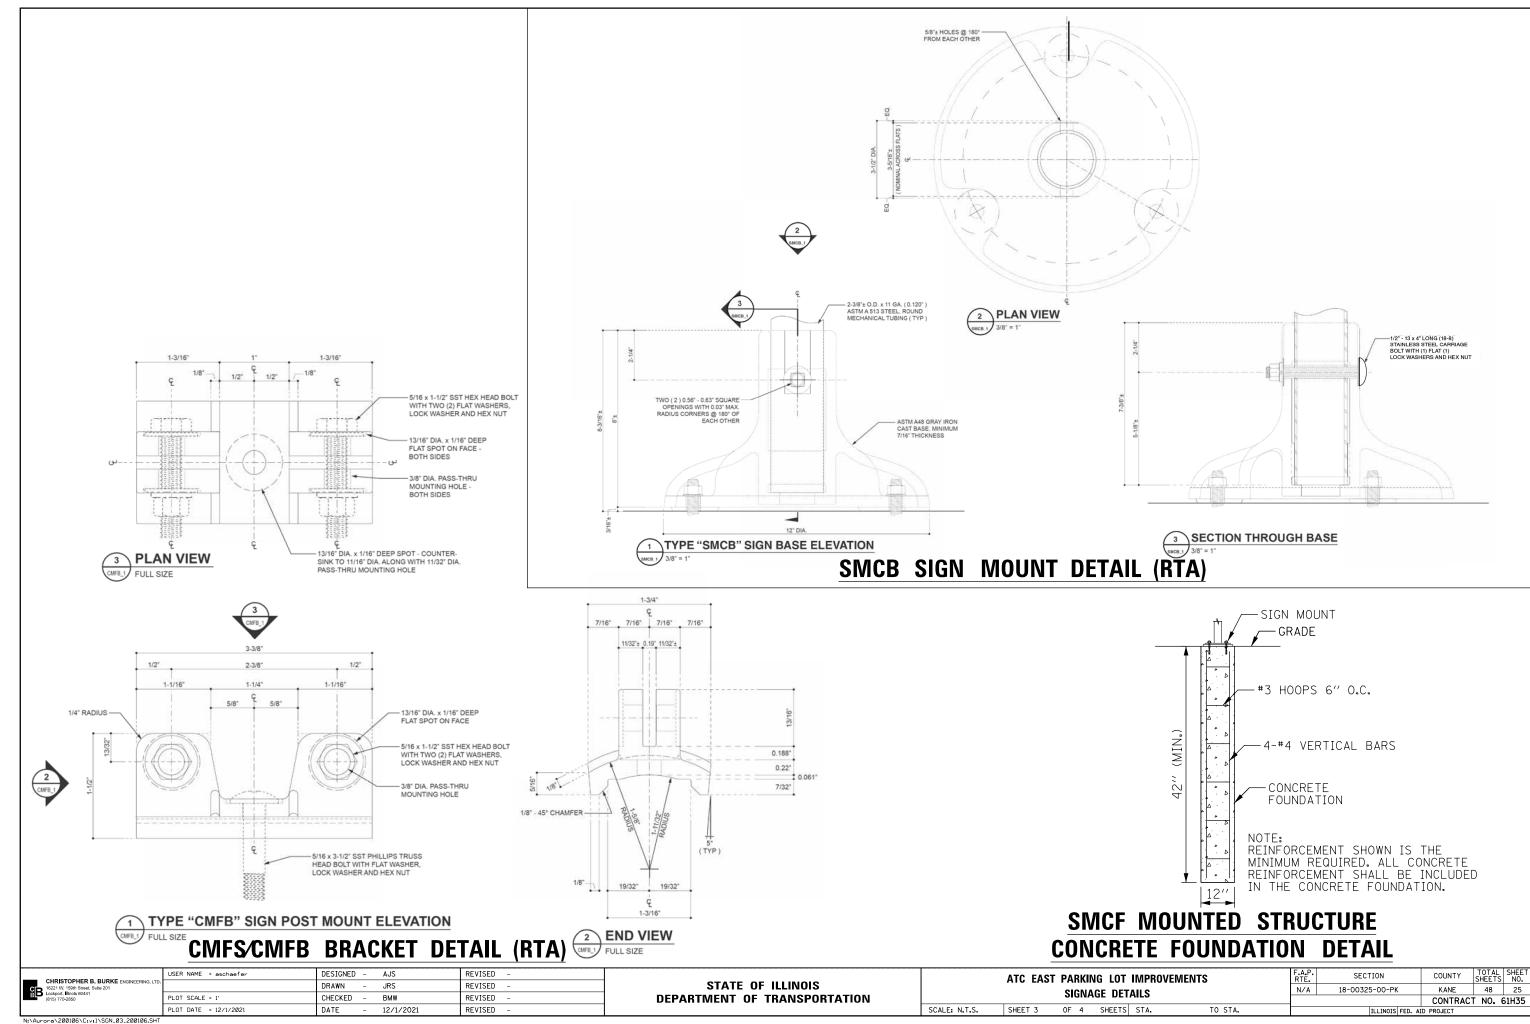

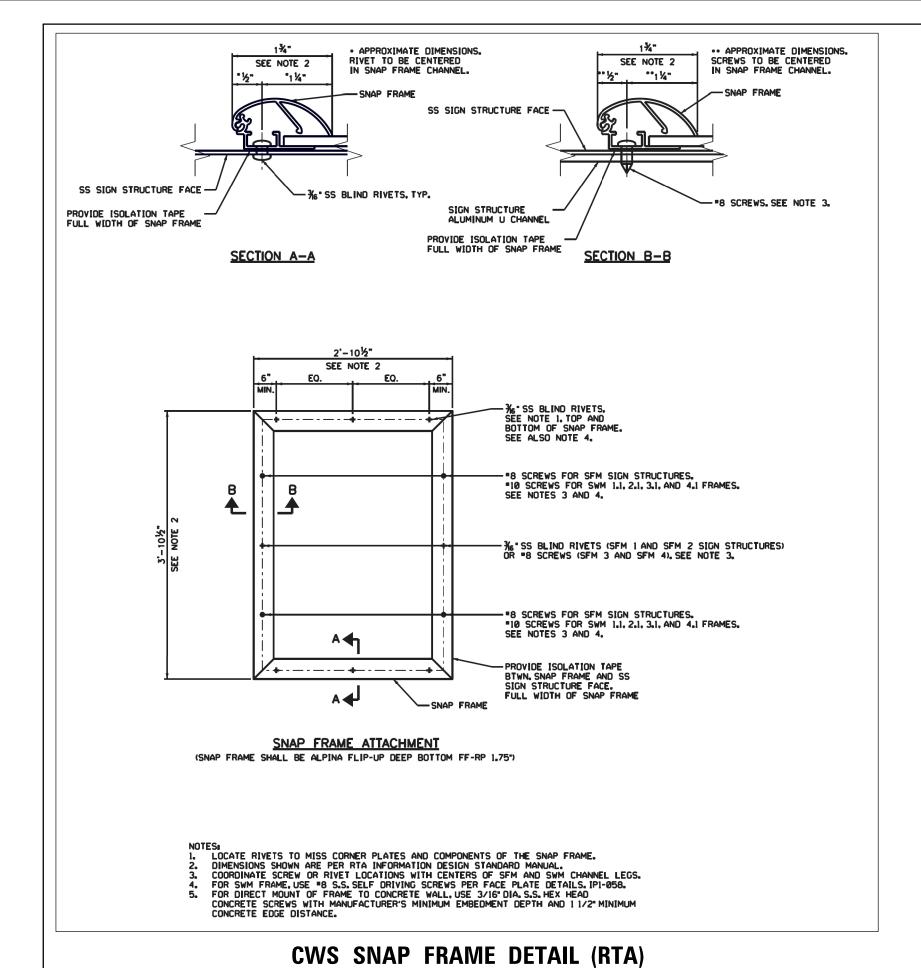


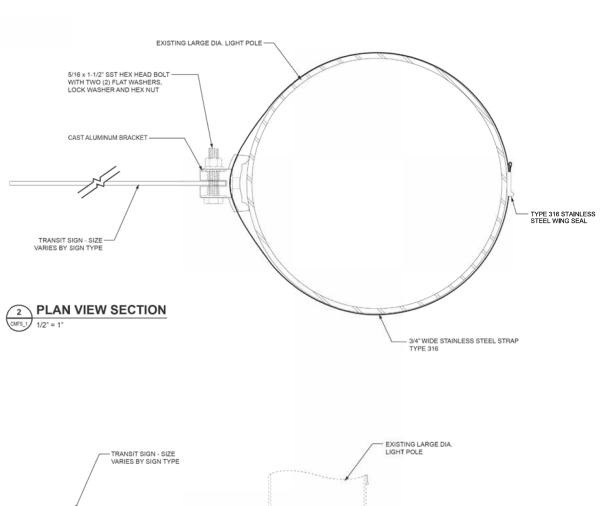


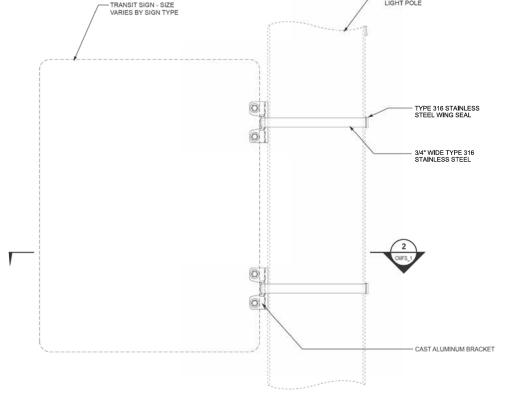


## CMFS MOUNT DETAIL (RTA)


	- CURIOTORIUS D. RURKS	USER NAME = aschaefer	ATC FAST PARKING IC		IG LOT IMPROV	/FMFNTS	F.A.P.	SECTION	COUNTY	TOTAL	SHEET					
	EB 16221 W. 199th Street, Suite 201 Lockport, Illinois 60441 (815) 770-2850		DRAWN -	JRS	REVISED -	STATE OF ILLINOIS DEPARTMENT OF TRANSPORTATION				LINENTO	N/A	18-00325-00-PK	KANE	48	26	
		PLOT SCALE = 1'	CHECKED -	ВМЖ	REVISED -		SIGNAGE DETAILS						CONTRAC	CONTRACT NO. 611		
ı		PLOT DATE = 12/1/2021	DATE -	12/1/2021	REVISED -		SCALE: N.T.S.	SHEET 4	0F 4	SHEETS STA.	TO STA.	1	TILL INDIS FED. /	ID PROJECT		

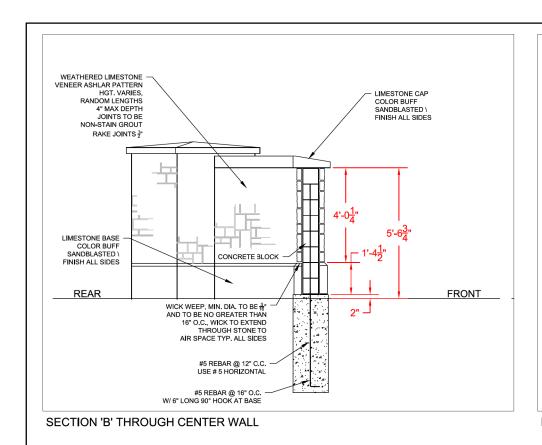

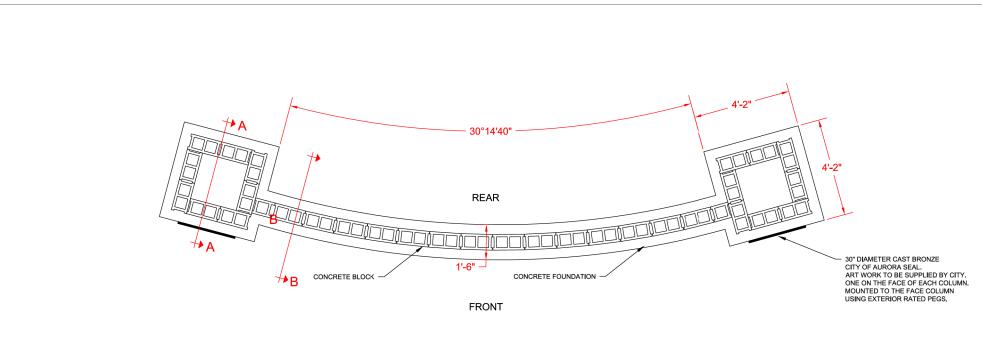

PLAN VIEW

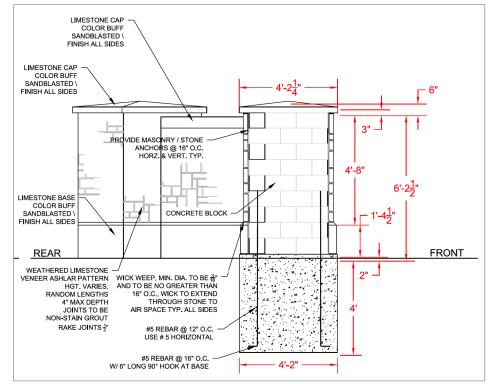


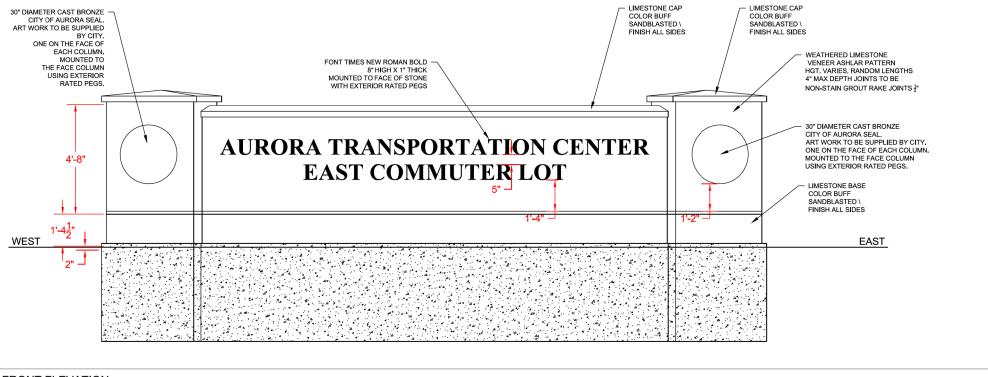


SECTION 'A' THROUGH WEST END COLUMN

FRONT ELEVATION


CHDISTORIED B. BLIDKE SHOWS SHOW	USER NAME = aschaefer	DESIGNED - AJS	REVISED -		Δ	ATC EAST PARKING LOT IMPROVEMENTS	F.A.P.	SECTION	COUNTY	TOTAL :	SHEET NO.
CHRISTOPHER B. BURKE ENGINEERING, LID 16221 W. 159th Street, Suite 201 Lockport. Illinois 60441		DRAWN - JRS	REVISED -	STATE OF ILLINOIS DEPARTMENT OF TRANSPORTATION  SCAL	GATEWAY MONUMENT SIGN DETAILS			18-00325-00-PK	KANE	48	27
(815) 770-2850	PLOT SCALE = 1'	CHECKED - BMW	REVISED -						CONTRACT	T NO. 6	1H35
	PLOT DATE = 12/1/2021	DATE - 12/1/2021	REVISED -		SCALE: N.T.S. S	SHEET 1 OF 2 SHEETS STA. TO STA.		ILLINOIS FED. AI	D PROJECT		

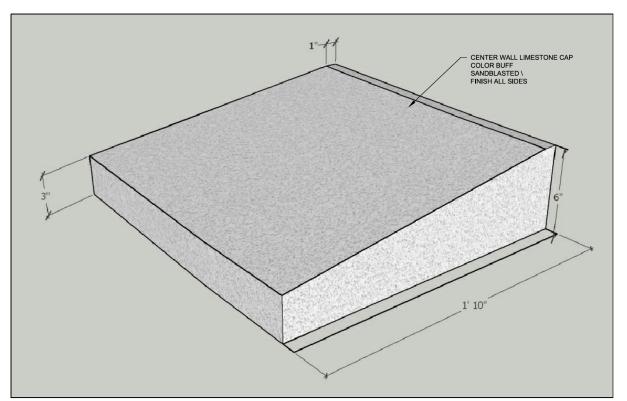


**CENTER WALL CAP** 

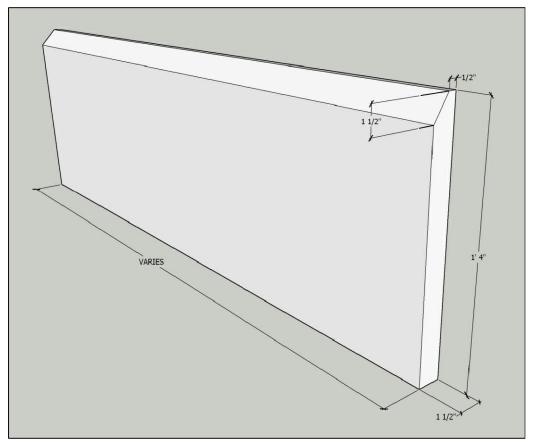


LIMESTONE BASE

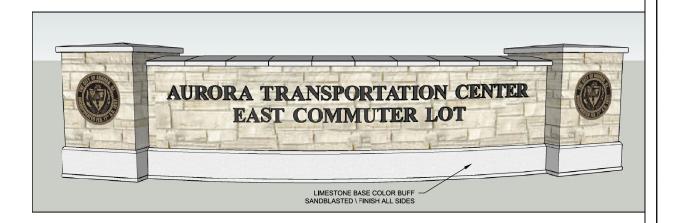

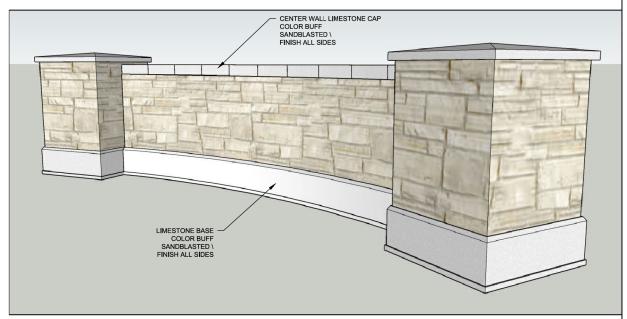

**REAR VIEW** 

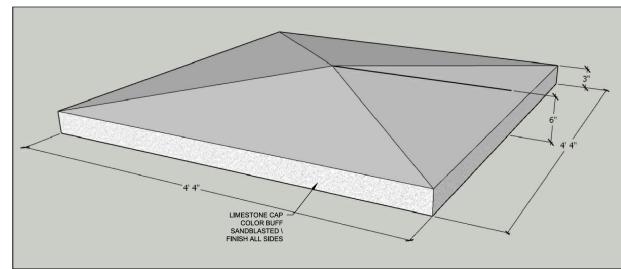

END COLUMN CAP

SCALE: N.T.S.

ı		CURICTORUED B. BURKE	L
ı	GВ	CHRISTOPHER B. BURKE ENGINEERING, LTD. 16221 W. 159th Street, Suite 201	l
l	ВО	Lockport, Illinois 60441 (815) 770-2850	

	USER NAME = aschaefer	DESIGNED	-	AJS	REVISED -
D.		DRAWN	-	JRS	REVISED -
	PLOT SCALE = 1'	CHECKED	-	BMW	REVISED -
-	PLOT DATE = 12/1/2021	DATE	-	12/1/2021	REVISED -

STATE OF ILLINOIS
DEPARTMENT OF TRANSPORTATION

ATC EAST PARKING LOT IMPROVEMENTS	F.A.P. RTE.	SECTION	COUNTY	TOTAL SHEETS	SHEET NO.	
GATEWAY MONUMENT SIGN DETAILS	N/A	18-00325-00-PK	KANE	48	28	
GATEVAT MONOWENT SIGN DETAILS			CONTRAC	T NO. 6	S1H35	
SHEET 2 OF 2 SHEETS STA. TO STA.		ILLINOIS FED. AID PROJECT				

### **GENERAL NOTES**

- ELECTRICAL CONTRACTOR SHALL BE RESPONSIBLE FOR OBTAINING A PERMIT FROM THE CITY OF AURORA BEFORE THE START OF WORK, ANY COST FOR PERMIT SHALL BE INCLUDED IN THE COST OF THE CONTRACT.
- 2. BEFORE INSTALLING LIGHT STANDARDS NEAR OVERHEAD AND UNDERGROUND ELECTRIC UTILITIES SHALL CALL COM ED FOR LOCATION APPROVAL AND MINIMUM CLEARANCE REQUIREMENTS.
- 3. THE WORK PERFORMED UNDER THIS CONTRACT SHALL IN NO WAY INTERFERE WITH THE NORMAL OPERATION OF ANY EXISTING UTILITY SERVICE. THE CONTRACTOR SHALL FURNISH ALL NECESSARY ITEMS OF EQUIPMENT REQUIRED TO MAINTAIN SUCH NORMAL OPERATION AT NO ADDITIONAL COST TO THE OWNER. THE COST ASSOCIATED FOR THIS WORK SHALL BE CONSIDERED INCLUDED IN THE COST OF THE CONTRACT, AND NO ADDITIONAL COMPENSATION SHALL BE AWARDED.
- 4. ALL REMOVAL OR EXCAVATION ITEMS BEING DISPOSED OF AT AN UNCONTAMINATED SOIL FILL OPERATION OR CLEAN CONSTRUCTION AND DEMOLITION DEBRIS (CCDD) FILL SITE SHALL MEET THE REQUIREMENTS OF PUBLIC ACT 96-1416. ALL COSTS ASSOCIATED WITH MEETING THESE REQUIREMENTS SHALL BE INCLUDED IN THE UNIT PRICE COST FOR THE ASSOCIATED REMOVAL OR EXCAVATION ITEMS IN THE CONTRACT. THESE COSTS SHALL INCLUDE BUT ARE NOT LIMITED TO ALL REQUIRED TESTING, LAB ANALYSIS. CERTIFICATION BY A LICENSED PROFESSIONAL OWNER'S REPRESENTATIVE. AND STATE AND LOCAL TIPPING FEE.
- 5. THE CONTRACTOR SHALL BE SOLELY RESPONSIBLE FOR JOB SITE SAFETY AS WELL AS SUPERVISION/DIRECTION AND MEANS/METHODS OF CONSTRUCTION.
- 6. ALL WORK SHALL BE IN ACCORDANCE WITH THE LATEST EDITIONS OF THE FOLLOWING SPECIFICATIONS, WHICH ARE HEREBY MADE A PART HEREOF:
  - A. "STANDARD SPECIFICATIONS FOR ROAD AND BRIDGE CONSTRUCTION", AS PREPARED BY IDOT.
  - B. "THE NATIONAL ELECTRICAL CODE".
  - C. MUNICIPAL CODES & STANDARDS.
- 7. NO MATERIALS SHALL BE DELIVERED TO THE JOB SITE UNTIL ALL PERTINENT EQUIPMENT SUBMITTALS HAVE BEEN REVIEWED BY THE ENGINEER.
- 8. CAST A GROUND ROD INSIDE EVERY CONCRETE POLE FOUNDATION AND CONNECT TO THE POLE GROUNDING LUG VIA A \*6 COPPER WIRE WITH A MECHANICAL CONNECTION AT THE GROUND ROD AND PIGTAIL SPLICE INSIDE THE POLE HANDHOLE.
- 9. ALL UNDERGROUND WIRING SHALL BE COPPER (OR SIZE AS SHOWN ON THE PLANS) XLP TYPE-USE, EXTRA ABRASION RESISTANCE, 600 VOLTS, INSTALLED IN SCH 40 HDPE CONDUIT A MINIMUM 30 INCHES BELOW FINISHED GRADE, FOLLOWING THE ROADWAY OR SIDEWALK EDGE.
- 10. TO MAINTAIN THE STRUCTURAL INTEGRITY OF LIGHT POLES WITH LUMINAIRE ARMS, THEY SHALL NOT BE ERECTED AND LEFT TO STAND WITHOUT LUMINAIRES.
- 11. ALL POLE HANDHOLES SHALL FACE AWAY FROM TRAFFIC.
- 12. THE ELECTRICAL CONTRACTOR SHALL FURNISH TWO SETS OF FULL SIZE RECORD DRAWINGS TO THE OWNER'S REPRESENTATIVE UPON COMPLETION OF THE LIGHTING AND ELECTRICAL IMPROVEMENTS. THE DRAWINGS SHALL SHOW THE INSTALLED LOCATIONS OF ALL LIGHT POLES, UNDERGROUND CONDUITS/WIRING, HANDHOLES, JUNCTION BOXES & CONTROLLER CABINETS. THE DRAWINGS WILL BE REVIEWED BY THE FINGINFER
- 13. UPON COMPLETION OF THE PROPOSED LIGHTING IMPROVEMENTS, THE CONTRACTOR SHALL PERFORM ELECTRICAL TESTING AND VERIFY THAT THE INSTALLATION COMPLIES WITH THE LATEST EDITION OF THE STANDARD SPECIFICATIONS FOR ROAD AND BRIDGE CONSTRUCTION IN ILLINOIS, ALL ELECTRICAL TESTING SHALL BE PERFORMED IN THE PRESENCE OF THE ENGINEER AND THE VILLAGE.
- 14. BACKFILL MATERIAL FOR TRENCHES IN THE SUBGRADE OF THE PROPOSED IMPROVEMENT, AND FOR TRENCHES OUTSIDE OF THE SUBGRADE WHERE THE INNER EDGE OF THE TRENCH IS WITHIN 2 FT OF THE EDGE OF THE PAVEMENT, CURB, GUTTER, CURB AND GUTTER, STABILIZED SHOULDER, OR SIDEWALK SHALL BE TRENCH BACKFILL.
- 15. THE CONTRACTOR SHALL BE RESPONSIBLE FOR THE ESTABLISHMENT OF FINISHED GRADE. THE RESIDENT ENGINEER MAY ASSIST THE CONTRACTOR, AS APPLICABLE, BUT THE RESPONSIBILITY FOR COORDINATING THE FINISHED GRADE ELEVATION WITH THE TOP OF THE FOUNDATION HEIGHT AND THE LIGHT SHALL REMAIN WITH THE CONTRACTOR.
- 16. NO POLES SHALL BE ERECTED UNTIL THE RESPECTIVE FOUNDATIONS HAVE CURED, (IF APPLICABLE) AND HAVE BEEN REVIEWED BY THE ENGINEER.
- 17. THE CONTRACTOR SHALL MAKE SPECIAL NOTE OF THE REQUIREMENTS FOR WIRE MARKERS AND SHALL TAG ALL WIRE MARKERS AND SHALL TAG ALL WIRE ACCORDINGLY.
- 18. EQUIPMENT GROUND CONDUCTORS SHALL BE SPLICED AND BONDED AT EACH LIGHT POLE OR OTHER PIECE OF EQUIPMENT.
- 19. CONDUIT MUST BE POSITIONED IN THE FIELD TO AVOID CONFLICT WITH TREES, BUSHES, DRAINS AND OTHER UTILITIES AND LANDSCAPING.
- 20. IT SHALL BE THE CONTRACTOR'S RESPONSIBILITY TO MARK THE PROPOSED LOCATIONS OF ALL LIGHT POLES AND LIGHTING CONTROLLERS FOR EXAMINATION AND CONFIRMATION WITH THE RESIDENT ENGINEER AT THE PRECONSTRUCTION INSPECTION. THE CONTRACTOR SHALL VERIFY ALL UTILITY LOCATIONS PRIOR TO AUGERING FOR LIGHT POLE FOUNDATIONS. THE EXACT LOCATIONS OF ALL ITEMS SHALL BE CONFIRMED WITH THE RESIDENT ENGINEER PRIOR TO STARTING WORK.
- 21. THE CONTRACTOR SHALL BE RESPONSIBLE FOR TIMELY NOTIFICATION AND ALL COORDINATION WITH COM ED FOR NEW ELECTRIC SERVICE TO THE PROPOSED LIGHTING CONTROLLERS. THE ELECTRIC SERVICE COORDINATION PERFORMED BY THE ENGINEER DURING DESIGN IS INCLUDED IN THE PLANS FOR THE CONTRACTORS INFORMATION.
- 22. THE LIGHT POLE LOCATIONS SHALL COMPLY WITH THE MINIMUM CLEAR WIDTH FOR AN ACCESSIBLE ROUTE FOR SIDEWALKS PER CURRENT AMERICAN WITH DISABILITIES ACT (ADA) REQUIREMENTS.

### LIGHTING BILL OF MATERIALS

	DESCRIPTION	<u>UNIT</u>	QUANTITY
	TRENCH BACKFILL	CU YD	1
	ELECTRIC SERVICE INSTALLATION	EACH	1
*	ELECTRIC UTILITY SERVICE CONNECTION	LSUM	1
	UNDERGROUND CONDUIT, GALVANIZED STEEL, 1 1/2" DIA.	FOOT	145
	UNDERGROUND CONDUIT,PVC, 1 1/4" DIA.	FOOT	155
	UNDERGROUND CONDUIT, PVC, 1 1/2" DIA.	F00T	145
	UNDERGROUND CONDUIT, PVC, 2" DIA.	F00T	645
	HANDHOLE, COMPOSITE CONCRETE	EACH	3
	ELECTRIC CABLE IN CONDUIT, 600V (XLP-TYPE USE) 1/C NO. 14	F00T	1885
	ELECTRIC CABLE IN CONDUIT, 600V (XLP-TYPE USE) 1/C NO. 10	FOOT	3135
	ELECTRIC CABLE IN CONDUIT, 600V (XLP-TYPE USE) 1/C NO. 6	F00T	410
	ELECTRIC CABLE IN CONDUIT, 600V (XLP-TYPE USE) 1/C NO. 4	FOOT	690
	ELECTRIC CABLE IN CONDUIT, 600V (XLP-TYPE USE) 1/C NO. 2	F00T	640
	LIGHTING CONTROLLER, PEDESTAL MOUNTED, 240VOLT, 60AMP	EACH	1
	LIGHT POLE FOUNDATION, 30" DIAMETER	FOOT	10
	REMOVAL OF LIGHTING UNIT, SALVAGE	EACH	18
	REMOVAL OF POLE FOUNDATION	EACH	1
•	SIGN LIGHTING UNIT COMPLETE	EACH	3
*	REMOVE EXISTING CABLE	F00T	275
*	MISCELLANEOUS ELECTRICAL WORK	LSUM	1
*	LUMINAIRE REPLACEMENT SPECIAL	EACH	12
*	LIGHTING UNIT COMPLETE, SPECIAL	EACH	18
	MODIFY EXISTING CABINET EQUIPMENT AND APPURTENANCES	EACH	1
•	MAINTENANCE OF LIGHTING SYSTEM	CAL MO	6
	* SEE SPECIAL PROVISION		

### **ABBREVIATIONS**


Α	AMPS	HPS	HIGH PRESSURE SODIUM					
CKT	CIRCUIT	PVC	POLYVINYL CHLORIDE					
CNC	COILABLE NON-METALLIC CONDUIT	RGS	RIGID GALVANIZED STEEL CONDUIT					
DIA	DIAMETER	ROW	RIGHT OF WAY					
FT	FOOT	SS	STAINLESS STEEL					
FOC	FACE OF CURB	STA	STATION					
GFCI	GROUND FAULT CIRCUIT INTERRUPTER	V	VOLTS					
		W	WATTS WEATHER RESISTANT					
GND	GROUND	WR						
HDPE	HIGH DENSITY POLYETHYLENE							
нн	HAND HOLE							


STATE OF ILLINOIS
DEPARTMENT OF TRANSPORTATION


SCALE: N.T.S.


ATC EAST PARKING LOT IMPROVEMENTS
LIGHTING GENERAL NOTES & BILL OF MATERIALS


SHEET OF SHEETS STA. TO STA.

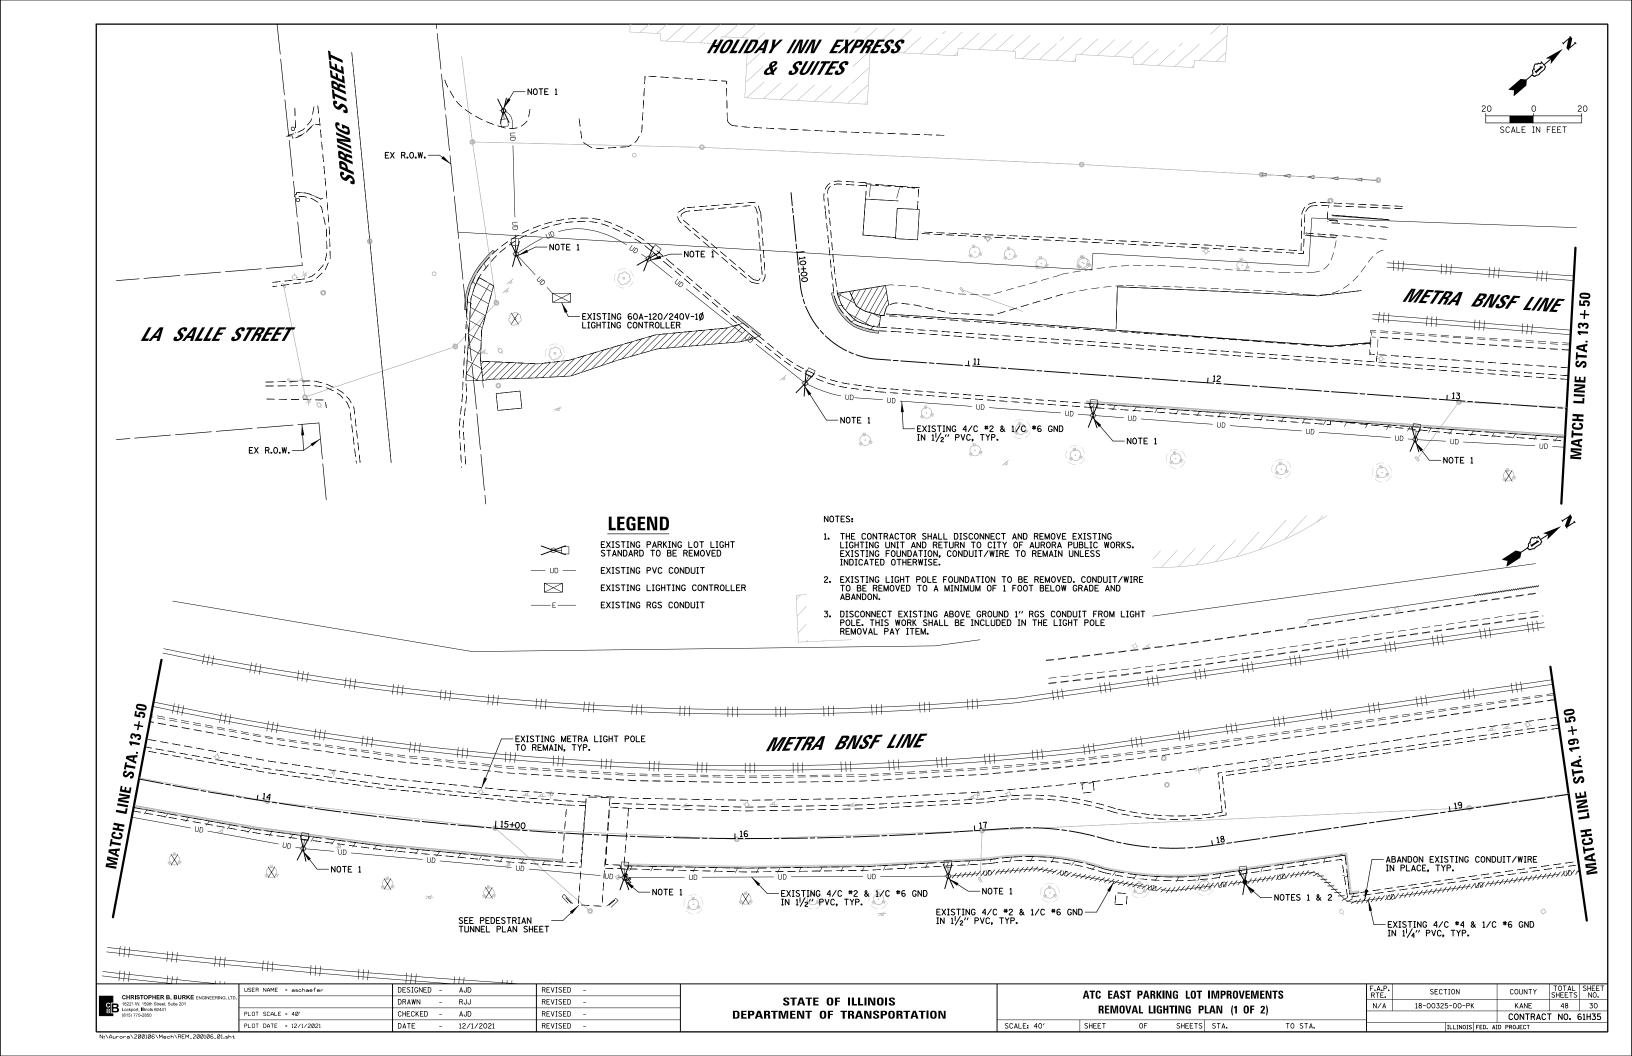

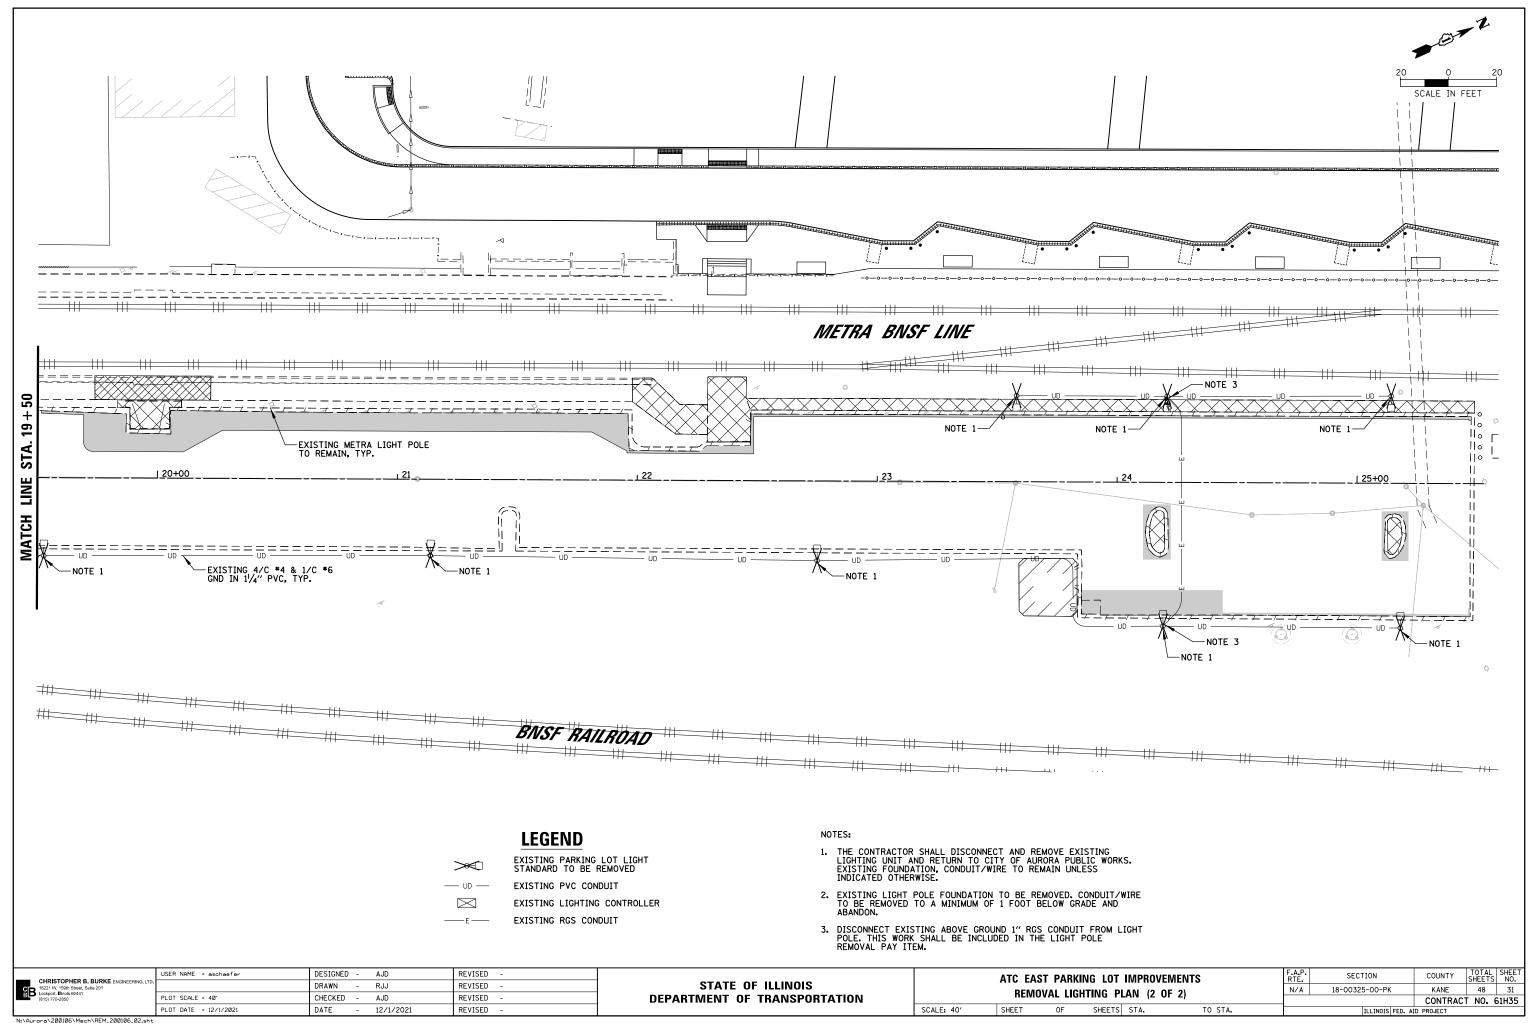


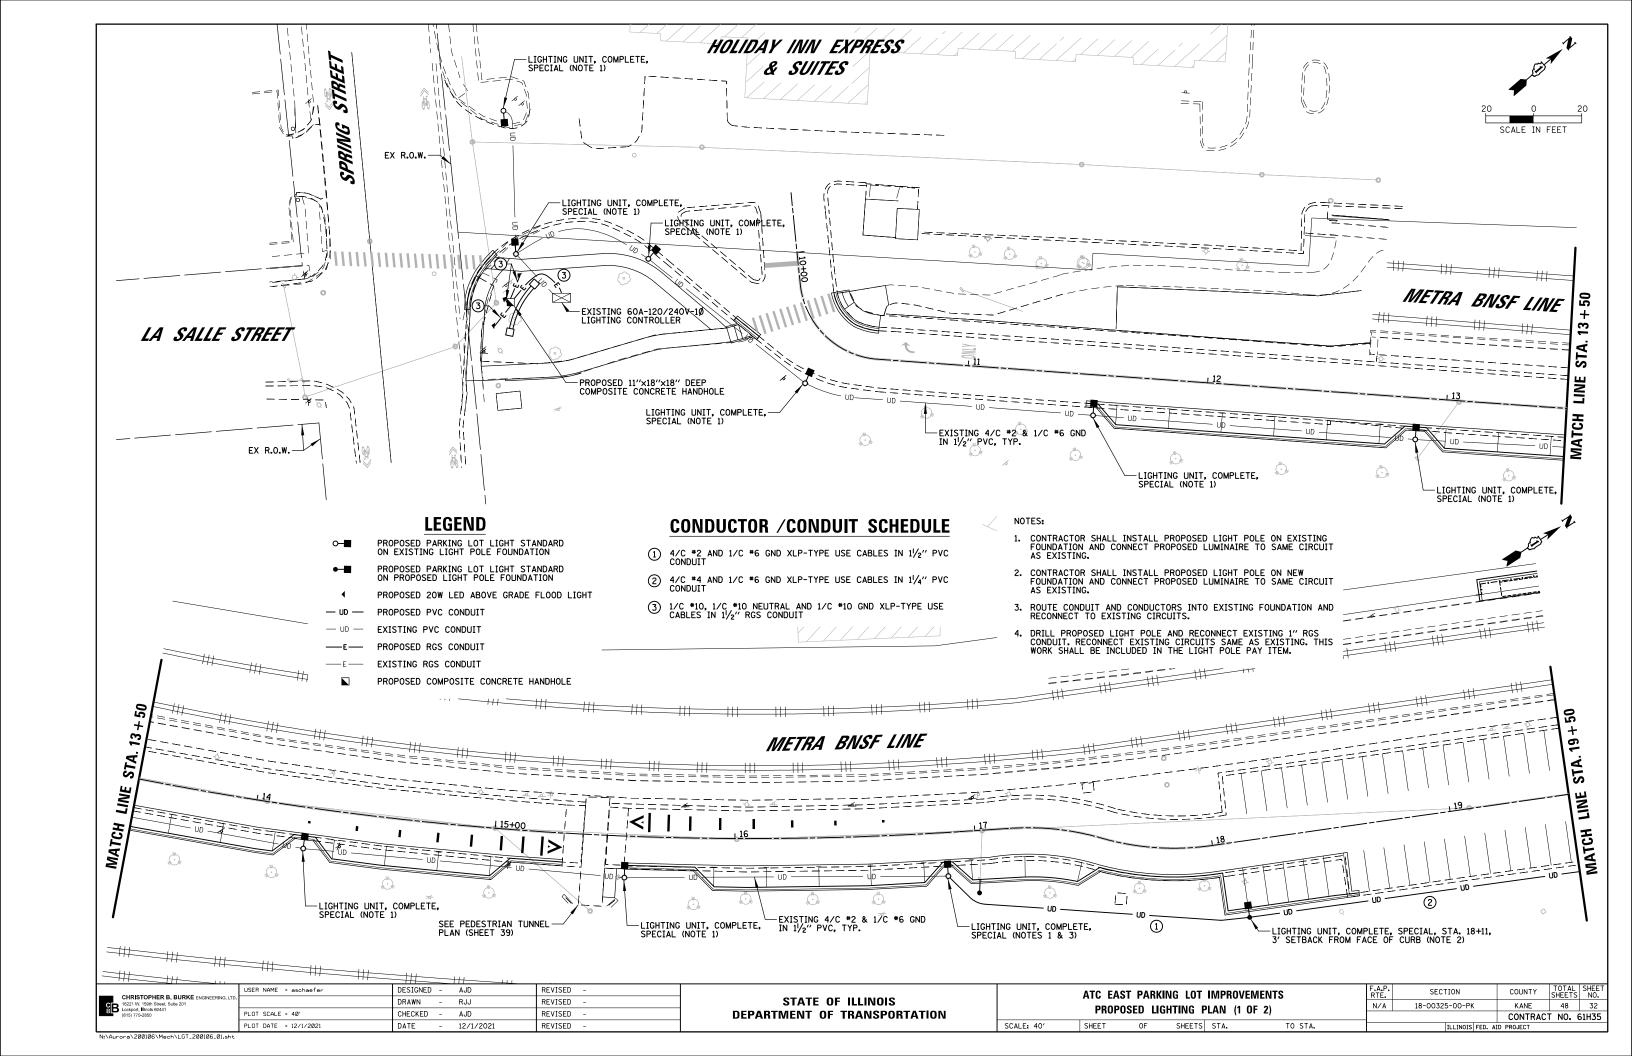

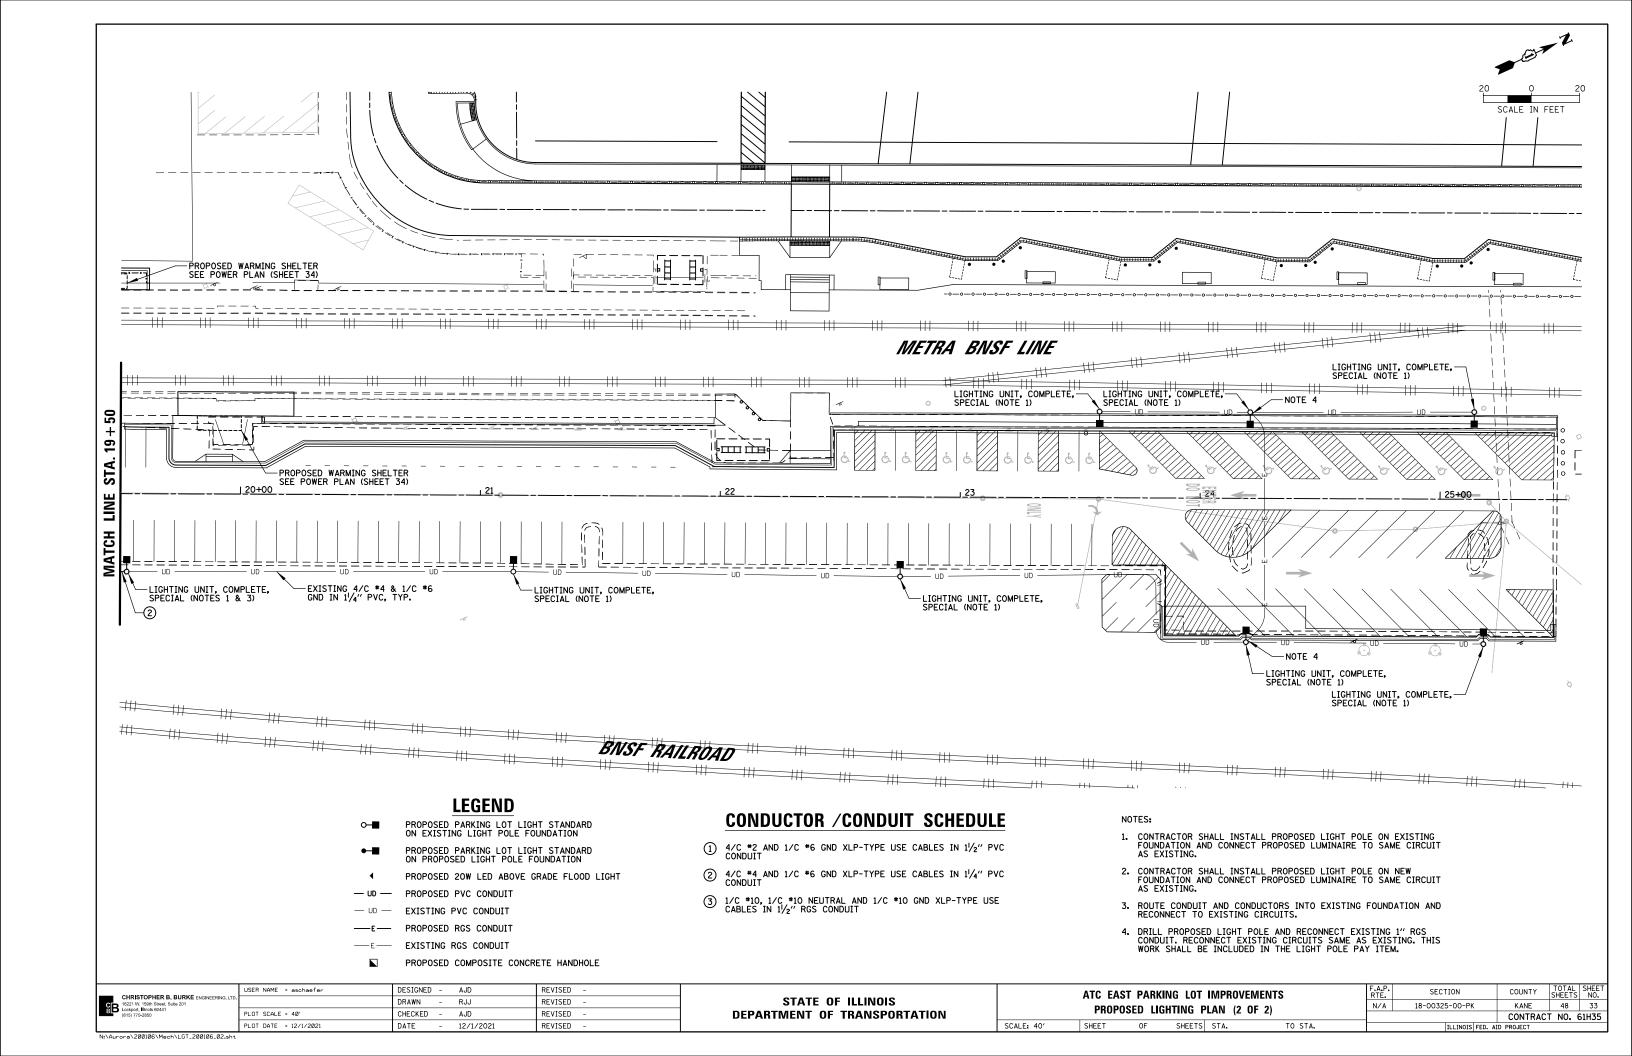

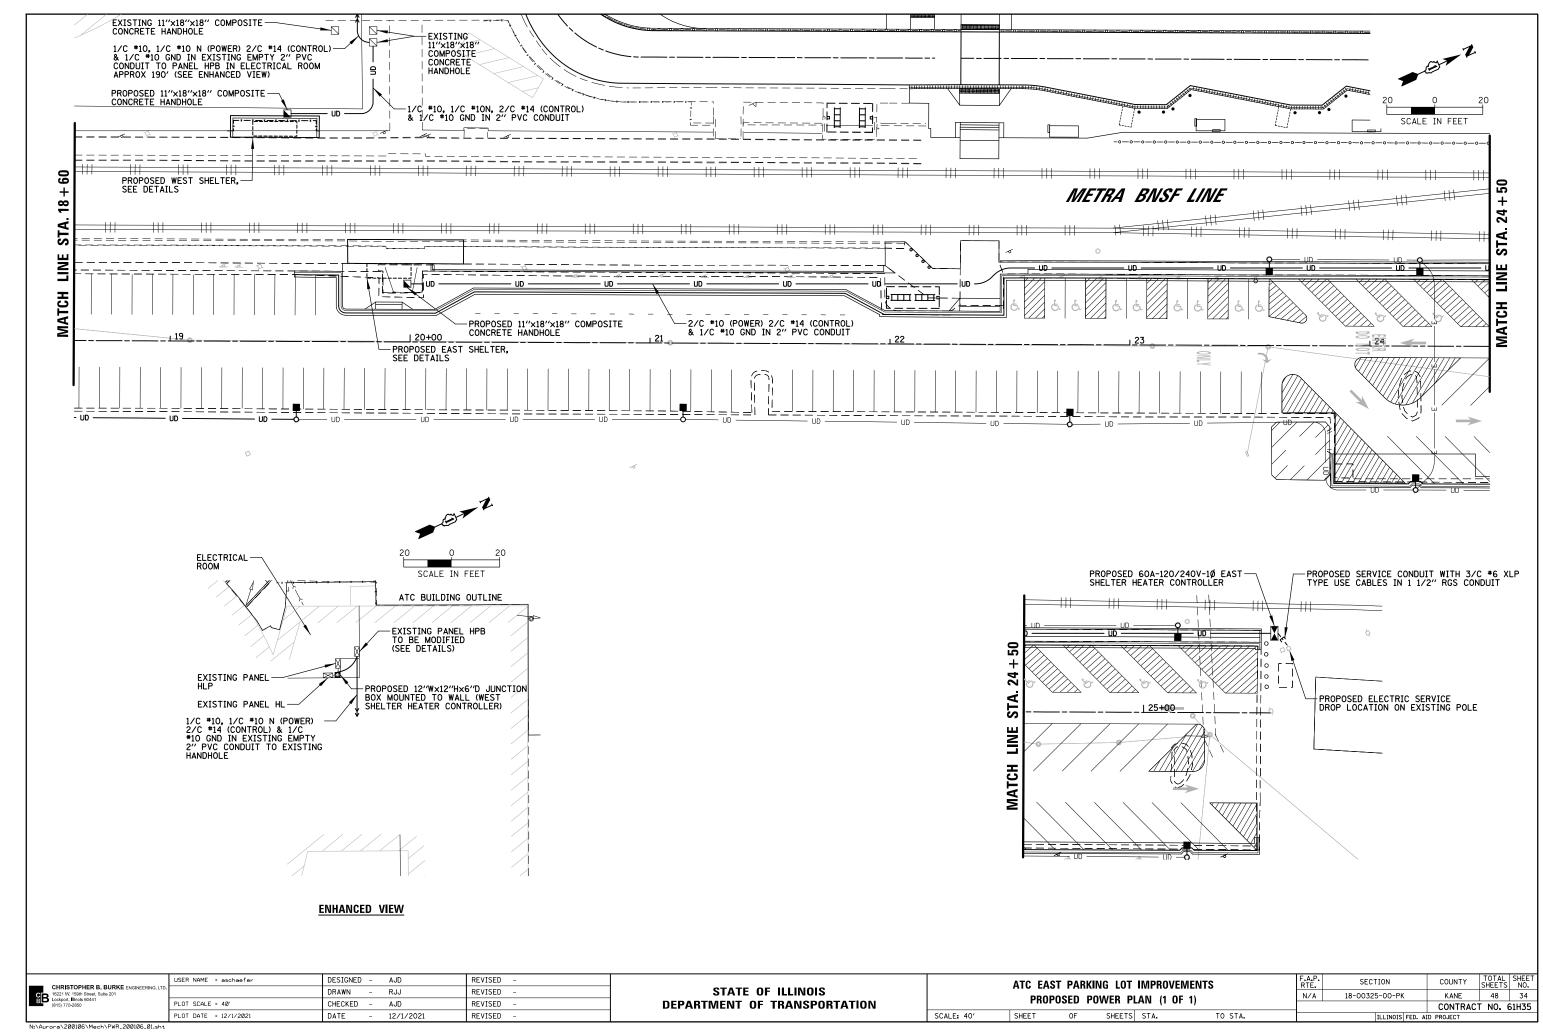


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ITEM	SPECIFICATION
1 MAIN CIRCUIT BREAKER	60 AMPERE, 2P, 240V SERVICE RATING, 10KAIC
2 LAMPHOLDER CIRCUIT BREAKER	20 AMPERE, 1P, 120V RATING, 10KAIC
3 CONTROL CIRCUIT BREAKER	15 AMPERE, 1P, 120V RATING, 10KAIC
4 CONTACTOR CIRCUIT BREAKER	30 AMPERE, 2P, 120V RATING, 10KAIC
5 TIME DELAY RELAY	15 AMPERE, 120 V OPERATED, ELECTRONIC, TIME DELAY OFF, 0.1-10 MIN ADJUSTABLE, DPDT, 2 NO & 2 NC CONTACTS, PLUG-IN FINGER SAFE SOCKET, PANEL MOUNTED
6 CABINET RECEPTACLE AND BOX	COMMERCIAL GRADE GFCI 20A/120V, MOUNTED IN A WEATHERPROOF CAST ALUMINUM SINGLE GANG BOX WITH WEATHERPROOF COVER
7 CABINET LIGHT	5 WATT LED STRIP LIGHT, 60K HOUR RATING, 65K COLOR TEMPERATURE, DOOR SWITCH CONTROLLED, FASTENED TO TOP OF CABINET
8 CONTACTOR	30 AMPERE, 2P, 120V COIL, MECHANICALLY HELD
POWER DISTRIBUTION BLOCK	600 VOLT, INSULATED, SIZE AS REQ'D, 10KAIC
10 SERVICE CABLES	3-600V (XLP-TYPE USE) NO. #6
11 LAMPHOLDER WIRE	2-600V XLP NO. 12
12 CONTROL WIRE	2-600V XLP NO. 12
(13) SURGE ARRESTOR	10 K AMPERE RATING
14 TERMINAL BLOCK	2 TERMINAL, SCREW TYPE, MAX. #10 WIRE SIZE
15 DOOR SWITCH	20A/120V, DOOR MTD SNAP ACTION PLUNGER
(16) HAND-AUTO-OFF CONTROL SWITCH	20A, 3 POS. MTD IN CAST ALUM. ENCLOSURE

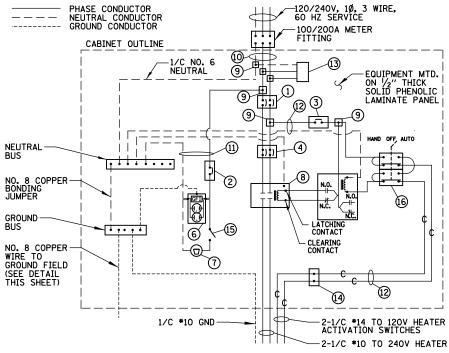

#### NOTES


- 1. ALL ITEMS SHOWN ABOVE SHALL BE INCLUDED IN THE PRICE BID FOR "LIGHTING CONTROLLER, PEDESTAL MOUNTED, 240VOLT, 60AMP" INCLUDING CABINET AND FOUNDATION. UNDERGROUND CONDUIT AND WIRING PAID FOR SEPARATELY.
- 2. THE LIGHTING CONTROLLER TOGETHER WITH ALL OF ITS COMPONENTS SHALL BE UL LISTED AS AN "ENCLOSED INDUSTRIAL CONTROL PANEL" UNDER UL508A.
- 3. CONNECTION OF SURGE ARRESTOR TO LINE SIDE OF MAIN CIRCUIT BREAKER SHALL NOT BE "DOUBLE LUGGED."
- 4. THE MAIN CIRCUIT BREAKER SHALL BE LABELED "SERVICE DISCONNECT".
- 5. ALL SWITCHES AND CONTROLS SHALL BE IDENTIFIED USING TWO COLOR ENGRAVED NAMEPLATES.
- 6. THE PANEL MANUFACTURER SHALL LABEL THE CABINET WITH THE APPROPRIATE ARC FLASH WARNING AND PERSONNEL PROTECTION EQUIPMENT REQUIRED FOR SERVICING.
- 7. ALL EXPOSED BUS BARS SHALL BE INSULATED, AND ALL WIRING SHALL BE COPPER.
- 8. ALL GROUND CONDUCTORS SHALL BE GREEN AND NEUTRAL CONDUCTORS SHALL BE WHITE, PHASE CONDUCTORS SHALL BE COLOR CODED IN ACCORDANCE WITH SECTION 1066.02 OF THE STANDARD SPECIFICATIONS. CONTRACTOR SHALL ONLY USE SOLID COLOR CODED INSULATIONS. COLOR STRIPPING OF PHASE CONDUCTORS SHALL NOT BE ALLOWED.

## EAST SHELTER HEATER CONTROLLER COMPONENT SCHEDULE AND WIRING DIAGRAM

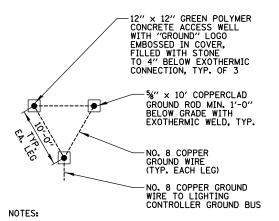

1. ITEMS SHOWN ABOVE SHALL BE INCLUDED IN THE LIGHTING CONTROLLER PAY ITEM.

## **GROUND FIELD DETAIL (TYP.)**

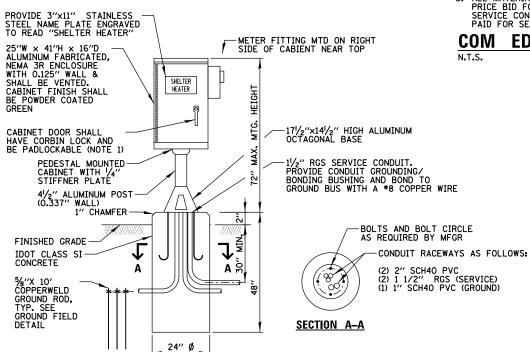

SCALE: N.T.S.

#### NOTES:

- ALL ITEMS SHOWN ABOVE INCLUDING CABINET, CONCRETE FOUNDATION SHALL BE INCLUDED IN THE LIGHTING CONTROLLER PAY ITEM, EXCEPT FOR THE HORIZONTAL PORTION OF SERVICE CONDUIT & WIRE WHICH SHALL BE PAID SEPARATELY.
- 2. A 30"Wx24"Dx5" THICK CONCRETE WORK PAD SHALL BE PROVIDED IN FRONT OF THE CABINET. TOP OF PAD SHALL BE 1" ABOVE GRADE AND HAVE A \( \frac{7}{4}\)" CHAMFER ALL AROUND.
- 3. ALL EXTERIOR CABINET HARDWARE SHALL BE STAINLEES STEEL.

# EAST SHELTER HEATER CONTROLLER CABINET AND FOUNDATION

Ì		USER NAME = aschaefer	DESIGNED	-	AJD	REVISED -	
١	CHRISTOPHER B. BURKE ENGINEERING, LTD. 16221 W. 159th Street, Suite 201		DRAWN	-	RJJ	REVISED -	
١	I	PLOT SCALE = 40'	CHECKED	-	AJD	REVISED -	
- 1		PLOT DATE = 12/1/2021	DATE	-	12/1/2021	REVISED -	

STATE OF ILLINOIS
DEPARTMENT OF TRANSPORTATION

N.T.S.

ATC EAST PARKING LOT IMPROVEMENTS LIGHTING DETAILS (1 OF 6)						F.A.P. RTE.	SECTION	COUNTY	TOTAL SHEETS	SHEET NO.
						N/A	18-00325-00-PK	KANE	48	35
		LIGITING	DLIAILS	(1 01	0)			CONTRAC	T NO.	61H35
	SHEET	0F	SHEETS	STA.	TO STA.		D PROJECT			

### EXISTING COM ED WOOD UTILITY POLE NON-METALLIC U-GAURD CONTRACTOR TO INSTALL SUFFICIENT CABLE SLACK TO REACH COM ED SECONDARY/TRANSFORMER FURNISHED BY CONTRACTOR INSTALLED BY WITHOUT SPLICING COM ED (NOTE 2 COM ED TO INSTALL FROM 10 FT. ABOVE FURNISHED & INSTALLED CONTRACTOR GRADE AND UP 10'-1 1/2" GALV. CONDUIT 2 HOLE STRAPS, AS REQUIRED GRADE LINE -2" RIGID GLAVANIZED STEEL (RGS) ELBOW 1 1/2" RGS CONDUIT WITH— 3/C \*6 XLP-TYPE USE CABLES TO EAST SHELTER %"x10" COPPERWELD GROUND ROD W/ \*4 AWG BARE COPPER GROUND WIRE ATTACHED W/ CLAMPS, LISTED FOR DIRECT BURIAL SERVICE HEATER CONTROLLER CABINET

#### NOTES:

- 1. ALL WORK SHALL CONFORM TO COM ED'S BOOK OF "INFORMATION AND REQUIREMENTS FOR THE SUPPLY OF ELECTRIC SERVICE."
- 2. CONTRACTOR SHALL PROVIDE CONDUIT BUSHING AND SEALING COMPOUND AT TOP OF RISER.
- 3. ALL MATERIAL ABOVE (EXCEPT FOR POLE) SHALL BE INCLUDED IN THE PRICE BID FOR "ELECTRIC SERVICE INSTALLATION". THE HORIZONTAL SERVICE CONDUIT AND WIRING FROM POLE TO CONTROLLER SHALL BE PAID FOR SEPERATELY.

### **COM ED OVERHEAD CONNECTION POLE**


ITEM	SPECIFICATION
1 HEATER CIRCUIT BREAKER	20 AMPERE, 1P, 277V RATING, 65KAIC
2 CONTROL TRANSFORMER	50VA, 277V TO 120V, 1P, OPEN TYPE, WITH INTEGRAL PRIMARY AND SECONDARY FUSING
3 TIME DELAY RELAY	15 AMPERE, 120 V OPERATED, ELECTRONIC, TIME DELAY OFF, 0.1-10 MIN ADJUSTABLE, DPDT, 2 NO & 2 NC CONTACTS, PLUG-IN FINGER SAFE SOCKET, PANEL MOUNTED
4 POWER RELAY	30 AMPERE, 1P, 120V COIL, ELECTRICALLY HELD
5 POWER DISTRIBUTION BLOCK	600 VOLT, INSULATED, SIZE AS REQ'D, 65KAIC
6 FEEDER CABLES	3-600V (XLP-TYPE USE) NO. #10
7 CONTROL WIRE	2-600V XLP NO. 14
TERMINAL BLOCK	2 TERMINAL, SCREW TYPE, MAX. *10 WIRE SIZE
9 HAND-AUTO-OFF CONTROL SWITCH	20A, 3 POS. MTD IN CAST ALUM. ENCLOSURE
(10) JUNCTION BOX	12"Wx12"Hx6"D, NEMA 1, HINGED, SURFACE MTD.
11) EXISTING PANELBOARD	PANEL HPB, 600A, 277/480V, 3P, SURFACE MTD.
(2) CONDUIT	1" EMT BETWEEN PANEL AND JUNCTION BOX


	NED
PANELBOARD HPB OUTLINE JUNCTION BOX OUTLINE	_
NOTE 1  NOTE 1	7

#### NOTES:

- 1. FURNISH AND INSTALL NEW CIRCUIT BREAKER IN EXISTING PANELBOARD HPB IN THE AURORA TRANSPORTATION CENTER ELECTRICAL ROOM. COORDINATE ALL WORK WITH THE CITY.
- 2. ALL ITEMS SHOWN ABOVE SHALL BE INCLUDED IN THE PRICE BID FOR "MODIFY EXISTING CABINET EQUIPMENT AND APPURTENANCES". THIS WORK INCLUDES WIRING/CONDUIT FROM PANELBOARD TO PROPOSED JUNCTION BOX. COORDINATE JUNCTION BOX LOCATION WITH THE CITY UNDERGROUND CONDUIT AND WIRING PAID FOR SEPARATELY.
- 3. ALL SWITCHES AND CONTROLS SHALL BE IDENTIFIED USING TWO COLOR ENGRAVED NAMEPLATES.
- 4. ALL EXPOSED BUS BARS SHALL BE INSULATED, AND ALL WIRING SHALL BE COPPER.
- 5. ALL GROUND CONDUCTORS SHALL BE GREEN AND NEUTRAL CONDUCTORS SHALL BE WHITE. PHASE CONDUCTORS SHALL BE COLOR CODED IN ACCORDANCE WITH SECTION 1066.02 OF THE STANDARD SPECIFICATIONS. CONTRACTOR SHALL ONLY USE SOLID COLOR CODED INSULATIONS. COLOR STRIPPING OF PHASE CONDUCTORS SHALL NOT BE ALLOWED.

# WEST SHELTER HEATER CONTROLLER COMPONENT SCHEDULE AND WIRING DIAGRAM

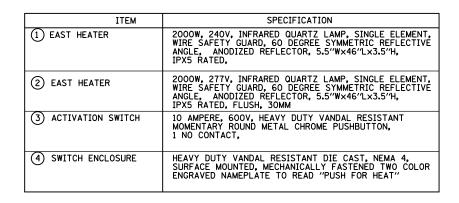

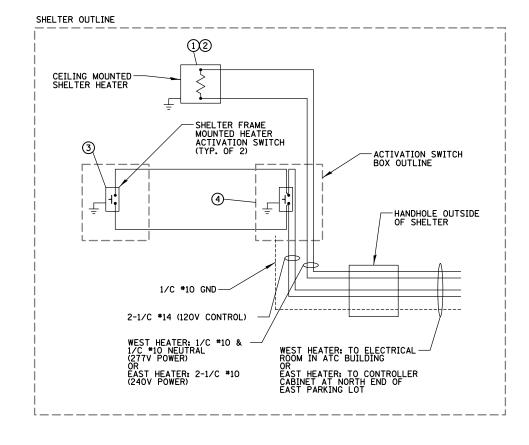



#### NOTES:

- 1. ALL ITEMS SHOWN ABOVE FOR BOTH SHELTERS SHALL BE INCLUDED IN THE PRICE BID FOR "MISCELLANEOUS ELECTRICAL WORK". SHELTER, HANDHOLE, WIRING AND UNDERGROUND CONDUIT FROM HANDHOLE TO CONTROLS (OR CONTROLLER) PAID FOR SEPARATELY.
- 2. SEE SHELTER ELECTRICAL DETAILS FOR MORE INFORMATION.
- 3. ALL GROUND CONDUCTORS SHALL BE GREEN AND NEUTRAL CONDUCTORS SHALL BE WHITE. PHASE CONDUCTORS SHALL BE COLOR CODED IN ACCORDANCE WITH SECTION 1066.02 OF THE STANDARD SPECIFICATIONS. CONTRACTOR SHALL ONLY USE SOLID COLOR CODED INSULATIONS. COLOR STRIPPING OF PHASE CONDUCTORS SHALL NOT BE ALLOWED.

## EAST AND WEST SHELTER HEATER COMPONENT SCHEDULE AND ACTIVATION SWITCH WIRING DIAGRAM

	USER NAME = aschaefer	DESIGNED -	AJD	REVISED -		ATC EAST PARKING LOT IMPROVEMENTS					F.A.P.	SECTION	COUNTY	TOTAL	SHEE	įΤ		
	CHRISTOPHER B. BURKE ENGINEERING, LTD. 16221 W. 159th Street, Suite 201	D.	DRAWN - RJJ		REVISED -						STATE OF ILLINOIS DEPARTMENT OF TRANSPORTATION	N/A	18-00325-00-PK	KANE	48	36	<u>,</u> —'	
ELD Lockport, Illinois 60441 (815) 770-2850	PLOT SCALE = 40'	CHECKED -	AJD	REVISED -	LIGHTING DETAILS (2 OF 6)					CONTRACT NO			T NO.	61H35				
		PLOT DATE = 12/1/2021	DATE - :	12/1/2021	REVISED -		SCALE: N.T.S.	SHEET	OF	SHEETS	STA.	TO STA.		ILLINOIS FED. A	ID PROJECT			_

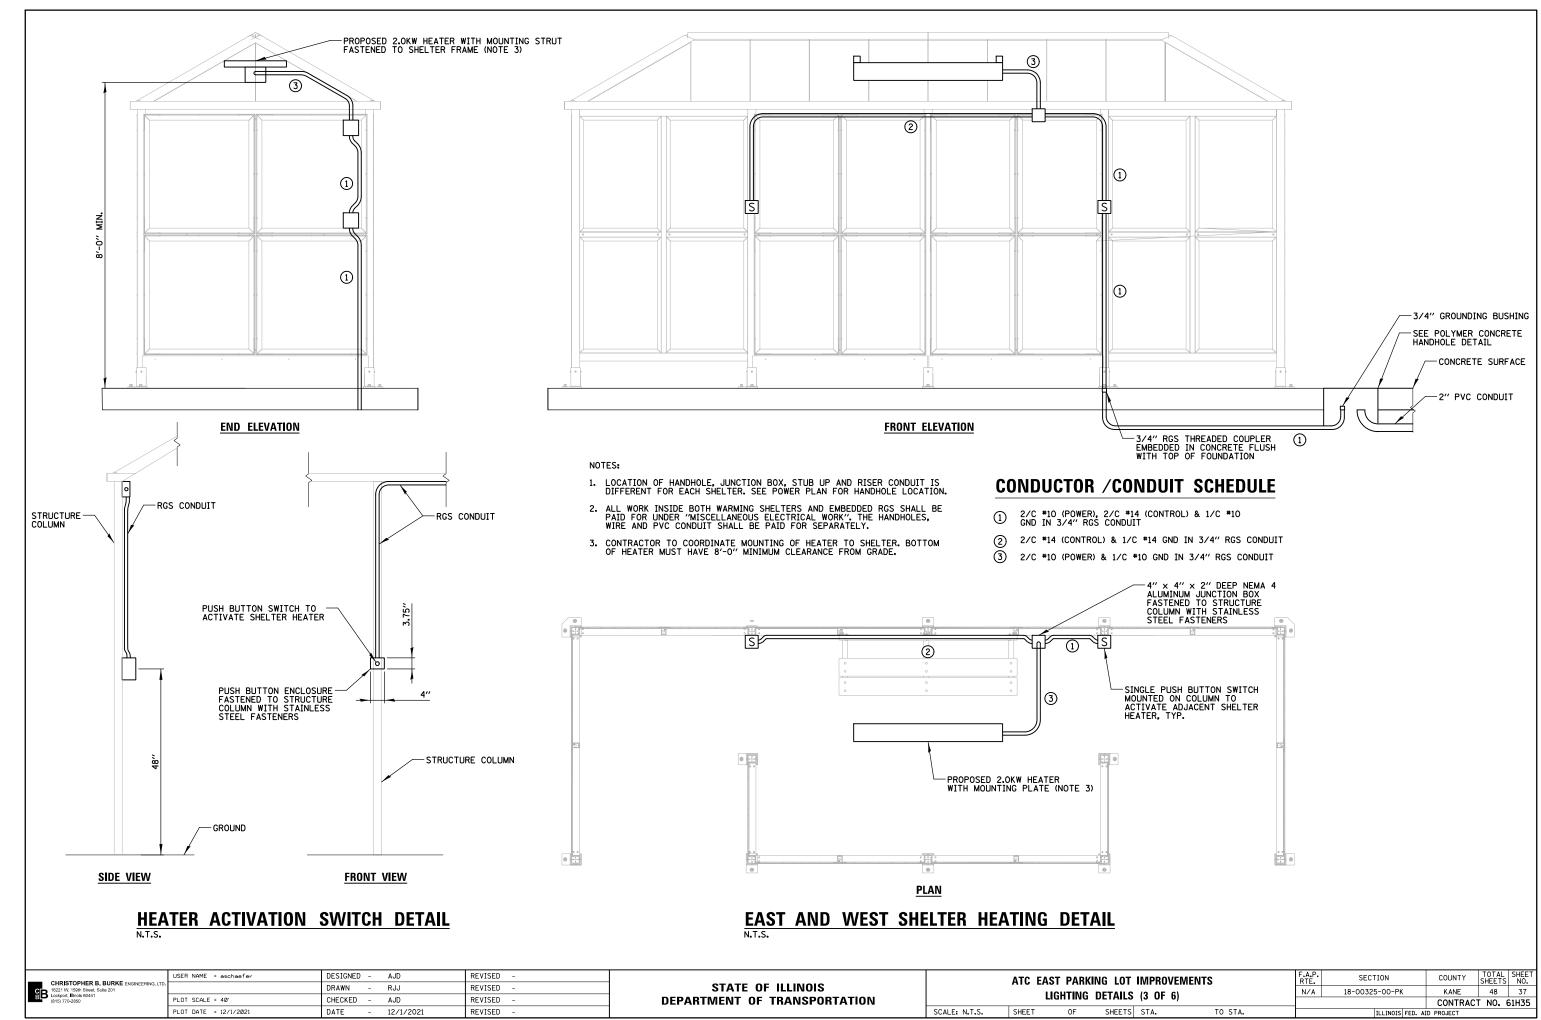


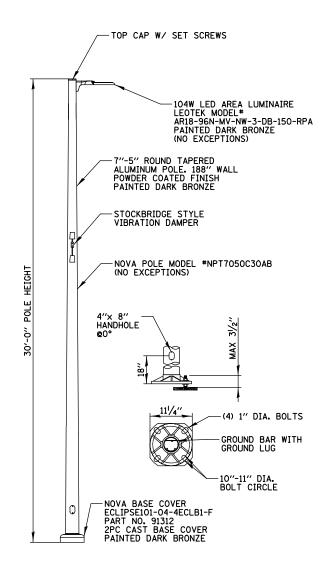

#### NOTES:

- 1. POLE HANDHOLE SHALL FACE AWAY FROM PARKING LOT.
- LIGHT POLE, BASE COVER, AND LED LUMINAIRE SHALL BE PAID FOR UNDER "LIGHTING UNIT, COMPLETE, SPECIAL".


# **LIGHTING UNIT COMPLETE, SPECIAL** N.T.S.

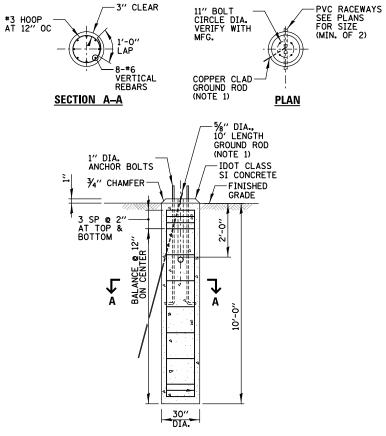


#### NOTES:

- 1. GROUND ROD SHALL BE CAST INTO CONCRETE FOUNDATION WITH 8 FEET IN CONTACT WITH SOIL.
- 2. FOUNDATIONS SHALL BE VIBRATED IN ACCORDANCE WITH IDOT STANDARD PRACTICES.
- 3. ALL ABOVE ITEMS INCLUDING CONCRETE, REINFORCEMENT, RACEWAYS, GROUND ROD AND FORM WORK SHALL BE INCLUDED IN THE LIGHT POLE FOUNDATION PAY ITEM.
- 4. FOUNDATION DEPTH IS BASED ON COHESIVE SOIL ALONG THE LENGTH OF THE SHAFT, WITH AN AVERAGE UNCONFINED COMPRESSIVE STRENGTH (Qu)1.0 TON/SF). SOIL STRENGTH SHAL BE VERIFIED BY BORING DATA PRIOR TO CONSTRUCTION, OR WITH TESTING DURING FOUNDATION DRILLING. THE OWNER'S REPRESENTATIVE SHALL BE CONTACTED FOR A REVISED DESIGN IF OTHER CONDITIONS ARE ENCOUNTERED.
- 5. THE REBAR CAGE SHALL NOT BE WELDED.

# CONCRETE FOUNDATION DETAIL

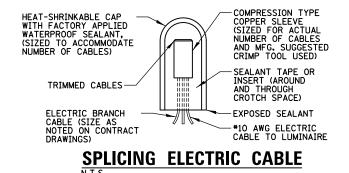

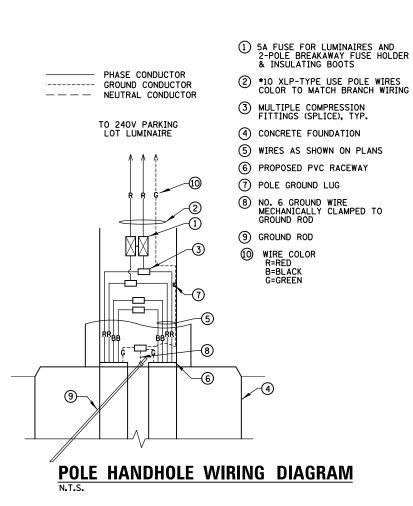




	USER NAME = aschaefer	DESIGNED	-	AJD	REVISED -	
LTD.		DRAWN	-	RJJ	REVISED -	
	PLOT SCALE = 40'	CHECKED	-	AJD	REVISED -	
	PLOT DATE = 12/1/2021	DATE	-	12/1/2021	REVISED -	

STATE OF ILLINOIS
DEPARTMENT OF TRANSPORTATION

SCALE: N.T.S.

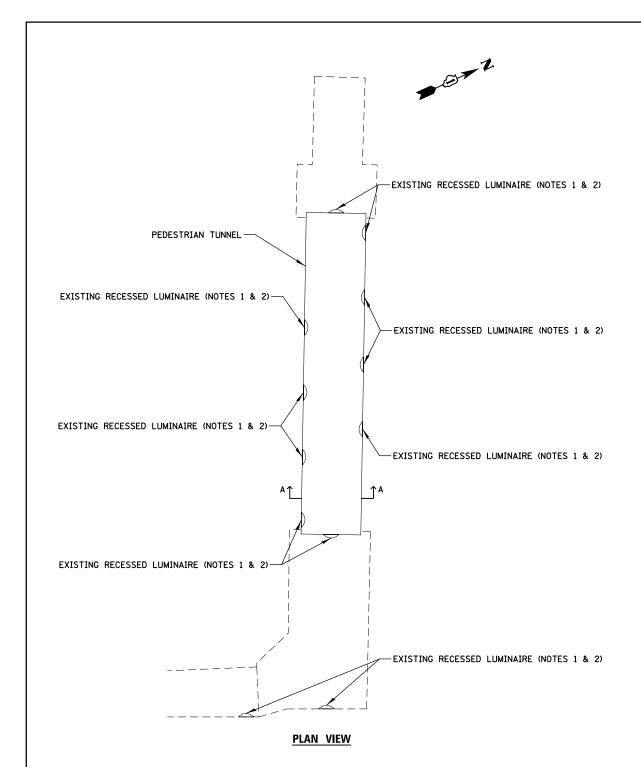

# - STAINLESS STEEL TROUGH BEYOND AT EACH JOINT IN PRECAST TUNNEL SEGMENTS 1 -BACKER ROD & SEALANT $\triangleleft$ -CELL VENT WEEP HOLE @ 32" O.C. -EXISTING RECESSED LUMINAIRE TO BE REPLACED (NOTES 1 & 2) -8" AIR SPACE -GALV. STEEL ANCHOR 16" O.C. VERT. 32" O.C. HORIZ. -GLAZED BRICK -MORTAR STOP MATERIAL -DOWEL @ 32" O.C. FILL CELL W/ GROUT FLASHING--CELL VENT WEEP HOLE @ 32" O.C. IMMEDIATELY ABOVE FLASHING TRENCH DRAIN (TYP.) -W.W.F 6×6 W2.9×W2.9 1'-0'' $\triangleleft$

 $\triangleleft$ 

## SECTION A-A

#### NOTES:

- 1. REMOVE EXISTING RECESSED TUNNEL LUMINAIRE AND REPLACE WITH PROPOSED 30W LED LUMINAIRE KENALL MODEL \*MRITESR-PP-PP-MB-25L40K-DV (NO EXCEPTIONS). ALL WORK SHALL BE PAID FOR UNDER "LUMINAIRE REPLACEMENT SPECIAL", SEE SPECIAL PROVISONS.
- EXISTING LUMINAIRE SHALL BE REMOVED/REPLACED/ RECONNECTED SAME DAY TO ENSURE TUNNEL LIGHTING IS FUNCTIONAL EVERY NIGHT FROM DUSK TO DAWN.

# PEDESTRIAN TUNNEL


N.T.S.

	USER NAME = aschaefer	DESIGNED -	AJD	REVISED -	
CHRISTOPHER B. BURKE ENGINEERING, LTD. 16221 W. 159th Street, Suite 201 Lockport, Illinois 60441		DRAWN -	RJJ	REVISED -	s <sup>-</sup>
BD Lockport, Illinois 60441 (815) 770-2850	PLOT SCALE = 40'	CHECKED -	AJD	REVISED -	DEPARTMI
	PLOT DATE = 12/1/2021	DATE -	12/1/2021	REVISED -	

STATE OF ILLINOIS
DEPARTMENT OF TRANSPORTATION


SCALE: N.T.S.

				F.A.P. RTE.	SECTION	COUNTY	TOTAL SHEETS	SHEET NO.	
LIGHTING DETAILS (5 OF 6)			N/A	18-00325-00-PK	KANE	48	39		
	LIGITING	DETAILS	(3 0) (	''			CONTRAC	T NO. 6	51H35
SHEET	0F	SHEETS	STA.	TO STA.		TILITNOTS EED AT	D PRO IECT		

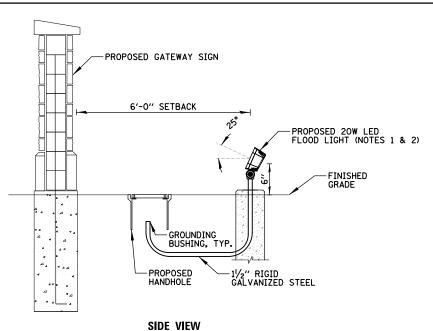


#### NOTES:

- FLOOD LIGHT SIGNIFY MODEL\*DFL7-RM-16L-350-NW-G2-UNV-BZ-PSO (NO EXCEPTIONS).
- 2. CONTRACTOR TO TILT FLOOD LIGHT 25° FROM HORIZONTAL.
- LUMINAIRE AND FOUNDATION SHALL BE INCLUDED IN THE PAY ITEM FOR "SIGN LIGHTING UNIT, COMPLETE". RGS CONDUIT AND WIRE SEPARATELY.

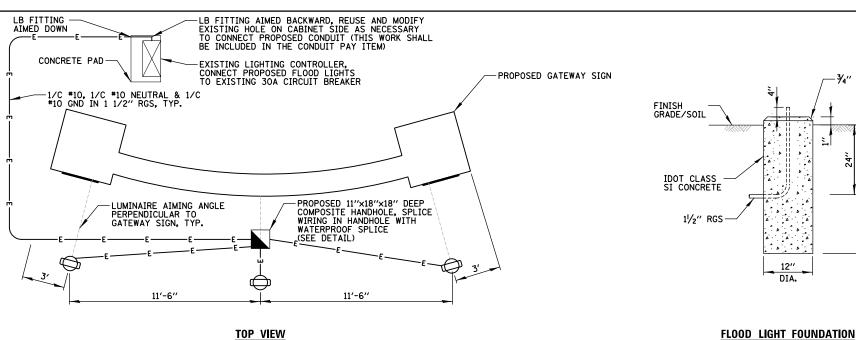


## **SIGN LIGHTING UNIT, COMPLETE**

N.T.S.

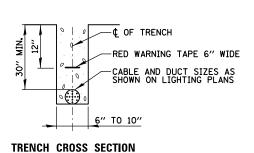

# **ELECTRIC CONDUIT INSTALLATION**

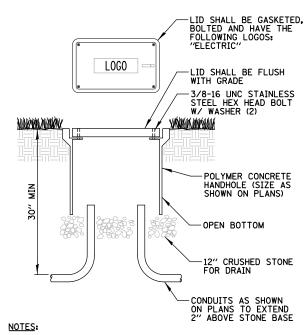



-¾" CHAMFER

- 1. NO SPLICING ALLOWED IN HANDHOLE, UNLESS OTHERWISE SHOWN.
- 2. POLYMER CONCRETE HANDHOLE AND LID SHALL BE GREY.
- 3. BOX & LID SHALL MEET/EXCEED ANSI TIER 15 LOADING REQUIREMENTS, AND BE TESTED IN ACCORDANCE WITH THE LATEST EDITION OF THE ANSI/SCTE 77 "SPECIFICATION FOR UNDERGROUND ENCLOSURE INTEGRITY", AND THE PROVISIONS OF PARAGRAPHS 5.2.3 AND 5.2.4 OF WESTERN UNDERGROUND COMMITTEE GUIDE 3.6.

# POLYMER CONCRETE HANDHOLE

CHRISTOPHER B. BURKE ENGINEERING, LTD.	USER NAME = aschaefer	DESIGNED - AJD	REVISED -	OTATE OF HUMOIO		ATC EA	ST PARK	ING LOT IMPROVE	MENTS	F.A.P. RTE.	SECTION	COUNTY	TOTAL SHEET NO.
B 16221 W. 159th Street, Suite 201 Lockport, Illinois 60441		DRAWN - RJJ	REVISED -	STATE OF ILLINOIS			ICHTING	DETAILS (6 OF 6)		N/A	18-00325-00-PK	KANE	48 40
(815) 770-2850	PLOT SCALE = 40'	CHECKED - AJD	REVISED -	DEPARTMENT OF TRANSPORTATION			LIGITING	DETAILS (0 OF 0)				CONTRAC	T NO. 61H35
	PLOT DATE = 12/1/2021	DATE - 12/1/2021	REVISED -		SCALE: N.T.S.	SHEET	OF	SHEETS STA.	TO STA.		ILLINOIS FED. AI	D PROJECT	

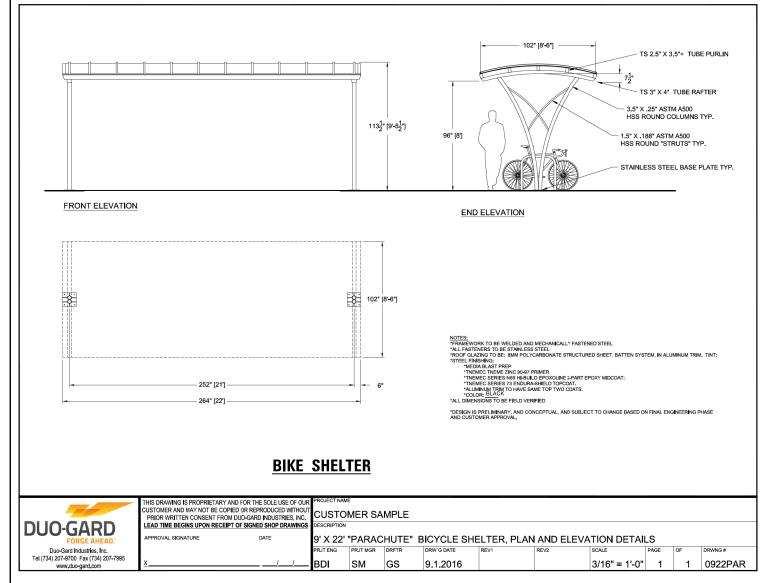

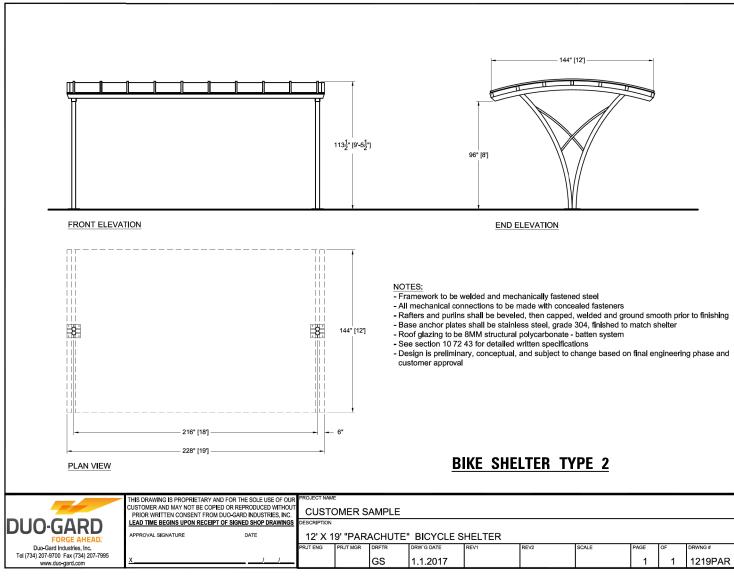

CHRISTOPHER B. BU 16221 W. 159th Street, Suite Lockport, Illinois 60441 (815) 770-2850	
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	USER NAME = aschaefer	DESIGNED	-	AJS	REVISED -	
LTD.		DRAWN	-	JRS	REVISED -	
	PLOT SCALE = 40'	CHECKED	-	ВММ	REVISED -	
	PLOT DATE = 12/1/2021	DATE	-	12/1/2021	REVISED -	


STATE OF ILLINOIS
DEPARTMENT OF TRANSPORTATION


SCALE: N.T.S.

 ATC EAST PARKING LOT IMPROVEMENTS
 F.A.P. RTE.
 SECTION
 COUNTY SHEETS NO.
 SHEET NO.

 CONSTRUCTION DETAILS

 SHEET 1
 OF 4 SHEETS STA.
 TO STA.
 IILLINDIS FED. AID PROJECT
 NO. 61H35

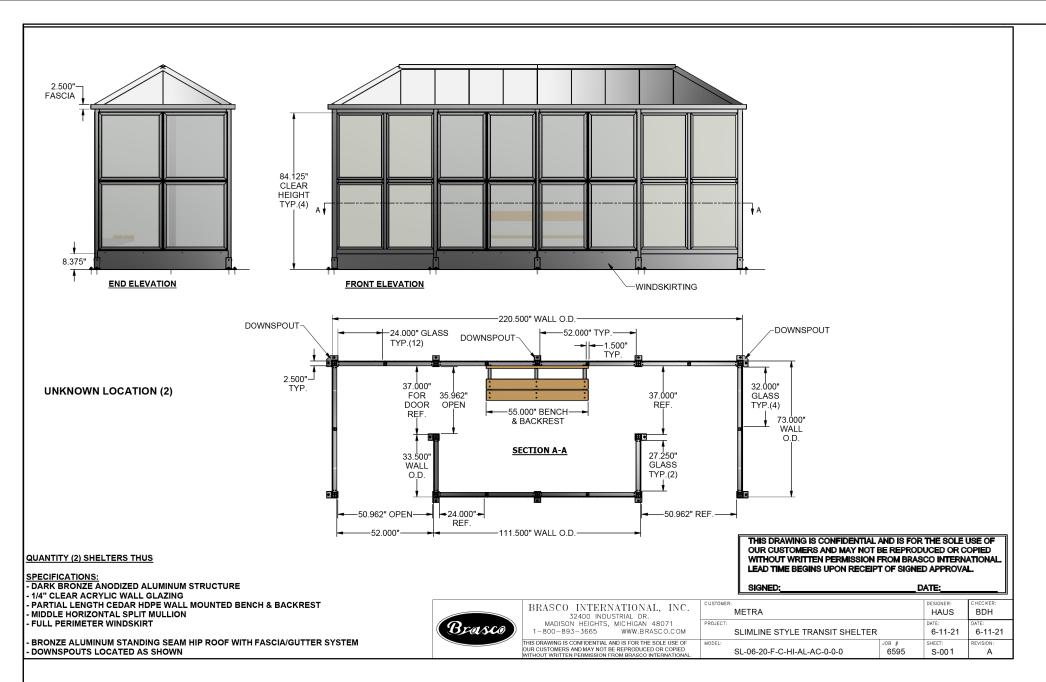

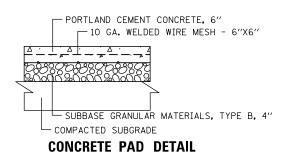

1" 6" VARIES VARIES 0"-9" -EXIST. GROUND -PROP. LANDSCAPE RESTORATION (TO BE PAID FOR SEPARATELY) PROPOSED PCC SIDEWALK, 5" ON SUBBASE—GRANULAR MATERIAL, TYPE B 4" (TO BE PAID FOR SEPARATELY) SUITABLE BACKFILL MATERIALS 12" NO. 6 TIE BAR - 36" C-C\* -PROP. 3/4" PREFORMED EXPANSION JOINT AT CONCRETE SIDEWALKS \* PROP. CONCRETE CURB -IN ACCORDANCE WITH IDOT STANDARD 606001 -SUBBASE GRANULAR MATERIAL, TYPE B 4" (TO BE PAID FOR SEPARATELY) -2 NO. 4 DEFORMED STEEL CONTINUOUS REINFORCEMENT \* INCLUDED IN THE COST FOR CONCRETE CURB, TYPE B (SPECIAL)

NOTES:
1. EXPANSION JOINTS PLACED AT A MAXIMUM 60 FEET SPACING. CONTRACTION JOINTS PLACED AT A MAXIMUM 10 FEET SPACING. EXPANSION JOINTS SHALL HAVE TWO 18" LONG NO. 6 SMOOTH STEEL DOWL BARS PLACED AT MID DEPTH.

3. 3/4" PREFORMED EXPANSION JOINT SHALL BE PLACED BETWEEN THE PROPOSED CONCRETE CURB AND PROPOSED SIDEWALK.

## **CONCRETE CURB, TYPE B (SPECIAL)**

	USER NAME = aschaefer	DESIGNED -	AJS	REVISED -	
CHRISTOPHER B. BURKE ENGINEERING, LTD. 16221 W. 159th Street, Suite 201 Lockport, Illinois 60441		DRAWN -	JRS	REVISED -	1
Lockport, Illinois 60441 (815) 770-2850	PLOT SCALE = 40'	CHECKED -	ВМЖ	REVISED -	]
	PLOT DATE = 12/1/2021	DATE -	12/1/2021	REVISED -	1

STATE OF ILLINOIS **DEPARTMENT OF TRANSPORTATION** 

COMBINATION CONCILIE CORD AND GOTTER, TITE I	<u>0-0.12</u>	(SI LUIAL)		
	F.A.P. RTE.	SECTION	COUNTY	ļ
CONSTRUCTION DETAILS	N/A	18-00325-00-PK	KANE	Γ
CONSTRUCTION DETAILS			CONTRAC	Ŧ

TO STA.

# 3. DEPRESSED CURB HEADS SHALL BE INSTALLED AT ALL ADA CURB RAMPS/BLENDED TRANSITIONS AND AT THE KISS & RIDE AREA SHOWN ON THE PLANS. DEPRESSED CURB HEAD SHALL BE 1/2" TALL IN ACCORDANCE WITH ADA AND PROWAG REQUIREMENTS. COMBINATION CONCRETE CURR AND GUTTER TYPE R\_6 12 (SPECIAL)

2. EXPANSION JOINTS PLACED AT A MAXIMUM 60 FEET SPACING. CONTRACTION JOINTS PLACED AT A MAXIMUM 10 FEET SPACING. EXPANSION JOINTS SHALL HAVE TWO 18" LONG NO. 6 SMOOTH STEEL DOWL BARS PLACED AT MID DEPTH.

NOTES: 1. ALL CURB AND GUTTER SHALL BE REVERSED PITCH AS SHOWN UNLESS OTHERWISE DIRECTED BY THE ENGINEER.

SHEET 2 OF 4 SHEETS STA.

FULL DEPTH SAWCUT


PROPOSED FULL DEPTH PAVEMENT-(TO BE PAID FOR SEPARATELY)

PAVEMENT REMOVAL (IF REQUIRED)

SCALE: N.T.S.

EXIST, FLEXIBLE PAVEMENT

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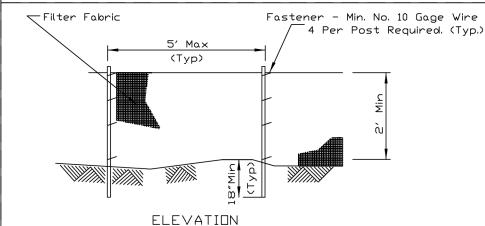


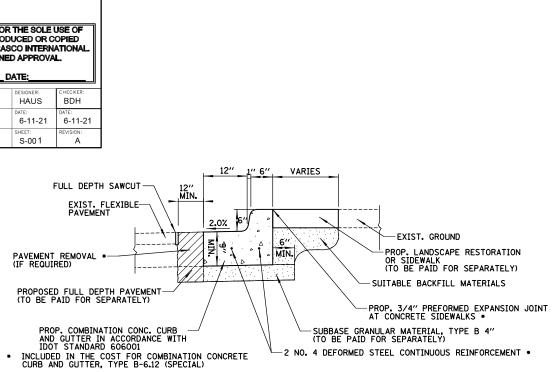
2 NO. 4 DEFORMED STEEL CONTINUOUS REINFORCEMENT \*

48 42

CONTRACT NO. 61H35

## SILT FENCE PLAN



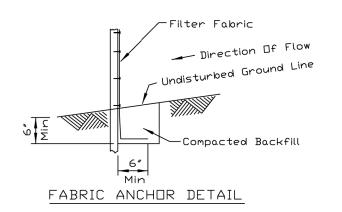

#### NOTES:


- 1. Temporary sediment fence shall be installed prior to any grading work in the area to be protected. They shall be maintained throughout the construction period and removed in conjunction with the final grading and site stabilization.
- 2. Filter fabric shall meet the requirements of material specification 592 Geotextile Table 1 or 2, Class I with equivalent opening size of at least 30 for nonwoven and 50 for woven.
- 3. Fence posts shall be either standard steel post or wood post with a minimum cross-sectional area of 3.0 sq. in.

REFERENCE		<b>A</b>	
Project			N
Designed	Date		- 11
Checked	Date		- I V
Approved	Date	Natural Resources	Conservs



STANDARD DWG. NO. IL-620 SHEET 1 DF 2 DATE 11-20-01

## SILT FENCE

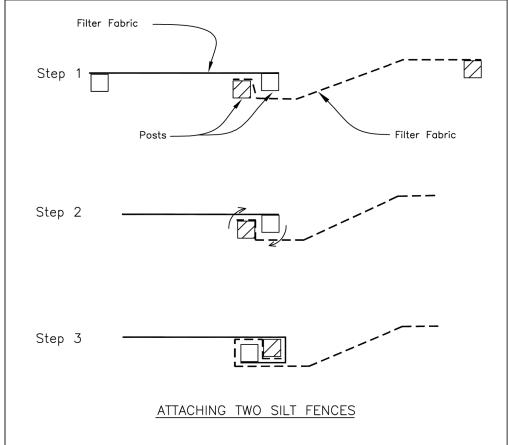


- 1. Place the end post of the second fence inside the end post of the first fence. 2. Rotate both posts at least 180 degrees in a clockwise direction to create a tight
- seal with the fabric material. 3. Drive both posts a minimum of 18 inches into the ground and bury the flap.


REFERENCE		<b>A</b>
Project		
Designed	Date	
Checked	Date	
Approved	Date	Natural Resources Consc

STANDARD DWG. NO. IL-620(W) SHEET 2 OF 2 DATE 1-29-99

SCALE: N.T.S.

# INLET PROTECTION - PAVED AREAS DROP-IN PROTECTION

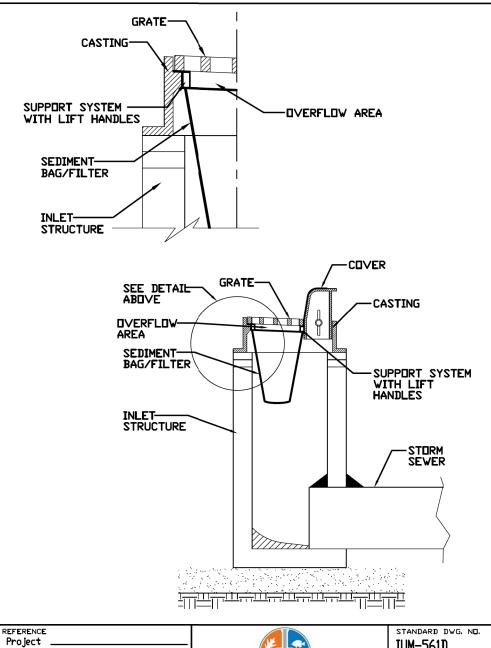

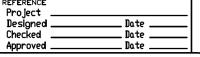





CHRISTOPHER B. BURKE ENGII 16221 W. 159th Street, Suite 201 Lockport, Illinois 60441 (815) 770-2850	NEERING,
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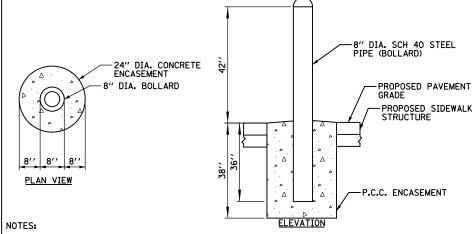
	USER NAME = aschaefer	DESIGNED	-	AJS	REVISED -
TD.		DRAWN	-	JRS	REVISED -
	PLOT SCALE = 40'	CHECKED	-	BMW	REVISED -
	PLOT DATE = 12/1/2021	DATE	-	12/1/2021	REVISED -

STATE OF ILLINOIS **DEPARTMENT OF TRANSPORTATION** 

ATC EAST PARKING LOT IMPROVEMENTS						F.A.P. RTE.	SECTION	COUNTY	TOTAL SHEETS	SHEET NO.
CONSTRUCTION DETAILS							18-00325-00-PK	KANE	48	43
								CONTRAC	T NO.	61H35
	SHEET 3	0F 4	SHEETS	STA.	TO STA.		ILLINOIS FED. AI	D PROJECT		



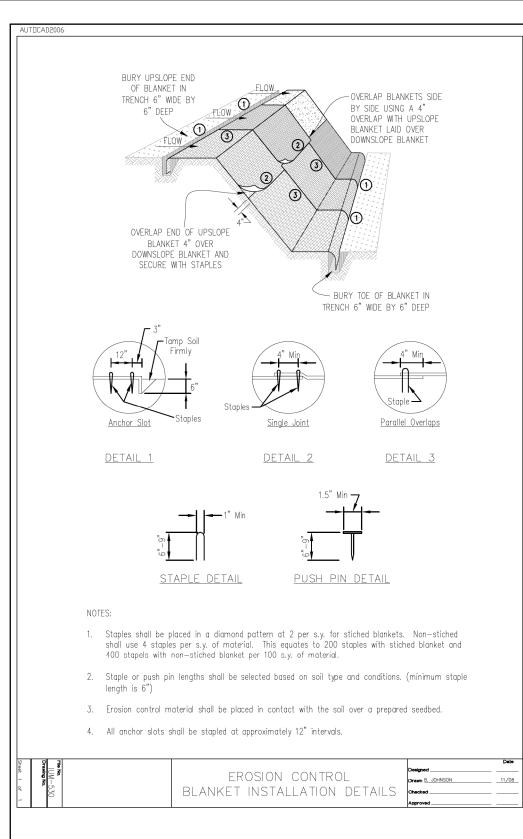

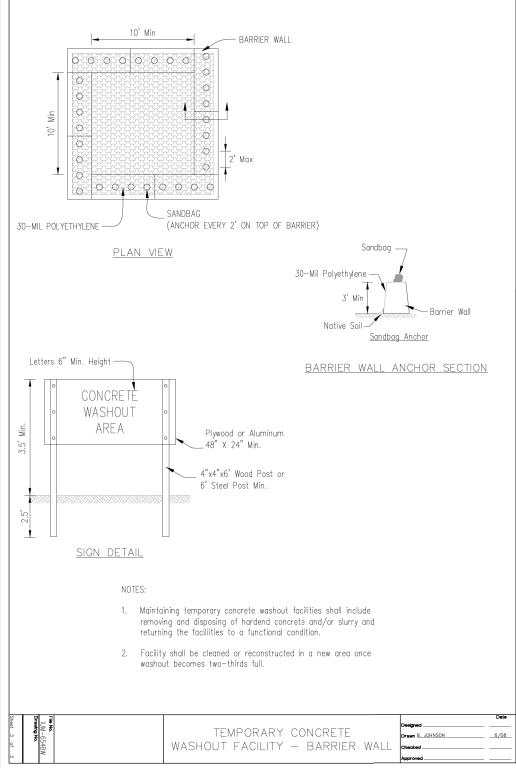

- . PIPE SHALL BE SCHEDULE 40 STEEL PIPE
- 2. BOLLARD SHALL BE INSTALLED PLUMB IN ALL DIRECTIONS
- THE TOP 8" OF THE OUTER EDGE OF THE CONCRETE ENCASEMENT SHALL BE FORMED WITH A SINGLE USE FOUNDATION FORM. THIS FORM SHALL BE REMOVED PRIOR TO THE INSTALLATION OF THE ADJACENT PAVEMENT.
- 4. THE 8" DIAMETER BOLLARD SHALL BE FILLED WITH PORTLAND CEMENT CONCRETE.
- THE 8" DIAMETER BOLLARD SHALL BE COVERED WITH AN ENAMEL PAINT COLOR SAFETY YELLOW.
  THE CONTRACTOR SHALL SUBMIT A SAMPLE OF THE PAINT TO THE ENGINEER FOR APPROVAL
  PRIOR TO PAINTING.
- 6. SEE SIGNAGE DETAILS FOR BOLLARD MOUNTED SIGN POSTS.

## **BOLLARD DETAIL**





627 Amersale Drive Naperville, IL 60563 Phone: (800) 323-5664 Fax: (630) 897-0573 sales@belson.com

Model # UX200-8-P

**Dimension Sheet** 

## EXTENDED SQUARE U RACK ON RAILS | 4 LOOPS 8 BIKES

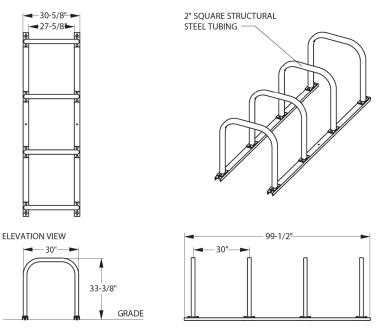

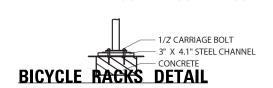

STATE OF ILLINOIS
DEPARTMENT OF TRANSPORTATION

ATC EAST PARKING LOT IMPROVEMENTS

CONSTRUCTION DETAILS


SHEET 4 OF 4 SHEETS STA. TO STA.

SCALE: N.T.S.

F.A.P. SECTION COUNTY TOTAL SHEETS NO.


N/A 18-00325-00-PK KANE 48 44

CONTRACT NO. 61H35

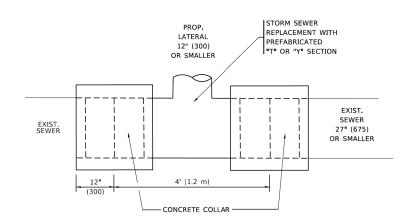

#### **DETAIL "A"**

LATERAL CONNECTION TO EXISTING SEWER
OF 27" (675) OR SMALLER

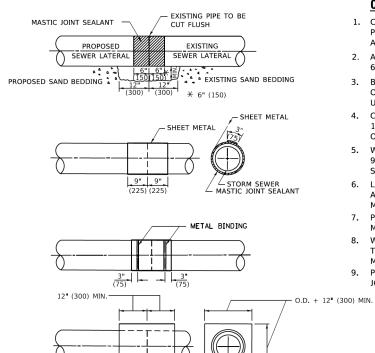

- CLASS SI CONCRETE-


<u>DETAIL "B"</u> CLASS SI CONCRETE COLLAR

## **CONSTRUCTION SEQUENCE**

- CUT THE EXISTING END OF THE PIPE SO AS TO PRESENT A FLUSH BUTT JOINT. BRUSH AND CLEAN ALL PIPES.
- 2. APPLY THE MASTIC JOINT SEALANT TO THE FIRST 6" (150) OF EACH PIPE.
- BUTT THE PIPES TOGETHER LEAVING A MINIMUM OF 12' x 6' (300 x 150) DEEP EXCAVATION UNDER AND AROUND EACH PIPE END.
- 4. CUT A PIECE OF SHEET METAL GAGE NO. 19 1.1 (0.0418) 18" (450) WIDE BY THE OUTSIDE CIRCUMFERANCE OF THE PIPE PLUS 3" (75) LONG.
- 5. WRAP THE SHEET METAL AROUND THE PIPES, 9" (225) ON EACH SIDE OF THE JOINT, STARTING AT THE TOP OF THE PIPE.
- LAP THE SHEET METAL AT LEAST 3" (75) AT THE TOP OF THE PIPE AND PLACE THE MASTIC JOINT SEALANT BETWEEN THE LAP.
- 7. PLACE TWO METAL BANDS AROUND THE SHEET METAL AND TIGHTEN.
- WIPE OFF ANY EXCESS MASTIC JOINT SEALANT THAT OOZES OUT FROM BETWEEN THE SHEET METAL AND THE PIPES.
- 9. PLACE CLASS SI CONCRETE AROUND THE

SCALE: NONE

\* ALL DIMENSIONS ARE IN INCHES (MILLIMETERS) UNLESS OTHERWISE SHOWN.

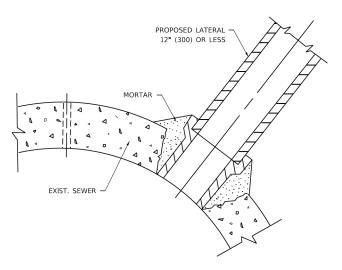

#### DETAIL "C"

PROPOSED LATERAL
CONNECTION TO EXISTING SEWER
OF 30" (750) OR LARGER

#### NOTES:

#### MATERIAL

MATERIAL USED FOR THE TEE OR WYE SECTION SHALL BE COMPATIBLE WITH THE EXISTING STORM SEWER OR THE PROPOSED STORM SEWER.

#### **CONSTRUCTION METHODS**

- I. THIS WORK SHALL BE CONSTRUCTED IN CONFORMANCE WITH THE APPLICABLE PORTIONS OF SECTION 550 OF THE STANDARD SPECIFICATIONS.
- II. CONNECTION TO AN EXISTING STORM SEWER SHALL BE BY EITHER OF THE FOLLOWING METHODS:

  A) PROPOSED STORM SEWER CONNECTION TO EXISTING SEWER OF 27" (675) OR SMALLER SEE
  - B) PROPOSED STORM SEWER CONNECTION TO EXISTING SEWER OF 30" (750) OR LARGER SEE DETAIL "C".

IF THE EXISTING SEWER PIPE IS CRACKED, BROKEN OR OTHERWISE DAMAGED BY THE CONTRACTOR IN MAKING THE CIRCULAR OPENING, THE CONTRACTOR SHALL REPLACE THAT SECTION OF PIPE WITH PIPE EQUAL AND SIMILAR IN ALL RESPECTS TO THE PIPE IN THE EXISTING SEWER, IN A CAREFUL WORKMANLIKE MANNER, WITHOUT EXTRA COMPENSATION.

## GENERAL

CARE MUST BE TAKEN TO PREVENT DEBRIS FROM ENTERING THE SEWER. ALL DEBRIS WHICH ENTERS THE SEWER MUST BE REMOVED. THE SEWER MUST BE LEFT CLEAN AND UNOBSTRUCTED UPON COMPLETION OF THE CONTRACT.

CARE MUST BE TAKEN TO PREVENT ANY PART OF THE NEW PIPE CONNECTION FROM PROJECTING INTO THE EXISTING SEWER.

#### BASIS OF PAYMENT

TEE OR WYE CONNECTIONS SHALL BE PAID FOR AT THE CONTRACT UNIT PRICE EACH FOR STORM SEWER TEE OR WYE OF THE TYPE AND SIZE SPECIFIED IN THE PLANS, THIS PRICE SHALL INCLUDE ALL EXCAVATION OF THE TRENCH, REMOVAL OF THE EXISTING STORM SEWER, FURNISHING AND INSTALLING THE SPECIFIED TEE OR WYE SECTION, FURNISHING AND INSTALLING THE REQUIRED CONCRETE COLLAR, AND ALL OTHER MATERIAL NECESSARY TO COMPLETE THIS WORK AS SHOWN AND SPECIFIED.

REMOVAL AND REINSTALLATION OF EXISTING STORM SEWER ADJACENT TO THE PROPOSED TEE OR WYE SECTION, FOR THE PURPOSE OF FACILITATING THE INSTALLATION OF THE TEE OR WYE SECTION, WILL NOT BE PAID FOR SEPARATELY BUT SHALL BE INCLUDED IN THE UNIT PRICE BID FOR THE WORK.

TRENCH BACKFILL, EXCAVATION IN ROCK AND REMOVAL AND REPLACEMENT OF UNSUITABLE MATERIAL BELOW PLAN BEDDING GRADE WILL BE PAID FOR SEPARATELY.

CONCRETE COLLAR FOR CONNECTING A PROPOSED STORM SEWER TO AN EXISTING STORM SEWER WILL NOT BE PAID PAID FOR SEPARATELY BUT SHALL BE INCLUDED IN THE COST OF THE PROPOSED STORM SEWER


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	DRAWN -	REVISED -	R. SHAH 09-09-94
PLOT SCALE = 50.0000 ' / in.	CHECKED -	REVISED -	R. SHAH 10-25-94
PLOT DATE = 3/27/2019	DATE - 07-25-90	REVISED -	R. SHAH 06-12-96

STATE OF ILLINOIS
DEPARTMENT OF TRANSPORTATION

DETAIL OF STORM SEWER						SECTION	COUNTY	TOTAL SHEETS	SHEET NO.
	CONNECTION	TO FYIC	TING	SEWER	N/A	18-00325-00-PK	KANE	48	45
CONNECTION TO EXISTING SEVEN						BD500-01 (BD-7)	CONTRACT NO. 61H35		
	SHEET 1 OF 1	SHEETS	STA.	TO STA.		ILLINOIS FED A	D PROJECT		


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(FOR BUTT JOINT AND HMA TAPER SEE DETAIL BELOW)

#### OPTION 1

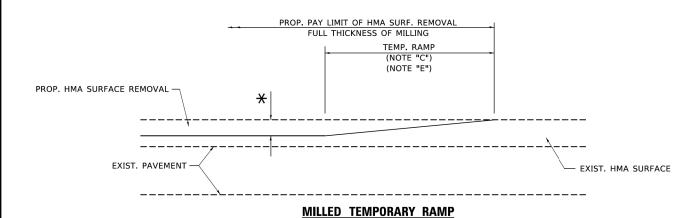


#### HMA CONSTRUCTED TEMPORARY RAMP

(FOR BUTT JOINT AND HMA TAPER SEE DETAIL BELOW)
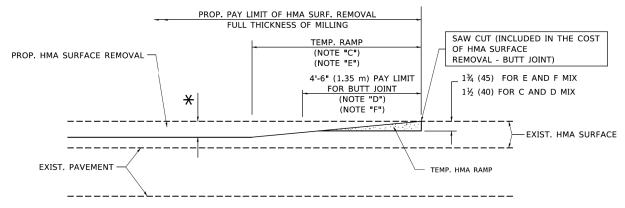
## OPTION 2

# TYPICAL TEMPORARY RAMP

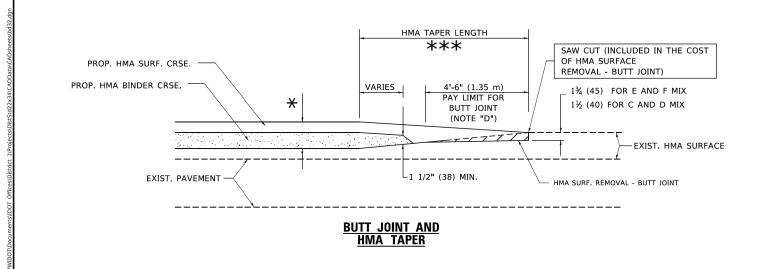

# TYPICAL BUTT JOINT AND HMA TAPER FOR MILLING AND RESURFACING

06-13-90

DESIGNED - M. DE YONG

DRAWN

DATE


CHECKED .

PROP. HMA OR PCC

SURFACE REMOVAL - BUTT JOINT
30'-0" (9.0 m) (NOTE "A")
15'-0" (4.5 m) (NOTE "B")

\*\* \* EXIST. PAVEMENT

BUTT JOINT DETAIL

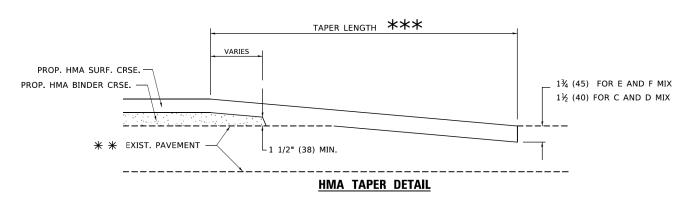

# TYPICAL BUTT JOINT AND HMA TAPER FOR RESURFACING ONLY

\*\* PC CONCRETE, HMA OR HMA RESURFACED PAVEMENT.

## **NOTES**

- A. MAINLINE ROADWAYS AND MAJOR SIDE ROADS.
- B. MINOR SIDE ROADS.
- C. THE TEMP. RAMP SHALL BE CONSTRUCTED IMMEDIATELY UPON REMOVAL OF THE EXISTING HMA SURFACE.
- D. THE BUTT JOINT SHALL BE CONSTRUCTED IMMEDIATELY PRIOR TO PLACING THE PROPOSED HMA COURSES.
- E. TAPER THE TEMP. RAMP AT A RATE OF 3'-0" (900 mm) PER 1 INCH (25 mm) OF MILLING THICKNESS.
- F. INSTALLATION AND REMOVAL OF THE 4'-6" (1.35 m) TEMP. RAMP IS INCLUDED IN COST OF HMA SURFACE REMOVAL BUTT JOINT.

  \*\* SEE TYPICAL SECTIONS FOR MILLING THICKNESS.
- G. SEE ARTICLE 406.08 AND 406.14 OF THE STANDARD SPECIFICATIONS FOR "HMA AND/OR PCC SURFACE REMOVAL, BUTT JOINT".
- \*\*\* 20'-0" (6.1 m) PER 1 (25) RESURFACING (NOTE "A") 10'-0" (3.0 m) PER 1 (25) RESURFACING (NOTE "B")

#### **BASIS OF PAYMENT**

THE BUTT JOINT WILL BE PAID FOR AT THE CONTRACT UNIT PRICE PER SQUARE YARD (SQUARE METER) FOR "HOT-MIX ASPHALT SURFACE REMOVAL - BUTT JOINT" OR FOR "PORTLAND CEMENT CONCRETE SURFACE REMOVAL-BUTT JOINT".

ALL DIMENSIONS ARE IN INCHES (MILLIMETERS) UNLESS OTHERWISE SHOWN.

STATE OF ILLINOIS
DEPARTMENT OF TRANSPORTATION

| SCALE: NONE | SHEET | OF | SHEET | STA. | TO S

REVISED - R. SHAH 10-25-94

REVISED - A. ABBAS 03-21-97

REVISED - M. GOMEZ 04-06-01


REVISED - R BORO 01-01-07

N:\Aurora\200106\Civil\D1\_02\_BD-32\_200106.SHT

USER NAME = footemj

PLOT DATE = 3/27/2019

PLOT SCALE = 50.0000 ' / in.

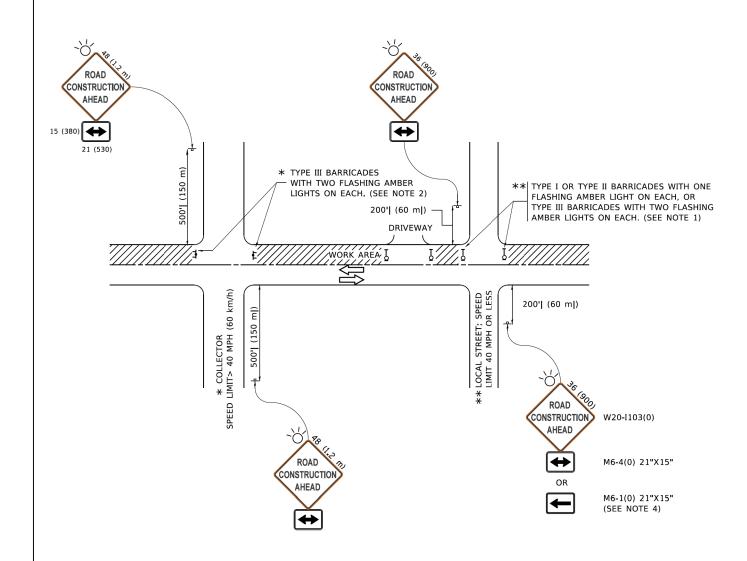

#### NOTES:

- 1. SIDE ROAD WITH A SPEED LIMIT OF 40 MPH (60 km/h) OR LESS AS SHOWN ON THE DRAWING AND AS DIRECTED BY THE ENGINEER:
- a) ONE "ROAD CONSTRUCTION AHEAD" SIGN 36 x 36 (900x900) WITH A FLASHER MOUNTED ON IT APPROXIMATELY 200' (60 m) IN ADVANCE OF THE MAIN ROUTE.
- b) THE CLOSED PORTION OF THE MAIN ROUTE SHALL BE PROTECTED BY BLOCKING WITH TYPE I, TYPE II OR TYPE III BARRICADES, 1/3 OF THE CROSS SECTION OF THE CLOSED PORTION.
- SIDE ROAD WITH A SPEED LIMIT GREATER THAN 40 MPH (60 km/h) AS SHOWN ON THE DRAWING AND AS DIRECTED BY THE ENGINEER:
- a) ONE "ROAD CONSTRUCTION AHEAD" SIGN 48 x 48 (1.2 m x 1.2 m) WITH A FLASHER MOUNTED ON IT APPROXIMATELY 500' (150 m) IN ADVANCE OF THE MAIN POLITE
- THE CLOSED PORTION OF THE MAIN ROUTE SHALL BE PROTECTED BY
  b) BLOCKING WITH TYPE III BARRICADES, 1/2 OF THE CROSS SECTION
  OF THE CLOSED PORTION.
- 3. CONES MAY BE SUBSTITUTED FOR BARRICADES OR DRUMS AT HALF THE SPACING DURING DAY OPERATIONS. CONES SHALL BE A MINIMUM OF 28 (710)
- WHEN THE SIDE ROAD LIES BETWEEN THE BEGINNING OF THE MAINLINE
  4. SIGNING AND THE WORK ZONE, A SINGLE HEADED ARROW (M6-1) SHALL
  BE USED IN LIEU OF THE DOUBLE HEADED ARROW (M6-4).

- 5. WHEN WORK IS BEING PERFORMED ON A SIDE ROAD OR DRIVEWAY, FOLLOW THE APPLICABLE STANDARD(S). THE DIRECTIONAL ARROW (M6-1 OR M6-4) SHALL BE COVERED OR REMOVED WHEN NO LONGER CONSISTENT WITH THE TRAFFIC CONTROL SET-UP.
- 6. ADVANCE WARNING SIGNS ARE TO BE OMITTED ON DRIVEWAYS UNLESS OTHERWISE SPECIFIED IN THE PLANS OR BY THE ENGINEER
- 7. THE TRAFFIC CONTROL AND PROTECTION FOR SIDE ROADS, INTERSECTIONS, AND DRIVEWAYS SHALL BE INCLUDED IN THE COST OF SPECIFIED TRAFFIC CONTROL STANDARDS OR ITEMS.

All dimensions are in inches (millimeters) unless otherwise shown.

 USER NAME
 = footemj
 DESIGNED - L.H.A.
 REVISED - A. HOUSEH 10-15-96

 DRAWN REVISED - T. RAMMACHER 01-06-00

 PLOT SCALE = 50.0000 '/ in.
 CHECKED - REVISED - A. SCHUETZE 07-01-13

 PLOT DATE = 3/4/2019
 DATE - 06-89
 REVISED - A. SCHUETZE 09-15-16

STATE OF ILLINOIS
DEPARTMENT OF TRANSPORTATION

TRAFFIC CONTROL AND PROTECTION FOR SIDE ROADS, INTERSECTIONS, AND DRIVEWAYS


SHEET 1 OF 1 SHEETS STA. TO STA

F.A. SECTION COUNTY TOTAL SHEET'S NO.

N/A 18-00325-00-PK KANE 48 47

TC-10 CONTRACT NO. 61H35

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\* LANE REDUCTION ARROWS REQUIRED AT SPEEDS OF 45 MPH OR GREATER OR WHEN SPECIFIED IN PLANS. **U\_TURN** TYPE OF MARKING WIDTH OF LINE PATTERN COLOR SPACING / REMARKS NO PASSING ZONE LINES: FOR ONE DIRECTION FOR BOTH DIRECTIONS 5½ (140) C-C FROM SKIP-DASH CENTERLINE 11 (280) C-C OMIT SKIP-DASH CENTERLINE BETWEEN 4 (100) 2 @ 4 (100) LANE LINES SKIP-DASH SKIP-DASH 10' (3 m) LINE WITH 30' (9 m) SPACE (125) ON FREEWAYS DOTTED LINES SAME AS LINE BEING EXTENDED SKIP-DASH SAME AS LINE BEING EXTENDED 2' (600) LINE WITH 6' (1.8 m) SPACE (EXTENSIONS OF CENTER, LANE OR TURN LANE MARKINGS) EDGE LINES 4 (100) SOLID YELLOW-LEFT WHITE-RIGHT OUTLINE MEDIANS IN YELLOW 6 (150) LINE; FULL SIZE LETTERS & SYMBOLS (8' (2.4m)) TURN LANE MARKINGS SOLID SEE TYPICAL TURN LANE MARKING DETAIL WHITE TWO WAY LEFT TURN MARKING 2 @ 4 (100) EACH DIRECTION YELLOW 10' (3 m) LINE WITH 30' (9 m) SPACE FOR SKIP-DASH; 5½ (140) C-C BETWEEN SOLID LINE AND SKIP-DASH LINE SEE TYPICAL TWO-WAY LEFT TURN MARKING DETAIL CROSSWALK LINES (PEDESTRIAN) A. DIAGONALS (BIKE & EQUESTRIAN) B. LONGITUDINAL BARS (SCHOOL) NOT LESS THAN 6' (1.8 m) APART 2' (600) APART 2' (600) APART SEE TYPICAL CROSSWALK MARKING DETAILS. PLACE 4' (1.2 m) IN ADVANCE OF AND PARALLEL TO CROSSWALK, IF PRESENT. OTHERWISE, PLACE AT DESIRED STOPPING POINT. PARALLEL TO CROSSROAD CENTERLINE, WHERE STOP LINES 24 (600) SOLID WHITE PAINTED MEDIANS 11 (280) C-C FOR THE DOUBLE LINE SEE TYPICAL PAINTED MEDIAN MARKING. 2 @ 4 (100) WITH 12 (300) DIAGONALS SOLID YELLOW: TWO WAY TRAFFIC WHITE: ONE WAY TRAFFIC NO DIAGONALS USED FOR 4' (1.2 m) WIDE MEDIANS 8 (200) WITH 12 (300) DIAGONALS @ 45° SOLID DIAGONALS: 15' (4.5 m) C-C (LESS THAN 30MPH (50 km/h)) 20' (6 m) C-C 30MPH (50 km/h) TO 45MPH (70 km/h)) 30' (9 m) C-C (OVER 45MPH (70 km/h)) 24 (600) TRANSVERSE LINES; "RR" IS 6' (1.8 m) LETTERS; 16 (400) LINE FOR "X" RAILROAD CROSSING SOLID WHITE SEE STATE STANDARD 780001 50' (15 m) C-C (LESS THAN 30MPH (50 km/h)) 75' (25 m) C-C (30 MPH (50 km/h) TO 45MPH (70 km/h)) 150' (45 m) C-C (OVER 45MPH (70 km/h)) SHOULDER DIAGONALS (REQUIRED FOR SHOULDERS > 8') WHITE - RIGHT YELLOW - LEFT 12 (300) @ 45° SOLID

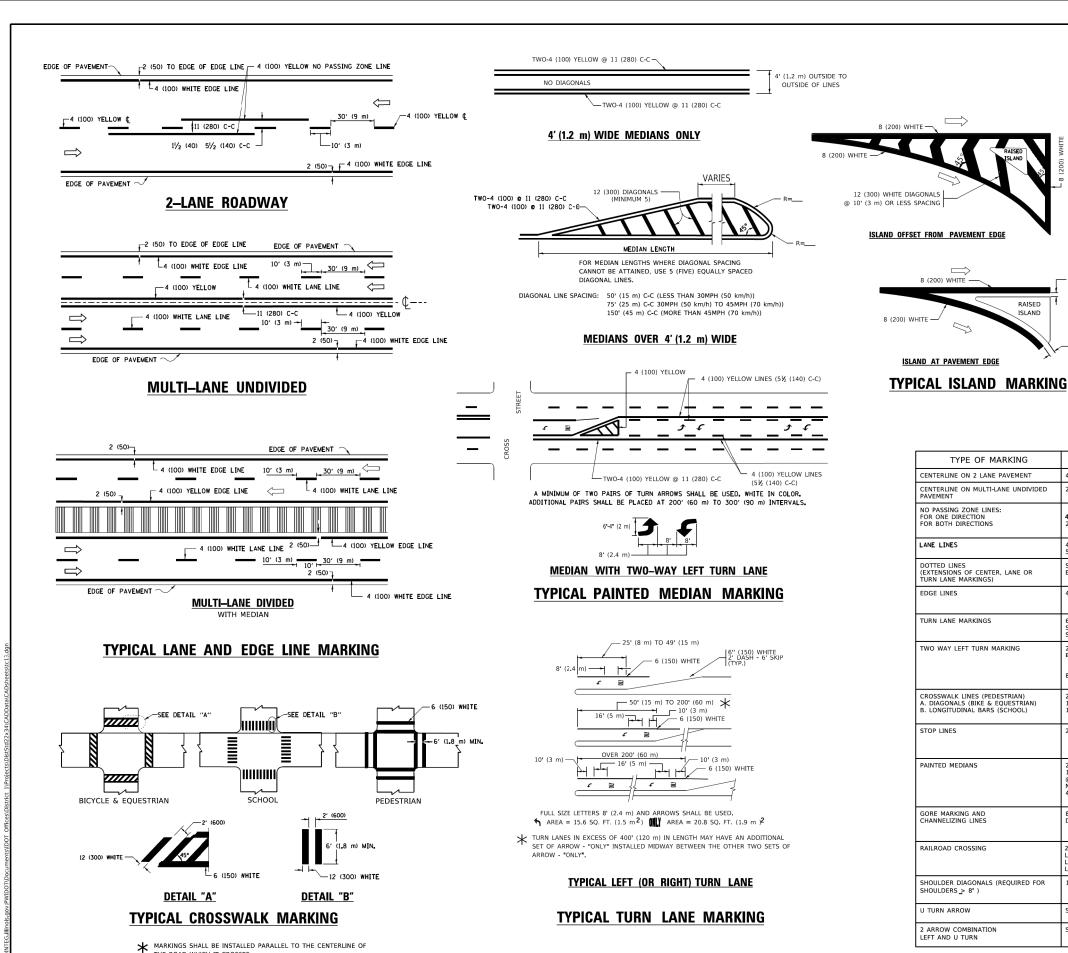**COMBINATION** 

LEFT AND U-TURN

5'-4" (1620)

40 (1020)

2 (50)

2 (50)

RAISED

FOR FURTHER DETAILS ON PAVEMENT MARKING REFER TO STANDARD SPECIFICATIONS FOR ROAD AND BRIDGE CONSTRUCTION AND STATE STANDARD 780001.

SHEET

SCALE: NONE

SEE DETAIL

SOL TO

WHITE

unless otherwise shown.

D(FT)

580

665

750

LANE REDUCTION TRANSITION

SPEED LIMIT

45

50

REVISED - C. JUCIUS 09-09-09 REVISED - C. JUCIUS 07-01-13 C. JUCIUS 12-21-15

STATE OF ILLINOIS **DEPARTMENT OF TRANSPORTATION** 

DISTRICT ONE TYPICAL PAVEMENT MARKINGS						F.A. RTE.	SECTION	COUNTY	TOTAL SHEETS	SHE
						N/A	18-00325-00-PK	KANE	48	48
							TC-13	CONTRACT NO. 61H3		
1	OF	2	SHEETS	STA.	TO STA.	ILLINOIS FED. AID PROJECT				

30.4 SF

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USER NAME = footemj

PLOT SCALE = 50.0000 ' / in PLOT DATE = 3/4/2019

DESIGNED -

DRAWN

DATE

CHECKED

EVERS

REVISED -