PLAN AND PROFILE - GRANT PARK

PLAN AND PROFILE - KING ARTHUR

ELECTRIC SERVICE COORDINATION

INTERSECTIONS, AND DRIVEWAYS (TC-10)

CONSTRUCTION DETAILS

LIGHTING PLAN

LIGHTING DETAILS

CROSS SECTIONS

LIGHTING GENERAL NOTES AND BILL OF MATERIALS

DISTRICT ONE TYPICAL PAVEMENT MARKINGS (TC-13)

TRAFFIC CONTROL AND PROTECTION FOR SIDE ROADS,

SECTION

COUNTY

INDEX OF SHEETS

SHEET NO.

6-7

8-10

11-16

17

18-23

24-27

32-52

TRAFFIC DATA

ADT (2014) = N/ASPEED LIMIT = N /A

CLASSIFICATION - BIKE PATH

FULL SIZE PLANS HAVE BEEN PREPARED USING STANDARD ENGINEERING SCALES. REDUCED SIZED PLANS WILL NOT CONFORM TO STANDARD SCALES. IN MAKING MEASUREMENTS ON REDUCED PLANS, THE ABOVE SCALES MAY BE USED.

JOINT UTILITY LOCATION INFORMATION FOR EXCAVATION 1-800-892-0123

PLANS FOR PROPOSED FEDERAL AID HIGHWAY DESCRIPTION ADDISON CREEK TRAIL BIKE PATH **COVER SHEET** GENERAL NOTES AND HIGHWAY STANDARDS WHITEHALL AVENUE TO GOLFVIEW DRIVE AND SUMMARY OF QUANTITIES RHODES AVENUE TO FULLERTON AVENUE TYPICAL SECTIONS AND EARTHWORK SCHEDULE ALIGNMENT, TIES AND BENCHMARKS - GRANT PARK **BIKE PATH** ALIGNMENT, TIES AND BENCHMARKS - KING ARTHUR

SECTION NO.: 13-00084-00-BT PROJECT NO.: M-4003(403) CITY OF NORTHLAKE COOK COUNTY

JOB NO.: C-91-073-15 R 12 E

3rd P.M.

	11 12 L	Sru P.IV
	END PROJECT STA. 62 + 28.29	
and Second	S SANDA	
	356	
	12.00	
	HAZANICA COLOR	
		A TOOL AND AND AND
7 2		
	TORKE SEE	
PROJECT BEGINS STA. 30 + 51.87	74.00	-
A		3505
PROJECT BEGINS	END PROJ STA. 24+5	ECT NO.
STA. 10 + 24.58	WITCHE STORY	ANCE THE PROPERTY OF THE PROPE
		AND
END PROJECT STA. 72 + 31.76	SECTION SO	OUR CONTRACTOR OF THE PARTY OF
SOUTH AVE.		

LOCATION MAP - LEYDEN TOWNSHIP **GROSS LENGTH OF PROJECT**

NET LENGTH OF PROJECT

= 4,839 LINEAL FEET (0.92 MI.) = 4,839 LINEAL FEET (0.92 MI.)

s.	LOCATION
PROFESSIONAL **	APPR
October 8 , 2014	APPR
ANDREW M. PUFUNDT ILLINOIS REGISTRATION No. 062-061729 EXPIRATION DATE: II/30/15	PASSI
D62-057484 S LICENSED PROFESSIONAL ENGINEER	RELEA BID E LIMITI
OCTOBER 8 . 2014	FIMILI


aught lell

ANTHONÝ J. DERICCO

EXPIRATION DATE: 11/30/15

ILLINOIS REGISTRATION No. 062-057484

N OF SECTION INDICATED THUS: - -

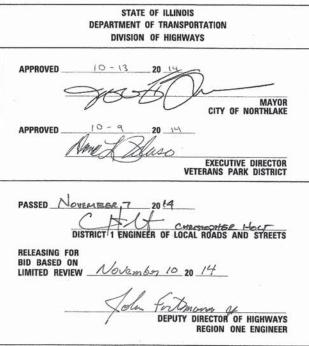

PRINTED BY THE AUTHORITY OF THE STATE OF ILLINOIS

CONTRACT NO. 61A85

SPECIFICATIONS, STANDARDS AND SPECIAL PROVISIONS

ALL CONSTRUCTION SHALL BE DONE IN ACCORDANCE WITH THE "STANDARD SPECIFICATIONS FOR ROAD AND BRIDGE CONSTRUCTION", ADOPTED JANUARY 1, 2012; THE "SUPPLEMENTAL SPECIFICATIONS AND RECURRING SPECIAL PROVISIONS", ADOPTED JANUARY 1, 2014; THE LATEST EDITION OF THE "ILLINOIS MANUAL ON UNIFORM TRAFFIC CONTROL DEVICES FOR STREETS AND HIGHWAYS", (IMUTCD); "THE STANDARD SPECIFICATIONS FOR WATER AND SEWER MAIN CONSTRUCTION IN ILLINOIS" JULY 2009 SIXTH EDITION, THE "DETAILS" IN THE PLANS AND THE "SPECIAL PROVISIONS" INCLUDED IN THE CONTRACT DOCUMENTS.

ALL WORK SHALL BE PERFORMED IN ACCORDANCE WITH APPLICABLE LAWS AND GOVERNMENT AGENCY REGULATIONS AND RULES; AUTHORITIES HAVING JURISDICTION; OSHA REGULATIONS AND RULES; AND ANY APPLICABLE RULES AND REGULATIONS OF THE STATE OF ILLINOIS OR COOK COUNTY AGENCIES. FURTHERMORE, AND AS RELATED TO THE WORK, THE CONTRACTOR SHALL GIVE NOTICES AND COMPLY WITH APPLICABLE LAWS, ORDINANCES, RULES, REGULATIONS, AND LAWFUL ORDERS OF ALL PUBLIC AUTHORITIES BEARING ON THE SAFETY OF PERSONS OR PROPERTY OR THEIR PROTECTION FROM DAMAGE. INJURY OR LOSS.

ALL TRAFFIC CONTROL AND OTHER ADVISORY SIGNS NEEDED FOR CONSTRUCTION ARE TO BE FURNISHED BY THE CONTRACTOR IN ACCORDANCE WITH SECTION 700 OF THE STANDARD SPECIFICATIONS.

THE CONTRACTOR SHALL BE RESPONSIBLE FOR CONTACTING THE OWNERS OF ALL EXISTING FACILITIES SO THAT THE UTILITIES AND THEIR APPURTENANCES MAY BE LOCATED AND ADJUSTED OR MOVED, IF NECESSARY, PRIOR TO THE START OF CONSTRUCTION OPERATIONS. THE CONTRACTOR SHALL COOPERATE WITH ALL UTILITY OWNERS AS PROVIDED FOR IN THE STANDARD SPECIFICATIONS.

THE LOCATIONS OF EXISTING DRAINAGE STRUCTURES, STORM AND SANITARY SEWERS, WATER SERVICE LINES AND OTHER UTILITY LINES ARE APPROXIMATE, AND THE ENGINEER DOES NOT GUARANTEE THEIR ACCURACY. THEIR EXACT HORIZONTAL AND VERTICAL LOCATIONS ARE TO BE DETERMINED IN THE FIELD BY THE CONTRACTOR AT HIS OWN

THE CONTRACTOR SHALL BE RESPONSIBLE FOR THE PROTECTION OF ALL UNDERGROUND OR SURFACE UTILITIES EVEN THOUGH THEY MAY NOT BE SHOWN ON THE PLANS. ANY UTILITY THAT IS DAMAGED DURING CONSTRUCTION SHALL BE REPAIRED OR REPLACED TO THE SATISFACTION OF THE ENGINEER. THIS WORK SHALL BE AT THE CONTRACTOR'S

COORDINATION OF ALL UTILITY WORK INVOLVED IN THE CONSTRUCTION AREA WILL BE DISCUSSED AT THE PRECONSTRUCTION CONFERENCE.

BEFORE STARTING ANY EXCAVATION, THE CONTRACTOR SHALL CALL "JULIE" AT 800-892-0123 FOR FIELD LOCATIONS OF BURIED ELECTRIC, TELEPHONE, GAS AND CABLE TELEVISION FACILITIES. (48 HOURS NOTIFICATION IS REQUIRED.)

STAKING

THE CONTRACTOR SHALL PROTECT AND CAREFULLY PRESERVE ALL SECTION OR SUBSECTION MONUMENTS OR PROPERTY OR REFERENCE MARKERS UNTIL THE ENGINEER, HIS AGENT OR AN AUTHORIZED SURVEYOR HAS WITNESSED OR OTHERWISE REFERENCED

ALL RADII FOR PROPOSED CURB AND GUTTER ARE TO THE EDGE OF PAVEMENT UNLESS OTHERWISE NOTED, AND SHALL BE AS INDICATED ON THE PLANS, ELEVATIONS SHOWN AT POINT OF CURVE, ETC. IS EDGE OF PAVEMENT UNLESS OTHERWISE NOTED.

WATER, STORM SEWER AND SANITARY SEWER

WHENEVER DURING CONSTRUCTION OPERATIONS ANY LOOSE MATERIAL IS DEPOSITED IN THE FLOW LINE OF DRAINAGE STRUCTURES SUCH THAT THE NATURAL FLOW OF WATER IS OBSTRUCTED, IT SHALL BE REMOVED AT THE CLOSE OF EACH WORKING DAY. AT THE CONCLUSION OF CONSTRUCTION OPERATIONS, ALL UTILITY STRUCTURES SHALL BE FREE FROM DIRT AND DEBRIS. THE WORK SPECIFIED ABOVE WILL NOT BE PAID FOR SEPARATELY BUT SHALL BE COMPLETED PER ARTICLE 107.15 OF THE STANDARD

ANY EXISTING OR PROPOSED STORM SEWER DAMAGED BY THE CONTRACTOR DURING CONSTRUCTION SHALL BE REPLACED BY THE CONTRACTOR AT THEIR EXPENSE.

THE CONTRACTOR SHALL NOT OPEN OR SHUT ANY WATER VALVES OR FIRE HYDRANTS WITHOUT PRIOR AUTHORIZATION FROM THE CITY WATER DEPARTMENT. UNAUTHORIZED USE SHALL SUBJECT THE OFFENDER TO ARREST AND PROSECUTION.

COST TO CONNECT EXISTING OR PROPOSED STORM SEWER TO EXISTING OR PROPOSED DRAINAGE STRUCTURE SHALL BE INCLUDED IN THE COST FOR STORM SEWER.

GENERAL NOTES

GENERAL NOTES

- THE CITY OF NORTHLAKE AND ENGINEER SHALL BE NOTIFIED BY THE CONTRACTOR IN WRITING AT LEAST (3) FULL WORKING DAYS PRIOR TO COMMENCEMENT OF CONSTRUCTION.
- THE CONTRACTOR SHALL PROVIDE ALL NECESSARY PROTECTION FOR EXISTING UTILITIES IN CONFORMANCE WITH THE AFFECTED UTILITY COMPANIES' REQUIREMENTS AS MAY BE REQUIRED TO PERFORM THE WORK OF THIS CONTRACT.
- BEFORE BEGINNING CONSTRUCTION, THE CONTRACTOR SHALL VERIFY THE LINE AND GRADES SHOWN ON THE CONTRACT DRAWINGS. IF THERE ARE ANY DISCREPANCIES FROM WHAT IS SHOWN ON THE CONTRACT DRAWINGS, THE CONTRACTOR SHALL IMMEDIATELY REPORT SAME TO THE ENGINEER PRIOR TO PERFORMING WORK. CONTRACTOR SHALL BE RESPONSIBLE FOR COORDINATION OF WORK AS REQUIRED.
- THE CONTRACT DOCUMENTS ARE NOT INTENDED TO SHOW EVERY AND ALL DETAILS OF WORK TO BE PERFORMED OR EQUIPMENT TO BE SUPPLIED. THE INTENT OF THE DOCUMENTS IS TO ILLUSTRATE THE CONCEPTUAL DESIGN AND LAYOUT. THE CONTRACTOR SHALL BE KNOWLEDGEABLE AND REGULARLY ENGAGED IN THE TYPE OF WORK DESCRIBED BY THESE CONTRACT DOCUMENTS, AND SHALL BE RESPONSIBLE FOR UNDERSTANDING THEIR INTENT. ADDITIONAL WORK TO BE CALLED FOR BY THESE PERFORMED OR ITEM OF EQUIPMENT TO BE SUPPLIED WHICH IS NOT SPECIFICALLY CONTRACT DOCUMENTS BUT WHICH IS NECESSARY TO PROVIDE A COMPLETE AND SUCCESSFUL WORKING SYSTEM SHALL BE INCLUDED IN ACCORDANCE WITH ARTICLE 109.04.
- IT IS THE CONTRACTOR'S RESPONSIBILITY TO DETERMINE ALL MATERIAL QUANTITIES AND APPRISE HIMSELF/HERSELF OF ALL CONDITIONS. NO CLAIMS FOR ADDITIONAL COMPENSATION FOR INDIVIDUAL PAY ITEMS WILL BE RECOGNIZED DUE TO THE CONTRACTOR'S FAILURE TO UNDERSTAND THE SCOPE OF WORK.
- THE WORK PERFORMED UNDER THIS CONTRACT SHALL IN NO WAY INTERFERE WITH THE NORMAL OPERATION OF ANY EXISTING UTILITY SERVICE. THE CONTRACTOR SHALL FURNISH ALL NECESSARY ITEMS OF EQUIPMENT REQUIRED TO MAINTAIN SUCH NORMAL OPERATION AT NO ADDITIONAL COST TO THE OWNER. THE COST ASSOCIATED FOR THIS WORK SHALL BE CONSIDERED INCLUDED IN THE COST OF THE CONTRACT.
- CERTAIN INFORMATION SHOWN ON THESE DRAWINGS HAS BEEN OBTAINED FROM DRAWINGS OF RECORD. CONTRACTOR SHALL VERIFY SUCH INFORMATION PRIOR TO ACTUAL START OF WORK. WHERE DISCREPANCIES ARE DISCOVERED THE CONTRACTOR SHALL IMMEDIATELY NOTIFY THE ENGINEER. FAILURE BY THE CONTRACTOR TO IMMEDIATELY NOTIFY THE ENGINEER OF SUCH DISCREPANCIES SHALL RESULT I THE CONTRACTOR BEARING THE FULL BURDEN OF ALL RISKS/COSTS ATTRIBUTED TO THE DISCOVERED DESCREPANCY.
- SOIL EROSION PROTECTION SHALL BE IN ACCORDANCE WITH IEPA STANDARDS AND SPECIFICATIONS FOR SOIL EROSION AND SEDIMENT CONTROL. ALL DISTURBED AREAS (NOT IMPERVIOUS IN NATURE) SHALL BE FINE GRADED, TOPSOIL RESTORED (MIN 6 INCHES) AND SEED/MULCH APPLIED UNLESS OTHERWISE SPECIFIED ON THE PLANS.

MISCELLANEOUS

DIMENSIONS: IT SHALL BE THE CONTRACTOR'S RESPONSIBILITY TO VERIFY ALL DIMENSIONS AND CONDITIONS EXISTING IN THE FIELD PRIOR TO ORDERING MATERIALS

ALL SAWCUTTING SHALL BE INCLUDED TO REMOVAL ITEMS AND SHALL BE PERFORMED PRIOR TO BEGINNING REMOVAL. ANY ITEMS OF WORK REMOVED PRIOR TO SAWCUTTING WILL NOT BE MEASURED FOR PAYMENT.

RELOCATING EXISTING SIGNS: EXISTING SIGNS WHICH ARE IN CONFLICT WITH PROPOSED IMPROVEMENTS SHALL BE REMOVED AND REINSTALLED UPON COMPLETION OF TOPROVEMENTS SHALL BE REMOVED AND REINSTALLED UPON COMPLETION OF CONFLICTING IMPROVEMENTS IN ACCORDANCE WITH THE ILLINOIS DEPARTMENT OF TRANSPORTATION "MANUAL OF UNIFORM TRAFFIC CONTROL DEVICES" AND THE "STANDARD SPECIFICATIONS FOR ROAD AND BRIDGE CONSTRUCTION". STOP SIGNS, SPEED LIMIT SIGNS, AND STREET NAME SIGNS SHALL BE UP AND VISIBLE AT ALL TIMES. THIS WORK SHALL BE PERFORMED PER ARTICLE 107.25 OF THE STANDARD SPECIFICATIONS.

PROPOSED CONCRETE CURB AND GUTTER SHALL BE TRANSITIONED TO EXISTING CURB AND GUTTER OVER A LENGTH OF 5 FEET. THIS WORK SHALL BE PAID FOR AT THE CONTRACT UNIT PRICE PER FOOT FOR COMBINATION CONCRETE CURB AND GUTTER.

ANY DEFACED WORK SHALL BE CORRECTED OR REPLACED BY THE CONTRACTOR AT HIS SOLE EXPENSE PRIOR TO FINAL PAYMENT. THE CITY WILL COOPERATE WITH THE CONTRACTOR TO MINIMIZE VANDALISM, BUT THE CONTRACTOR SHALL BE ULTIMATELY RESPONSIBLE TO CORRECT ANY DAMAGE PER CONDITIONS OF ARTICLE 107.30 OF THE STANDARD SPECIFICATIONS.

THE CONTRACTOR SHALL BE SOLELY RESPONSIBLE FOR JOB SITE SAFETY AS WELL AS SUPERVISION / DIRECTION AND MEANS / METHODS OF CONSTRUCTION.

COMMONWEALTH EDISON PROPERTY

NO VEHICLES, EQUIPMENT OR ANYTHING ELSE (INCLUDING, BUT NOT LIMITED TO, ANY EQUIPMENT ATTACHED TO VEHICLES OR EQUIPMENT SUCH AS ANTENNAS, AND/OR ANY TREES, SHRUBS OR OTHER PLANS OR VEGATATION PLANTED OR INSTALLED ON PROPERTY) HAVING A HEIGHT WHICH EXCEEDS THE MAXIMUM ALLOWABLE HEIGHT UNDER OSHA'S HEIGHT STANDARDS SHALL BE DRIVEN, MOVED OR TRANSPORTED ON PROPERTY WITHOUT PROPERTY OWNER'S WRITTEN CONSENT.

NO ACTIVITIES WILL BE PERMITTED WHICH COULD RESULT IN A WIRE TO GROUND ELECTRICAL CONTACT OR DAMAGE TO TOWERS OR POLES.

NO PAVING OR GRADING WORK (OR SIMILAR WORK) OF ANY KIND WILL BE UNDERTAKEN WITHIN A TEN (10) FOOT RADIUS OF ANY TOWER LEG (OR SIMILAR EQUIPMENT, IMPROVEMENT OR FACILITY) OF COMED.

NOTIFICATION SHALL BE GIVEN TO COMED AT LEAST SEVENTY TWO (72) HOURS PRIOR THE COMMENCEMENT OF ANY ACTIVITY ON COMED PROPERTY. TELEPHONE NUMBER IS 866-340-2841

CONTRACTOR TO PROVIDE INSURANCE CERTIFICATE TO MEET REQUIREMENTS OF COMED PRIOR TO BEGINNING ANY ACTIVITIES ONSITE.

DISTRICT ONE STANDARDS

- TRAFFIC CONTROL AND PROTECTION FOR SIDE ROADS, INTERSECTIONS. AND DRIVEWAYS
- TC-13 DISTRICT ONE TYPICAL PAVEMENT MARKINGS

HIGHWAY STANDARDS

- 000001-06 STANDARD SYMBOLS, ABBREVIATIONS, AND PATTERNS
- TEMPORARY EROSION CONTROL SYSTEMS 280001-07
- 542401-01 METAL END SECTION FOR PIPE CULVERTS
- CONCRETE CURB TYPE B AND COMBINATION CONCRETE 606001-06 CURB AND GUTTER
- 664001-02 CHAIN LINK FENCE
- 701006-05 OFF-RD OPERATIONS, 2L, 2W, 15' (4.5M) TO 24" (600MM) FROM PAVEMENT EDGE
- 701301-04 LANE CLOSURE, 2L, 2W, SHORT TIME OPERATIONS
- URBAN LANE CLOSURE, 2L, 2W UNDIVIDED 701501-06
- 701801-05 SIDEWALK, CORNER OR CROSSWALK CLOSURE
- 701901-04 TRAFFIC CONTROL DEVICES
- 720001-01 SIGN PANEL MOUNTING DETAILS
- APPLICATIONS OF TYPES A&B METAL POSTS 729001-01 (FOR SIGNS & MARKERS)
- 780001-05 TYPICAL PAVEMENT MARKINGS

TO STA.

TLE NAME = DESIGNED - AMP REVISED DRAWN - MAK REVISED LOT SCALE = 1 CHECKED - MEW REVISED DATE REVISED LOT DATE = 10/18/2014

STATE OF ILLINOIS DEPARTMENT OF TRANSPORTATION GENERAL NOTES AND HIGHWAY STANDARDS

SHEET NO. OF SHEETS STA.

SCALE:

SECTION	COUNTY	TOTAL	SHEET NO.
13-00084-00-BT	COOK	52	2
	CONTRACT	NO. 6	1A85
		13-00084-00-BT COOK	

SUMMARY OF QUANTITIES

		SUMMARY OF QUANTITIES		TOTAL QUANTITY				
_								
L	CODE NO.	ITEM	UNIT	0028				
+	20100500	TREE REMOVAL, ACRES	ACRE	0.15				
+	20101100	TREE TRUNK PROTECTION	EACH	4				
F	20101200	TREE ROOT PRUNING	EACH	37				
4	20101300	TREE PRUNING (1 TO 10 INCH DIAMETER)	EACH	60				
*	20101350	TREE PRUNING (OVER 10 INCH DIAMETER)	EACH	40				
F	20800150	TRENCH BACKFILL	CUYD	12				
F		GEOTECHNICAL FABRIC FOR GROUND STABILIZATION		1165				
Ļ			SQ YD					
*	25000100	SEEDING, CLASS 1	ACRE	2.5				
*	25000400	NITROGEN FERTILIZER NUTRIENT	POUND	225				
*	25000500	PHOSPHORUS FERTILIZER NUTRIENT	POUND	225				
A	25000600	POTASSIUM FERTILIZER NUTRIENT	POUND	225				
×	25100125	MULCH, METHOD 3	ACRE	2.5				
*	25200200	SUPPLEMENTAL WATERING	UNIT	75				
	28000400	PERIMETER EROSION BARRIER	FOOT	9950				
F		INLET FILTERS	EACH	2				
F								
	30300001	AGGREGATE SUBGRADE IMPROVEMENT	CUYD	385				
-	35102100	AGGREGATE BASE COURSE, TYPE B 9"	SQ YD	6025				
F	40600275	BITUMINOUS MATERIALS (PRIME COAT)	POUND	13110				
	40603335	HOT-MIX ASPHALT SURFACE COURSE, MIX "D", N50	TON	1050				
	44000100	PAVEMENT REMOVAL	SQYD	500				
	44000500	COMBINATION CURB AND GUTTER REMOVAL	FOOT	25				
-	542A0220	PIPE CULVERTS, CLASS A, TYPE 1 15"	FOOT	50				
	542C0213	PIPE CULVERTS, CLASS C, TYPE 1 8"	FOOT	22				
F		METAL END SECTIONS 8"	EACH	2				
		METAL END SECTIONS 15"						
			EACH	2				
*		FIRE HYDRANTS TO BE MOVED	EACH	1				
-	60251200	CATCH BASINS TO BE ADJUSTED WITH NEW TYPE 8 GRATE	EACH	2				
	60603900	COMBINATION CONCRETE CURB AND GUTTER, TYPE B-6.12 (ABUTTING EXISTING PAVEMENT)	FOOT	25				
*	63200310	GUARDRAIL REMOVAL	FOOT	10				
*	66400305	CHAIN LINK FENCE, 6'	FOOT	50				


	The Lineson			STP
_			(iii) - 12-1-12-13	TOTAL QUANTITY
_		SUMMARY OF QUANTITIES		TYPE CODE
	CODE NO.	ITEM	UNIT	0028
×	66900200	NON-SPECIAL WASTE DISPOSAL	CU YD	3295
*	66900450	SPECIAL WASTE PLANS AND REPORTS	L SUM	1
ŀ	66900530	SOIL DISPOSAL ANALYSIS	EACH	2
+	67100100	MOBILIZATION	L SUM	1
t	70102620	TRAFFIC CONTROL AND PROTECTION, STANDARD 701501	L SUM	1
t	70102640	TRAFFIC CONTROL AND PROTECTION, STANDARD 701801	L SUM	1
ł	72000100	SIGN PANEL - TYPE 1	SQ FT	3
ł	72900100	METAL POST - TYPE A	FOOT	13
*	78000400	THERMOPLASTIC PAVEMENT MARKING - LINE 6"	FOOT	45
I		THERMOPLASTIC PAVEMENT MARKING - LINE 12"	FOOT	32
T		THERMOPLASTIC PAVEMENT MARKING - LINE 24"	FOOT	6
Ĺ				
		ELECTIC SERVICE INSTALLATION	EACH	1
Ė	80400200	ELECTRIC UTILITY SERVICE CONNECTION	L SUM	1
	81028200	UNDERGROUND CONDUIT, GALVANIZED STEEL, 2" DIA.	FOOT	40
	81028210	UNDERGROUND CONDUIT, GALVANIZED STEEL, 2 1/2" DIA.	FOOT	75
•	81028720	UNDERGROUND CONDUIT, COILABLE NONMETALLIC CONDUIT, 1" DIA.	FOOT	1950
*	81028730	UNDERGROUND CONDUIT, COILABLE NONMETALLIC CONDUIT, 1 1/4" DIA.	FOOT	9650
	81400730	HANDHOLE, COMPOSITE CONCRETE	EACH	13
·	81702120	ELECTRIC CABLE IN CONDUIT, 600V (XLP-TYPE USE) 1/C NO. 8	FOOT	35930
	81702150	ELECTRIC CABLE IN CONDUIT, 600V (XLP-TYPE USE) 1/C NO. 2	FOOT	150
	82500335	LIGHTING CONTROLLER, PEDESTAL MOUNTED, 240 VOLT, 100 AMP	EACH	1
	83600200	LIGHT POLE FOUNDATION, 24" DIAMETER	FOOT	366
*	C2012460	SHRUB, VIBURNUM LENTAGO (NANNYBERRY VIBURNUM), 5' HEIGHT, BALLED AND BURLAPPED	EACH	5
	The second	FLOOD LIGHTING UNIT	EACH	2
		ORNAMENTAL LIGHT UNIT. COMPLETE	EACH	61
Ļ				20 1) - 1510 1 1 1 1 1 1 1 1 1 1 1 1 1 1 1 1 1
-		TOPSOIL FURNISH AND PLACE, SPECIAL	CUYD	620
		STABILIZED CONSTRUCTION ENTRANCE	SQ YD	196
F		CONSTRUCTION LAYOUT	L SUM	1
F	Z0022800	FENCE REMOVAL	FOOT	300
		MAINTAIN EXISTING LIGHTING SYSTEM S SPECIAL PROVISION	CAL MO	2

FILE NAME =	USER NAME = esidorczuk	DESIGNED - AMP	REVISED -	
N:\NORTHLAKE\940032DC131\C1v1	1\QUA_940032dc131_01,sht	DRAWN - MAK	REVISED -	
	PLOT SCALE = 1'	CHECKED - MEW	REVISED -	
	PLOT DATE = 10/16/2014	DATE -	REVISED -	

STATE OF ILLINOIS
DEPARTMENT OF TRANSPORTATION

SCALE:

	CHRARA	ADV	OF O	LABITIT	IFC	F.A.P RTE.	SE	CTION	COUNTY	TOTAL	SHEET NO.
SUMMARY OF QUANTITIES					IE9	-	13-000	84-00-BT	соок	52	3
_	r								CONTRACT	NO. 6	1A85
	SHEET NO.	OF	SHEETS	STA.	TO STA.	FED. ROAD	DIST. NO.	ILLINOIS FED.	AID PROJECT		

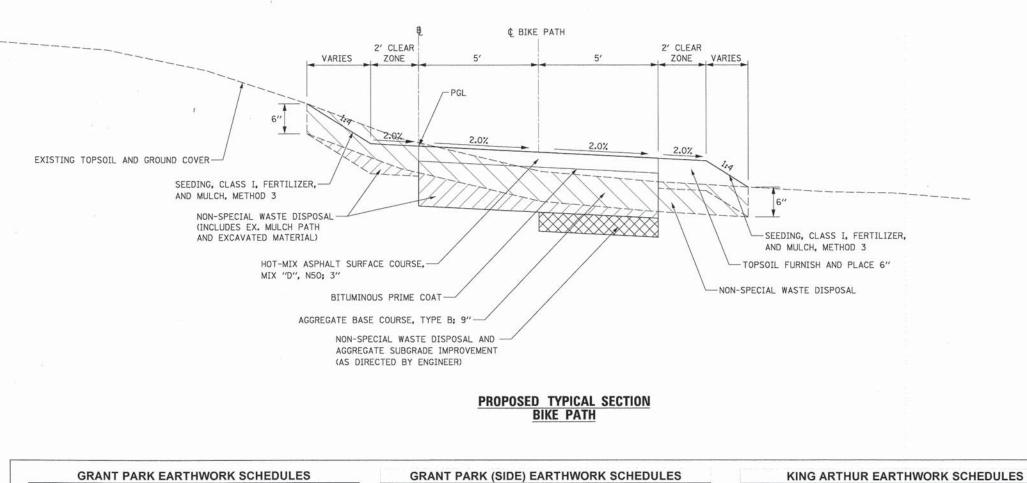

HOT-MIX ASPHALT MIXTURE	REQUIREMENTS
MIXTURE TYPE	AIR VOIDS & Ndes
BIKE PATH	
HOT-MIX ASPHALT SURFACE COURSE, MIX "D", N50	4% @ 50 GYR

THE UNIT WEIGHT USED TO CALCULATE ALL HOT-MIX ASPHALT SURFACE MIXTURE QUANTITIES IS 112 LBS/SY/IN.

THE "AC TYPE" FOR POLYMERIZED HMA MIXES SHALL BE "SBS/SBR PG 76-22" AND FOR NON-POLYMERIZED HMA THE "AC TYPE" SHALL BE "PG 64-22" UNLESS MODIFIED BY DISTRICT ONE SPECIAL PROVISIONS.

FOR HMA FULL DEPTH "AC TYPE" SEE SPECIAL PROVISIONS.

FOR USE OF RECYCLED MATERIALS SEE SPECIAL PROVISIONS.



TYPICAL SECTION NOTES:

- THE BIKE PATH AND CLEAR ZONE MAXIMUM CROSS SLOPE IS 2%. SEE CROSS SECTIONS FOR DIRECTION OF SLOPE.
- 2. EMBANKMENT IS INCLUDED IN THE COST OF NON-SPECIAL WASTE DISPOSAL.
- STOCKPILING LOCATIONS WILL BE DETERMINED IN THE FIELD DURING CONSTRUCTION.

	CUT (SQ FT)	FILL (SQ FT)	PROPOSED TOPSOIL (SQ FT)	EXCAVATION (CU YD)	EMBANKMENT (CU YD)	EARTHWORK BALANCE ("+" = WASTE, "," = SHORTAGE) NON-SPECIAL WASTE DISPOSAL (CU YD)	TOPSOIL FURNISH AND PLACE, 6" (CU YD)
TOTALS	100000000000000000000000000000000000000	T-International		1194.6	5.7	1188.9	233.8
GRANT PARK	-						
10+24.67	14.3	0.0	2.0	0.0	0.0	0.0	0.0
10+50.00	28.6	0.0	4.8	20.1	0.0	20.1	3.2
11+00.00	26.9	0.0	5.0	51.4	0.0	51.4	9.1
11+50.00	18.7	0.0	3.0	42.2	0.0	42.2	7.4
12+00.00	17.0	0.0	3.0	33.1	0.0	33.1	5.6
12+50.00	16.5	0.0	2.5	31.0	0.0	31.0	5,1
13+00.00	10.5	0.0	2.8	25.0	0.0	25.0	4.9
13+50.00	23.3	0.0	2.5	31.3	0.0	31.3	4.9
14+00.00	22.2	0.0	2.3	42.1	0.0	42.1	4.4
14+50.00	27.9	0.0	3.8	46.4	0.0	46.4	5.6
15+00.00	22.8	0.0	8.3	46.9	0,0	46.9	11.2
15+50.00	40.2	0.0	4.8	58.3	0.0	58.3	12.1
16+00.00	20.0	0.0	2.5	55.7	0.0	55.7	6.8
16+50.00	32.1	0.0	5.0	48.2	0.0	48.2	6.9
17+00.00	16.2	1.4	5.5	44.7	1.3	43.4	9.7
17+50.00	24.6	0.0	2.3	37.8	1.3	36.5	7.2
17+69.23	25.8	0.0	3.0	17.9	0.0	17.9	1.9
18+17.65	13.4	0.0	2.5	35.1	0.0	35.1	4.9
18+50.00	13.2	0.0	3.8	15.9	0.0	15.9	3.8
19+00.00	15.3	0.0	4.0	26.4	0.0	26.4	7.2
19+50.00	14.7	0.0	3.0	27.8	0.0	27.8	6.5
20+00.00	12.9	0.0	2.3	25.6	0.0	25.6	4.9
20+50.00	31.4	0.0	6.5	41.0	0.0	41.0	8.1
20+70.00	53.8	0.1	9.5	31.6	0.0	31.5	5.9
20+80.00	42.1	0.1	9.8	17.8	0.0	17.7	3.6
21+00.00	28.6	0.0	9.5	26.2	0.0	26.1	7.1
21+13.72	13.1	0.1	2.3	10.6	0.0	10.6	3.0
21+50.00	11,3	0.0	2.5	16.4	0,1	16.3	3.2
22+00.00	10.8	0.0	3.0	20.5	0.0	20,5	5.1
22+50.00	8.8	0.0	2.8	18,1	0.0	18,1	5.4
23+00.00	26.4	0.0	7.0	32.6	0.0	32.6	9.1
23+40.00	22.1	0.0	6.0	35.9	0.0	35.9	9.6
23+50.00	11.2	0.3	2.8	6.2	0.1	6.1	1,6
23+82.07	20.9	0.4	7.3	19.1	0.4	18.6	6.0
24+00.00	50.2	0.0	7.0	23.6	0.1	23.5	4.7
24+15.08	121,3	0.0	11.0	47.9	0.0	47.9	11.2
24+50.00	8.7	3.5	11.0	84.1	2,3	81.8	16.7

B

| CUT (8Q FT) | FILL | PROPOSED | TOPSOIL (8Q FT) | (8Q

	CUT (SQ FT)	FILL (SQ FT)	PROPOSED TOPSOIL (SQ FT)	EXCAVATION (CU YD)	EMBANKMENT (CU YD)	EARTHWORK BALANCE ("+" = WASTE, "-" = SHORTAGE) NON-SPECIAL WASTE DISPOSAL (CU YD)	TOPSOIL FURNISH AND PLACE, 6" (CU YD)
TOTALS				1725.5	112.8	1612.7	352.4
KING ARTHUR							
30+52.42	11.8	0.0	2.5	0.0	0.0	0.0	0.0
31+00.00	8.6	0.1	3.3	18.0	0.1	17.9	5.1
31+50.00	11.2	0.0	2.5	18.3	0.1	18.2	5.4
32+00.00	11.8	0.0	2.5	21.3	0.0	21.3	4.6
32+50.00	11.1	0,0	2.5	21.2	0,0	21.2	4.6
33+00.00	10.9	0.0	2.5	20.4	0.0	20.4	4.6
33+50.00	12.5	0.0	2.3	21.7	0.0	21.7	4,4
34+00.00	13,5	0.0	2.5	24.1	0.0	24.1	4.4
34+50.00	11.5	0.0	2.1	23.1	0.0	23.1	4.3
35+00.00	12.0	0.0	2.0	21.8	0.0	21.8	3,8
35+50.00	10.3	0.0	3.0	20.6	0.0	20.6	4.6
36+00.00	9.2	0.0	3.0	18.1	0.0	18.1	5.6
38+50.00	9.9	0.0	3.0	17.7	0.0	17.7	5.6
37+00.00	12.1	0.0	2.0	20.4	0.0	20.4	4.6
37+50.00	11.4	0.0	2.0	21.8	0.0	21.8	3.7
38+00.00	14.3	0.0	2.5	23.8	0.0	23.8	4.2
38+50.00	12.4	0.0	2.5	24.7	0,0	24.7	4.6
39+00.00	11,2	0.0	2.3	21.9	0.0	21.9	4.4
39+50.00	10.6	0.0	2.5	20.2	0.0	20.2	4.4
40+00.00	11.7	0.0	2.3	20.6	0.0	20,6	4.4
40+50.00	14.5	0.0	2.5	24.3	0.0	24,3	4.4
41+00.00	56.8	0.0	9.0	66.0	0.0	66.0	10.6
41+36,22	1.0	121,5	21.0	38.8	81.5	-42.7	20.1
41+50.00	15.4	0.0	2.5	4.2	31.0	-26.8	6.0

	CUT (SQ FT)	FILL (SQ FT)	PROPOSED TOPSOIL (SQ FT)	(CU YD)	EMBANKMENT (CU YD)	EARTHWORK BALANCE ("+" = WASTE, "-" = SHORTAGE) NON-SPECIAL WASTE DISPOSAL (CU YD)	TOPSOIL FURNISH AND PLACE, 6" (CU YD)
TOTALS			1000	1725.5	112.8	1612.7	352,4
KING ARTHUR							
42+00.00	12.8	0.0	2.5	26,1	0.0	26,1	4.6
42+50.00	9.4	0.0	3.0	20.6	0.0	20.6	5.1
43+00.00	10.4	0.0	2.3	18.3	0.0	18.3	4.9
43+50.00	12.0	0.0	2.0	20.7	0.0	20.7	4.0
44+00.00	52.4	0.0	8,5	59.6	0.0	59.6	9.7
44+36.50	63.6	0.1	8.8	78.4	0.1	78.3	11.7
44+50.00	46.2	0.0	7.8	27.5	0.0	27.4	4.2
45+00.00	28.7	0.0	5.6	69.4	0.0	69.4	12.4
45+50.00	16.3	0.0	3.0	41.7	0.0	41.7	8.0
46+00.00	8.4	0.0	3.4	22.9	0.0	22.9	5.9
46+50.00	13.3	0.0	2.5	20.1	0.0	20.1	5.5
47+00.00	15.0	0.0	3.0	26.2	0.0	26.2	5.1
47+50,00	11.0	0.0	2.5	24.1	0.0	24.1	5.1
48+00.00	12.8	0.0	2.3	22.0	0.0	22.0	4.4
48+50.00	11.7	0.0	2.0	22.7	0.0	22.7	4.0
49+00.00	8.2	0.0	3.0	18.4	0.0	18.4	4.6
49+50.00	10.9	0.0	2.3	17.7	0.0	17.7	4.9
50+00.00	16.4	0.0	3.0	25.3	0.0	25.3	4.9
50+50.00	11.7	0.0	2.3	26.0	0.0	26.0	4.9
51+00.00	12.7	0.0	2.3	22.6	0.0	22.6	4.3
51+50.00	27.4	0.0	5.0	37.1	0.0	37.1	6.8
52+00.00	15.6	0.0	3.0	39.8	0.0	39.8	7.4
52+50.00	13.6	0.0	2.5	27.0	0.0	27.0	5.1
53+00.00	12.3	0.0	2.0	24.0	0.0	24.0	4.2
53+50.00	15.4	0.0	3.0	25.6	0.0	25.6	4.6
54+00.00	12.6	0.0	2.0	25.9	0.0	25.9	4.6
54+50.00	13.2	0.0	2.3	23.9	0.0	23.9	4.0
55+00.00	10.9	0.0	2.3	22.3	0.0	22.3	4.3
55+50.00	12.7	0.0	2.5	21.9	0.0	21.9	4.4
56+00.00	12.4	0.0	2.0	23.2	0.0	23.2	4.2
56+50.00	14.4	0.0	2.0	24.8	0.0	24.8	3.7
57+00.00	12.0	0.0	2.3	24.4	0.0	24.4	4.0
57+50.00	11.7	0.0	2.0	21.9	0.0	21.9	4.0
58+00.00	15.0	0.0	2.5	24.7	0.0	24.7	4.2
58+50.00	11.9	0.0	2.3	24.9	0.0	24.9	4.4
59+00.00	13.3	0.0	2.3	23.3	0.0	23.3	4.3
59+50.00	12.8	0.0	2.3	24.2	0.0	24.2	4.3
60+00.00	13.5	0.0	2.5	24.2	0.0	24.4	4.5
60+50.00	15.1	0.0	2.5	26.5	0.0	26.5	4.6
61+00.00	13.9	0.0	2.5	26.5	0.0	26.9	4.6
	15.2	0.0	3.6		0.0		5.5
61+50.00		0.0		26.9		26.9	
62+00.00	11.7	0.0	2.3	13.8	0.0	24.9 13.8	5,5


RTHWORK SUMMARY				G. a. arg arg
	EXCAVATION (CU YD)	EMBANKMENT (CU YD)	EARTHWORK BALANCE ("+" = WASTE, "-" = SHORTAGE) NON-SPECIAL WASTE DISPOSAL (CU YD)	TOPSOIL FURNISH AND PLACE, 6" (CU YD)
PROJECT TOTALS	3023.0	119.2	2903.8	616.9
GRANT PARK	1194.6	5.7	1188.9	233.8
STA. 10+24 - STA. 24+50				
GRANT PARK (SIDE)	103.0	0.7	102.2	30.6
STA. 70+00 - 72+23				
KING ARTHUR	1725.5	112.8	1612.7	352.4
STA, 30+52 - STA, 62+28				


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Lancard Control of the Control of th	PLOT DATE = 10/16/2014	DATE -	REVISED -

STATE OF ILLINOIS
DEPARTMENT OF TRANSPORTATION

				ONS AND CHEDULE	
NOT TO SCALE	SHEET NO.	OF	SHEETS	STA.	

-	15 000	01 00 01	CONTRACT	02	1A85
_	13-000	84-00-BT	COOK	52	4
A.P	SE	CTION	COUNTY	TOTAL	SHEET NO.

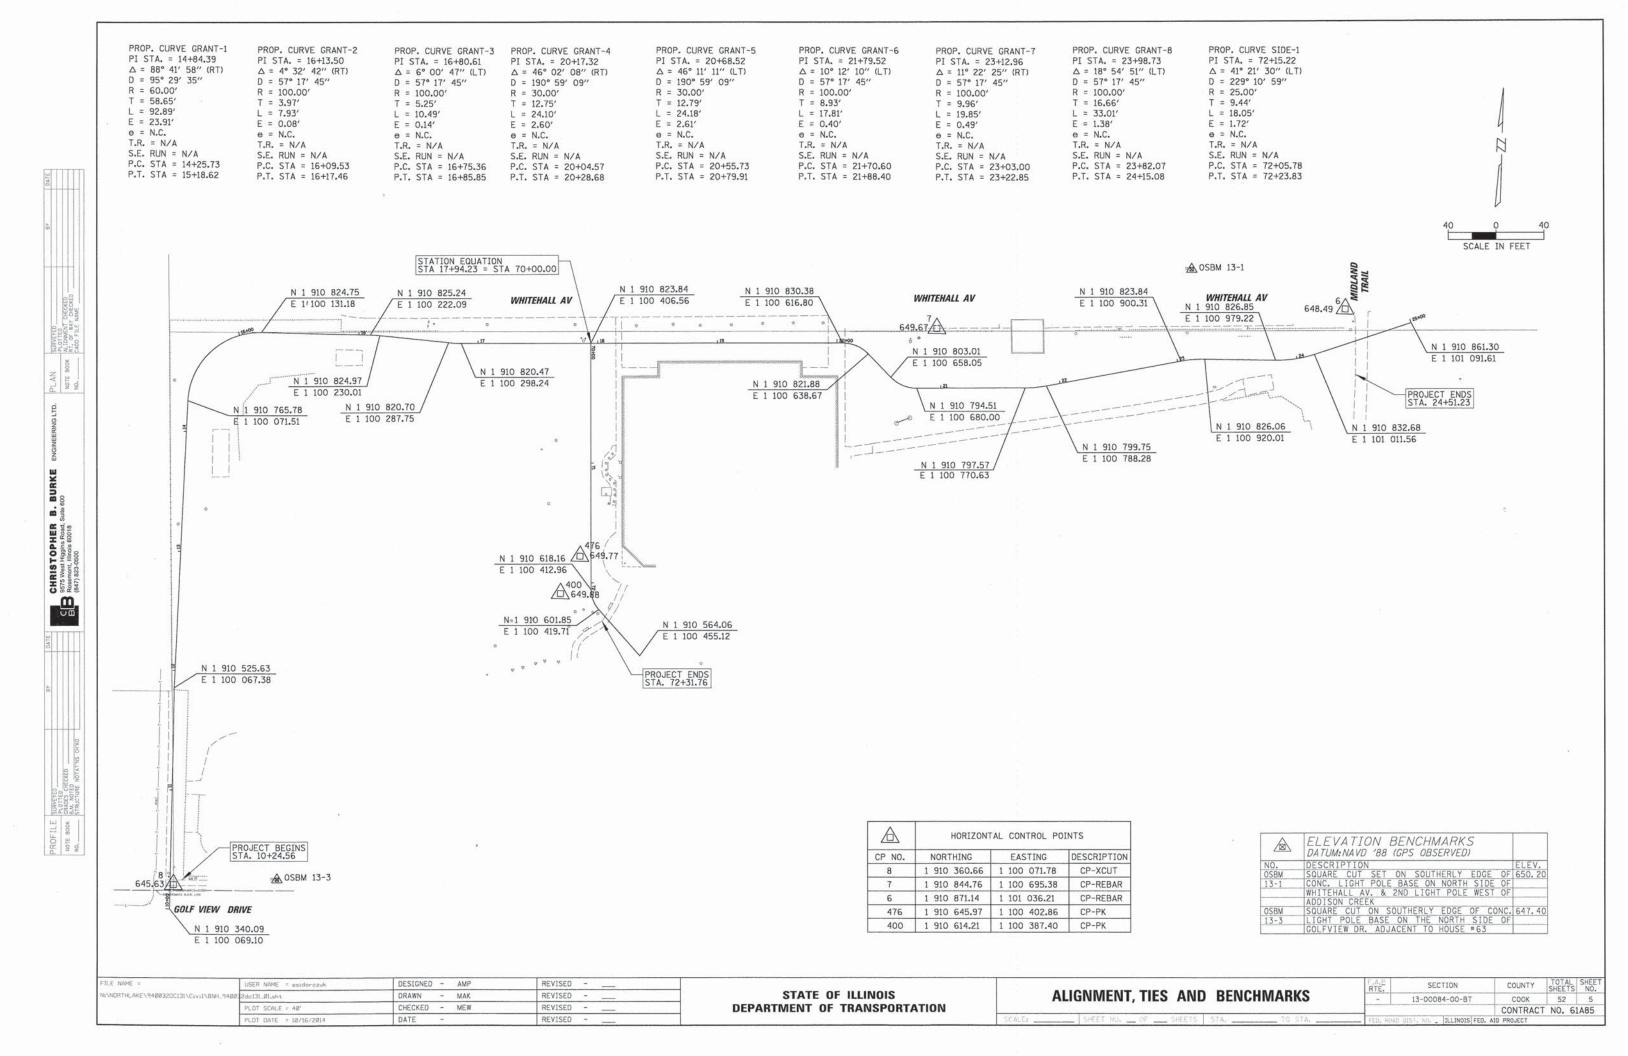

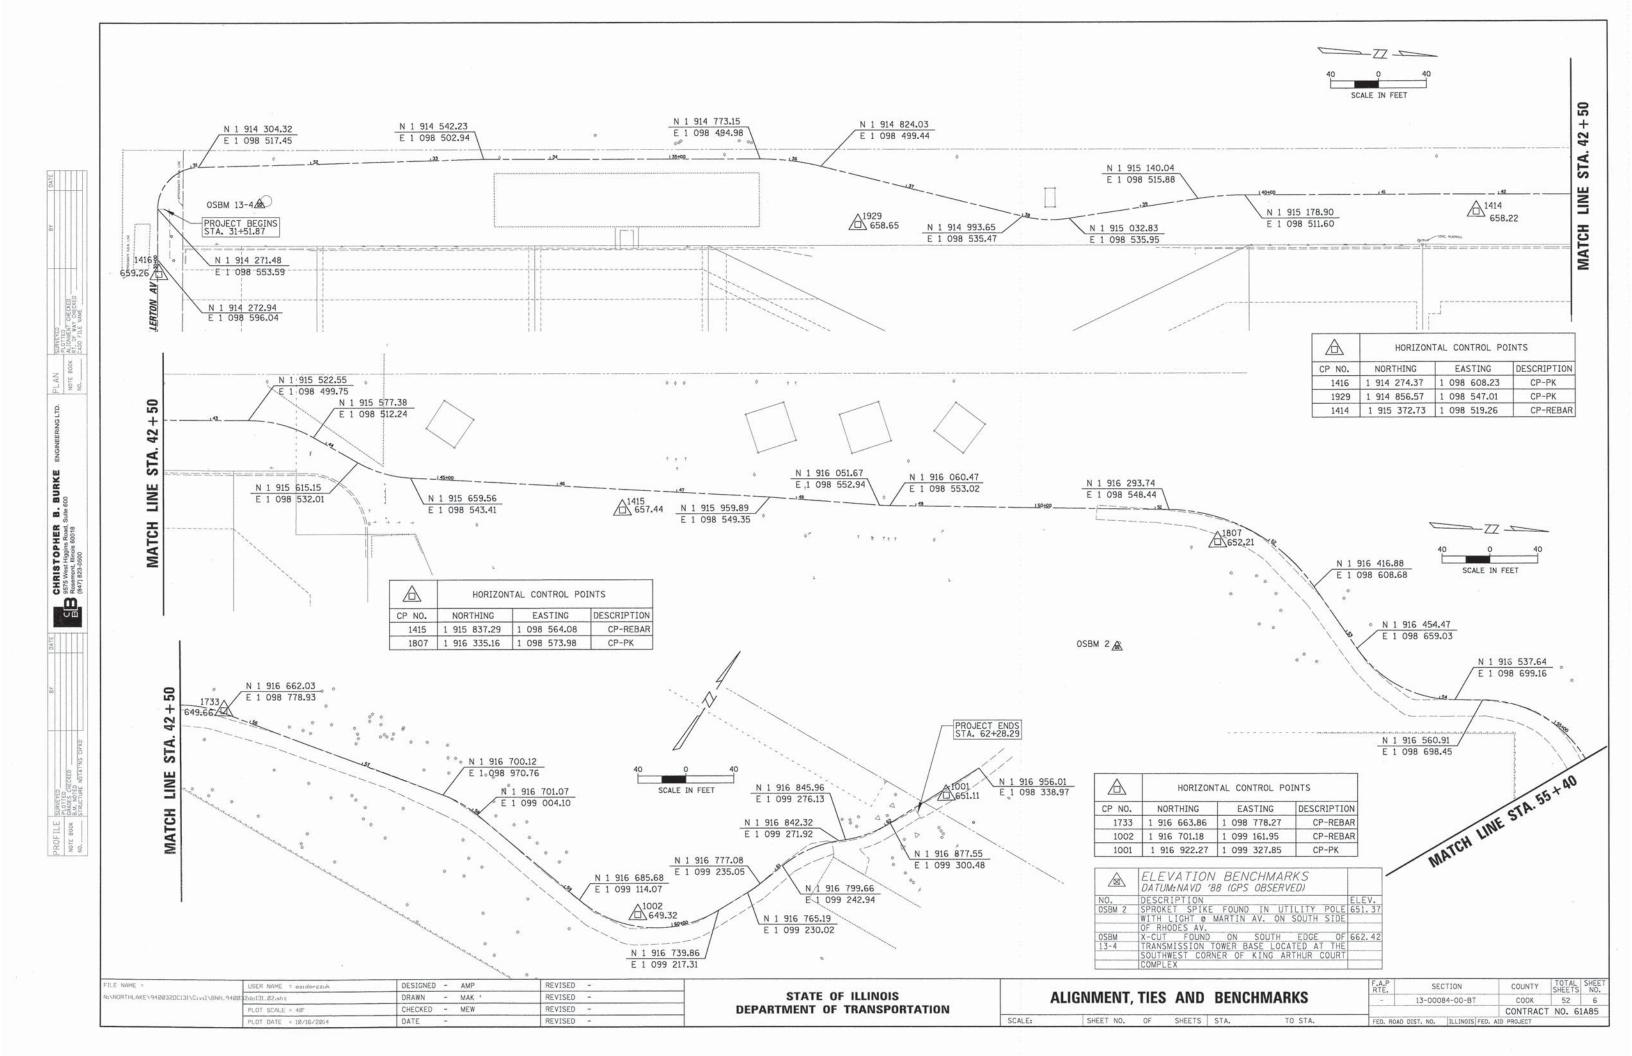

PROP. CURVE KING-1 PROP. CURVE KING-2 PROP. CURVE KING-3 PROP. CURVE KING-4 PROP. CURVE KING-5 PI STA. = 30+86.12 PI STA. = 36+01.22 PI STA. = 38+20.08 PI STA. = 39+68.22 PI STA. = 43+60.69 Δ = 88° 29′ 05″ (RT) $\triangle = 13^{\circ} 58' 14'' (RT)$ $\Delta = 22^{\circ} 35' 44'' (LT)$ $\Delta = 8^{\circ} 37' 30'' (RT)$ $\Delta = 29^{\circ} 37' 09'' (RT)$ D = 163° 42′ 08" D = 27° 17′ 01″ D = 57° 17′ 45″ D = 22° 02' 13" D = 52° 05' 13" R = 35.00'R = 210.00'R = 100.00'R = 260.00'R = 110.00'T = 34.09'T = 25.73'T = 19.98'T = 19.61'T = 29.08'L = 54.05'L = 51.20'L = 39.44'L = 39.14'L = 56.86'E = 13.86'E = 1.57' E = 1.98'E = 0.74'E = 3.78'P.C. STA = 30+52.04P.C. STA = 35+75.49P.C. STA = 38+00.10P.C. STA = 39+48.61P.C. STA = 43+31.60P.T. STA = 31+06.09P.T. STA = 36+26.70P.T. STA = 38+39.54P.T. STA = 39+87.75P.T. STA = 43+88.47 PROP. CURVE KING-14 PROP. CURVE KING-15 PROP. CURVE KING-11 PROP. CURVE KING-12 PROP. CURVE KING-13 PI STA. = 61+33.17 PI STA. = 61+84.56 PI STA. = 57+89.19 PI STA. = 59+88.58 PI STA. = 60+76.12 $\Delta = 19^{\circ} 11' 58'' (RT)$ $\Delta = 23^{\circ} \ 00' \ 25'' \ (LT)$ $\Delta = 71^{\circ} 19' 17'' \text{ (LT)}$ $D = 57^{\circ} 17' 45''$ $\Delta = 29^{\circ} 53' 11'' (RT)$ $\Delta = 7^{\circ} 23' 59'' (LT)$ D = 57° 17′ 45″ R = 100.00'R = 100.00'R = 100.00'R = 100.00'R = 100.00'T = 20.35'T = 16.91'T = 26.69'T = 71.75'T = 6.47'L = 40.15' L = 52.16' L = 33.51'L = 124.48' L = 12.91'E = 1.42'E = 3.50'E = 2.05'E = 23.08'E = 0.21'P.C. STA = 60+69.65 P.C. STA = 61+06.48 P.C. STA = 61+64.21P.C. STA = 57+72.28 P.C. STA = 59+16.83 P.T. STA = 58+05.79P.T. STA = 61+58.64 P.T. STA = 62+04.37 P.T. STA = 60+82.56P.T. STA = 60+41.31

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	PLOT SCALE = 40°	CHECKED - MEW	REVISED -	
	PLOT DATE = 10/16/2014	DATE -	REVISED -	1-7/

STATE OF ILLINOIS
DEPARTMENT OF TRANSPORTATION

SCALE:

PROP. CURVE KING-6

PI STA. = 44+54.65

D = 57° 17′ 45"

R = 100.00'

T = 23.56'

L = 46.27'

E = 2.74'

 $\Delta = 26^{\circ} 30' 35'' (LT)$

P.C. STA = 44+31.10

P.T. STA = 44+77.36

PROP. CURVE KING-7

PI STA. = 48+74.00

 $\Delta = 3^{\circ} 21' 40'' (LT)$

P.C. STA = 48+69.60

P.T. STA = 48+78.40

D = 38° 11′ 50″

R = 150.00'

T = 4.40'

L = 8.80'

E = 0.06'

PROP. CURVE KING-8

 $\Delta = 54^{\circ} 22' 55'' (RT)$

PI STA. = 51+88.77

P.C. STA = 51+11.71

P.T. STA = 52+54.09

D = 38° 11′ 50″

R = 150.00'

T = 77.06'

L = 142.37'

E = 18.64'

PROP. CURVE KING-9

PI STA. = 53+68.97

D = 57° 17′ 45″

R = 100.00'

T = 52.06'

L = 95.99'

E = 12.74'

 $\Delta = 54^{\circ} 59' 57'' \text{ (LT)}$

P.C. STA = 53+16.91

P.T. STA = 54+12.90

PROP. CURVE KING-10

PI STA. = 55+20.86

 $\Delta = 80^{\circ} 30' 41'' (RT)$

P.C. STA = 54+36.18

P.T. STA = 55+76.70

D = 57° 17′ 45″

R = 100.00'

T = 84.67'

L = 140.52'

E = 31.03'


ALIGNMENT, TIES AND BENCHMARKS


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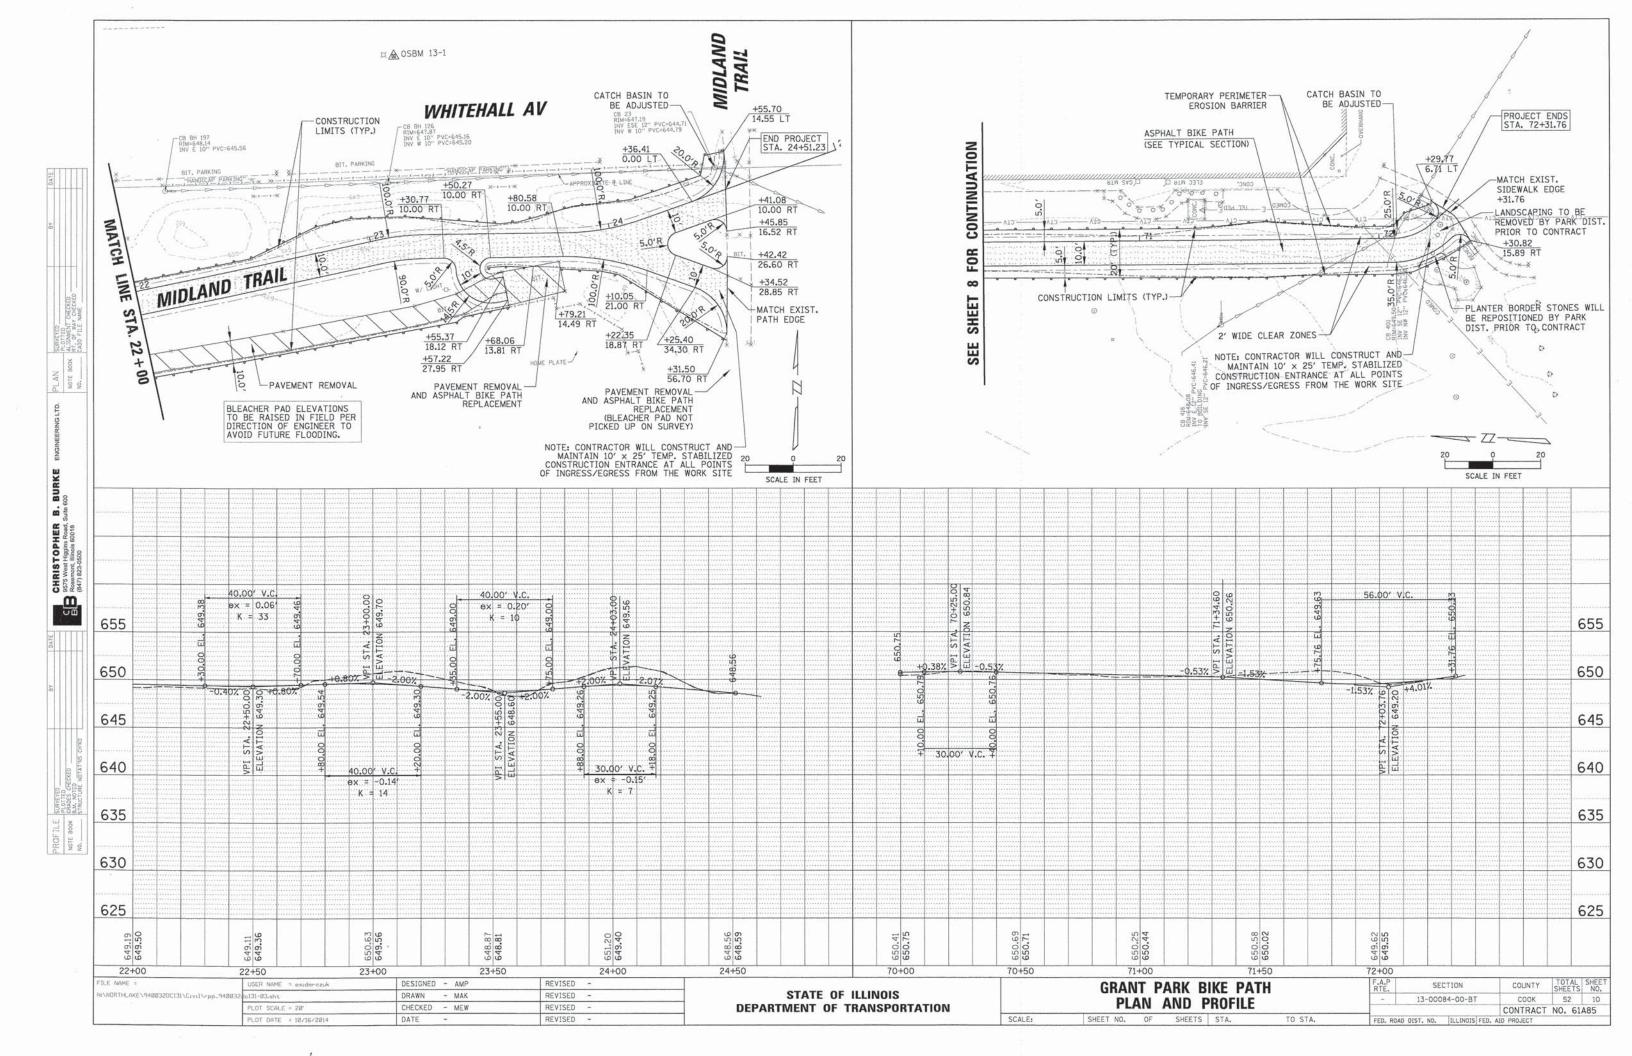
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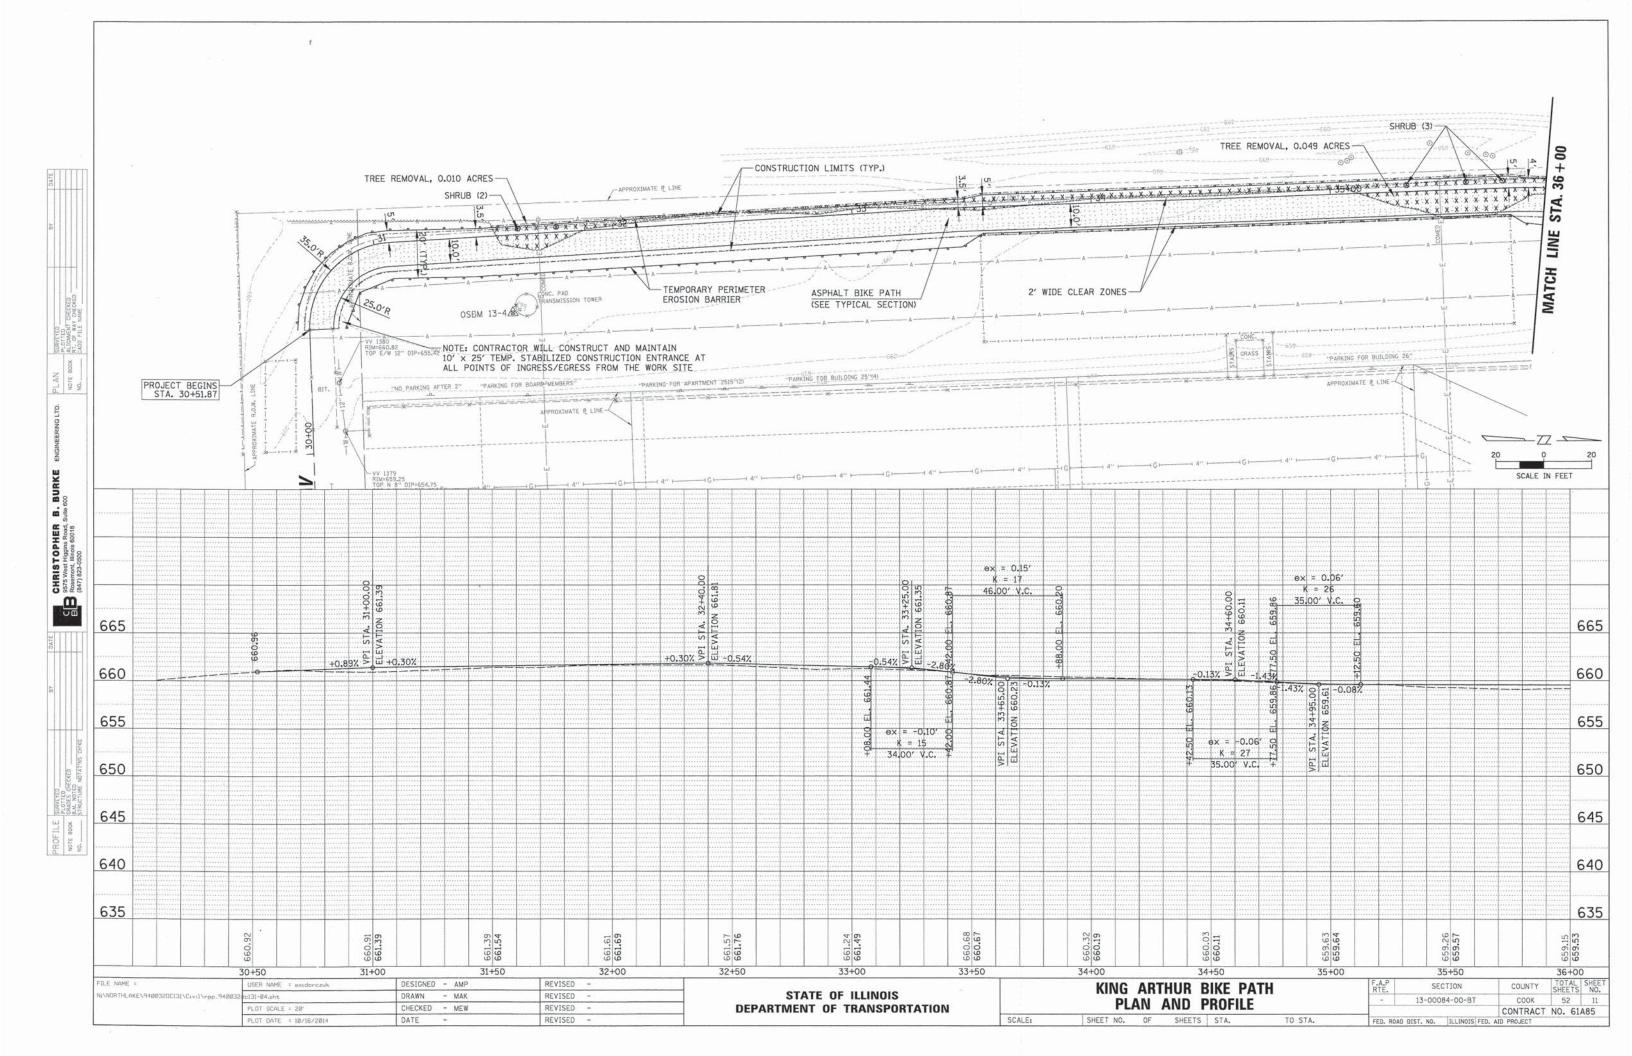
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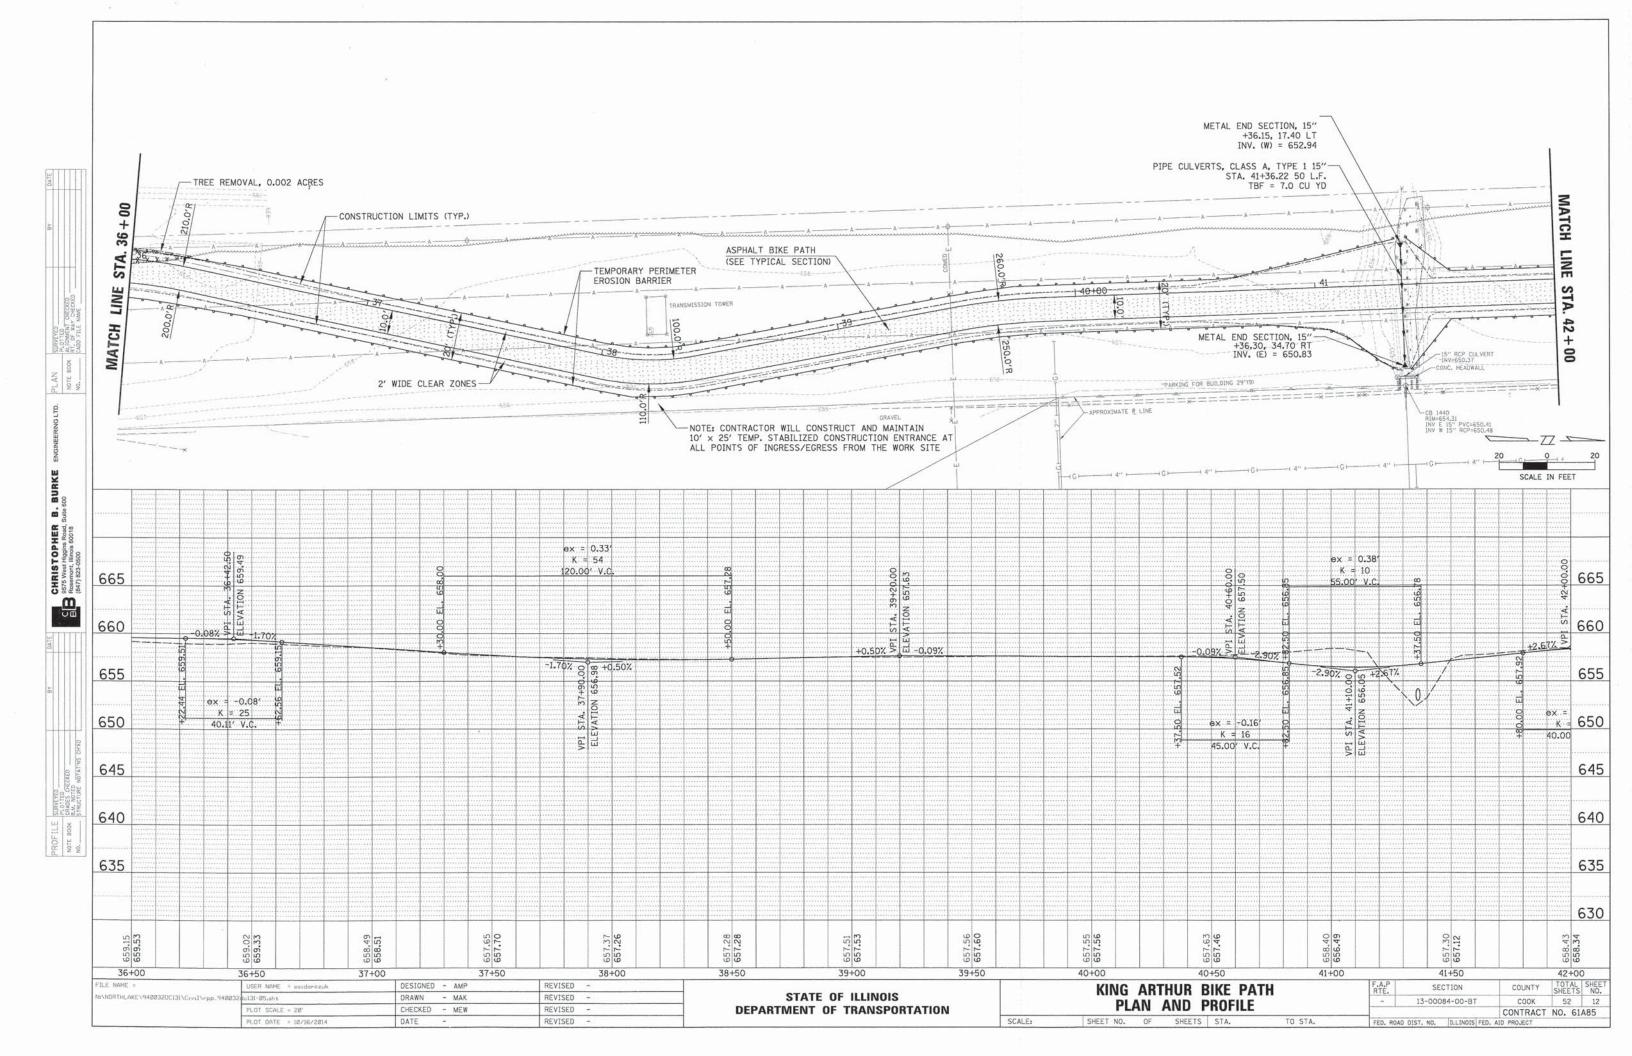
PROFILE SURVE NOTE BOOK CRADE










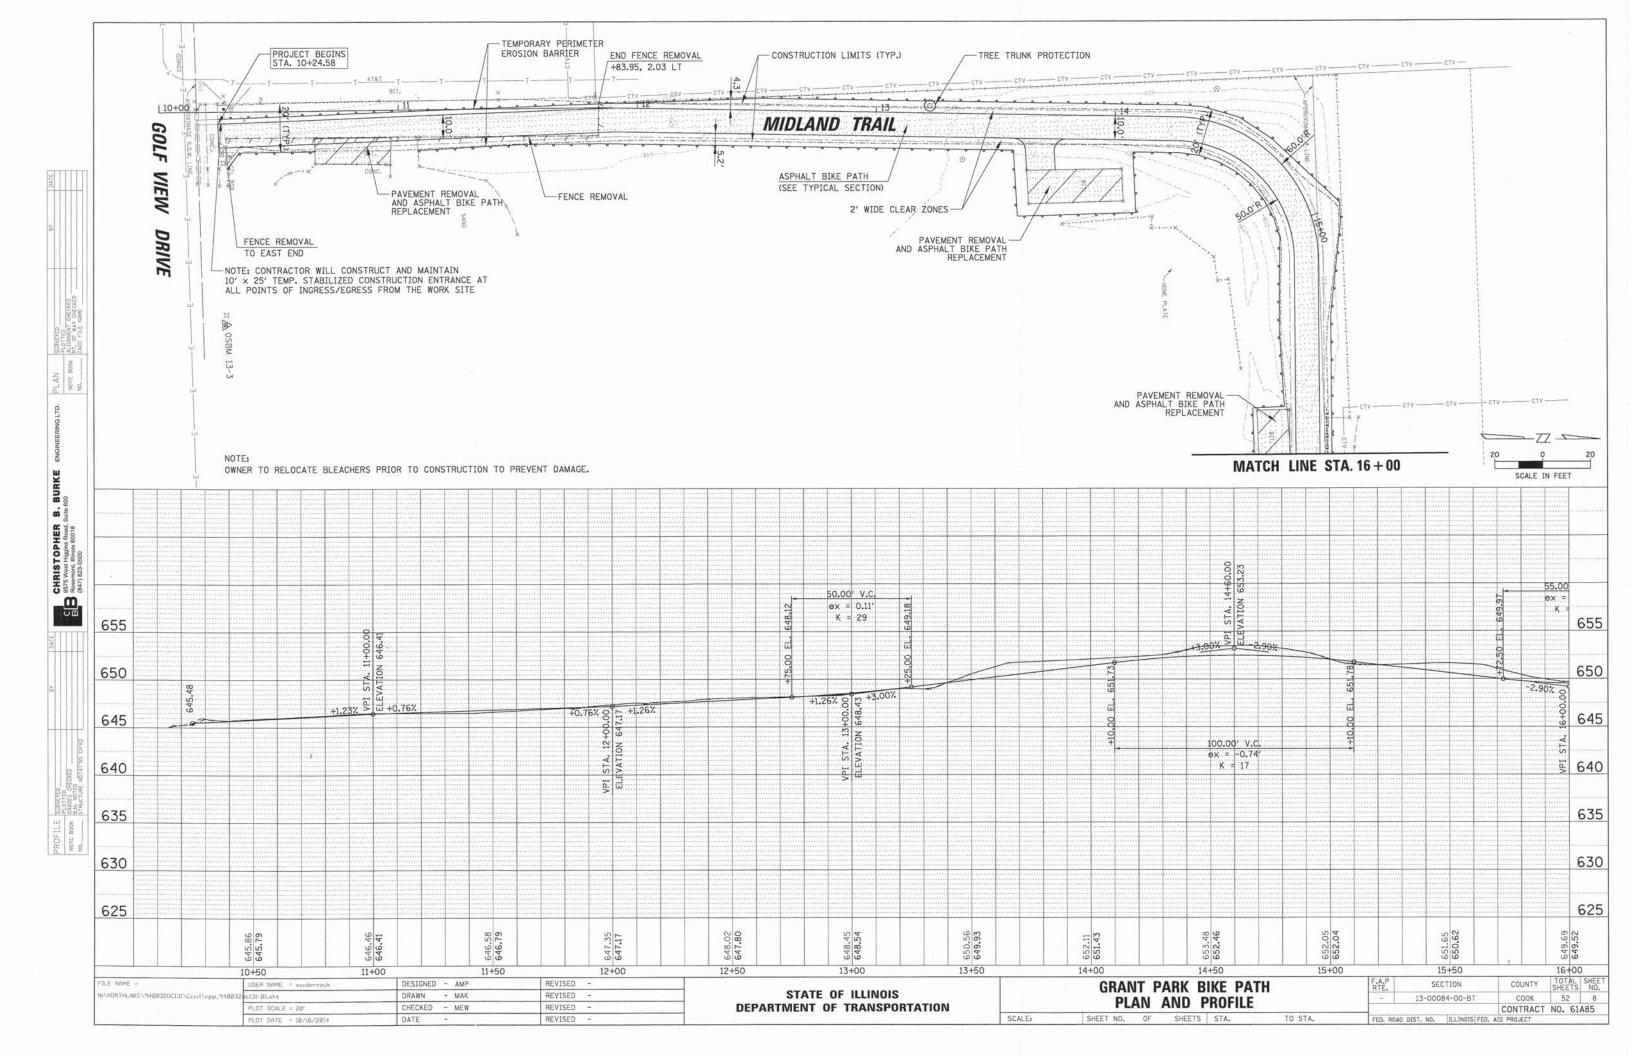


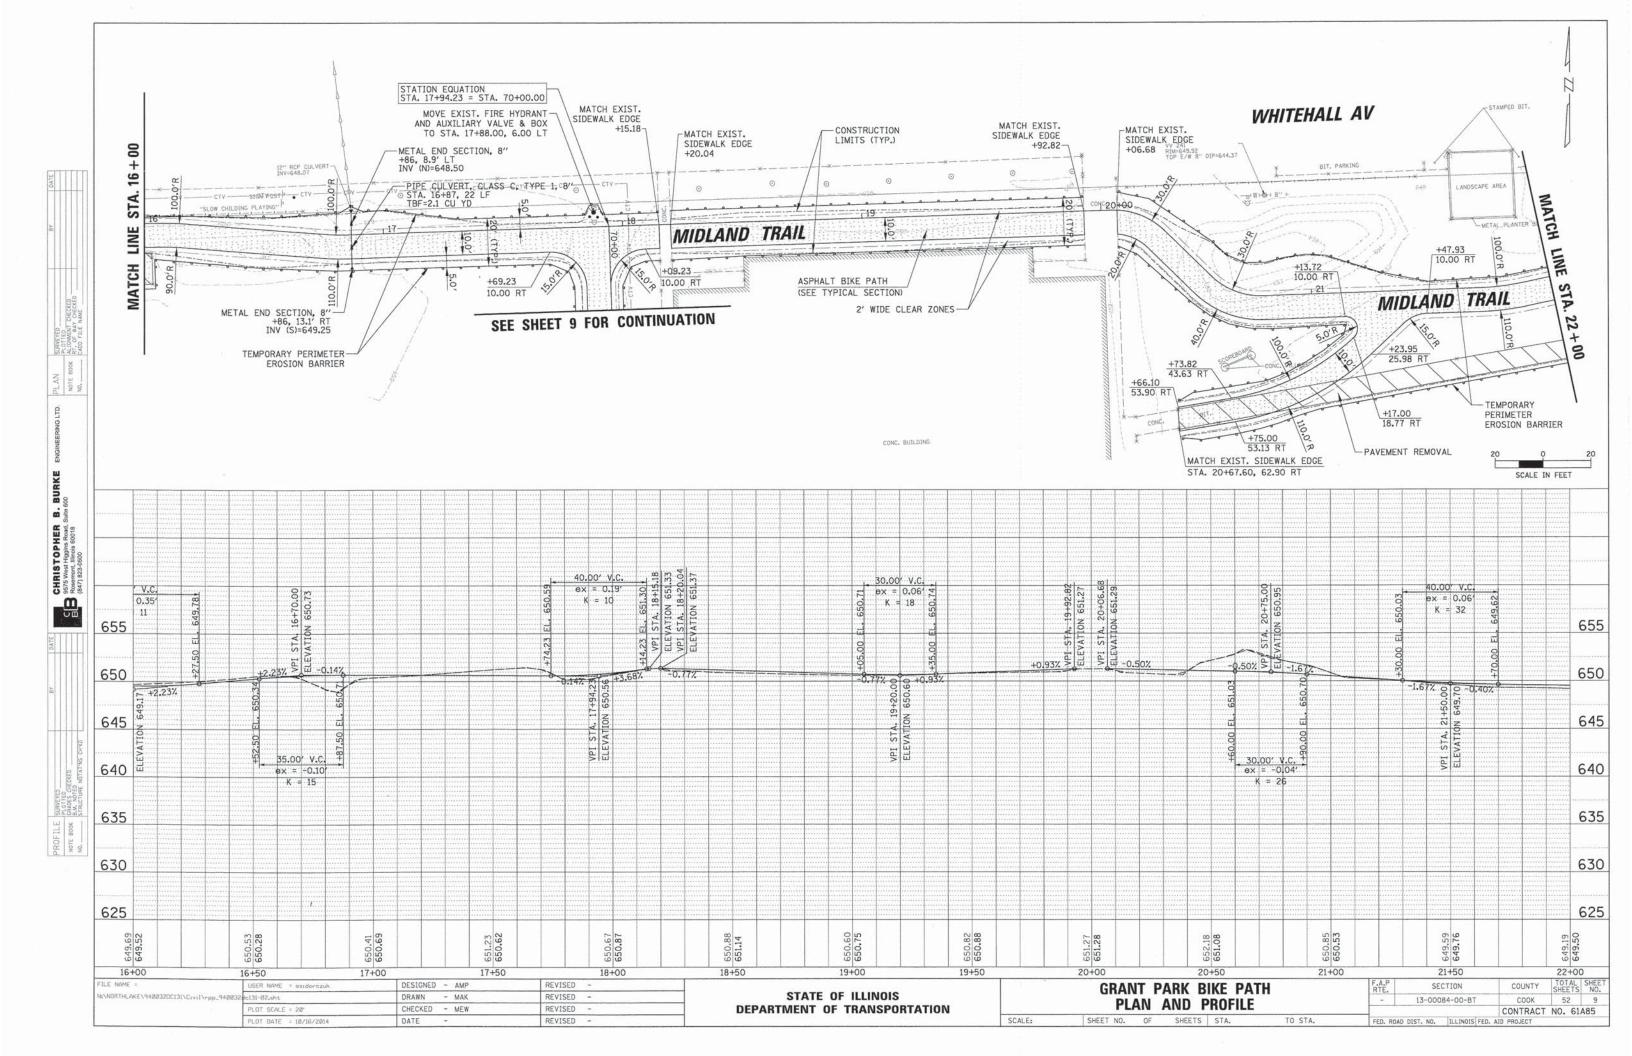

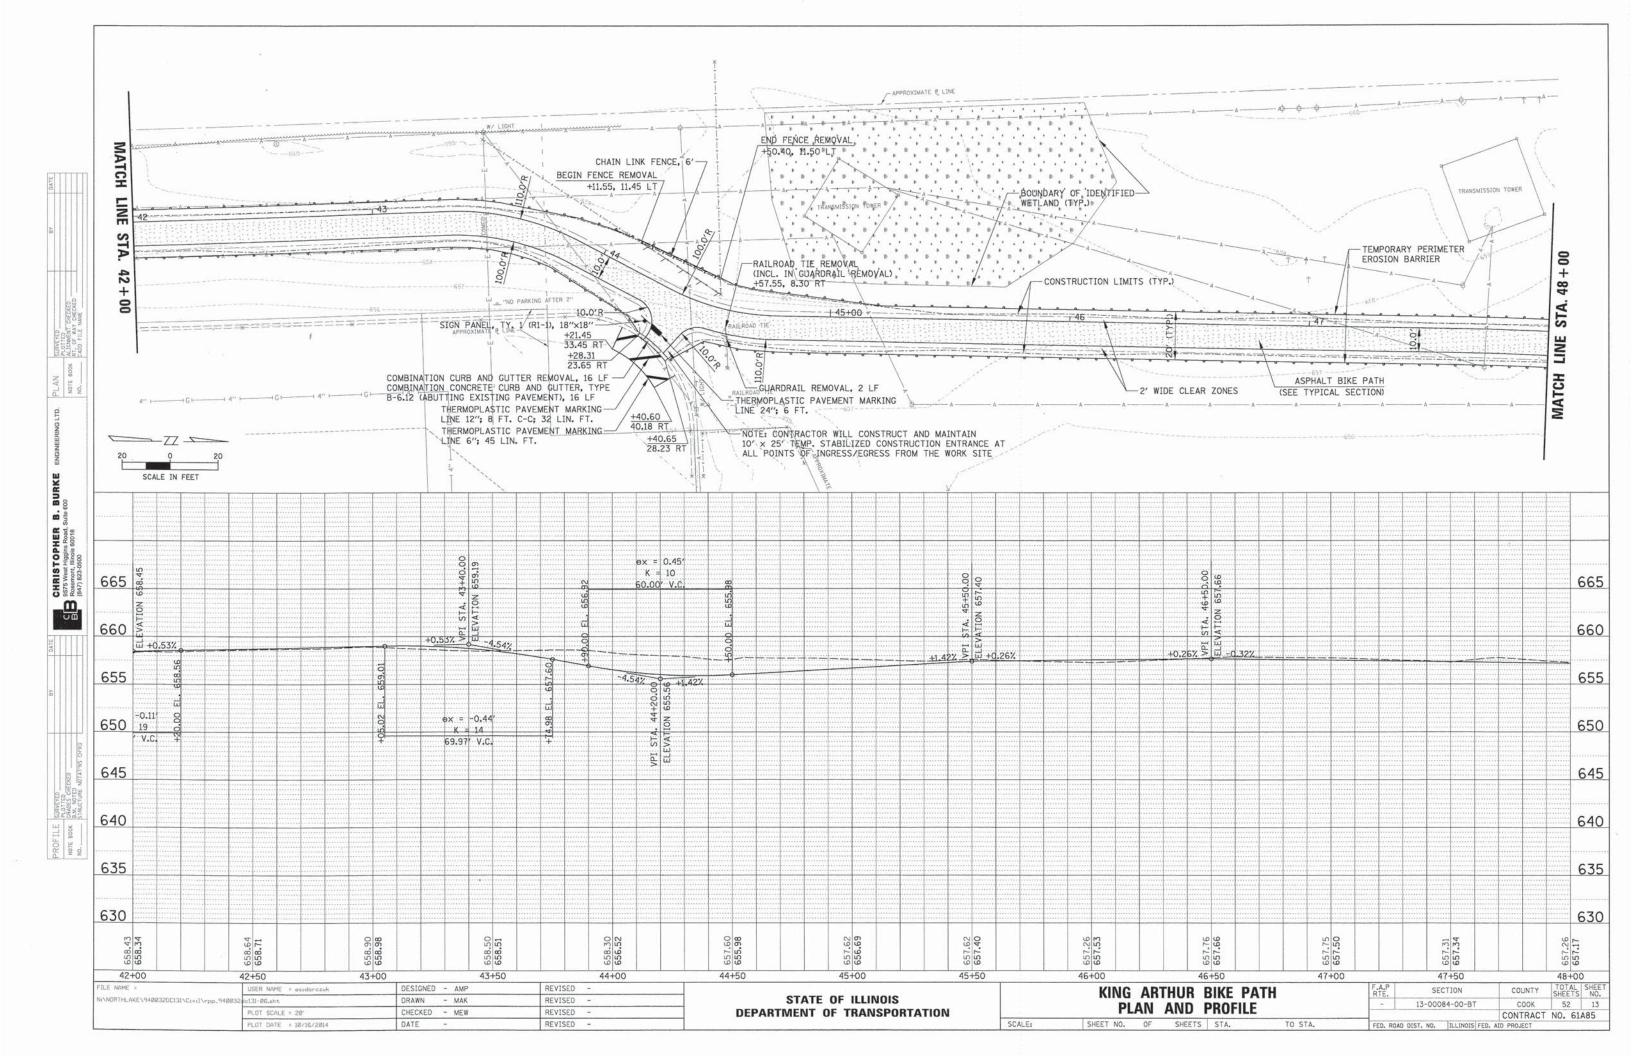

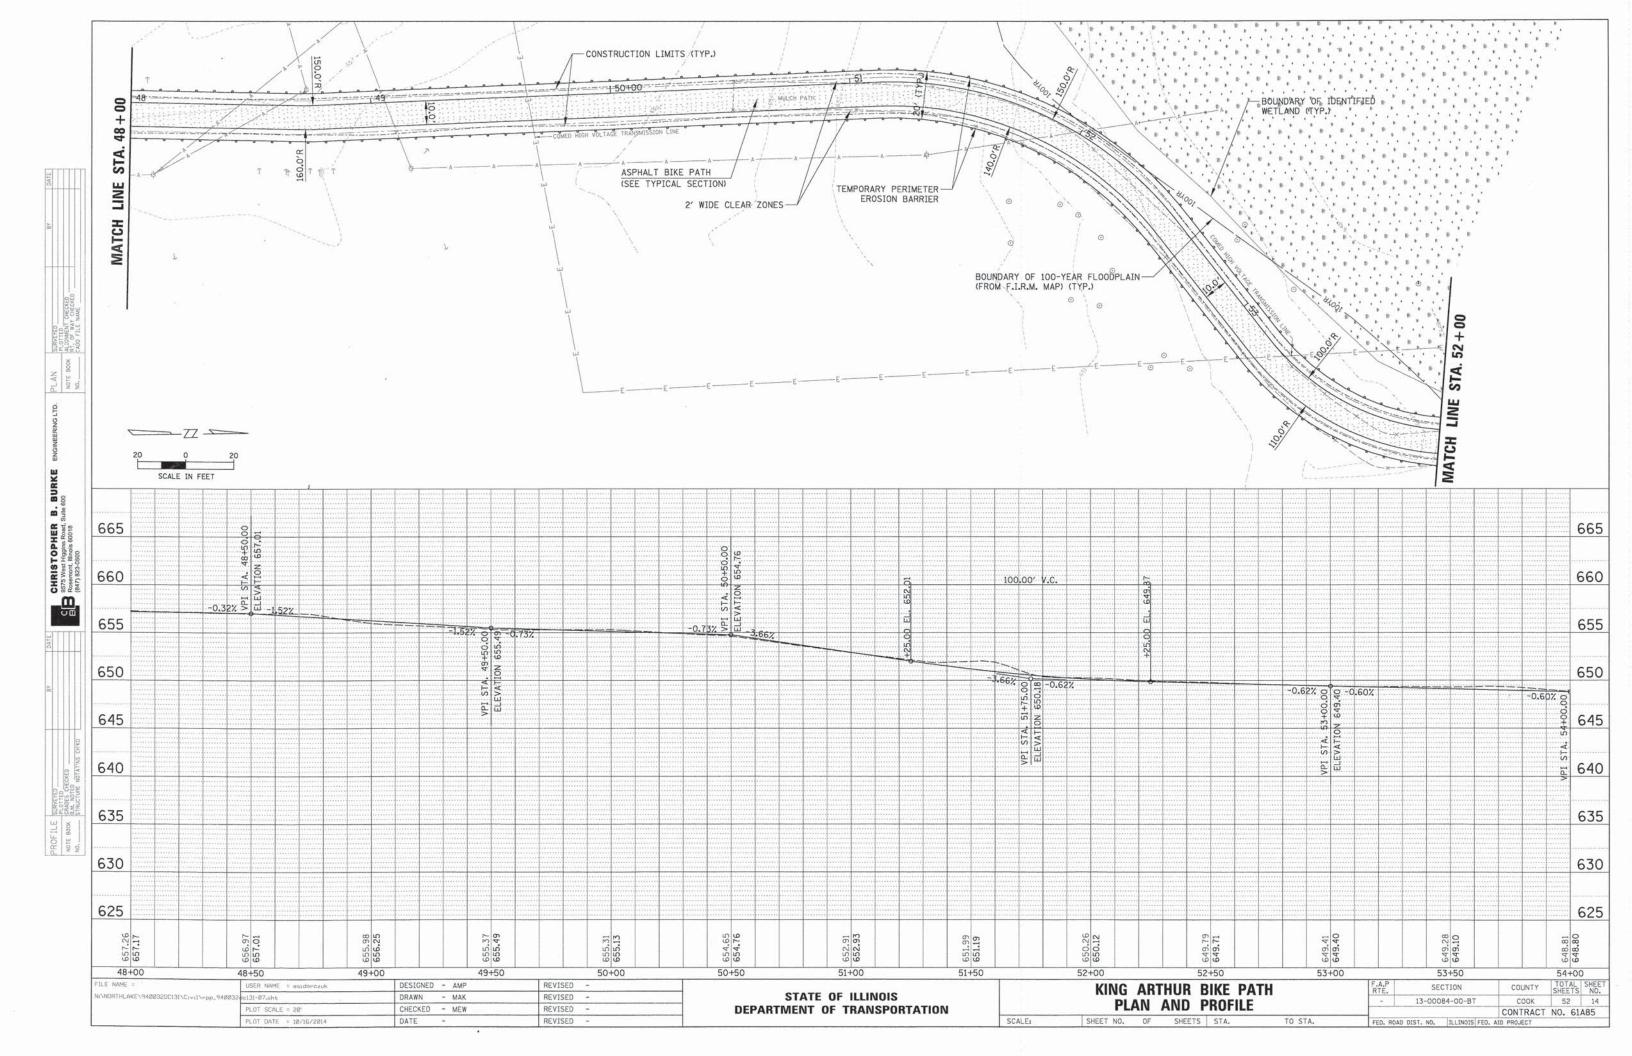

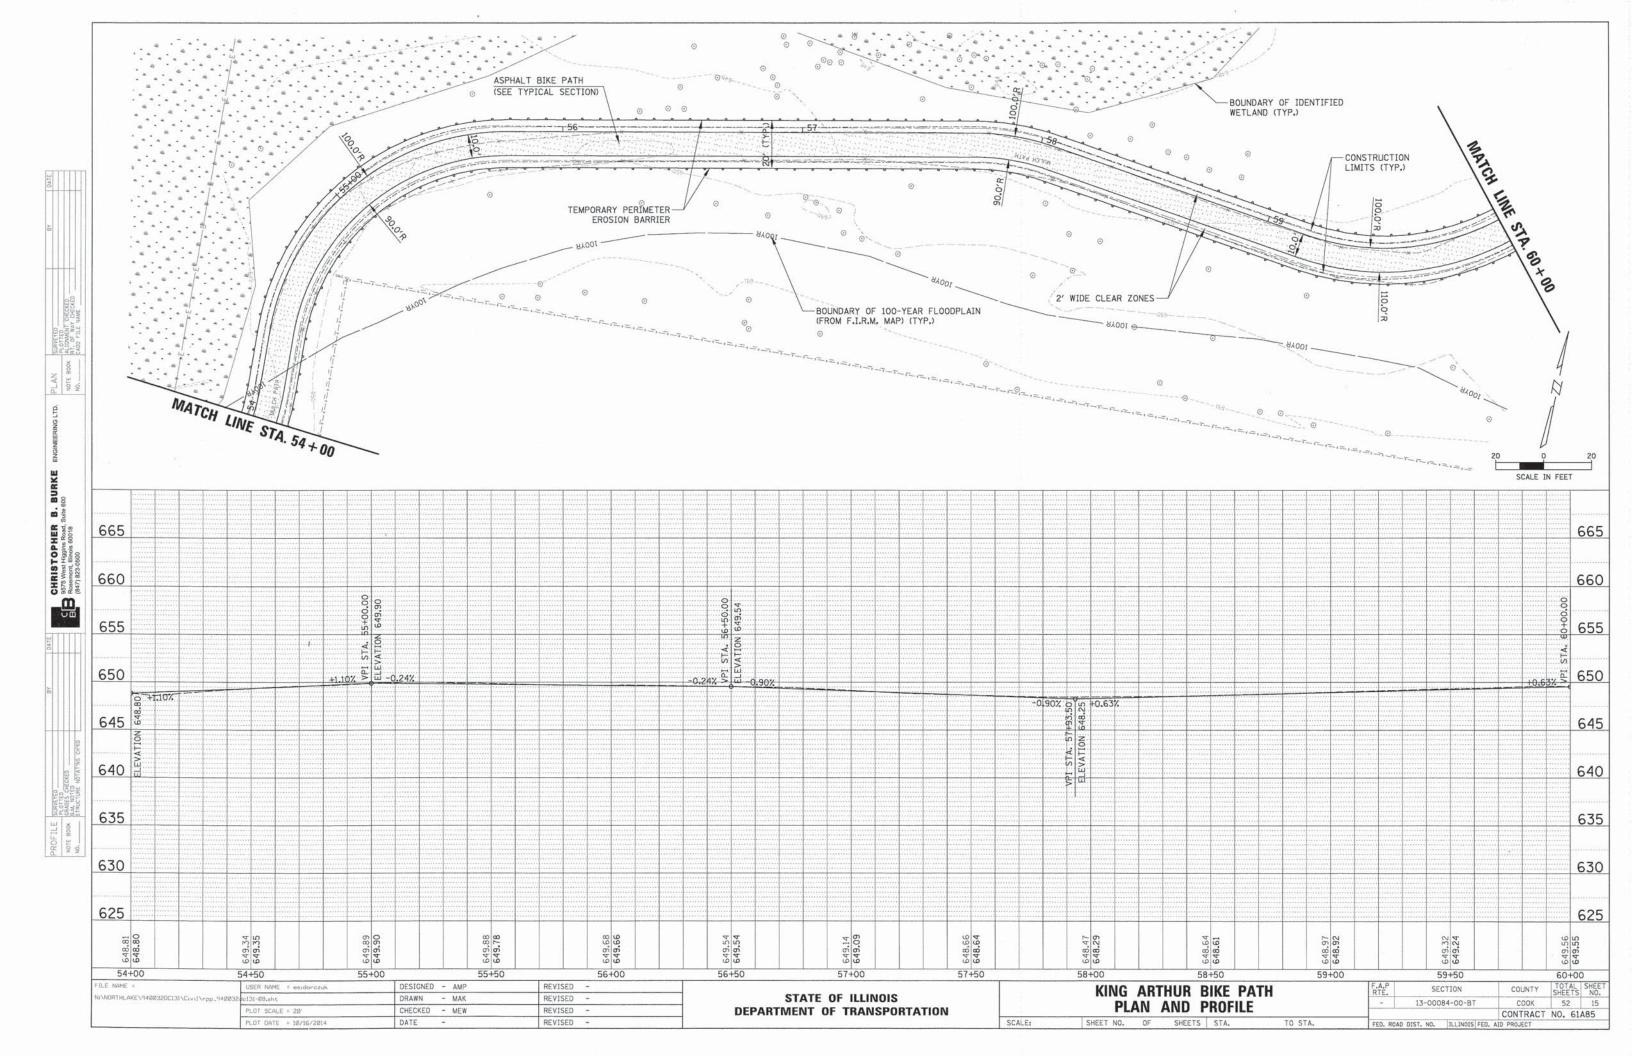

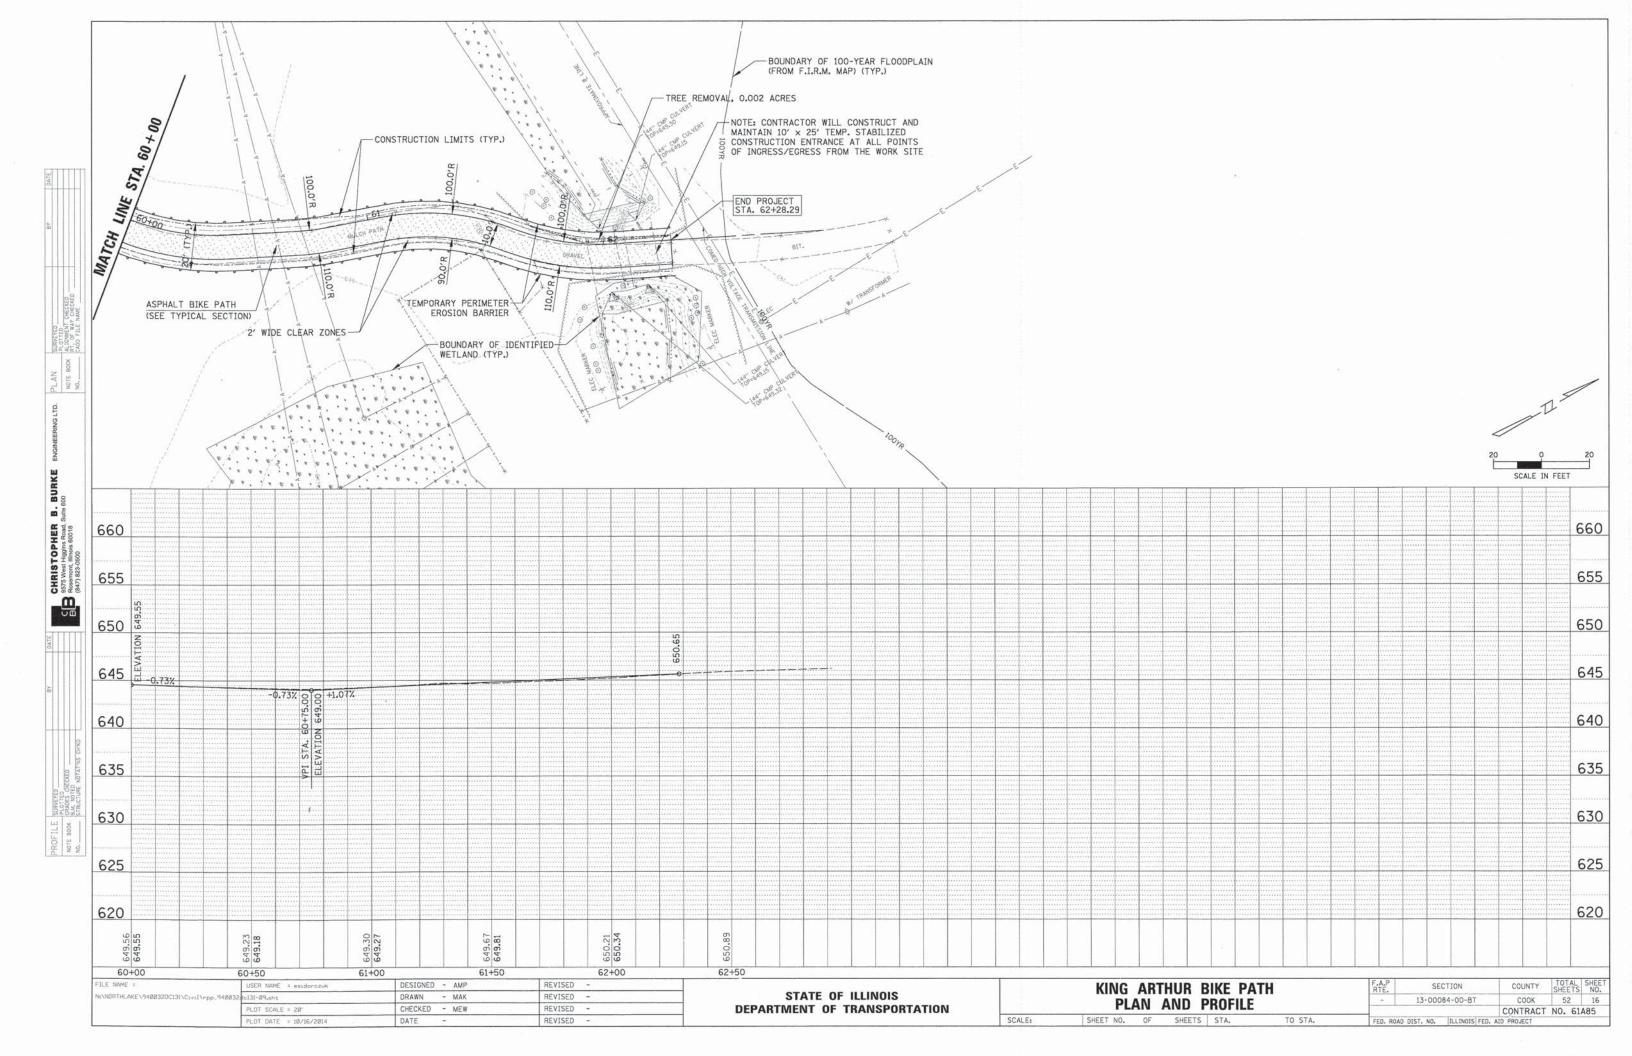

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LIGHTING GENERAL NOTES

- THE EXACT LOCATIONS OF ALL UTILITIES SHALL BE VERIFIED BY THE CONTRACTOR BEFORE THE INSTALLATION OF ANY COMPONENTS OF THE LIGHTING SYSTEM. FOR THE LOCATIONS OF THE UTILITIES, CALL JULIE TOLL FREE AT (800) 892-0123.
- BEFORE INSTALLING LIGHT STANDARDS NEAR OVERHEAD AND UNDERGROUND ELECTRIC UTILITIES, THE CONTRACTOR SHALL CALL COM ED FOR LOCATION APPROVAL AND MINIMUM CLEARANCE REQUIREMENTS.
- ALL REMOVAL OR EXCAVATION ITEMS BEING DISPOSED OF AT AN UNCONTAMINATED SOIL FILL OPERATION OR CLEAN CONSTRUCTION AND DEMOLITION DEBRIS (CCDD) FILL SITE SHALL MEET THE REQUIREMENTS OF PUBLIC ACT 96-1416, ALL COSTS ASSOCIATED WITH MEETING THESE REQUIREMENTS SHALL BE INCLUDED IN THE UNIT PRICE COST FOR THE ASSOCIATED REMOVAL OR EXCAVATION ITEMS IN THE CONTRACT. THESE COSTS SHALL INCLUDE BUT ARE NOT LIMITED TO ALL REQUIRED TESTING, LAB ANALYSIS, CERTIFICATION BY A LICENSED PROFESSIONAL ENGINEER, AND STATE AND LOCAL TIPPING FEE.
- 4. THE CONTRACTOR SHALL BE SOLELY RESPONSIBLE FOR JOB SITE SAFETY AS WELL AS SUPERVISION/DIRECTION AND MEANS/METHODS OF CONSTRUCTION.
- ALL WORK SHALL BE IN ACCORDANCE WITH THE LATEST EDITION OF THE FOLLOWING SPECIFICATIONS, WHICH ARE HEREBY MADE A PART HEREOF:
 - A. "STANDARD SPECIFICATIONS FOR ROAD AND BRIDGE CONSTRUCTION", AS PREPARED BY IDOT.
 - B. "THE NATIONAL ELECTRICAL CODE".
 - C. MUNICIPAL CODES & STANDARDS.
- 6. NO MATERIALS SHALL BE DELIVERED TO THE JOB SITE UNTIL ALL PERTINENT EQUIPMENT SUBMITTALS HAVE BEEN REVIEWED BY THE ENGINEER.
- CAST A GROUND ROD INSIDE EVERY CONCRETE POLE FOUNDATION AND CONNECT TO THE POLE GROUNDING LUG VIA A *6 SOLID COPPER WIRE WITH A MECHANICAL CONNECTION AT THE GROUND ROD AND PIGTAIL SPLICE INSIDE THE POLE HANDHOLE.
- THE INSTALLATION OF BURIED WARNING TAPE, SPECIFIED AS PART OF TRENCH FOR UNDERGROUND CONDUITS, SHALL BE REVIEWED BY THE ENGINEER PRIOR TO BACKFILLING OR DURING PLOWING OPERATIONS, AS APPLICABLE.
- THE CONTRACTOR SHALL LABEL ALL WIRES WITH WIRE MARKERS INDICATING THE CIRCUIT ID IN EVERY CONTROLLER, POLE BASE, HAND HOLE AND SPLICE/CONNECTION POINT. WIRE MARKERS SHALL BE WHITE NYLON WITH INTEGRAL MECHANICAL FASTENER WITH MINIMUM $\frac{3}{4}$ " X 1" WRITEABLE AREA.
- 10. ALL UNDERGROUND WIRING SHALL BE MINIMUM *8 COPPER (OR SIZE AS SHOWN ON THE PLANS) XLP TYPE-USE, EXTRA ABRASION RESISTANCE, 600 VOLTS, BURIED A MINIMUM 30 INCHES BELOW FINISHED GRADE, FOLLOWING THE ROADWAY OR SIDEWALK EDGE.
- 11. LUMINAIRES SHALL BE LEVEL & HAVE A TIGHT FIT ON MAST ARMS TO THE ENGINEER'S SATISFACTION. THIS WORK SHALL INCLUDE FIELD ADJUSTING OF THE LUMINAIRE WHICH WILL BE INCLUDED IN THE COST OF THE LIGHT UNIT PAY ITEM.
- 12. NO POLES SHALL BE ERECTED UNTIL THE RESPECTIVE FOUNDATIONS HAVE CURED, (IF APPLICABLE) AND HAVE BEEN REVIEWED BY THE ENGINEER.
- 13. TO MAINTAIN THE STRUCTURAL INTEGRITY OF LIGHT POLES WITH MAST ARMS, THEY SHALL NOT BE ERECTED AND LEFT TO STAND WITHOUT LUMINAIRES.
- 14. THE CONTRACTOR SHALL BE RESPONSIBLE FOR THE ESTABLISHMENT OF THE TOP OF FOUNDATION ELEVATION WITH THE FINISHED GRADE.
- 15. EQUIPMENT GROUND CONDUCTORS SHALL BE SPLICED AND BONDED AT EACH LIGHT POLE OR OTHER PIECE OF EQUIPMENT.
- 16. IT SHALL BE THE CONTRACTOR'S RESPONSIBILITY TO MARK THE PROPOSED LOCATIONS OF ALL LIGHT POLES FOR EXAMINATION AND CONFIRMATION WITH THE ENGINEER. ALL UTILITIES SHALL BE LOCATED PRIOR TO MARKING PROPOSED LOCATIONS.
- 17. THE ELECTRICAL CONTRACTOR SHALL FURNISH TWO SETS OF FULL SIZE RECORD DRAWINGS TO THE ENGINEER UPON COMPLETION OF THE LIGHTING AND ELECTRICAL IMPROVEMENTS. THE DRAWINGS SHALL SHOW THE INSTALLED LOCATIONS OF ALL LIGHT POLES, UNDERGROUND CONDUITS/WIRING, HANDHOLES, JUNCTION BOXES & CONTROLLER CABINETS. THE DRAWINGS WILL BE REVIEWED BY THE
- 18. UPON COMPLETION OF THE PROPOSED LIGHTING IMPROVEMENTS, THE CONTRACTOR SHALL PERFORM ELECTRICAL TESTING AND VERIFY THAT THE INSTALLATION COMPLIES WITH THE LATEST EDITION OF THE STANDARD SPECIFICATIONS FOR ROAD AND BRIDGE CONSTRUCTION IN ILLINOIS.
- 19. THE CONTRACTOR SHALL BE RESPONSIBLE FOR TIMELY NOTIFICATION AND ALL COORDINATION WITH COMED FOR NEW ELECTRIC SERVICE TO THE PROPOSED LIGHTING CONTROLLER. THE ELECTRIC SERVICE COORDINATION PERFORMED BY THE ENGINEER DURING DESIGN IS INCLUDED IN THE PLANS FOR THE CONTRACTORS INFORMATION.
- 20. THE LIGHT POLE LOCATIONS SHALL COMPLY WITH THE MINIMUM CLEAR WIDTH FOR AN ACCESSIBLE ROUTE FOR SIDEWALKS PER CURRENT AMERICAN WITH DISABILITIES ACT (ADA) REQUIREMENTS.
- 21. ALL STEEL SHALL BE FROM DOMESTIC SOURCE.

LIGHTING BILL OF MATERIALS

CODE NO.	DESCRIPTION	UNIT	QUANTITY
80400100	ELECTRIC SERVICE INSTALLATION	EACH	1
80400200	ELECTRIC UTILITY SERVICE CONNECTION	LSUM	1
81028200	UNDERGROUND CONDUIT, GALVANIZED STEEL, 2" DIA.	FOOT	40
81028210	UNDERGROUND CONDUIT, GALVANIZED STEEL, 2 1/2" DIA.	FOOT	75
81028720	UNDERGROUND CONDUIT, COILABLE NONMETALLIC CONDUIT, 1" DIA.	FOOT	1950
81028730	UNDERGROUND CONDUIT, COILABLE NONMETALLIC CONDUIT, 1 1/4" DIA.	FOOT	9650
81400730	HANDHOLE, COMPOSITE CONCRETE	EACH	13
81702120	ELECTRIC CABLE IN CONDUIT, 600V (XLP-TYPE USE) 1/C NO. 8	FOOT	35930
81702150	ELECTRIC CABLE IN CONDUIT, 600V (XLP-TYPE USE) 1/C NO. 2	FOOT	150
82500335	LIGHTING CONTROLLER, PEDESTAL MOUNTED, 240VOLT, 100AMP	EACH	1
83600200	LIGHT POLE FOUNDATION, 24" DIAMETER	FOOT	366
•X0324390	FLOOD LIGHTING UNIT	EACH	2
•X0326654	ORNAMENTAL LIGHT UNIT, COMPLETE	EACH	61
- Z0033028	MAINTENANCE OF LIGHTING SYSTEM	CAL MO	2

CAUTION NOTICE TO CONTRACTOR

THE CONTRACTOR IS SPECIFICALLY CAUTIONED TO THE LOCATION AND/OR ELEVATION OF EXISTING AND PROPOSED UTILITIES AS SHOWN ON THESE PLANS. THE INFORMATION IS NOT TO BE RELIED ON AS BEING EXACT OR COMPLETE. THE CONTRACTOR MUST CALL THE LOCAL UTILITY LOCATION CENTER AT LEAST 72 HOURS BEFORE ANY EXCAVATION TO REQUEST EXACT FIELD LOCATIONS OF THE UTILITIES. IT SHALL BE THE RESPONSIBILITY OF THE CONTRACTOR TO INFORM ENGINEER OF ANY EXISTING UTILITIES WHICH CONFLICT WITH THE PROPOSED IMPROVEMENTS.

> THE CITY OF NORTHLAKE WILL OWN AND MAINTAIN THE PROPOSED LIGHTING SYSTEM

> > SCALE: N.T.S.

ABBREVIATIONS

AIC AMPS INTERRUPTING CURRENT

CKT CIRCUIT

DIAMETER DIA

DOUBLE POLE DOUBLE THROW SWITCH DPDT

FT

FOC FACE OF CURB

GROUND FAULT CIRCUIT INTERRUPTER **GFCI**

HDPE HIGH DENSITY POLYETHYLENE

HH HAND HOLE

N.C. NORMALLY CLOSED

N.O. NORMALLY OPEN

PVC POLYVINYL CHLORIDE

RIGID GALVANIZED STEEL RGS

ROW RIGHT OF WAY

SPST SINGLE POLE SINGLE HROW SWITCH

STA STATION

VOLTS.


WATTS


ILE NAME -DESIGNED - AJD REVISED NORTHLAKE\94ØØ320C1 DRAWN - LRR REVISED PLOT SCALE = 20' CHECKED - AJD REVISED DATE REVISED


STATE OF ILLINOIS DEPARTMENT OF TRANSPORTATION LIGHTING GENERAL NOTES AND BILL OF MATERIALS

SHEET NO. OF SHEETS STA.

SECTION COUNTY COOK 13-00084-00-BT CONTRACT NO. 61A85 FED. ROAD DIST. NO. | ILLINOIS FED. AID PROJECT

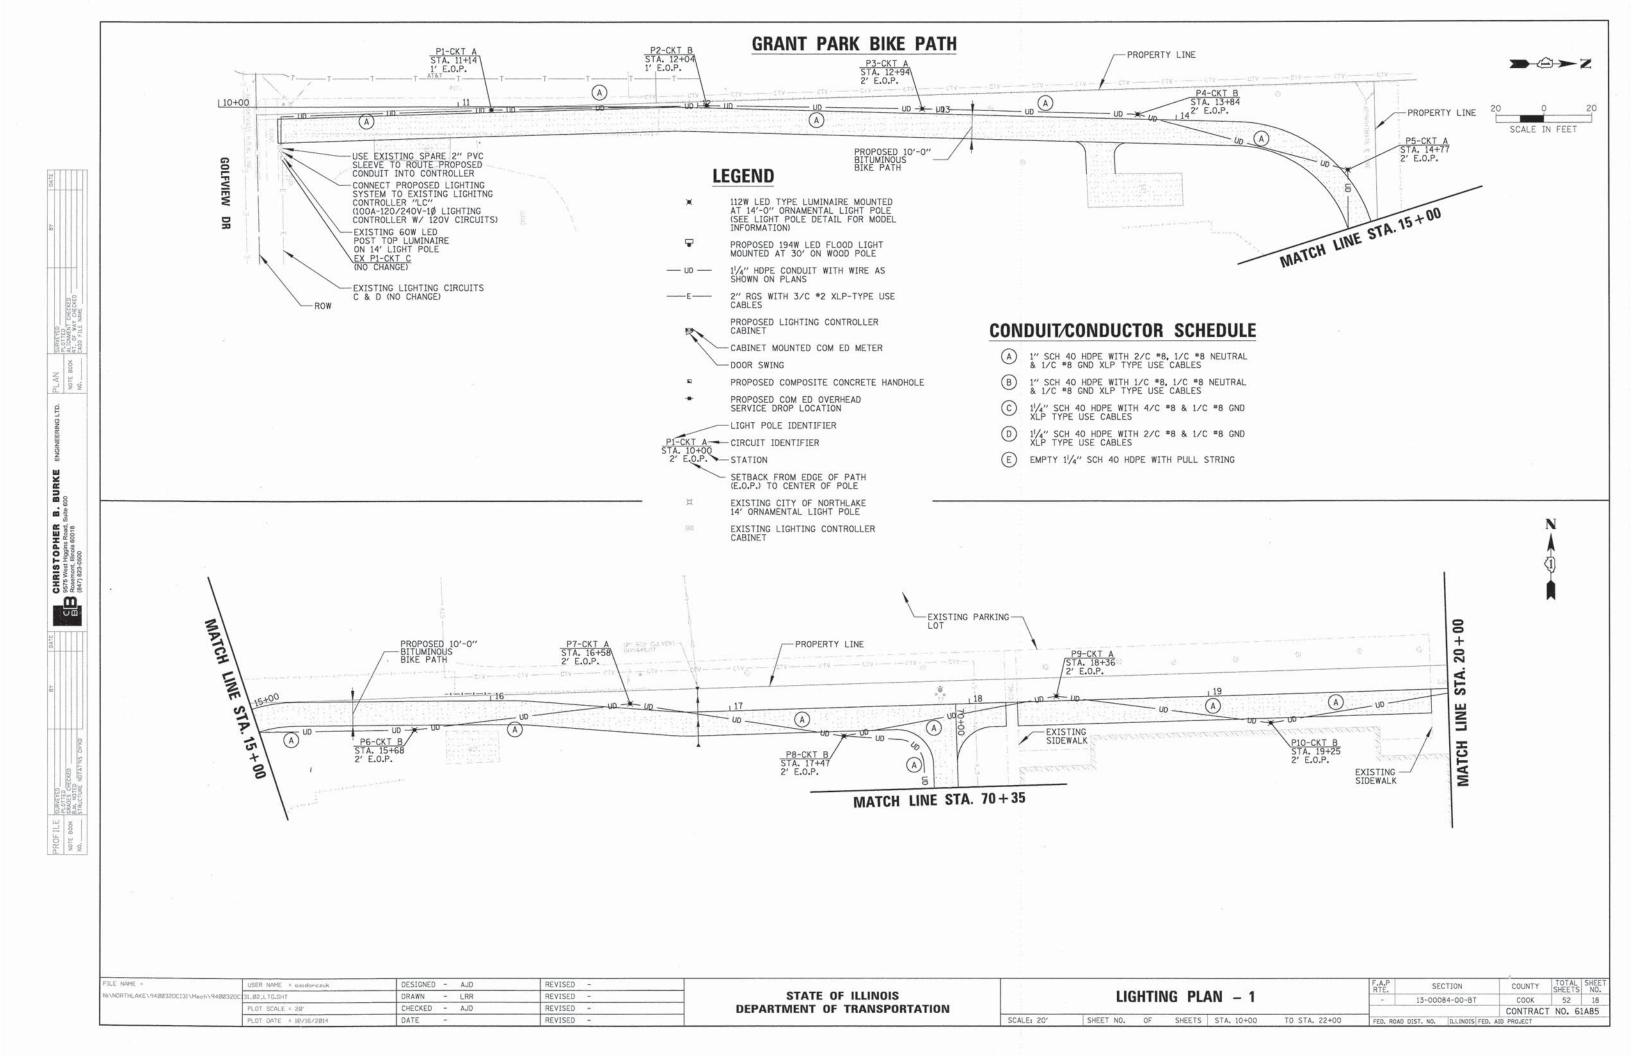

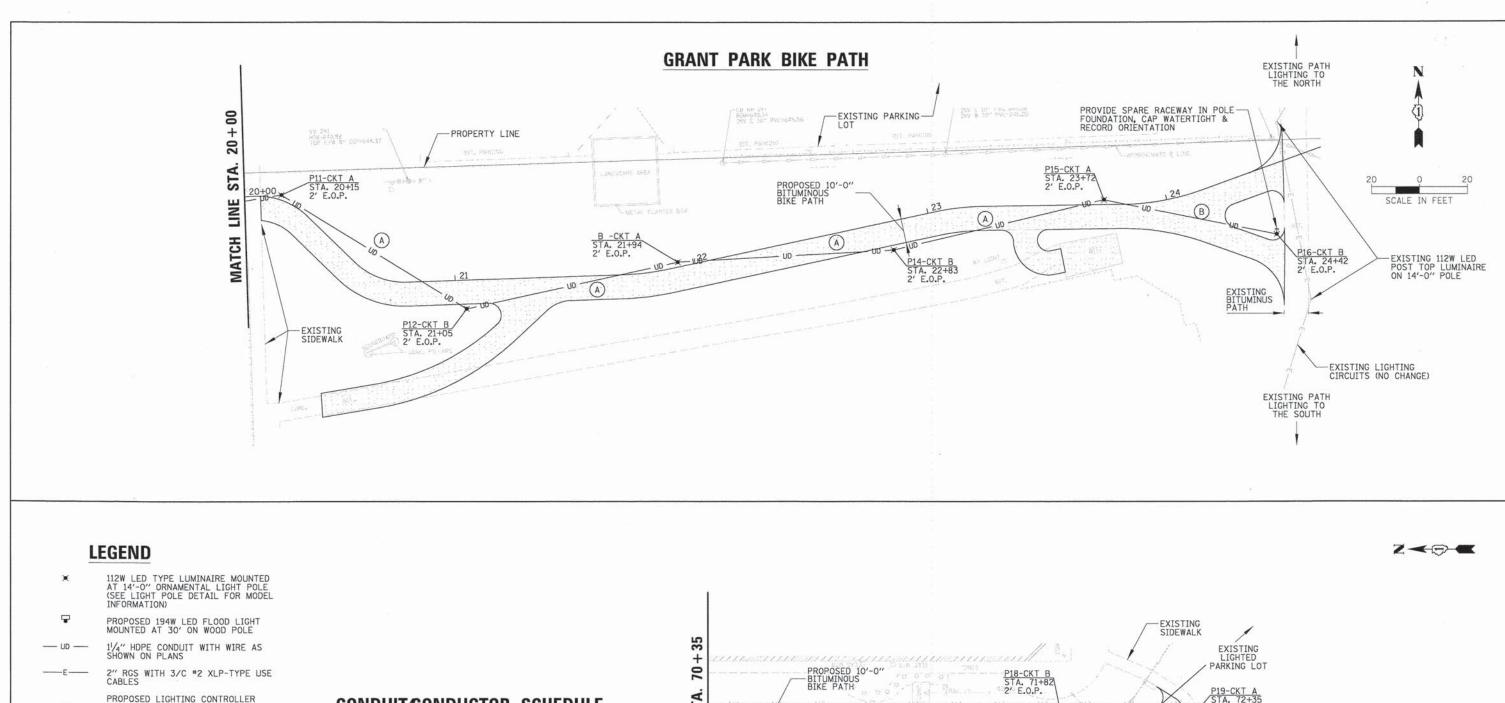

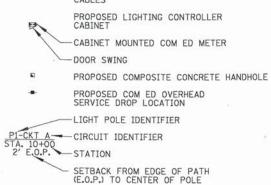


EXISTING CITY OF NORTHLAKE 14' ORNAMENTAL LIGHT POLE

B

EXISTING LIGHTING CONTROLLER CABINET

CONDUIT/CONDUCTOR SCHEDULE 1" SCH 40 HDPE WITH 2/C #8, 1/C #8 NEUTRAL & 1/C #8 GND XLP TYPE USE CABLES 1" SCH 40 HDPE WITH 1/C #8, 1/C #8 NEUTRAL & 1/C #8 GND XLP TYPE USE CABLES $1^{\text{I}}\!/_{\text{4}}{}^{\prime\prime}$ SCH 40 HDPE WITH 4/C *8 & 1/C *8 GND XLP TYPE USE CABLES $1^{1}\!/_{4}$ " SCH 40 HDPE WITH 2/C *8 & 1/C *8 GND XLP TYPE USE CABLES


(E) EMPTY 11/4" SCH 40 HDPE WITH PULL STRING

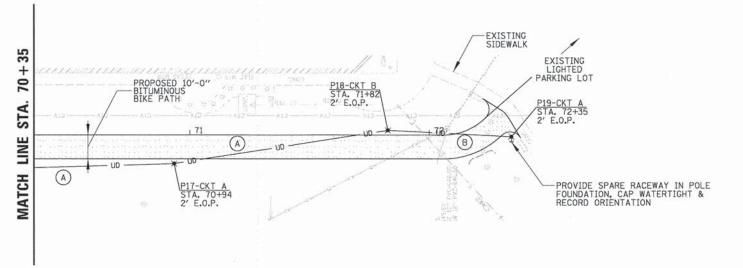



COUNTY TOTAL SHEET NO.


CONTRACT NO. 61A85

FILE NAME =	USER NAME = esidorczuk	DESIGNED - AJD	REVISED -			NOIS LIGHTING PLAN – 2			F.A.P	SE	TION	COUNTY
N:\NORTHLAKE\940032DCl31\Mech\940032D	31_03_LTG.SHT	DRAWN - LRR	REVISED -	STATE OF ILLINOIS LIGHTING PLAN - 2				LIGHTING PLAN		17.12.	13-000	0084-00-BT
	PLOT SCALE = 20'	CHECKED - AJD	REVISED -	DEPARTMENT OF TRANSPORTATION						10 000		CONTRAC
	PLOT DATE = 10/16/2014	DATE -	REVISED -		SCALE: 20'	SHEET NO.	OF	SHEETS	FED. RO	AD DIST. NO.	ILLINOIS FED.	AID PROJECT

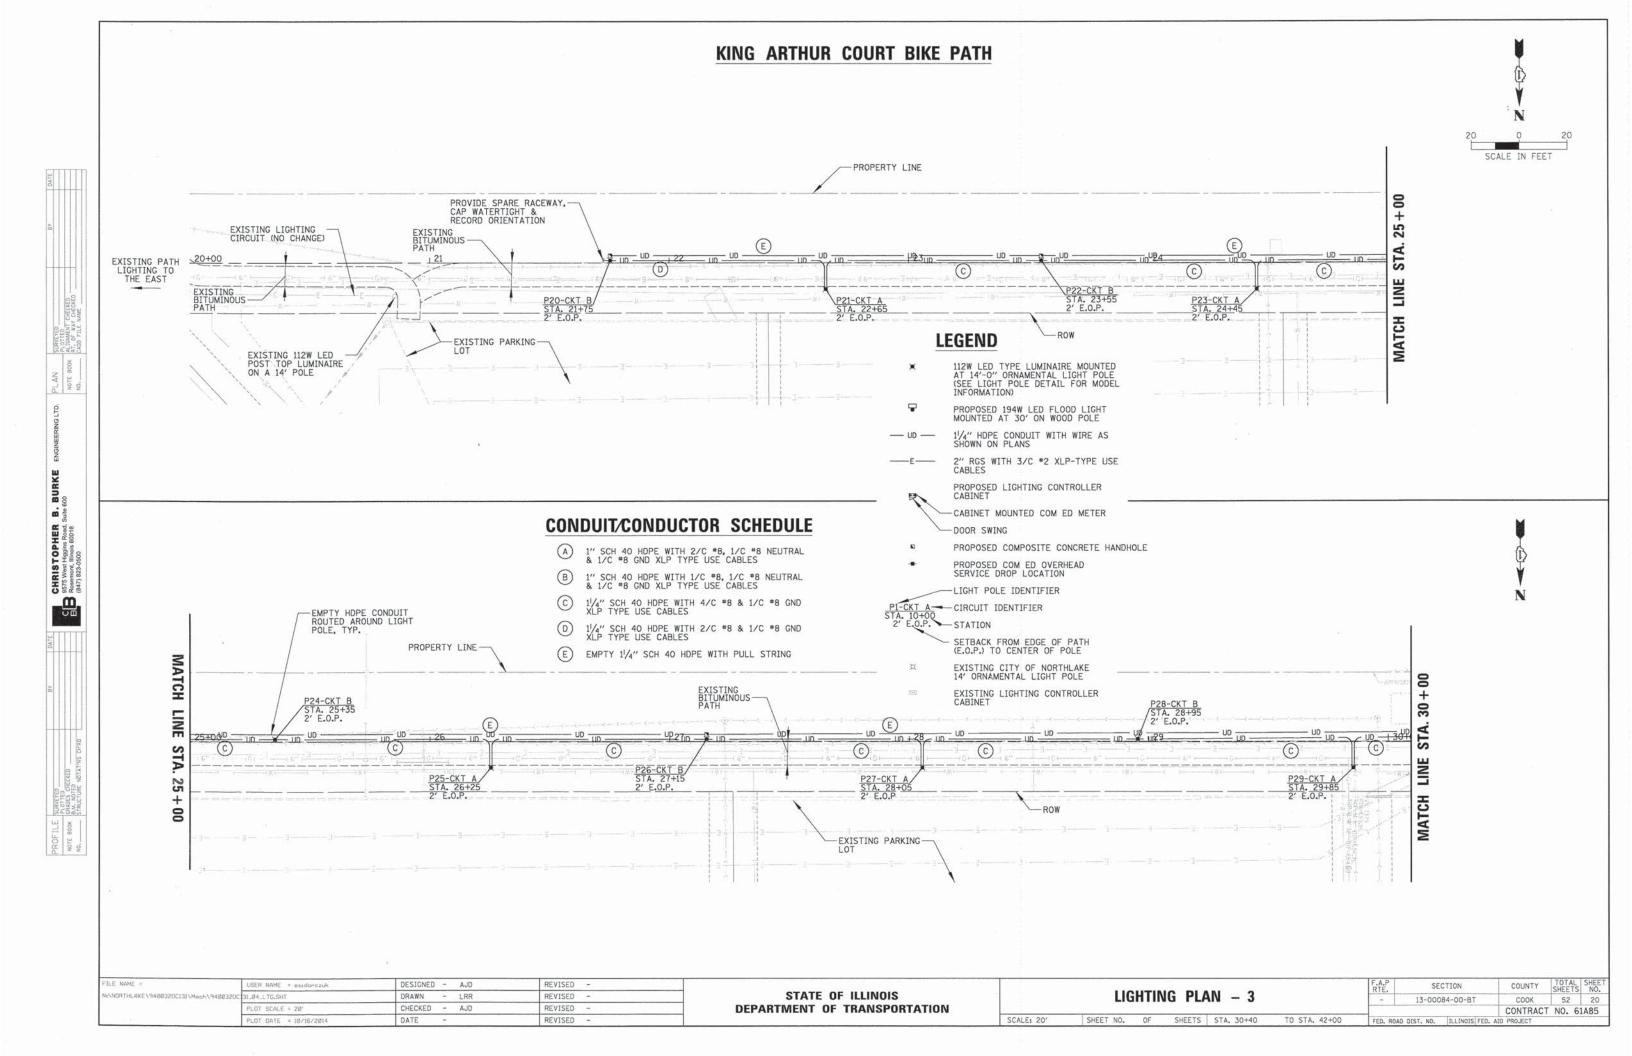

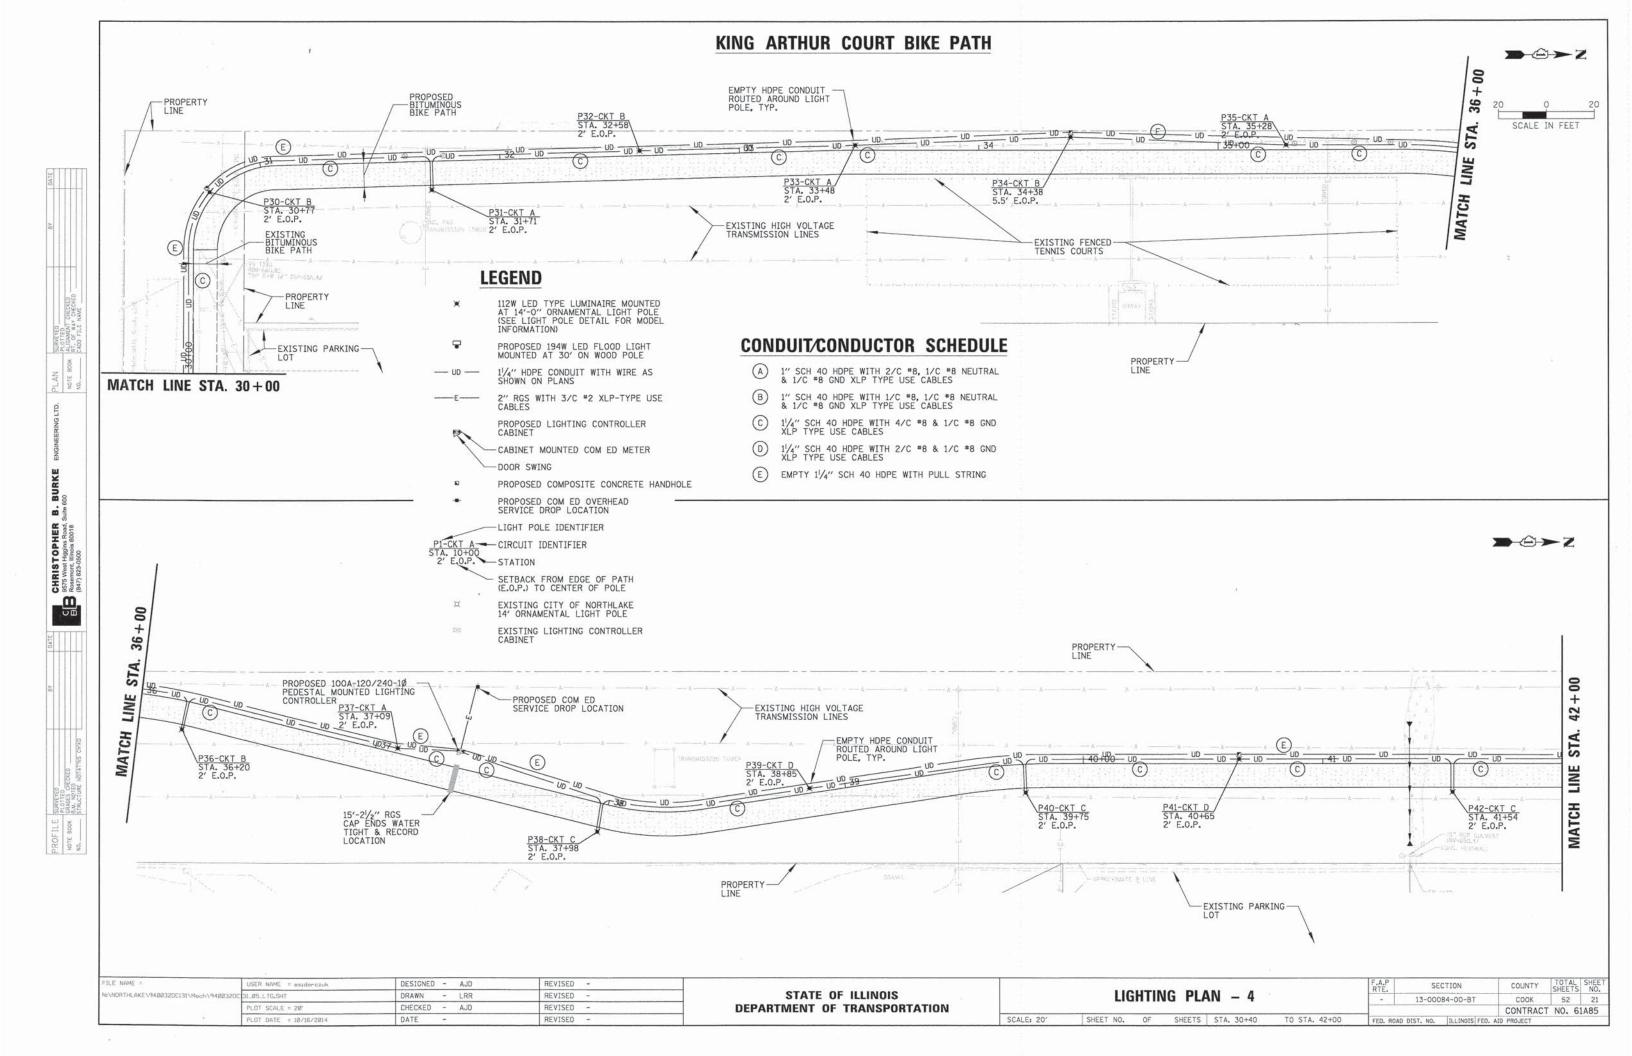

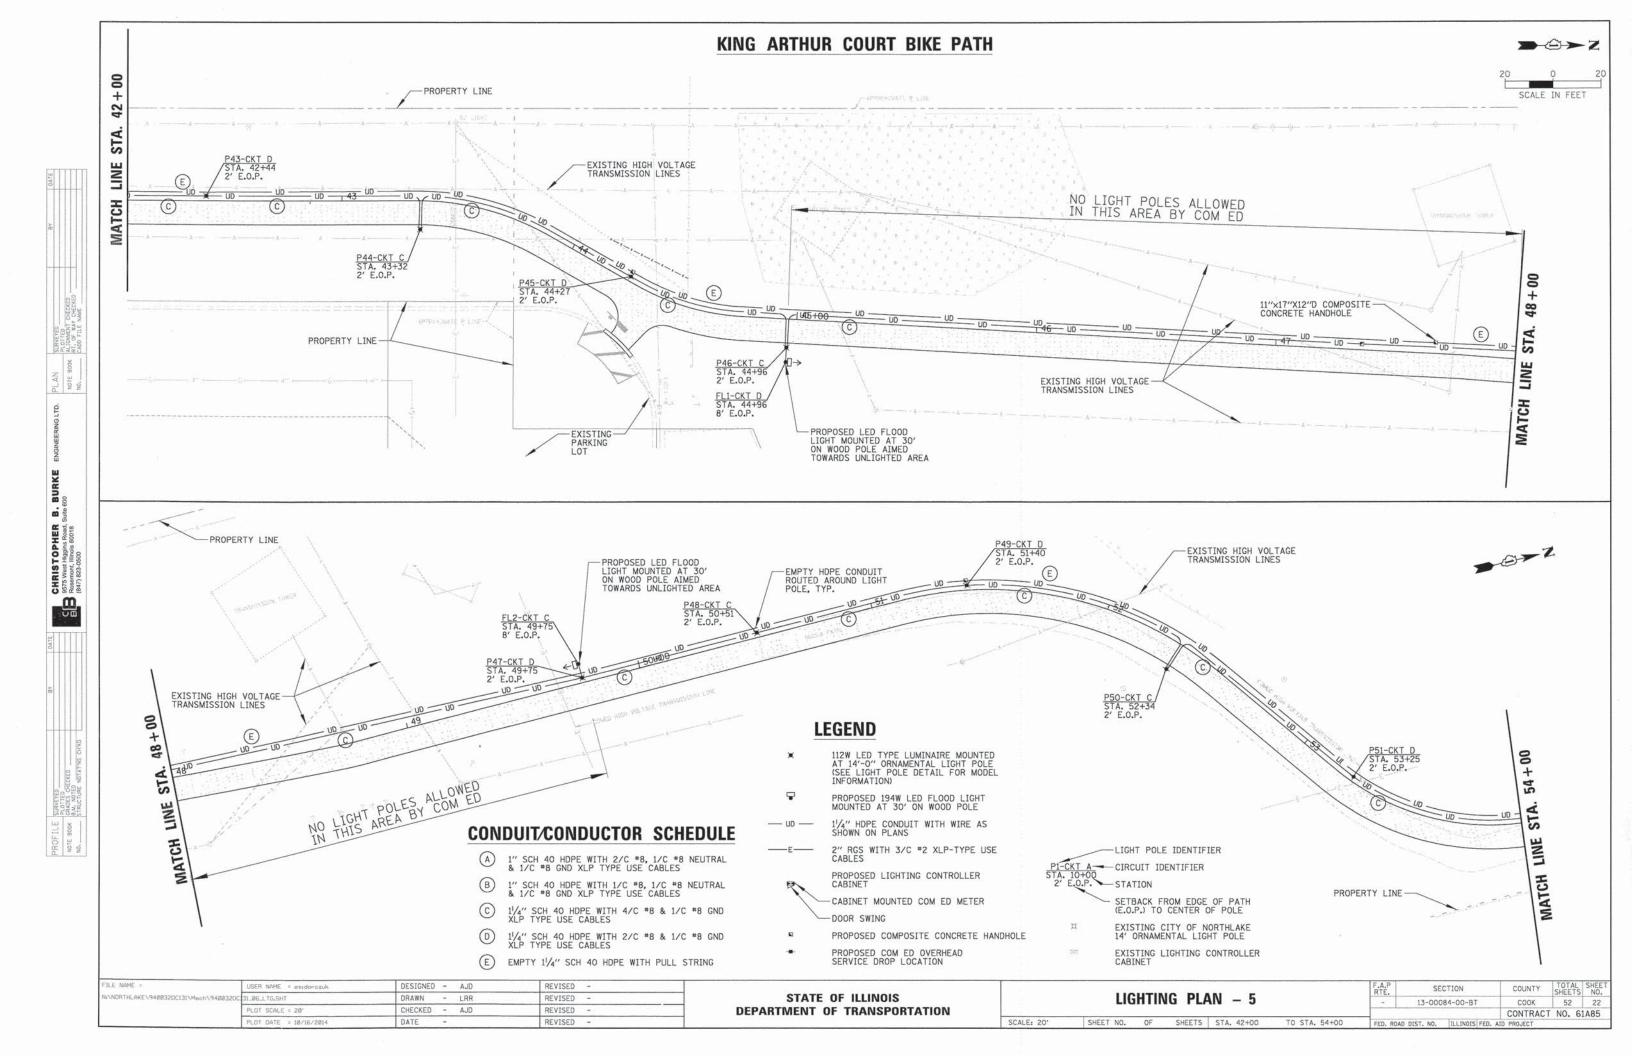

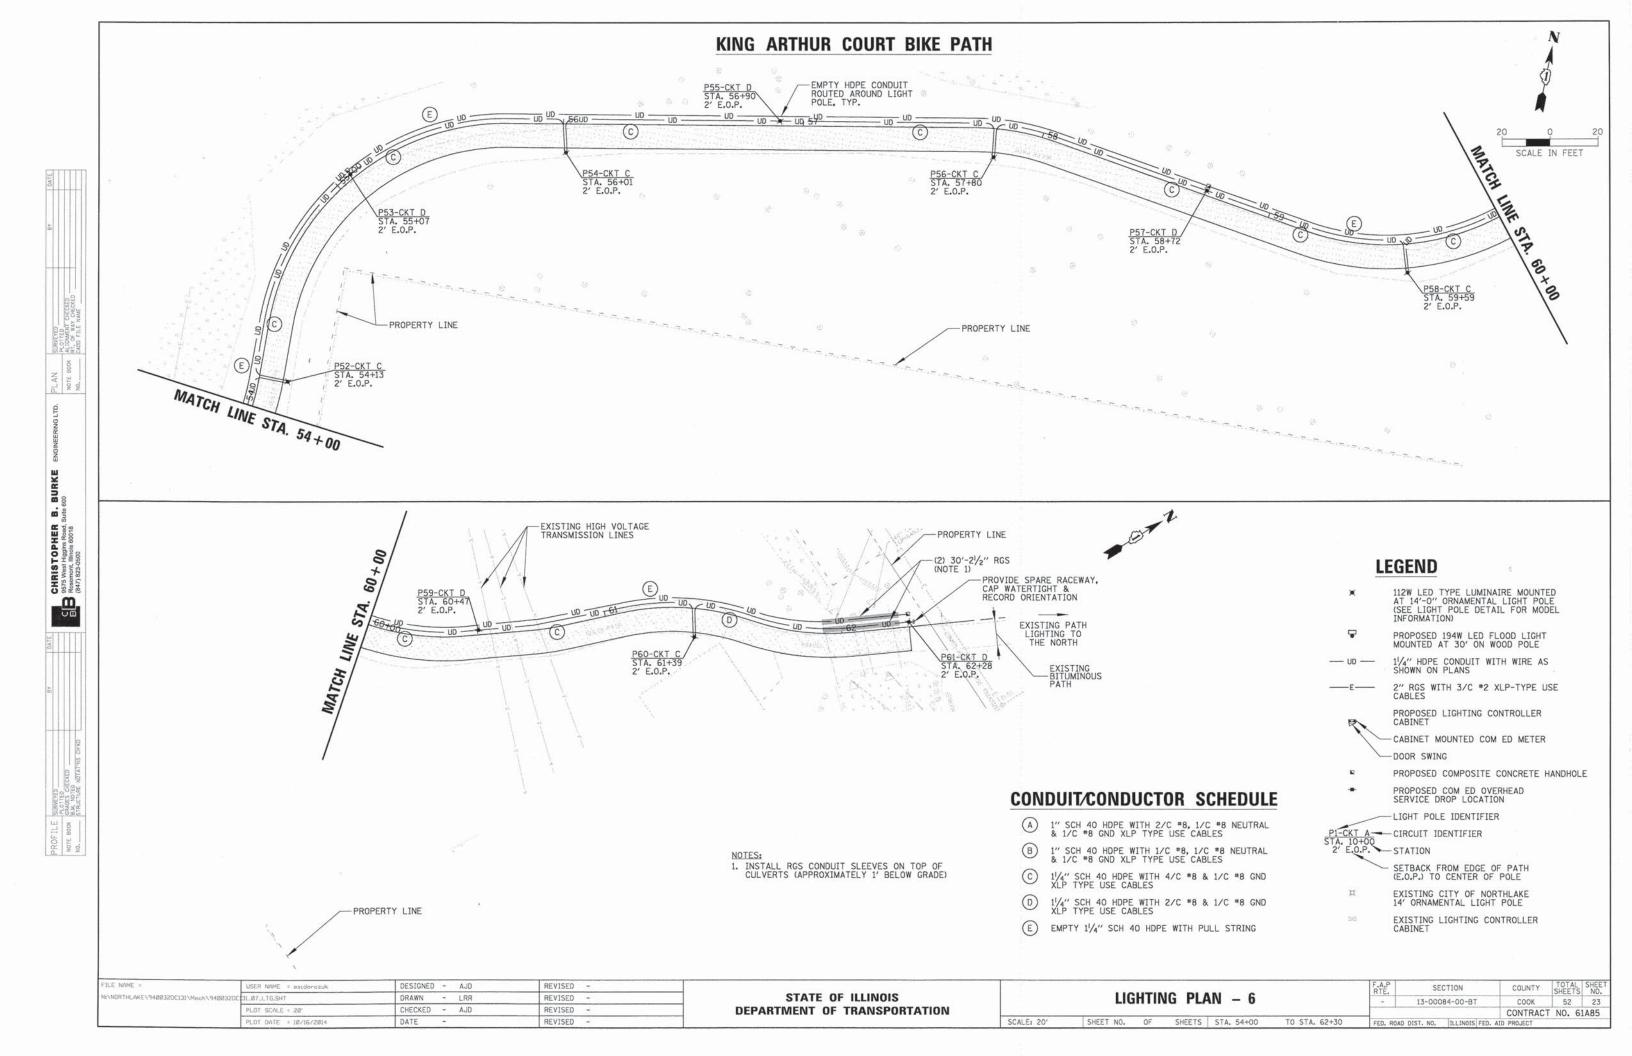

1) MAIN CIRCUIT BREAKER	100 AMPERE, 2P, 240V SERVICE RATING, 10KAIC THERMAL MAGNETIC MOLDED CASE
2 LAMPHOLDER CIRCUIT BREAKER	20 AMPERE, 1P, 120V RATING, 10KAIC THERMAL MAGNETIC MOLDED CASE
3 PHOTOELECTRIC CONTROL CIRCUIT BREAKER	15 AMPERE, 1P, 120V RATING, 10KAIC THERMAL MAGNETIC MOLDED CASE
4 AUXILIARY RELAY	120 V OPERATED DPDT 60 HZ COIL 2 NO & 2 NC CONTACTS, PLUG IN TYPE, PANEL MOUNTED
5 CABINET RECEPTACLE AND BOX	COMMERCIAL GRADE GFCI 20A/12OV, MOUNTED IN A WEATHERPROOF CAST ALUMINUM SINGLE GANG BOX WITH WEATHERPROOF COVER
6 CABINET LIGHT AND BOX	DIE CAST ALUMINUM BOX AND CAGE, WITH VAPORPROOF CLEAR GLASS GLOBE, EXTERIOR GRADE 120V-100W MEDIUM BASE ROUGH SERVICE INCANDESCENT LAMP
7 CONTACTOR	100 AMPERE, 2P, 120V COIL, MECHANICALLY HELD
8 BRANCH LINE CIRCUIT BREAKERS	5-30A, 2P, 240V RATING, 10KAIC (LITE CKTS) THERMAL MAGNETIC MOLDED CASE
(9) POWER DISTRIBUTION BLOCK	600 VOLT, INSULATED, SIZE AS REQ'D
(10) FUTURE CAMERA BREAKER	20 AMPERE, 1P, 120V RATING, 10KAIC THERMAL MAGNETIC MOLDED CASE
(11) LAMPHOLDER WIRE	2-600V XLP NO. 12
(12) CONTROL WIRE	2-600V XLP NO. 12
13) SURGE ARRESTOR	10 K AMPERE RATING
(4) PHOTOELECTRIC CONTROL WIRE	3-600V XLP NO. 12
(5) DOOR SWITCH	20A/120V, DOOR MOUNTED SNAP ACTION TYPE PLUNGER SWITCH
(6) HAND-AUTO-OFF CONTROL SWITCH	20A, 3 POS. MTD IN CAST ALUM. ENCLOSURE
17 PHOTOCELL	120V, MTD. ON BOTTOM SIDE OF CABINET, 30 SEC DELAY, SPST-NC, 1-4FC ON, 3-12FC OFF
(18) TERMINAL BLOCK	3 TERMINAL, SCREW TYPE, MAX. #10 WIRE SIZE
(19) CIRCUIT BREAKER DIST. BLOCKS	30A, 600V, 10 KAIC - WIRE RANGE: LINE SIDE LUG (1) #2/0-#14 AWG, LOAD SIDE LUGS (2) #4-#14 AWG
NOTES:	
1. ALL ITEMS LISTED IN LIGHT PAY ITEM INCLUDING CABIN	TING CONTROLLER COMPONENT SCHEDULE SHALL BE INCLUDED IN THE LIGHTING CONTRET AND FOUNDATION.
 THE LIGHTING CONTROLLER AS AN "ENCLOSED INDUSTRI 	TOGETHER WITH ALL OF ITS COMPONENTS SHALL BE UL LISTED AL CONTROL PANEL" UNDER UL508A.
3. CONNECTION OF SURGE ARR	ESTOR TO LINE SIDE OF MAIN CIRCUIT BREAKER SHALL NOT BE "DOUBLE LUGGED."
LIGHTING Ó	ONTROLLER LC1 COMPONENT SCHEDULE


E G

ITEM

ULE SHALL BE INCLUDED IN THE LIGHTING CONTROLLER


SPECIFICATION

VIPONENT SCHEDULE

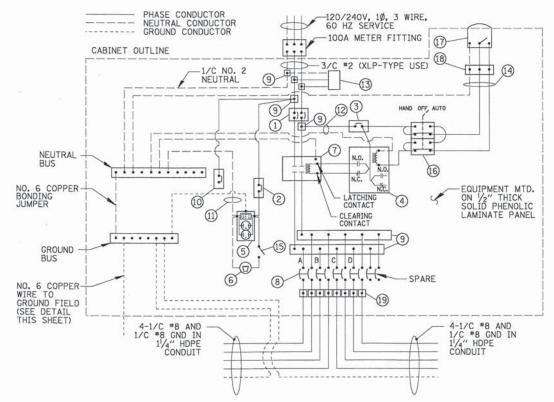

LIGHTING CONTROLLER LC1 WIRING DETAIL

1			
FILE NAME = USER NAME = esidoroza	k DESIGNED - AJD	REVISED -	
N:\NORTHLAKE\940032DCl3i\Mech\940032DC 31.08_LDT.aht	DRAWN - LRR	REVISED -	
PLOT SCALE = 20°	CHECKED - AJD	REVISED -	
PLOT DATE = 10/16/201	4 DATE -	REVISED -	

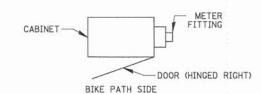

LIGHTING CONTROLLER LC1

CABINET METER FITTING & DOOR ORIENTATION


EXISTING COM ED WOOD-UTILITY POLE NON-METALLIC U-GAURD CONTRACTOR TO INSTALL -SUFFICIENT CABLE SLACK TO REACH COM ED SECONDARY/TRANSFORMER AS FURNISHED BY CONTRACTOR INSTALLED BY WITHOUT SPLICING (NOTE 2) COM ED TO INSTALL FROM 10 FT. ABOVE GRADE AND UP FURNISHED & INSTALLED CONTRACTOR 10'-2" GALV. CONDUIT 2 HOLE STRAPS, AS -GRADE LINE REQUIRED -5/"x10" COPPERWELD GROUND ROD W/ *4 AWG BARE COPPER GROUND WIRE ATTACHED W/ CLAMPS, LISTED FOR DIRECT BURIAL SERVICE

- ALL WORK SHALL CONFORM TO COM ED'S BOOK OF "INFORMATION AND REQUIREMENTS FOR THE SUPPLY OF ELECTRIC SERVICE."
- 2. CONTRACTOR SHALL PROVIDE CONDUIT BUSHING AND SEALING COMPOUND AT TOP OF RISER.
- 3. ALL MATERIAL ABOVE (EXCEPT FOR POLE) SHALL BE INCLUDED IN THE PRICE BID FOR "ELECTRIC SERVICE INSTALLATION". THE HORIZONTAL SERVICE CONDUIT AND WIRING FROM POLE TO CONTROLLER SHALL BE PAID FOR SEPERATELY.

COM ED OVERHEAD CONNECTION POLE

LIGHTING CONTROLLER LC1 112W LED LUMINAIRE 194W LED FLOOD LIGHT TOTAL CIRCUIT LOAD CIRCUIT ID LOAD/FIXT (WATTS) LOAD/FIXT. (WATTS) (WATTS) AMPS (VOLTS) QTY. 112 W 194 W 1,008 W 4.2A (240V) 9 112 W 0 194 W 1,008 W 4.2A (240V) 12 112 W 194 W 1,538 W 6.2A (240V) D 12 112 W 194 W 1,538 W 6.4A (240V) TOTAL 42 21.2A (240V)


PROPOSED LIGHTING/ELECTRICAL CIRCUIT LOADS

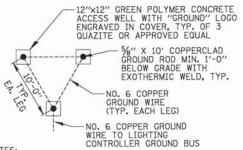

NOTES:

1. ACCESS WELLS & GROUND RODS/WIRING SHALL BE INCLUDED IN THE LIGHTING CONTROLLER PAY ITEM.

GROUND FIELD DETAIL (TYP.)

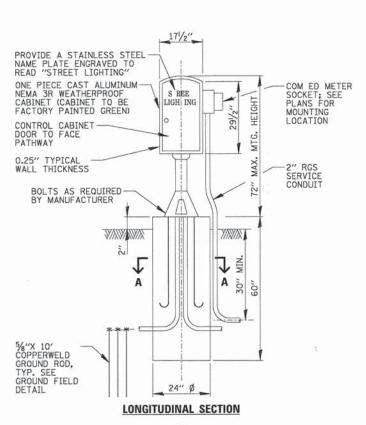

SECTION A-A

-21/2" SCH 40 PVC CONDUIT RACEWAYS AS REQUIRED (PROVIDE 2 SPARES)

NOTE: ALL ITEMS SHOWN ABOVE INCLUDING FOUNDATION SHALL BE INCLUDED IN THE LIGHTING CONTROLLER PAY ITEM EXCEPT FOR THE SERVICE CONDUIT/CABLES.


LIGHTING CONTROLLER LC1 CABINET AND FOUNDATION

STATE OF ILLINOIS **DEPARTMENT OF TRANSPORTATION** SHEET NO.

1101		o DET		_	F.A.P RTE.	SE	CTION	COUNTY	TOTAL	SHEET NO.
LIGHTING DETAILS – 1		1	-	13-000	84-00-BT	COOK	52	24		
								CONTRAC	T NO. 6	1A85
ET NO.	OF	SHEETS	STA.	TO STA.	FED. ROAD	DIST. NO.	ILLINOIS FED. A	ID PROJECT		


		ITEM	SPECIFICATION OR EQUAL	
		(1) MAIN CIRCUIT BREAKER	60 AMPERE, 2P, 240 V RATING, 10KAIC	
		2 LAMPHOLDER CIRCUIT BREAKER	15 AMPERE, 1P, 120 V RATING, 10KAIC	
		3 PHOTOELECTRIC CONTROL CIRCUIT BREAKER	15 AMPERE, 1P, 120 V RATING, 10KAIC	
		(4) AUXILIARY RELAY	120 V OPERATED SPST 60 HZ COIL 600V NORMALLY OPEN CONTACTS	
		(5) NOT USED		
DATE		6 LAMPHOLDER WITH OUTLET	120 VOLT WEATHERPROOF LAMPHOLDER WITH SPST SWITCH & GFCI OUTLET	
		(7) CONTACTOR	30 AMPERE, 2 POLE, 240 V RATING	
		(8) BRANCH LINE CIRCUIT BREAKERS	4- 30 AMPERE, 1P, 120 V RATING, 10KAIC	
A		9 TERMINAL BLOCK	600 VOLT	
		(10) SERVICE CABLES	3-600V (EPR-TYPE USE) NO. 6	
		(1) LAMPHOLDER WIRE	2-600V EPR NO. 12	
		(12) CONTROL WIRE	2-600V EPR NO. 12	
		(13) BRANCH LINE CABLES	3/C NO. 8 & 1/C NO. 8 XLP GROUND, 600V, IN 1" HDPE	
ECKEL VE VE		(14) PHOTOELECTRIC CONTROL WIRE	3-600V EPR NO. 12	
SURVEYED. PLOTED ALIDMENT CHECKED RT. OF WAY CHECKED CADD FILE NAME		(15) NOT USED		
SUR ALLIC CADE		(16) HAND-AUTO-OFF CONTROL SWITCH	20 AMPERE, 3 POLE, 600 V	
8000K		(17) SURGE ARRESTORS	10 K AMPERE RATING	
PLAN NOTE 8	EX	XISTING LIGHTING CONT	ROLLER "LC" COMPONENT SCHED	ULE
9		1 1 1 1 1 1 1 1 1 1 1 1 1 1 1 1 1 1 1	0/240V, 10,3 WIRE, 60 HZ SERVICE	
ENGINEERING LTD			the state of the s	
NE EE	MET	ER TO BE SUPPLIED BY		
ENGI	LOCA	AL UTILITY COMPANY	PHAS	SE CONDL
ш			NEU	TRAL CON
BURKE			(17)	UND CONE
3 8		<u> </u>		
e eta		-1/C NO. 6		

CHRISTOPHER IS 9575 West Higgins Road, Sur Rosemont, Illinois 60018 (847) 823-0500

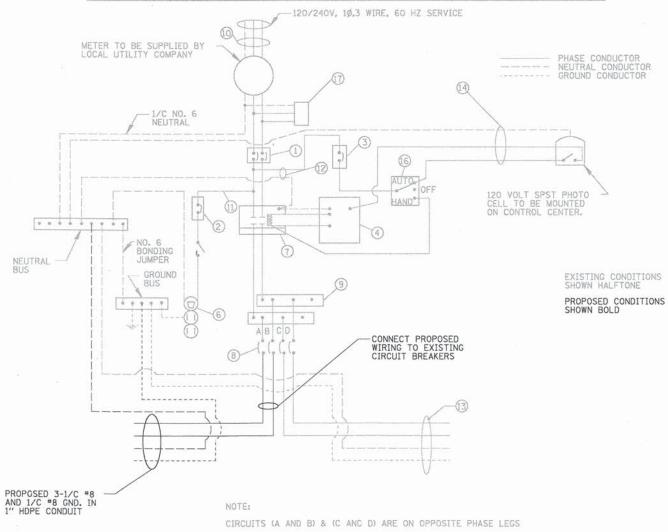

		EXISTING I	LIGHTII	NG CONTROLL	ER "LC"	
CIRCUIT ID		60W LED UMINAIRE		112W LED LUMINAIRE	TOTAL (CIRCUIT LOAD
CIRCUIT ID	QTY.	LOAD/FIXT. (WATTS)	ату.	LOAD/FIXT. (WATTS)	(WATTS)	AMPS (VOLTS)
Α	-		10	112 W	1,120 W	6.5A (120V)
В	-	-	9	112 W	1,008 W	6.5A (120V)
С	3	60 W	T/	-	180 W	1.5 A (120V)
D	2	60 W	-	н.	120 W	1.0 A (120V)
TOTAL	5	N/A	19	N/A	2,428 W	10.1A (240V)

PROPOSED LIGHTING/ELECTRICAL CIRCUIT LOADS

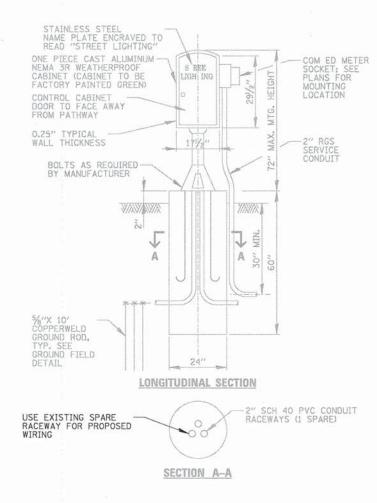

EXISTING LIGHTING CONTROLLER "LC" CABINET AND FOUNDATION N.T.S.


SCALE: N.T.S.

EXISTING LIGHTING CONTROLLER "LC" WIRING DETAIL

FILE NAME =	USER NAME # esidorozuk	DESIGNED - AJD	REVISED -	
N:\NORTHLAKE\9400320C131\Me	ch\940032DC 31_09_LDT.sht	DRAWN - LRR	REVISED -	
	PLOT SCALE = 20°	CHECKED - AJD	REVISED -	
	PLOT DATE = 10/16/2014	DATE -	REVISED -	

STATE OF ILLINOIS
DEPARTMENT OF TRANSPORTATION

LIGHTING DETAILS - 2		•	F.A.P RTE.	SECTION	COUNTY	TOTAL	SHEET NO.			
		-	13-00084-00-BT	COOK	52	25				
								CONTRACT	NO. 6	1A85
EET	NO.	OF	SHEETS	STA.	TO STA.	FED. ROA	DIST. NO. ILLINOIS FED.	AID PROJECT		

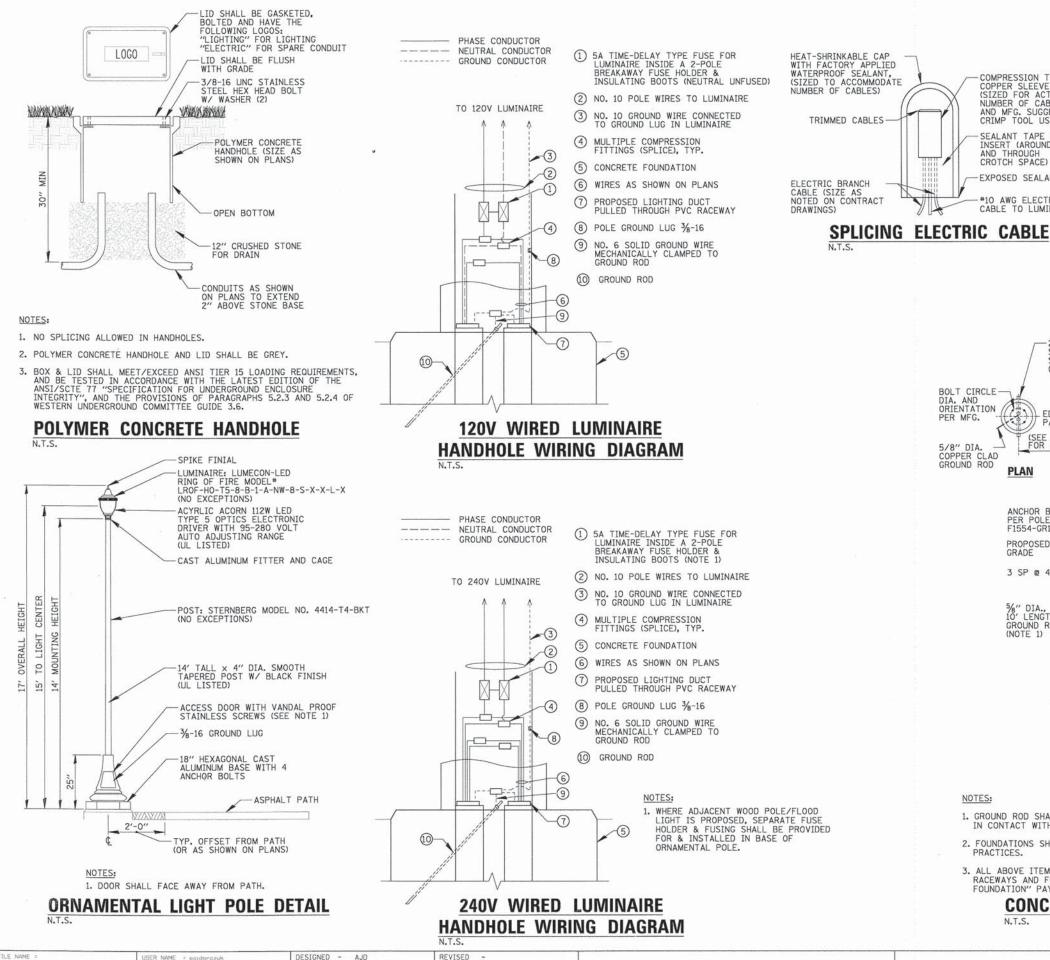

DRAWN - LRR

CHECKED - AJD

DATE

REVISED


REVISED

REVISED

1_10_LDT.sht

PLOT SCALE = 20

B

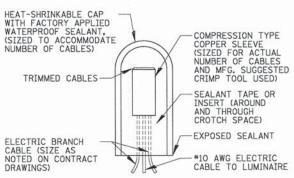

BOLT CIRCLE-DIA. AND

ORIENTATION PER MFG.


-3" CLEAR

RED WARNING TAPE 6" WIDE - CABLE AND DUCT SIZES AS SHOWN ON LIGHTING PLANS 6" TO 10"

FINISHED GRADE

TYPICAL CONDUIT INSTALLATION DETAIL

TRENCH SECTION

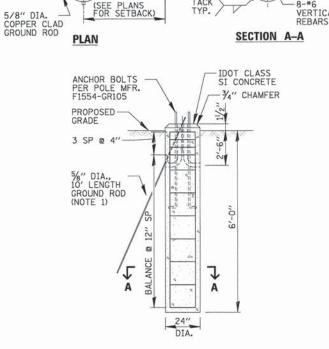

-2/2" LARGE RADIUS SCH 40 PVC CONDUIT SLEEVES AS REQUIRED (MIN. OF 2)

EDGE OF-

HOOPS

NOTES:


STATE OF ILLINOIS

DEPARTMENT OF TRANSPORTATION

- GROUND ROD SHALL BE CAST INTO CONCRETE FOUNDATION WITH 8 FEET IN CONTACT WITH SOIL.
- 2. FOUNDATIONS SHALL BE VIBRATED IN ACCORDANCE WITH IDOT STANDARD PRACTICES.
- 3. ALL ABOVE ITEMS INCLUDING CONCRETE, GROUND ROD, REINFORCEMENT, RACEWAYS AND FORMWORK SHALL BE INCLUDED IN THE "LIGHT POLE FOUNDATION" PAY ITEM.

CONCRETE FOUNDATION DETAIL

	1101				•	RTE.	SE	CTION	COUNTY	SHEETS	NO.
	LIGH	HING	j DEI#	AILS -	3	-	13-000	84-00-BT	соок	52	26
									GONTRAC	T NO. 6	1A85
SCALE: N.T.S.	SHEET NO.	OF	SHEETS	STA.	TO STA.	FED. ROA	AD DIST. NO.	ILLINOIS FED.	AID PROJECT		

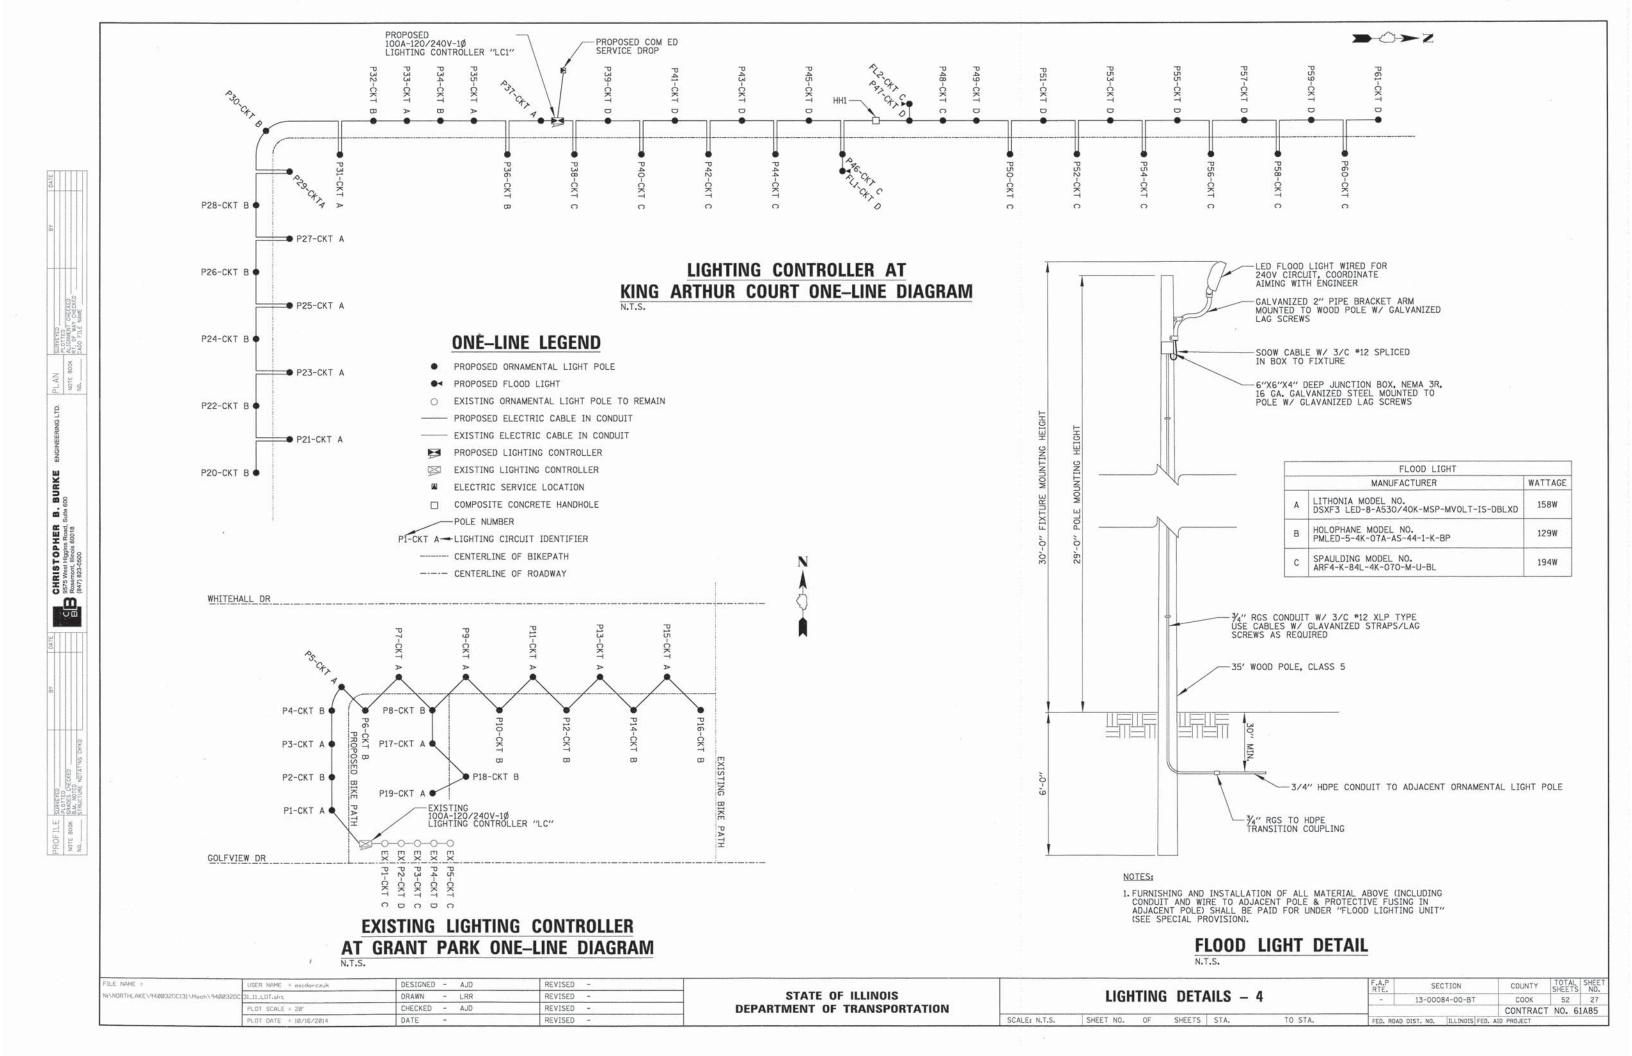

Lewis	Re	vno	lds

Lewis Reynolds

Wednesday, August 13, 2014 8:34 AM Sent:

To: fabian.vela@comed.com

Subject: Account # 4098117076 - 27 N. King Arthur Ct. Northlake, IL 60164 - Bike Path Lighting

Attachments: ComEd Service Application.doc

Good morning, attached is the Service and Meter Application for the proposed project. Just to reiterate some things, we would like to receive service from the pole North of the tennis courts and South of the transmission tower. At our site visit on 7/9/14 you said that you would look into installing a transformer on that pole so that would can have 120/240V service and that a rough cost estimate was around \$10,000. Thank you again for your help. Please let me know if you need any additional information.

Lewis R. Reynolds Christopher B. Burke Engineering, Ltd. 9575 W. Higgins Road, Suite 600 Rosemont, IL 60018 Phone: (847) 823-0500 Fax: (847) 939-5214 E-Mail: [reynolds@cbbel.com

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Service and Meter Application Switch and Load Information Sheet

Please complete a separate sheet for each switch - existing or new: Project Name: City of Northlake-King Arthur Ct. Path Lighting

Site Address: 27 N. King Arthur Ct. Switch Name and Location: 200' W. of NW Corner of Building 27 in King Arthur Court Apartment Complex

Service Voltage (check one):	
20/240V 1-phase, 3-wire	277/480V 3-phase, 4-wire
120/240V 3-phase, 4-wire	480V 3-phase 3-wire (B-phase Gro
☐ 120/208V 3-phase, 4-wire ☐ Other:	480V 3-phase 3-wire (Ungrounder

ed - requires ground detection equip.)

☐ 4kV ☐ 12kV ☐ 34kV 3-phase, 3-wire ☐ 4kV ☐ 12kV ☐ 3-phase, 4-wire Other Items (check all that apply):

New Construction N/A Sq. Ft. Underground Service
Building Addition Sq. Ft. Overhead Service
Relocating Existing Service Entrance Commercial – No. of units
Hi-Rise/ Vault Service Residential – No. of units New Construction N/A Sq. Ft.

Sq. Ft.

Date of Ground Breaking (est.): Date to Energize: June 2015

☐ Hi-Rise/ Vault Service

Date to Final Grade (est.): March 2015 Hours of Operation Per Day: \square 8 \boxtimes 12 \square 16 \square 24

Switch Size (amps): 100 (If switchgear is 1,200 Amps or larger, customer must submit drawings for ComEd approval) Switch Rating (percentage): 80

Secondary Conductors: 1 Sets of 3 /C 2 (No. of condu CU or □ AL (No. of conductors) (Size)

Total Connected Load Information:

(KW or HP)	Description:	Connect	ed Load:
		1-phase	3-phase
Lighting:	Ornamental Path Lighting	5.2 kW	
VAC:			
Receptacle:			
Process Heat:			
Water Heat:			***************************************
Space Heat:			
Motors*:			
Welders**:			
TOTAL LOAD:		5.2 kW	

*Motor Load Detail included above:

Description	Quantity	Size (HP)	Efficiency Rating	Phase / Voltage	Nema Code	Starts Per Hr. or Day	Starting Amps	Use
					-			-
				Committee No.	-			

WWMalder Detail included about

Description	Quantity	Size (kVA)	Type	Max. Inst. Demand	P.F. at Peak	Welds Per Minute	Cycles Per Weld	Hours Per Day Use
					-			





Service and Meter Application

Project Information Sheet

Project Name: City of Northlake-King Arthur Ct. Path Lighting

Site Address: 27 N. King Arthur Ct.

City: Northlake

Zip: 60164

Total Number of Service Entrance Locations (meters/switches) Requested: 1

Legal Name of Entity (Electric Consumer): City of Northlake

☐ Corporation ☐ Partnership ☐ Sole Proprietor ☒ Other: Municipality

Existing Account Number: 4098117076 Tax I.D.: 36-6006021

Principle(s) to Sign Contracts For Service, Easements, Etc.:

Property Owner: City of Northlake

Phone: (708) 343-8700 Building Owner: City of Northlake Phone: (708) 343-8700 Phone:

Building Manager:

Mailing Address For Contracts:

Mailing Address For Electric Bills:

Company: City of Northlake

Address: 9575 W. Higgins Rd.

Company: City of Northlake Address: 55 E. North Ave.

Phone: (708) 343-8700 Fax: (708) 343-8708 Zip: 60164

City: Northlake

Fax:

Zip:

Phone: (708) 562-0940 Fax: Zip: 60164

City: Northlake Address: 100 W. Palmer Ave.

Project Contacts:

Consulting Engineer: Anthony DeRicco E-mail: adericco@cbbel.com

Fax: (847) 939-5214 Firm Name: Christopher B. Burke Engineering Phone: (847) 823-0500 City: Rosemont Zip: 60018

Electrical Contractor:

Consulting Engineer:

E-mail:

Phone:

Firm Name: Address:

Fax: City: Zip:

Address:

Consulting Engineer: Firm Name:

E-mail:

Phone: City:

The Following Documents May Be Required:

1. Plat of Survey with legal description of property (for easement, if required)

2. Site Plan showing building relative to property lines - mark service entrance location(s)

3. Civil drawings (showing water, sewer, gas, phone, electric, pavement, grading, etc.)

Complete electrical drawings and/or load detail sheets

Information Provided By: Print Name: Anthony DeRicco


Signature: Date: 8/13/14

COM ED CORRESPONDENCE


CONTROLLER #1 SERVICE APPLICATION

FILE NAME :	USER NAME = esidonozuk	DESIGNED - AJD	REVISED -		ELECTRIC SERVICE COORDINATION	F.A.P SECTION	COUNTY TOTAL SHEET
N:\NORTHLAKE\940032DC13I\Mech\940032DC	31_12_LDT.sht	DRAWN - LRR	REVISED -	STATE OF ILLINOIS		- 13-00084-00-BT	COOK 52 28
	PLOT SCALE = 20°	CHECKED - AJD	REVISED -	DEPARTMENT OF TRANSPORTATION	"FOR INFORMATION ONLY"		CONTRACT NO. 61A85
	PLOT DATE = 10/16/2014	DATE -	REVISED -		SCALE: N.T.S. SHEET NO. OF SHEETS STA. TO STA.	FED. ROAD DIST. NO. ILLINOIS FED	. AID PROJECT




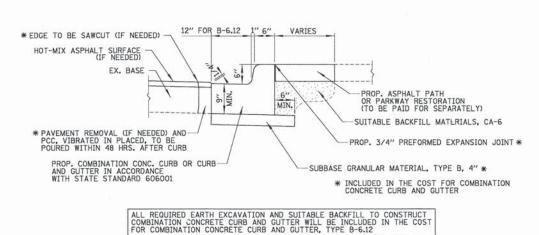


COMBINATION CONCRETE CURB AND GUTTER, TYPE B-6.12

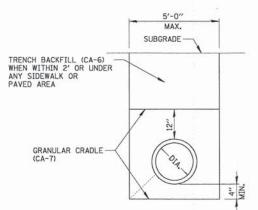


TYPICAL TRENCH DETAIL

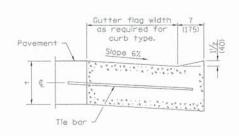

DEPRESSED CURB (TYPICAL)

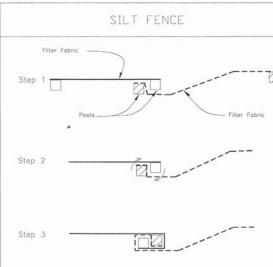

ATTACHING TWO SILT FENCES

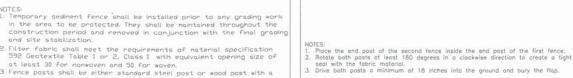

and site stabilization.

2. Filter fabric shall meet the requirements of naterial specification 592 Geotextile Table 1 or 2. Class I with equivalent opening size of at least 30 for nonwoven and 50 for woven.

3. Fence posts shall be either standard steel post or wood post with a ninimum cross-sectional area of 3.0 sq. in.

SILT FENCE PLAN

Fastener - Min. No. 18 Gage Wine

4 Per Post Required (Typ.

FABRIC ANCHOR DETAIL

REFERENCE Project		A ND	CC STANDARD DVG. NO.
Designed	Do te	♦ NR	SHEET 1 OF 2
Approved	Date	Netural Resources Corservation Ser	

ELEVATION

REFERENCE	
Project	
Designed	Odle
Checked	Date
Approved	Dute




and Class III compaction.

Filter Fabric


* Must Extend Full Width

Of Ingress And Egress Operation

3.Any drainage facilities required because of washing shall be constructed according to manufacturers specifications. 4.If wash racks are used they shall be installed according to the nanufacturer's specifications. NRCS IL-630

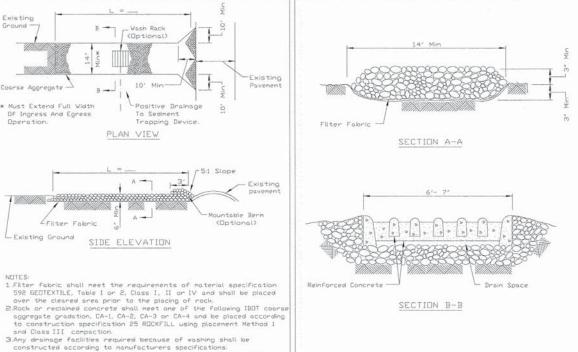

STABILIZED CONSTRUCTION ENTRANCE PLAN

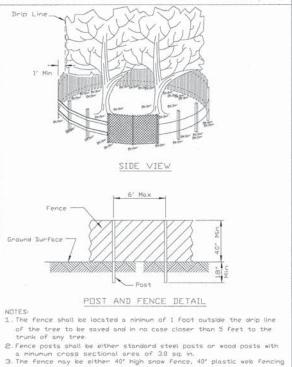

TREE PROTECTION - FENCING

NRCS

DESIGNED - AMP REVISED DRAWN - MAK REVISED 2de131_01.sht CHECKED - MEW REVISED

STATE OF ILLINOIS **DEPARTMENT OF TRANSPORTATION**

STABILIZED CONSTRUCTION ENTRANCE PLAN

| Wash Rack | (Optional)

Positive Drainage

To Sediment

PLAN VIEW


SIDE ELEVATION

CONSTRUCTION DETAILS SHEET NO. OF SHEETS STA.

IL-630

TOTAL SHEE NO. SECTION COUNTY COOK 13-00084-00-BT CONTRACT NO. 61A85 FED. ROAD DIST. NO. | ILLINOIS FED. AID PROJECT

1L-690

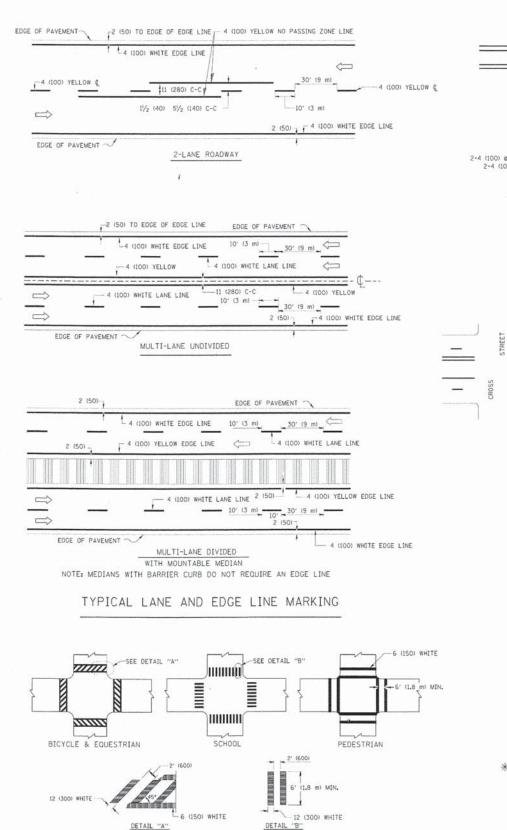


2-4 (100) YELLOW ® 11 (280) C-C

NO DIAGONALS

4' (1,2 m) OUTSIDE TO OUTSIDE OF LINES


2-4 (100) YELLOW ® 11 (280) C-C

4' (1.2 m) WIDE MEDIANS ONLY

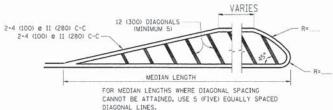

DIAGONAL LINE SPACING: 50' (15 m) C-C (LESS THAN 30MPH (50 km/h))
75' (25 m) C-C 30MPH (50 km/h) T0 45MPH (70 km/h))
150' (45 m) C-C (MORE THAN 45MPH (70 km/h))

MEDIANS OVER 4' (1.2 m) WIDE

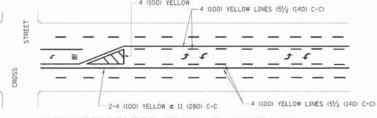


A MINIMUM OF TWO PAIRS OF TURN ARROWS SHALL BE USED, WHITE IN COLOR, ADDITIONAL PAIRS SHALL BE PLACED AT 200' (60 m) TO 300' (90 m) INTERVALS.



MEDIAN WITH TWO-WAY LEFT TURN LANE

TYPICAL PAINTED MEDIAN MARKING

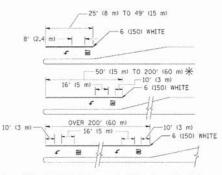


FULL SIZE LETTERS 8 (2.4 m) AND ARROWS SHALL BE USED. \P AREA = 15.6 SO. FT. (1.5 m²) Π AREA = 20.8 SO. FT. (1.9 m²)

* TURN LANES IN EXCESS OF 400' (120 m) IN LENGTH MAY HAVE AN ADDITIONAL SET OF ARROW - "ONLY" INSTALLED MIDWAY BETWEEN THE OTHER TWO SETS OF ARROW - "ONLY".

TYPICAL LEFT (OR RIGHT) TURN LANE

TYPICAL TURN LANE MARKING

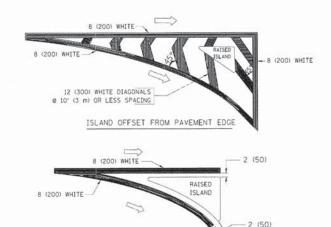

TYPICAL ISLAND MARKING

ISLAND AT PAVEMENT EDGE

TYPE OF MARKING	WIDTH OF LINE	PATTERN	COLOR	SPACING / REMARKS
CENTERLINE ON 2 LANE PAVEMENT	4 (100)	SKIP-DASH	YELLOW	10' (3 m) LINE WITH 30' (9 m) SPACE
CENTERLINE ON MULTI-LANE UNDIVIDED PAVEMENT	2 0 4 (100)	SOLID	YELLOW	11 (280) C-C
NO PASSING ZONE LINES: FOR ONE DIRECTION FOR BOTH DIRECTIONS	4 (100) 2 9 4 (100)	SOLID SOLID	YELLOW YELLOW	5/2 (140) C-C FROM SKIP-DASH CENTERLINE 11 (280) C-C OMIT SKIP-DASH CENTERLINE BETWEEN
LANE LINES	4 (100) 5 (125) ON FREEWAYS	SKIP-DASH SKIP-DASH	WHITE WHITE	10' (3 m) LINE WITH 30' (9 m) SPACE
DOTTED LINES (EXTENSIONS OF CENTER, LANE OR TURN LANE MARKINGS)	SAME AS LINE BEING EXTENDED	SKIP-DASH	SAME AS LINE BEING EXTENDED	2' (600) LINE WITH 6' (1.8 m) SPACE
EDGE LINES	4 (100)	SOLID	YELLOW-LEFT WHITE-RIGHT	OUTLINE MOUNTABLE MEDIANS IN YELLOW: EDGE LINES ARE NOT USED NEXT TO BARRIER CURB
TURN LANE MARKINGS	6 (150) LINE: FULL SIZE LETTERS & SYMBOLS (8' (2.4m))	SOLID	WHITE	SEE TYPICAL TURN LANE MARKING DETAIL
TWO WAY LEFT TURN MARKING	2 @ 4 (100) EACH DIRECTION	SKIP-DASH AND SOLID	YELLOW	10' (3 m) LINE WITH 30' (9 m) SPACE FOR SKIP-DASH; 51/2 (140) C-C BETWEEN SOLID LINE AND SKIP-DASH LINE
	8' (2.4m) LEFT ARROW	IN PAIRS	WHITE	SEE TYPICAL TWO-WAY LEFT TURN MARKING DETAIL
CROSSWALK LINES (PEDESTRIAN) A. DIAGONALS (BIKE & EQUESTRIAN) B. LONGITUDINAL BARS (SCHOOL)	2 @ 6 (150) 12 (300) @ 45° 12 (300) @ 90°	SOLID SOLID SOLID	WHITE WHITE WHITE	NOT LESS THAN 6' (1.8 m) APART 2' (500) APART 2' (500) APART SEE TYPICAL CROSSWALK MARKING DETAILS.
STOP LINES	24 (600)	SOLID	WHITE.	PLACE 4' (1.2 m) IN ADVANCE OF AND PARALLEL TO CHOSSWALK, IF PRESENT. OTHERNISE, PLACE AT DESIRED STOPPING POINT. PARALLEL TO CROSSROAD CENTERLINE, WHERE POSSIBLE
PAINTED MEDIANS	2 @ 4 (100) WITH 12 (300) DIAGONALS 0 45° NO DIAGONALS USED FOR 4' (1.2 m) WIDE MEDIANS	SOLID	YELLOW: TWO WAY TRAFFIC WHITE: ONE WAY TRAFFIC	11 (280) C-C FOR THE DOUBLE LINE SEE TYPICAL PAINTED MEDIAN MARKING.
GORE MARKING AND CHANNELIZING LINES	8 (200) WITH 12 (300) DIAGONALS @ 45°	SOLID	WHITE	DIAGONALS: 15' (4,5 m) C-C (LESS THAN 30MPH (50 km/h)) 20' (6 m) C-C 30MPH (50 km/h) TO 45MPH (70 km/h)) 30' (9 m) C-C (OVER 45MPH (70 km/h))
RAILROAD CROSSING	24 (600) TRANSVERSE LINES: "RR" IS 6' (1.8 m) LETTERS; 16 (400) LINE FOR "X"	SOLID	WHITE	SEE STATE STANDARD 780001 AREA OF: "R"-3.6 SQ. FT. (0.33 m²) EACH "X"-54.0 SQ. FT. (5.0 m²)
SHOULDER DIAGONALS	12 (300) @ 45°	SOLÍD	WHITE - RIGHT YELLOW - LEFT	50' (15 m) C-C (LESS THAN 30MPH (50 km/h)) 75' (25 m) C-C (30 MPH (50 km/h) TO 45MPH (70 km/h) 150' (45 m) C-C (0VER 45MPH (70 km/h))

FOR FURTHER DETAILS ON PAVEMENT MARKING REFER TO STANDARD SPECIFICATIONS FOR ROAD AND BRIDGE CONSTRUCTION AND STATE STANDARD 780001.


All dimensions are in inches (millimeters) unless otherwise shown.

FILE NAME =	USER NAME = drivakosgn	DESIGNED EVERS	REVISED T. RAMMACHER 10-27-94
c:\ow_work\pw:dot\cr;vokosgn\d8108315\tc 3.dgn		DRAWN -	REVISED -C. JUCIUS 09-09-09
	PLOT SCALE = 50.000 1/ IN.	CHECKED -	REVISED -
	PLOT DATE = 9/9/2009	DATE - 03-19-90	REVISED

TYPICAL CROSSWALK MARKING

STATE OF ILLINOIS
DEPARTMENT OF TRANSPORTATION

	DISTRICT ONE					F.A RTE.	SECTION	COUNTY	TOTAL	SHEET NO.
TYPICAL PAVEMENT MARKINGS						-	13-00084-00-BT	соок	52	30
						TC-13		CONTRACT	NO.	61A85
ALE: NONE	SHEET NO	0. 1 OF	1 SHEETS	STA.	TO STA.	FED. ROAD DIST. NO. 1 ILLINOIS FED. AID PROJECT				

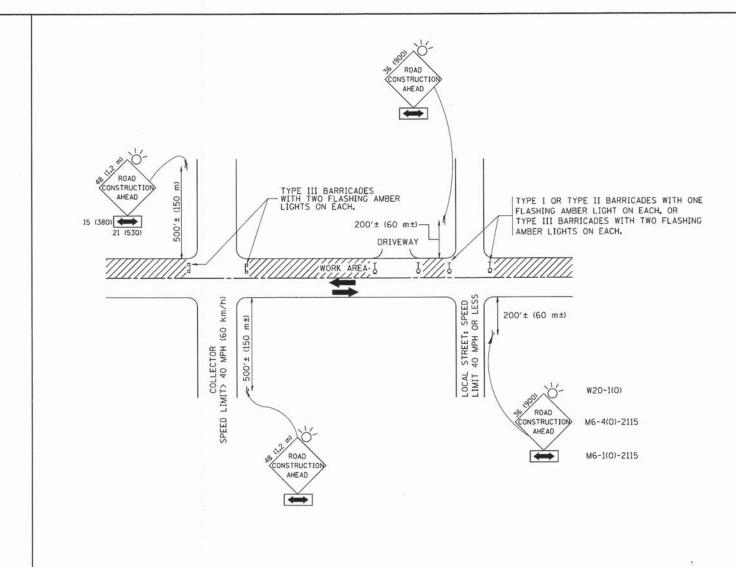

TRAFFIC CONTROL AND PROTECTION FOR SIDE ROADS, INTERSECTIONS, AND DRIVEWAYS

NOTES:

- A. FOR NO LANE RESTRICTION ON THE SIDE ROAD OR DRIVEWAYS
- SIDE ROAD WITH A SPEED LIMIT OF 40 MPH (60 km/h) OR LESS AS SHOWN ON THE DRAWING AND AS DIRECTED BY THE ENGINEER:
- O) ONE ROAD CONSTRUCTION AHEAD SIGN 36 x 36 (900x900) WITH A FLASHER AND FLAG MOUNTED ON IT APPROXIMATELY 200' (60 m) IN ADVANCE OF THE MAIN ROUTE.
- b) THE CLOSED PORTION OF THE MAIN ROUTE SHALL BE PROTECTED BY BLOCKING WITH TYPE I, TYPE II OR TYPE III BARRICADES, 1/3 OF THE CROSS SECTION OF THE CLOSED PORTION.
- 2. SIDE ROAD WITH A SPEED LIMIT GREATER THAN 40 MPH (60 km/h) AS SHOWN ON THE DRAWING AND AS DIRECTED BY THE ENGINEER:
- O) ONE ROAD CONSTRUCTION AHEAD SIGN 48 x 48 (1.2 m x 1.2 m) WITH A FLASHER MOUNTED ON IT APPROXIMATELY 500' (150 m) IN ADVANCE OF THE MAIN ROUTE.
- b) THE CLOSED PORTION OF THE MAIN ROUTE SHALL BE PROTECTED BY BLOCKING WITH TYPE III BARRICADES, 1/2 OF THE CROSS SECTION OF THE CLOSED PORTION.
- 3. WHEN THE SIDE ROAD LIES BETWEEN THE BEGINNING OF THE MAINLINE SIGNING AND THE WORK ZONE, A SINGLE HEADED ARROW (MG-1) SHALL BE USED IN LIEU OF THE DOUBLE HEADED ARROW (MG-4).

- B. FOR A LANE CLOSURE ON A SIDE ROAD OR DRIVEWAY:
- USE APPLICABLE PORTIONS OF THE TYPICAL APPLICATION OF TRAFFIC CONTROL DEVICES (STD. 701501, STD. 701606 OR THE APPROPRIATE STANDARD). THE SPACING OF SIGNS AND BARRICADES SHALL BE ADJUSTED FOR FIELD CONDITIONS AS DIRECTED BY THE ENGINEER. THE DIRECTIONAL ARROW SHALL BE COVERED OR REMOVED WHEN NO LONGER CONSISTENT WITH THE SIDE ROAD LANE CLOSURE.
- C. ADVANCE WARNING SIGNS ARE TO BE OMITTED ON DRIVEWAY UNLESS OTHERWISE NOTED.
- D. THE TRAFFIC CONTROL AND PROTECTION FOR SIDE ROADS, INTERSECTIONS, AND DRIVEWAYS SHALL BE INCIDENTAL TO THE COST OF SPECIFIED TRAFFIC CONTROL STANDARDS OR ITEMS.

All dimensions are in millimeters (inches) unless otherwise shown.

File NAME = USER NAME = geglianobt DESIGNED - LHA REVISED - J. OBERLE 10-18-95

Wi\distatd\22x34\tci8.dgn

PLOT SCALE = 58.008 ' / IN. CHECKED - REVISED - A. HOUSEH 10-15-96

PLOT DATE = 1/4/2008 DATE - 06-89 REVISED -T. RAMMACHER 01-06-00

STATE OF ILLINOIS
DEPARTMENT OF TRANSPORTATION

F.A. SECTION COUNTY TOTAL SHEETS NO.

- 13-00084-00-BT COOK 52 31

TC-10 CONTRACT NO. 61A85

FED. ROAD DIST. NO. 1 | ILLINOIS | FED. AID PROJECT

