				TRE	EREMOV	AL AND PROTECTION	ON							TRE	E REMOV	AL AND PROTECTION	NC		
TREE IUMBER	STA	OFFSET	LT/RT	STREET	SIZE	TREE REMOVAL (6 TO 15 UNITS DIAMETER)	TREE REMOVAL (OVER 15 UNITS DIAMETER)	*TREE REMOVAL (UNDER 6 UNITS DIAMETER)	TEMPORARY FENCE	TREE NUMBER	STA	OFFSET	LT/RT	STREET	SIZE	TREE REMOVAL (6 TO 15 UNITS DIAMETER)	TREE REMOVAL (OVER 15 UNITS DIAMETER)	*TREE REMOVAL (UNDER 6 UNITS DIAMETER)	
					INCH	UNIT	UNIT	UNIT	FOOT						INCH	UNIT	UNIT	UNIT	FOOT
1445	141+73.8	54.5	LT	IL 7	7	7	0	0		21408	213+57.2	71.4	LT	IL 7	3	0	0	0	20
1446	141+80.2	53.5	LT	IL 7	15	15	0	0		1539	213+72.1	74.0	LT	IL 7	8	0	0	0	20
1450	141+93.0	50.8	LT	L 7	6	6	0	0		21409	213+74.3	70.8	LT	IL 7	4	0	0	0	20
1451	141+94.0	51.9	LT	L 7	6	6	0	0		1540	213+76.7	69.9	LT	IL 7	6	0	0	0	20
1452	141+98.8	53.7	LT	IL 7	6	6	0	0		1541	213+77.8	66.6	LT	IL 7	10	10	0	0	
1463	142+04.0	51.0	LT	IL 7	10	10	0	0		21410	213+84.1	66.5	LT	IL 7	4	0	0	4	
1465	142+14.6	53.6		IL 7	9	9	0	0		1542	213+85.1	70.5	LT	IL 7	6	0	0	0	20
1464	142+14.9	60.9		L 7	44	0	44	0		1543	213+88.7	73.2		IL 7	6	0	0	0	20
1466 1467	142+15.3 142+56.5	47.2 53.3		L 7 L 7	9	9 14	0	0		21411	213+95.3	72.6	LT	IL 7	4	0	0	0	20
1467	142+56.5	62.1	LT LT	IL 7	14 14	14	0	0		21425 1522	214+32.9 214+36.8	81.3 64.3	LT RT	IL 7 IL 7	6 14	14	0	0	
1469	142+79.0	54.4		L 7	14	14	0	0		1544	214+30.8	73.4			6	0	0	0	20
21001	143+40.0	64.9	LT	IL 7	14	0	0	0	20	21412	214+37.3	67.3			4	0	0	4	- 20
21002	143+92.2	63.0	LT	L 7	12	0	0	0	20	21412	214+45.4	72.8			4	0	0	0	20
1470	143+94.0	57.9	LT	L 7	12	12	0	0		1524	214+46.0	60.3	RT	IL 7	14	14	0	0	
21101	160+09.2	124.2	RT	L 7	12	0	0	0	20	21414	214+56.4	69.4	LT	IL 7	4	0	0	4	
1471	161+97.7	67.2	RT	L 7	6	6	0	0		1526	214+57.2	55.3	RT	IL 7	18	0	18	0	
1472	161+99.1	62.8	RT	IL 7	22	0	22	0		21415	214+60.8	72.0	LT	IL 7	4	0	0	0	20
1473	163+03.4	63.4	RT	IL 7	10	10	0	0		1527	214+62.5	63.1	RT	IL 7	12	12	0	0	
21102	165+18.9	74.2	RT	L 7	8	0	0	0	20	1545	214+70.7	73.3	LT	IL 7	6	0	0	0	20
1474	165+25.1	61.3	RT	L 7	7	7	0	0		1528	214+81.5	62.9	RT	IL 7	6	6	0	0	
21103	165+31.7	71.6	RT	IL 7	9	0	0	0	20	21416	215+05.0	61.2	LT	IL 7	4	0	0	4	
1475	165+45.1	57.5	RT	IL 7	6	6	0	0		21417	215+16.4	67.3	LT	IL 7	4	0	0	4	
1476	165+57.2	53.8	RT	IL 7	10	10	0	0		1530	215+40.6	66.8	RT	IL 7	12	12	0	0	
1477	165+72.8	57.2	RT	IL 7	6	6	0	0		1531	215+40.7	67.2	RT	IL 7	12	12	0	0	
21104	166+04.7	79.6		L 7	6	0	0	0	20	21418	215+44.2 215+57.7	83.7		IL 7	4	0 8	0	4	
1478 1479	166+05.8	68.9	RT	L 7 L 7	12 12	12 12	0	0		1533 21419	215+57.7	62.8 71.8	RT LT	IL 7 IL 7	8	0 0	0	4	
1479	166+16.5 167+05.5	61.2 58.6	RT RT	IL 7	30	0	30	0		21419	215+39.3	59.0	RT		8	8	0	0	
21207	182+41.3	68.6		L 7	2	0	0	2		21401	215+73.1	69.6	LT		4	0	0	4	+
21201	182+66.2	67.7	RT	L 7	12	0	0	0	20	21420	215+80.8	59.5			4	0	0	4	
21205	182+85.5	69.8	LT	L 7	2	0	0	0	20	21422	215+89.9	69.7	LT	IL 7	4	0	0	4	-
21202	182+95.7	69.0	RT	L 7	14	0	0	0	20	1546	216+02.1	60.0	RT	IL 7	14	14	0	0	-
1206	183+48.9	65.5	LT	IL 7	2	0	0	0	20	21520	216+11.1	81.1	LT	IL 7	6	0	0	0	20
1208	183+60.4	45.4	RT	L 7	30	0	0	0	20	1587	216+32.8	66.0	LT	IL 7	7	7	0	0	
1203	184+87.7	97.5	RT	IL 7	12	0	0	0	20	1550	216+34.4	58.9	RT	IL 7	7	7	0	0	
1204	184+88.9	69.1	RT	IL 7	13	0	0	0	20	21521	216+43.7	76.6	LT	IL 7	4	0	0	4	
1303	198+52.7	103.7	RT	L 7	6	0	0	0	20	21522	216+45.3	80.7	LT	IL 7	16	0	0	0	20
1305	198+52.9	134.0	RT	L 7	6	0	0	0	20	25224	216+54.5	70.2	LT	IL 7	4	0	0	4	
1306	198+87.1	159.0	RT	IL 7	6	0	0	0	20	21525	216+55.1	79.9	LT	IL 7	4	0	0	0	20
1308	198+87.8	117.0	RT	IL 7	6	0	0	0	20	1551	216+65.7	53.4	RT	IL 7	6	6	0	0	
1309	199+19.8	104.6	RT	IL 7	6	0	0	0	20	1588	216+84.2	66.2	LT	IL 7	6	6	0	0	
1307	199+20.0	135.5	RT	IL 7	6	0	0	0	20	1553	216+90.4	64.6	RT	IL 7	10	10	0	0	4
1423	212+79.3	73.1	LT	IL 7	4	0	0	0	20	21526	217+02.9	64.5		IL 7	4	0	0	4	
1402	212+87.1	75.7		L 7	4	0	0	0	20	21527	217+03.4	71.3	LT		4	0	0	4	
1537	213+07.4	69.0		L 7	6	0	0	0	20	21728	217+03.4	71.3	LT	IL 7	4	0	0		+
1538	213+07.4	69.0		L 7	6	0	0	0	20	21501 21502	217+09.3 217+09.6	104.1	RT RT	IL 7 IL 7	7	0	0	0	20
1403 1404	213+17.9 213+27.6	70.3 63.8		IL 7 IL 7	4	0	0	0 4	20	21502	217+09.6	112.1	RT	IL 7	18	0	0	0	20
21404 21405	213+27.6	76.7	LT LT	IL 7 IL 7	4 5	0	0	4 0	20	32009	217+10.5	43.6	RT		6	6	0	0	+ 20
- 1400	213+35.2	69.6		IL 7	4	0	0	4	20	02003	217 - 10.0	0.0			U U		U U		

USER NAME = mmæestræ	DESIGNED TPD	REVISED -			SCHEDULE OF QUANTITIES	F.A.P. RI	E. SECTION	COUNTY	TOTAL SHEET SHEETS NO.
	DRAWN TPD	REVISED -	STATE OF ILLINOIS		TREE SCHEDULE	351	536-R-1	WILL	1232 101
PLOT SCALE = 1:20.0001	CHECKED PJO	REVISED -	DEPARTMENT OF TRANSPORTATION					CONTRAC	T NO. 60L71
PLOT DATE = 8/15/2014	DATE 8/15/2014	REVISED -		SCALE: NONE	SHEET NO. OF SHEETS STA. TO STA		ILLINOIS	ED. AID PROJECT	

# COST INCLUDED IN EARTHWORK, SEE STANDARD SPECIFICATIONS OF ROADWAY AND BRIDGE CONSTRUCTION SECTION 201

				TRE	E REMOV	AL AND PROTECTIO	ON							TRE	E REMOV	AL AND PROTECTIO	ON		
TREE IUMBER	STA	OFFSET	LT/RT	STREET	SIZE	TREE REMOVAL (6 TO 15 UNITS DIAMETER)	TREE REMOVAL (OVER 15 UNITS DIAMETER)	*TREE REMOVAL (UNDER 6 UNITS DIAMETER)	TEMPORARY FENCE	TREE NUMBER	STA	OFFSET	LT/RT	STREET	SIZE	TREE REMOVAL (6 TO 15 UNITS DIAMETER)	TREE REMOVAL (OVER 15 UNITS DIAMETER)	*TREE REMOVAL (UNDER 6 UNITS DIAMETER)	TEMPORA FENCE
					INCH	UNIT	UNIT	UNIT	FOOT						INCH	UNIT	UNIT	UNIT	FOOT
32012	217+48.6	124.7	RT	IL 7	4	0	0	0	20	21517	227+61.0	74.8	RT	IL 7	15	15	0	0	1
21540	217+48.7	144.7	RT	IL 7	4	0	0	0	20	21518	227+92.3	64.2	RT	IL 7	12	12	0	0	
32011	217+49.3	71.8	RT	IL 7	4	0	0	0	20	21519	227+92.3	64.2	RT	IL 7	12	12	0	0	1
32010	217+49.4	59.4	RT	IL 7	6	6	0	0		1586	228+44.2	61.5	RT	IL 7	6	6	0	0	
1589	217+83.3	62.7	LT	IL 7	6	6	0	0		21601	230+54.1	73.6	RT	IL 7	8	0	0	0	20
1590	217+85.2	75.3	LT	IL 7	6	6	0	0		1603	231+04.1	57.7	RT	IL 7	48	0	48	0	
1591	217+94.6	70.0	LT	IL 7	6	6	0	0		1606	231+63.4	100.7	RT	IL 7	12	0	0	0	20
1592	217+94.6	70.0	LT	IL 7	6	6	0	0		21631	232+10.5	130.2	RT	IL 7	9	0	0	0	20
1556	218+12.9	61.5	RT	IL 7	12	12	0	0		21615	232+17.1	91.6	LT	IL 7	?	0	0	0	20
1557	218+34.9	57.6	RT	IL 7	10	10	0	0		1610	235+89.5	49.9	RT	IL 7	12	12	0	0	
1593	218+59.8	62.9	LT	IL 7	8	8	0	0		1611	235+99.3	53.7	RT	IL 7	7	7	0	0	
1594	218+75.5	60.0	LT	IL 7	8	8	0	0		1612	236+03.2	54.9	RT	IL 7	7	7	0	0	
1558	218+95.2	58.6	RT	IL 7	8	8	0	0		21634	237+00.8	106.6	LT	IL 7	?	0	0	0	20
1595	219+05.3	57.1	LT	IL 7	12	12	0	0		21632	237+01.5	71.7	LT	IL 7	2	0	0	0	20
1559	219+15.8	60.7	RT	IL 7	10	10	0	0		21633	237+01.7	87.6	LT	IL 7	?	0	0	0	20
1560	219+56.5	50.7	RT	IL 7	42	0	42	0		21619	237+36.1	105.8	LT	IL 7	?	0	0	0	20
1596	219+70.0	58.5	LT	IL 7	10	10	0	0		21618	237+36.4	88.1	LT	IL 7	?	0	0	0	20
1561	219+72.5	36.9	RT	IL 7	7	7	0	0		21617	238+36.2	70.9	LT	IL 7	3	0	0	0	20
21529	219+74.6	67.5	LT	IL 7	6	0	0	0	20	21635	238+45.5	109.2	LT	IL 7	?	0	0	0	20
1562	219+77.7	38.5	RT	IL 7	8	8	0	0		21611	239+34.6	68.7	RT	IL 7	12	0	0	0	20
1563	219+77.7	38.5	RT	IL 7	8	8	0	0		21620	240+04.1	127.4	LT	IL 7	?	0	0	0	20
1564	219+89.3	64.6	RT	IL 7	12	12	0	0		21621	240+06.1	104.2	LT	IL 7	?	0	0	0	20
1565	220+01.5	52.5	RT	IL 7	6	6	0	0		21612	240+15.5	68.9	RT	IL 7	6	0	0	0	20
1566	220+05.5	54.6	RT	IL 7	6	6	0	0		1628	242+14.5	64.3	LT	IL 7	18	0	18	0	
1567	220+10.5	63.4	RT	IL 7	6	6	0	0		1629	243+32.7	62.9	LT	IL 7	14	14	0	0	
1568	220+21.8	55.4	RT	IL 7	8	8	0	0		1632	244+11.1	60.1	LT	IL 7	6	6	0	0	
1569	220+43.4	63.4	RT	IL 7	10	10	0	0		1634	244+13.3	61.1	LT	IL 7	52	0	52	0	
1597	220+58.7	51.3	LT	IL 7	6	6	0	0		1635	244+15.5	60.8	LT	IL 7	15	15	0	0	
1598	220+63.1	52.8	LT	IL 7	6	6	0	0		1636	244+47.1	60.0	LT	IL 7	30	0	30	0	
1599	220+72.7	53.3	LT	IL 7	20	0	20	0		1637	244+90.8	63.1	LT	IL 7	42	0	42	0	
1600	220+85.5	55.1	LT	IL 7	10	10	0	0		1639	245+37.6	56.8	LT	IL 7	12	12	0	0	
1601	221+00.4	57.2	LT	IL 7	10	10	0	0		1640	245+54.4	57.9	LT	IL 7	6	6	0	0	
1571	221+14.6	59.4	RT	IL 7	6	6	0	0		1641	245+74.6	68.5	LT	IL 7	6	6	0	0	
1570	221+15.2	55.6	RT	IL 7	6	6	0	0		21627	245+85.0	73.5	LT	IL 7	12	12	0	0	
1572	221+24.0	57.2	RT	IL 7	6	6	0	0		1642	246+06.0	68.4	LT	IL 7	12	12	0	0	
1602	221+29.8	63.5	LT	IL 7	6	6	0	0		1672	246+08.7	63.1	LT	IL 7	7	7	0	0	
1573	221+34.6	57.4	RT	IL 7	6	6	0	0		1673	246+10.2	63.8	LT	IL 7	10	10	0	0	
574	221+83.4	53.8	RT	IL 7	14	14	0	0		1643	246+10.5	52.8	RT	IL 7	12	12	0	0	
1575	221+83.4	53.3	RT	IL 7	14	14	0	0		1644	246+10.5	52.8	RT	IL 7	15	15	0	0	1
1576	222+46.0	51.0	RT	IL 7	7	7	0	0		1645	246+10.5	52.8	RT	IL 7	15	15	0	0	1
1577	222+46.0	51.0	RT	IL 7	7	7	0	0		1646	246+10.5	52.8	RT	IL 7	15	15	0	0	1
1578	222+76.7	50.2	RT	IL 7	12	12	0	0		1647	246+12.7	52.8	RT	IL 7	15	15	0	0	1
1504	223+27.3	84.2	RT	IL 7	?	0	0	0	20	21701	246+12.7	64.2	RT	IL 7	8	8	0	0	
1580	223+27.9	52.7	RT	IL 7	12	12	0	0		21702	246+12.7	64.2	RT	IL 7	16	0	16	0	1
1505	223+57.7	112.7	RT	IL 7	?	0	0	0	20	21703	246+22.5	64.2	RT	IL 7	16	0	16	0	1
1506	224+54.3		RT	IL 7	10	10	0	0		21711	246+26.1	72.1	LT	IL 7	10	10	0	0	1
1508	224+56.0	66.6	RT	IL 7	8	8	0	0		1674	246+39.4	63.8	LT	IL 7	7	7	0	0	1
1507	224+57.4		RT	IL 7	10	10	0	0		1675	246+55.9	62.2	LT	IL 7	7	7	0	0	+
1530	224+99.8	55.5	LT	IL 7	8	8	0	0		1676	246+57.2	55.1	LT	IL 7	7	7	0	0	+
1531	225+00.5	56.0	LT	IL 7	8	8	0	0		1677	246+75.3	55.8	LT	IL 7	9	9	0	0	+
21516	227+37.1	69.9	RT		20	0	20	0		1679	246+96.3	69.0	LT	IL 7	6	6	0	0	+
		30.0		· · · ·		1 Ž		L Ÿ		1673	247+19.2	69.0	LT	IL 7	6	6	0	0	+

USER NAME = mmaestra	DESIGNED '	TPD	REVISED -				CHEDUL		ANTITIES		F.A.P. RTE.	SECTION	COUNTY	TOTAL SHEET SHEETS NO.
	DRAWN	TPD	REVISED -	 STATE OF ILLINUIS				E SCHED			351	536-R-1	WILL	1232 102
PLOT SCALE = 1:20.0001	CHECKED F	PJO	REVISED -	DEPARTMENT OF TRANSPORTATION									CONTRACT	NO. 60L71
PLOT DATE = 8/15/2014	DATE 8	8/15/2014	REVISED -		SCALE: NONE	SHEET NO.	OF	SHEETS	STA.	TO STA.		ILLINOIS FED. A	D PROJECT	

# COST INCLUDED IN EARTHWORK, SEE STANDARD SPECIFICATIONS OF ROADWAY AND BRIDGE CONSTRUCTION SECTION 201


				TRE	E REMOV	AL AND PROTECTIO	ON							TRE	E REMOV	AL AND PROTECTI	ON		
TREE IUMBER	STA	OFFSET	LT/RT	STREET	SIZE	TREE REMOVAL (6 TO 15 UNITS DIAMETER)	TREE REMOVAL (OVER 15 UNITS DIAMETER)	*TREE REMOVAL (UNDER 6 UNITS DIAMETER)	TEMPORARY FENCE	TREE NUMBER	STA	OFFSET	LT/RT	STREET	SIZE	TREE REMOVAL (6 TO 15 UNITS DIAMETER)	TREE REMOVAL (OVER 15 UNITS DIAMETER)	*TREE REMOVAL (UNDER 6 UNITS DIAMETER)	TEMPORA FENCE
					INCH	UNIT	UNIT	UNIT	FOOT						INCH	UNIT	UNIT	UNIT	FOOT
1682	247+30.2	69.7	LT	IL 7	7	7	0	0		21808	270+97.0	73.0	RT	IL 7	?	0	0	0	20
1648	247+30.2	56.1	RT	IL 7	15	15	0	0		21809	270+97.6	74.0	RT	IL 7	?	0	0	0	20
1649	247+30.2	56.1	RT	IL 7	15	15	0	0		21810	271+05.0	73.0	RT	IL 7	?	0	0	0	20
1650	247+42.5	56.1	RT	IL 7	15	15	0	0		21811	271+18.0	75.4	RT	IL 7	6	0	0	0	20
1684	247+43.3	61.9	LT	IL 7	6	6	0	0		21812	271+45.9	73.9	RT	IL 7	14	0	0	0	20
1683	247+49.9	71.1	LT	IL 7	6	6	0	0		21820	271+45.9	60.5	RT	IL 7	4	0	0	4	
1686	247+53.3	64.4		IL 7	9	9	0	0		21821	271+45.9	60.5	RT	IL 7	4	0	0	4	<u> </u>
1685	247+93.7	72.1		IL 7	9	9	0	0		21822	271+57.8	60.5	RT	L 7	4	0	0	4	
21712 1687	248+04.2	72.9		IL 7 IL 7	7 20	7 0	20	0		21813 21824	272+07.3	80.6 107.5	RT RT	IL 7 IL 7	14 4	0	0	0	20
1688	248+22.5 248+23.0	54.0 71.4	LT LT	IL 7	6	6	20	0		21824	272+24.3 272+60.3	82.7	RT	L 7	15	0	0	0	20
21714	248+25.0	73.9	LT	IL 7	12	12	0	0		1727	272+00.3	50.1	RT	L 7	8	8	0	0	- 20
21714	248+20.1	73.4	LT	IL 7	6	6	0	0		1727	277+93.3	51.7	RT	IL 7	12	12	0	0	+
1689	248+83.6	71.6	LT	IL 7	15	15	0	0		1728	277+94.7	50.7	RT	IL 7	12	12	0	0	
1690	249+26.1	60.6	LT	IL 7	8	8	0	0		1725	277+99.6	59.5			18	0	18	0	
1691	249+27.6	66.5	LT		6	6	0	0		1730	278+04.5	53.8	RT		15	15	0	0	+
1692	249+42.8	71.2	LT	IL 7	12	12	0	0		1766	278+15.3	70.5	LT		10	10	0	0	
1693	249+70.6	71.9	LT	IL 7	10	10	0	0		1767	278+23.6	72.5	LT		15	15	0	0	
1652	249+92.1	53.3	RT	IL 7	24	0	24	0		1731	278+23.6	54.3	RT	IL 7	8	8	0	0	-
1653	250+10.8	53.2	RT	IL 7	15	15	0	0		1732	278+23.6	54.3	RT	IL 7	8	8	0	0	-
1654	250+13.5	53.6	RT	IL 7	15	15	0	0		1733	278+26.1	54.3	RT	IL 7	12	12	0	0	-
1704	250+31.8	63.6	RT	IL 7	12	0	0	0	20	1768	278+27.4	61.8	LT	IL 7	8	8	0	0	-
1655	250+42.7	54.1	RT	IL 7	32	0	32	0		1769	278+27.9	50.3	LT	IL 7	12	12	0	0	+
1656	251+34.9	54.7	RT	IL 7	32	0	32	0		1734	278+31.9	48.4	RT	IL 7	12	12	0	0	1
21706	251+35.0	67.5	RT	IL 7	10	10	0	0		1770	278+41.9	50.3	LT	IL 7	12	12	0	0	1
21705	251+40.2	66.0	RT	IL 7	10	10	0	0		1771	278+47.6	69.5	LT	IL 7	28	0	28	0	
1659	253+29.1	55.5	RT	IL 7	30	0	30	0		1772	278+53.4	48.5	LT	IL 7	7	7	0	0	
21707	253+51.8	66.5	RT	IL 7	28	0	28	0		1774	278+67.6	70.9	LT	IL 7	24	0	24	0	
1694	254+21.4	72.0	LT	IL 7	7	7	0	0		21902	278+81.3	76.0	LT	IL 7	7	7	0	0	
1701	256+28.6	68.6	LT	IL 7	12	12	0	0		1738	278+82.5	54.8	RT	IL 7	15	15	0	0	
1666	257+95.5	58.9	RT	IL 7	12	12	0	0		21903	278+82.5	66.4	LT	IL 7	7	7	0	0	
1667	258+38.2	56.9	RT	IL 7	24	0	24	0		21904	278+86.7	76.3	LT	IL 7	14	14	0	0	
1668	258+58.2	58.5	RT	IL 7	14	14	0	0		21905	278+89.8	50.1	LT	IL 7	10	10	0	0	
1669	258+77.3	58.6	RT	IL 7	14	14	0	0		21900	278+97.1	68.9	LT	IL 7	8	8	0	0	
1670	258+96.7	57.7	RT	IL 7	18	0	18	0		21906	279+07.2	49.0	LT	IL 7	14	14	0	0	
1671	259+65.6	57.6	RT	IL 7	15	15	0	0		21907	279+15.9	69.1	LT	IL 7	20	0	20	0	
1708	260+11.5	95.8	RT	IL 7	3	0	0	0	20	1744	279+16.1	54.1	RT	IL 7	12	12	0	0	
1709	260+68.5		RT	IL 7	2	0	0	0	20	21908	279+19.7	51.1	LT	IL 7	14	14	0	0	
1823	267+55.9		RT	IL 7	6	0	0	0	20	21909	279+33.0	64.9	LT	IL 7	6	6	0	0	
702	270+22.2	57.3	RT	IL 7	12	12	0	0		1747	279+35.7	54.4	RT	IL 7	7	7	0	0	
1703	270+34.3	57.4	RT	IL 7	12	12	0	0		1748	279+36.6	54.4	RT	IL 7	7	7	0	0	
1704	270+34.3		RT	IL 7	6	6	0	0			279+36.6	67.8	LT	IL 7	8	8	0	0	
705	270+34.3	51.6	RT	IL 7	6	6	0	0		1749	279+45.5	53.9	RT	IL 7	12	12	0	0	
706	270+34.3		RT	IL 7	6	6	0	0		21912	279+45.9	64.3		IL 7	12	12	0	0	
707	270+34.3	51.6	RT	IL 7	6	6	0	0			279+53.6	53.2	RT	IL 7	10	10	0	0	
1708	270+34.3		RT	IL 7	6	6	0	0			279+54.6	53.2	RT	IL 7	15	15	0	0	
709	270+34.3		RT	IL 7	6	6	0	0			279+56.9	52.4		L7	14	14	0	0	+
1710	270+34.3		RT	IL 7	6	6	0	0		21913	279+59.9	65.7		IL 7	12	12	0	0	
1711	270+70.3	51.6	RT	IL 7	6	6	0	0		1752	279+72.9	52.4	RT	L 7	12	12	0	0	+
1806	270+71.4	70.8	RT	IL 7	?	0	0	0	20	21914	279+77.4	67.3			14	14	0	0	+
21807	270+77.3	71.8	RT	IL 7	?	0	0	0	20	21915	279+99.1	76.1		IL 7	36	0	36	0	
712	270+78.7	58.9	RT	IL 7	12	12	0	0		21916	280+13.1	50.4	LT	IL 7	12	12	0	0	

USER NAME = mmaestra	DESIGNED TPD	REVISED -			COULDI				F.A.P. RTE.	SECTION	COUNTY	TOTAL SHEET
	DRAWN TPD	REVISED -	STATE OF ILLINOIS			EE SCHEI	JANTITIES		351	536-R-1	WILL	1232 103
PLOT SCALE = 1:20.0001	CHECKED PJO	REVISED -	DEPARTMENT OF TRANSPORTATION		In	LL JUNLL	JOLL				CONTRA	CT NO. 60L71
PLOT DATE = 8/15/2014	DATE 8/15/2014	REVISED -		SCALE: NONE	SHEET NO. OF	SHEETS	STA.	TO STA.		ILLINOIS FE	AID PROJECT	


# COST INCLUDED IN EARTHWORK, SEE STANDARD SPECIFICATIONS OF ROADWAY AND BRIDGE CONSTRUCTION SECTION 201


				TRE	EREMOV	AL AND PROTECTIO	ЛС	1	
TREE NUMBER	STA	OFFSET	LT/RT	STREET	SIZE	TREE REMOVAL (6 TO 15 UNITS DIAMETER)	TREE REMOVAL (OVER 15 UNITS DIAMETER)	*TREE REMOVAL (UNDER 6 UNITS DIAMETER)	TEMPORA FENCE
					INCH	UNIT	UNIT	UNIT	FOOT
21918	280+24.9	66.4	LT	IL 7	12	12	0	0	
21919	280+28.2	50.1	LT	IL 7	12	12	0	0	
1756	280+28.3	53.5	RT	IL 7	12	12	0	0	
21920	280+35.7	65.0	LT	IL 7	6	6	0	0	
1757	280+40.8	52.5	RT	IL 7	10	10	0	0	
21921	280+51.3	52.5	LT	IL 7	8	8	0	0	
21922	280+51.4	52.7	LT	IL 7	12	12	0	0	
21923	280+53.9	54.1	LT	IL 7	12	12	0	0	
21924	280+60.7	56.5	LT	IL 7	8	8	0	0	
21925	280+61.4	56.4	LT	IL 7	8	8	0	0	
21926	280+65.8	62.5	LT	IL 7	12	12	0	0	
21927	280+79.3	62.6	LT	IL 7	6	6	0	0	
21928	280+81.8	49.5	LT	IL 7	12	12	0	0	
21929	280+87.9	51.8	LT	IL 7	16	0	16	0	
21930	280+89.5	66.6	LT	IL 7	15	15	0	0	
21931	994+90.4	52.6	LT	IL 7	10	10	0	0	
2612	996+79.0	95.7	LT	CEDAR	24	0	0	0	20
2610	996+79.3	71.4	LT	CEDAR	18	0	0	0	20
2611	997+32.9	71.6	LT	CEDAR	14	0	0	0	20
2609	997+61.0	45.6	LT	CEDAR	18	0	0	0	20
2615	997+68.3	60.8	LT	CEDAR	?	0	0	0	20
2616	1009+54.8	78.9	LT	CEDAR	?	0	0	0	20
22101	1009+70.1	44.5	LT	CEDAR	10	0	0	0	20
22102	1009+85.2	44.2	LT	CEDAR	10	0	0	0	20
22103	1010+00.0	44.6	LT	CEDAR	10	0	0	0	20
22104	1010+14.4	44.7	LT	CEDAR	10	0	0	0	20
22105	1010+30.1	44.9	LT	CEDAR	10	0	0	0	20
22106	1010+45.1	44.5	LT	CEDAR	10	0	0	0	20
22107	1010+60.5	44.5	LT	CEDAR	10	0	0	0	20
22108	1010+75.8	44.7	LT	CEDAR	10	0	0	0	20
22109	1010+90.6	44.8	LT	CEDAR	10	0	0	0	20
22110	1011+05.8	44.8	LT	CEDAR	10	0	0	0	20
22111	1011+21.1	44.5	LT	CEDAR	10	0	0	0	20
22112	1011+35.6	44.5	LT	CEDAR	10	0	0	0	20
22113	1011+50.4	44.5	LT	CEDAR	10	0	0	0	20
22114	1011+65.5	44.3	LT	CEDAR	10	0	0	0	20
22115	1497+11.5	44.5	LT	CEDAR	10	0	0	0	20
21114	1497+57.1	26.8	RT	PARKER	?	0	0	0	20
21115	2002+02.4	26.8	RT	PARKER	?	0	0	0	20
22306	2002+71.7	53.5	LT	N BELL	14	0	0	0	20
22307	2003+87.4	40.7	LT	N BELL	6	0	0	0	20
22301	2006+92.0	52.7	RT	N BELL	?	0	0	0	20
32004	2994+69.5	42.3	LT	WILL-COOK	10	0	0	0	20
32003	2995+05.5	41.8	LT	WILL-COOK	12	0	0	0	20
32002	2995+10.7	37.4	LT	WILL-COOK	10	0	0	0	20
32001	2995+58.6	37.4	LT	WILL-COOK	12	0	0	0	20
22400	2996+59.4	46.1	LT	WILL-COOK	12	0	0	0	20
32005	2994+69.5	41.7	LT	WILL-COOK	8	0	0	0	20
					TOTALS	3542	1588	632	2860


USER NAME = mmæestræ	DESIGNED TPD	REVISED -			SCHEDULE OF QUANTITIES		F.A.P. RTE.	SECTION	COUNTY TOTAL SHEETS	HEET NO.
	DRAWN TPD	REVISED -	STATE OF ILLINOIS		TREE SCHEDULE		351	536-R-1	WILL 1232	104
PLOT SCALE = 1:20.0001	CHECKED PJO	REVISED -	DEPARTMENT OF TRANSPORTATION						CONTRACT NO. 60L	L71
PLOT DATE = 8/15/2014	DATE 8/15/2014	REVISED -		SCALE: NONE	SHEET NO. OF SHEETS STA.	TO STA.		ILLINOIS FED.	AID PROJECT	

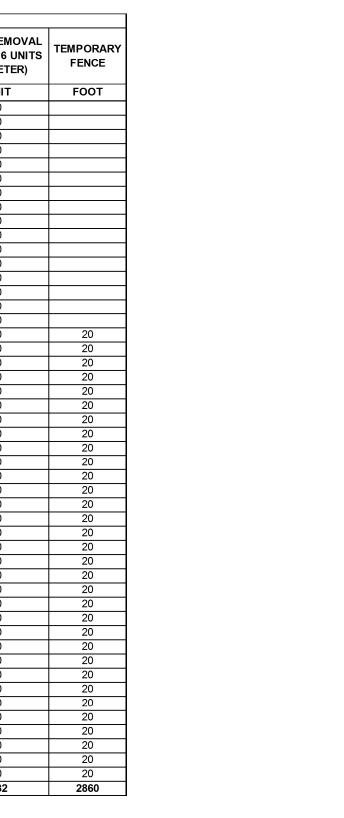



# \* COST INCLUDED IN EARTHWORK, SEE STANDARD SPECIFICATIONS OF ROADWAY AND BRIDGE CONSTRUCTION SECTION 201

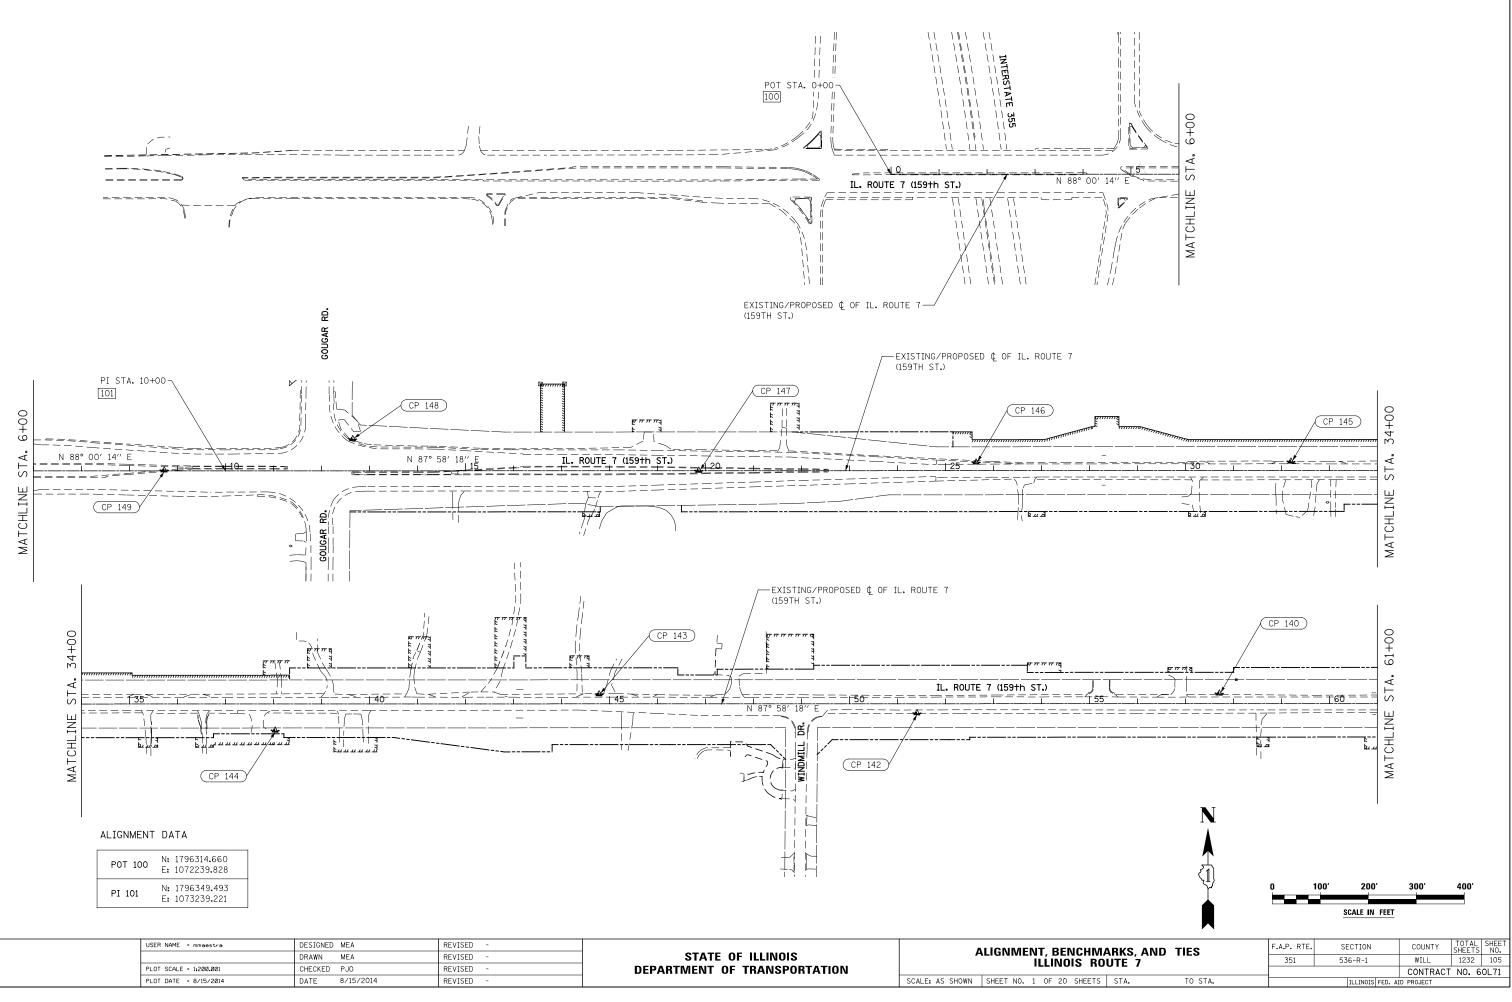

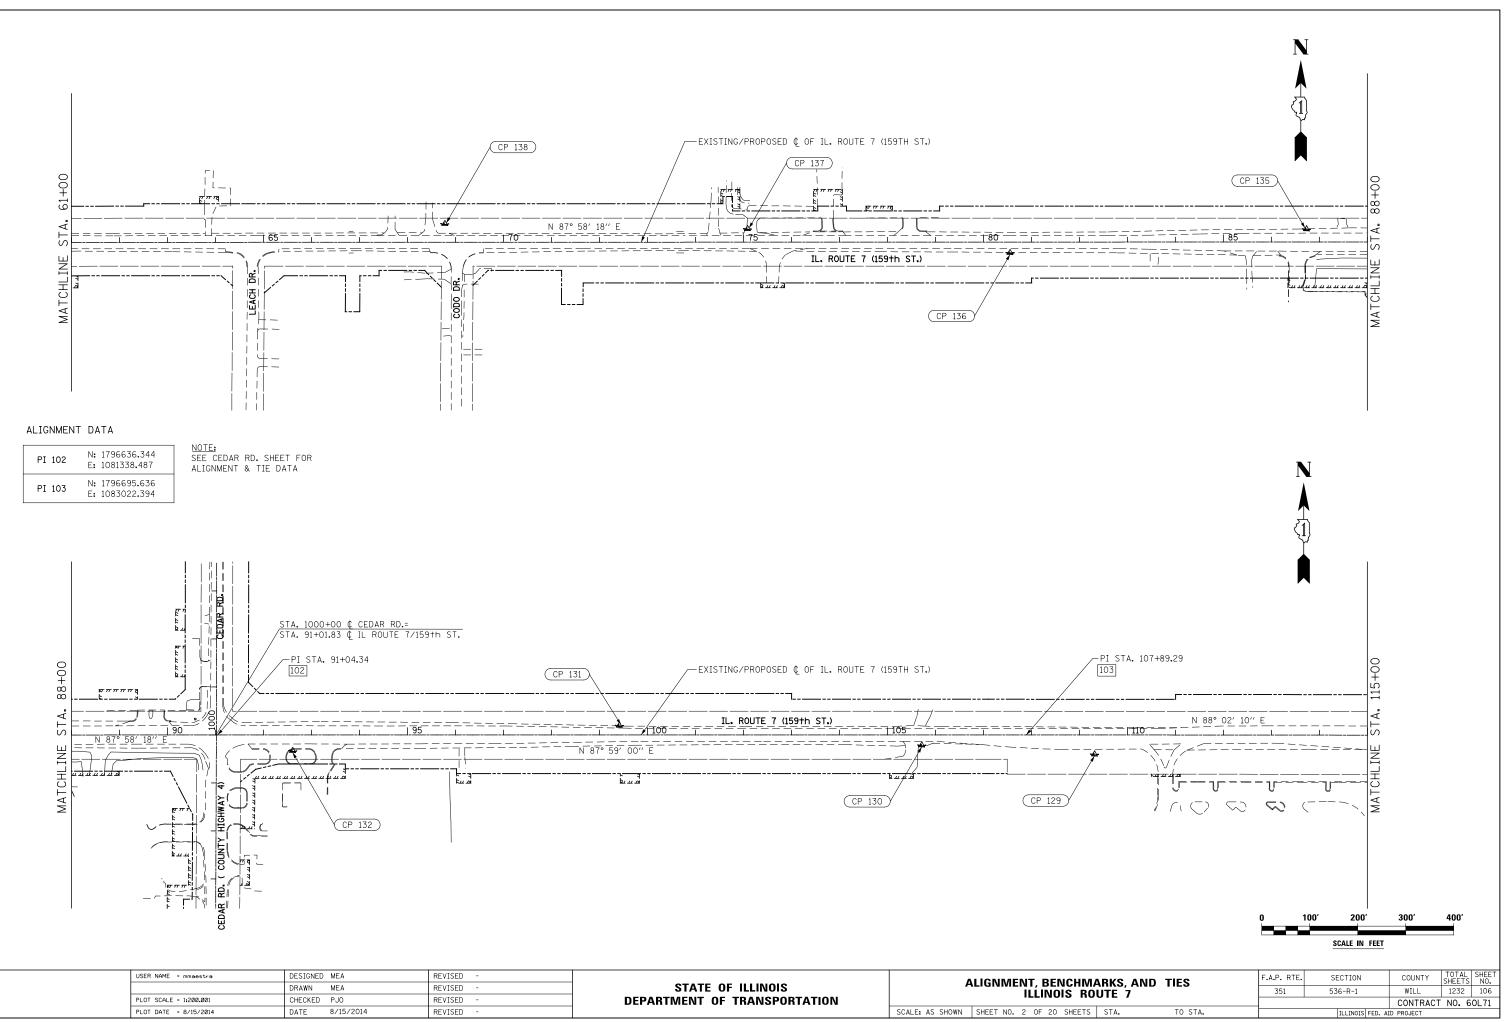

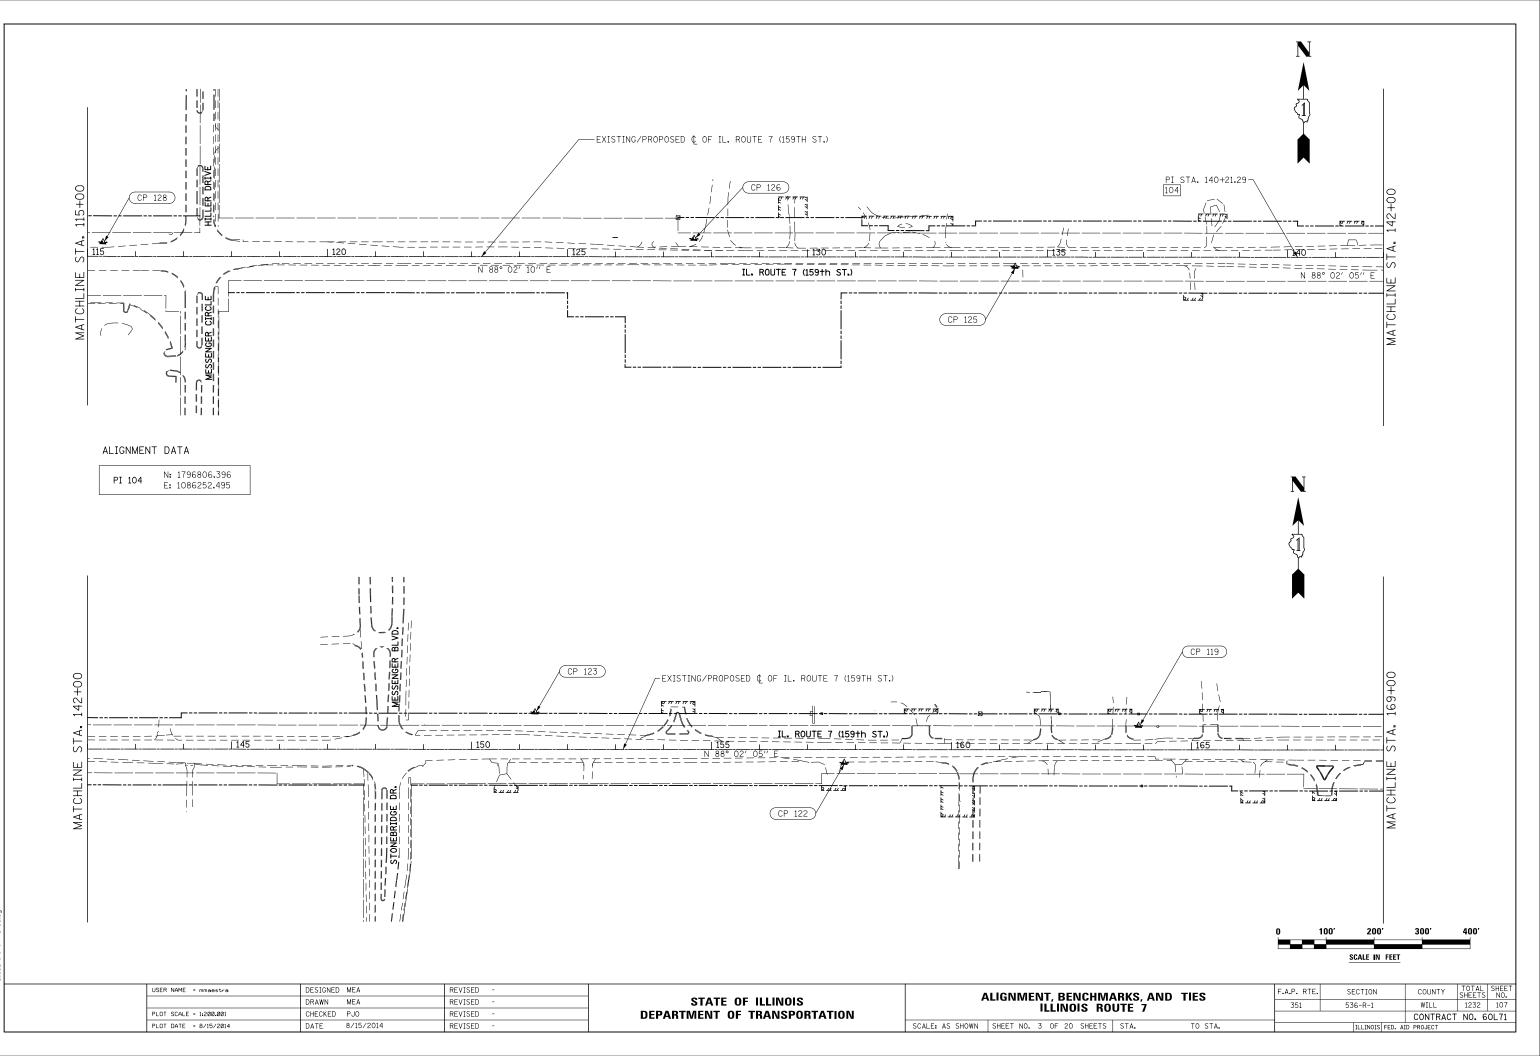


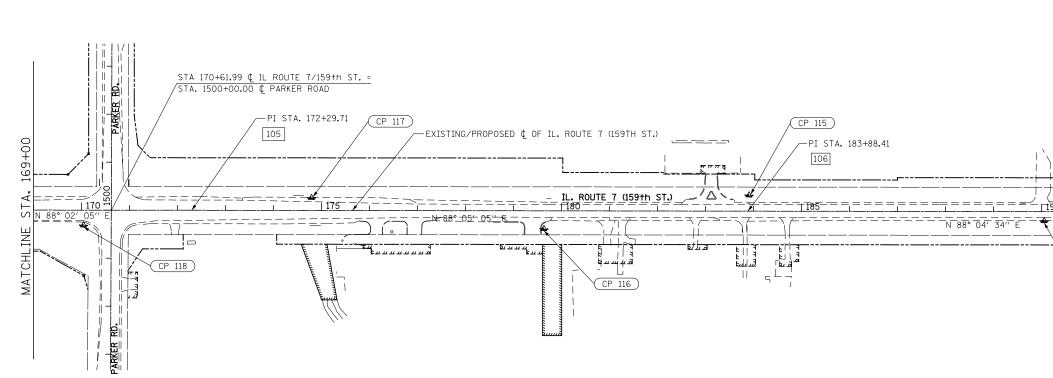


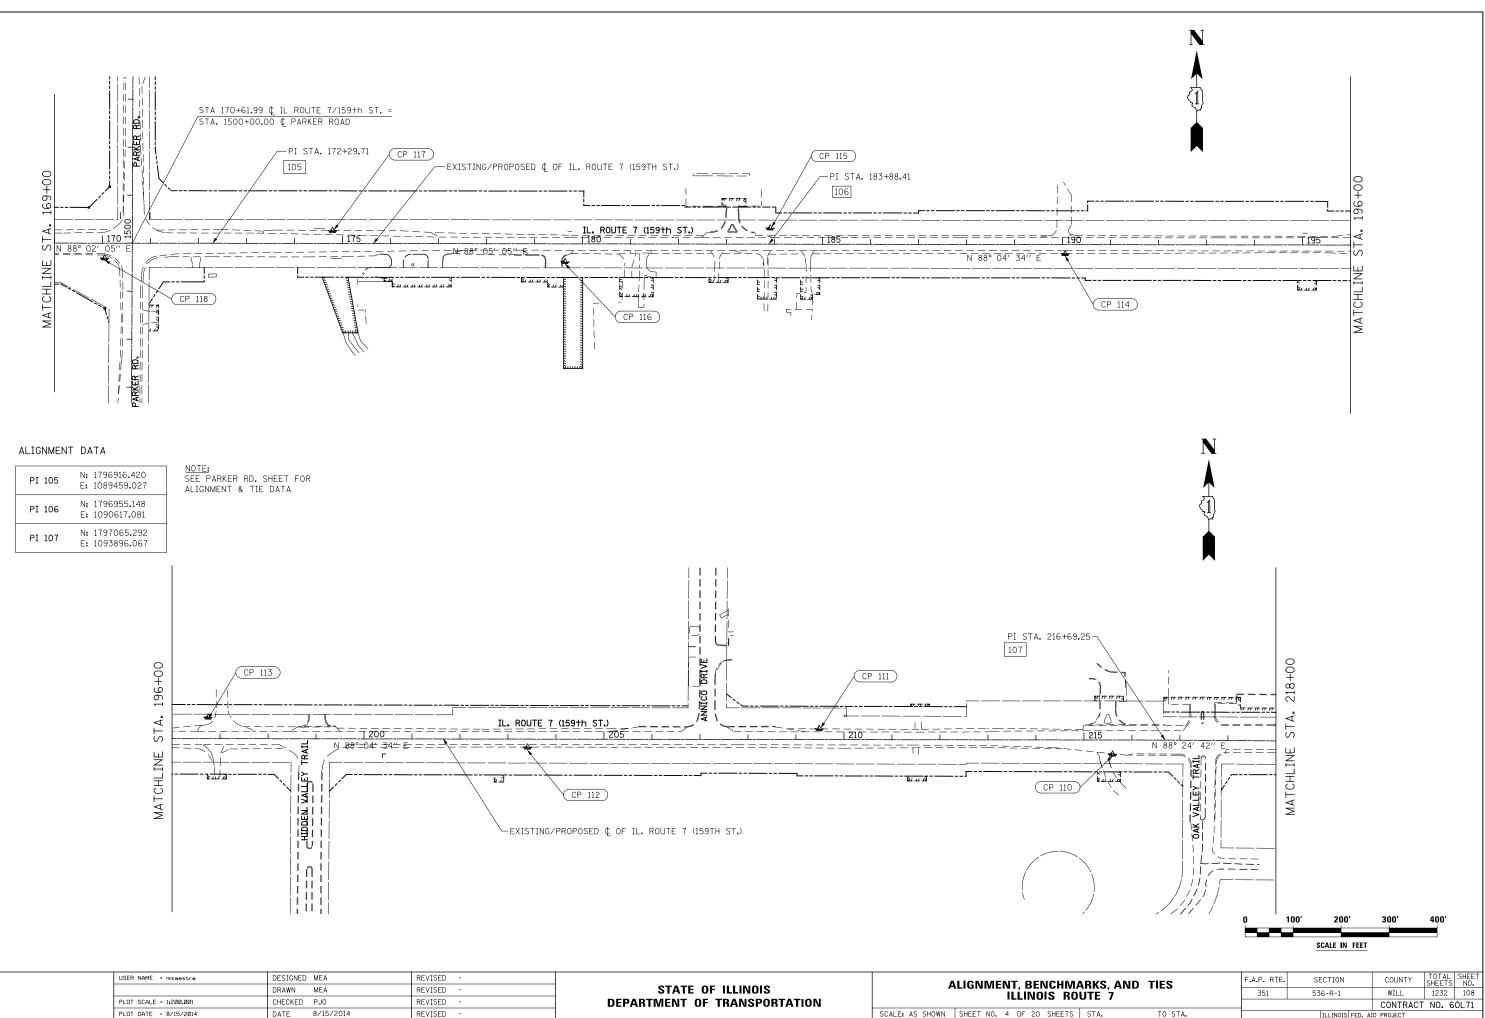

SCALE: AS SHOWN SHEET NO. 4 OF 20 SHEETS STA.

TO STA. ILLINOIS FED. AID PROJECT

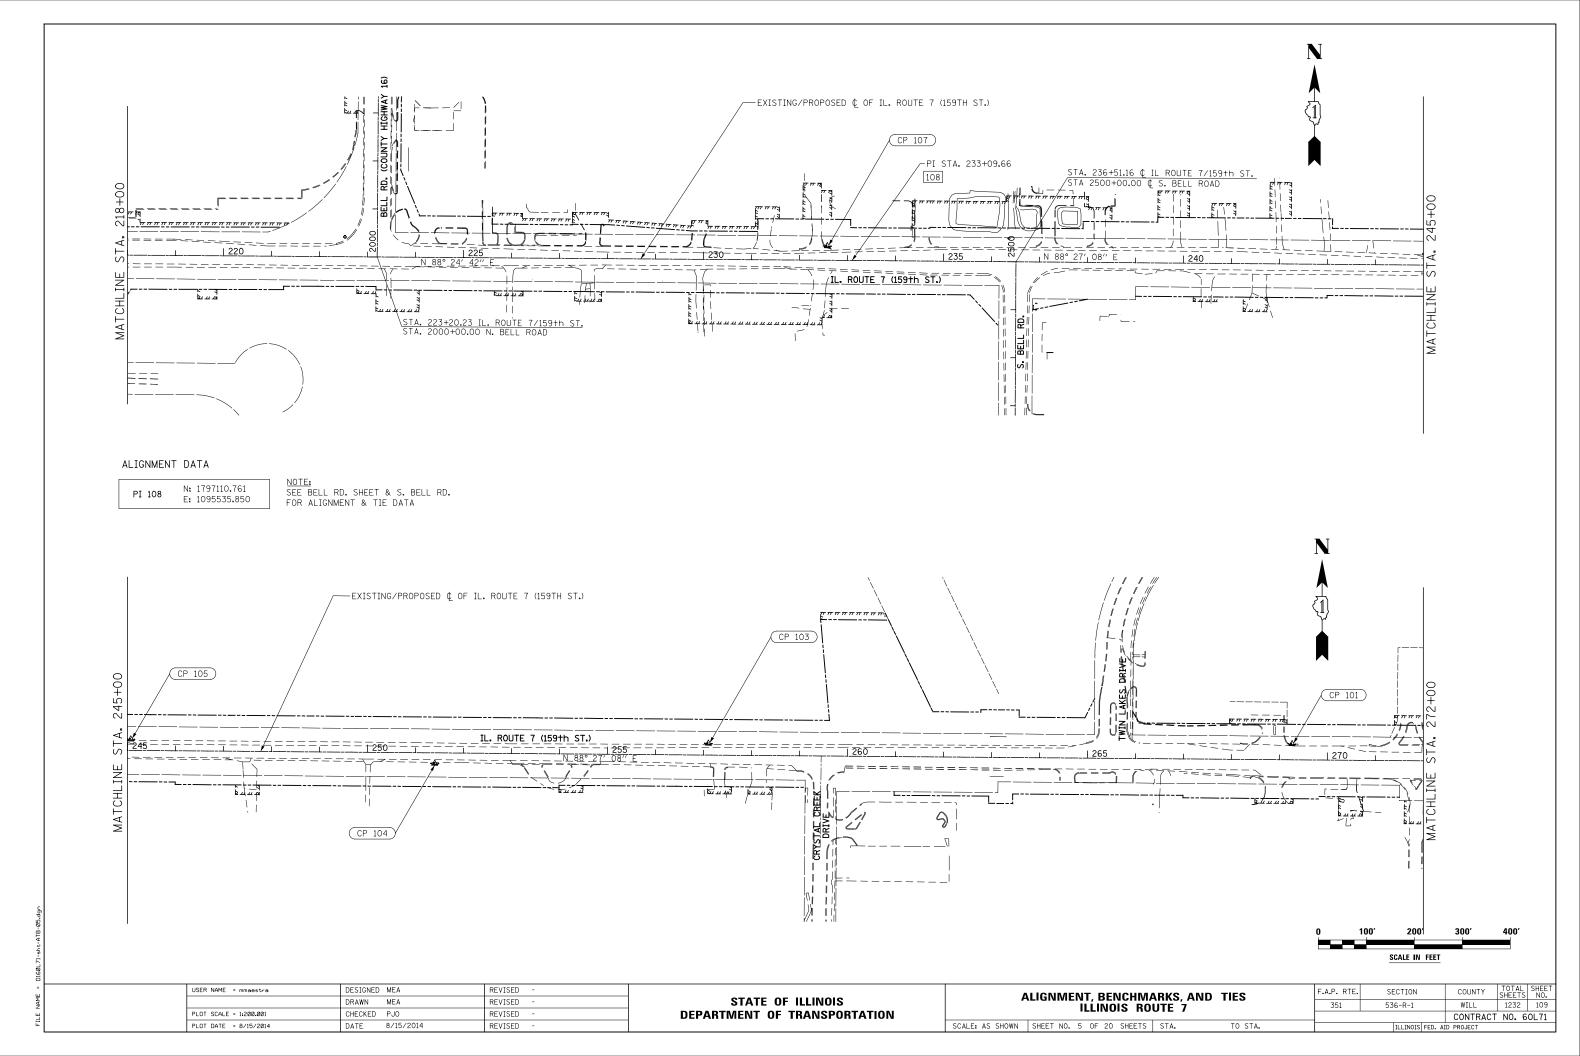

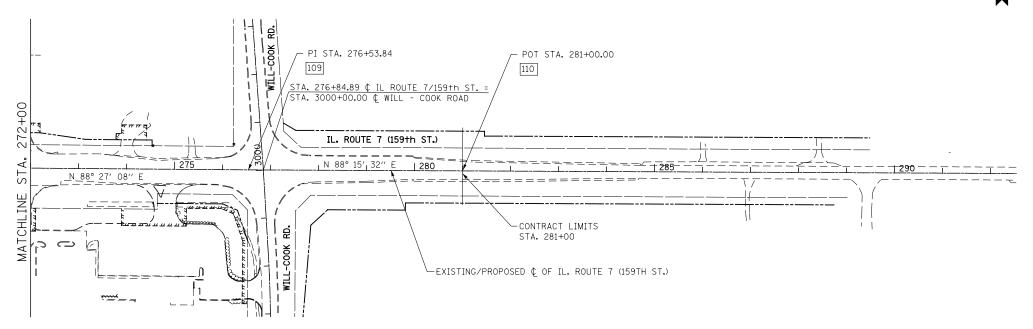

# ALIGNMENT DATA


PI 109	N: 1797228.090 E: 1099878.446
POT 110	N: 1797241.646 E: 1100324.396

<u>NOTE:</u> SEE WILL-COOK RD. SHEET FOR ALIGNMENT & TIE DATA


USER NAME = mmoestro DESIGNED MEA REVISED -		
	BENCHMA	
PLOT SCALE = 1/200.001 CHECKED PJO REVISED - DEPARTMENT OF TRANSPORTATION	INOIS ROL	
PLOT DATE = 10/20/2014 DATE 10/21/2014 REVISED - SCALE: AS SHOWN SHEET NO. 6 C	OF 20 SHEETS	ST

		0 1	00' 200'	300′	400′
			SCALE IN FEE	<u></u>	
ARKS, AND	тісе	F.A.P. RTE.	SECTION	COUNTY	TOTAL SHEE SHEETS NO.
DUTE 7	IILS	351	536-R-1	WILL	1232 110
				CONTRAC	T NO. 60L71
STA.	TO STA.		ILLINOIS FED.	AID PROJECT	



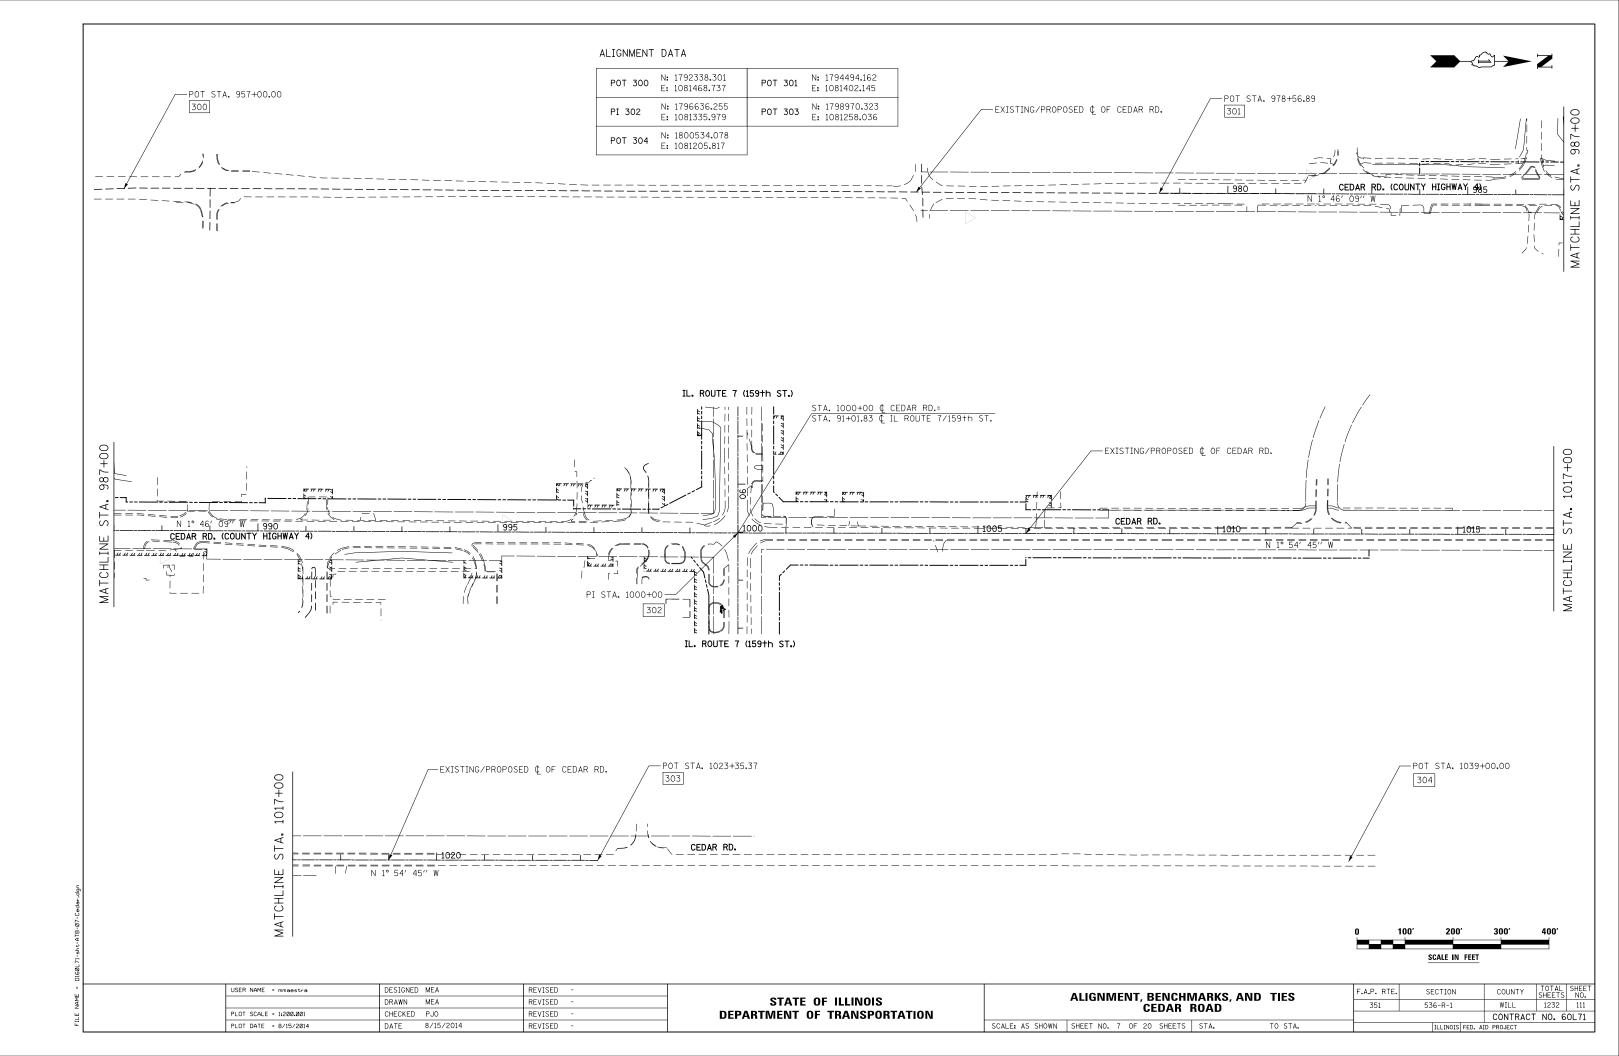




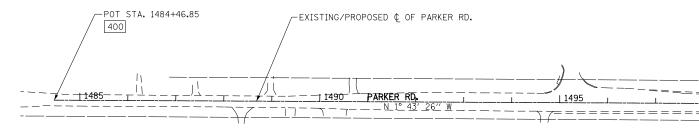



# ALIGNMENT DATA

POT 400	N: 1795358.225 E: 1089338.124
PI 401	N: 1796910.668 E: 1089291.400
POT 402	N: 1798564.028 E: 1089239.932

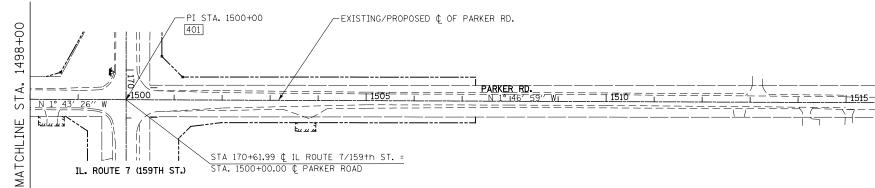


USER NAME = mmaestra	DESIGNED MEA	REVISED -			ALIGNMENT, BENCHMAR
	DRAWN MEA	REVISED -	STATE OF ILLINOIS		···· ·····
PLOT SCALE = 1:200.001	CHECKED PJO	REVISED -	DEPARTMENT OF TRANSPORTATION		PARKER RO
PLOT DATE = 8/15/2014	DATE 8/15/2014	REVISED -		SCALE: AS SHOWN	SHEET NO. 8 OF 20 SHEETS ST

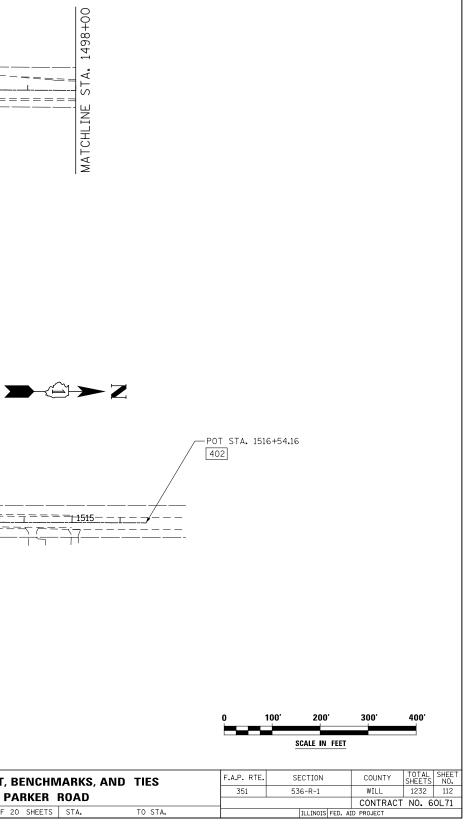

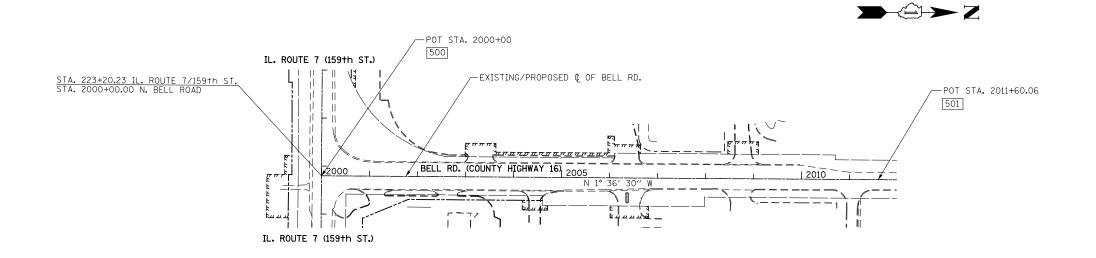


# ALIGNMENT DATA

POT	500	N: 1797083.336 E: 1094546.800
POT	501	N: 1798242.943 E: 1094514.242
POT	600	N: 1796720.162 E: 1095889.145
POT	601	N: 1797119.984 E: 1095877.227

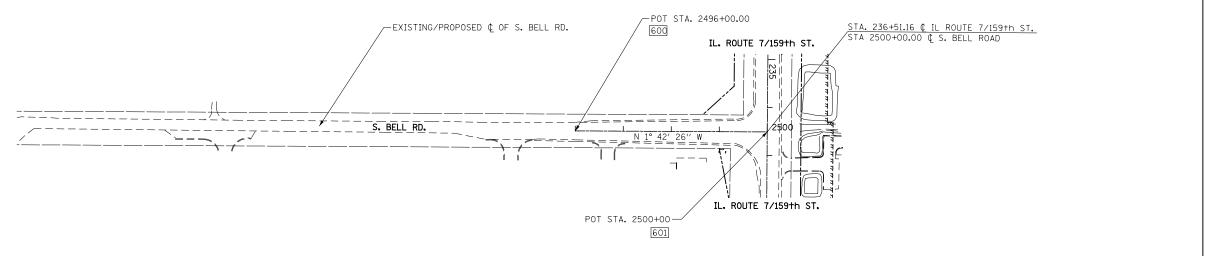


					0 10	D' 200'	300' ET	400'
USER NAME = mmaestra	DESIGNED MEA	REVISED -		ALIGNMENT, BENCHMARKS, AND TIES	F.A.P. RTE.	SECTION	COUNTY	TOTAL SHEET
	DRAWN MEA	REVISED -	STATE OF ILLINOIS	BELL ROAD	351	536-R-1	WILL	1232 113
PLOT SCALE = 1:200.001	CHECKED PJO	REVISED -	DEPARTMENT OF TRANSPORTATION				CONTRACT	NO. 60L71
PLOT DATE = 8/15/2014	DATE 8/15/2014	REVISED -		SCALE: AS SHOWN SHEET NO. 9 OF 20 SHEETS STA. TO STA.		ILLINOIS FED	AID PROJECT	



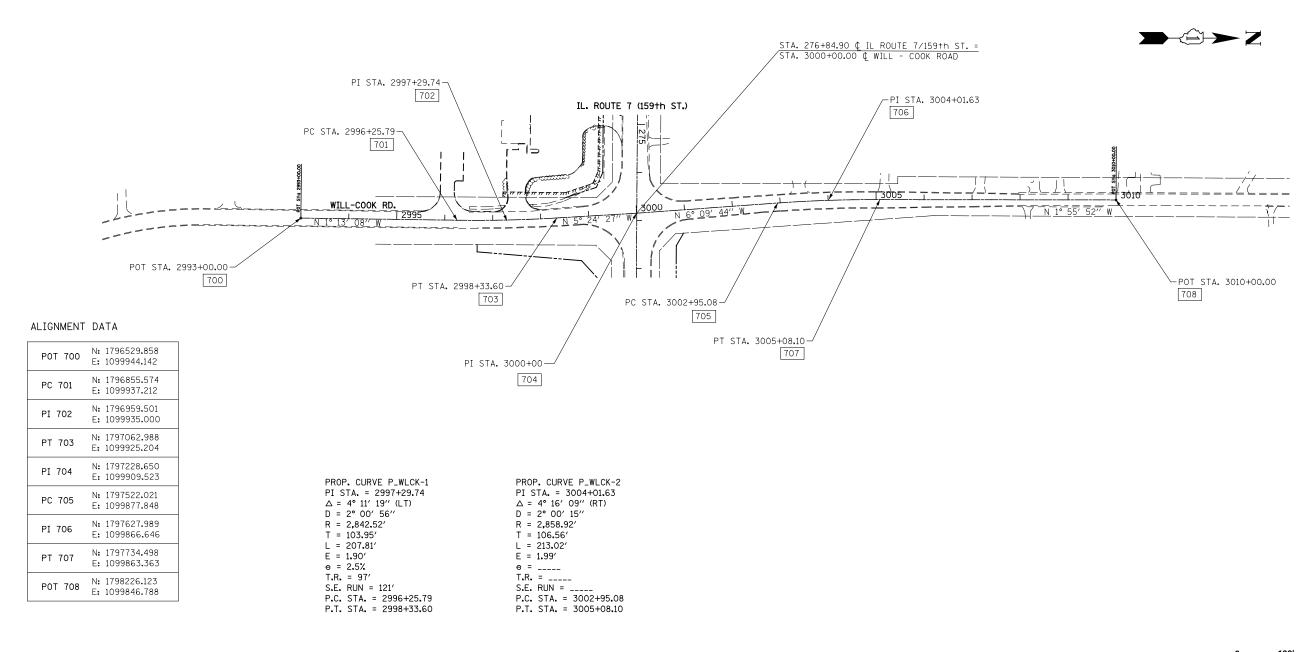


USER NAME = mmaestra	DESIGNED MEA	REVISED -		ALIGNMENT, BENCHMA
	DRAWN MEA	REVISED -	STATE OF ILLINOIS	-
PLOT SCALE = 1:200.001	CHECKED PJO	REVISED -	DEPARTMENT OF TRANSPORTATION	WILL-COOK
PLOT DATE = 8/15/2014	DATE 8/15/2014	REVISED -		SCALE: AS SHOWN SHEET NO. 10 OF 20 SHEETS


			0 '	100' 2	200 30	0 400	
				SCALE	IN FEET		
M	IARKS, AND	TIES	F.A.P. RTE.	SECTIO	DN CO	UNTY TOTAL SHEETS	SHEET
	-		351	536-R-	1 W	ILL 1232	114
N N	ROAD				C01	NTRACT NO. 6	30L71
S	STA.	TO STA.		ILLIN	OIS FED. AID PRO.	JECT	

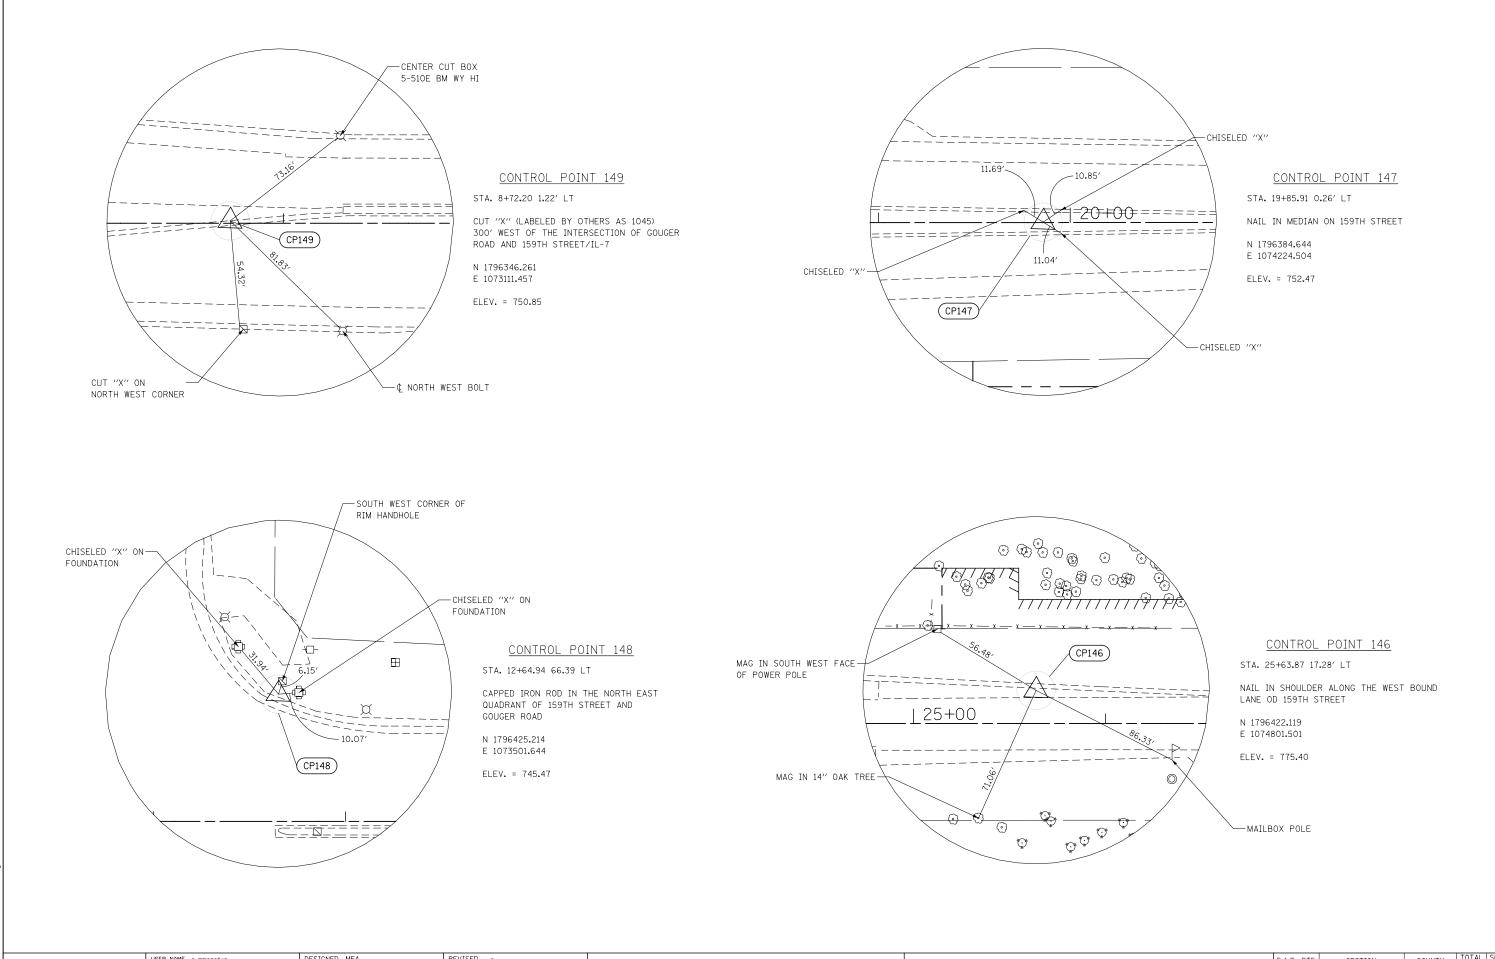


USER NAME = mmæstræ	DESIGNED MEA	REVISED -		_		F.A.P. RTE.	SECTION	COUNTY	TOTAL SHEET SHEETS NO.
	DRAWN MEA	REVISED -	STATE OF ILLINOIS	A	LIGNMENT, BENCHMARKS, AND TIES	351	536-R-1	WILL	1232 115
PLOT SCALE = 1:50.0003	CHECKED PJO	REVISED -	DEPARTMENT OF TRANSPORTATION			_		CONTRACT	NO. 60L71
PLOT DATE = 8/18/2014	DATE 8/15/2014	REVISED -		SCALE: AS SHOWN	SHEET NO. 11 OF 20 SHEETS STA. TO STA.		ILLINOIS FED.	AID PROJECT	

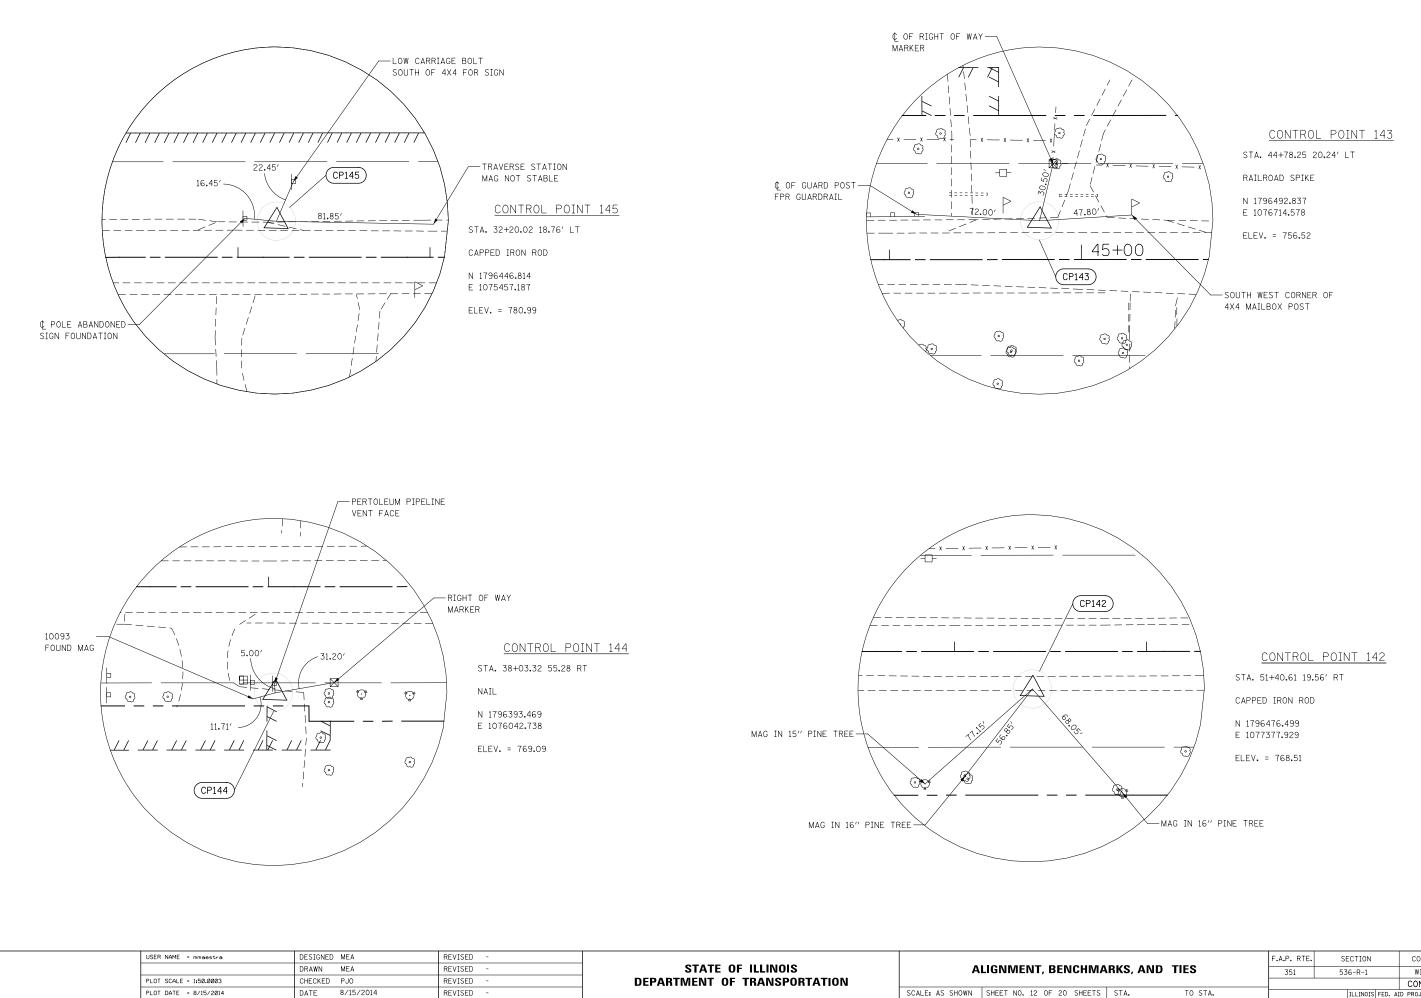


_			F.A.P. RTE.	SECTION	COUNTY	TOTAL SHEETS	SHEET NO.
A	ARKS, AND TIES		351	536-R-1	WILL	1232	116
					CONTRACT	NO. 6	0L71
5	STA.	TO STA.		ILLINOIS FED. A	ID PROJECT		

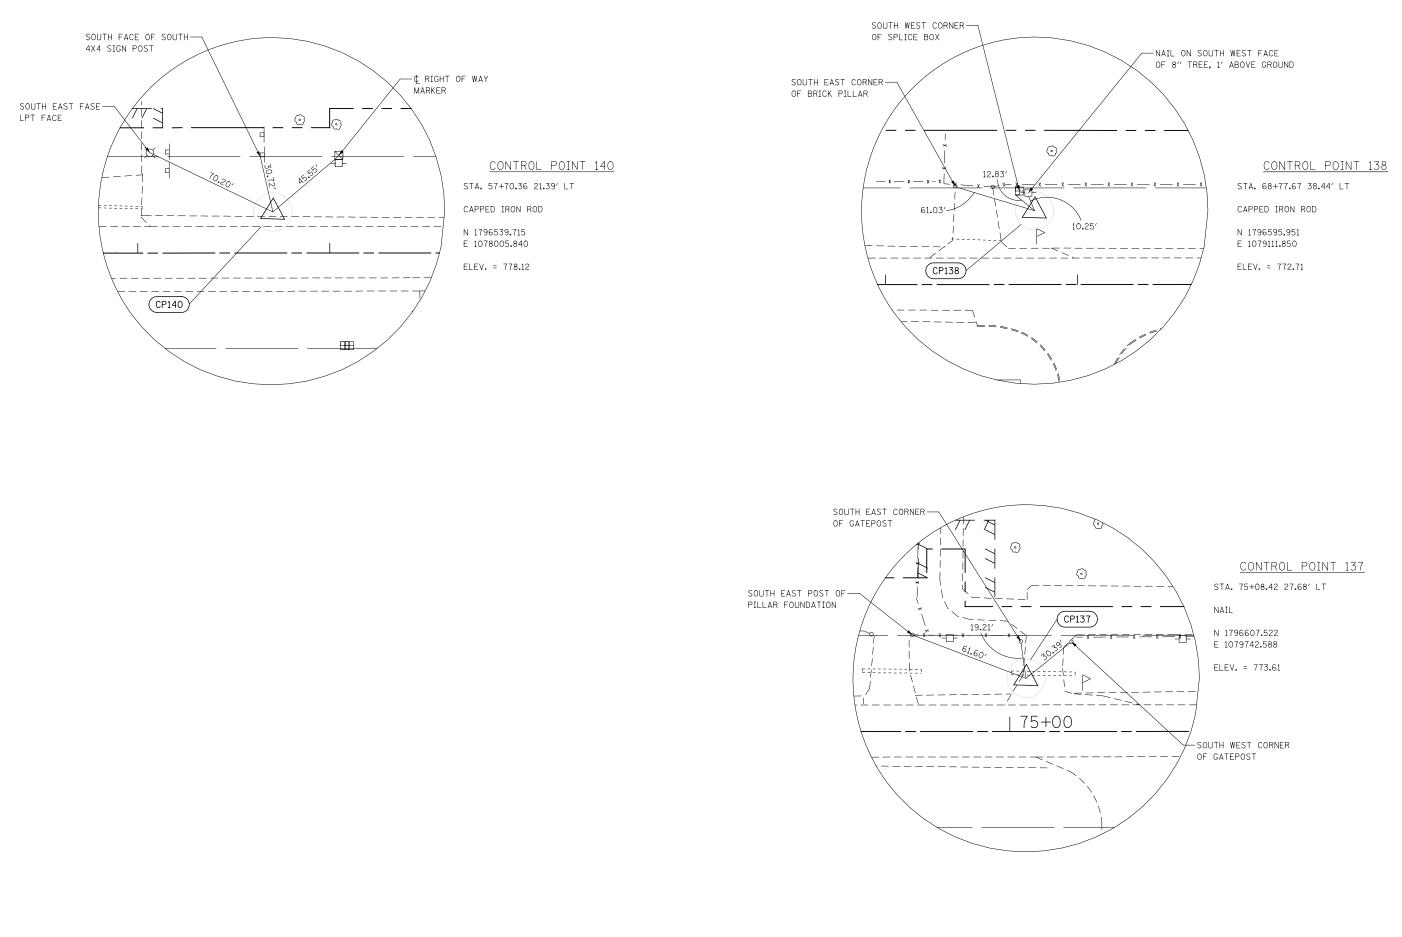


USER NAME = mmaestra	DESIGNED MEA	REVISED -			F.A.P. RTE. SECTION	COUNTY TOTAL SHEET SHEETS NO.
	DRAWN MEA	REVISED -	STATE OF ILLINOIS	ALIGNMENT, BENCHMARKS, AND TIES	351 536-R-1	WILL 1232 117
PLOT SCALE = 1:50.0003	CHECKED PJO	REVISED -	DEPARTMENT OF TRANSPORTATION			CONTRACT NO. 60L71
PLOT DATE = 8/15/2014	DATE 8/15/2014	REVISED -		SCALE: AS SHOWN SHEET NO. 13 OF 20 SHEETS STA. TO STA.	ILLINOIS FED.	AID PROJECT

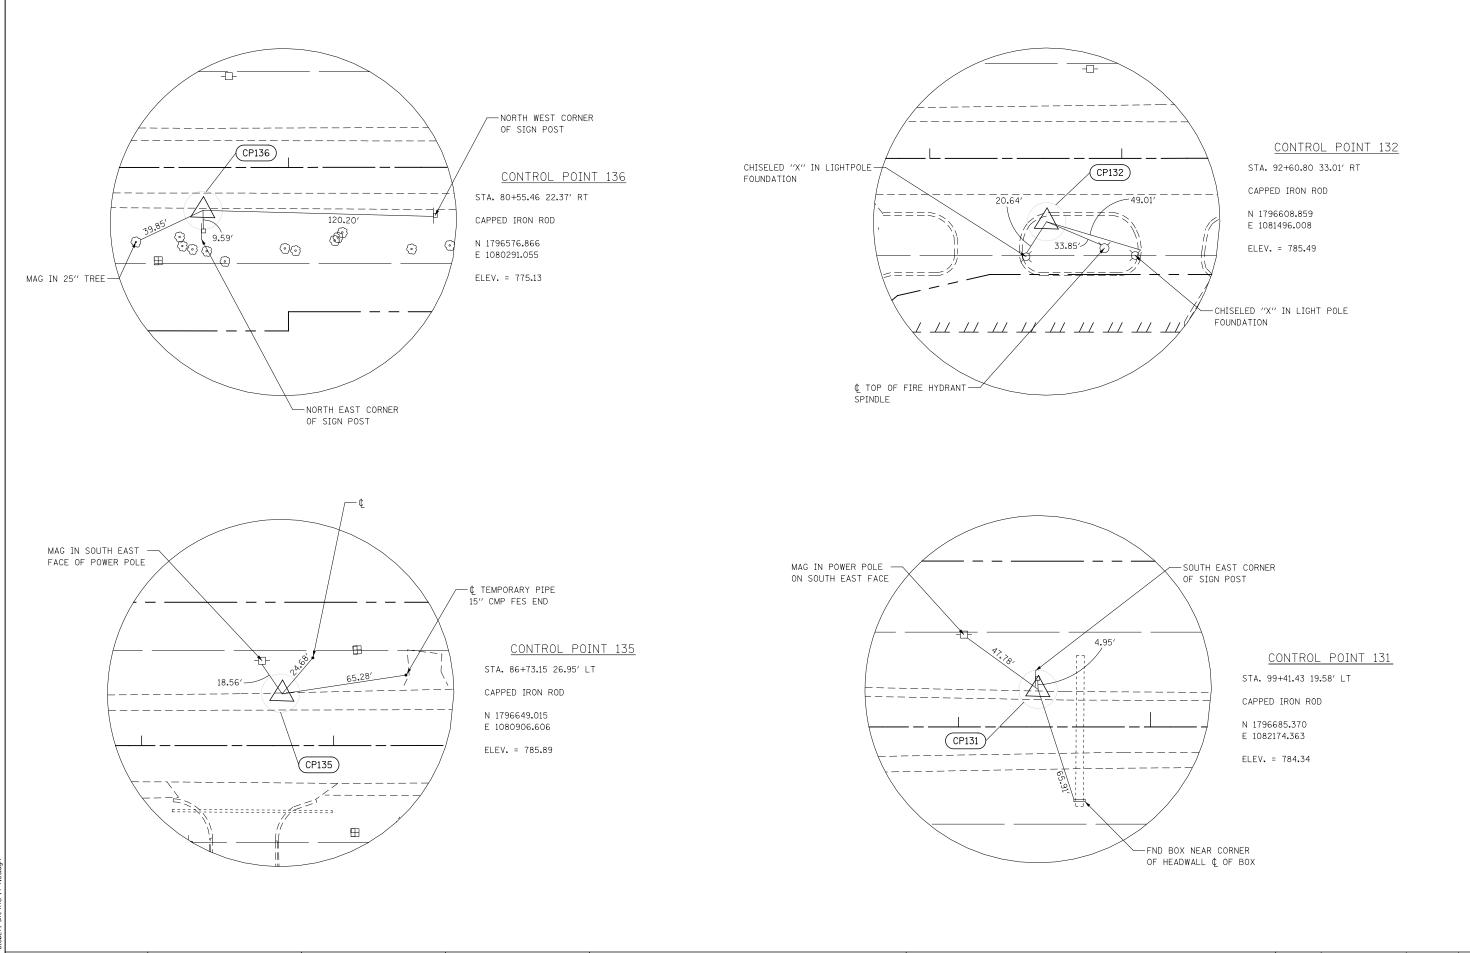


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	DRAWN MEA	REVISED -	STATE OF ILLINOIS	ALIGNMENT, BENCHMARKS, AND TIES	351	536-R-1	WILL	1232 118
PLOT SCALE = 1:50.0003	CHECKED PJO	REVISED -	DEPARTMENT OF TRANSPORTATION				CONTRACT	T NO. 60L71
PLOT DATE = 8/15/2014	DATE 8/15/2014	REVISED -		SCALE: AS SHOWN SHEET NO. 14 OF 20 SHEETS STA. TO STA.		ILLINOIS FED	. AID PROJECT	

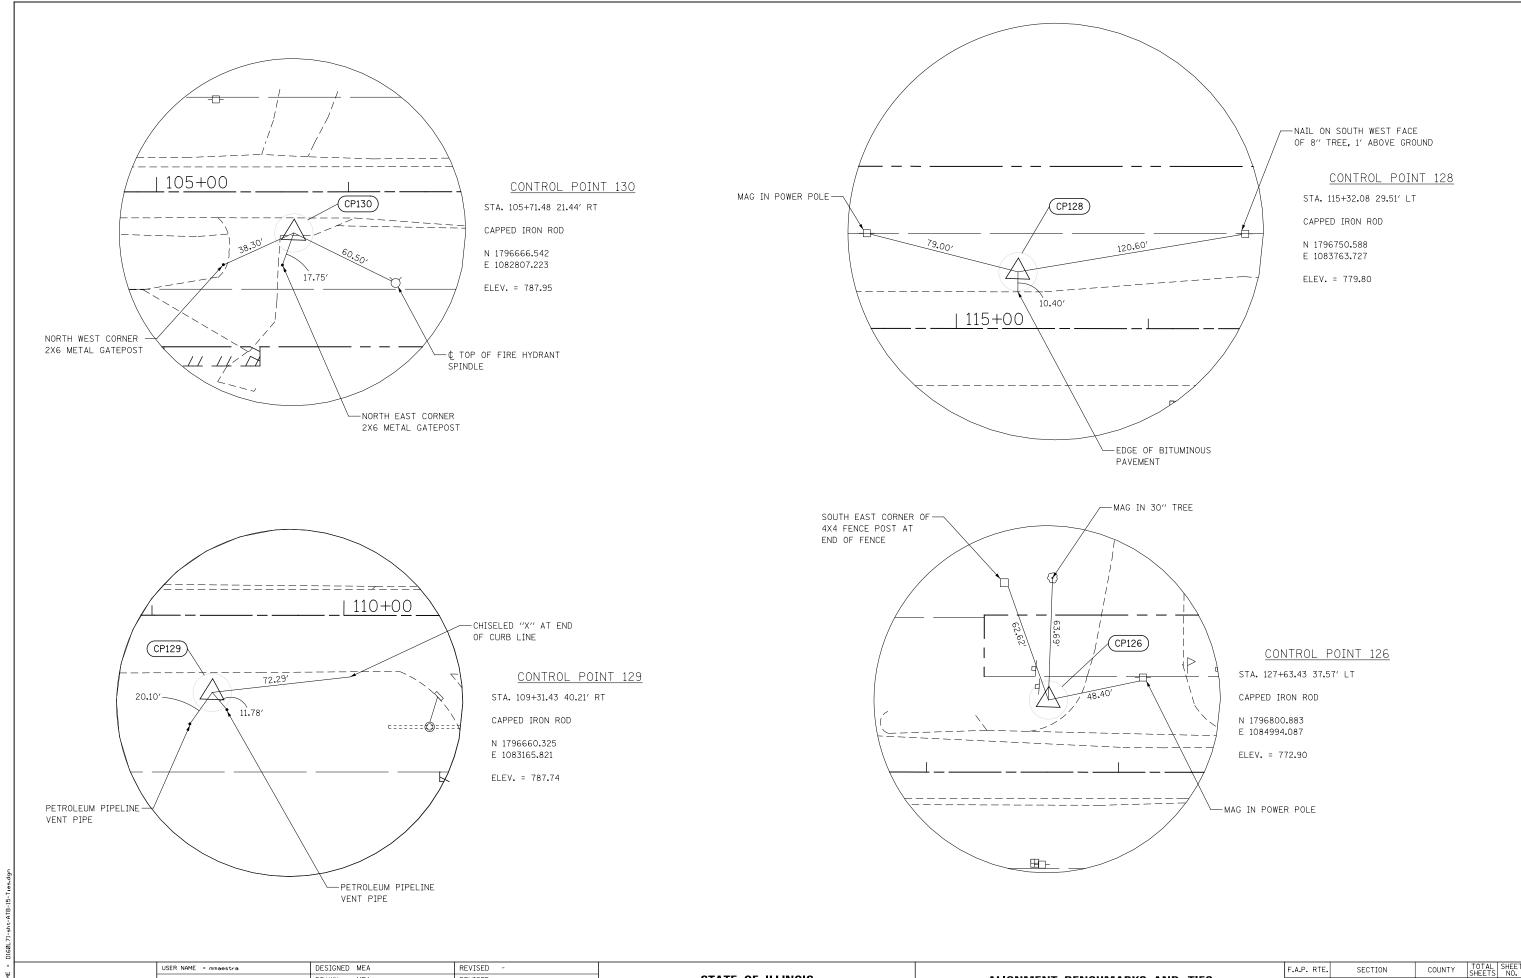

USER NAME = mmaestra	DESIGNED MEA	REVISED -					F.A.P.	RTE.	SECTION	COUNTY	TOTAL SHEET SHEETS NO.
	DRAWN MEA	REVISED -	STATE OF ILLINOIS	ALIC	GNMENT, BENCHMA	RKS, AND TIES	351		536-R-1	WILL	1232 119
PLOT SCALE = 1:50.0003	CHECKED PJO	REVISED -	DEPARTMENT OF TRANSPORTATION							CONTRAC	CT NO. 60L71
PLOT DATE = 8/15/2014	DATE 8/15/2014	REVISED -		SCALE: AS SHOWN SH	HEET NO. 15 OF 20 SHEETS	STA. TO			ILLINOIS FED.	AID PROJECT	

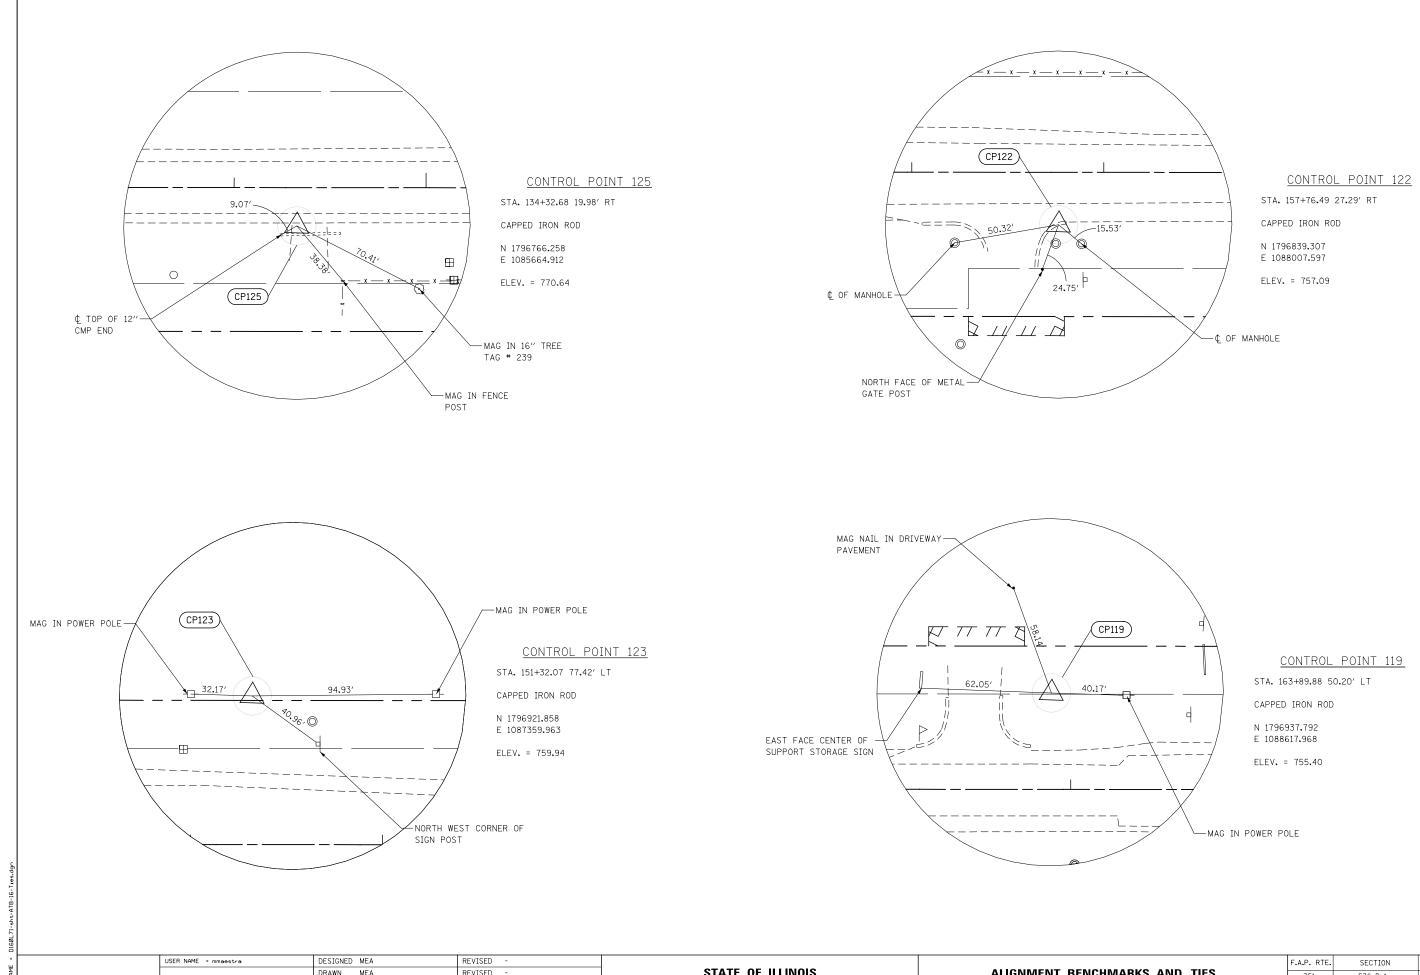

USER NAME = mmaestra	DESIGNED MEA	REVISED -			F.A.P. RTE.	SECTION	COUNTY TO	DTAL SHEET EETS NO.
	DRAWN MEA	REVISED -	STATE OF ILLINOIS	ALIGNMENT, BENCHMARKS, AND TIES	351	536-R-1	WILL 12	232 120
PLOT SCALE = 1:50.0003	CHECKED PJO	REVISED -	DEPARTMENT OF TRANSPORTATION				CONTRACT NO	0. 60L71
PLOT DATE = 8/15/2014	DATE 8/15/2014	REVISED -		SCALE: AS SHOWN SHEET NO. 16 OF 20 SHEETS STA. TO STA.		ILLINOIS FED. A	ID PROJECT	

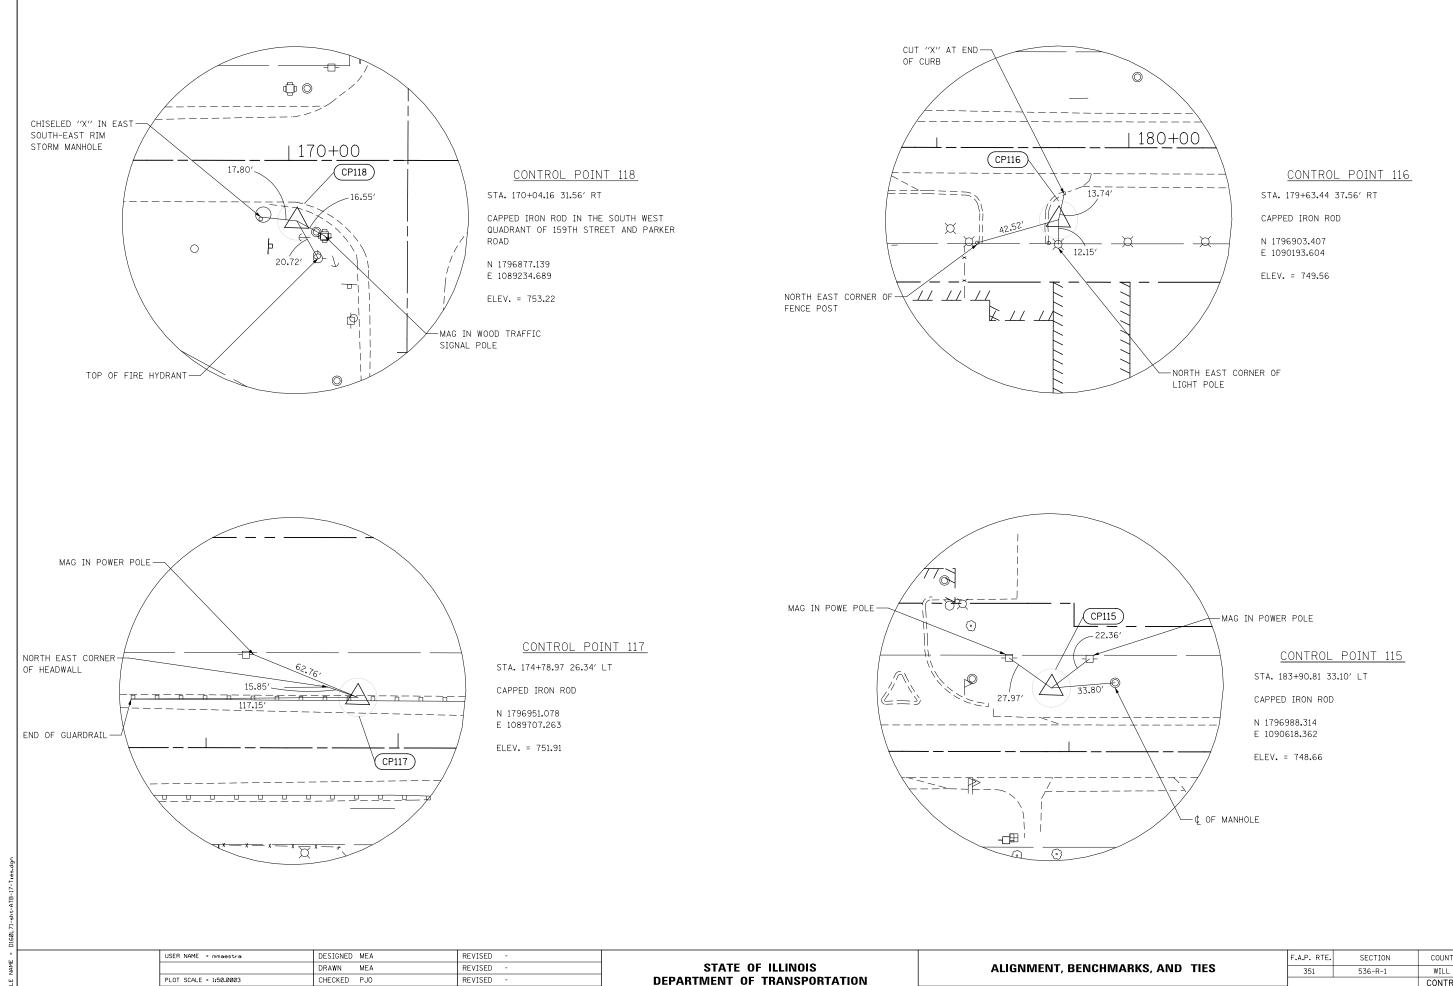


DATE

PLOT DATE = 8/15/2014


8/15/2014

REVISED


	-					F.A.P. RTE.	SECTION	COUNTY	TOTAL SHEETS	SHEET NO.
	Α	LIGNMENT, BENCH	IMA	RKS, AND	TIES	351	536-R-1	WILL	1232	121
							•	CONTRACT	NO. 6	0L71
SCA	LE: AS SHOWN	SHEET NO. 17 OF 20 SH	EETS	STA.	TO STA.		ILLINOIS FED. A	ID PROJECT		

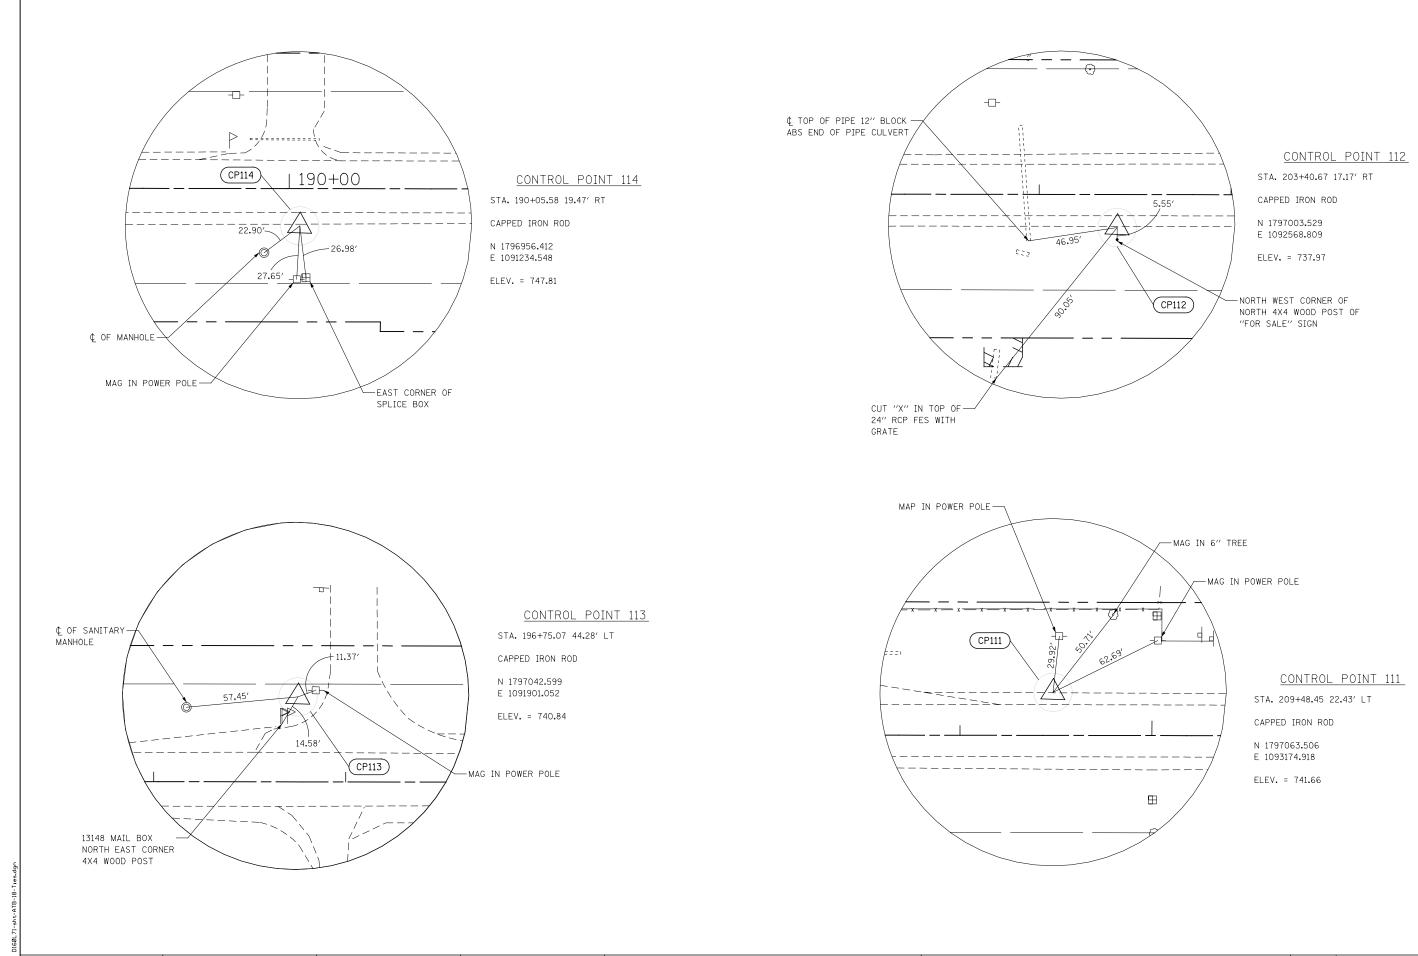

_	USER NAME = mmaestra	DESIGNED MEA	REVISED -			F.A.P. RTE. SECTION	COUNTY TOTAL SHEET
		DRAWN MEA	REVISED -	STATE OF ILLINOIS	ALIGNMENT, BENCHMARKS, AND TIES	351 536-R-1	WILL 1232 122
	PLOT SCALE = 1:50.0003	CHECKED PJO	REVISED -	DEPARTMENT OF TRANSPORTATION			CONTRACT NO. 60L71
	PLOT DATE = 8/15/2014	DATE 8/15/2014	REVISED -	SC	SCALE: AS SHOWN SHEET NO. 18 OF 20 SHEETS STA. TO STA.	ILLINOIS FED.	AID PROJECT

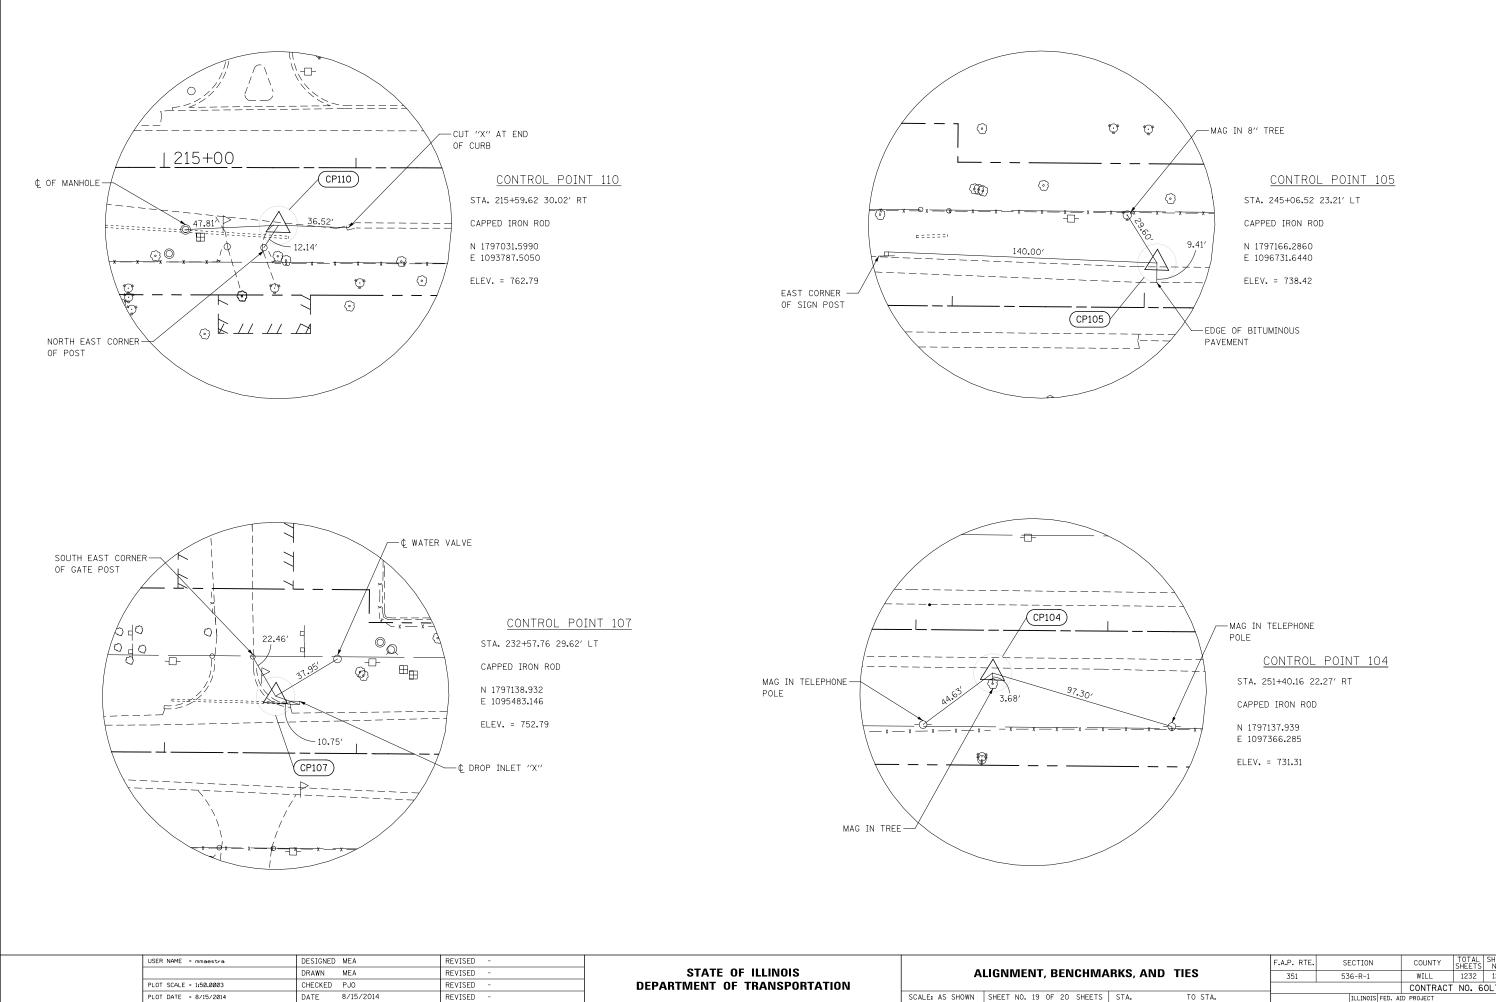

			F.A.P. RTE.	TOTAL SHEETS	SHEET NO.					
IA	RKS, A	RKS, AND TIES 351 536-R-1		WILL	1232	123				
_					CONTRACT	NO. 6	0L71			
S	STA.	TO STA.	ILLINOIS FED. AID PROJECT							

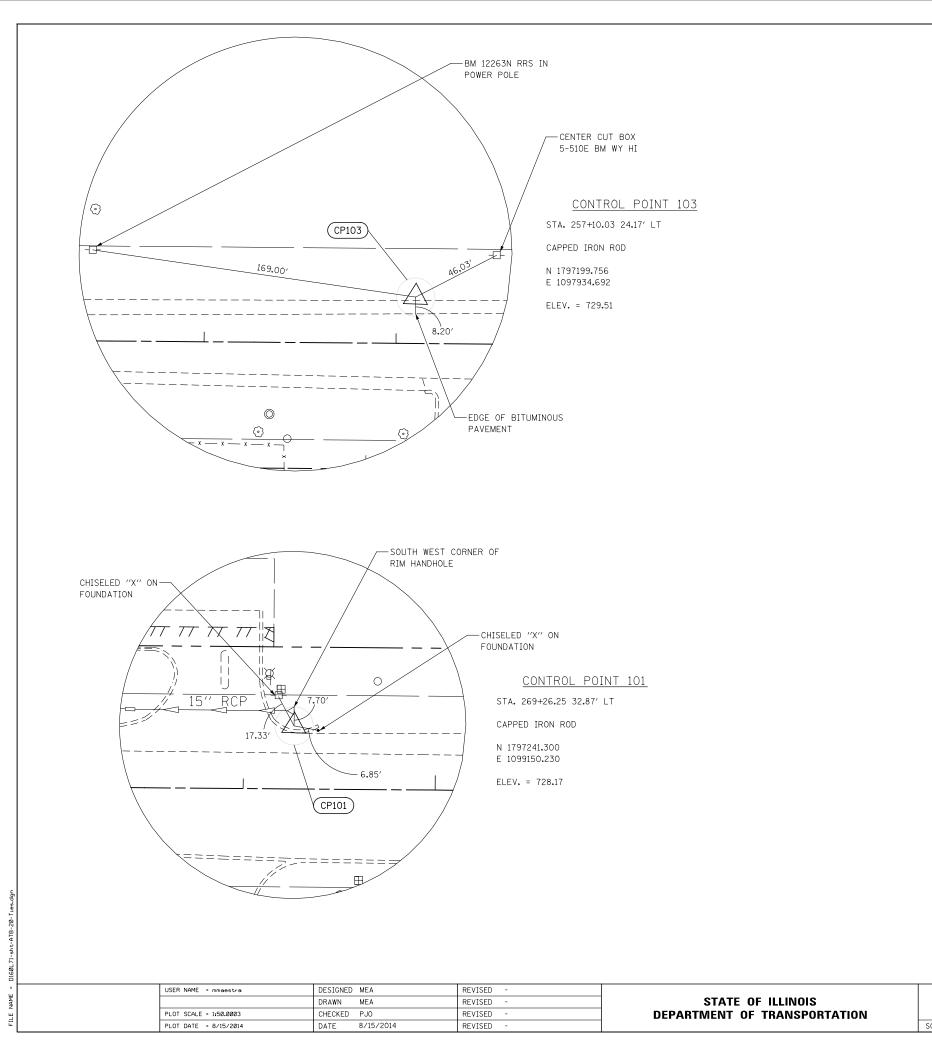


	F.A.P. RTE.	SECTION	COUNTY	TOTAL SHEETS	SHEET NO.			
IARKS, AND TIES	TIES 351 536-R-1 WILL 1				124			
	_		CONTRACT	NO. 6	0L71			
S STA. TO STA.	ILLINOIS FED. AID PROJECT							


# TRAFFIC CONTROL DETOUR GENERAL NOTES

- 1. ALL SIGNING SHALL BE IN ACCORDANCE WITH APPLICABLE PROVISIONS OF THE STATE OF ILLINOIS "STANDARD SPECIFICATIONS FOR ROAD AND BRIDGE CONSTRUCTION" ADOPTED JANUARY 1, 2012, THE DETAILS IN THESE PLANS, AND THE LATEST EDITION OF THE STATE OF ILLINOIS "MANUAL ON UNIFORM TRAFFIC CONTROL DEVICES".
- 2. THE CONTRACTOR SHALL PROCEED WITH THE WORK IN AN EXPEDIENT MANNER TO REDUCE THE LENGTH OF DURATION OF THE OAK VALLEY TRAIL DETOUR, THE OAK VALLEY TRAIL DETOUR SHALL NOT EXCEED FIFTEEN (15) CALENDAR DAYS
- 3. THE ENGINEER SHALL BE NOTIFIED IN WRITING AT LEAST THREE WEEKS PRIOR TO THE DAY THE DETOURS ARE TO BE IN EFFECT. THE ENGINEER WILL CONTACT THE APPROPRIATE LOCAL OFFICIALS AND INTERESTED PARTIES.
- 4. THE PUBLIC SHALL BE NOTIFIED ONE WEEK (7 CALENDAR DAYS) IN ADVANCE OF THE PLANNED ROAD CLOSURE THROUGH THE USE OF PORTABLE CHANGEABLE MESSAGE SIGNS. FOR OAK VALLEY TRAIL, THE SIGNS SHALL INDICATE THE FOLLOWING MESSAGE "OAK VALLEY TRAIL" (PHASE I, 3-SEC) "WILL CLOSE MM/DD" (PHASE II, 3-SEC) OR AS OTHERWISE DIRECTED BY THE ENGINEER. THE PORTABLE CHANGEABLE MESSAGE SIGNS NOTIFYING THE PUBLIC OF THE PLANNED CLOSURE SHALL BE IN PLACE AT LOCATIONS AS SHOWN ON THE DETOUR PLANS.
- 5. THE ROAD SHALL NOT BE CLOSED UNTIL ALL SIGNING IS ERECTED IN ACCORDANCE WITH THE DETOUR PLAN AND APPROVED BY THE ENGINEER.
- 6. THE CONTRACTOR SHALL MAKE ALL CHANGES IN THE SIGNING THAT ARE DEEMED NECESSARY BY THE ENGINEER.
- 7. THE CONTRACTOR SHALL BE RESPONSIBLE FOR MAINTENANCE OF ALL BARRICADES, SIGNS, LIGHTS, AND OTHER TRAFFIC CONTROL DEVICES, INSTALLED BY HIM, THAT ARE IN PLACE AND OPERATING 24 HOURS A DAY, 7 DAYS A WEEK, FOR THE DURATION OF THIS DETOUR.
- 8. ALL EXISTING SIGNING THAT DOES NOT APPLY AND/OR CONFLICTS WITH THE DETOUR ROUTE WHILE THE DETOUR IS IN EFFECT SHALL BE COMPLETELY COVERED BY THE CONTRACTOR. THIS WORK SHALL BE INCLUDED IN THE COST FOR TRAFFIC CONTROL AND PROTECTION (SPECIAL).
- 9. ALL DETOUR SIGNING SHALL BE POST MOUNTED.

- 10. ALL DETOUR SIGNING DESIGNATED WITH "(0)" IN THE SIGN CODE SHALL HAVE BLACK LEGENDS ON ORANGE HIGH INTENSITY BACKGROUNDS AND STANDARD BLACK BORDERS. ALL DETOUR SIGNING SHALL BE NEW OR LIKE NEW CONDITION.
- 11. THE SIZES OF ALL SIGNS NOT SPECIFIED IN THESE PLANS SHALL BE IN ACCORDANCE WITH THE ILLINOIS MANUAL ON UNIFORM TRAFFIC CONTROL DEVICES.
- 12. TYPE III BARRICADES, AND THEIR APPLICATION, SHALL CONFORM TO HIGHWAY STANDARD 701901.
- 13. THE "ROAD CLOSED" SIGN ON A TYPE III BARRICADE SHALL BE MOUNTED ABOVE THE TOP OF THE BARRICADE AS SHOWN IN THE SIGN LEGEND. ALL TYPE III BARRICADES SHALL HAVE TWO AMBER TYPE 'A' LOW INTENSITY FLASHING LIGHTS SPACED NEAR THE CENTERLINE OF THE SUPPORTS.
- 14. CONSTRUCTION EQUIPMENT SHALL NOT BE PARKED IMMEDIATELY BEHIND THE TYPE III BARRICADES AT ANY TIME. ARTICLE 107.14 OF THE STANDARD SPECIFICATIONS SHALL APPLY.
- 15. THE ENGINEER SHALL BE NOTIFIED AT LEAST THREE (3) DAYS PRIOR TO THE REMOVAL OF THE DETOUR. THE ENGINEER WILL CONTACT THE APPROPRIATE LOCAL OFFICIALS AND INTERESTED PARTIES.
- 16. PORTABLE CHANGEABLE MESSAGE SIGNS SHALL INDICATE THE MESSAGE SHOWN IN THE SIGN LEGEND. A MAXIMUM OF 3 PHASES SHALL BE USED. EACH PHASE SHALL BE DISPLAYED FOR 3 SECONDS WITH A MAXIMUM CYCLE OF 9 SECONDS. LETTERS SHALL BE 18 INCHES HIGH AND ALL UPPER-CASE. CHANGEABLE MESSAGE SIGNS SHALL COMPLY WITH THE REQUIREMENTS IN SECTION 6F.60 OF THE 2009 MUTCD.

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_		DRAWN	MEA	REVISED -	STATE OF ILLINOIS DEPARTMENT OF TRANSPORTATION		DET	TOUR GEN	IERAL N	JOTES 351			536-R-1	WILL	1232 125
	PLOT SCALE = 1:100.001	CHECKED	PJO	REVISED -						CONTRACT NO. 60L71			T NO. 60L71		
	PLOT DATE = 8/15/2014	DATE	8/15/2014	REVISED -		SCALE: N.T.S.	SHEET NO. 1 O	F 1 SHEET	IS STA.		TO STA.		ILLINOIS FED	AID PROJECT	

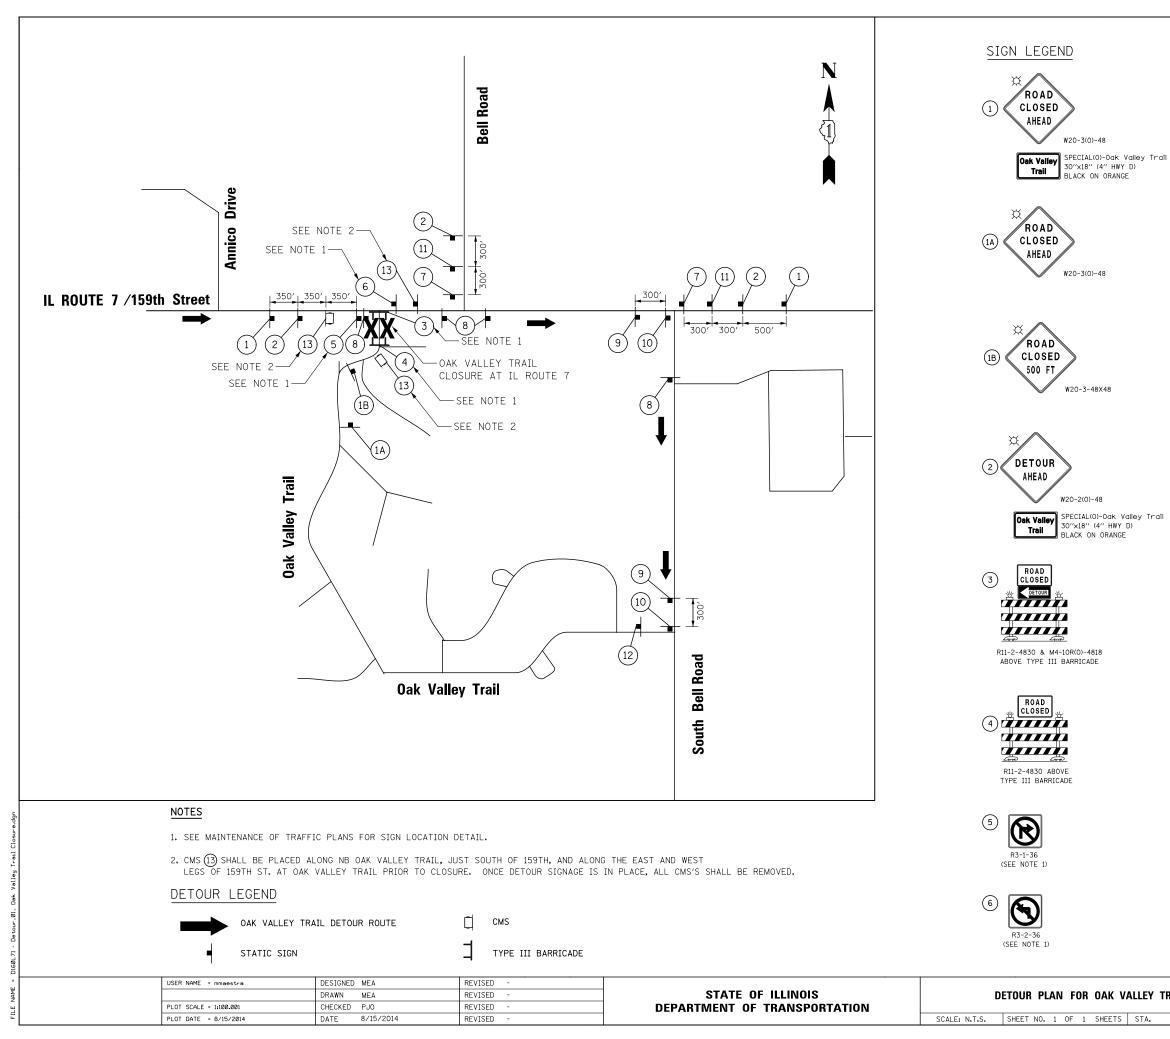

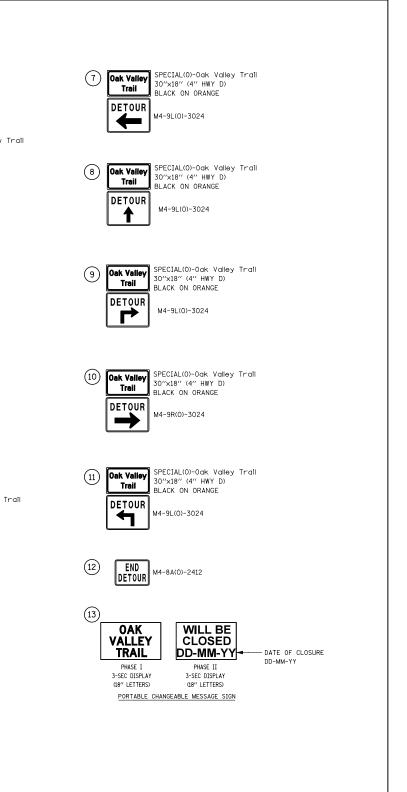

	F.A.P. RTE.	SECTION	COUNTY	TOTAL SHEETS	SHEET NO.			
VALLEY TRAIL CLOSURE	Y TRAIL CLOSURE 351 536-R-1				126			
1			CONTRACT	NO. 6	0L71			
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# MAINTENANCE OF TRAFFIC GENERAL NOTES

- 1. THE CONTRACTOR SHALL PROVIDE AND MAINTAIN A MINIMUM OF ONE 11' THROUGH TRAFFIC LANE IN EACH DIRECTION ON ILLINOIS ROUTE 7 EXCEPT AS OTHERWISE INDICATED ON THE PLANS. OFF-PEAK PERIOD LANE CLOSURES WILL BE ALLOWED FOR CONSTRUCTION ACTIVITY ONLY AS APPROVED BY THE ENGINEER. OFF-PEAK HOURS WILL BE DEFINED AS 10:00 AM TO 3:00 PM AND 8:00 PM TO 5:00 AM.
- 2. THE CONTRACTOR SHALL PROVIDE ALL SIGNS, VERTICAL PANELS, TYPE III BARRICADES, CHANNELIZATION DRUMS, TYPE II BARRICADES, ALL TEMPORARY CONCRETE BARRIERS AND PROTECTION NECESSARY FOR WORK ZONE TRAFFIC CONTROL AND PROTECTION, OR AS DIRECTED BY THE ENGINEER.
- THE CONTRACTOR SHALL INSTALL AND MAINTAIN PROPOSED AND TEMPORARY DRAINAGE SYSTEMS, AND EROSION CONTROL MEASURES DURING STAGE CONSTRUCTION THROUGHOUT THE DURATION OF THE PROJECT. THIS WORK SHALL BE INCLUDED IN THE COST OF THE PAY ITEMS ASSOCIATED WITH THE APPLICABLE DRAINAGE SYSTEMS AND EROSION CONTROL MEASURES.
- 4. THE CONTRACTOR SHALL COORDINATE PLACEMENT OF TRAFFIC SIGNS, TRAFFIC CONTROL DEVICES AND TRAFFIC LANE LOCATIONS WITH ADJACENT IDOT CONTRACT 60L72 OR AS DIRECTED BY THE ENGINEER. ALL COORDINATION ACTIVITES BETWEEN CONTRACT 60L71 AND CONTRACT 60L72 SHALL BE INCLUDED IN THE COST FOR TRAFFIC CONTROL AND PROTECTION (SPECIAL).
- 5. THE CONTRACTOR SHALL USE TEMPORARY PAVEMENT MARKING ON SURFACES TO BE REMOVED AND IN AREAS THAT DO NOT CONFLICT WITH OTHER STAGES. A PERMANENT MATERIAL (NOT TAPE OR PAINT) SHALL BE USED DURING ALL WINTER STAGING MONTHS (NOVEMBER 1 - APRIL 1). THE PLACEMENT AND REMOVAL OF PAVEMENT MARKINGS FOR WINTER MONTHS SHALL BE PAID FOR AT THE UNIT COST FOR PERMANENT PAVEMENT MARKING OF THE TYPE SPECIFIED ON THE PLANS.
- 6. THE CONTRACTOR SHALL USE WET REFLECTIVE TEMPORARY TAPE, TYPE III, ON EXISTING SURFACES TO REMAIN, AREAS IN CONFLICT WITH OTHER STAGES, AND PERMANENT SURFACES EXCEPT DURING WINTER MONTHS (NOVEMBER 1 - APRIL 1) WHEN ALL REFLECTIVE TEMPORARY TAPE PAVEMENT MARKINGS SHALL BE REPLACED WITH A PERMANENT MATERIAL (NOT PAINT). THE PLACEMENT AND REMOVAL OF PAVEMENT MARKINGS FOR WINTER MONTHS SHALL BE PAID FOR AT THE UNIT COST FOR PERMANENT PAVEMENT MARKING OF THE TYPE SPECIFIED ON THE PLANS.
- 7. 4 INCH SOLID WHITE PAVEMENT MARKING LINES SHALL BE USED TO DEFINE EDGE LINE WHERE CURB AND GUTTER DOES NOT EXIST.
- 8. 4 INCH SOLID DOUBLE YELLOW PAVEMENT MARKING LINES ARE TO BE USED TO SEPARATE OPPOSING TRAFFIC LANES.
- ALL DOUBLE YELLOW CENTERLINE MARKING LINES SHALL BE SPACED AT 11 INCHES CENTER 9. TO CENTER.
- 10. 6 INCH SOLID WHITE PAVEMENT MARKING LINES ARE TO BE USED TO DEFINE TURN LANES.
- 11. 12 INCH SOLID YELLOW PAVEMENT MARKING LINES ARE TO BE USED FOR TEMPORARY MEDIAN DIAGONAL LINES AT LOCATIONS AS SHOWN ON THE PLANS.
- 12. 24 INCH SOLID WHITE PAVEMENT MARKING LINES ARE TO BE USED FOR STOP BARS.
- 13. ALL DRUMS. VERTICAL PANELS. AND TYPE II BARRICADES (IF REQUIRED)SHALL BE EQUIPPED WITH MONO-DIRECTIONAL STEADY BURNING LIGHTS ON MULTILANE ROADWAYS, WHILE BI-DIRECTIONAL LIGHTS ARE REQUIRED ON ALL, TWO-WAY, TWO-LANE ROADWAYS.
- 14. ALL DRUMS, VERTICAL PANELS, AND TYPE II BARRICADES SHALL BE SPACED AT 50 FEET CENTER TO CENTER THROUGHOUT THE WORK ZONE, EXCEPT IN TAPER AREAS, GORE AREAS, AND ALONG CORNER RADII, WHERE THEY SHALL BE SPACED AT 25 FEET CENTER TO CENTER EXCEPT AS OTHERWISE INDICATED ON THE PLANS,
- 15. TYPE II BARICADES SHALL BE USED IN LIEU OF DRUMS IN LOCATIONS WHERE TYPE II MUST BE PLACED IN EXCAVATED AREAS DUE TO LIMITED SPACE. THESE BARICADES SHALL HAVE LEG EXTENSIONS INSTALLED SUCH THAT THE TOP OF THE BARRICADE IS IN COMPLIANCE WITH IDOT HIGHWAY STANDARD 701901. DRUMS AND BARRICADES SHALL NOT BE PLACED TOGETHER WITHIN AN INDIVIDUAL RUN OF DEVICES.
- 16. TEMPORARY CONCRETE BARRIERS SHALL BE EQUIPPED WITH TYPE "C" REFLECTORS, IN ACCORDANCE WITH HIGHWAY STANDARD 704011 AT 25' CENTERS.

- 17. ALL CONSTRUCTION WARNING SIGNS SHALL BE BLACK LEGEND ON ORANGE BACKGROUND.
- 18. ALL CONSTRUCTION WARNING SIGN DIMENSIONS SHALL BE 48" X 48", EXCEPT AS OTHERWISE STATED ON THE PLANS.
- 19. ALL "ROAD CONSTRUCTION AHEAD" WARNING SIGNS SHALL BE EQUIPPED WITH HIGH INTENSITY MONO-DIRECTIONAL FLASHING LIGHTS.
- 20. THE CONTRACTOR SHALL INSTALL AND COVER ALL TEMPORARY SIGNING BEFORE EXISTING SIGNS ARE REMOVED. THE CONTRACTOR SHALL RELOCATE EXISTING SIGNS AS INDICATED ON THE PLANS.
- 21. THE CONTRACTOR SHALL INSTALL AND COVER ALL PERMANENT SIGNING BEFORE TEMPORARY SIGNS ARE REMOVED. THE COST OF THIS WORK SHALL BE INCLUDED IN THE COST FOR SIGN PANEL. OF THE TYPE SPECIFIED.
- 22. ALL EXISTING GUIDE SIGNS (1.e. STREET NAME SIGNS, ADVANCE STREET NAME SIGNS, ROUTE MARKERS, ETC.) SHALL BE MAINTAINED AND VISIBLE TO TRAFFIC DURING CONSTRUCTION.
- 23. EXISTING TRAFFIC SIGNS IN CONFLICT WITH STAGING SHALL BE REMOVED, RELOCATED OR COVERED AS DIRECTED BY THE ENGINEER. THE COST OF THIS WORK SHALL BE INCLUDED IN THE COST FOR TRAFFIC CONTROL AND PROTECTION (SPECIAL).
- 24. DIRECTION INDICATOR BARRICADES SHALL BE USED AT LANE CLOSURE TAPER LOCATIONS AS DIRECTED BY THE ENGINEER.
- 25. THE CONTRACTOR SHALL MAINTAIN PRIVATE DRIVEWAY, COMMERCIAL DRIVEWAY, FIELD ENTRANCE, AND SIDE ROAD ACCESS AT ALL TIMES AT THE LOCATIONS SHOWN ON THE PLANS OR WHERE DIRECTED BY THE ENGINEER. THIS WORK SHALL BE PAID FOR AT THE CONTRACT UNIT PRICE PER EACH FOR TEMPORARY ACCESS (PRIVATE ENTRANCE), TEMPORARY ACCESS (COMMERCIAL ENTRANCE), TEMPORARY ACCESS (FIELD ENTRANCE), AND TEMPORARY ACCESS (ROAD). EACH DRIVEWAY, FIELD ENTRANCE, AND SIDE ROAD SHALL ONLY BE MEASURED FOR PAYMENT ONCE. DURING WINTER MONTHS. THE CONTRACTOR SHALL CONSTRUCT AND MAINTAIN TEMPORARY ACCESS COMPOSED OF A HOT-MIX ASPHALT SURFACE OVER PREVIOUSLY INSTALLED AGGREGATE TEMPORARY ACCESS. THIS WORK WILL BE PAID FOR SEPARATELY AND SHALL BE IN ACCORDANCE WITH TEMPORARY ACCESS (WINTERIZE).
- 26. AT THE END OF EACH WORK DAY, THE CONTRACTOR SHALL BACKFILL OR COVER ALL TRENCHES AND OPEN EXCAVATION HOLES FOR PROPOSED STORM SEWER, DRAINAGE STRUCTURES, AND WATER MAINS IN ORDER TO PROVIDE A SAFE CONDITION FOR MOTORISTS AND THE PUBLIC DURING NON-WORKING HOURS. THE COST OF THIS WORK SHALL BE INCLUDED IN THE COST FOR TRAFFIC CONTROL AND PROTECTION (SPECIAL).
- 27. LOCATIONS OF EXISTING SIDEWALK CLOSURES SHALL BE DETERMINED BY THE RESIDENT ENGINEER. AS DIRECTED BY THE ENGINEER, THE CONTRACTOR SHALL CLOSE EXISTING SIDEWALKS WHEN THEY ENTER A WORK ZONE IN ACCORDANCE WITH IDOT STANDARD 701801.
- 28. WARNING SIGNS ARE REQUIRED AT ALL DRIVEWAYS AND UNSIGNALIZED SIDE ROADS TO ALERT MOTORISTS OF THE NEW LANE CONFIGURATION FOR EACH STAGE CHANGE. THE SIGNS SHALL BE IN ACCORDANCE WITH MAINTENANCE OF TRAFFIC DETAIL - TEMPORARY INFORMATION SIGNING AT DRIVEWAYS/SIDE ROADS. THESE SIGNS SHALL BE PAID FOR SEPARATELY UNDER THE TEMPORARY INFORMATION SIGNING PAY ITEM AND SHALL BE MEASURED FOR PAYMENT ONCE PER EACH LOCATION. THE RELOCATION OF THESE SIGNS FOR SUBSEQUENT STAGES SHALL BE CONSIDERED INCLUDED IN THE COST FOR TEMPORARY INFORMATION SIGNING.
- 29. TEMPORARY CONCRETE BARRIER SHALL BE CONTINUOUSLY PINNED TO THE PAVEMENT WHEREVER A 3.5 FOOT CLEAR ZONE (FREE OF DROP-OFFS, FIXED OBJECTS, OR OTHER OBSTACLES) CANNOT BE PROVIDED FOR BEHIND THE BARRIER. THIS WORK SHALL BE INCLUDED IN THE COST OF TEMPORARY CONCRETE BARRIER OR RELOCATE TEMPORARY CONCRETE BARRIER.
- 30. DRUMS AND TEMPORARY PAVEMENT MARKING 4" DOUBLE YELLOW LINE SHALL BE INSTALLED TO DELINEATE THE LEFT TRAVEL EDGE OF PAVEMENT AFTER TEMPORARY PAVEMENT HAS BEEN CONSTRUCTED IN THE EXISTING RAISED MEDIAN IN PRE-STAGE.
- 31. TWO WEEKS PRIOR TO PLACEMENT OF PERMANENT PAVEMENT MARKINGS THE ENGINEER SHALL CONTACT CORY JUCIUS. AREA TRAFFIC FIELD ENGINEER. AT (847) 705-4411.
- 32. THE CONTRACTOR SHALL PROVIDE AND MAINTAIN ACCESS TO ALL COMMERCIAL AND PRIVATE ENTRANCES. PAY ITEMS ARE INCLUDED IN THE PLANS FOR THIS ITEM. SEE IDOT DISTRICT 1 STANDARD TC-26 FOR TEMPORARY INFORMATION SIGNING REQUIREMENTS AT DRIVEWAYS.

USER NAME = mmaestra	DESIGNED NAV	REVISED -		MAINTENANCE OF TRAFFIC	F.A.P. RTE.	SECTION	COUNTY	TOTAL SHEET SHEETS NO.
	DRAWN NAV	REVISED -	STATE OF ILLINOIS		351	536-R-1	WILL	1232 127
PLOT SCALE = 1:3.12003 CHECKED PJO REVISED - DEPARTMENT OF TRANSPORTATION		GENERAL NOTES			CONTRACT	NO. 60L71		
PLOT DATE = 8/15/2014	DATE 8/15/2014	REVISED -		SCALE: NONE SHEET NO. 1 OF 1 SHEETS STA. TO STA.		ILLINOIS FED. A	ID PROJECT	

# PRESTAGE 1

#### IL ROUTE 7

### CONSTRUCTION

WORK IN PRESTAGE 1 INCLUDES CONSTRUCTION OF THE FOLLOWING: TREE REMOVAL, REMOVAL OF EXISTING TRAFFIC SIGNAL EQUIPMENT, INSTALLATION OF TEMPORARY TRAFFIC SIGNALS, AND COMPLETE REMOVAL OF THE BARRIER MEDIAN, MEDIAN CONCRETE CURB AND GUTTER AND REPLACED WITH TEMPORARY PAVEMENT ON IL ROUTE 7. MEDIAN REMOVAL AND REPLACEMENT WORK WILL BE A SHORT-TERM MOVING WORK ZONE OPERATION. THE CONTRACTOR IS REQUIRED TO PLACE TEMPORARY PAVEMENT IN ALL LOCATIONS WHERE MEDIAN IS REMOVED BY THE END OF WORK FOR THAT DAY. WORK IN PRESTAGE ON IL ROUTE 7 INCLUDES CONSTRUCTION OF TEMPORARY PAVEMENT ON THE NORTH SIDE OF IL ROUTE 7.

#### DRAINAGE

TEMPORARY DRAINAGE WORK IN PRESTAGE 1 INCLUDES INSTALLATION OF NUMEROUS DRIVEWAY PIPE CULVERTS, CONSTRUCTION OF EMBANKMENTS TO FACILITATE PLACEMENT OF TEMPORARY PAVEMENTS, ESTABLISHMENT OF NEW NORTH DITCHES, AND EXTENSION OF EXISTING CROSS-ROAD CULVERTS.

PERMANENT DRAINAGE WORK IN PRESTAGE 1 INCLUDES CONSTRUCTION OF THE STORM SEWER MAIN DRAIN ON THE NORTH SIDE OF IL ROUTE 7 FROM STATION 108+03 TO STATION 171+45 ON THE EAST SIDE OF PARKER ROAD, WITH CROSS-CULVERT AND STORM SEWERS TO BE FULLY CONSTRUCTED ACROSS THE ENTIRE ROADWAY USING A SINGLE LANE NIGHT TIME CLOSURE. INCLUDES CONSTRUCTION OF DETENTION BASIN NO.1 ON THE SOUTH SIDE OF IL ROUTE 7 FROM STATION 125+00 TO STATION 130+70.

### TRAFFIC

TRAFFIC IS TO REMAIN IN THE EXISTING CONFIGURATION. TRAFFIC CONTROL SHALL BE IN ACCORDANCE WITH IDOT STANDARDS NO. 701326, 701601 AND 701701 WHEN APPLICABLE.

#### WINDMILL DRIVE

### CONSTRUCTION

WORK IN PRESTAGE 1 ON WINDMILL DRIVE INCLUDES CONSTRUCTION OF TEMPORARY PAVEMENT ON THE WEST AND EAST SIDE OF WINDMILL DRIVE.

# TRAFFIC

TRAFFIC IS TO REMAIN IN THE EXISTING CONFIGURATION. TRAFFIC CONTROL SHALL BE IN ACCORDANCE WITH IDOT STANDARDS NO. 701601 AND 701701 WHEN APPLICABLE.

### LEACH DRIVE

#### CONSTRUCTION

WORK IN PRESTAGE 1 ON LEACH INCLUDES CONSTRUCTION OF TEMPORARY PAVEMENT ON THE WEST SIDE OF LEACH DRIVE.

#### TRAFFIC

TRAFFIC IS TO REMAIN IN THE EXISTING CONFIGURATION. TRAFFIC CONTROL SHALL BE IN ACCORDANCE WITH IDOT STANDARDS NO. 701601 AND 701701 WHEN APPLICABLE.

#### CODO DRIVE

#### CONSTRUCTION

WORK IN PRESTAGE 1 ON CODO DRIVE INCLUDES CONSTRUCTION OF TEMPORARY PAVEMENT ON THE WEST SIDE OF CODO DRIVE.

#### TRAFFIC

TRAFFIC IS TO REMAIN IN THE EXISTING CONFIGURATION. TRAFFIC CONTROL SHALL BE IN ACCORDANCE WITH IDOT STANDARDS NO. 701601 AND 701701 WHEN APPLICABLE.

# CEDAR ROAD

#### CONSTRUCTION

WORK IN PRESTAGE 1 ON CODO DRIVE INCLUDES CONSTRUCTION OF TEMPORARY PAVEMENT ON THE EAST SIDE OF CEDAR ROAD (STA. 1000+70 TO STA. 1016+51).

#### TRAFFIC

TRAFFIC IS TO REMAIN IN THE EXISTING CONFIGURATION. TRAFFIC CONTROL SHALL BE IN ACCORDANCE WITH IDOT STANDARDS NO. 701326. 701601 AND 701701 WHEN APPLICABLE.

#### MESSENGER CIRCLE

# CONSTRUCTION

WORK IN PRESTAGE 1 ON MESSENGER CIRCLE INCLUDES CONSTRUCTION OF TEMPORARY PAVEMENT ADJACENT TO BOTH RADIUS RETURNS ON MESSENGER CIRCLE NORTH OF IL ROUTE 7.

# TRAFFIC

TRAFFIC IS TO REMAIN IN THE EXISTING CONFIGURATION. TRAFFIC CONTROL SHALL BE IN ACCORDANCE WITH IDOT STANDARDS NO. 701601 AND 701701 WHEN APPLICABLE.

## MESSENGER BLVD.

#### CONSTRUCTION

WORK IN PRESTAGE 1 ON MESSENGER BLVD. INCLUDES CONSTRUCTION OF TEMPORARY PAVEMENT ADJACENT TO BOTH RADIUS RETURNS ON MESSENGER BLVD, REMOVAL OF EXISTING MEDIAN AND REPLACEMENT WITH TEMPORARY PAVEMENT ON MESSENGER BLVD.

# TRAFFIC

TRAFFIC IS TO REMAIN IN THE EXISTING CONFIGURATION. TRAFFIC CONTROL SHALL BE IN ACCORDANCE WITH IDOT STANDARDS NO. 701601 AND 701701 WHEN APPLICABLE.

#### STONEBRIDGE DRIVE

CONSTRUCTION

NO CONSTRUCTION ACTIVITY.

# TRAFFIC

TRAFFIC IS TO REMAIN IN THE EXISTING CONFIGURATION

#### PARKER ROAD

#### CONSTRUCTION

WORK IN PRESTAGE 1 ON PARKER ROAD INCLUDES CONSTRUCTION OF TEMPORARY PAVEMENT ON THE WEST SIDE OF PARKER ROAD (STA. 1491+31 TO STA. 1510+31).

#### TRAFFIC

TRAFFIC IS TO REMAIN IN THE EXISTING CONFIGURATION. TRAFFIC CONTROL SHALL BE IN ACCORDANCE WITH IDOT STANDARDS NO. 701326, 701601 AND 701701 WHEN APPLICABLE.

#### HIDDEN VALLEY TRAIL

#### CONSTRUCTION

WORK IN PRESTAGE 1 ON HIDDEN VALLEY TRAIL INCLUDES CONSTRUCTION OF TEMPORARY PAVEMENT ON THE WEST AND EAST SIDE OF HIDDEN VALLEY TRAIL. AND THE REMOVAL OF EXISTING MEDIAN AND REPLACEMENT WITH TEMPORARY PAVEMENT ON HIDDEN VALLEY TRAIL.

# TRAFFIC

TRAFFIC IS TO REMAIN IN THE EXISTING CONFIGURATION. TRAFFIC CONTROL SHALL BE IN ACCORDANCE WITH IDOT STANDARDS NO. 701601 AND 701701 WHEN APPLICABLE.

# ANNICO DRIVE

CONSTRUCTION NO CONSTRUCTION ACTIVITY. TRAFFIC TRAFFIC IS TO REMAIN IN THE EXISTING CONFIGURATION

#### OAK VALLEY TRAIL

CONSTRUCTION NO CONSTRUCTION ACTIVITY.

# TRAFFIC

TRAFFIC IS TO REMAIN IN THE EXISTING CONFIGURATION

#### NORTH BELL ROAD

CONSTRUCTION

WORK IN PRESTAGE 1 ON NORTH BELL ROAD INCLUDES CONSTRUCTION OF TEMPORARY PAVEMENT ON WEST SIDE OF NORTH BELL ROAD (STA. 2010+00 TO 2012+67) AND A TEMPORARY PAVEMENT ROAD LIFT ON IL ROUTE 7 (STA. 221+40 TO STA. 225+10)

### TRAFFIC

TRAFFIC IS TO REMAIN IN THE EXISTING CONFIGURATION. TRAFFIC CONTROL SHALL BE IN ACCORDANCE WITH IDOT STANDARDS NO. 701601 AND 701701 WHEN APPLICABLE

#### SOUTH BELL ROAD

CONSTRUCTION TRAFFIC

### CRYSTAL CREEK DRIVE

CONSTRUCTION TRAFFIC

# TWIN LAKES DRIVE

CONSTRUCTION NO CONSTRUCTION ACTIVITY. TRAFFIC

# WILL-COOK ROAD

CONSTRUCTION

TRAFFIC

	USER NAME = mmaestra	DESIGNED NAV	REVISED -		MAINTENANCE OF TRAFFIC Suggested construction sequencing		F.A.P. RTE.	SECTION	COUNTY	TOTAL SHEET SHEETS NO.
		DRAWN NAV	REVISED -	STATE OF ILLINOIS			351	536-R-1	WILL	1232 128
	PLOT SCALE = 1:4.00004	CHECKED PJO	REVISED -	DEPARTMENT OF TRANSPORTATION	DEPARTMENT OF TRANSPORTATION SUGGESTED CONSTRUCTION SEQUENCING	SUGGESTED CONSTRUCTION SEQUENCING			CONTRACT	NO. 60L71
PL	PLOT DATE = 8/15/2014	DATE 8/15/2014	REVISED -		SCALE: NONE	SHEET NO. 1 OF 7 SHEETS STA. TO STA.		ILLINOIS FED.	AID PROJECT	

WORK IN PRESTAGE 1 ON SOUTH BELL ROAD INCLUDES CONSTRUCTION OF TEMPORARY PAVEMENT ON THE EAST SIDE OF SOUTH BELL ROAD (STA. 2496+75 TO STA. 2499+20)

TRAFFIC IS TO REMAIN IN THE EXISTING CONFIGURATION. TRAFFIC CONTROL SHALL BE IN ACCORDANCE WITH IDOT STANDARDS NO. 701601 AND 701701 WHEN APPLICABLE.

WORK IN PRESTAGE 1 ON CRYSTAL CREEK DRIVE INCLUDES CONSTRUCTION OF TEMPORARY PAVEMENT ON THE WEST SIDE OF CRYSTAL CREEK DRIVE.

TRAFFIC IS TO REMAIN IN THE EXISTING CONFIGURATION. TRAFFIC CONTROL SHALL BE IN ACCORDANCE WITH IDOT STANDARDS NO. 701601 AND 701701 WHEN APPLICABLE.

TRAFFIC IS TO REMAIN IN THE EXISTING CONFIGURATION

WORK IN PRESTAGE 1 ON WILL-COOK ROAD INCLUDES CONSTRUCTION OF TEMPORARY PAVEMENT ON THE WEST SIDE OF WILL-COOK ROAD (STA. 2993+25 TO 3003+06) AND ON THE EAST SIDE OF WILL-COOK ROAD (STA. 3001+00 RO STA. 3005+75)

TRAFFIC IS TO REMAIN IN THE EXISTING CONFIGURATION. TRAFFIC CONTROL SHALL BE IN ACCORDANCE WITH IDOT STANDARDS NO. 701326, 701601 AND 701701 WHEN APPLICABLE.

# STAGE 1

#### IL ROUTE 7

#### CONSTRUCTION

WORK IN STAGE 1 INCLUDES CONSTRUCTION OF THE FOLLOWING: RECONFIGURATION OF TRAFFIC SIGNALS, EASTBOUND PROPOSED PAVEMENT, AND TEMPORARY PAVEMENT ADJACENT TO EASTBOUND PROPOSED PAVEMENT AT VARIOUS LOCATIONS

WORK IN STAGE 1 INCLUDES CONSTRUCTION OF THE PILE-SUPPORTED SLABS AT TWO LOCATIONS ON THE SOUTH SIDE OF IL ROUTE 7.

#### DRAINAGE

DRAINAGE WORK IN STAGE 1 INCLUDES CONSTRUCTION OF THE STORM SEWER MAIN DRAIN, LATERALS, BOX CULVERTS AND DITCHES ON THE SOUTH SIDE OF IL ROUTE 7. CROSS-CULVERTS AND STORM SEWERS SHOWN ON THE EROSION CONTROL PLANS ARE TO BE FULLY CONSTRUCTED ACROSS THE ENTIRE ROADWAY USING A SINGLE LANE NIGHT TIME CLOSURE. INCLUDES CONSTRUCTION OF DETENTION POND NO.2 ON THE NORTH SIDE OF IL ROUTE 7 FROM STATION 259+62 TO STATION 261+77.

#### TRAFFIC

PROVIDE ONE THROUGH LANE IN EACH DIRECTION AND TURN LANE AT EACH INTERSECTION WHERE AN EXISTING LEFT TURN LANE WAS PRESENT ON IL ROUTE 7. TRAVEL LANES WILL BE ON THE NORTH SIDE OF IL ROUTE 7, UTILIZING EXISTING PAVEMENT AND TEMPORARY PAVEMENT FROM PRESTAGE 1.

#### WINDMILL DRIVE

#### CONSTRUCTION

WORK IN STAGE 1 INCLUDES CONSTRUCTION OF PROPOSED PAVEMENT IN NORTHBOUND AND SOUTHBOUND TRAVEL LANES OF WINDMILL DRIVE.

#### TRAFFIC

PROVIDE ONE THROUGH LANES IN EACH DIRECTION. TRAVEL LANES SPLIT SUCH THAT ONE TRAVEL LANE WILL BE ON EACH SIDE OF THE WORKZONE, UTILIZING EXISTING PAVEMENT AND TEMPORARY PAVEMENT

#### LEACH DRIVE

#### CONSTRUCTION

WORK IN STAGE 1 INCLUDES CONSTRUCTION OF PROPOSED PAVEMENT OF THE NORTHBOUND LANE OF LEACH DRIVE.

#### TRAFFIC

PROVIDE ONE THROUGH LANE IN EACH DIRECTION. TRAVEL LANES SHIFT TO THE WEST SIDE OF LEACH DRIVE, UTILIZING EXISTING PAVEMENT AND TEMPORARY PAVEMENT.

#### CODO DRIVE

#### CONSTRUCTION

WORK IN STAGE 1 INCLUDES CONSTRUCTION OF PROPOSED PAVEMENT OF THE NORTHBOUND LANE OF CODO DRIVE.

#### TRAFFIC

PROVIDE ONE THROUGH LANE IN EACH DIRECTION. TRAVEL LANES SHIFT TO THE WEST SIDE OF CODO DRIVE, UTILIZING EXISTING PAVEMENT AND TEMPORARY PAVEMENT.

#### CEDAR ROAD

#### CONSTRUCTION

WORK IN STAGE 1 INCLUDES CONSTRUCTION OF THE PROPOSED SOUTHBOUND TRAVEL LANES AND THE SOUTHBOUND LEFT TURN LANE ONTO IL ROUTE 7 ON CEDAR ROAD: CONSTRUCTION OF TEMPORARY PAVEMENT ON THE WEST SIDE OF CEDAR ROAD (STA. 1010+17 TO 1016+02); AND THE PROPOSED PAVEMENT AT THE SOUTHWEST RADIUS RETURN TO MEET PROPOSED PAVEMENT ON IL ROUTE 7.

#### TRAFFIC

PROVIDE ONE THROUGH LANE IN EACH DIRECTION. TRAVEL LANES SHIFT TO THE EAST SIDE OF CEDAR ROAD, UTILIZING EXISTING AND TEMPORARY PAVEMENT.

MESSENGER BLVD/ ANNICO DRIVE/ TWIN LAKES DRIVE

CONSTRUCTION

NO CONSTRUCTION ACTIVITY.

#### TRAFFIC

TRAFFIC IS TO REMAIN IN THE EXISTING CONFIGURATION.

#### MESSENGER CIRCLE

#### CONSTRUCTION

WORK IN STAGE 1 INCLUDES CONSTRUCTION OF PROPOSED PAVEMENT OF THE OUTSIDE TRAVEL LANES ON MESSENGER CIRCLE SOUTH OF IL ROUTE 7.

#### TRAFFIC

PROVIDE ONE THROUGH LANE IN EACH DIRECTION. ON MESSENGER CIRCLE SOUTH OF IL ROUTE TRAVEL LANES SHIFT TO THE INSIDE EXISTING TRAVEL LANES, UTILIZING EXISTING PAVEMENT 7. TRAFFIC REMAINS IN NORMAL CONFIGURATION ON MESSENGER CIRCLE NORTH OF IL ROUTE 7.

#### STONEBRIDGE DRIVE

CONSTRUCTION

WORK IN STAGE 1 INCLUDES CONSTRUCTION OF THE SOUTHBOUND PROPOSED PAVEMENT ON STONEBRIDGE DRIVE.

#### TRAFFIC

PROVIDE ONE THROUGH LANE IN EACH DIRECTION. TRAVEL LANES SHIFT TO THE EAST SIDE OF STONEBRIDGE DRIVE, UTILIZING EXISTING PAVEMENT.

#### PARKER ROAD

CONSTRUCTION

WORK IN STAGE 1 ON PARKER ROAD INCLUDES CONSTRUCTION OF TEMPORARY PAVEMENT ON THE EAST SIDE OF PARKER ROAD (STA. 1504+68 TO STA. 1509+69)

#### TRAFFIC

PROVIDE ONE THROUGH LANE IN EACH DIRECTION. TRAVEL LANES SPLIT AND SHIFT TO THE WEST SIDE OF PARKER ROAD, UTILIZING EXISTING AND TEMPORARY PAVEMENT.

#### **HIDDEN VALLEY TRAIL**

CONSTRUCTION

WORK IN STAGE 1 INCLUDES CONSTRUCTION OF THE SOUTHBOUND AND NORTHBOUND TRAVEL LANES PROPOSED PAVEMENT ON HIDDEN VALLEY TRAIL.

# TRAFFIC

PROVIDE ONE THROUGH LANE IN EACH DIRECTION. TRAVEL LANES SPLIT AND SHIFT TO THE OUTSIDES OF THE WORK ZONE. UTILIZING TEMPORARY PAVEMENT.

#### OAK VALLEY TRAIL

CONSTRUCTION

WORK IN STAGE 1 INCLUDES COMPLETE CONSTRUCTION OF OAK VALLEY TRAIL. TRAFFIC ACCESS TO IL ROUTE 7 WILL BE CLOSED. SEE DETOUR PLAN.

# NORTH BELL ROAD

CONSTRUCTION NO CONSTRUCTION ACTIVITY. TRAFFIC

TRAFFIC IS TO REMAIN IN EXISTING CONFIGURATION.

# SOUTH BELL ROAD

CONSTRUCTION

NO CONSTRUCTION ACTIVITY.

TRAFFIC

PROVIDE ONE THROUGH LANE IN EACH DIRECTION. TRAVEL LANES SHIFT TO THE EAST SIDE OF SOUTH BELL, UTILIZING EXISTING AND TEMPORARY PAVEMENT.

# CRYSTAL CREEK DRIVE

CONSTRUCTION

WORK IN STAGE 1 INCLUDES CONSTRUCTION OF THE NORTHBOUND PROPOSED PAVEMENT ON CRYSTAL CREEK DRIVE.

PROVIDE ONE THROUGH LANE IN EACH DIRECTION. TRAVEL LANES SHIFT TO THE WEST SIDE OF CRYSTAL CREEK DRIVE, UTILIZING EXISTING AND TEMPORARY PAVEMENT

#### WILL-COOK ROAD

CONSTRUCTION NO CONSTRUCTION ACTIVITY. TRAFFIC PROVIDE ONE THROUGH LANE IN EACH DIRECTION. TRAVEL LANES SHIFT TO THE WEST SIDE OF WILL COOK ROAD, UTILIZING EXISTING AND TEMPORARY PAVEMENT.

# **STAGE 1A**

IL ROUTE 7 CONSTRUCTION SEE STAGE 1. TRAFFIC SEE STAGE 1.

# WINDMILL DRIVE

CONSTRUCTION WINDMILL DRIVE. TRAFFIC

#### LEACH DRIVE

CONSTRUCTION LEACH DRIVE. TRAFFIC

#### CODO DRIVE

CONSTRUCTION CODO DRIVE.

TRAFFIC

### CEDAR ROAD

CONSTRUCTION

TRAFFIC

### MESSENGER CIRCLE

CONSTRUCTION EXISTING MEDIAN TRAFFIC

CONSTRUCTION TRAFFIC

USER NAME = mmaestra	DESIGNED NAV	REVISED -		MAINTENANCE OF TRAFFIC SUGGESTED CONSTRUCTION SEQUENCING		F.A.P. RTE.	SECTION	COUNTY	TOTAL SHEET
	DRAWN NAV	REVISED -	STATE OF ILLINOIS			351	536-R-1	WILL 1	1232 129
PLOT SCALE = 1:4.00004		REVISED -	DEPARTMENT OF TRANSPORTATION			_		CONTRACT	NO. 60L71
PLOT DATE = 8/15/2014	DATE 8/15/2014	REVISED -		SCALE: NONE	SHEET NO. 2 OF 7 SHEETS STA. TO STA.		ILLINOIS FED.	AID PROJECT	

WORK IN STAGE 1A INCLUDES CONSTRUCTION OF PROPOSED PAVEMENT AT THE RADIUS RETURNS OF WINDMILL DRIVE TO MEET PROPOSED PAVEMENT ON IL ROUTE 7 AND THE B6-12 CURB AND GUTTER ON

PROVIDE ONE THROUGH LANES IN EACH DIRECTION. TRAVEL LANES RETURN TO THEIR NORMAL CONFIGURATION, UTILIZING PROPOSED PAVEMENT FROM STAGE 1.

WORK IN STAGE 1A INCLUDES CONSTRUCTION OF PROPOSED PAVEMENT OF THE SOUTHBOUND LANE OF

PROVIDE ONE THROUGH LANE IN EACH DIRECTION. TRAVEL LANES RETURN TO THEIR NORMAL CONFIGURATION. UTILIZING PROPOSED PAVEMENT FROM STAGE 1.

WORK IN STAGE 1A INCLUDES CONSTRUCTION OF PROPOSED PAVEMENT OF THE SOUTHBOUND LANE OF

PROVIDE ONE THROUGH LANE IN EACH DIRECTION. TRAVEL LANES SPLIT AND SHIFT TO EITHER SIDE OF THE WORK ZONE, UTILIZING TEMPORARY PAVEMENT ON THE WEST SIDE, AND PROPOSED PAVEMENT FROM STAGE 1 ON THE EAST SIDE.

WORK IN STAGE 1A INCLUDES CONSTRUCTION OF THE PROPOSED LEFT TURN LANES ON THE SOUTH LEG OF CEDAR ROAD, THE NORTHBOUND LEFT TURN LANE ONTO IL ROUTE 7 ON CEDAR ROAD, AND THE PROPOSED PAVEMENT OF THE NORTHBOUND INSIDE TRAVEL LANE ON THE NORTH LEG OF CEDAR ROAD.

PROVIDE ONE THROUGH LANE IN EACH DIRECTION. TRAVEL LANES SHIFT SPLIT AND SHIFT TO EITHER SIDE OF THE WORK ZONE, UTILIZING EXISTING AND TEMPORARY PAVEMENT ON THE EAST SIDE, AND PROPOSED PAVEMENT FROM STAGE 1 ON THE WEST SIDE.

WORK IN STAGE 1A INCLUDES CONSTRUCTION OF PROPOSED PAVEMENT OF THE INSIDE TRAVEL LANES ON MESSENGER CIRCLE SOUTH OF IL ROUTE 7 AND REPLACEMENT OF CURB AND GUTTER OF THE

PROVIDE ONE THROUGH LANE IN EACH DIRECTION. ON MESSENGER CIRCLE SOUTH OF IL ROUTE 7 TRAVEL LANES SHIFT TO THE OUTSIDE PROPOSED TRAVEL LANES, UTILIZING PROPOSED PAVEMENT FROM STAGE 1. TRAFFIC REMAINS IN NORMAL CONFIGURATION ON MESSENGER CIRCLE NORTH OF IL ROUTE 7.

#### STONEBRIDGE DRIVE

WORK IN STAGE 1A INCLUDES CONSTRUCTION OF THE NORTHBOUND OUTSIDE TRAVEL LANE PROPOSED PAVEMENT ON STONEBRIDGE DRIVE.

PROVIDE ONE THROUGH LANE IN EACH DIRECTION. THE SOUTHBOUND TRAVEL LANE RETURNS TO NORMAL CONFIGURATION, UTILIZING PROPOSED PAVEMENT FROM STAGE 1. THE NORTHBOUND TRAVEL LANE SHIFTS TO THE WEST, UTILIZING EXISTING PAVEMENT.

# MESSENGER BLVD/ ANNICO DRIVE/ TWIN LAKES DRIVE

CONSTRUCTION

## NO CONSTRUCTION ACTIVITY.

TRAFFIC

TRAFFIC IS TO REMAIN IN THE EXISTING CONFIGURATION.

# PARKER ROAD

#### CONSTRUCTION

WORK IN STAGE 1A INCLUDES CONSTRUCTION PROPOSED PAVEMENT OF THE NORTHBOUND TRAVEL LANE AND LEFT TURN LANES ON TO IL ROUTE 7 ON PARKER ROAD.

#### TRAFFIC

PROVIDE ONE THROUGH LANE IN EACH DIRECTION. TRAVEL LANES SPLIT AND SHIFT TO THE WEST OF PARKER ROAD, UTILIZING TEMPORARY AND EXISTING PAVEMENT.

#### HIDDEN VALLEY TRAIL

#### CONSTRUCTION

WORK IN STAGE 1A INCLUDES CONSTRUCTION OF PROPOSED PAVEMENT AT THE RADIUS RETURNS OF HIDDEN VALLEY TRAIL TO MEET PROPOSED PAVEMENT ON IL ROUTE 7 AND THE B-6.12 CURB AND GUTTER ON HIDDEN VALLEY TRAIL

### TRAFFIC

PROVIDE ONE THROUGH LANE IN EACH DIRECTION. TRAVEL LANES RETURN TO EXISTING CONFIGURATION.

#### OAK VALLEY TRAIL

CONSTRUCTION SEE STAGE 1. TRAFFIC

SEE STAGE 1.

### NORTH BELL ROAD

CONSTRUCTION

NO CONSTRUCTION ACTIVITY.

#### TRAFFIC

TRAFFIC IS TO REMAIN IN EXISTING CONFIGURATION

#### SOUTH BELL ROAD

#### CONSTRUCTION

WORK IN STAGE 1A INCLUDES CONSTRUCTION OF THE SOUTHBOUND PROPOSED PAVEMENT ON SOUTH BELL ROAD

#### TRAFFIC

PROVIDE ONE SOUTHBOUND THROUGH LANE, A LEFT TURN LANE ON TO IL ROUTE 7, AND A RIGHT TURN LANE ON TO IL ROUTE 7. TRAVEL LANES SHIFT TO THE EAST OF SOUTH BELL ROAD UTILIZING EXISTING AND TEMPORARY PAVEMENT.

#### CRYSTAL CREEK DRIVE

#### CONSTRUCTION

WORK IN STAGE 1A INCLUDES CONSTRUCTION OF THE SOUTHBOUND PROPOSED PAVEMENT ON CRYSTAL CREEK DRIVE.

#### TRAFFIC

PROVIDE ONE THROUGH LANE IN EACH DIRECTION. TRAVEL LANES SPLIT AND SHIFT TO EITHER SIDE OF THE WORK ZONE, UTILIZING TEMPORARY PAVEMENT ON THE WEST SIDE, AND PROPOSED PAVEMENT FROM STAGE 1 ON THE EAST SIDE.

#### WILL-COOK ROAD

#### CONSTRUCTION

WORK IN STAGE 1A INCLUDES CONSTRUCTION PROPOSED PAVEMENT OF THE NORTHBOUND TRAVEL LANE AND RIGHT TURN LANE ON TO IL ROUTE 7 ON WILL-COOK ROAD SOUTH OF IL ROUTE 7.

#### TRAFFIC

PROVIDE ONE THROUGH LANE IN EACH DIRECTION AND A LEFT TURN LANE ON TO IL ROUTE 7. TRAVEL LANES SHIFT TO THE WEST OF WILL-COOK ROAD, UTILIZING TEMPORARY AND EXISTING PAVEMENT.

CHECKED PJO

8/15/2014

REVISED

DATE

USER NAME = mmaestra

PLOT SCALE = 1:4.0000

PLOT DATE = 8/15/2014

# **STAGE 1B**

IL ROUTE 7 CONSTRUCTION SEE STAGE 1. TRAFFIC SEE STAGE 1.

#### WINDMILL DRIVE

CONSTRUCTION SEE STAGE 1A. TRAFFIC SEE STAGE 1A.

#### LEACH DRIVE

CONSTRUCTION SEE STAGE 1A. TRAFFIC SEE STAGE 1A.

# CODO DRIVE

#### CONSTRUCTION

WORK IN STAGE 1B INCLUDES CONSTRUCTION OF PROPOSED PAVEMENT AT THE RADIUS RETURN OF THE SOUTHBOUND LANE OF CODO DRIVE TO MEET PROPOSED PAVEMENT ON IL ROUTE 7, AND THE B-6.12 CURB AND GUTTER ON THE WEST SIDE OF CODO DRIVE.

# TRAFFIC

PROVIDE ONE THROUGH LANE IN EACH DIRECTION. TRAVEL LANES RETURN TO THEIR NORMAL CONFIGURATION, UTILIZING PROPOSED PAVEMENT FROM STAGES 1 AND 1A.

#### CEDAR ROAD

#### CONSTRUCTION

# WORK IN STAGE 1B INCLUDES CONSTRUCTION OF THE PROPOSED NORTHBOUND OUTSIDE TRAVEL LANES ON CEDAR ROAD, AND THE PROPOSED PAVEMENT AT THE SOUTHEAST RADIUS RETURN TO MEET PROPOSED PAVEMENT ON IL ROUTE 7.

# TRAFFIC

PROVIDE ONE THROUGH LANE IN EACH DIRECTION. TRAVEL LANES SHIFT TO THE WEST SIDE OF CEDAR DRIVE, UTILIZING PROPOSED PAVEMENT FROM STAGES 1 AND 1A.

#### MESSENGER CIRCLE

CONSTRUCTION

SEE STAGE 1A.

TRAFFIC

SEE STAGE 1A.

# STONEBRIDGE DRIVE

### CONSTRUCTION

WORK IN STAGE 1B INCLUDES CONSTRUCTION OF THE NORTHBOUND INSIDE TRAVEL LANE PROPOSED PAVEMENT ON STONEBRIDGE DRIVE.

#### TRAFFIC

PROVIDE ONE THROUGH LANE IN EACH DIRECTION. THE SOUTHBOUND TRAVEL LANE RETURNS TO NORMAL CONFIGURATION, UTILIZING PROPOSED PAVEMENT FROM STAGE 1. THE NORTHBOUND TRAVEL LANE SHIFTS TO THE EAST, UTILIZING PROPOSED PAVEMENT FROM STAGE1A.

MESSENGER BLVD/ ANNICO DRIVE/ TWIN LAKES DRIVE

CONSTRUCTION NO CONSTRUCTION ACTIVITY. TRAFFIC TRAFFIC IS TO REMAIN IN THE EXISTING CONFIGURATION

DESIGNED NAV REVISED MAINTENANCE OF DRAWN NAV REVISED STATE OF ILLINOIS SUGGESTED CONSTRUCTIO REVISED **DEPARTMENT OF TRANSPORTATION** 

PARKER ROAD CONSTRUCTION LANE ON PARKER ROAD. TRAFFIC

#### **HIDDEN VALLEY TRAIL**

CONSTRUCTION SEE STAGE 1A. TRAFFIC SEE STAGE 1A.

OAK VALLEY TRAIL CONSTRUCTION SEE STAGE 1.

TRAFFIC SEE STAGE 1.

# NORTH BELL ROAD

CONSTRUCTION NO CONSTRUCTION ACTIVITY. TRAFFIC

# SOUTH BELL ROAD

CONSTRUCTION SOUTH BELL ROAD TRAFFIC

#### CRYSTAL CREEK DRIVE

CONSTRUCTION

TRAFFIC TRAFFIC LANES RETURN TO THE EXISTING CONFIGURATION.

#### WILL-COOK ROAD

CONSTRUCTION ROUTE 7. TRAFFIC

SHEET NO. 3 OF 7 SHEETS

SCALE: NONE

WORK IN STAGE 1B INCLUDES CONSTRUCTION PROPOSED PAVEMENT OF THE SOUTHBOUND THROUGH

PROVIDE ONE THROUGH LANE IN EACH DIRECTION. TRAVEL LANES SPLIT AND SHIFT TO EITHER SIDE OF THE WORK ZONE, UTILIZING TEMPORARY AND EXISTING PAVEMENT ON THE WEST SIDE AND PROPOSED PAVEMENT FROM STAGE 1A ON THE EAST SIDE.

TRAFFIC IS TO REMAIN IN EXISTING CONFIGURATION

WORK IN STAGE 1B INCLUDES CONSTRUCTION OF THE PAINTED MEDIAN PROPOSED PAVEMENT ON

PROVIDE ONE SOUTHBOUND THROUGH LANE, A LEFT TURN LANE ONTO IL ROUTE 7, AND A RIGHT TURN LANE ONTO IL ROUTE 7. SOUTHBOUND TRAVEL LANE RETURNS TO NORMAL CONFIGURATION, UTILIZING PROPOSED PAVEMENT FROM STAGE 1A. NORTH BOUND TRAVEL LANES SHIFT TO THE EAST OF SOUTH BELL ROAD UTILIZING EXISTING AND TEMPORARY PAVEMENT.

WORK IN STAGE 1B INCLUDES CONSTRUCTION OF PROPOSED PAVEMENT AT THE RADIUS RETURN OF SOUTHBOUND CRYSTAL CREEK DRIVE TO MEET PROPOSED PAVEMENT ON IL ROUTE 7 AND THE B-6.12 CURB AND GUTTER ON SOUTHBOUND CRYSTAL CREEK DRIVE.

WORK IN STAGE 1B INCLUDES CONSTRUCTION OF THE REMAINING PROPOSED PAVEMENT (SOUTHBOUND LANE AND LEFT TURN LANE ON TO IL ROUTE 7) OF THE WILL-COOK ROAD SOUTH OF IL

PROVIDE ONE THROUGH LANE IN EACH DIRECTION AND A LEFT TURN LANE ONTO IL ROUTE 7. TRAVEL LANES SHIFT TO THE EAST OF WILL-COOK ROAD, PROPOSED PAVEMENT FROM STAGE 1A.

: 1	<b>FRAFFIC</b>		F.A.P. RTE.	SECTION	COUNTY	TOTAL SHEETS	SHEET NO.				
			351	536-R-1	WILL	WILL 1232					
	1 SEUDEIN				CONTRACT NO. 60L71						
S	STA.	TO STA.		ILLINOIS FED. AID PROJECT							

# STAGE 1D

		IL ROUTE 7
STAGE 1C	PARKER ROAD	CONSTRUCTION
IL ROUTE 7	CONSTRUCTION	SEE STAGE 1.
CONSTRUCTION	WORK IN STAGE 1C INCLUDES COMPLETING ALL CONSTRUCTION FROM EDGE OF PAVEMENT ON THE	TRAFFIC
SEE STAGE 1.	WEST SIDE OF PARKER TO THE PROPOSED R.O.W AND REMAINING PROPOSED PAVEMENT AT THE SOUTHWEST RADIUS TO MEET PROPOSED PAVEMENT ON IL ROUTE 7.	SEE STAGE 1.
TRAFFIC	TRAFFIC	
SEE STAGE 1.	PROVIDE ONE THROUGH LANE IN EACH DIRECTION. TRAVEL LANES RETURN TO NORMAL	WINDMILL DRIVE
SEE STAGE 1.	CONFIGURATION.	CONSTRUCTION
WINDMILL DRIVE		SEE STAGE 1A.
CONSTRUCTION	HIDDEN VALLEY TRAIL	TRAFFIC
SEE STAGE 1A.	CONSTRUCTION	SEE STAGE 1A.
TRAFFIC	SEE STAGE 1A.	
SEE STAGE 1A.	TRAFFIC	LEACH DRIVE
	SEE STAGE 1A.	CONSTRUCTION
LEACH DRIVE	OAK VALLEY TRAIL	SEE STAGE 1A.
CONSTRUCTION	CONSTRUCTION	TRAFFIC
SEE STAGE 1A.		SEE STAGE 1A.
TRAFFIC	SEE STAGE 1.	CODO DRIVE
SEE STAGE 1A.	TRAFFIC	
	SEE STAGE 1.	CONSTRUCTION
<u>CODO DRIVE</u>	NORTH BELL ROAD	SEE STAGE 1B.
CONSTRUCTION	CONSTRUCTION	TRAFFIC
SEE STAGE 1B.	NO CONSTRUCTION ACTIVITY.	SEE STAGE 1B.
TRAFFIC	TRAFFIC	CEDAR ROAD
SEE STAGE 1B.	TRAFFIC IS TO REMAIN IN EXISTING CONFIGURATION.	CONSTRUCTION
CEDAR ROAD		SEE STAGE 1B.
CONSTRUCTION	SOUTH BELL ROAD	TRAFFIC
SEE STAGE 1B.	CONSTRUCTION	SEE STAGE 1B.
TRAFFIC	WORK IN STAGE 1C INCLUDES CONSTRUCTION OF THE NORTHBOUND LEFT TURN LANE PROPOSED	
SEE STAGE 1B.	PAVEMENT ON SOUTH BELL ROAD.	MESSENGER CIRCLE
SEE STAGE IB.	TRAFFIC	CONSTRUCTION
MESSENGER CIRCLE	PROVIDE ONE SOUTHBOUND THROUGH LANE, A LEFT TURN LANE ONTO IL ROUTE 7, AND A RIGHT TURN LANE ONTO IL ROUTE 7. SOUTHBOUND TRAVEL LANE RETURNS TO NORMAL CONFIGURATION, UTILIZING	SEE STAGE 1A.
CONSTRUCTION	PROPOSED PAVEMENT FROM STAGE 1A. NORTH BOUND TRAVEL LANES SPLIT SHIFT TO EITHER SIDE OF	TRAFFIC
SEE STAGE 1A.	THE WORK ZONE. THE LEFT TURN LANE UTILIZES PAVEMENT FROM STAGE 1B AND THE RIGHT TURN LANE	SEE STAGE 1A.
TRAFFIC	UTILIZES EXISTING AND TEMPORARY PAVEMENT.	
SEE STAGE 1A.	CRYSTAL CREEK DRIVE	STONEBRIDGE DRIVE
	CONSTRUCTION	CONSTRUCTION
STONEBRIDGE DRIVE	SEE STAGE 1B.	SEE STAGE 1B.
CONSTRUCTION	TRAFFIC	TRAFFIC
SEE STAGE 1B.	SEE STAGE 1B.	SEE STAGE 1B.
TRAFFIC		
SEE STAGE 1B.	WILL-COOK ROAD	MESSENGER BLVD/ ANI
	CONSTRUCTION	CONSTRUCTION
MESSENGER BLVD/ ANNICO DRIVE/ TWIN LAKES DRIVE	SEE STAGE 1B.	NO CONSTRUCTION ACTIVIT
CONSTRUCTION	TRAFFIC	TRAFFIC
NO CONSTRUCTION ACTIVITY.	SEE STAGE 1B.	TRAFFIC IS TO REMAIN IN TH
TRAFFIC		PARKER ROAD
TRAFFIC IS TO REMAIN IN THE EXISTING CONFIGURATION.		CONSTRUCTION
		SEE STAGE 1C.
		0000000000

USER NAME = mmaestra DESIGNED NAV REVISED MAINTENANCE OF STATE OF ILLINOIS DRAWN NAV REVISED SUGGESTED CONSTRUCTIO PLOT SCALE = 1:4.00004 CHECKED PJO REVISED DEPARTMENT OF TRANSPORTATION PLOT DATE = 8/15/2014 DATE 8/15/2014 REVISED SCALE: NONE SHEET NO. 4 OF 7 SHEETS

# ANNICO DRIVE/ TWIN LAKES DRIVE

TIVITY.

*TRAFFIC* SEE STAGE 1C. IN THE EXISTING CONFIGURATION.

: 1	FRAFFIC		F.A.P. RTE.	F.A.P. RTE. SECTION COUNTY							
		NCINC	351	536-R-1	WILL	1232	131				
ON SEQUENCING					CONTRACT	NO. 6	0L71				
5	STA.	TO STA.		ILLINOIS FED. AID PROJECT							

#### HIDDEN VALLEY TRAIL

CONSTRUCTION SEE STAGE 1A TRAFFIC SEE STAGE 1A.

#### OAK VALLEY TRAIL

CONSTRUCTION SEE STAGE 1. TRAFFIC SEE STAGE 1.

#### NORTH BELL ROAD

CONSTRUCTION

NO CONSTRUCTION ACTIVITY. TRAFFIC

TRAFFIC IS TO REMAIN IN EXISTING CONFIGURATION.

### SOUTH BELL ROAD

#### CONSTRUCTION

WORK IN STAGE 1D INCLUDES CONSTRUCTION OF THE NORTHBOUND RIGHT TURN LANE PROPOSED PAVEMENT ON SOUTH BELL ROAD.

#### TRAFFIC

PROVIDE ONE SOUTHBOUND THROUGH LANE, A LEFT TURN LANE ON TO IL ROUTE 7, AND A RIGHT TURN LANE ON TO IL ROUTE 7. SOUTHBOUND TRAVEL LANE RETURNS TO NORMAL CONFIGURATION, UTILIZING PROPOSED PAVEMENT FROM STAGE 1A. NORTH BOUND TRAVEL LANES SHIFT TO THE WEST OF SOUTH BELL ROAD UTILIZING PROPOSED PAVEMENT FROM STAGE 1B AND 1C.

#### CRYSTAL CREEK DRIVE

CONSTRUCTION SEE STAGE 1B. TRAFFIC SEE STAGE 1B.

#### WILL-COOK ROAD

CONSTRUCTION SEE STAGE 1B. TRAFFIC SEE STAGE 1B.

#### STAGE 2

# IL ROUTE 7

CONSTRUCTION

WORK IN STAGE 2 INCLUDES CONSTRUCTION OF THE FOLLOWING: RECONFIGURATION OF TRAFFIC SIGNALS, AND WESTBOUND PROPOSED PAVEMENT

WORK IN STAGE 2 INCLUDES CONSTRUCTION OF THE PILE-SUPPORTED SLABS AT TWO LOCATIONS ON THE NORTH SIDE OF IL ROUTE 7.

#### DRAINAGE

DRAINAGE WORK IN STAGE 2 INCLUDES CONSTRUCTION OF THE STORM SEWER MAIN DRAIN, LATERALS, BOX CULVERTS AND DITCHES ON THE NORTH SIDE OF IL ROUTE 7.

#### TRAFFIC

PROVIDE ONE THROUGH LANE IN EACH DIRECTION AND TURN LANE AT EACH INTERSECTION WHERE AN EXISTING LEFT TURN LANE WAS PRESENT ON IL ROUTE 7. TRAVEL LANES WILL BE ON THE SOUTH SIDE OF IL ROUTE 7. UTILIZING PROPOSED PAVEMENT FROM STAGE 1.

WINDMILL DRIVE/ LEACH DRIVE/ CODO DRIVE/ STONEBRIDGE DRIVE/ HIDDEN VALLEY TRAIL/ OAK VALLEY TRAIL/ CRYSTAL CREEK DRIVE

CONSTRUCTION NO CONSTRUCTION ACTIVITY.

TRAFFIC

TRAFFIC IS TO REMAIN IN THE EXISTING CONFIGURATION

# CEDAR ROAD

# CONSTRUCTION

WORK IN STAGE 2 INCLUDES CONSTRUCTION OF THE REMAINING PROPOSED PAVEMENT OF THE NORTHWEST RADIUS RETURN TO MEET THE PROPOSED PAVEMENT ON IL ROUTE 7, THE REMAINING PROPOSED PAVEMENT OF THE SOUTHBOUND TRAVEL LANE (STA. 1010+10 TO 1016+00), AND THE PROPOSED PAVEMENT OF THE RADIUS RETURNS TO MEET THE EXISTING PAVEMENT ON CEDAR GLEN DRIVE.

#### TRAFFIC

PROVIDE ONE THROUGH LANE IN EACH DIRECTION. TRAVEL LANES SHIFT TO THE EAST SIDE OF CEDAR ROAD, UTILIZING PROPOSED PAVEMENT FROM STAGES 1A AND 1B.

### MESSENGER CIRCLE

CONSTRUCTION

#### WORK IN STAGE 2 INCLUDES CONSTRUCTION OF NORTHBOUND PROPOSED PAVEMENT ON MESSENGER CIRCLE NORTH OF IL ROUTE 7.

#### TRAFFIC

PROVIDE ONE THROUGH LANE IN EACH DIRECTION. ON MESSENGER CIRCLE NORTH OF IL ROUTE 7 TRAFFIC LANES SHIFT TO THE WEST OF MESSENGER CIRCLE, UTILIZING EXISTING AND TEMPORARY PAVEMENT. TRAFFIC REMAINS IN NORMAL CONFIGURATION ON MESSENGER CIRCLE SOUTH OF IL ROUTE 7.

#### MESSENGER BLVD.

#### CONSTRUCTION

WORK IN STAGE 2 INCLUDES CONSTRUCTION OF THE SOUTHBOUND AND NORTHBOUND INSIDE TRAVEL LANES PROPOSED PAVEMENT AND PROPOSED MEDIAN.

#### TRAFFIC

PROVIDE ONE THROUGH LANE IN EACH DIRECTION. TRAFFIC LANES SPLIT AND SHIFT TO EITHER SIDE OF THE WORK ZONE, UTILIZING EXISTING AND TEMPORARY PAVEMENT.

#### PARKER ROAD

CONSTRUCTION

NO CONSTRUCTION ACTIVITY.

#### TRAFFIC

PROVIDE ONE THROUGH LANE IN EACH DIRECTION. TRAVEL LANES SOUTH OF IL ROUTE 7 SPLIT AND SHIFT TO THE OUTSIDE LANES OF PARKER ROAD, UTILIZING PROPOSED PAVEMENT FROM STAGE 1. TRAVEL LANES NORTH OF IL ROUTE 7 SHIFT TO THE EAST OF PARKER ROAD, UTILIZING PROPOSED PAVEMENT FROM STAGE 1.

### ANNICO DRIVE

### CONSTRUCTION

WORK IN STAGE 2 INCLUDES CONSTRUCTION OF THE SOUTHBOUND PROPOSED PAVEMENT ON ANNICO DRIVE.

#### TRAFFIC

PROVIDE ONE THROUGH LANE IN EACH DIRECTION. TRAFFIC LANES SHIFT TO THE EAST SIDE OF ANNICO DRIVE, UTILIZING EXISTING AND TEMPORARY PAVEMENT

#### NORTH BELL ROAD

# CONSTRUCTION

NO CONSTRUCTION ACTIVITY.

# TRAFFIC

PROVIDE ONE LANE IN EACH DIRECTION. TRAFFIC LANES SHIFT TO THE WEST SIDE OF NORTH BELL ROAD, UTILIZING EXISTING AND TEMPORARY PAVEMENT.

#### SOUTH BELL ROAD

CONSTRUCTION NO CONSTRUCTION ACTIVITY.

TRAFFIC

TRAFFIC IS TO REMAIN IN THE EXISTING CONFIGURATION

# TWIN LAKES DRIVE

CONSTRUCTION WORK IN STAGE 2 INCLUDES CONSTRUCTION OF THE SOUTHBOUND PROPOSED PAVEMENT ON TWIN LAKES DRIVE.

#### TRAFFIC

PROVIDE ONE THROUGH LANE IN EACH DIRECTION. TRAFFIC LANES SHIFT TO THE EAST OF TWIN LAKES DRIVE, UTILIZING EXISTING PAVEMENT.

#### WILL-COOK ROAD

CONSTRUCTION NO CONSTRUCTION ACTIVITY. TRAFFIC

# STAGE 2A

### IL ROUTE 7

CONSTRUCTION SEE STAGE 2. TRAFFIC SEE STAGE 2

CONSTRUCTION NO CONSTRUCTION ACTIVITY. TRAFFIC

#### CEDAR ROAD

CONSTRUCTION

#### MESSENGER CIRCLE

CONSTRUCTION CIRCLE NORTH OF IL ROUTE 7.

TRAFFIC

#### MESSENGER BLVD.

CONSTRUCTION

TRAFFIC

#### PARKER ROAD

CONSTRUCTION

# TRAFFIC

FROM STAGE 1.

# ANNICO DRIVE

CONSTRUCTION ANNICO DRIVE.

TRAFFIC

USER NAME = mmaestra	DESIGNED NAV	REVISED -			MAINTENANCE OF TRAFFIC	F.A.P. RTE.	SECTION	COUNTY TO	OTAL SHEET
	DRAWN NAV	REVISED -	STATE OF ILLINOIS	SUGGESTED CONSTRUCTION SEQUENCING		351	536-R-1		1232 132
PLOT SCALE = 1:4.00004	CHECKED PJO	REVISED -	DEPARTMENT OF TRANSPORTATION					CONTRACT N	10. 60L71
PLOT DATE = 8/15/2014	DATE 8/15/2014	REVISED -	SCA	SCALE: NONE	SHEET NO. 5 OF 7 SHEETS STA. TO STA.		ILLINOIS FED. A	ID PROJECT	

PROVIDE ONE THROUGH LANE IN EACH DIRECTION AND A LEFT TURN LANE ONTO IL ROUTE 7. TRAVEL LANES SHIFT TO THE EAST SIDE OF WILL COOK ROAD, UTILIZING EXISTING PAVEMENT, PROPOSED PAVEMENT FROM STAGE 1, AND TEMPORARY PAVEMENT FROM STAGE 1.

# WINDMILL DRIVE/ LEACH DRIVE/ CODO DRIVE/ STONEBRIDGE DRIVE/ HIDDEN VALLEY TRAIL/ OAK VALLEY TRAIL/ CRYSTAL CREEK DRIVE

TRAFFIC IS TO REMAIN IN THE EXISTING CONFIGURATION.

WORK IN STAGE 2A INCLUDES CONSTRUCTION OF THE BARRIER MEDIAN ON THE SOUTH LEG OF CEDAR DRIVE, AND OF THE REMAINING PROPOSED PAVEMENT OF THE NORTHBOUND INSIDE TRAVEL LANE TO MEET THE PROPOSED PAVEMENT ON IL ROUTE 7

PROVIDE ONE THROUGH LANE IN EACH DIRECTION. TRAVEL LANES SHIFT SPLIT AND SHIFT TO EITHER SIDE OF THE WORK ZONE, UTILIZING PROPOSED PAVEMENT FROM STAGES 1, 1A, 1B AND 2.

WORK IN STAGE 2A INCLUDES CONSTRUCTION OF SOUTHBOUND PROPOSED PAVEMENT ON MESSENGER

PROVIDE ONE THROUGH LANE IN EACH DIRECTION. ON MESSENGER CIRCLE NORTH OF IL ROUTE 7 TRAFFIC LANES SHIFT TO THE EAST OF HILLER DRIVE, UTILIZING EXISTING AND TEMPORARY PAVEMENT. TRAFFIC REMAINS IN NORMAL CONFIGURATION ON MESSENGER CIRCLE SOUTH OF IL ROUTE 7.

WORK IN STAGE 2A INCLUDES CONSTRUCTION OF THE SOUTHBOUND AND NORTHBOUND OUTSIDE TRAVEL LANES PROPOSED PAVEMENT.

PROVIDE ONE THROUGH LANE IN EACH DIRECTION. TRAFFIC LANES SPLIT AND SHIFT TO EITHER SIDE OF THE PROPOSED MEDIAN, UTILIZING PROPOSED PAVEMENT FROM STAGE 2.

WORK IN STAGE 2A INCLUDES CONSTRUCTION OF NORTHWEST INTERSECTION PROPOSED PAVEMENT TO MEET PROPOSED PAVEMENT AT IL ROUTE 7 AND NORTH PARKER.

PROVIDE ONE THROUGH LANE IN EACH DIRECTION. TRAVEL LANES SOUTH OF IL ROUTE 7 SPLIT AND SHIFT TO THE OUTSIDE LANES OF PARKER ROAD, UTILIZING PROPOSED PAVEMENT FROM STAGE 1. TRAVEL LANES NORTH OF IL ROUTE 7 SHIFT TO THE EAST OF PARKER ROAD, UTILIZING PROPOSED PAVEMENT

WORK IN STAGE 2A INCLUDES CONSTRUCTION OF PROPOSED PAVEMENT IN THE CENTER LANE ON

PROVIDE ONE THROUGH LANE IN EACH DIRECTION. TRAFFIC LANES SPLIT AND SHIFT TO EITHER SIDE OF THE WORK ZONE, UTILIZING EXISTING PAVEMENT ON THE NORTHBOUND LANE AND PROPOSED PAVEMENT FROM STAGE 2 ON THE SOUTHBOUND LANE.

#### NORTH BELL ROAD

# CONSTRUCTION

WORK IN STAGE 2A INCLUDES CONSTRUCTION OF THE NORTHBOUND PROPOSED PAVEMENT ON NORTH BELL ROAD.

TRAFFIC

PROVIDE ONE LANE IN EACH DIRECTION. TRAFFIC LANES SHIFT TO THE WEST SIDE OF NORTH BELL ROAD, UTILIZING EXISTING AND TEMPORARY PAVEMENT.

#### SOUTH BELL ROAD

CONSTRUCTION NO CONSTRUCTION ACTIVITY. TRAFFIC

TRAFFIC IS TO REMAIN IN THE EXISTING CONFIGURATION

#### TWIN LAKES DRIVE

#### CONSTRUCTION

WORK IN STAGE 2A INCLUDES CONSTRUCTION OF THE NORTHBOUND PROPOSED PAVEMENT ON TWIN LAKES DRIVE.

#### TRAFFIC

PROVIDE ONE THROUGH LANE IN EACH DIRECTION. TRAFFIC LANES SHIFT TO THE WEST OF TWIN LAKES DRIVE, UTILIZING PROPOSED PAVEMENT FROM STAGE 2.

#### WILL-COOK ROAD

#### CONSTRUCTION

WORK IN STAGE 2A INCLUDES CONSTRUCTION THE SOUTHBOUND THROUGH LANE AND SOUTHBOUND LEFT TURN LANE ONTO IL ROUTE 7 PROPOSED PAVEMENT ON NORTH WILL-COOK.

#### TRAFFIC

PROVIDE ONE THROUGH LANE IN EACH DIRECTION AND A LEFT TURN LANE ONTO IL ROUTE 7. TRAVEL LANES SHIFT TO THE EAST SIDE OF WILL COOK ROAD, UTILIZING EXISTING PAVEMENT, PROPOSED PAVEMENT FROM STAGE 1. AND TEMPORARY PAVEMENT FROM STAGE 1.

# **STAGE 2B**

#### IL ROUTE 7

CONSTRUCTION SEE STAGE 2.

TRAFFIC

SEE STAGE 2.

### WINDMILL DRIVE/ LEACH DRIVE/ CODO DRIVE/ STONEBRIDGE DRIVE/ HIDDEN VALLEY TRAIL/ OAK VALLEY TRAIL/ CRYSTAL CREEK DRIVE

CONSTRUCTION

NO CONSTRUCTION ACTIVITY.

TRAFFIC

TRAFFIC IS TO REMAIN IN THE EXISTING CONFIGURATION

#### CEDAR ROAD

#### CONSTRUCTION

WORK IN STAGE 2B INCLUDES CONSTRUCTION OF THE PROPOSED PAVEMENT AT THE NORTHEAST RADIUS RETURN TO MEET PROPOSED PAVEMENT ON IL ROUTE 7.

#### TRAFFIC

PROVIDE ONE THROUGH LANE IN EACH DIRECTION. THE SOUTHBOUND TRAVEL LANE REMAINS ON THE WEST SIDE OF CEDAR ROAD, AND THE NORTHBOUND TRAVEL LANE SHIFTS TO THE ENTER OF CEDAR ROAD, UTILIZING PROPOSED PAVEMENT FROM THE FLUSH MEDIAN AND LEFT TURN LANE FROM STAGES 1A, 1B, 2, AND 2A.

#### MESSENGER CIRCLE

#### CONSTRUCTION

WORK IN STAGE 2B INCLUDES CONSTRUCTION OF REMAINING PROPOSED PAVEMENT ON MESSENGER CIRCLE NORTH OF IL ROUTE 7 AND PROPOSED MEDIAN.

#### TRAFFIC

PROVIDE ONE THROUGH LANE IN EACH DIRECTION. ON MESSENGER CIRCLE NORTH OF IL ROUTE 7 TRAFFIC LANES SPLIT AND SHIFT TO EITHER SIDE OF THE WORK ZONE, UTILIZING PROPOSED PAVEMENT FROM STAGES 2 AND 2A. TRAFFIC REMAINS IN NORMAL CONFIGURATION ON MESSENGER CIRCLE SOUTH OF IL ROUTE 7.

# MESSENGER BLVD.

CONSTRUCTION SEE STAGE 2A. TRAFFIC SEE STAGE 2A.

# PARKER ROAD

# CONSTRUCTION

WORK IN STAGE 2B INCLUDES CONSTRUCTION OF SOUTHBOUND LEFT TURN LANE PROPOSED PAVEMENT ON PARKER ROAD.

# TRAFFIC

PROVIDE ONE THROUGH LANE IN EACH DIRECTION. TRAVEL LANES SOUTH OF IL ROUTE 7 SPLIT AND SHIFT TO THE OUTSIDE LANES OF PARKER ROAD, UTILIZING PROPOSED PAVEMENT FROM STAGE 1. TRAVEL LANES NORTH OF IL ROUTE 7 SPLIT AND SHIFT TO EITHER SIDE OF THE WORKZONE, UTILIZING PROPOSED PAVEMENT FROM STAGE 1.

# ANNICO DRIVE

# CONSTRUCTION

WORK IN STAGE 2B INCLUDES CONSTRUCTION OF NORTHBOUND PROPOSED PAVEMENT ON ANNICO DRIVE.

# TRAFFIC

PROVIDE ONE THROUGH LANE IN EACH DIRECTION. TRAFFIC LANES SHIFT TO THE WEST SIDE OF ANNICO DRIVE, UTILIZING PROPOSED PAVEMENT FROM STAGE 2 AND 2A.

# NORTH BELL ROAD

CONSTRUCTION WORK IN STAGE 2B INCLUDES CONSTRUCTION OF THE SOUTHBOUND PROPOSED PAVEMENT ON NORTH BELL ROAD. TRAFFIC PROVIDE ONE LANE IN EACH DIRECTION. TRAFFIC LANES SHIFT TO THE EAST SIDE OF NORTH BELL ROAD. UTILIZING PROPOSED PAVEMENT FROM STAGE 2A.

# SOUTH BELL ROAD

CONSTRUCTION NO CONSTRUCTION ACTIVITY TRAFFIC TRAFFIC IS TO REMAIN IN THE EXISTING CONFIGURATION

### TWIN LAKES DRIVE

#### CONSTRUCTION

WORK IN STAGE 2B INCLUDES CONSTRUCTION OF REMAINING PROPOSED PAVEMENT ON TWIN LAKES DRIVE AND PROPOSED MEDIAN ON TWIN LAKES DRIVE.

# TRAFFIC

PROVIDE ONE THROUGH LANE IN EACH DIRECTION. TRAFFIC LANES SHIFT TO THE WEST OF TWIN LAKES DRIVE, UTILIZING PROPOSED PAVEMENT FROM STAGE 2.

#### WILL-COOK ROAD

CONSTRUCTION

WORK IN STAGE 2B INCLUDES CONSTRUCTION OF THE NORTHBOUND THROUGH LANE PROPOSED PAVEMENT ON NORTH WILL-COOK ROAD.

#### TRAFFIC

PROVIDE ONE THROUGH LANE IN FACH DIRECTION AND A LEFT TURN LANE ONTO IL ROUTE 7, TRAVEL LANES SPLIT AND SHIFT TO EITHER SIDE OF THE WORK ZONE. SOUTHBOUND LANES SHIFT TO THE WEST OF WILL-COOK ROAD UTILIZING PROPOSED PAVEMENT FROM STAGE 2A. THE NORTHBOUND THROUGH LANE SHIFTS TO THE EAST OF WILL-COOK ROAD, UTILIZING EXISTING AND TEMPORARY PAVEMENT.

# STAGE 2C

IL ROUTE 7 CONSTRUCTION SEE STAGE 2. TRAFFIC SEE STAGE 2.

# WINDMILL DRIVE/ LEACH DRIVE/ CODO DRIVE/ STONEBRIDGE DRIVE/ HIDDEN VALLEY TRAIL/ OAK VALLEY TRAIL/ CRYSTAL CREEK DRIVE

CONSTRUCTION NO CONSTRUCTION ACTIVITY. TRAFFIC TRAFFIC IS TO REMAIN IN THE EXISTING CONFIGURATION.

# CEDAR ROAD

CONSTRUCTION SEE STAGE 2B. TRAFFIC SEE STAGE 2B.

### MESSENGER CIRCLE

CONSTRUCTION SEE STAGE 2B. TRAFFIC SEE STAGE 2B.

# MESSENGER BLVD.

CONSTRUCTION SEE STAGE 2A. TRAFFIC SEE STAGE 2A.

# PARKER ROAD

CONSTRUCTION TRAFFIC

# ANNICO DRIVE

CONSTRUCTION SEE STAGE 2B. TRAFFIC SEE STAGE 2B.

# NORTH BELL ROAD

CONSTRUCTION TRAFFIC

# SOUTH BELL ROAD

CONSTRUCTION NO CONSTRUCTION ACTIVITY. TRAFFIC TRAFFIC IS TO REMAIN IN THE EXISTING CONFIGURATION.

# TWIN LAKES DRIVE

CONSTRUCTION SEE STAGE 2B. TRAFFIC SEE STAGE 2B.

	USER NAME = mmæestræ	DESIGNED NAV	REVISED -		MAINTENANCE OF TRAFFIC SUGGESTED CONSTRUCTION SEQUENCING		F.A.P. RTE.	SECTION	COUNTY	TOTAL SHEET SHEETS NO.		
		DRAWN NAV	REVISED -	STATE OF ILLINOIS			351	536-R-1	WILL	1232 133		
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	PLOT DATE = 8/15/2014	DATE 8/15/2014	REVISED -		SCALE: NONE	SHEET NO. 6 OF 7 SHEETS	STA.	TO STA.		ILLINOIS FED. A	ID PROJECT	

WORK IN STAGE 2C INCLUDES CONSTRUCTION OF THE NORTHWEST INTERSECTION PROPOSED PAVEMENT TO MEET PROPOSED PAVEMENT AT IL ROUTE 7 AND NORTH PARKER.

PROVIDE ONE THROUGH LANE IN EACH DIRECTION. TRAVEL LANES SHIFT TO THE WEST SIDE OF PARKER ROAD, UTILIZING PROPOSED PAVEMENT FROM STAGE 1.

WORK IN STAGE 2C INCLUDES CONSTRUCTION OF 15' X 15' SQUARE PAVEMENT PATCH AT THE INTERSECTION OF NORTH BELL ROAD AND IL ROUTE 7.

PROVIDE ONE NORTHBOUND LANE, A SOUTHBOUND RIGHT TURN LANE AND A SOUTHBOUND LEFT TURN THE NORTHBOUND TRAFFIC LANE RETURNS TO NORMAL CONFIGURATION. THE SOUTHBOUND TRAFFIC LANES SPLIT SHIFT TO EITHER SIDE OF THE WORK ZONE.

#### WILL-COOK ROAD

#### CONSTRUCTION

WORK IN STAGE 2C INCLUDES CONSTRUCTION OF THE REMAINING PROPOSED PAVEMENT AT THE NORTHEAST CORNER OF THE INTERSECTION AT IL ROUTE 7 AND PROPOSED CURB AND GUTTER ALONG THE SOUTHEAST EDGE OF WILL-COOK ROAD.

#### TRAFFIC

PROVIDE ONE THROUGH LANE IN EACH DIRECTION AND A LEFT TURN LANE ONTO IL ROUTE 7. TRAVEL LANES SHIFT TO THE WEST SIDE OF WILL-COOK ROAD, UTILIZING PROPOSED PAVEMENT.

# STAGE 2D

### <u>IL ROUTE 7</u>

CONSTRUCTION SEE STAGE 2. TRAFFIC SEE STAGE 2.

# WINDMILL DRIVE/ LEACH DRIVE/ CODO DRIVE/ STONEBRIDGE DRIVE/ HIDDEN VALLEY TRAIL/ OAK VALLEY TRAIL/ CRYSTAL CREEK DRIVE CONSTRUCTION

NO CONSTRUCTION ACTIVITY. *TRAFFIC* TRAFFIC IS TO REMAIN IN THE EXISTING CONFIGURATION.

# CEDAR ROAD

CONSTRUCTION SEE STAGE 2B. TRAFFIC SEE STAGE 2B.

# MESSENGER CIRCLE

CONSTRUCTION SEE STAGE 2B. TRAFFIC SEE STAGE 2B.

# MESSENGER BLVD.

CONSTRUCTION SEE STAGE 2A. TRAFFIC SEE STAGE 2A.

# PARKER ROAD

CONSTRUCTION SEE STAGE 2C. TRAFFIC SEE STAGE 2C.

# ANNICO DRIVE

CONSTRUCTION SEE STAGE 2B. TRAFFIC SEE STAGE 2B.

# NORTH BELL ROAD

# CONSTRUCTION

WORK IN STAGE 2D INCLUDES CONSTRUCTION OF REMAINING PROPOSED PAVEMENT ON NORTH BELL ROAD AND THE PROPOSED MEDIAN ON NORTH BELL ROAD.

TRAFFIC

PROVIDE ONE THROUGH LANE IN EACH DIRECTION. TRAVEL LANES WILL BE SPLIT AND SHIFTED ON EITHER SIDE OF THE WORKZONE, UTILIZING PROPOSED PAVEMENT FROM STAGES 2 AND 2A.

### SOUTH BELL ROAD

CONSTRUCTION NO CONSTRUCTION ACTIVITY. TRAFFIC TRAFFIC IS TO REMAIN IN THE EXISTING CONFIGURATION

# TWIN LAKES DRIVE

CONSTRUCTION SEE STAGE 2B. TRAFFIC SEE STAGE 2B.

### WILL-COOK ROAD

CONSTRUCTION SEE STAGE 2C. TRAFFIC SEE STAGE 2C.

# **STAGE 3**

<u>IL ROUTE 7</u>

CONSTRUCTION

WORK DURING STAGE 3 INCLUDES CONSTRUCTION OF THE PROPOSED BARRIER MEDIAN AND INSIDE LEFT TURN LANES IN LOCATIONS WHERE THERE ARE DUAL LEFT TURNS ON IL ROUTE 7.

# TRAFFIC

PROVIDE ONE THROUGH LANE IN EACH DIRECTION. THROUGH LANES WILL BE ON OUTSIDE PROPOSED TRAVEL LANES, UTILIZING PROPOSED PAVEMENT FROM STAGES 1 AND 2.

# WINDMILL DRIVE/ LEACH DRIVE/ CODO DRIVE/ MESSENGER CIRCLE/ STONEBRIDGE

DRIVE/ HIDDEN VALLEY TRAIL/ OAK VALLEY TRAIL/ CRYSTAL CREEK DRIVE CONSTRUCTION NO CONSTRUCTION ACTIVITY.

TRAFFIC

TRAFFIC IS TO REMAIN IN THE EXISTING CONFIGURATION.

MESSENGER CIRCLE/ MESSENGER BLVD/ ANNICO DRIVE/ TWIN LAKES DRIVE

CONSTRUCTION NO CONSTRUCTION ACTIVITY. TRAFFIC


TRAFFIC IS TO REMAIN IN THE EXISTING CONFIGURATION.

#### CEDAR ROAD/ PARKER ROAD/ NORTH BELL ROAD/ SOUTH BELL ROAD/ WILL-COOK


ROAD CONSTRUCTION NO CONSTRUCTION ACTIVITY. TRAFFIC

TRAFFIC IS TO REMAIN IN THE EXISTING CONFIGURATION.


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		DRAWN NAV	REVISED -	STATE OF ILLINOIS			351	536-R-1	WILL 1232 1
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	PLOT DATE = 8/15/2014	DATE 8/15/2014	REVISED -				ILLINOIS FED. AID PROJECT		

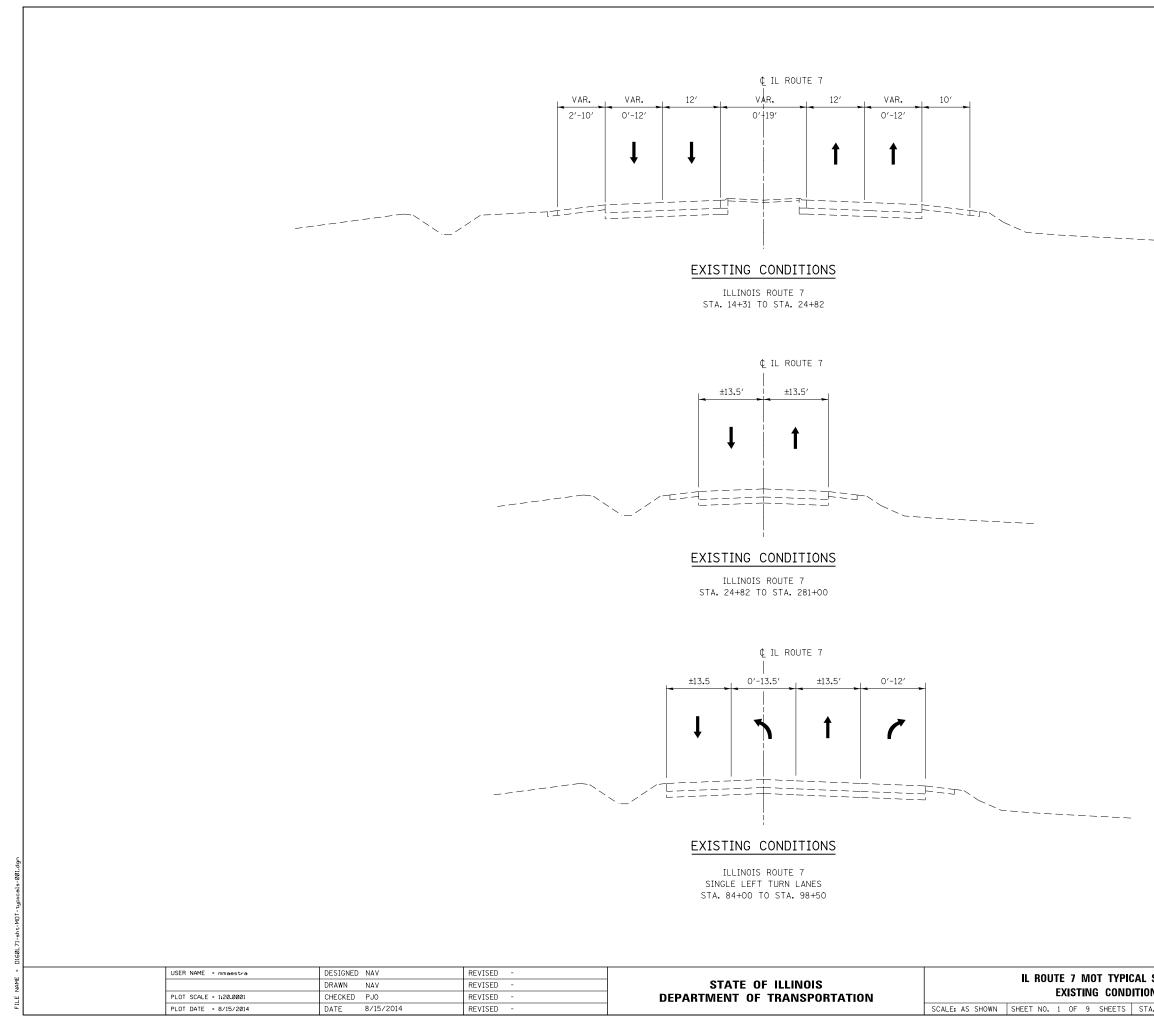

PICAL SECTIONS IDITIONS			F.A.P. RTE.	SECTION	COUNTY	COUNTY TOTAL SHEETS			
			351	536-R-1	WILL	1232	135		
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ICAL SECTIONS IE 1			F.A.P. RTE.	SECTION	COUNTY	TOTAL SHEETS	SHEET NO.			
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			CONTRACT NO. 60L71							
5	STA.	TO STA.	ILLINOIS FED. AID PROJECT							

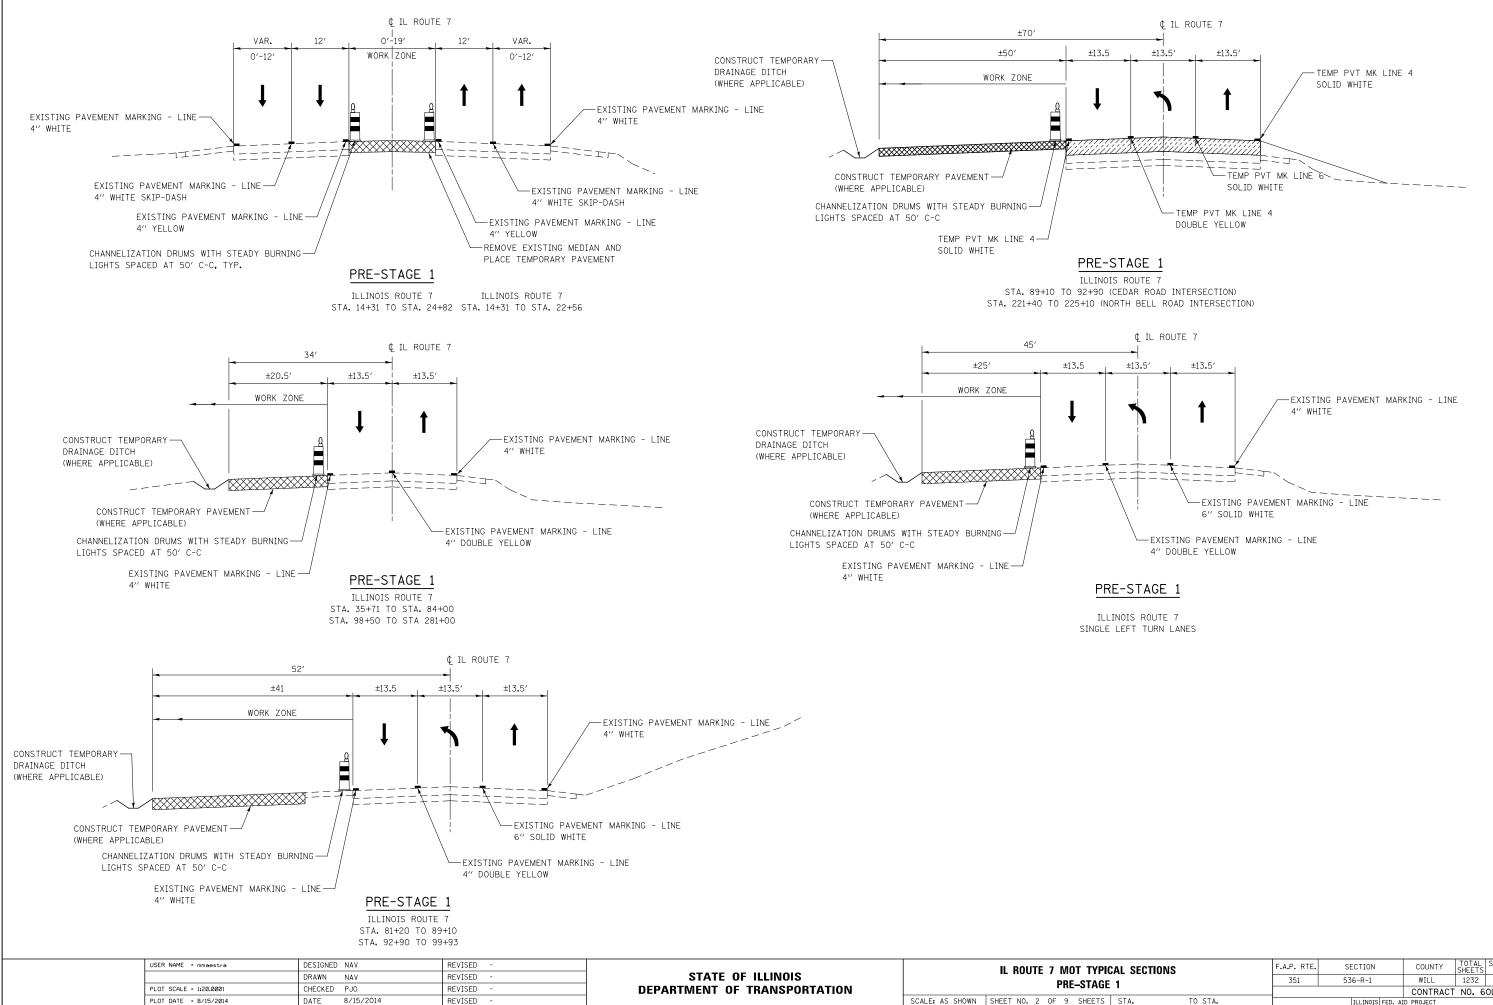

STATE OF ILLINOIS

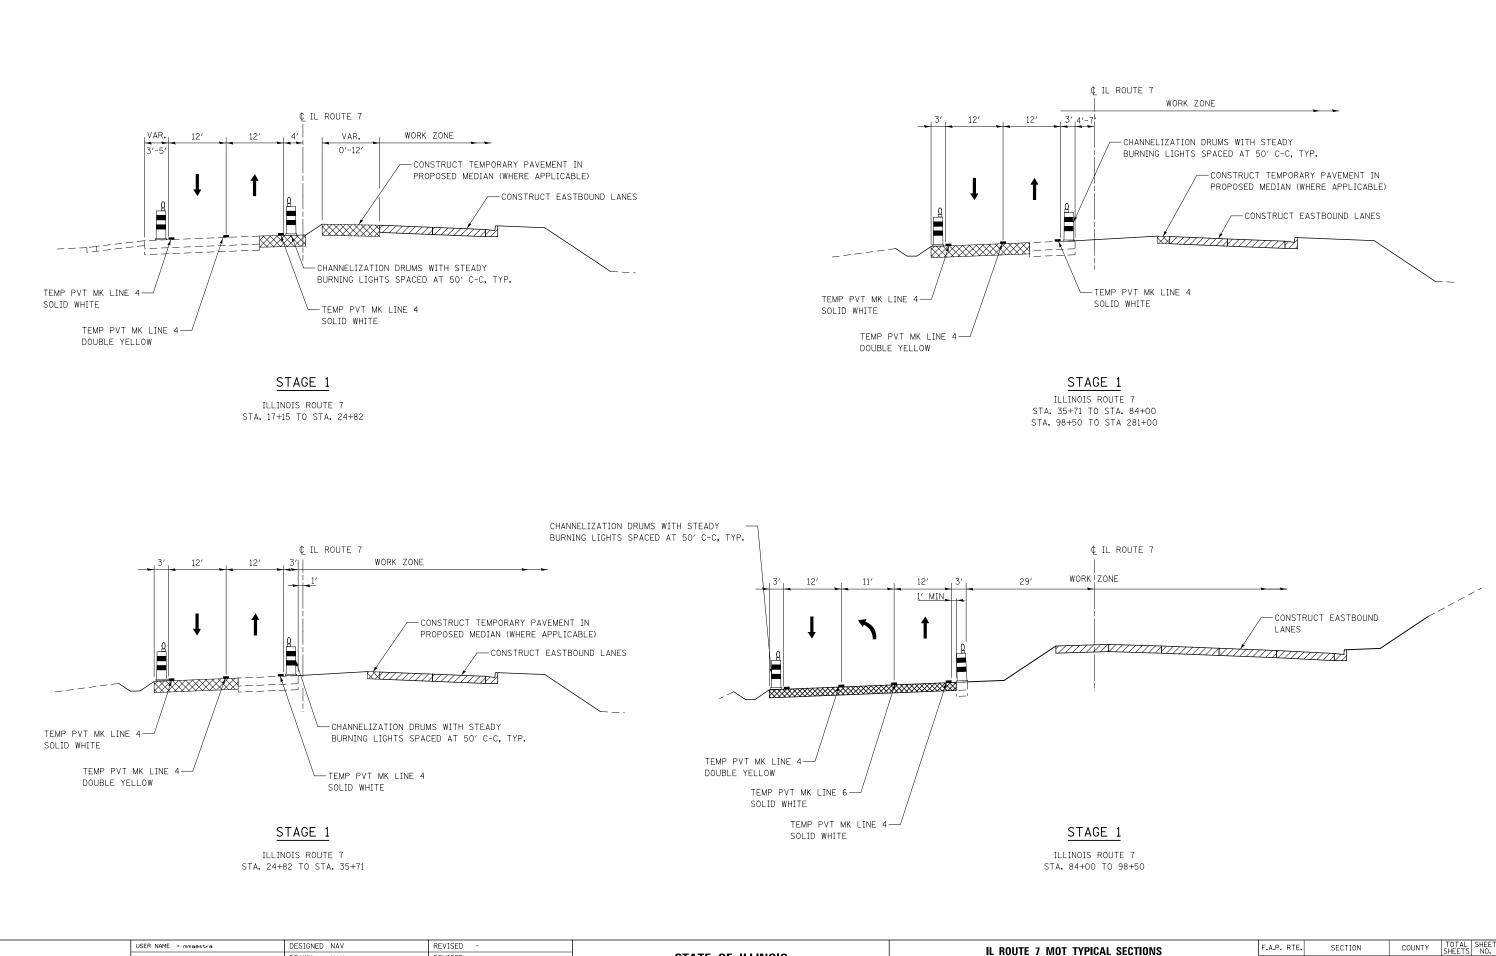**DEPARTMENT OF TRANSPORTATION** 

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DATE 8/15/2014

PLOT SCALE = 1:20.0001

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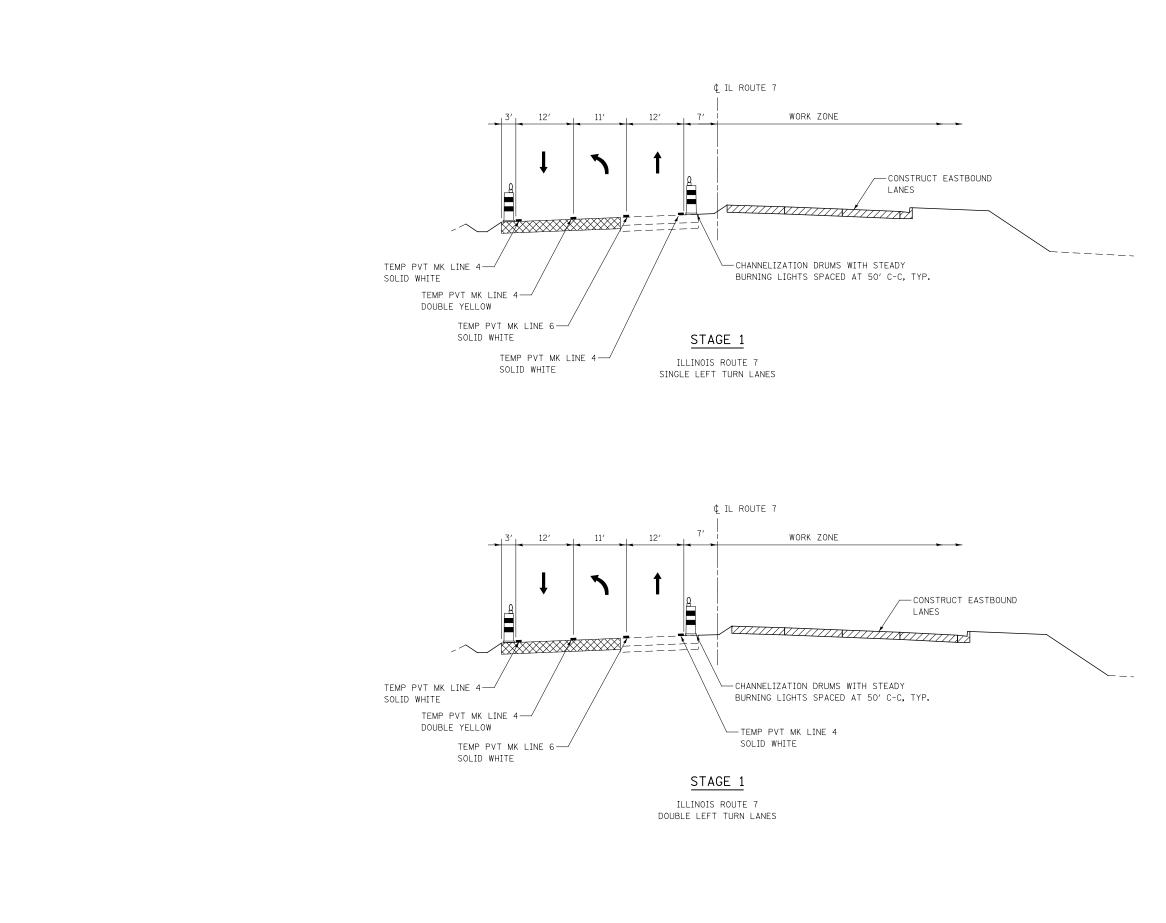
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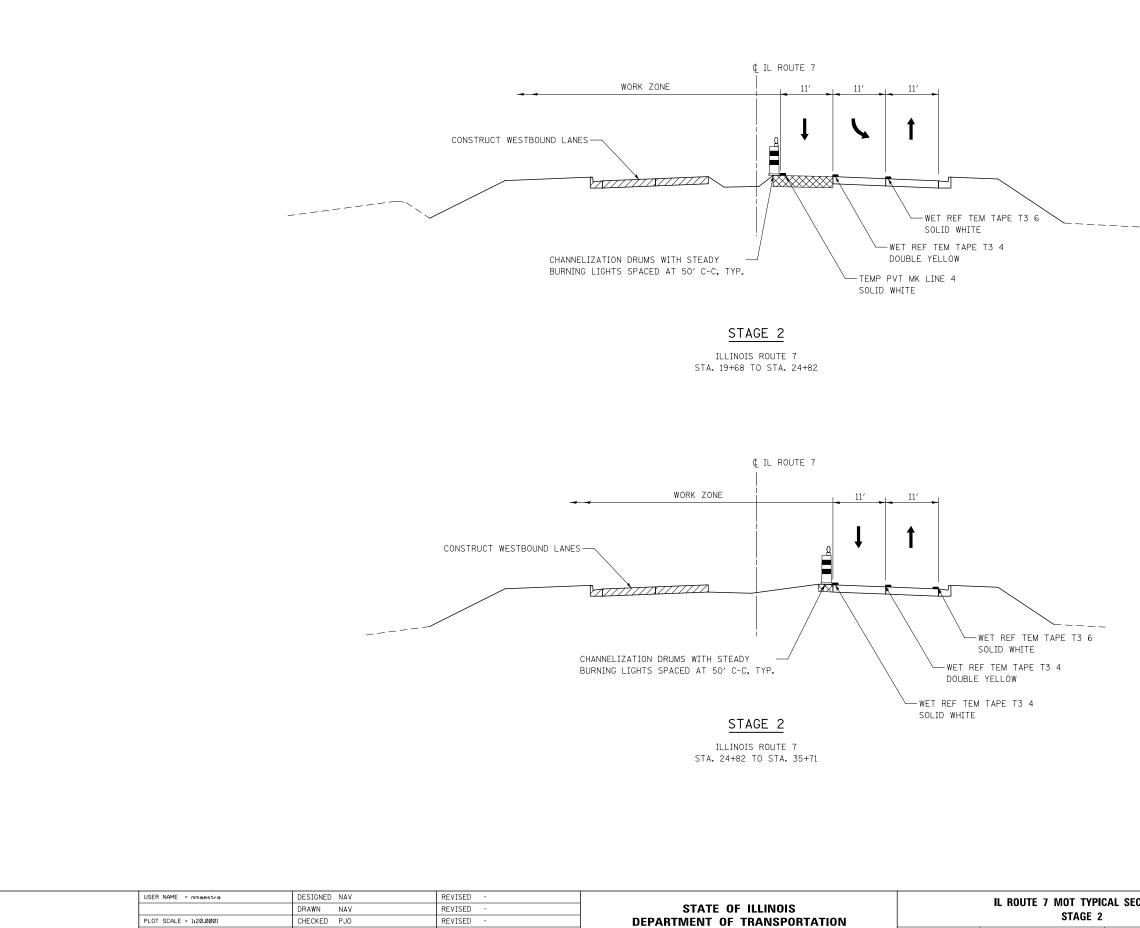
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STAGE 1

SCALE: AS SHOWN SHEET NO. 3 OF 9 SHEETS



USER NAME = mmaestra	DESIGNED NAV	REVISED -			IL ROUTE 7 MOT TYPICAL SECTIONS	F.A.P. RTE.	SECTION	COUNTY	TOTAL S	SHEET
	DRAWN NAV	REVISED -	STATE OF ILLINOIS		STAGE 1	351	536-R-1	WILL	1232	138
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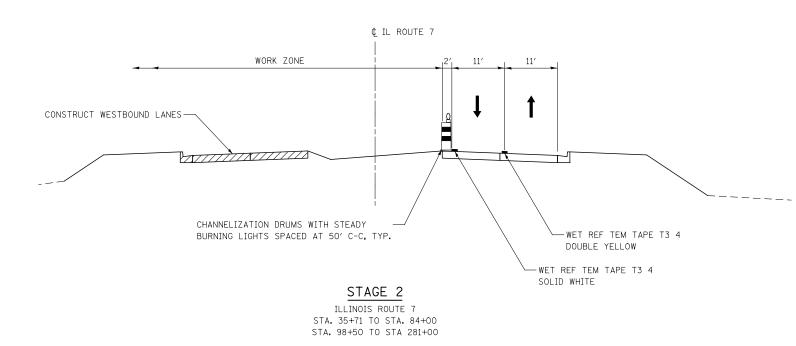
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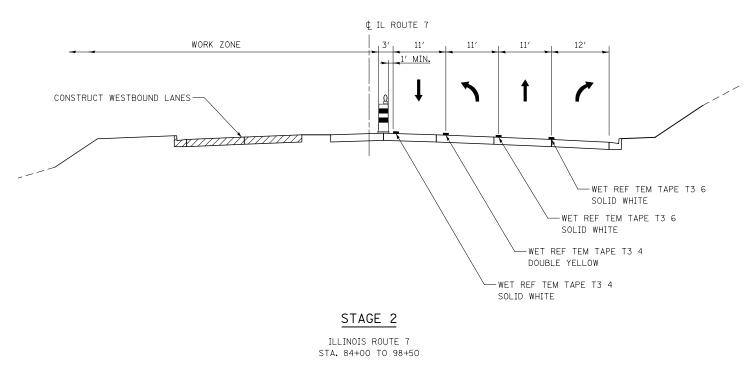
DATE 8/15/2014

REVISED


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ICAL SECTIONS         F.A.P. RTE.         SECTION         COUNTY         TOTAL SHEETS         SHEET NO.           2         351         536-R-1         WILL         1232         139					
ICAL SECTIONS         F.A.P. RTE.         SECTION         COUNTY         TOTAL SHEETS         SHEET NO.           2         351         536-R-1         WILL         1232         139					
ICAL SECTIONS         F.A.P. RTE.         SECTION         COUNTY         TOTAL SHEETS         SHEET NO.           2         351         536-R-1         WILL         1232         139					
ICAL SECTIONS         F.A.P. RTE.         SECTION         COUNTY         TOTAL SHEETS         SHEET NO.           2         351         536-R-1         WILL         1232         139					
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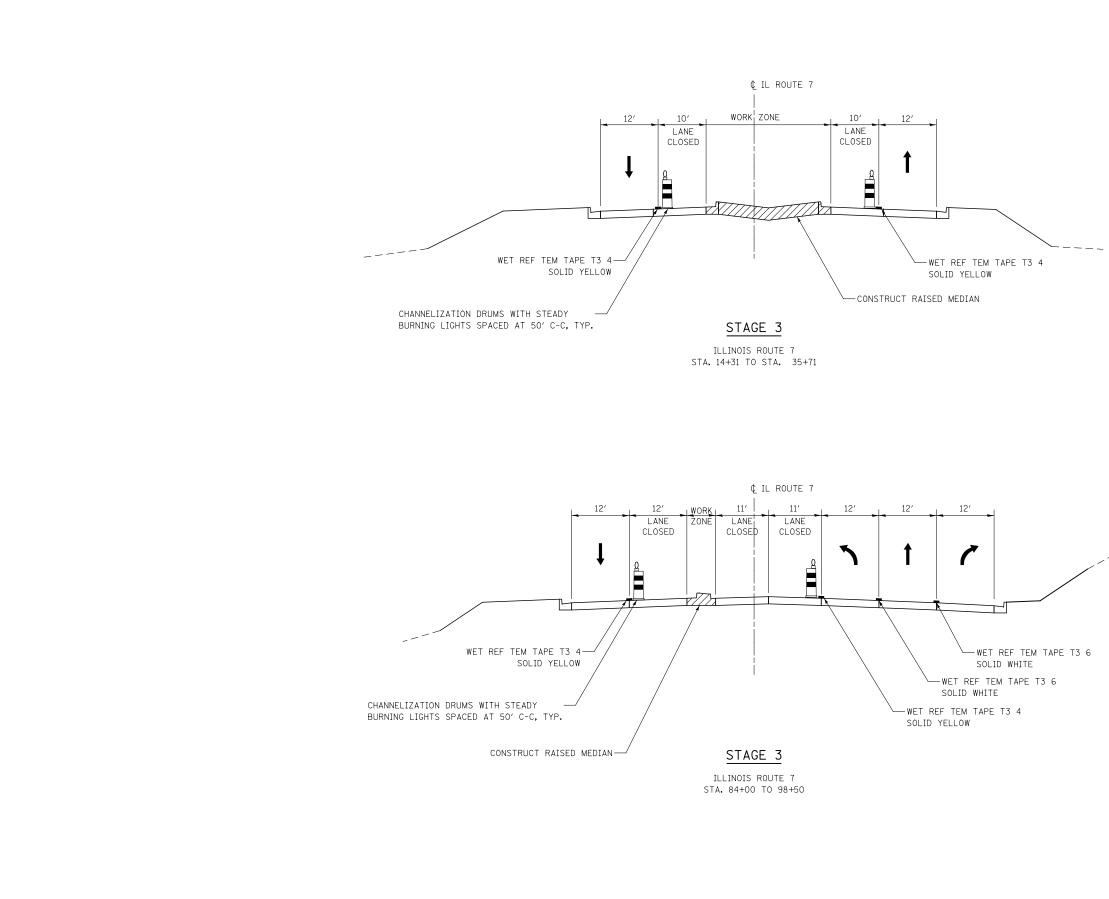





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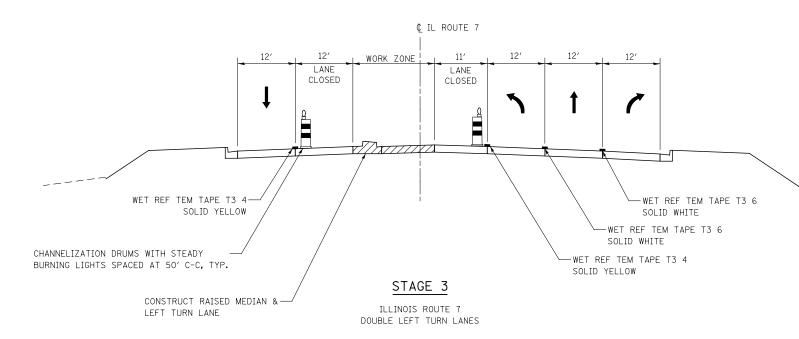


USER NAME = mmoestro	DESIGNED NAV	REVISED -		IL ROUTE 7 MOT TYPICAL SECTIONS	F.A.P. RTE.	SECTION	COUNTY	TOTAL SHEETS	SHEET NO.
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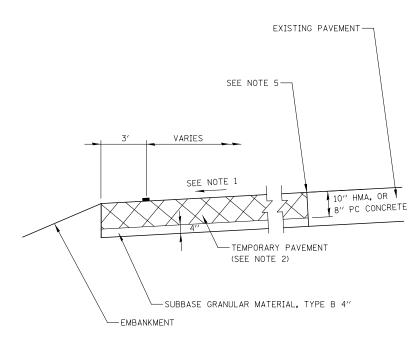



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USER NAME = mmaestra	DESIGNED NAV	REVISED -		IL ROUTE 7 MOT TYPICAL SECTIONS	F.A.P. RTE.	SECTION	COUNTY	TOTAL SHEET
	DRAWN NAV	REVISED -	STATE OF ILLINOIS	STAGE 3	351	536-R-1	WILL	1232 143
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PLOT DATE = 8/15/2014	DATE 8/15/2014	REVISED -		SCALE: AS SHOWN SHEET NO. 9 OF 9 SHEETS STA. TO STA.		ILLINOIS FED.	ID PROJECT	

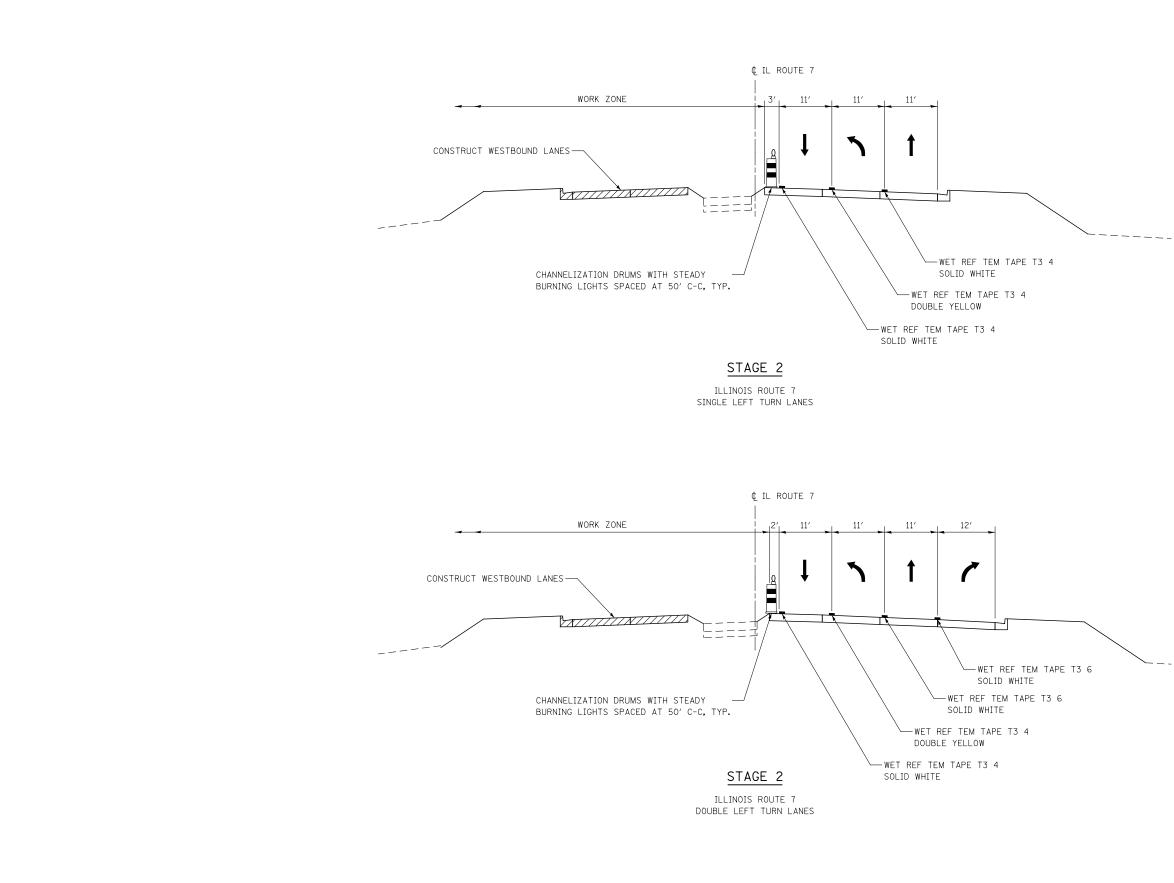

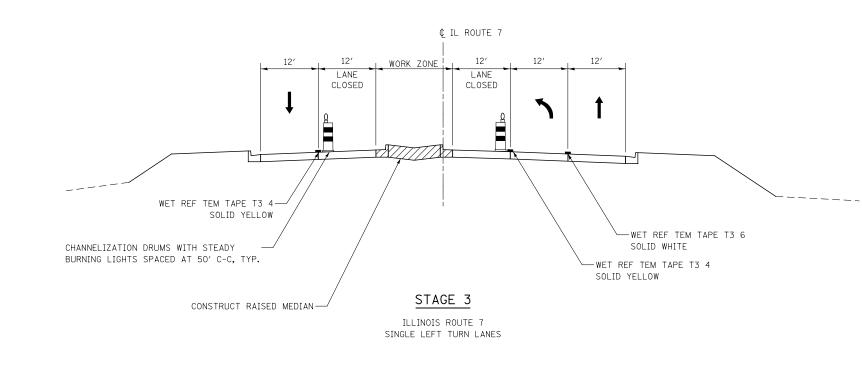


TEMPORARY PAVEMENT DETAIL

## NOTES

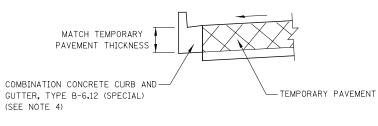- 1. CROSS SLOPE OF TEMPORARY PAVEMENT SHALL MATCH THE CROSS SLOPE OF THE ADJACENT EXISTING PAVEMENT BUT SHALL NOT BE LESS THAN 1.5%, UNLESS OTHERWISE DIRECTED BY THE ENGINEER OR SHOWN ON THE CROSS SECTIONS.
- 2. THE TEMPORARY PAVEMENT SHALL BE CONSTRUCTED OF EITHER HOT-MIX ASPHALT OR CLASS PV CONCRETE. SEE TYPICAL SECTIONS - HOT-MIX ASPHALT MIXTURE REQUIREMENTS.
- 3. SUBBASE GRANULAR MATERIAL, TYPE B 4" SHALL BE PAID FOR SEPERATELY.
- 4. THE COMBINATION CONCRETE CURB AND GUTTER TYPE B-6.12 (SPECIAL) SHALL MATCH THE THICKNESS OF THE ADJACENT TEMPORARY PAVEMENT.
- 5. WHERE EXISTING PAVEMENT IS DETERIORATED SAW CUT 1 FOOT OF EXISTING PAVEMENT AND REPLACE WITH TEMPORARY PAVEMENT. ADDITIONAL TEMPORARY PAVEMENT WILL BE PAID FOR AT THE CONTRACT UNIT PRICE FOR TEMPORTARY PAVEMENT. 1 FOOT AREA OF ADDITIONAL PAVEMENT REMOVAL SHALL NOT BE MEASURED FOR PAYMENT TWICE. SAW CUT COST IS INCLUDED WITH PAVEMENT REMOVAL ITEM.

USER NAME = mmaestra	DESIGNED NAV	REVISED -			F.A.P. RTE.	SECTION	COUNTY TOTAL SHEET
	DRAWN NAV	REVISED -	STATE OF ILLINOIS	MAINTENANCE OF TRAFFIC DETAILS	351	536-R-1	WILL 1232 144
PLOT SCALE = 1:20.0001	CHECKED PJ0	REVISED -	DEPARTMENT OF TRANSPORTATION		L		CONTRACT NO. 60L71
PLOT DATE = 8/15/2014	DATE 8/15/2014	REVISED -		SCALE: AS SHOWN SHEET NO. 1 OF 5 SHEETS STA. TO STA.		ILLINOIS FED. AI	ID PROJECT



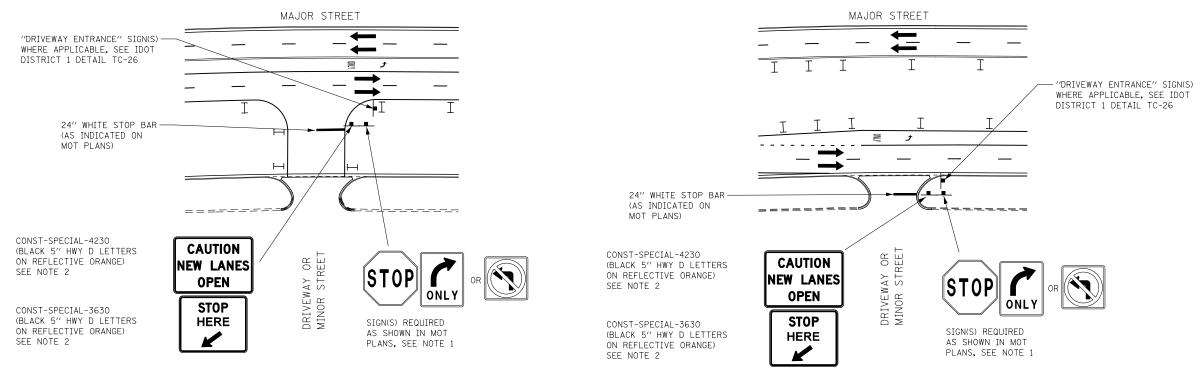


NEW TRAFFIC LANES OPEN OFFSET FROM EDGE OF PAVEMENT

NEW TRAFFIC LANES OPEN ADJACENT TO EDGE OF PAVEMENT


## TEMPORARY INFORMATION SIGNING AT DRIVEWAYS/SIDE ROADS DETAIL

- 1. SIGNS SHOWN ON THE MOT PLANS SHALL BE INSTALLED TO THE RIGHT OF THE TEMPORARY INFORMATION SIGNAGE, THE MOT SIGNS ARE INCLUDED IN THE COST FOR TRAFFIC CONTROL AND PROTECTION (SPECIAL).
- 2. CONST-SPECIAL SIGNS TO BE MEASURED AND PAID FOR SEPARATELY UNDER TEMPORARY INFORMATION SIGNING. THESE SIGNS WILL NOT BE REMEASURED FOR PAYMENT IN SUBSEQUENT STAGES. THE RELOCATION OF THESE SIGNS SHALL BE INCLUDED IN THE COST FOR TEMPORARY INFORMATION SIGNING.


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PLOT SCALE = 1:10.0001	CHECKED PJ0	REVISED -	DEPARTMENT OF TRANSPORTATION			I		CONTRAC	T NO. 60L71
PLOT DATE = 8/15/2014	DATE = 8/15/2014 DATE 8/15/2014 REVISED -			SCALE: AS SHOWN SHEET NO. 2 OF 5 SHEETS STA. TO STA			ILLINOIS FED. A	ID PROJECT	

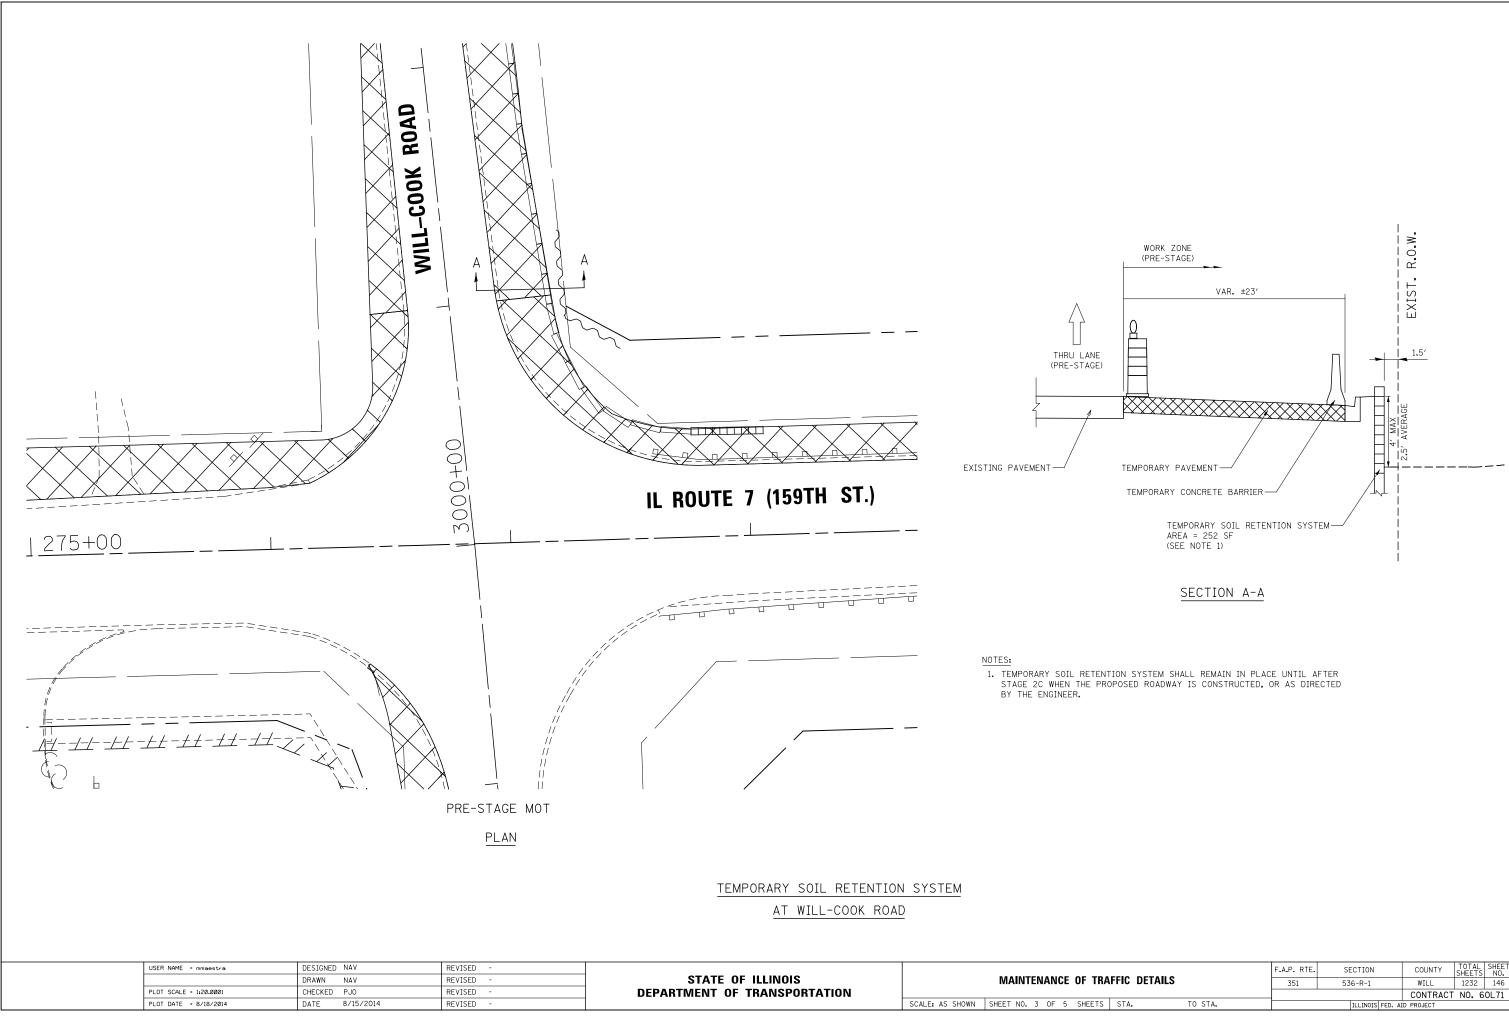

	DELINED		351	226-4-1	WILL	1232	140
					CONTRACT	NO. 6	0L71
S	STA.	TO STA.		ILLINOIS FED.	AID PROJECT		

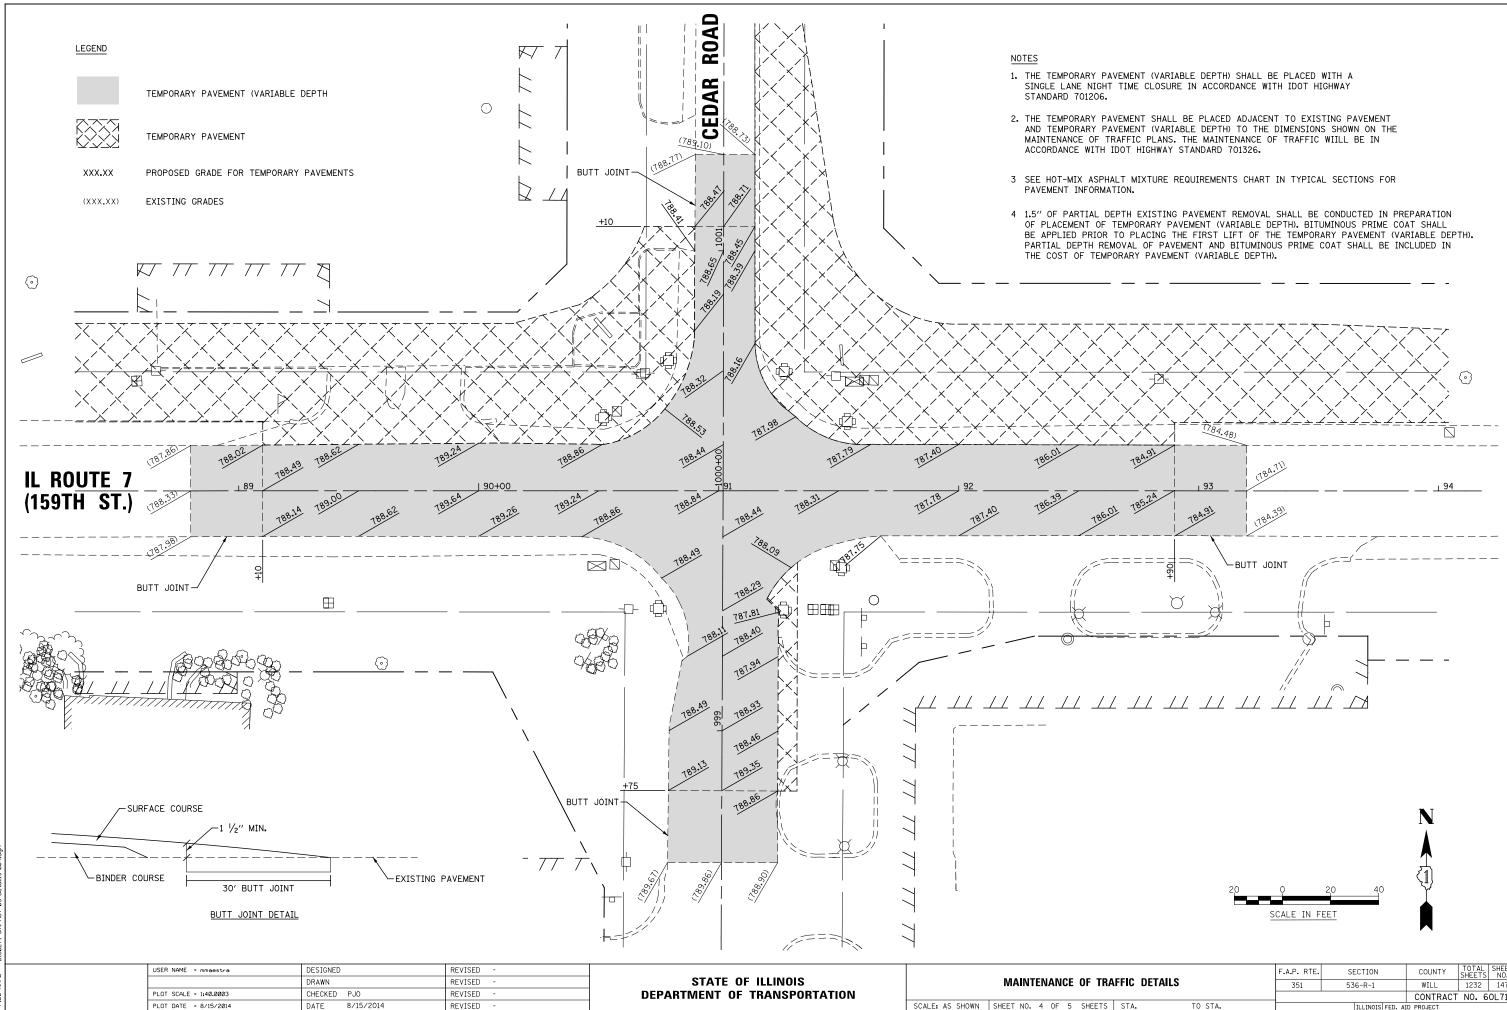

			F.A.P. RTE.	SECTION	COUNTY	TOTAL SHEETS	SHEET NO.
RAFFIC DETAILS 351 536-R-1 WILL 1232		1232	147				
					CONTRACT	NO. 6	0L71
S	STA.	TO STA.		ILLINOIS FED. A	ID PROJECT		

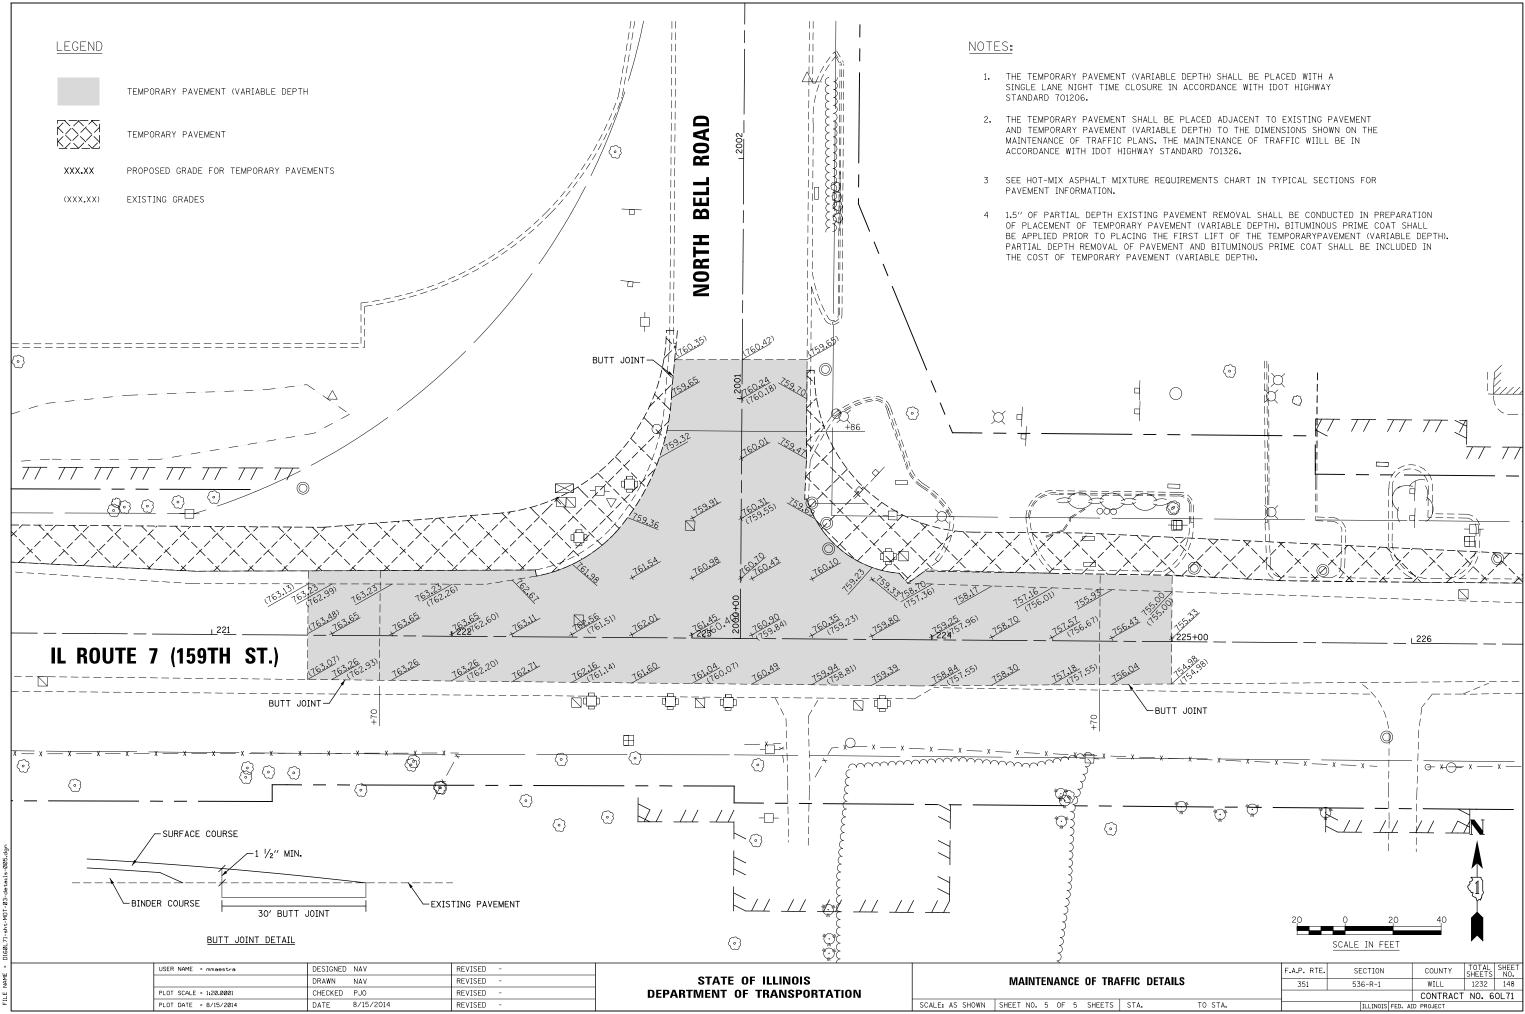

USER NAME = mmaestra	DESIGNED NAV	REVISED -				F.A.P. RTE.	SECTION	COUNTY	TOTAL SHEET
	DRAWN NAV	REVISED -	STATE OF ILLINOIS	MOT LEGEND		351	536-R-1	WILL	1232 149
PLOT SCALE = 1:100.001	CHECKED PJ0	REVISED -	DEPARTMENT OF TRANSPORTATION					CONTRACT	NO. 60L71
PLOT DATE = 8/15/2014	DATE 8/15/2014	REVISED -		SCALE: AS SHOWN SHEET NO. 1 OF 1 SHEETS STA.	TO STA.			AID PROJECT	

## TEMPORARY PAVEMENT MARKING - LINE 4", SOLID YELLOW (J)TEMPORARY PAVEMENT MARKING - LINE 4", DOUBLE YELLOW (к) SPACED AT 11" C-C WITH TEMPORARY RAISED REFLECTIVE PAVEMENT MARKERS SPACED 40' C-C (BI-DIRECTIONAL AMBER) (L)TEMPORARY PAVEMENT MARKING - LINE 6", SOLID WHITE M TEMPORARY PAVEMENT MARKING - LINE 6", WHITE DOTTED (10' LINE - 30' SPACE)

LEGEND

.....

TEMPORARY PAVEMENT MARKING - LINE 8 ", SOLID WHITE (N)(0)(P) TEMPORARY PAVEMENT MARKING, LETTERS & SYMBOLS WET REFLECTIVE TEMPORARY TAPE, TYPE III, 4", SOLID WHITE (R)(S)

TEMPORARY PAVEMENT PLACED  $\boxtimes$ IN THIS STAGE DIRECTION OF TRAFFIC 1 DIRECTION INDICATOR BARRICADE 0 CHANNELIZATION DRUM WITH STEADY BURNING LIGHT -( TEMPORARY RAISED REFLECTIVE ۰ MARKER (TWO-WAY AMBER)

CONSTRUCTION WORK ZONE

TEMPORARY IMPACT ATTENUATOR

(FULLY REDIRECTIVE, TEST LEVEL 3)

	TEMPORARY CONCRETE BARRIER
~~~~~	TEMPORARY SOIL RETENTION SYSTEM
	VERTICAL PANEL WITH STEADY BURNING LIGHT
Þ	SIGN
þ	TYPE III BARRICADE LOCATION
-¢-	FLASHING YELLOW LIGHT

## MOT PAVEMENT MARKING LEGEND

- (A)TEMPORARY PAVEMENT MARKING - LINE 4", SOLID WHITE
- TEMPORARY PAVEMENT MARKING LINE 4", WHITE SKIP-DASH В (10' LINE - 30' SPACE)
- (c)
- (D)
- (E)
- (F (2' LINE - 6' SPACE) (UNLESS OTHERWISE NOTED)

E = mmaestra	DESIGNE
	DRAWN
LE = 1:100.001	CHECKED

WET REFLECTIVE TEMPORARY TAPE, TYPE III, 4", SOLID YELLOW


- WET REFLECTIVE TEMPORARY TAPE, TYPE III, 4", DOUBLE YELLOW SPACED AT 11" C-C WITH TEMPORARY RAISED REFLECTIVE

- (T)
- (U)WET REFLECTIVE TEMPORARY TAPE, TYPE III, LETTERS & SYMBOLS


- WET REFLECTIVE TEMPORARY TAPE, TYPE III, 4", WHITE SKIP-DASH
- (G)(H)TEMPORARY PAVEMENT MARKING - LINE 12", SOLID WHITE (I)TEMPORARY PAVEMENT MARKING - LINE 12", SOLID YELLOW TEMPORARY PAVEMENT MARKING - LINE 24", SOLID WHITE


- - PAVEMENT MARKERS SPACED 40' C-C (BI-DIRECTIONAL AMBER)

WET REFLECTIVE TEMPORARY TAPE, TYPE III, 6", SOLID WHITE WET REFLECTIVE TEMPORARY TAPE, TYPE III, 6", WHITE DOTTED (2' LINE - 6' SPACE) (UNLESS OTHERWISE NOTED) WET REFLECTIVE TEMPORARY TAPE, TYPE III, 12", SOLID WHITE WET REFLECTIVE TEMPORARY TAPE, TYPE III, 12", SOLID YELLOW WET REFLECTIVE TEMPORARY TAPE, TYPE III, 24", SOLID WHITE

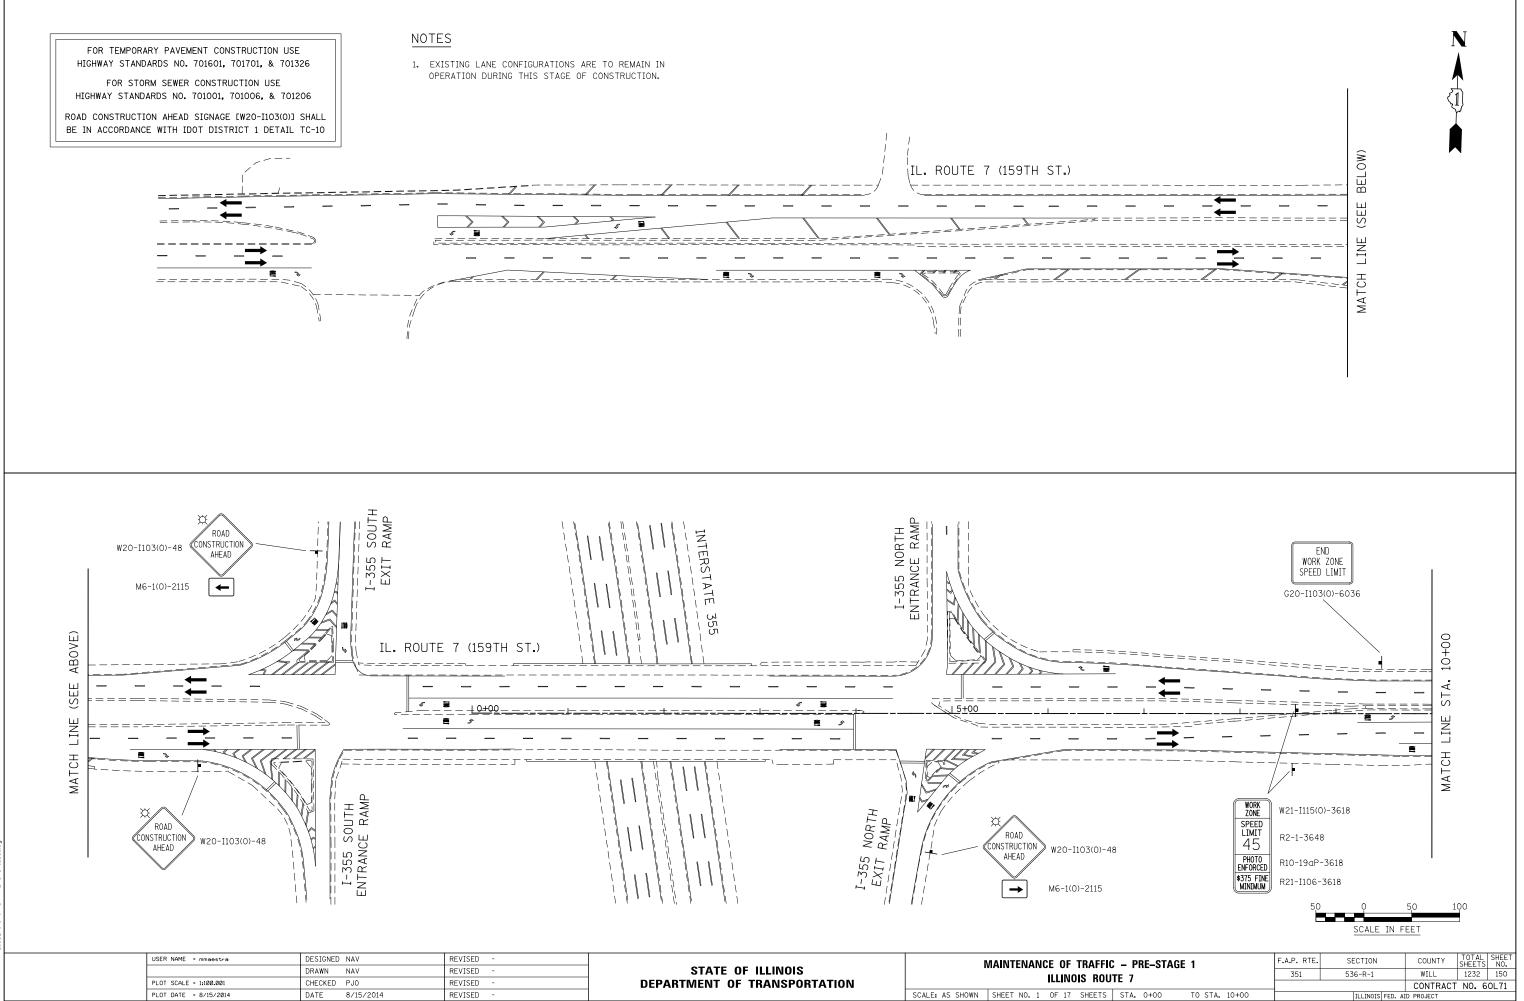


USER NAME = mmoestro	DESIGNED NAV DRAWN NAV	REVISED - REVISED -	STATE OF ILLINOIS	MAINTENANCE OF TRA		
PLOT SCALE = 1:100.001	CHECKED PJ0	REVISED -	DEPARTMENT OF TRANSPORTATION	ILL	INOIS ROUT	
PLOT DATE = 8/15/2014	DATE 8/15/2014	REVISED -		SCALE: AS SHOWN SHEET NO. 1 OF	17 SHEETS	

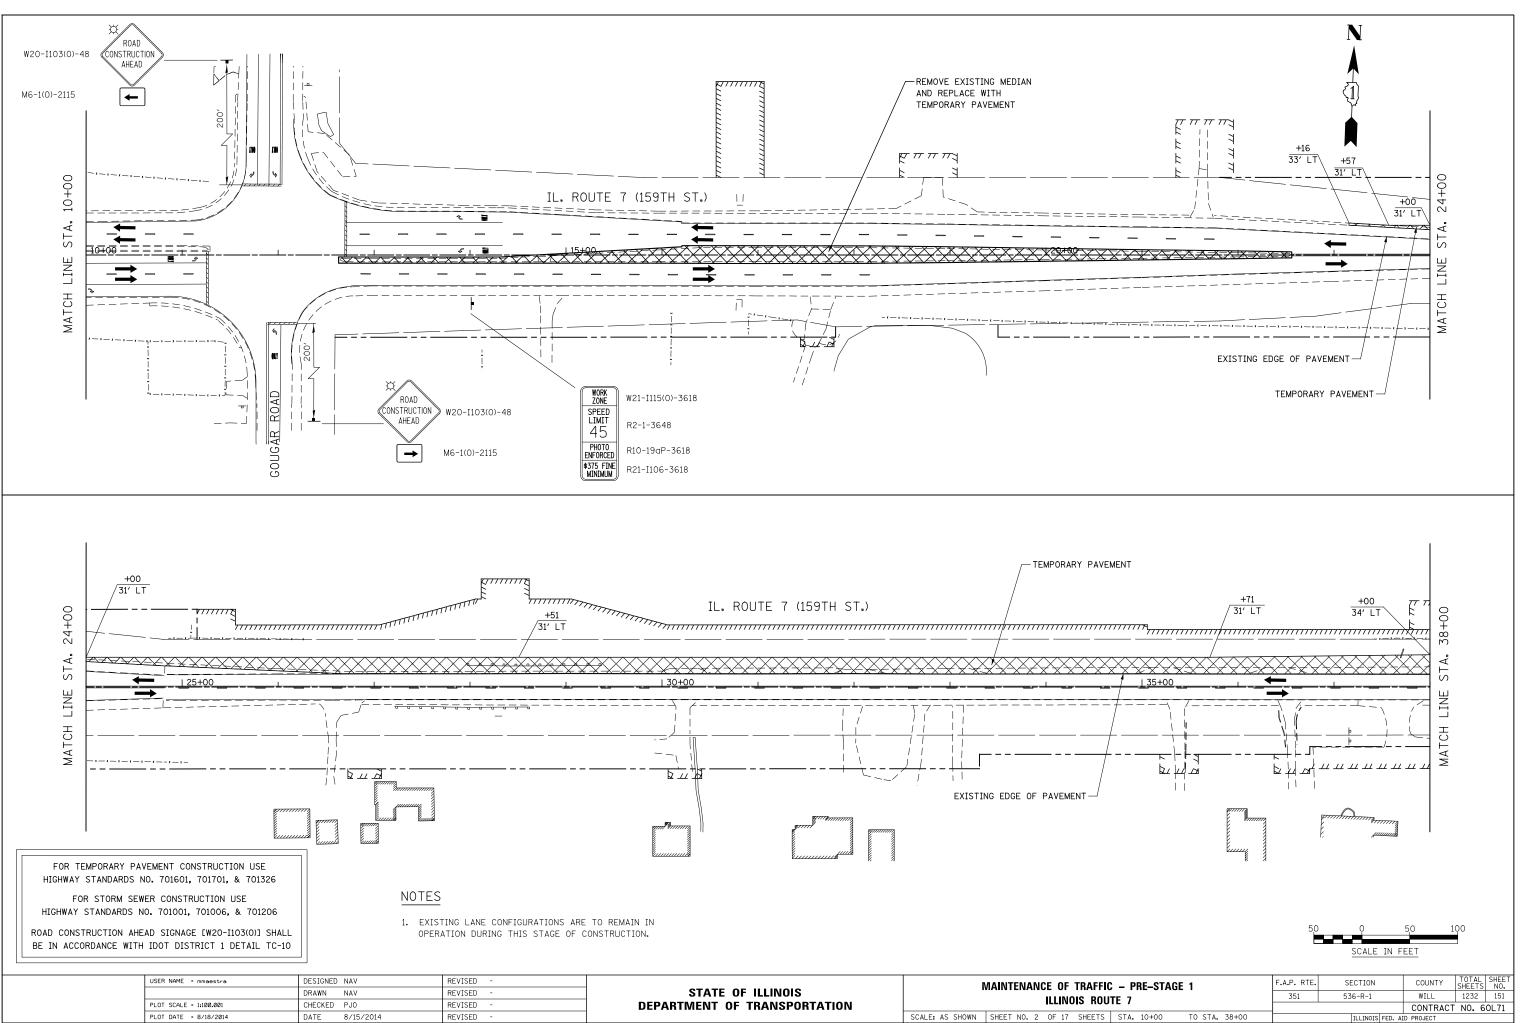


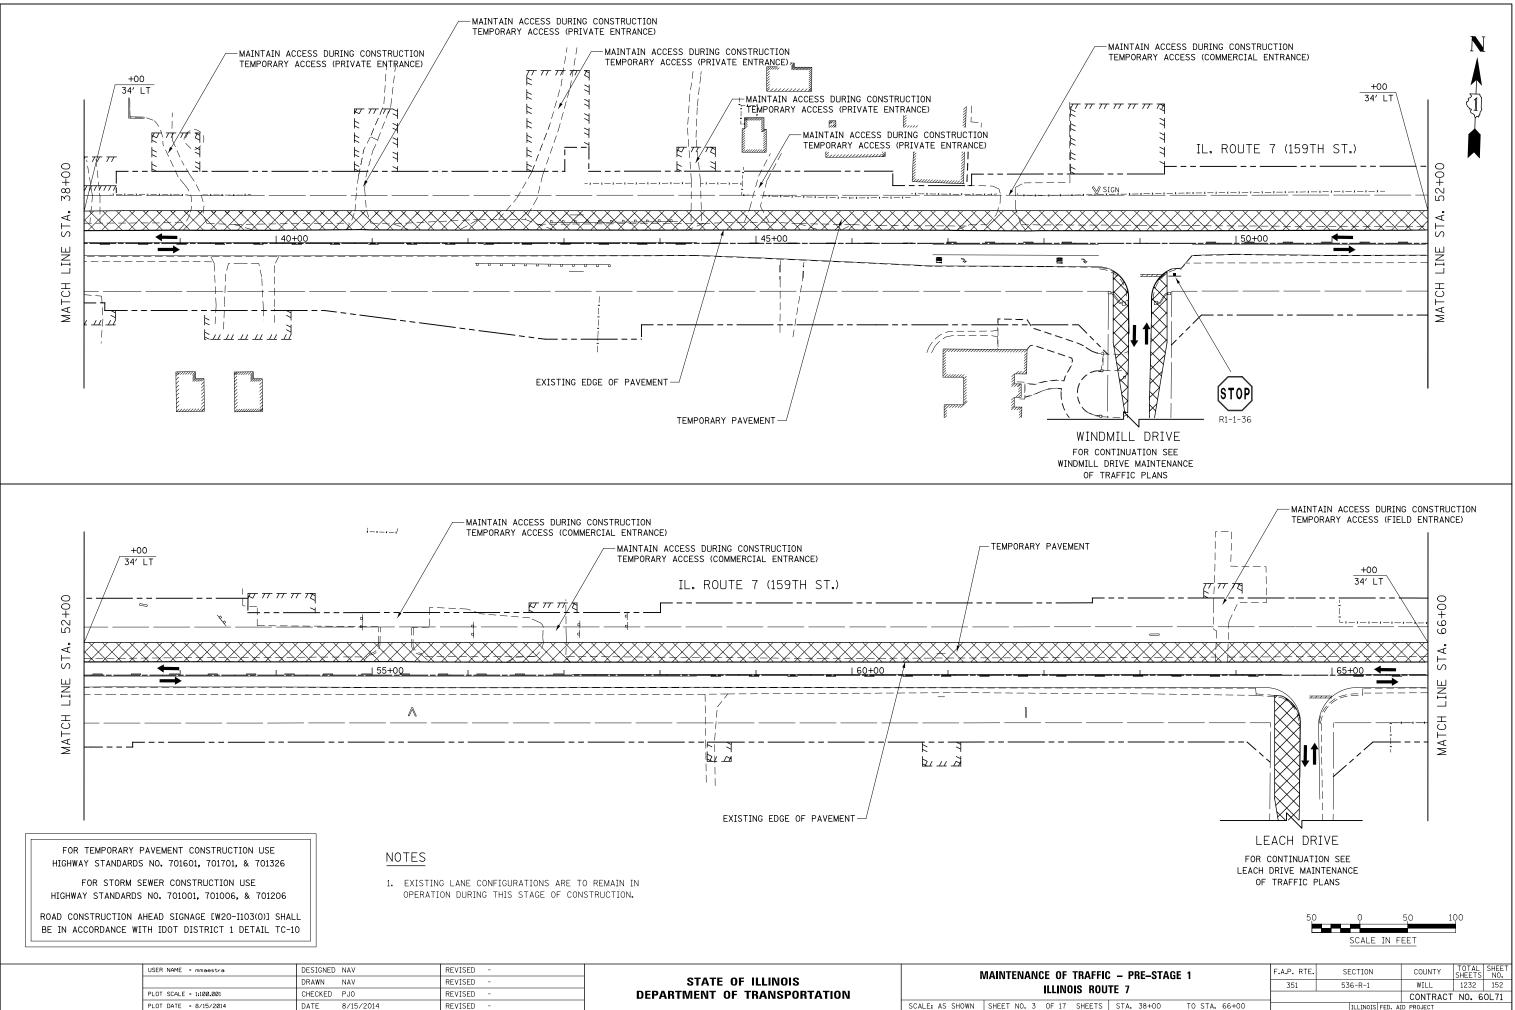


USER NAME = mmaestra	DESIGNED NAV	REVISED -		р	MAINTENANCE OF TRAFFI
	DRAWN NAV	REVISED -	STATE OF ILLINOIS	, n	
PLOT SCALE = 1:100.001	CHECKED PJ0	REVISED -	DEPARTMENT OF TRANSPORTATION		ILLINOIS ROU
PLOT DATE = 8/15/2014	DATE 8/15/2014	REVISED -		SCALE: AS SHOWN	SHEET NO. 3 OF 17 SHEETS

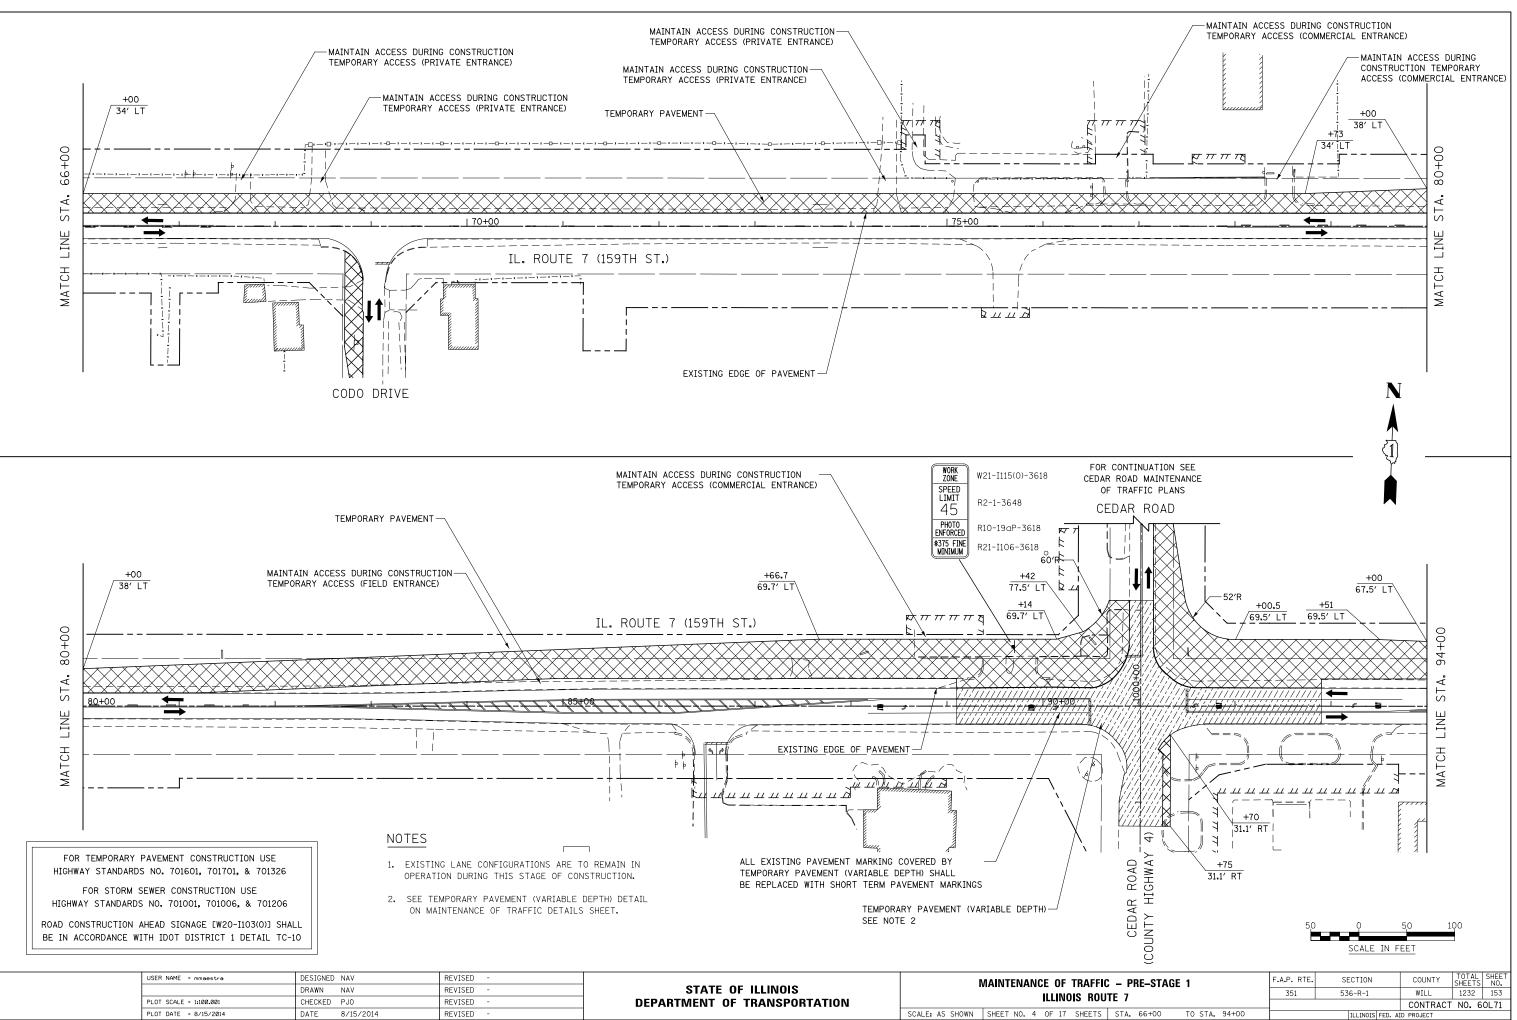



	USER NAME = mmaestra	DESIGNED NAV	REVISED -		MAINTENANCE OF TRAFFIC -
		DRAWN NAV	REVISED -	STATE OF ILLINOIS	
	PLOT SCALE = 1:100.001	CHECKED PJ0	REVISED -	DEPARTMENT OF TRANSPORTATION	ILLINOIS ROUTE
	PLOT DATE = 8/15/2014	DATE 8/15/2014	REVISED -		SCALE: AS SHOWN SHEET NO. 4 OF 17 SHEETS S

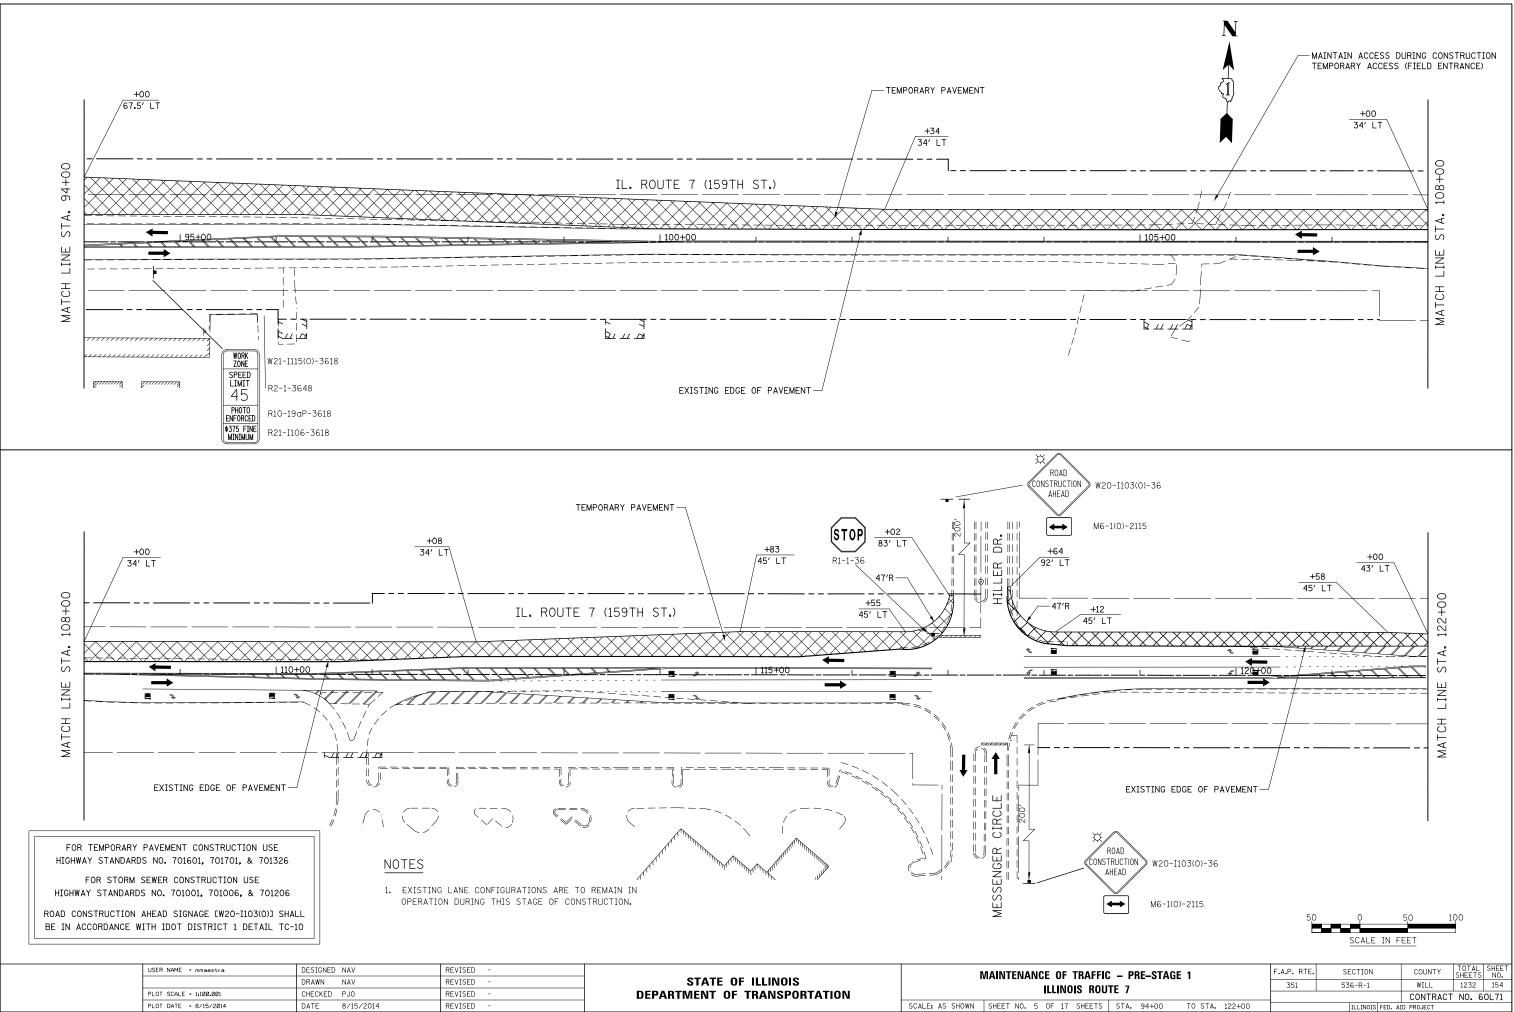

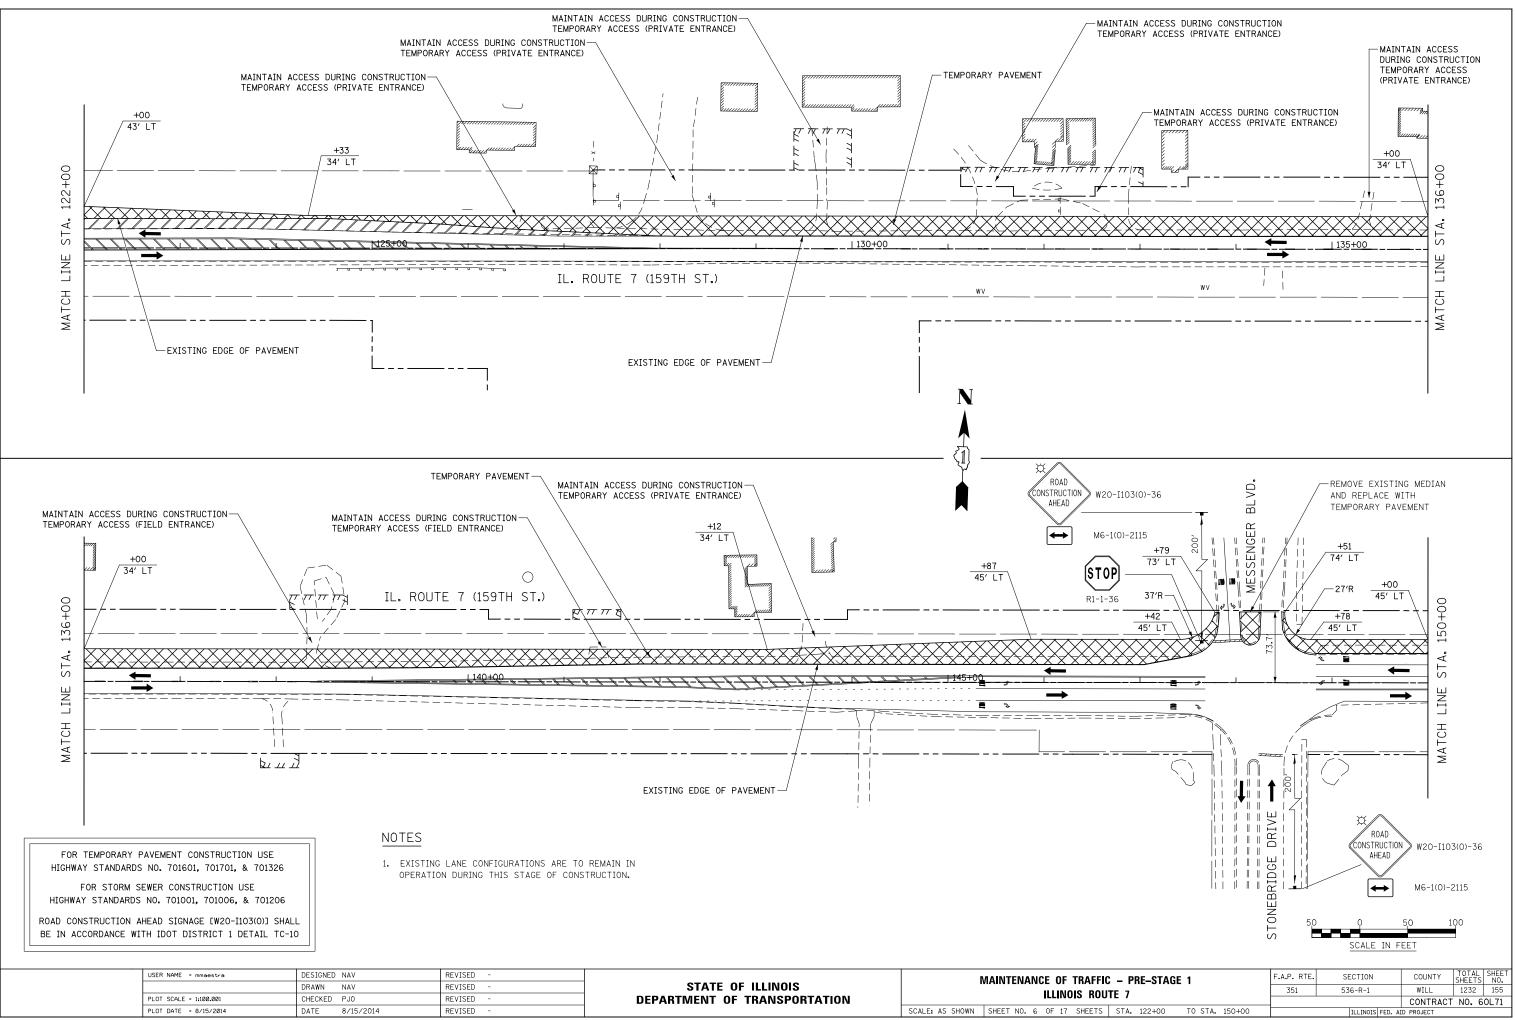



USER NAME = mmaestra	DESIGNED NAV	REVISED -		
	DRAWN NAV	REVISED -	STATE OF ILLINOIS	MAINTENANCE OF TRAFFIC
PLOT SCALE = 1:100.001	CHECKED PJ0	REVISED -	DEPARTMENT OF TRANSPORTATION	ILLINOIS ROU
PLOT DATE = 8/15/2014	DATE 8/15/2014	REVISED -		SCALE: AS SHOWN SHEET NO. 6 OF 17 SHEETS

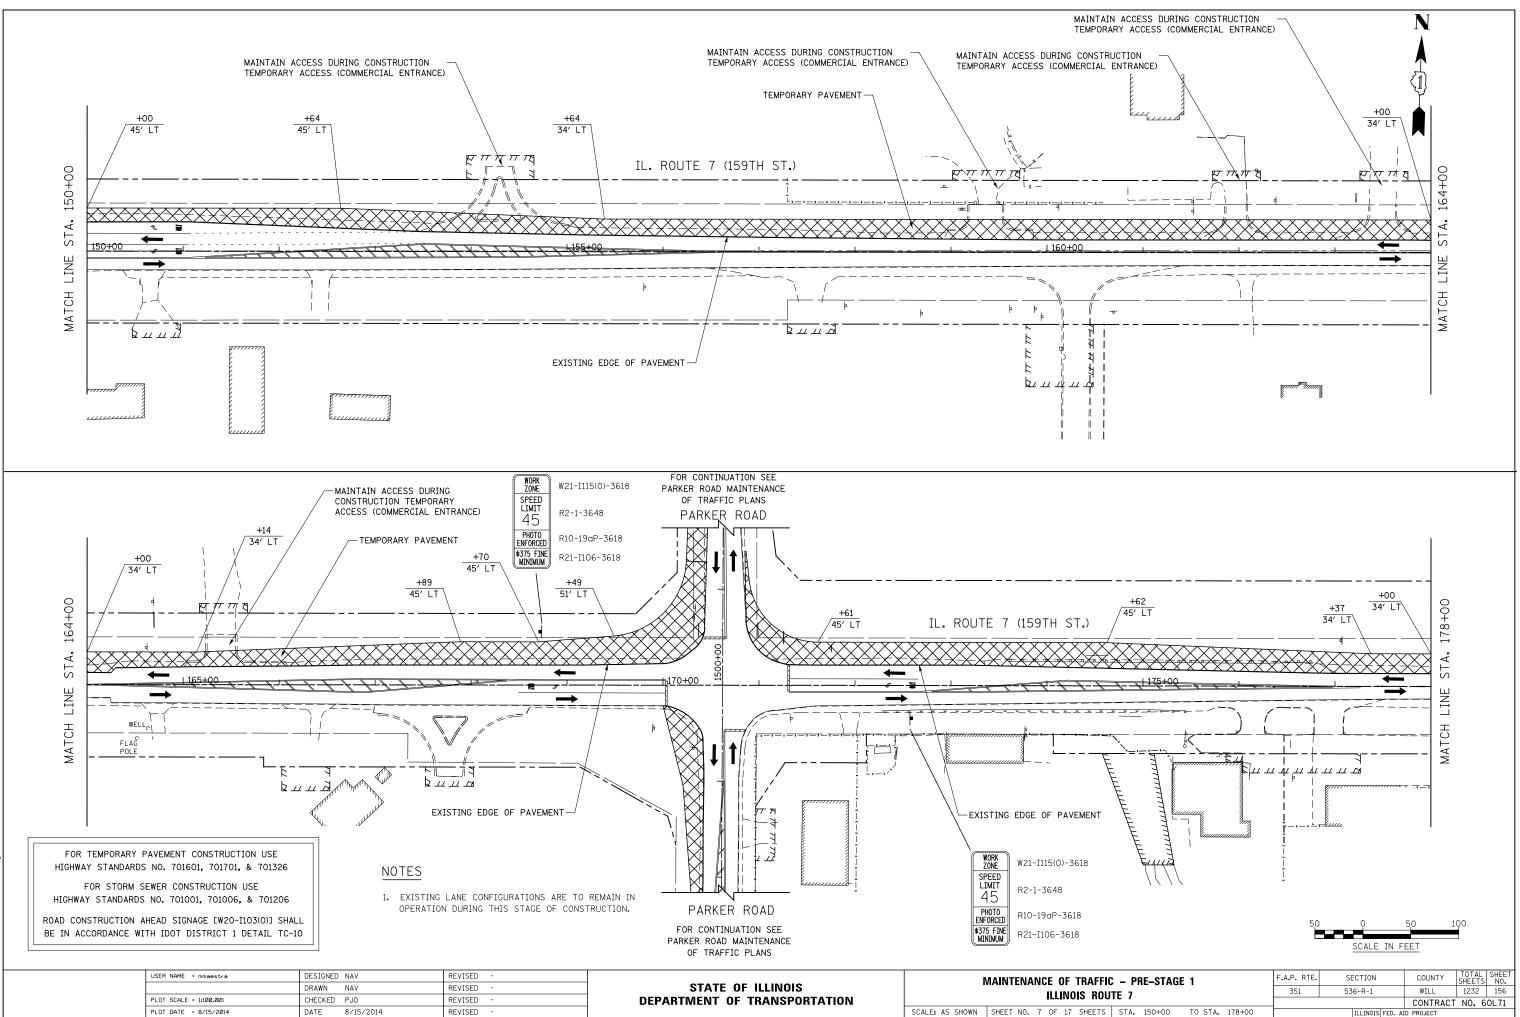

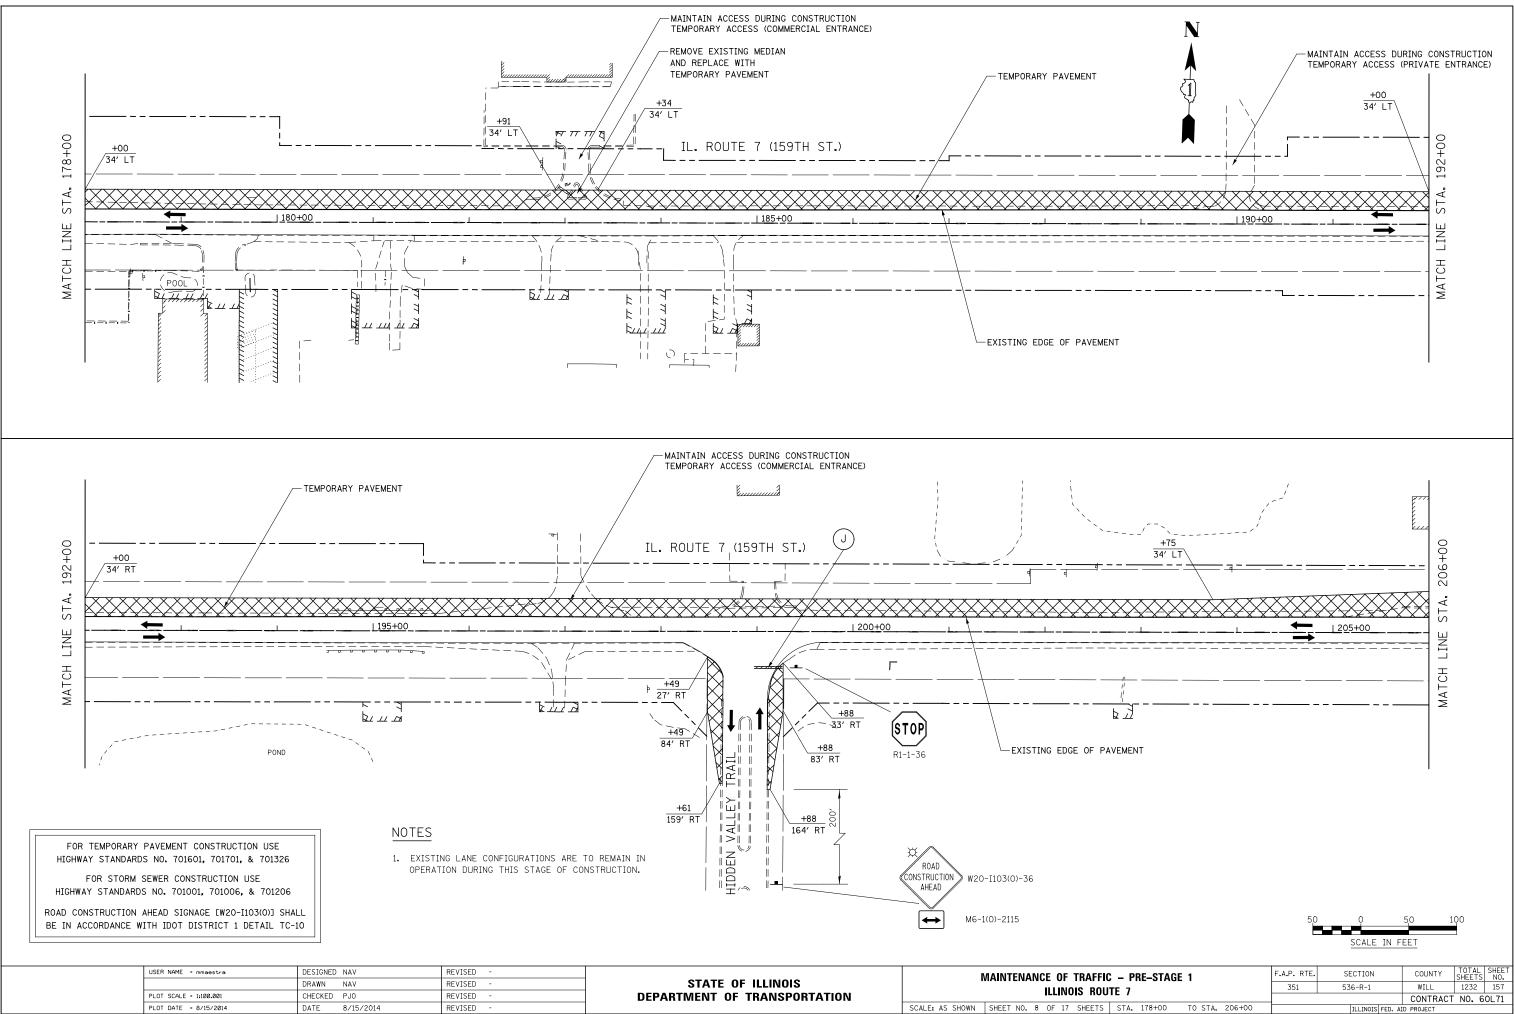



SCALE: AS SHOWN SHEET NO. 8 OF 17 SHEETS STA. 178+00 TO STA. 206+00 DATE PLOT DATE = 8/15/2014 8/15/2014 REVISED

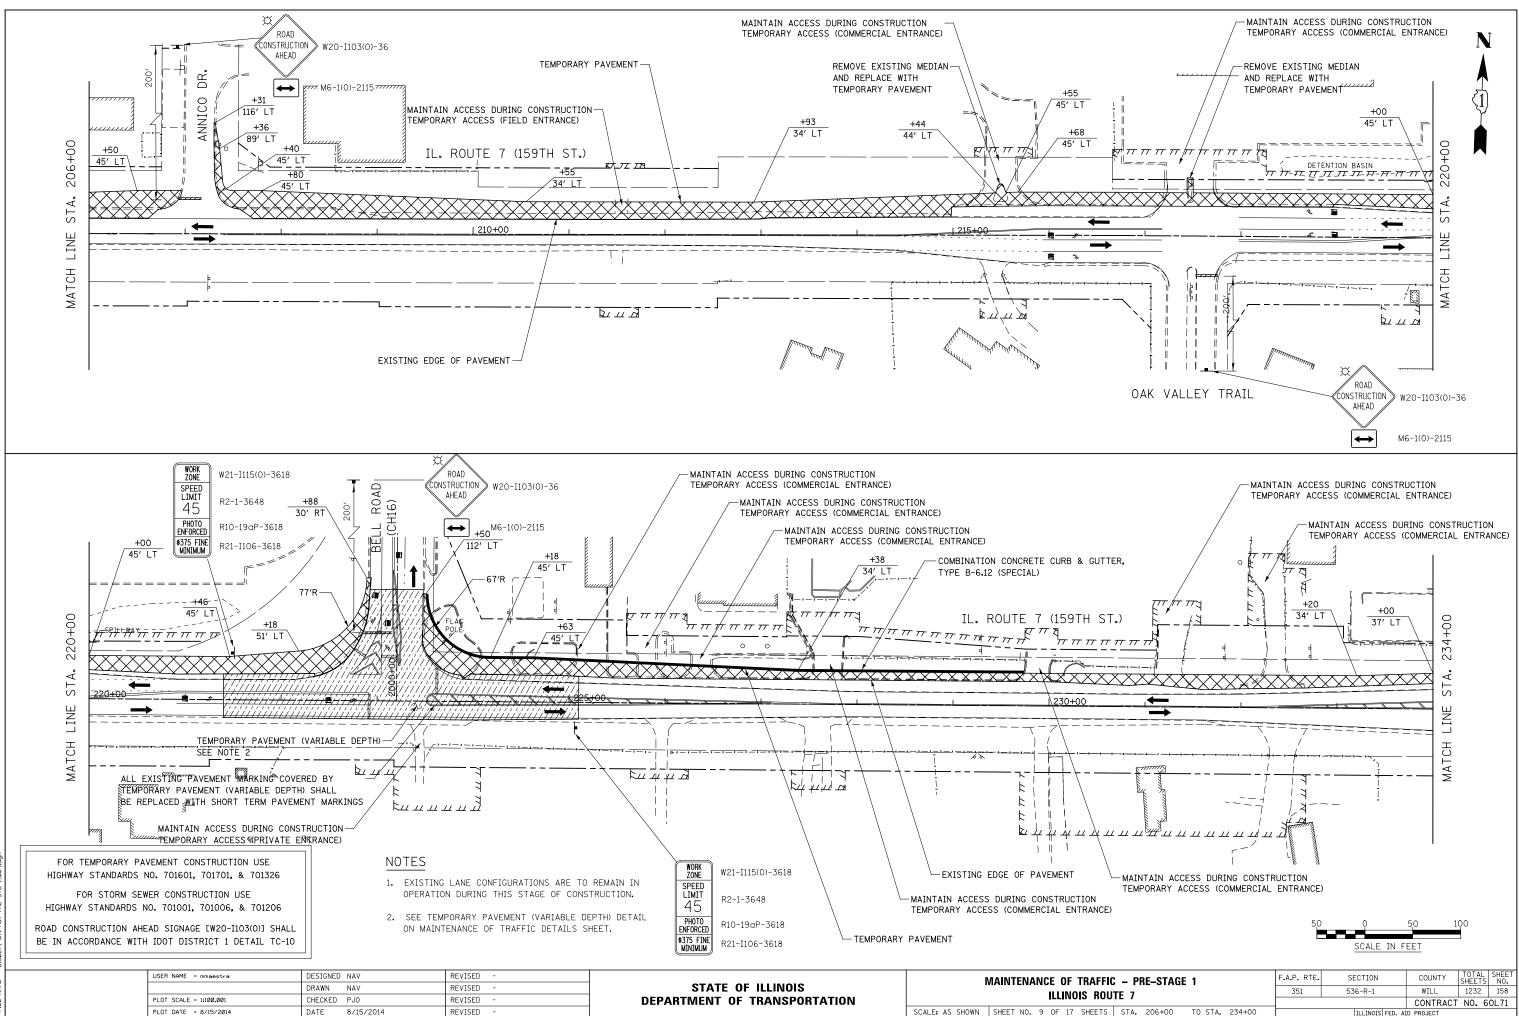

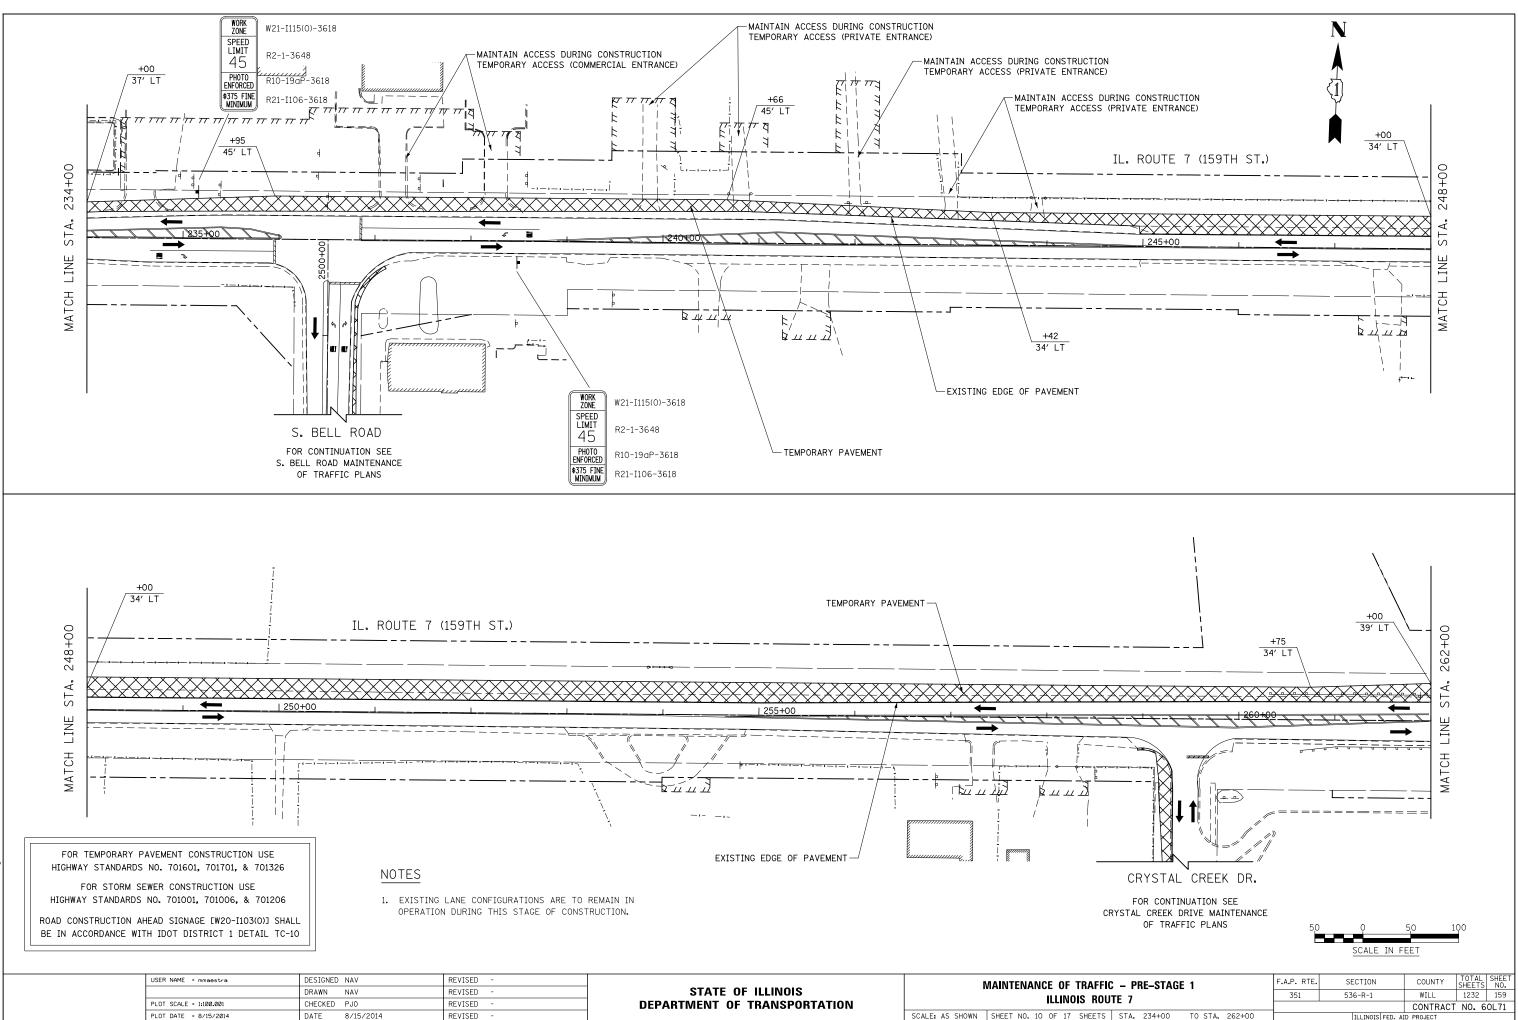



SCALE: AS SHOWN SHEET NO. 10 OF 17 SHEETS STA. 234+00 TO STA. 262+00

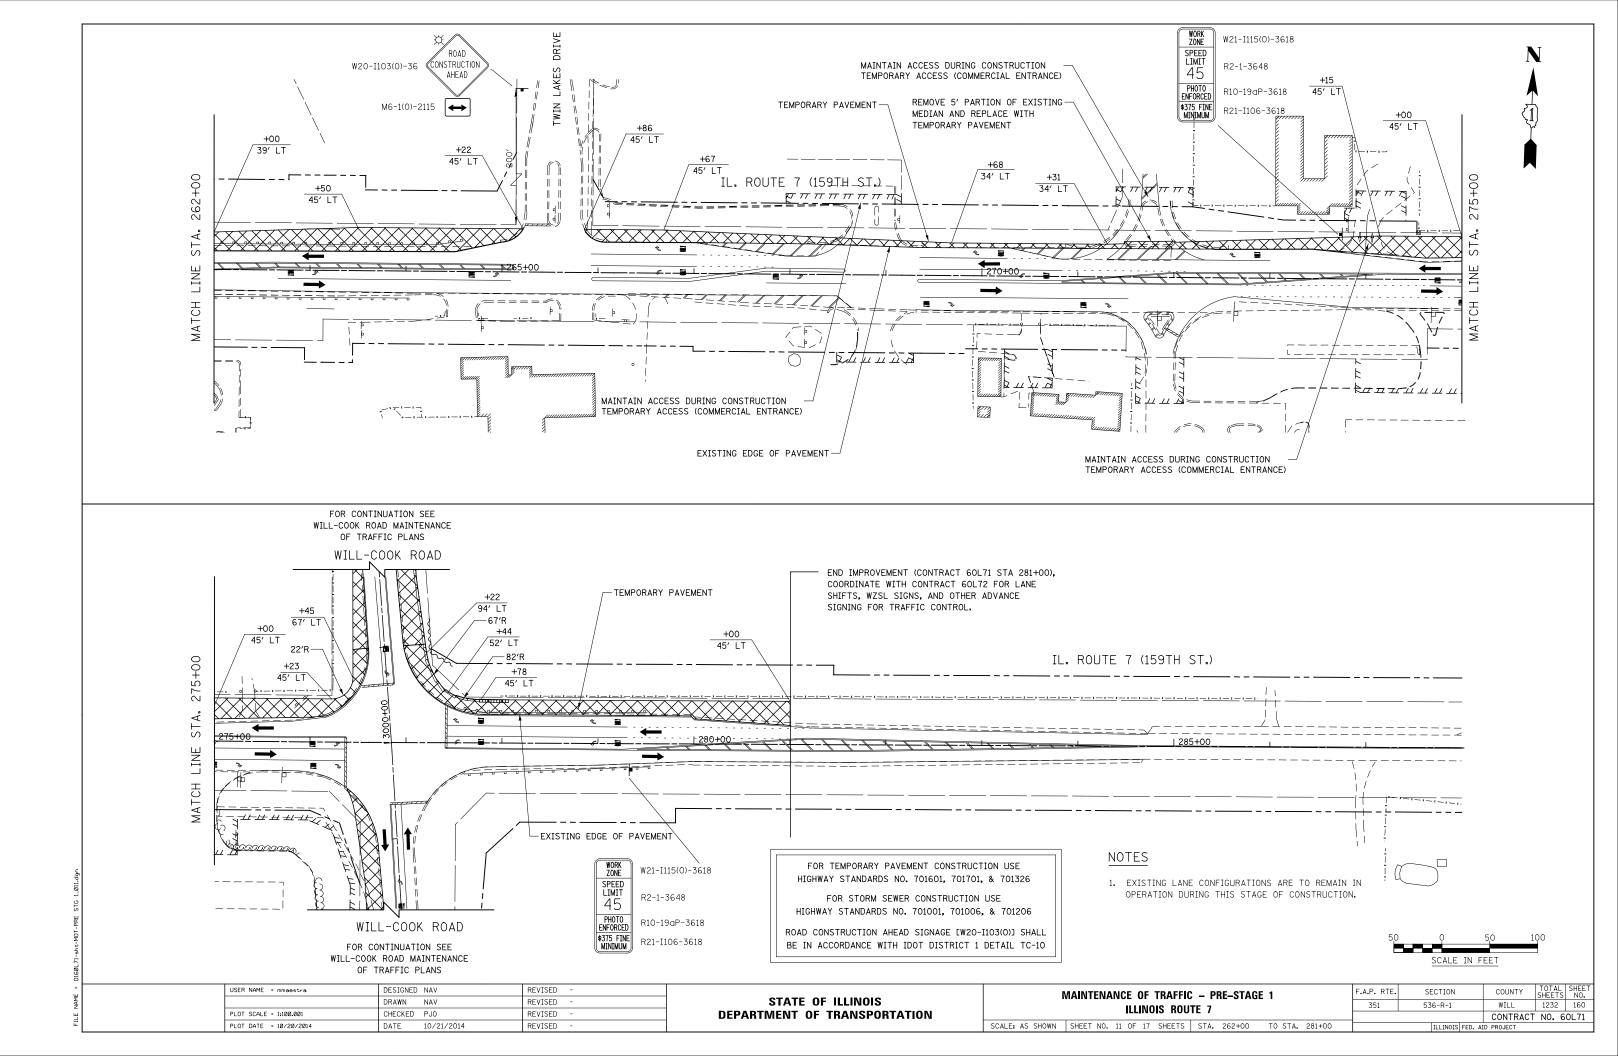


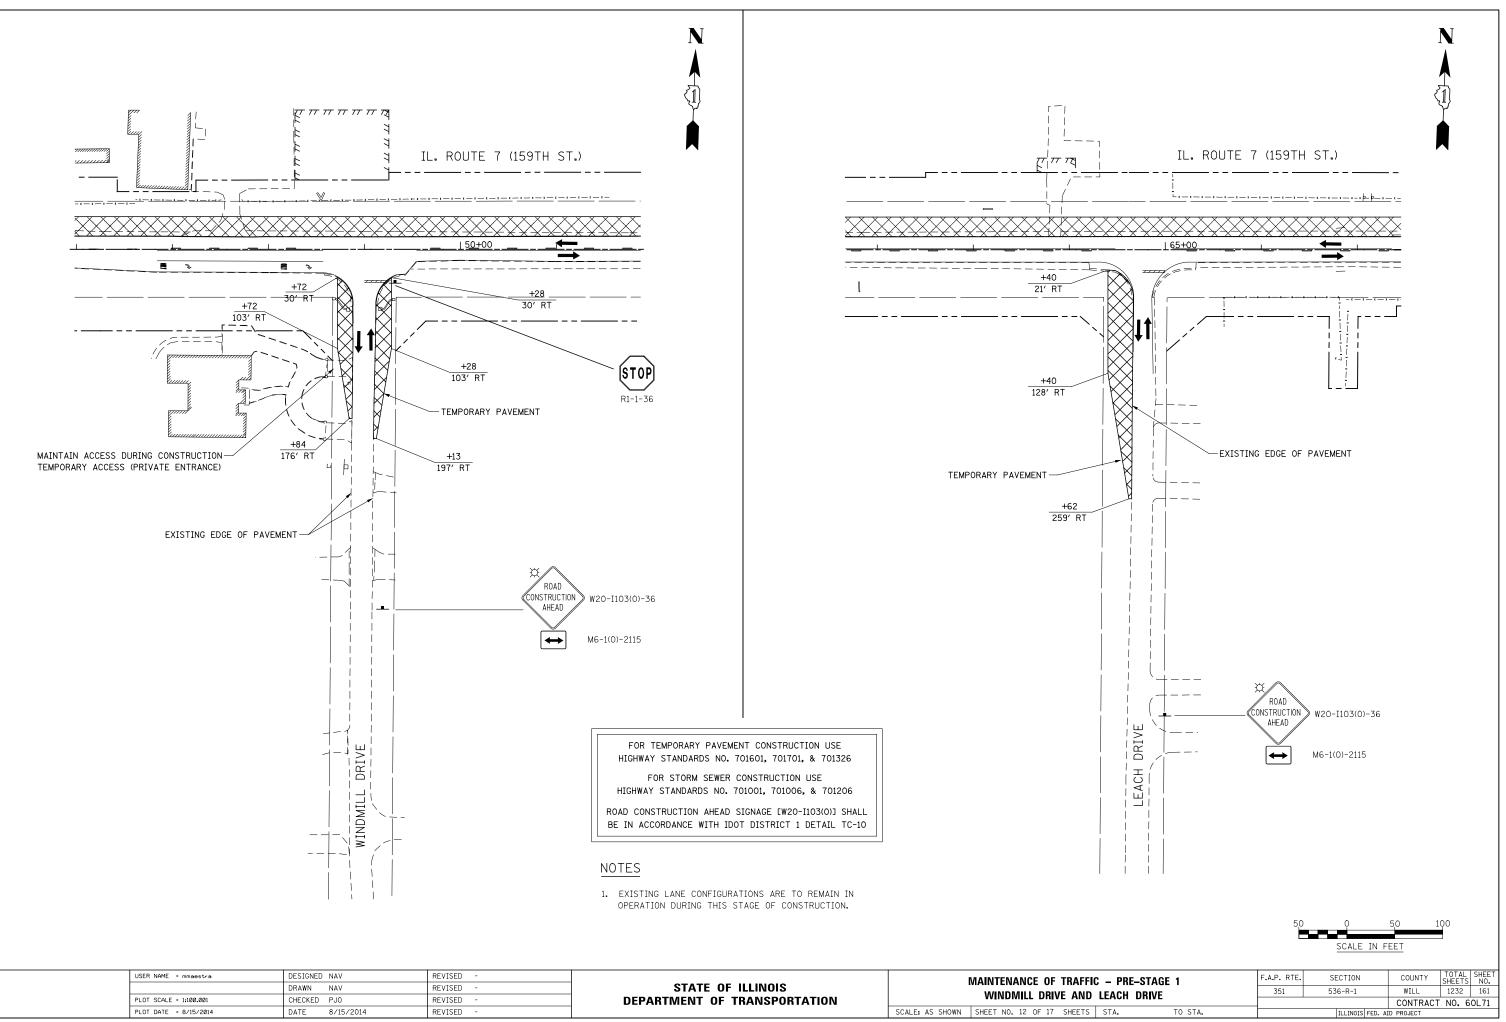

USER NAME = mmaestra	DESIGNED NAV	REVISED -		MAINTENANCE OF TRAFFIC
	DRAWN NAV	REVISED -	STATE OF ILLINOIS	
PLOT SCALE = 1:100.001	CHECKED PJ0	REVISED -	DEPARTMENT OF TRANSPORTATION	WINDMILL DRIVE AND L
PLOT DATE = 8/15/2014	DATE 8/15/2014	REVISED -		SCALE: AS SHOWN SHEET NO. 12 OF 17 SHEETS S

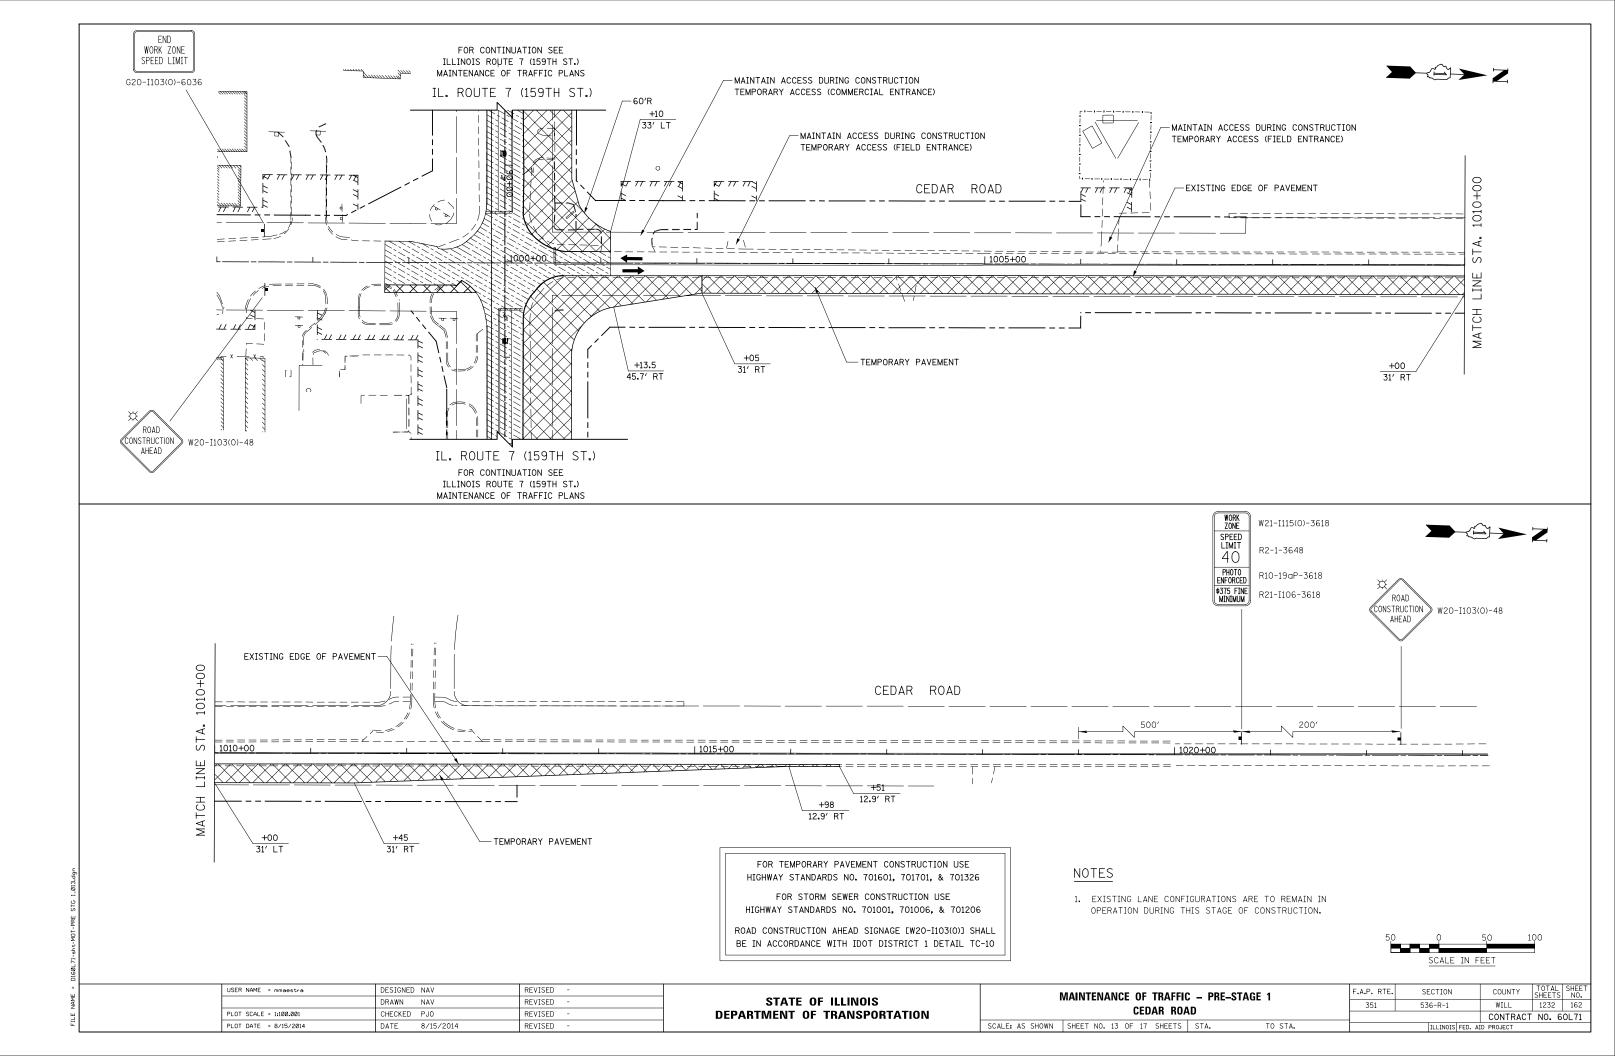


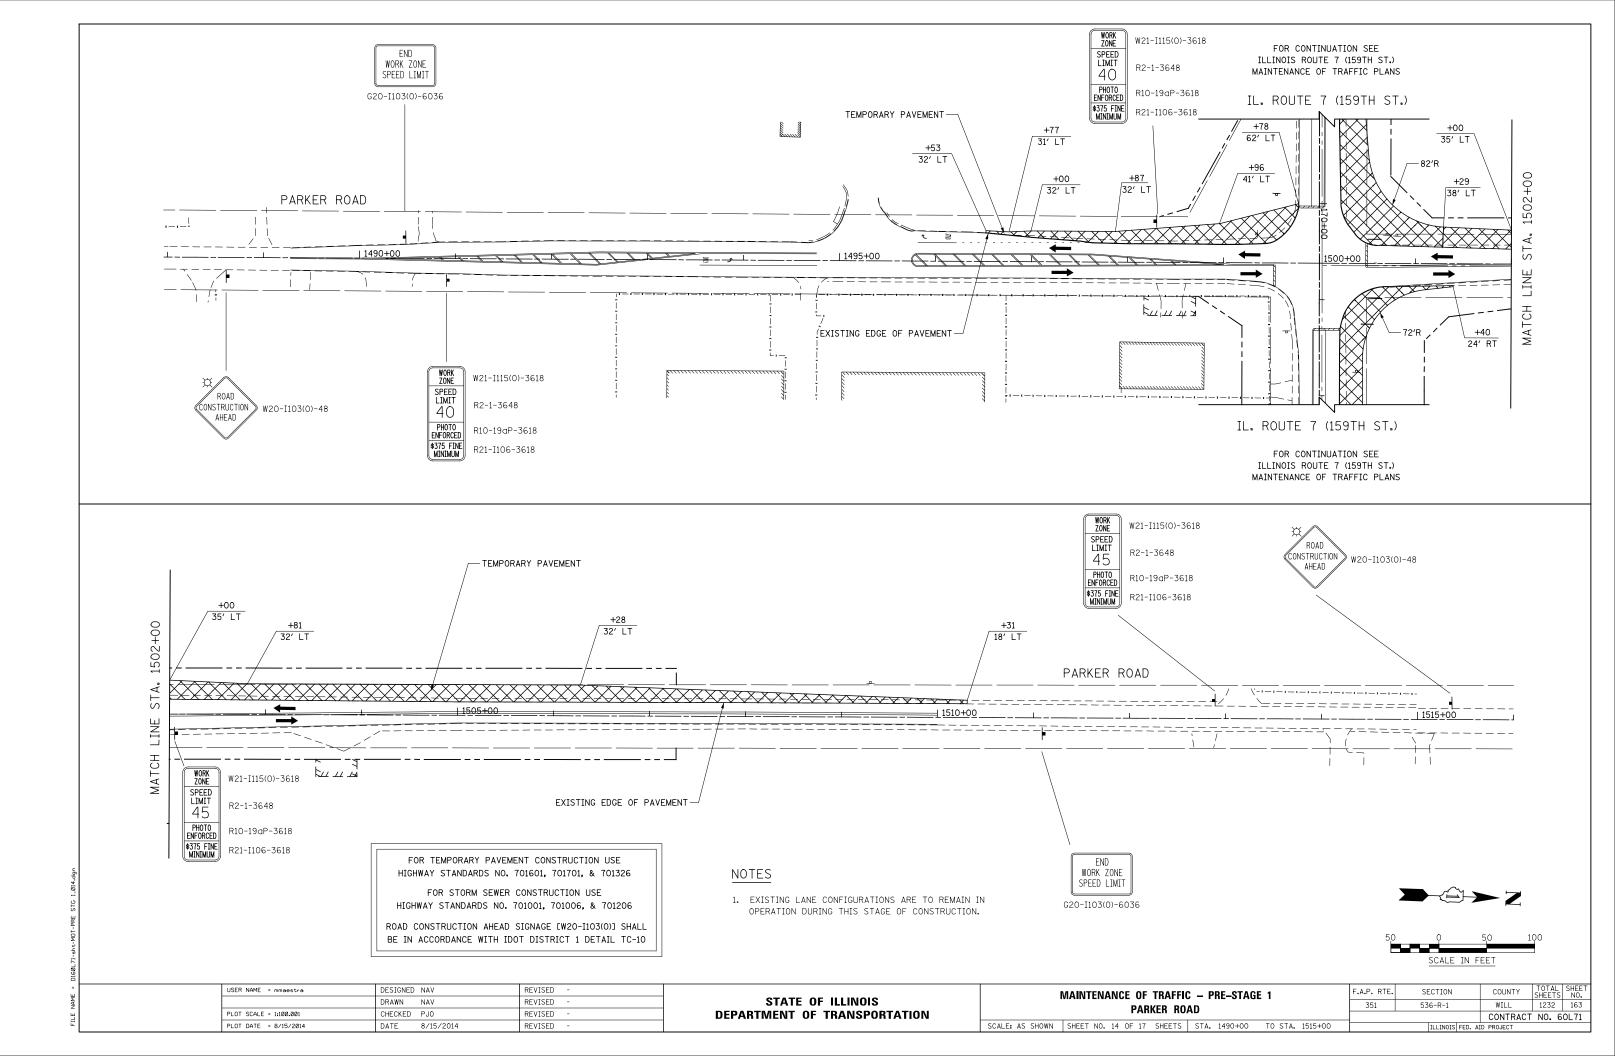

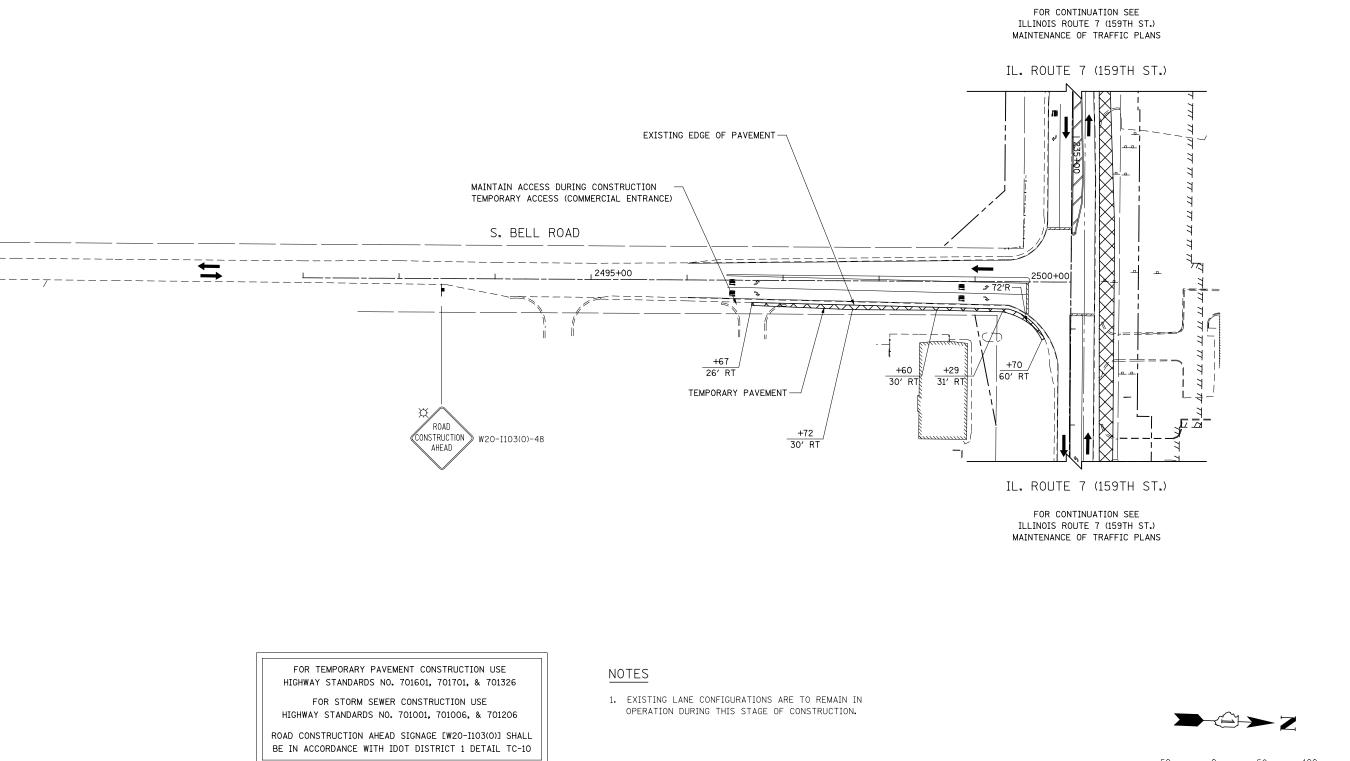

SCALE IN FEET

USER NAME = mmaestra	DESIGNED NAV	REVISED -		MAINTENANCE OF TRAFFIC – PRE-STAGE 1	F.A.P. RTE.	SECTION	COUNTY TOTAL SHEET
	DRAWN NAV	REVISED -	STATE OF ILLINOIS	SOUTH BELL ROAD	351	536-R-1	WILL 1232 164
PLOT SCALE = 1:100.001	CHECKED PJO	REVISED -	DEPARTMENT OF TRANSPORTATION	SUUIN BELL RUAD			CONTRACT NO. 60L71
PLOT DATE = 8/15/2014	DATE 8/15/2014	REVISED -		SCALE: AS SHOWN SHEET NO. 15 OF 17 SHEETS STA. 2492+00 TO STA. 2500+00		ILLINOIS FED. /	ID PROJECT

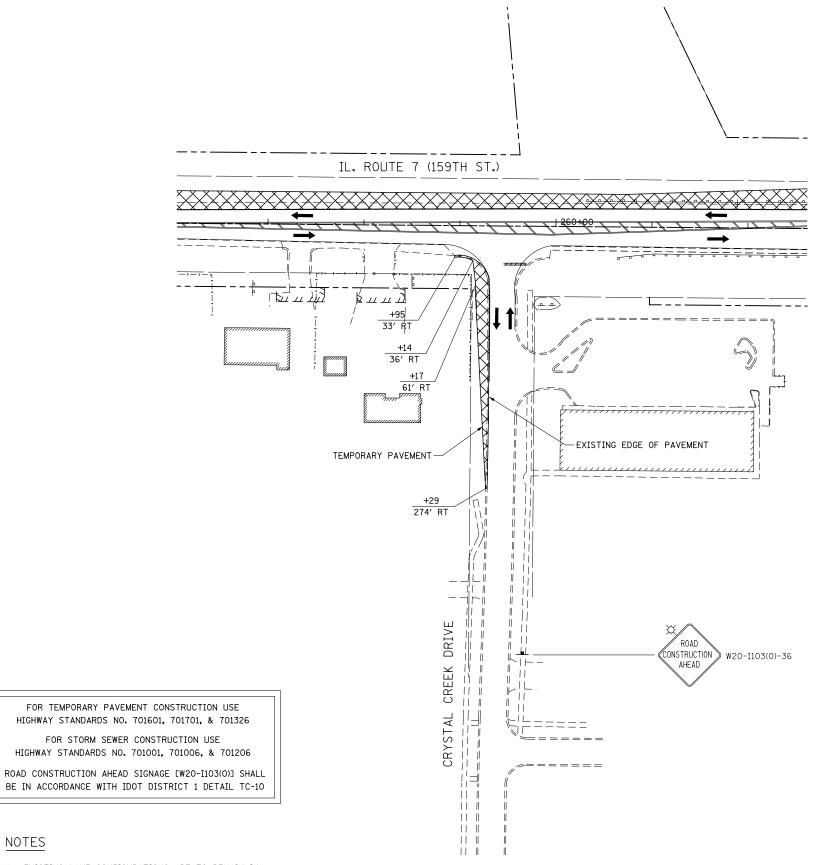


1. EXISTING LANE CONFIGURATIONS ARE TO REMAIN IN OPERATION DURING THIS STAGE OF CONSTRUCTION.

NOTES


USER NAME = mmæestræ	DESIGNED NAV	REVISED -	STATE OF ILLINOIS MAINTENANCE OF TRAFFIC – PRE–STAGE 1 F. DEPARTMENT OF TRANSPORTATION CRYSTAL CREEK DRIVE		MAINTENANCE OF TRAFFIC – PRE-STAGE 1	F.A.P. RTE.	SECTION	COUNTY	TOTAL SHEET SHEETS NO.		
	DRAWN NAV	REVISED -			351	536-R-1	WILL	1232 165			
PLOT SCALE = 1:100.001	CHECKED PJ0	REVISED -					CONTRACT	NO. 60L71			
PLOT DATE = 8/18/2014	DATE 8/15/2014	REVISED -		SCALE: AS SHOWN SHEET NO. 16 OF 17 SHEETS STA. TO STA.		SCALE: AS SHOWN SHEET NO. 16 OF 17 SHEETS STA. TO STA.			ILLINOIS FED.	AID PROJECT	





50	ò	50	100
	SCALE	IN FEET	

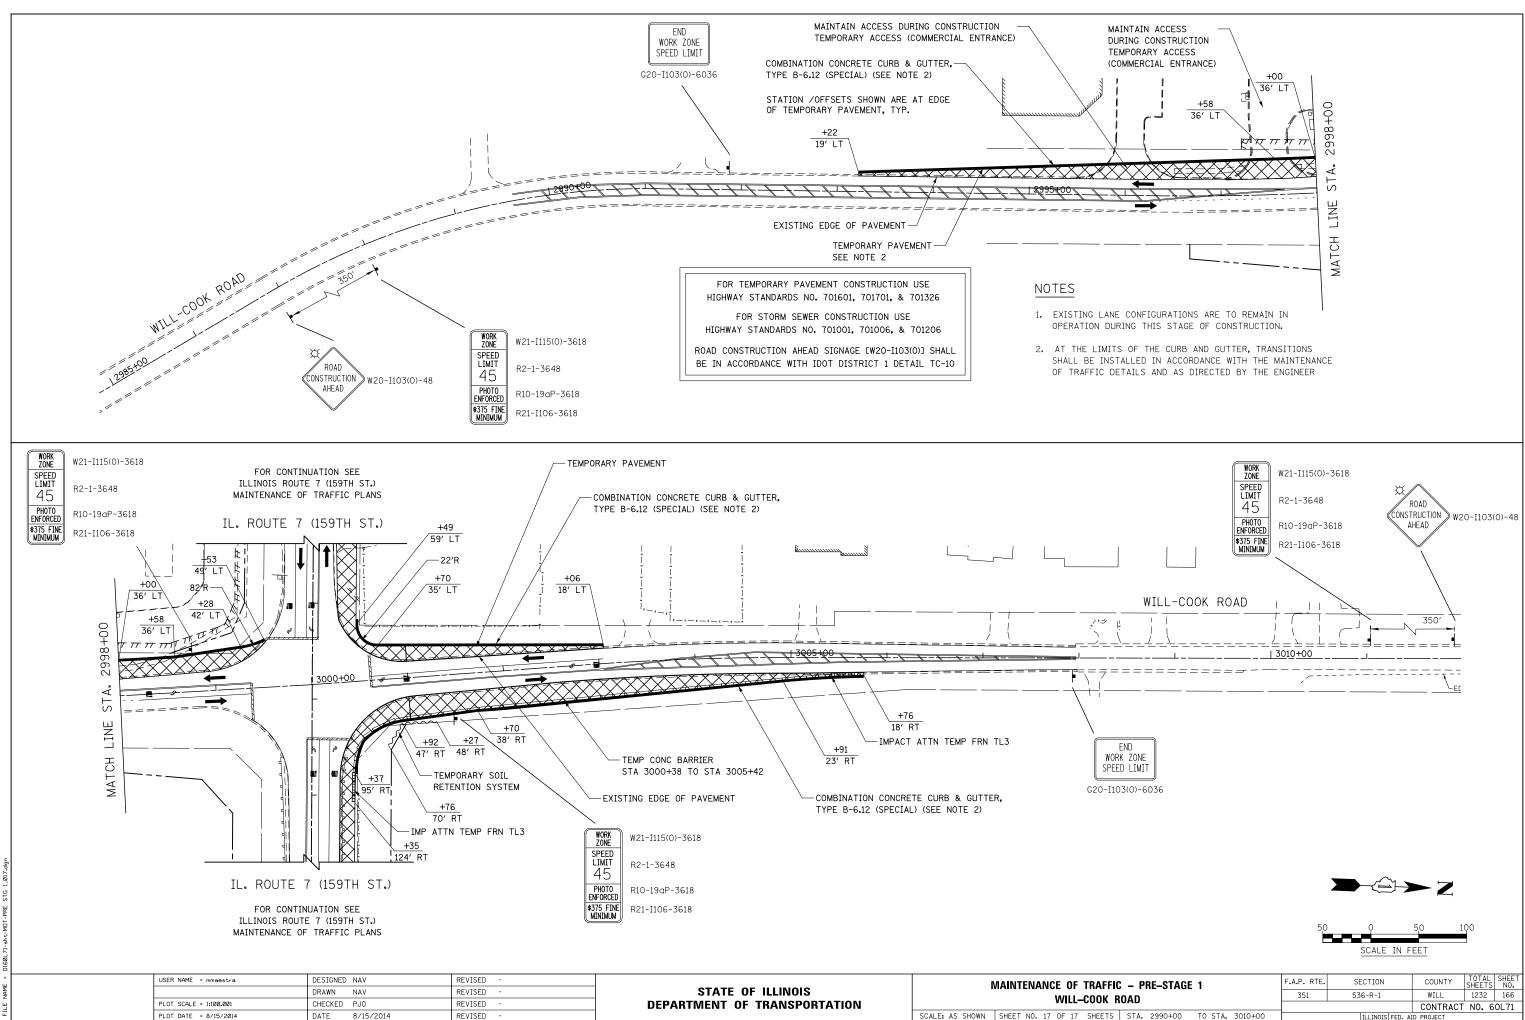



ILE NAME = DIG

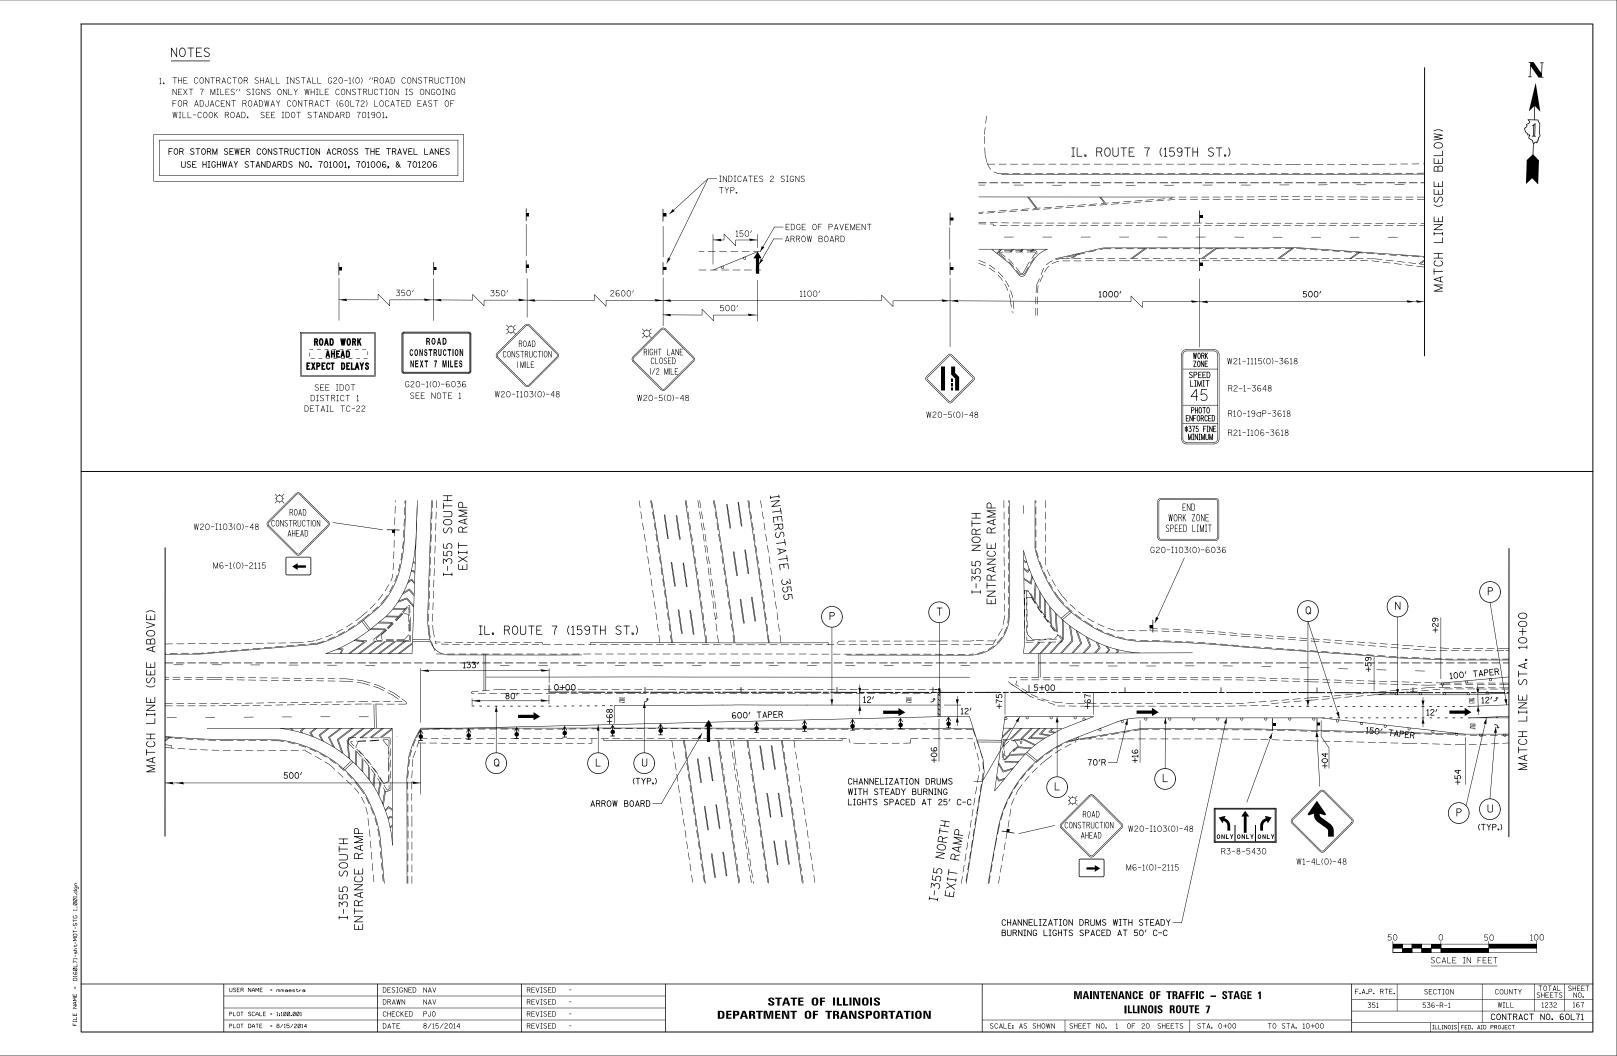


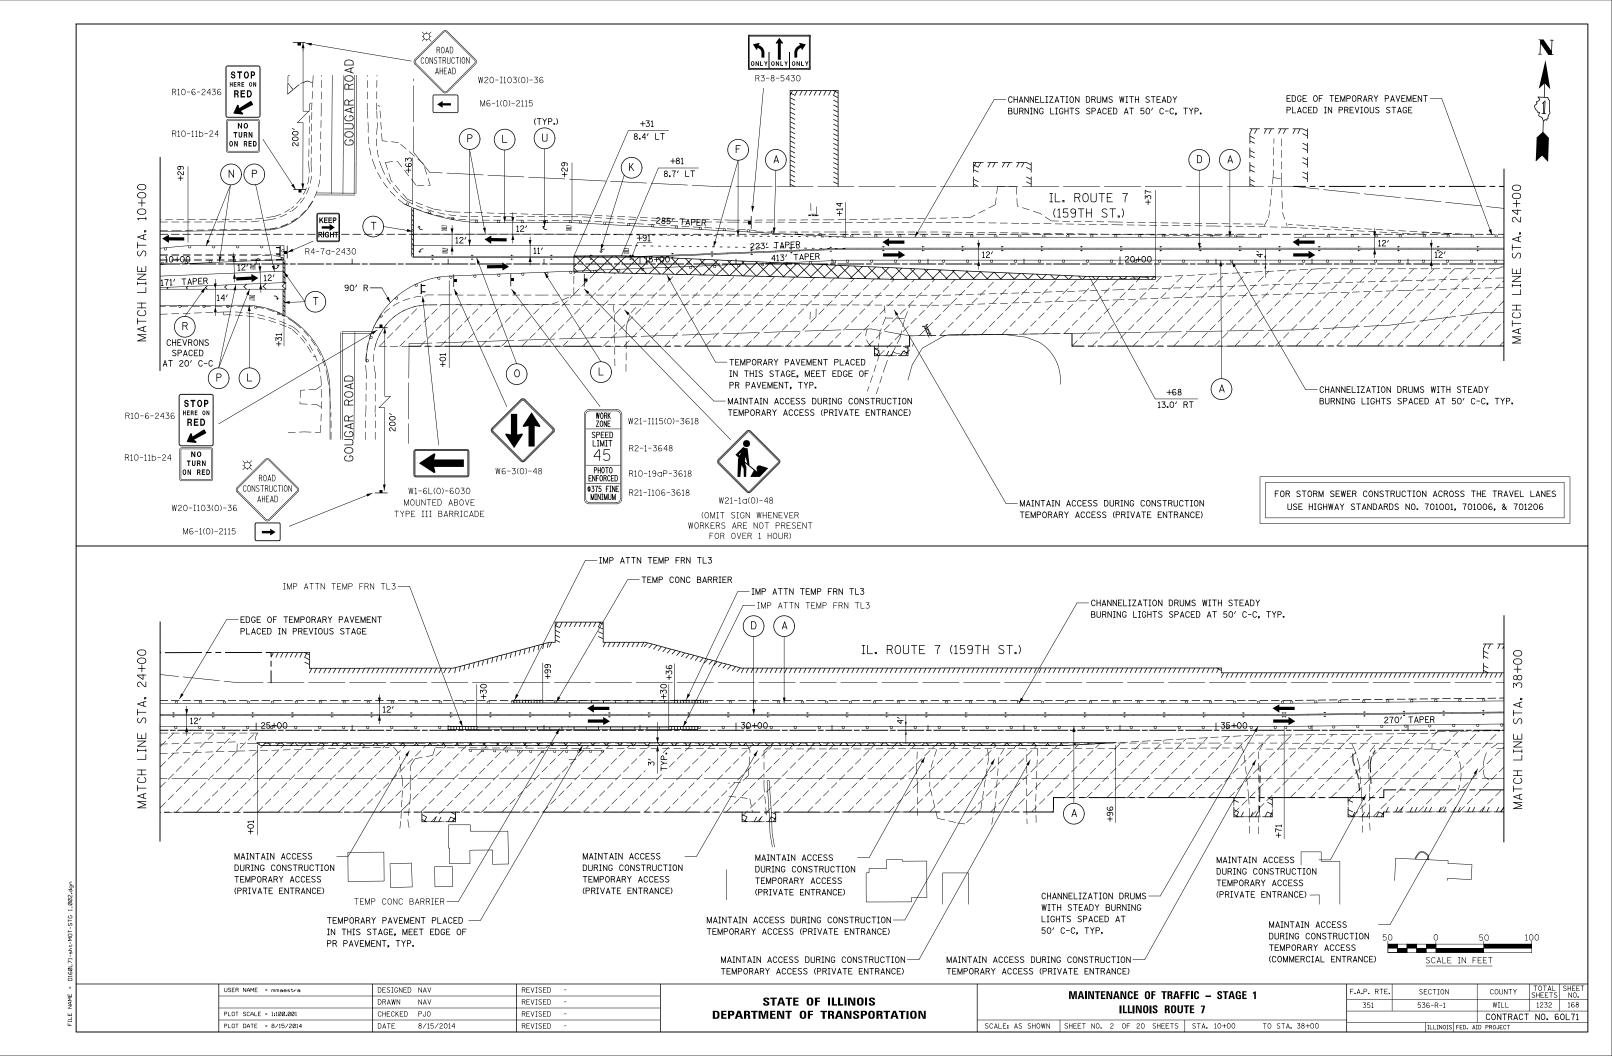


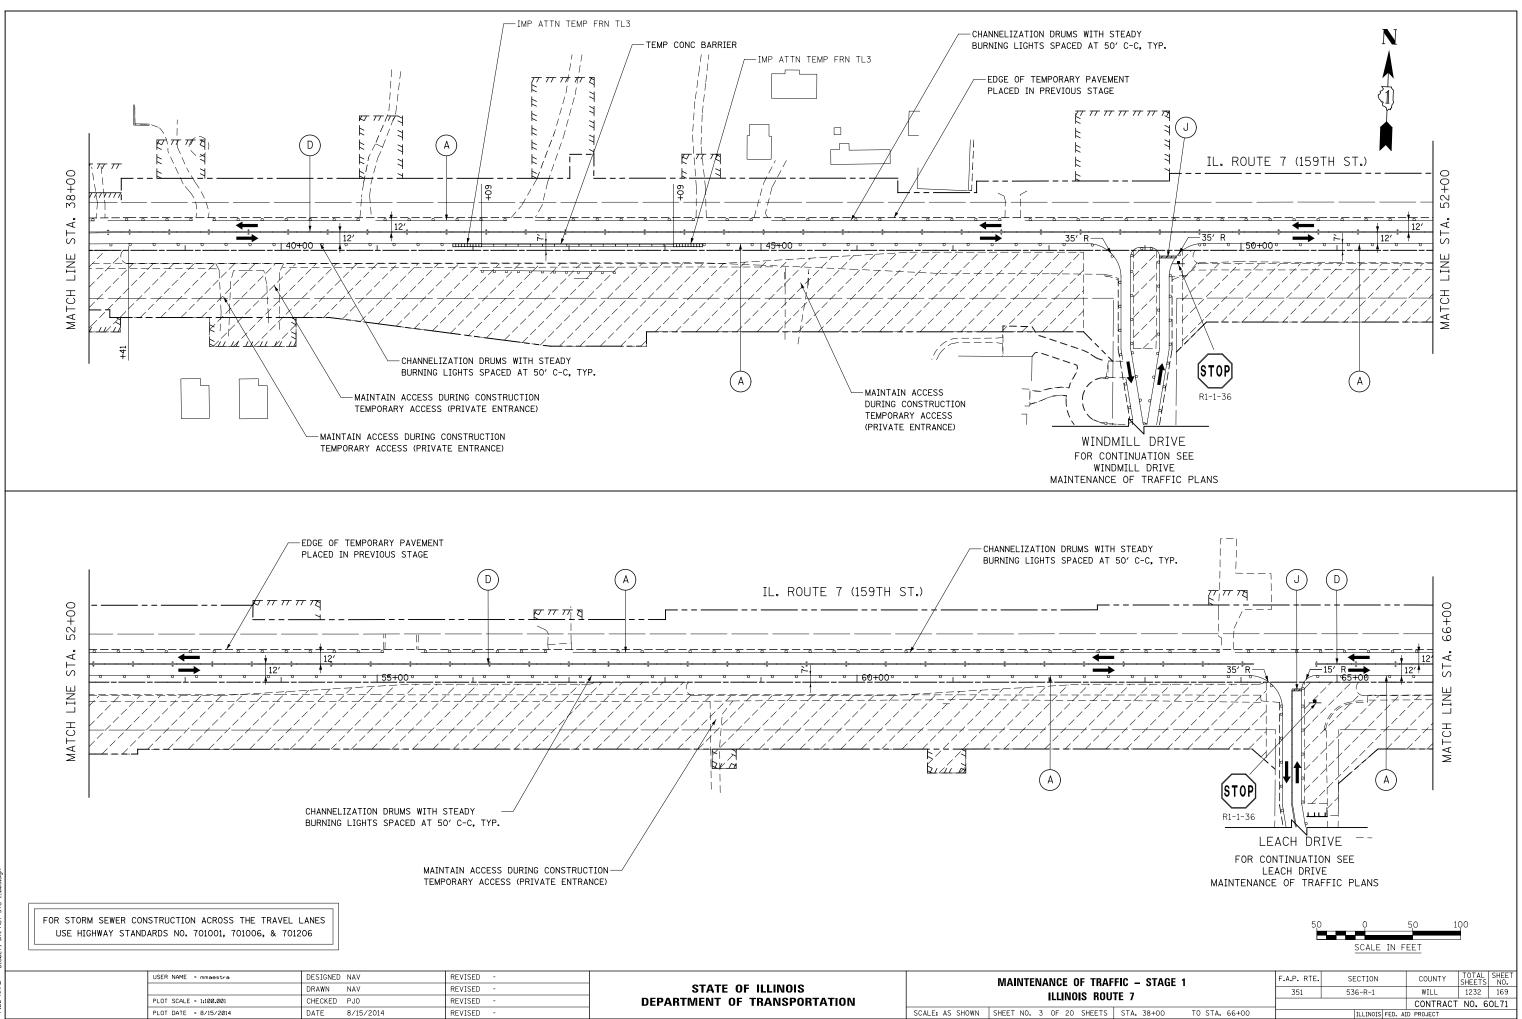

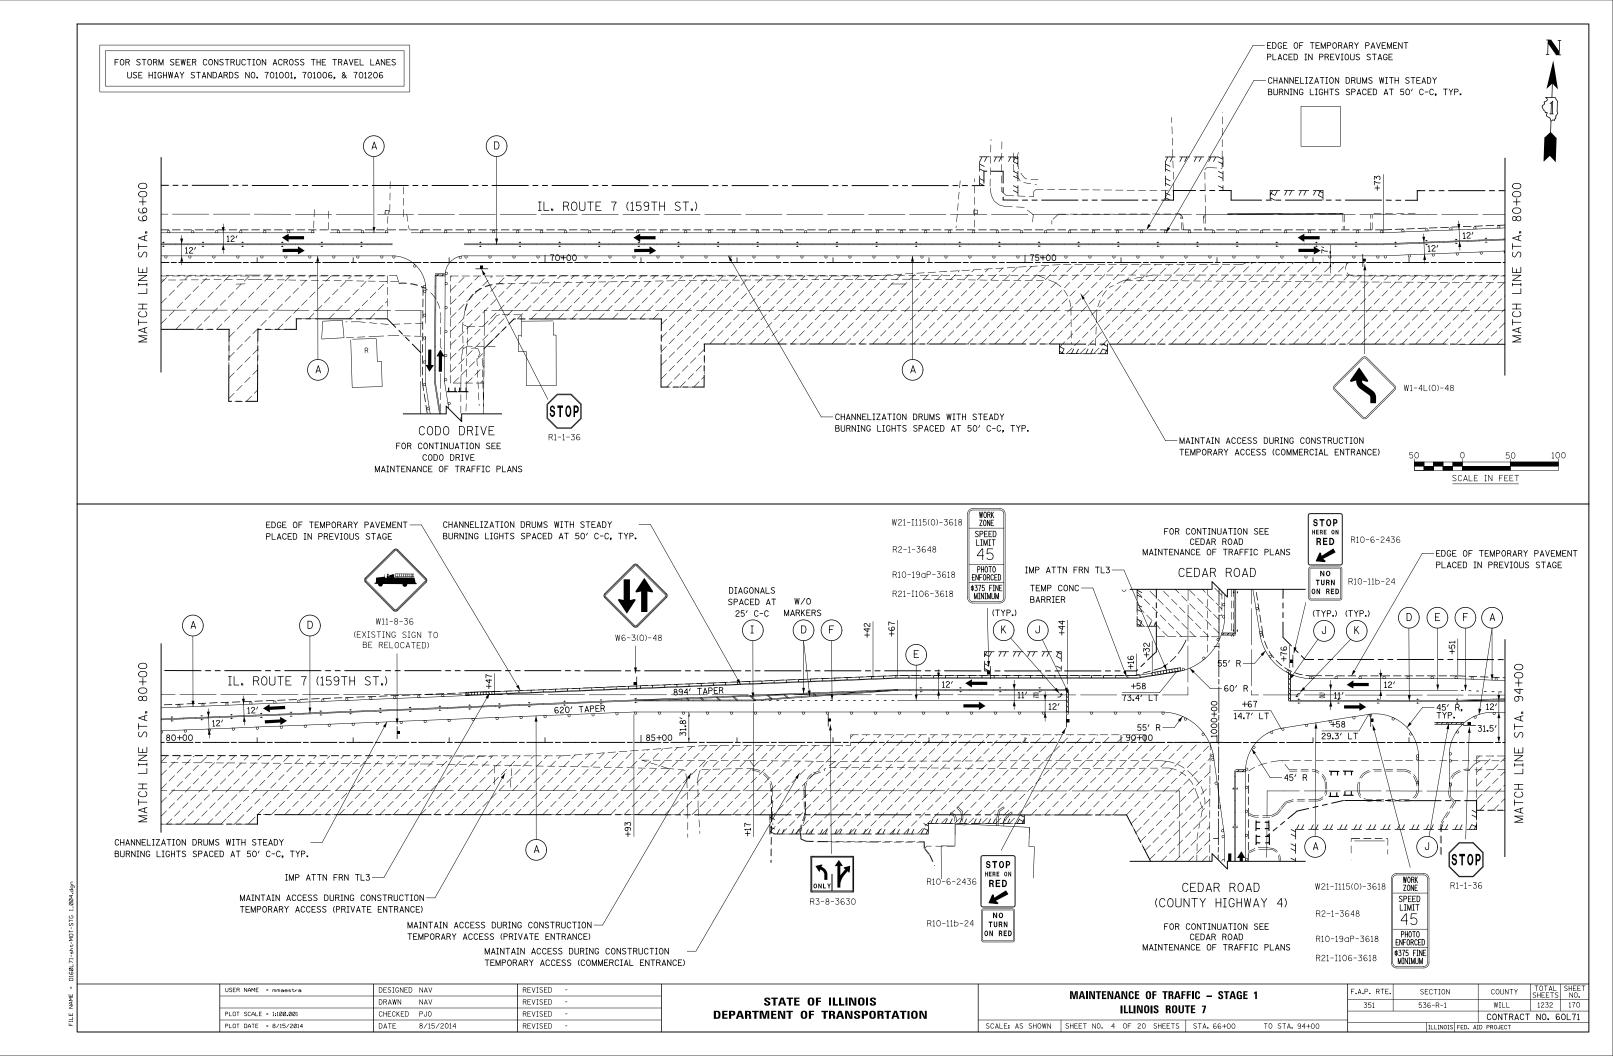


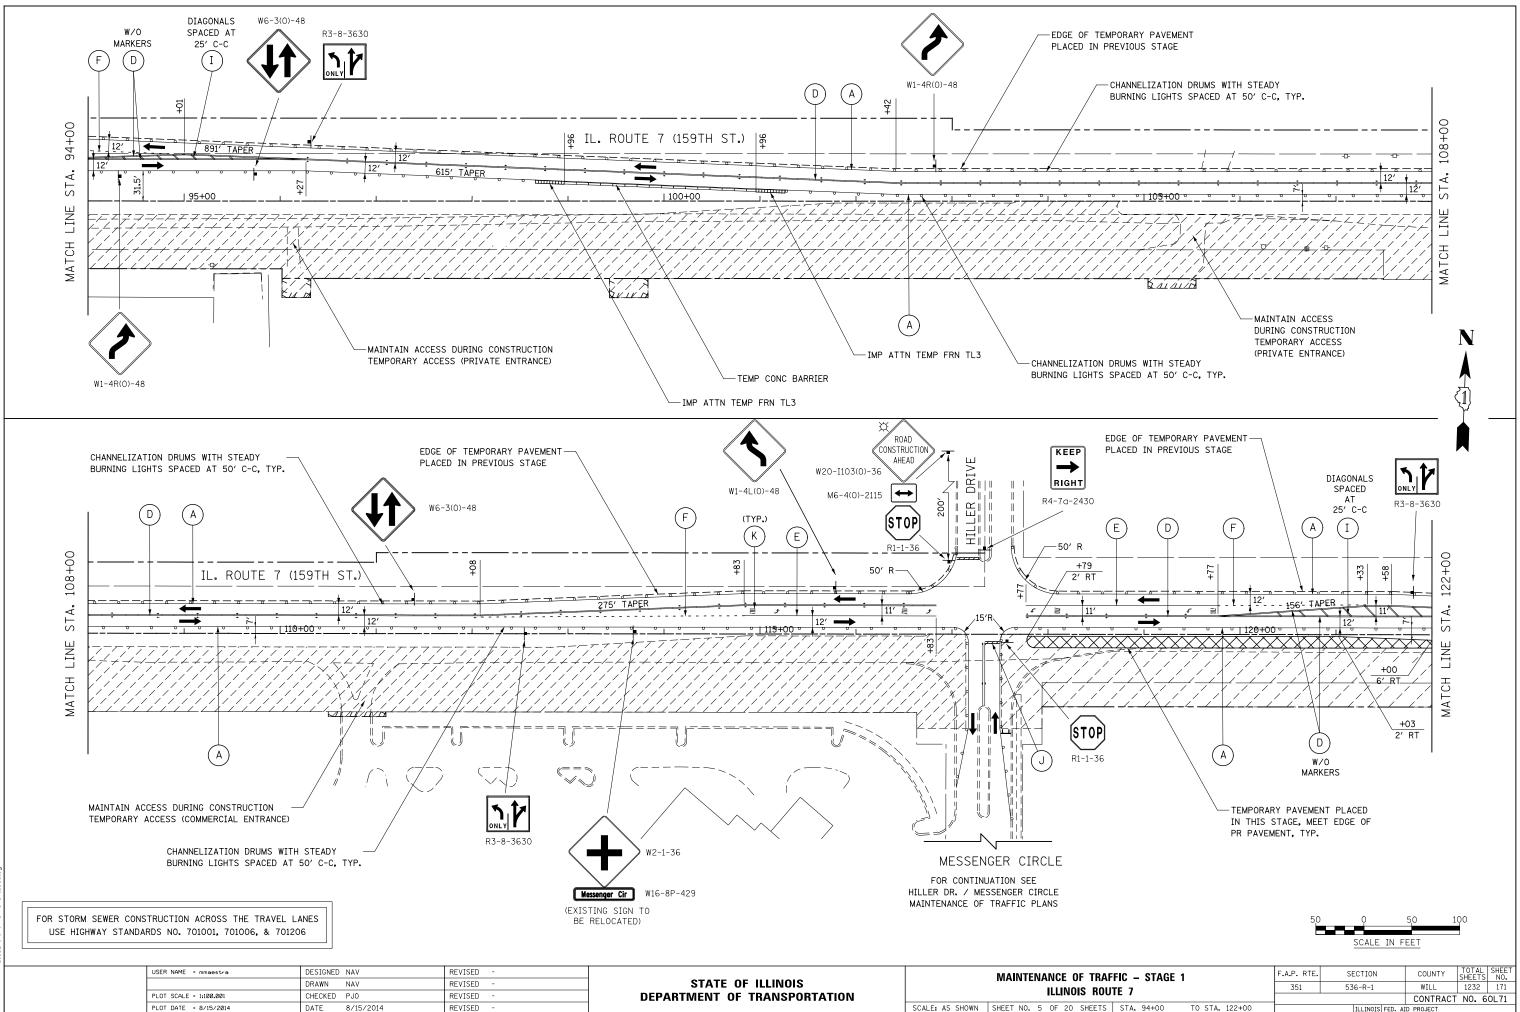


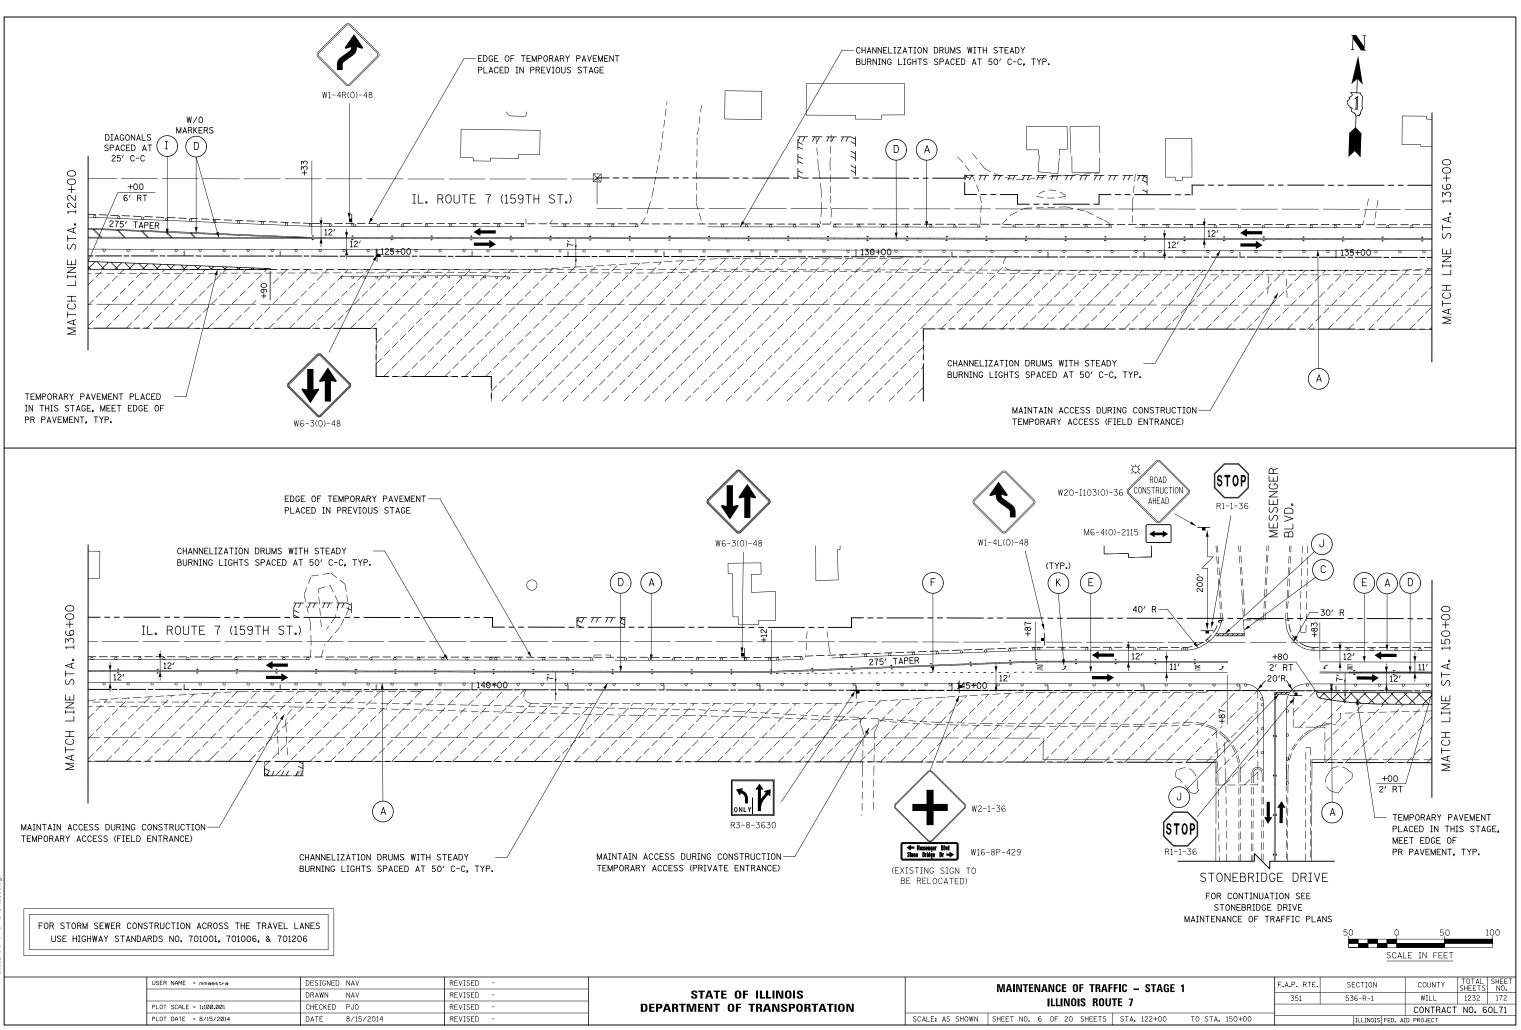


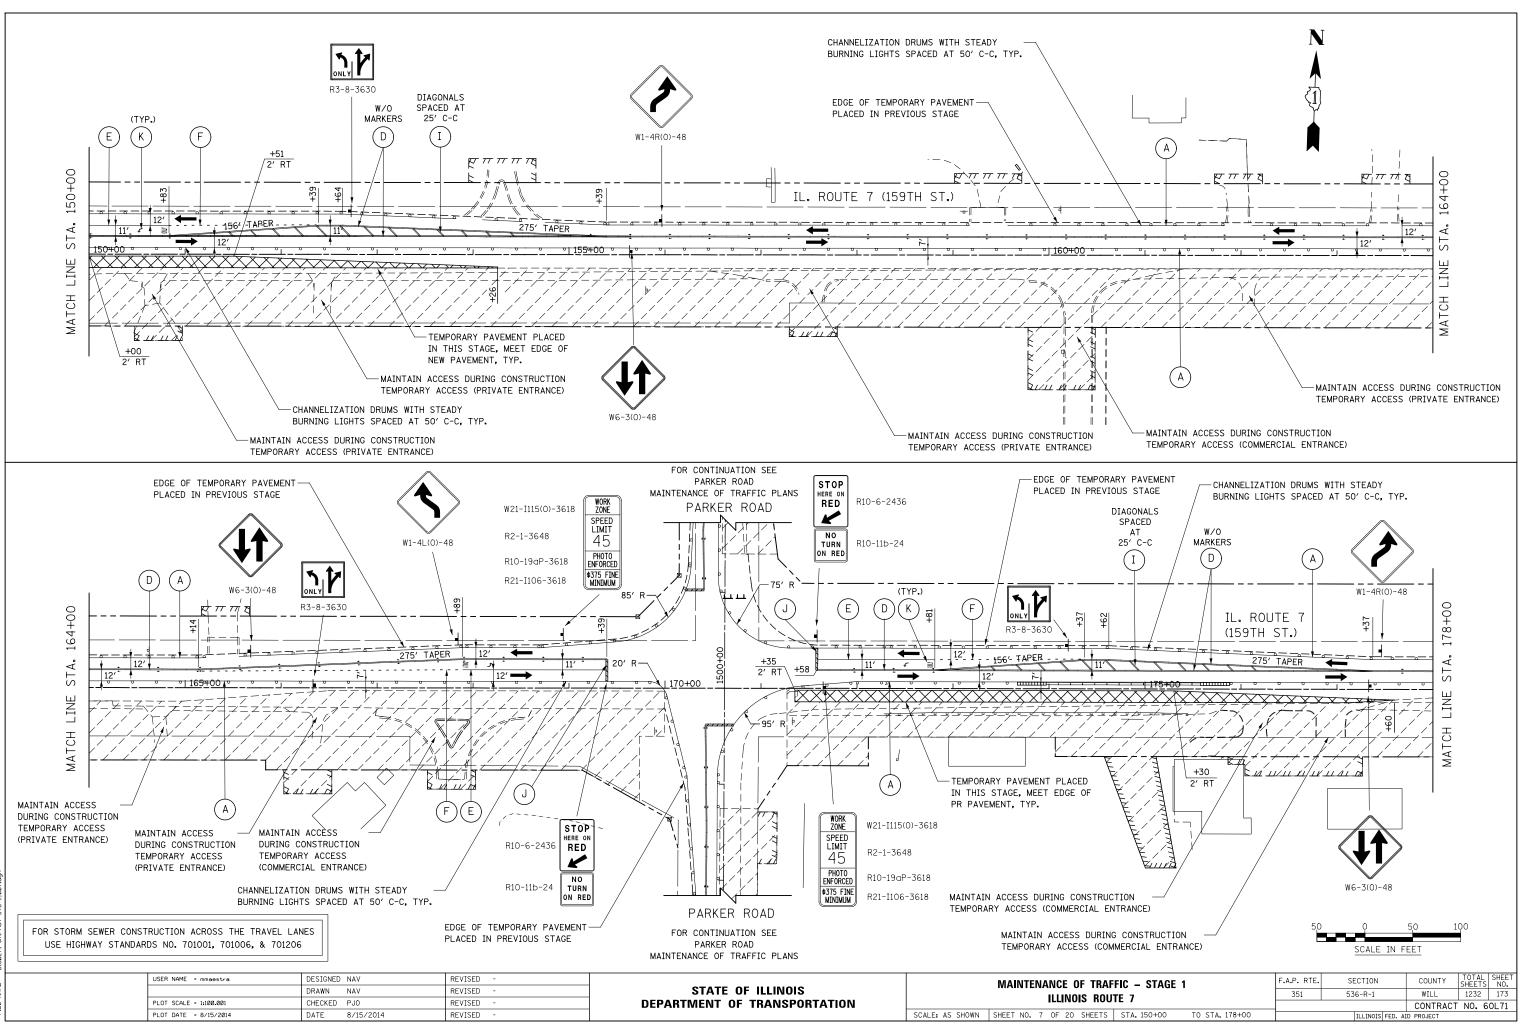



'AME = D160L71-sht-M0T-STG 1\_007.dgn

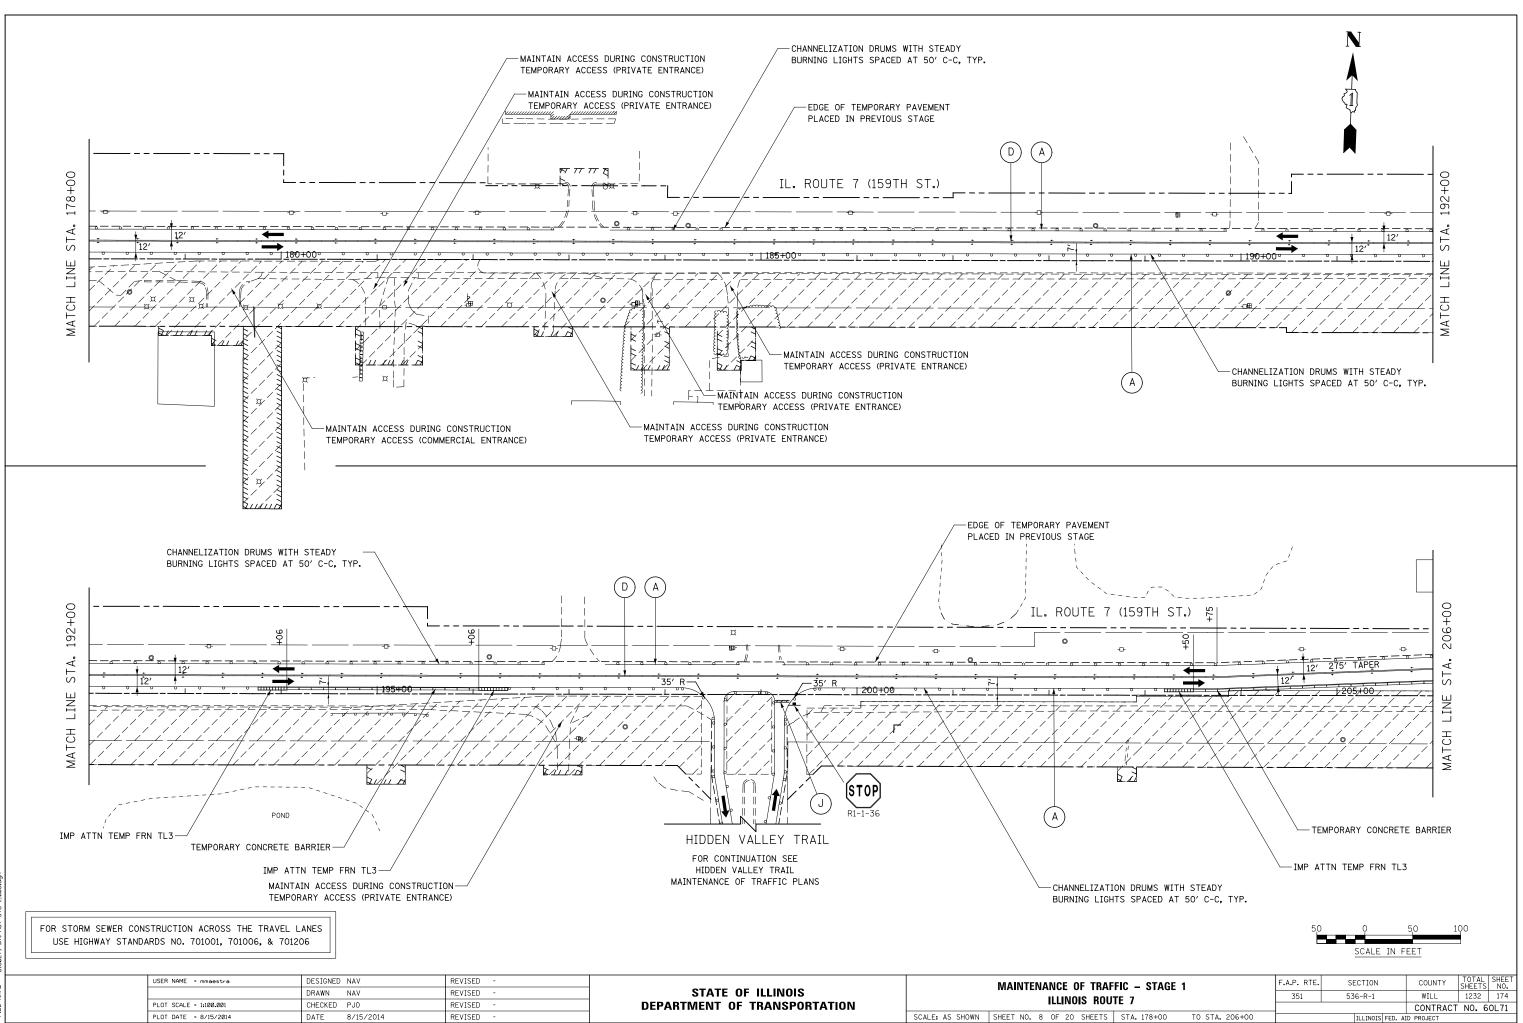


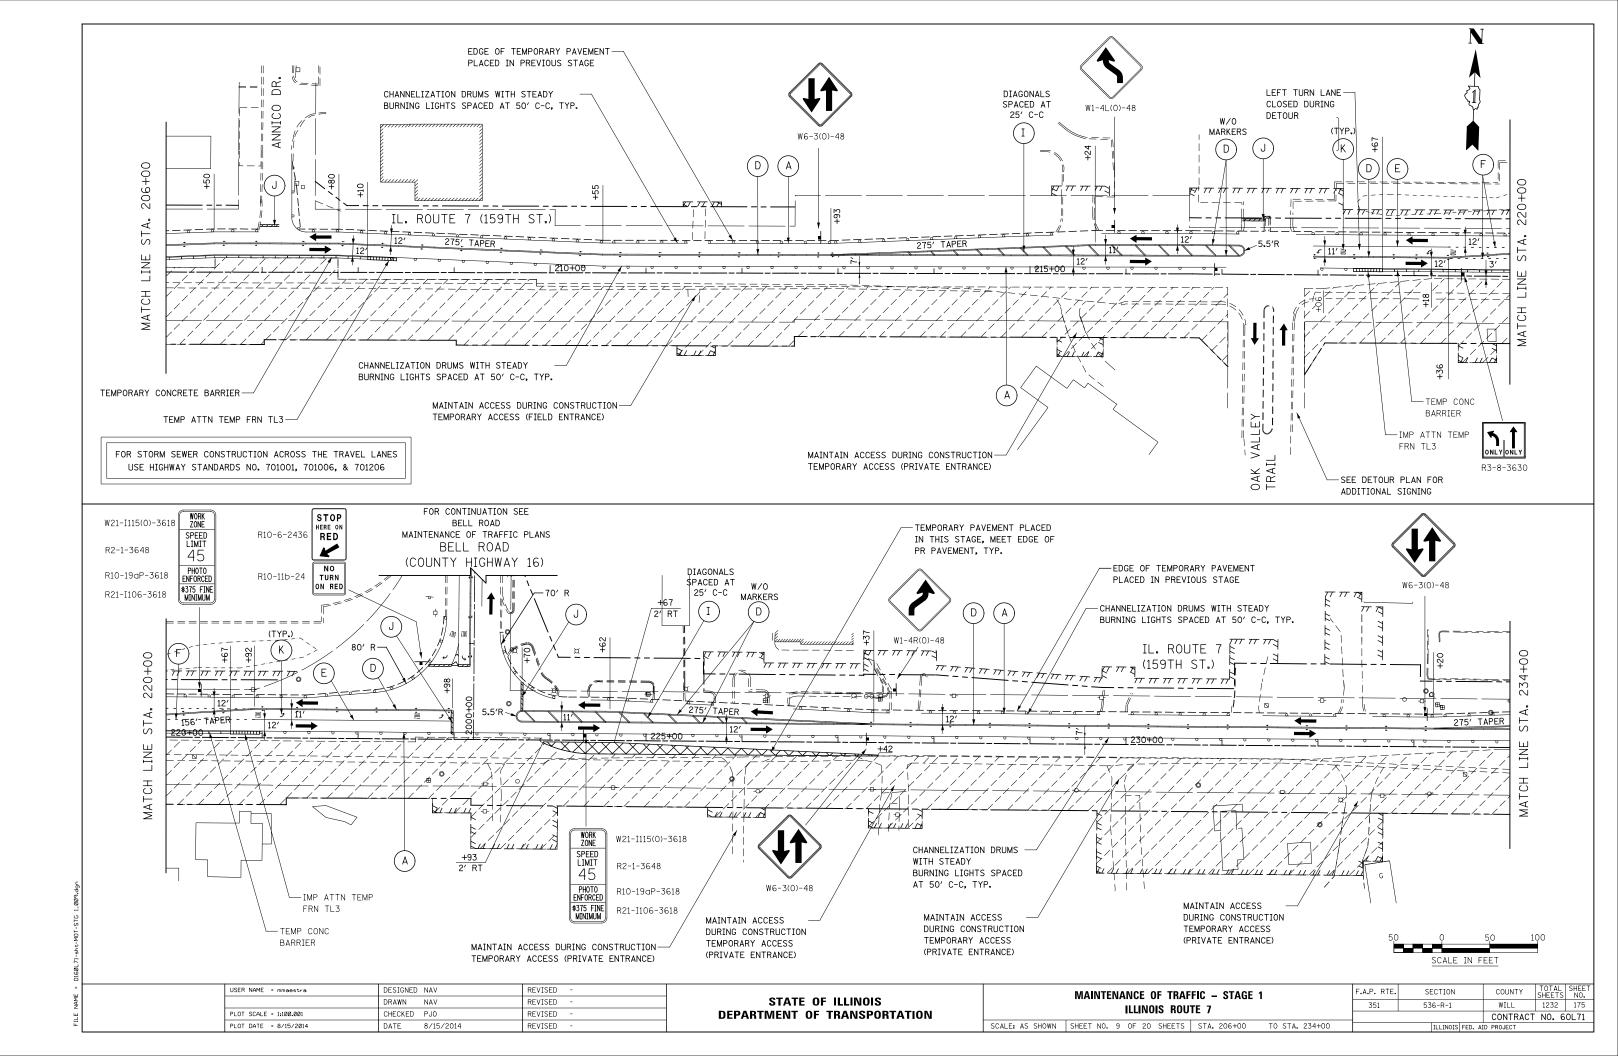


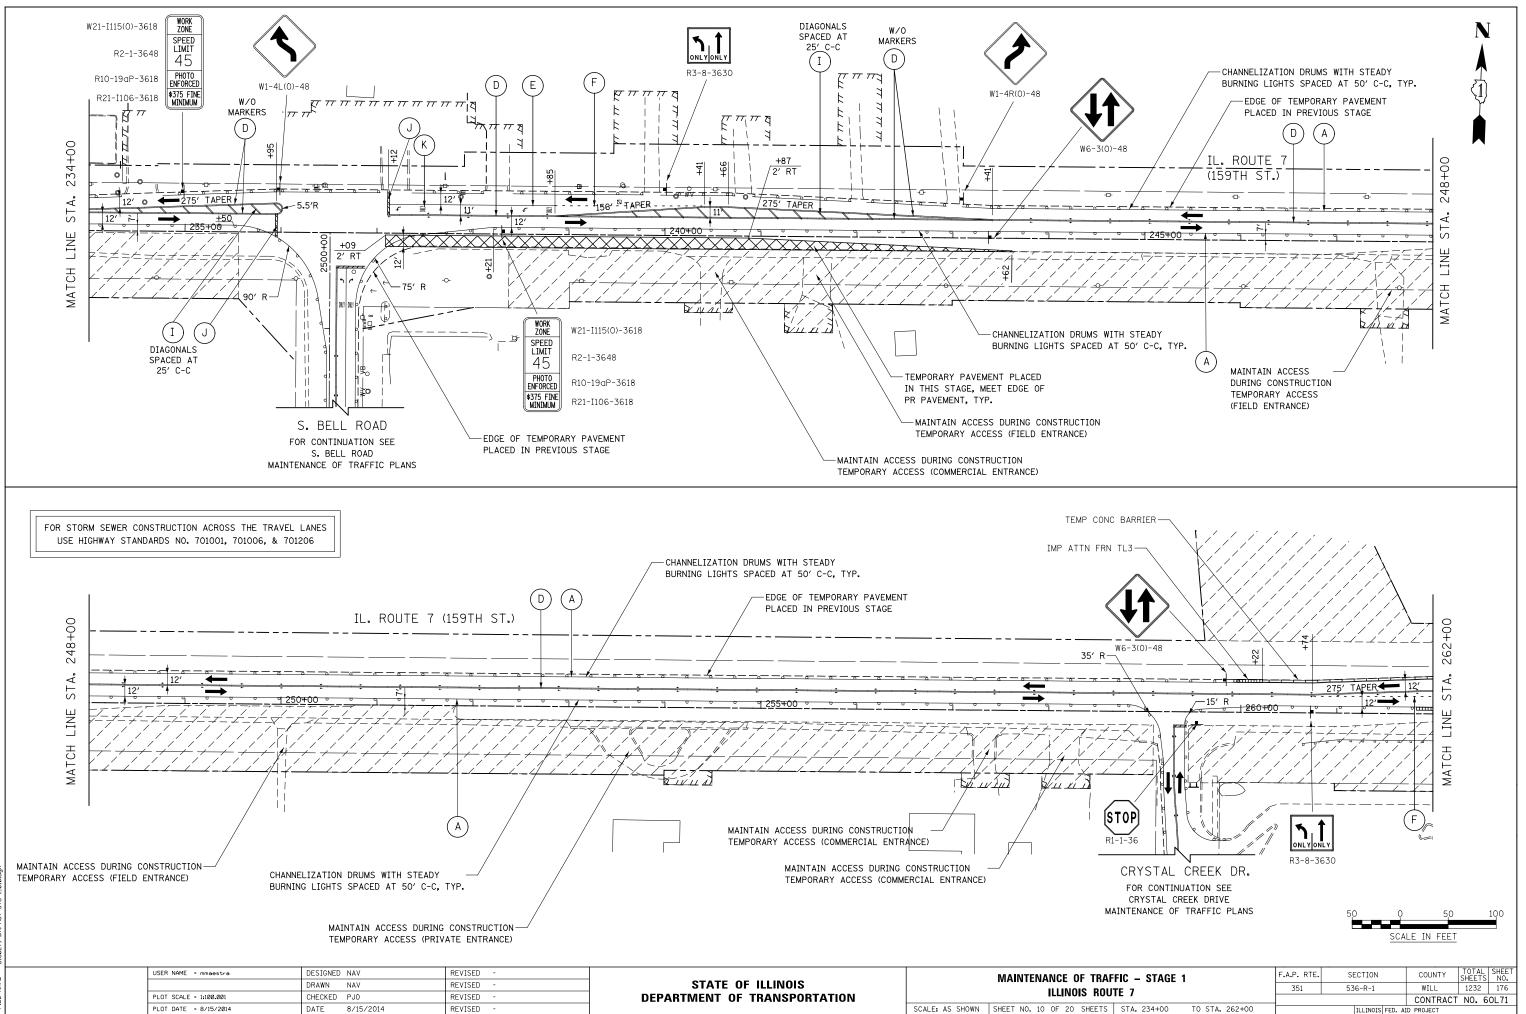


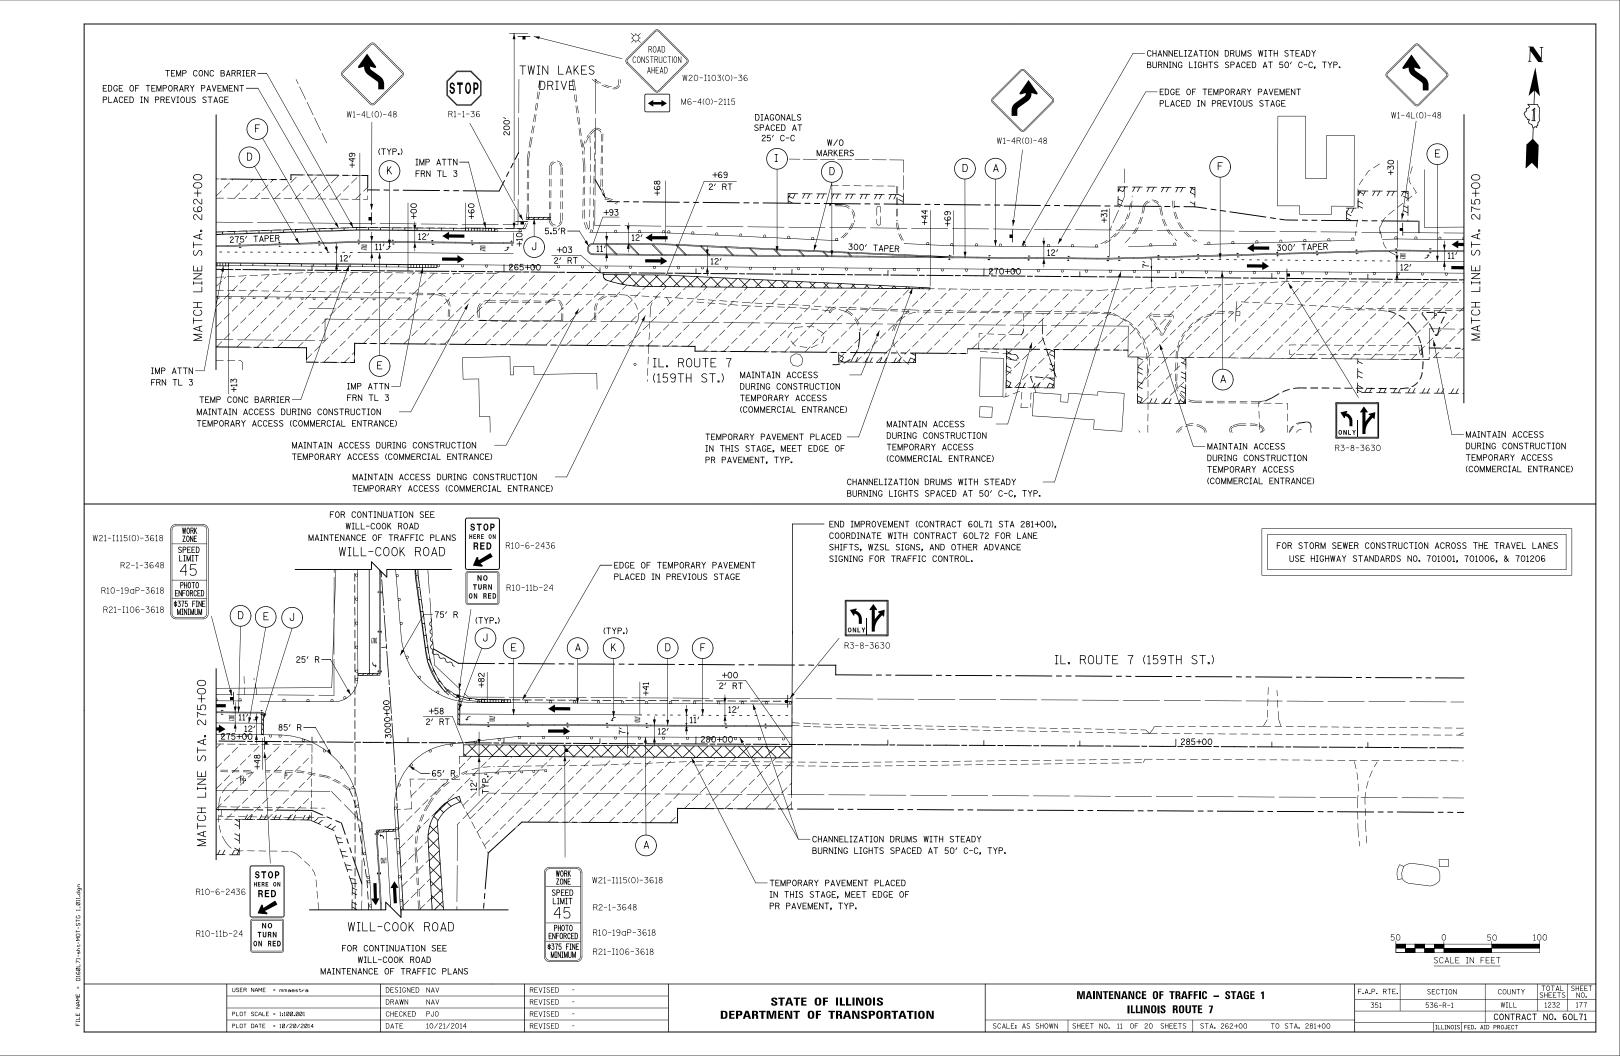


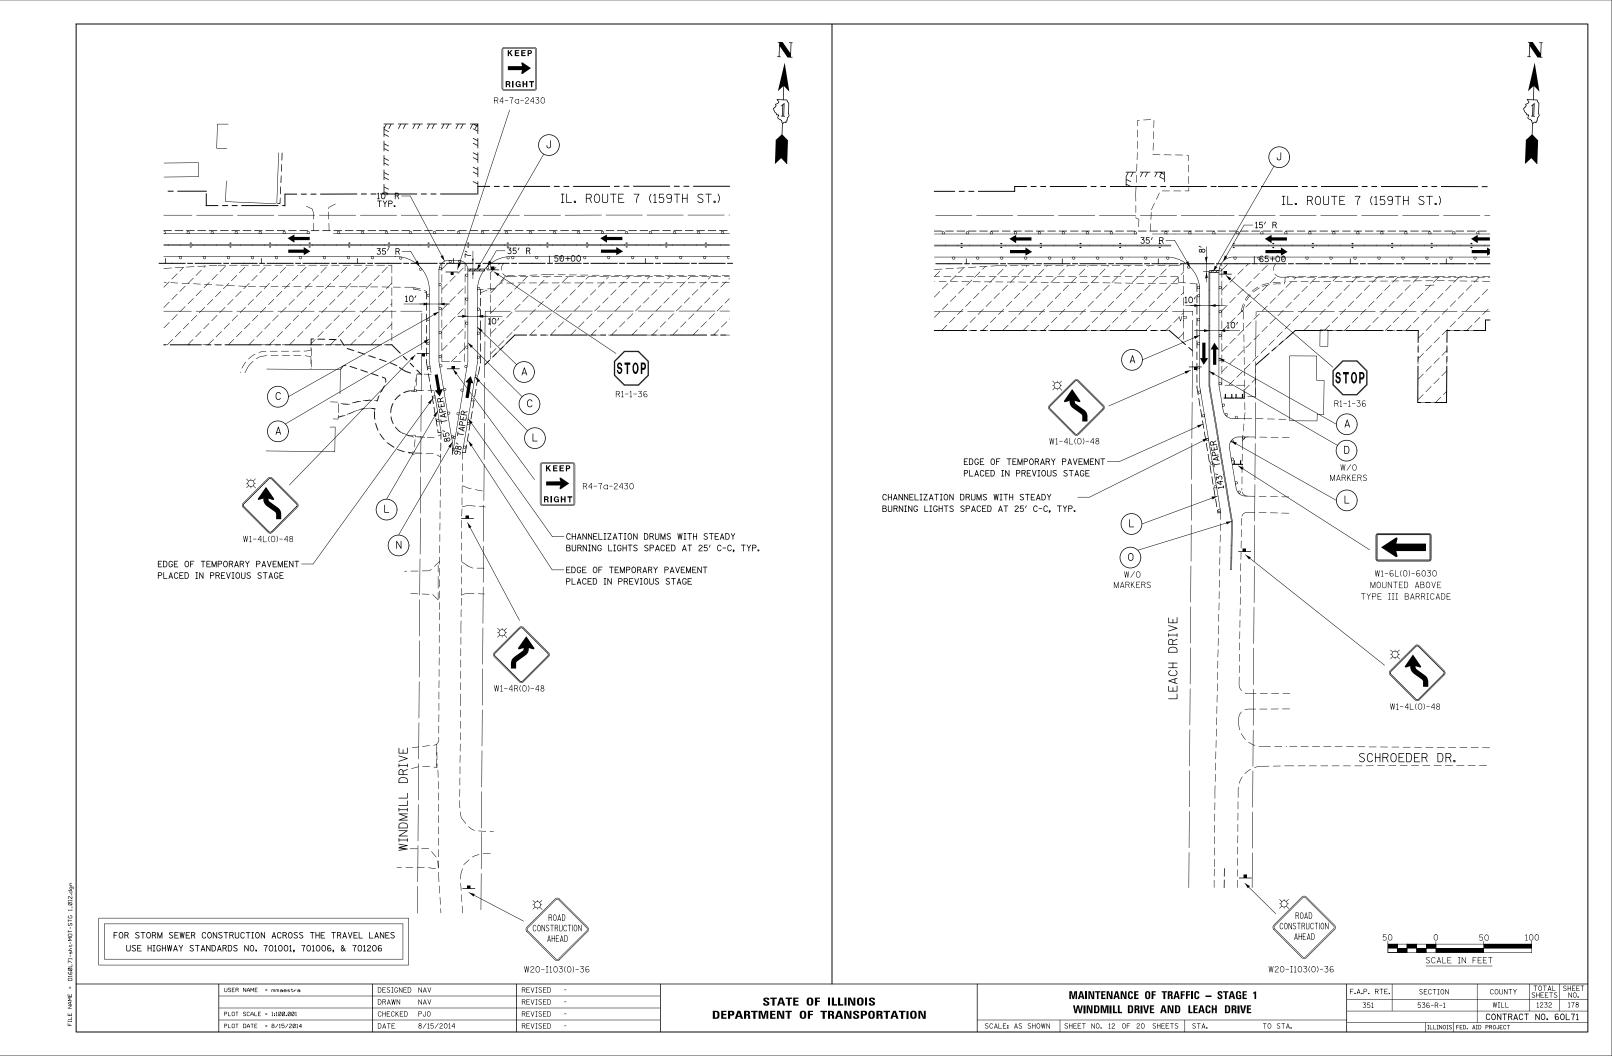


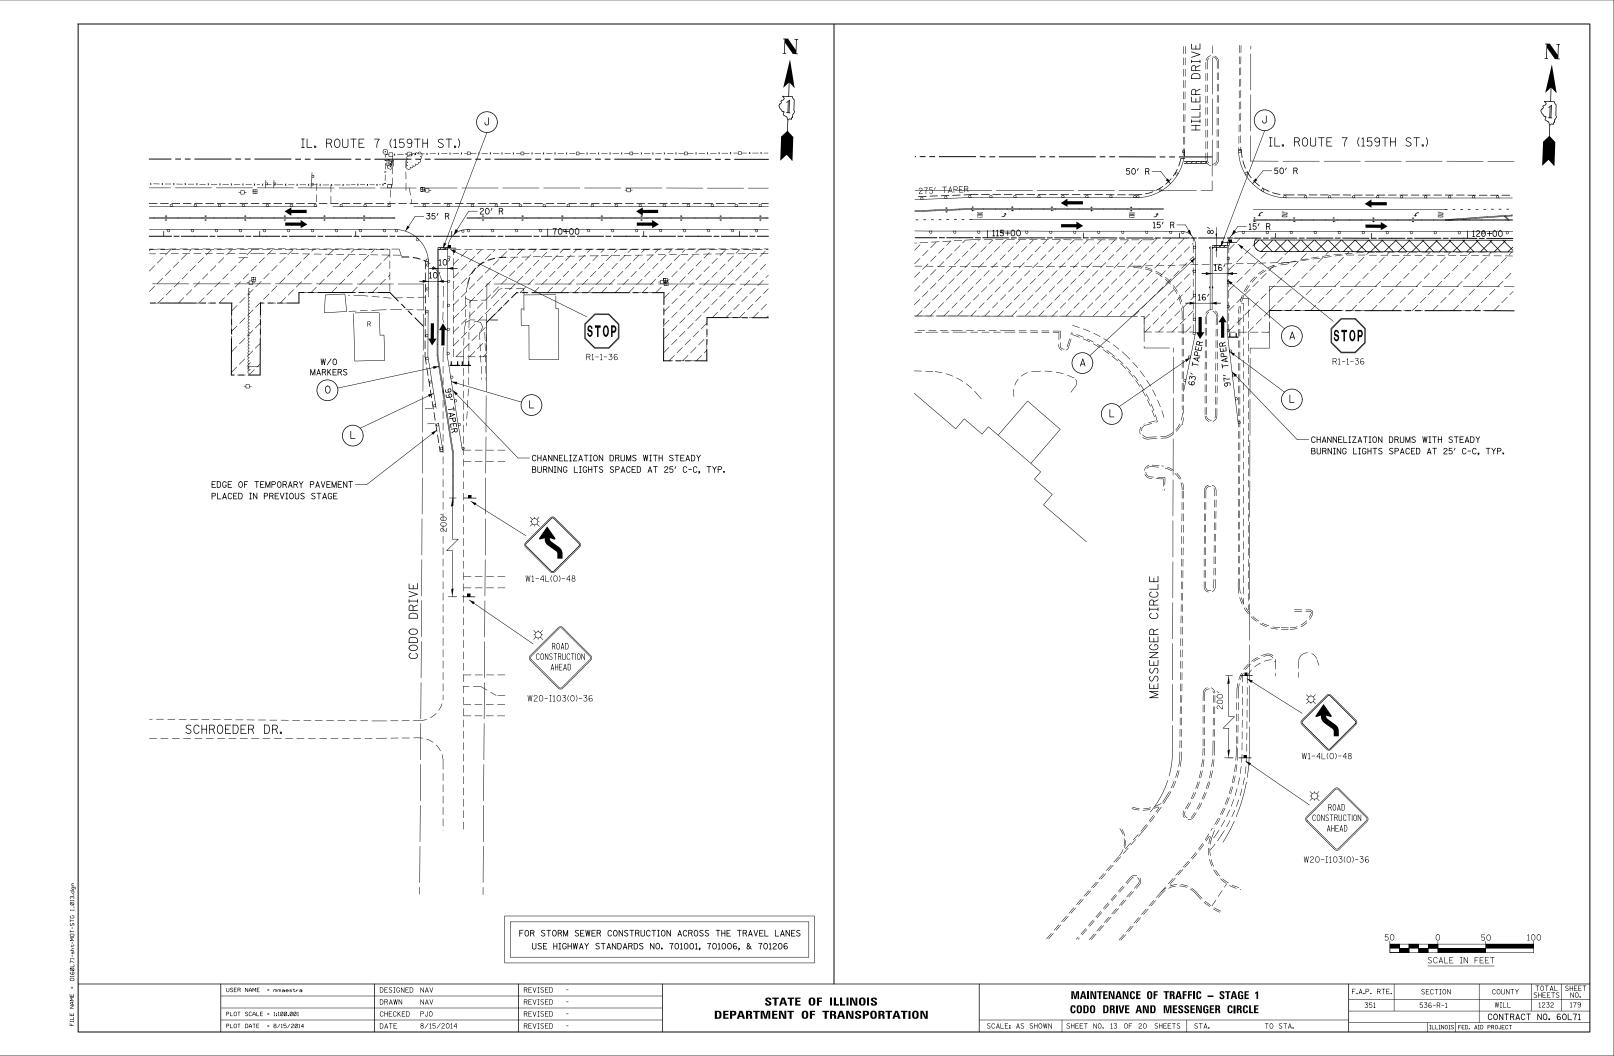

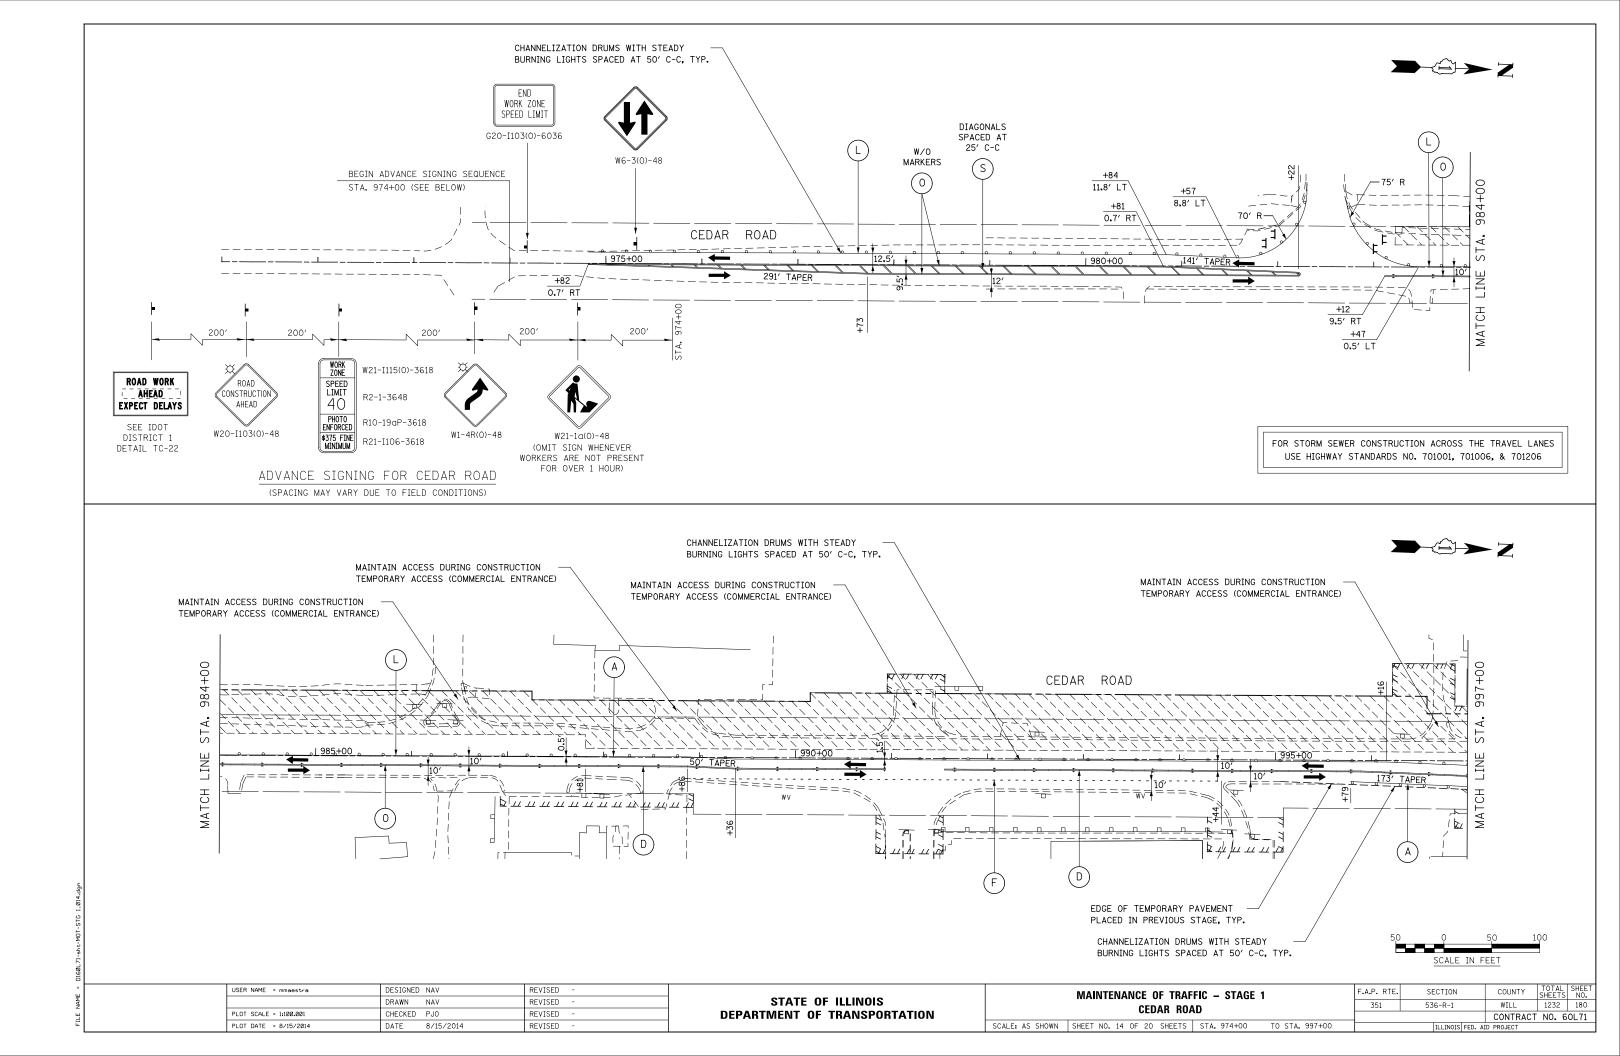


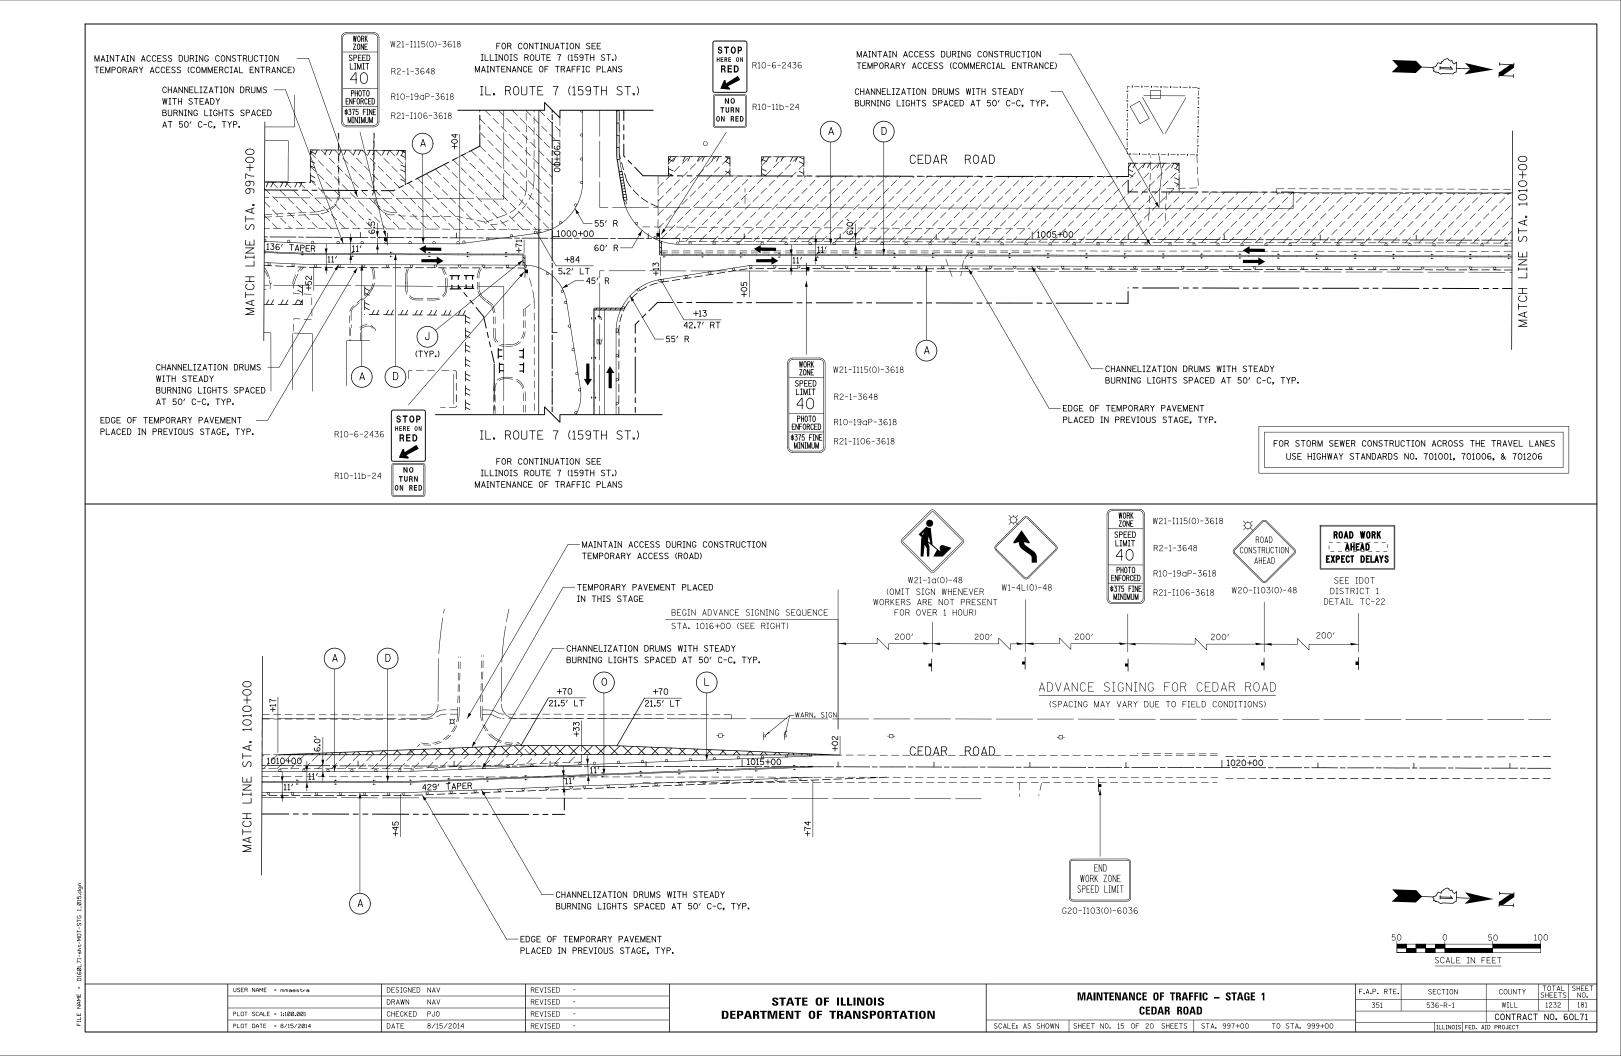


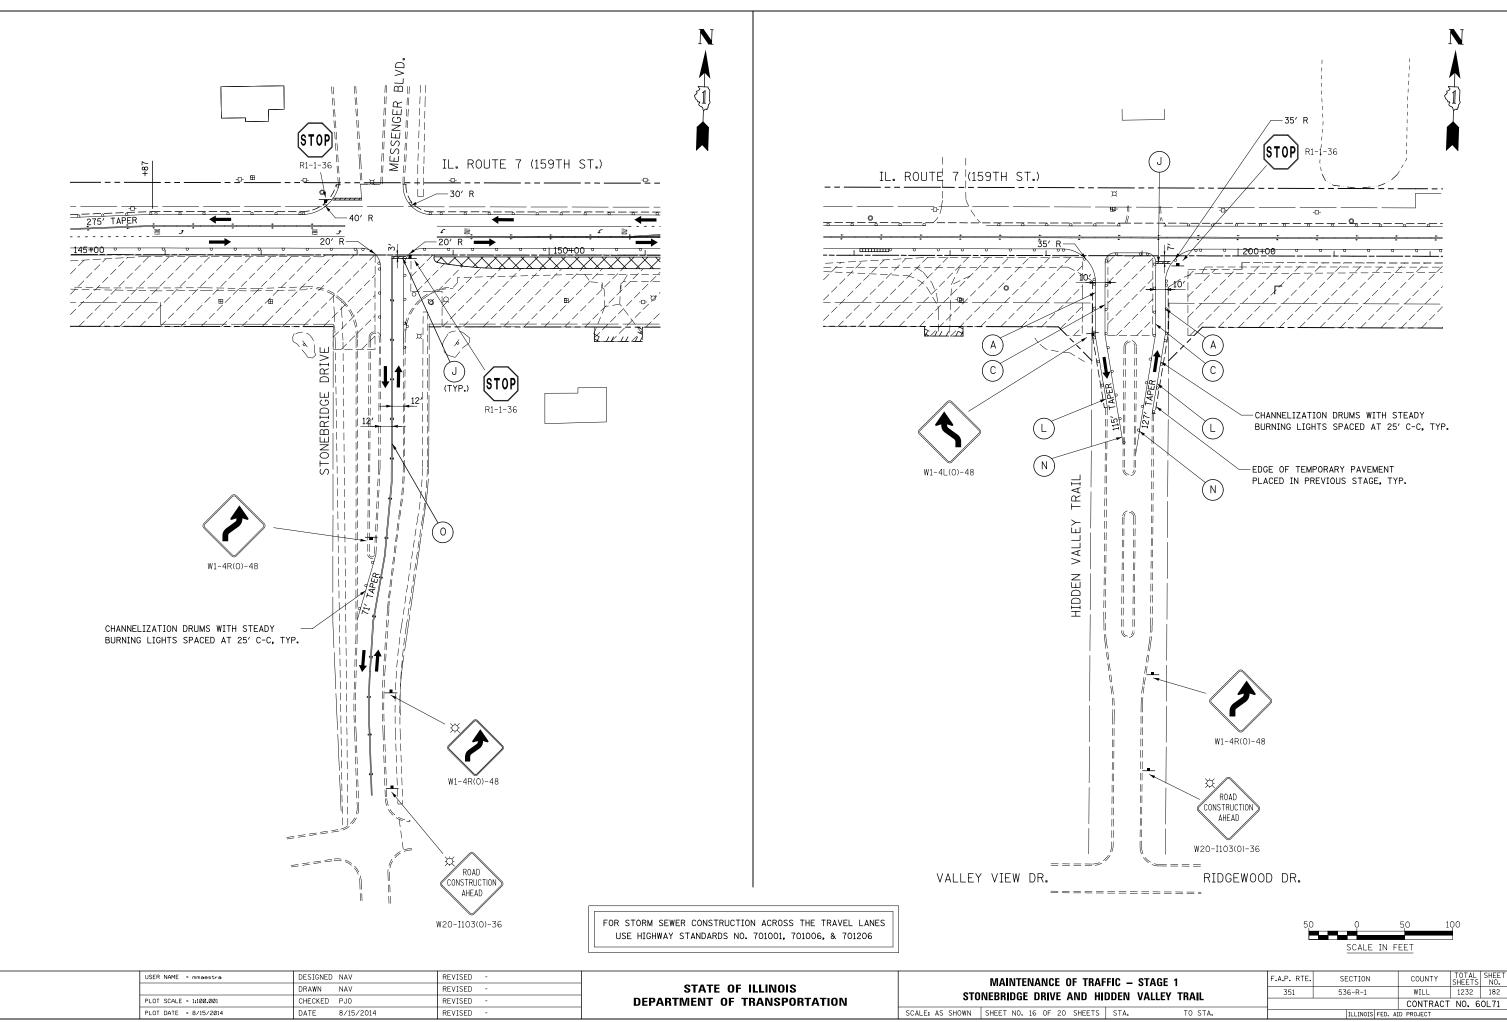

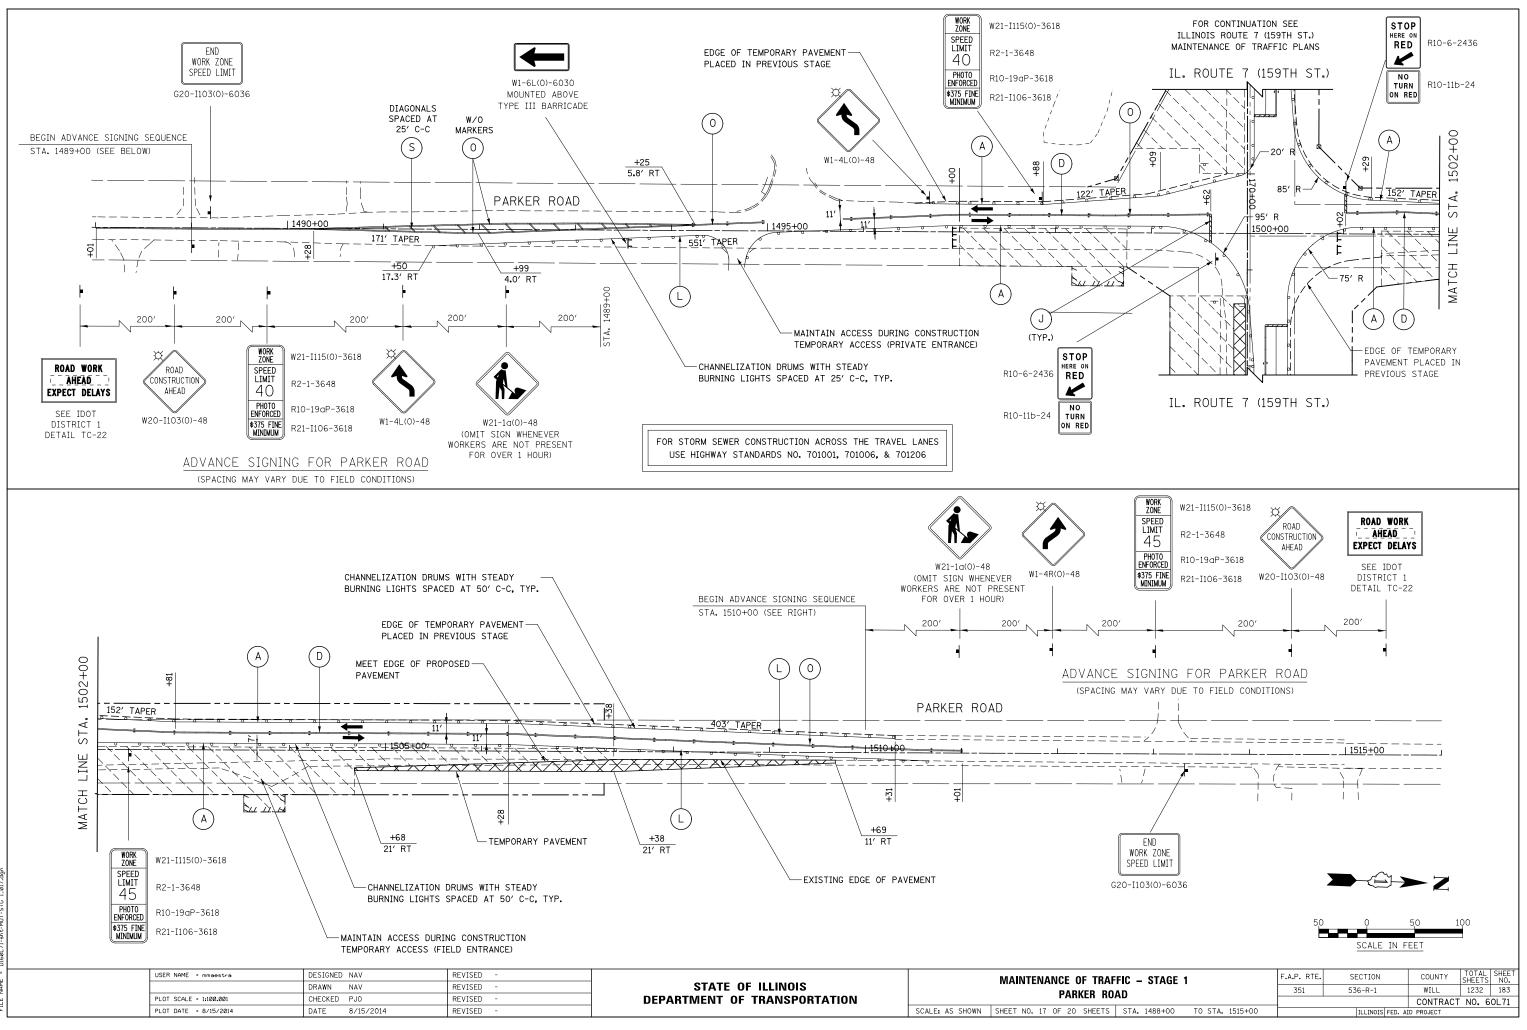

ILE NAME = D160L71-sht-M0T-STG

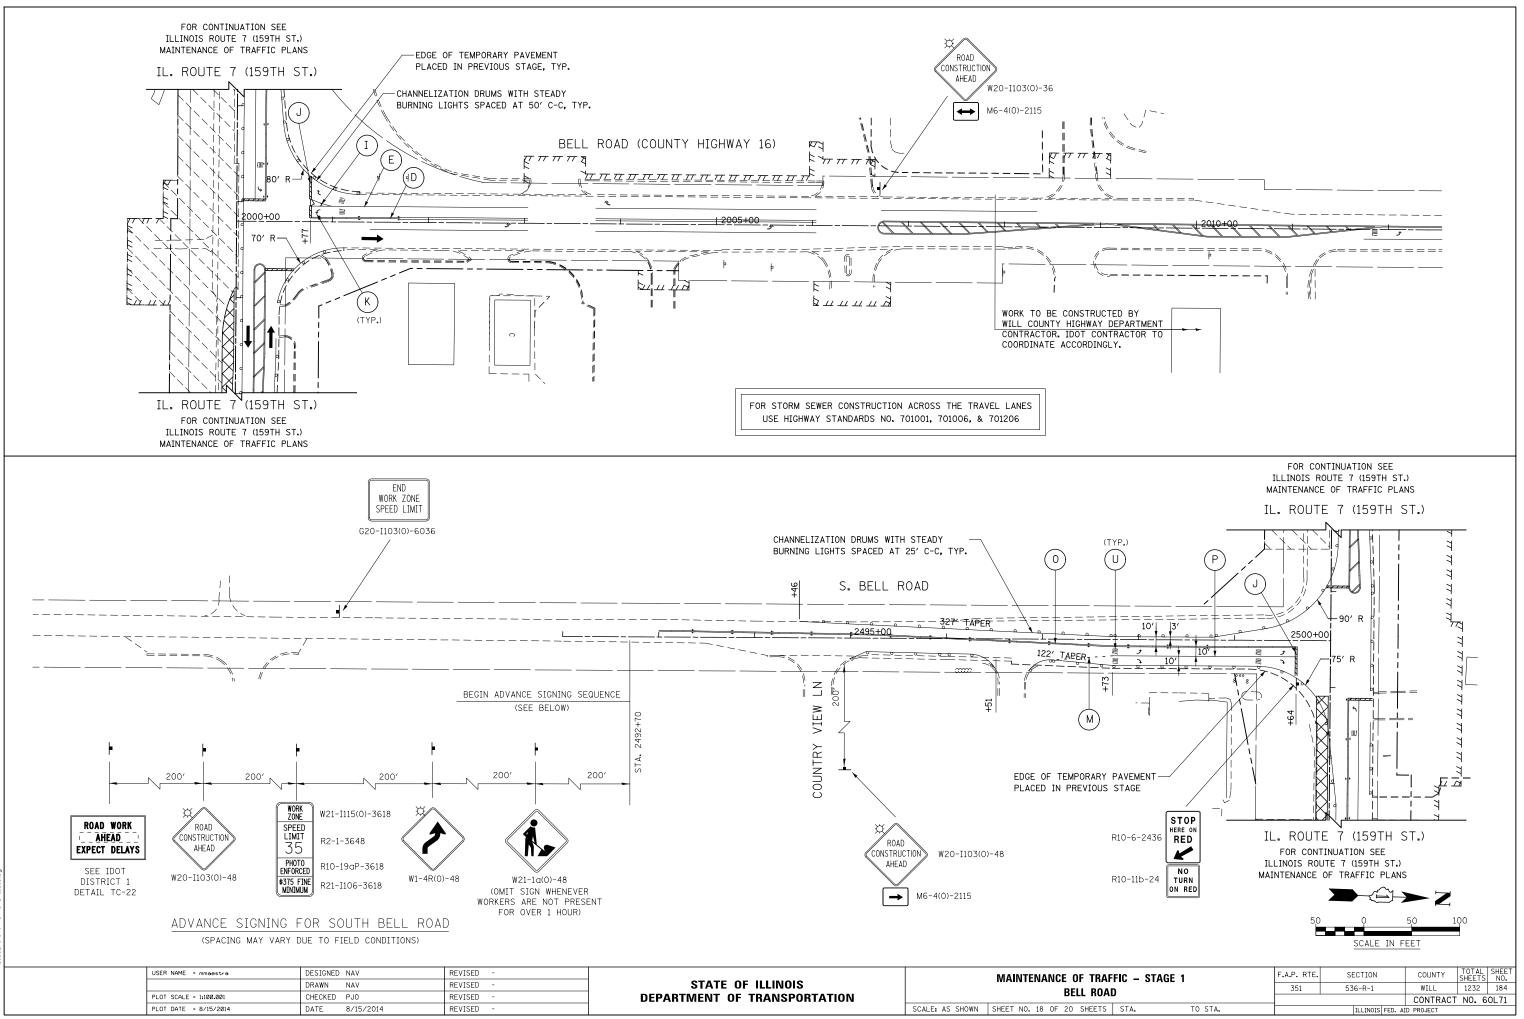


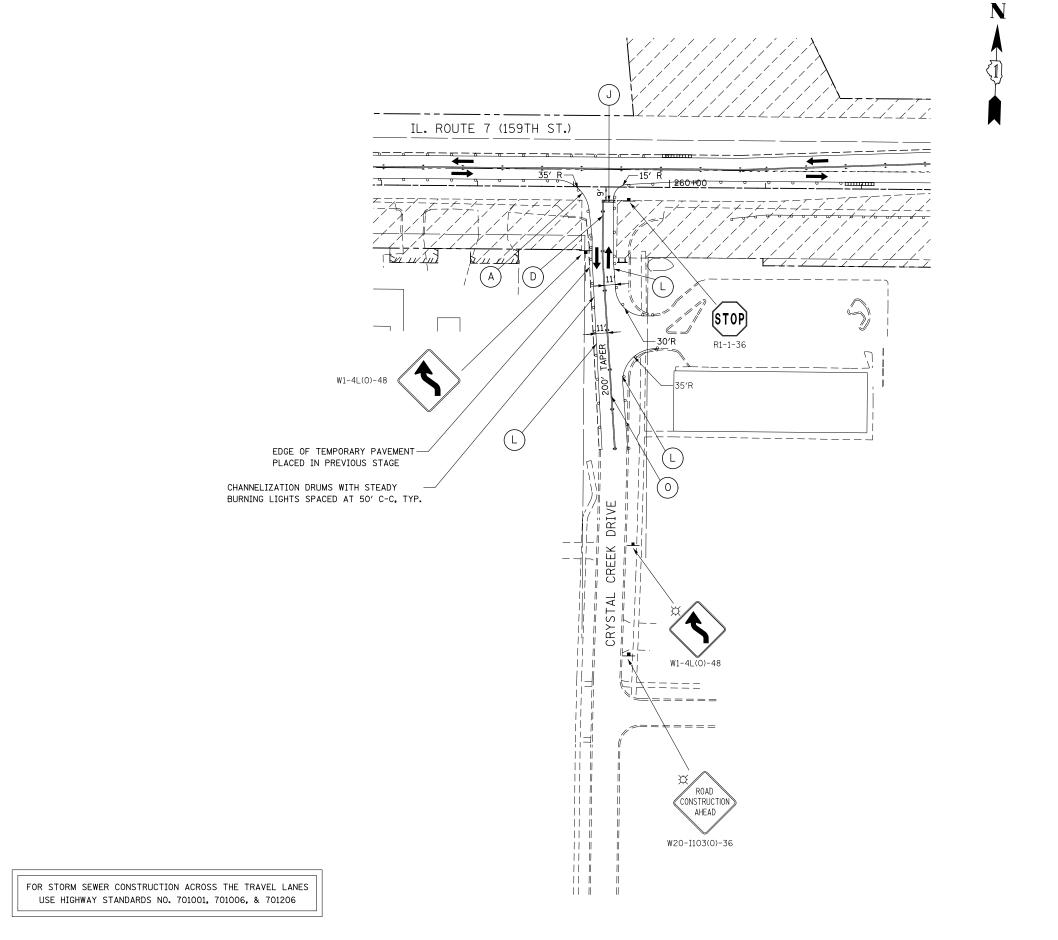


USER NAME = mmoestro PLOT SCALE = 1:100.001 PLOT DATE = 8/15/2014

5	DESIGNED NAV	REVISED -		MAINTENANCE OF TRAF	F.A.P. RTE.	SECTION	COUNTY	TOTAL S	SHEET NO.	
	DRAWN NAV	REVISED -	STATE OF ILLINOIS	CRYSTAL CREEK	351	536-R-1	WILL		185	
	CHECKED PJ0	REVISED -	DEPARTMENT OF TRANSPORTATION	GRISIAL CREEK		CONTRACT N			NO. 60	JL71
4	DATE 8/15/2014	REVISED -		SCALE: AS SHOWN SHEET NO. 19 OF 20 SHEETS	STA. TO STA.	ILLINOIS FED. AID PROJECT				

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	SCALE I	N FEET	

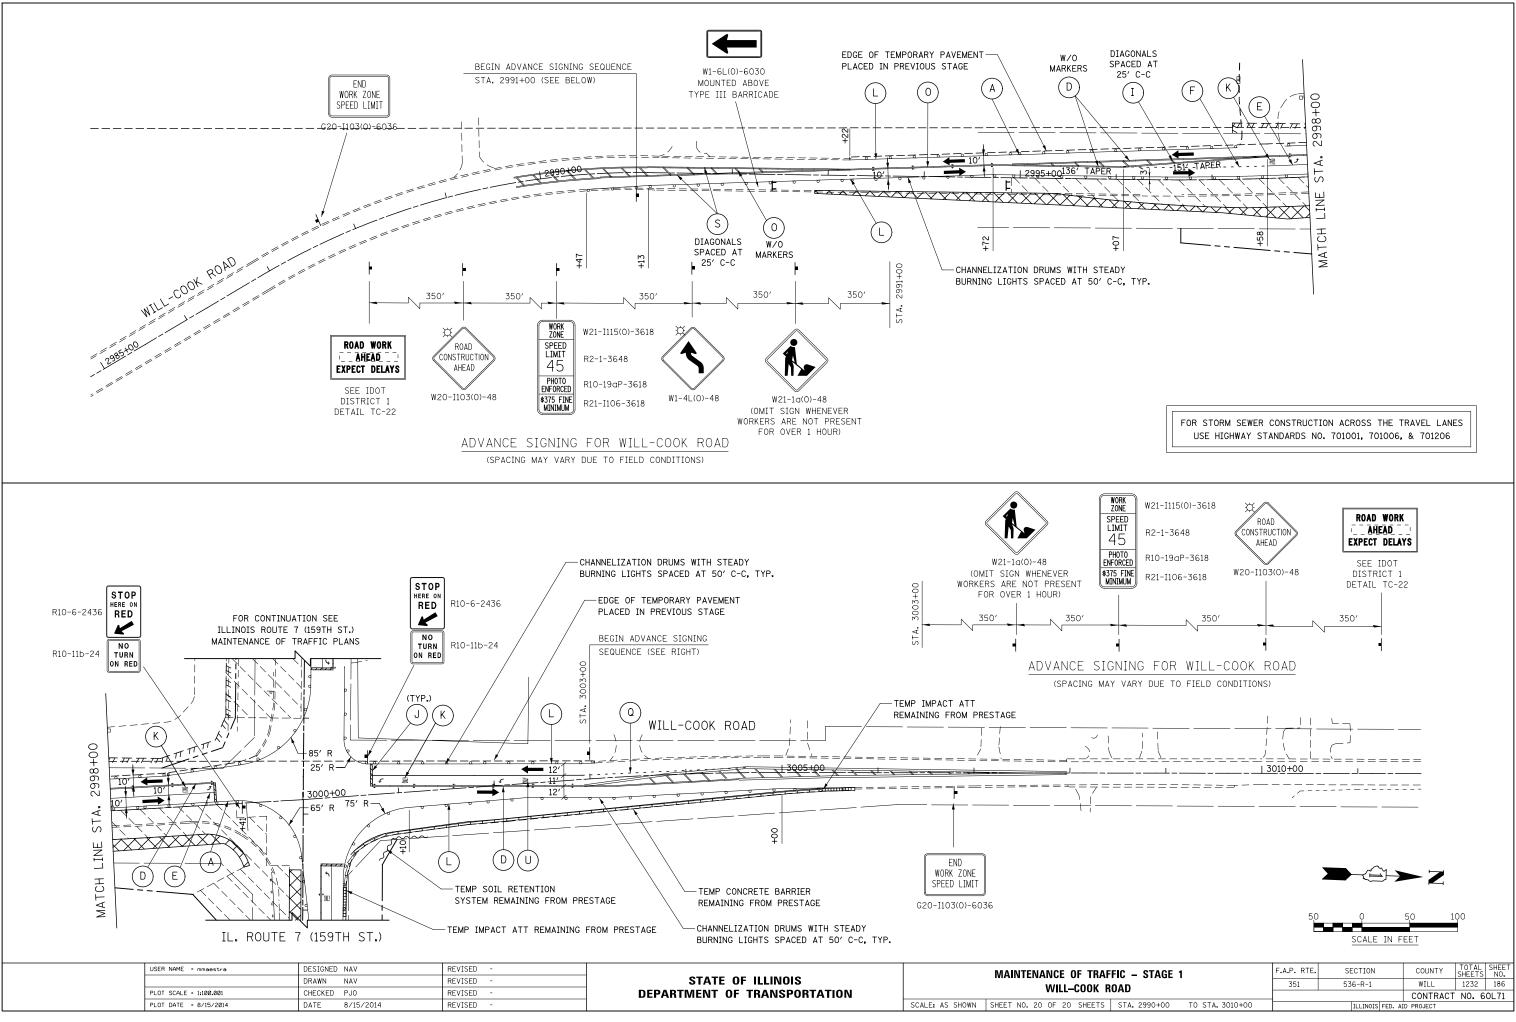

ĸ	UAD		CONTRACT NO. 60L7	/1
	STA. 2990+00	TO STA. 3010+00	ILLINOIS FED. AID PROJECT	-

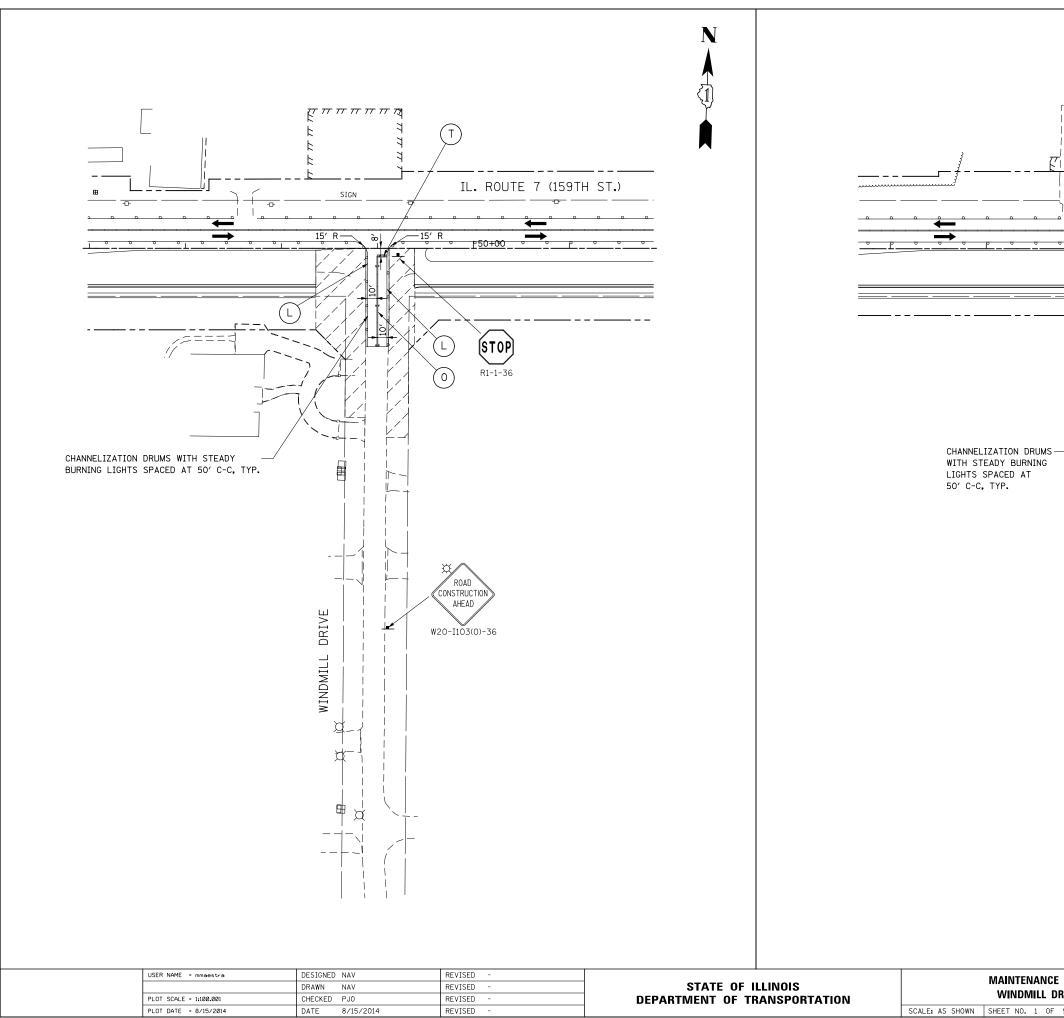



SCALE: AS SHOWN SHEET NO. 1 OF 9 SHEETS STA.


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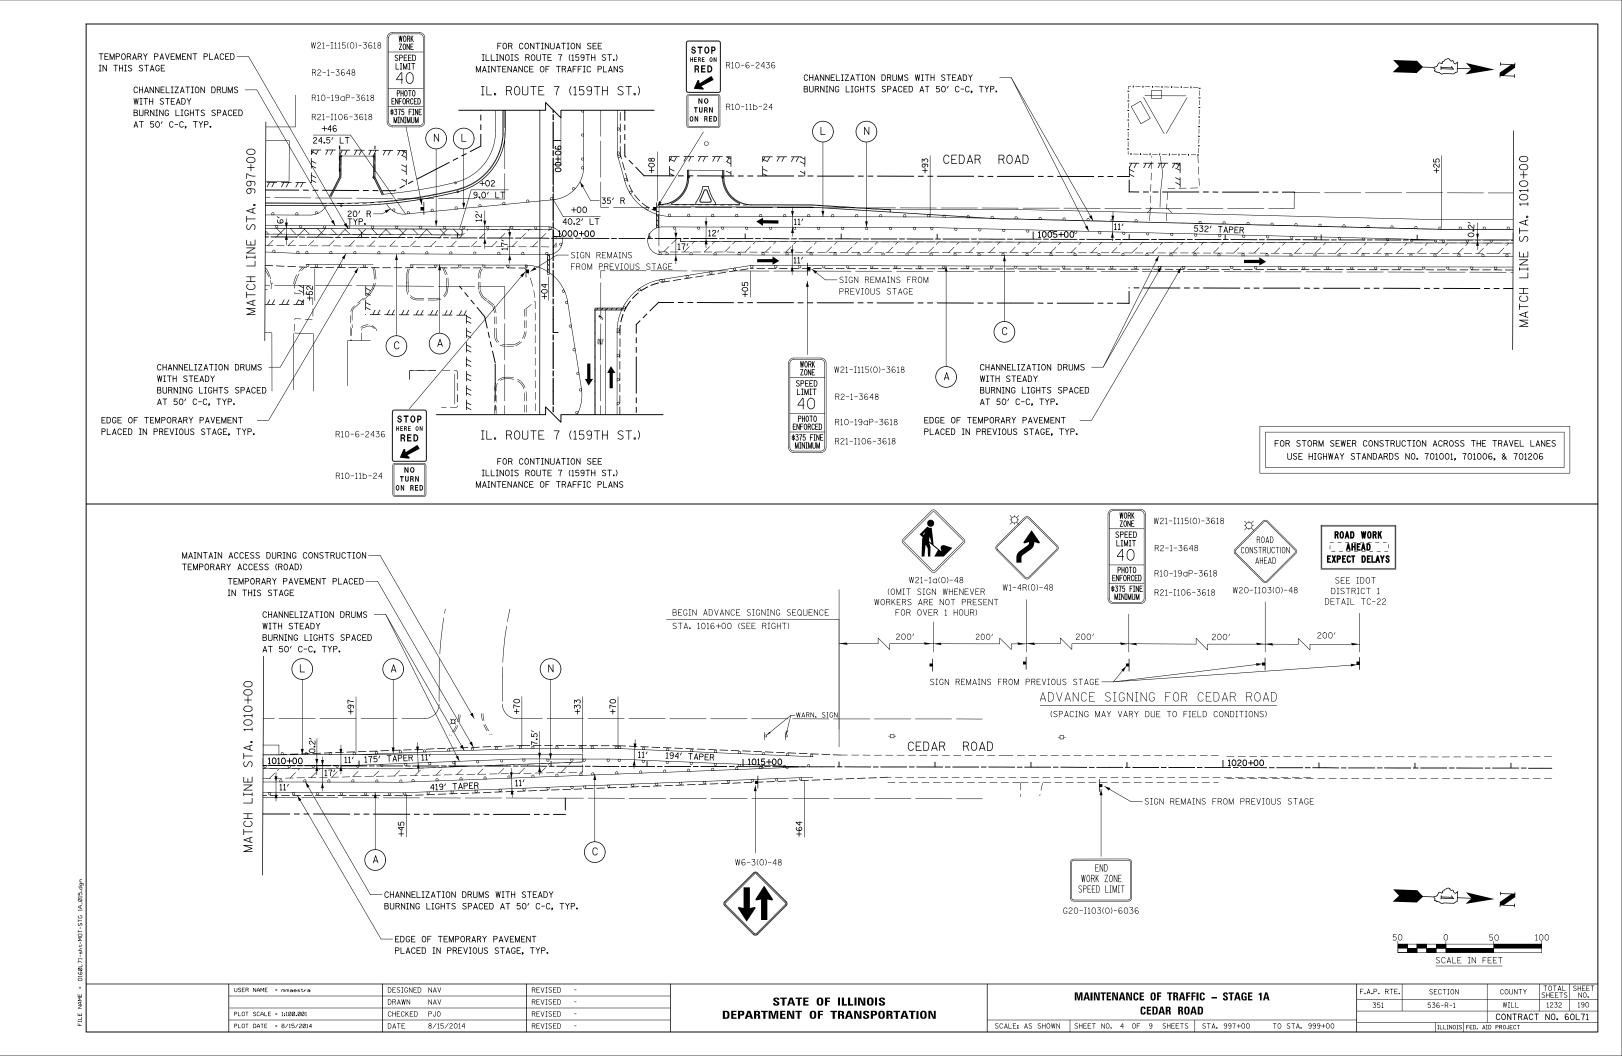
νP


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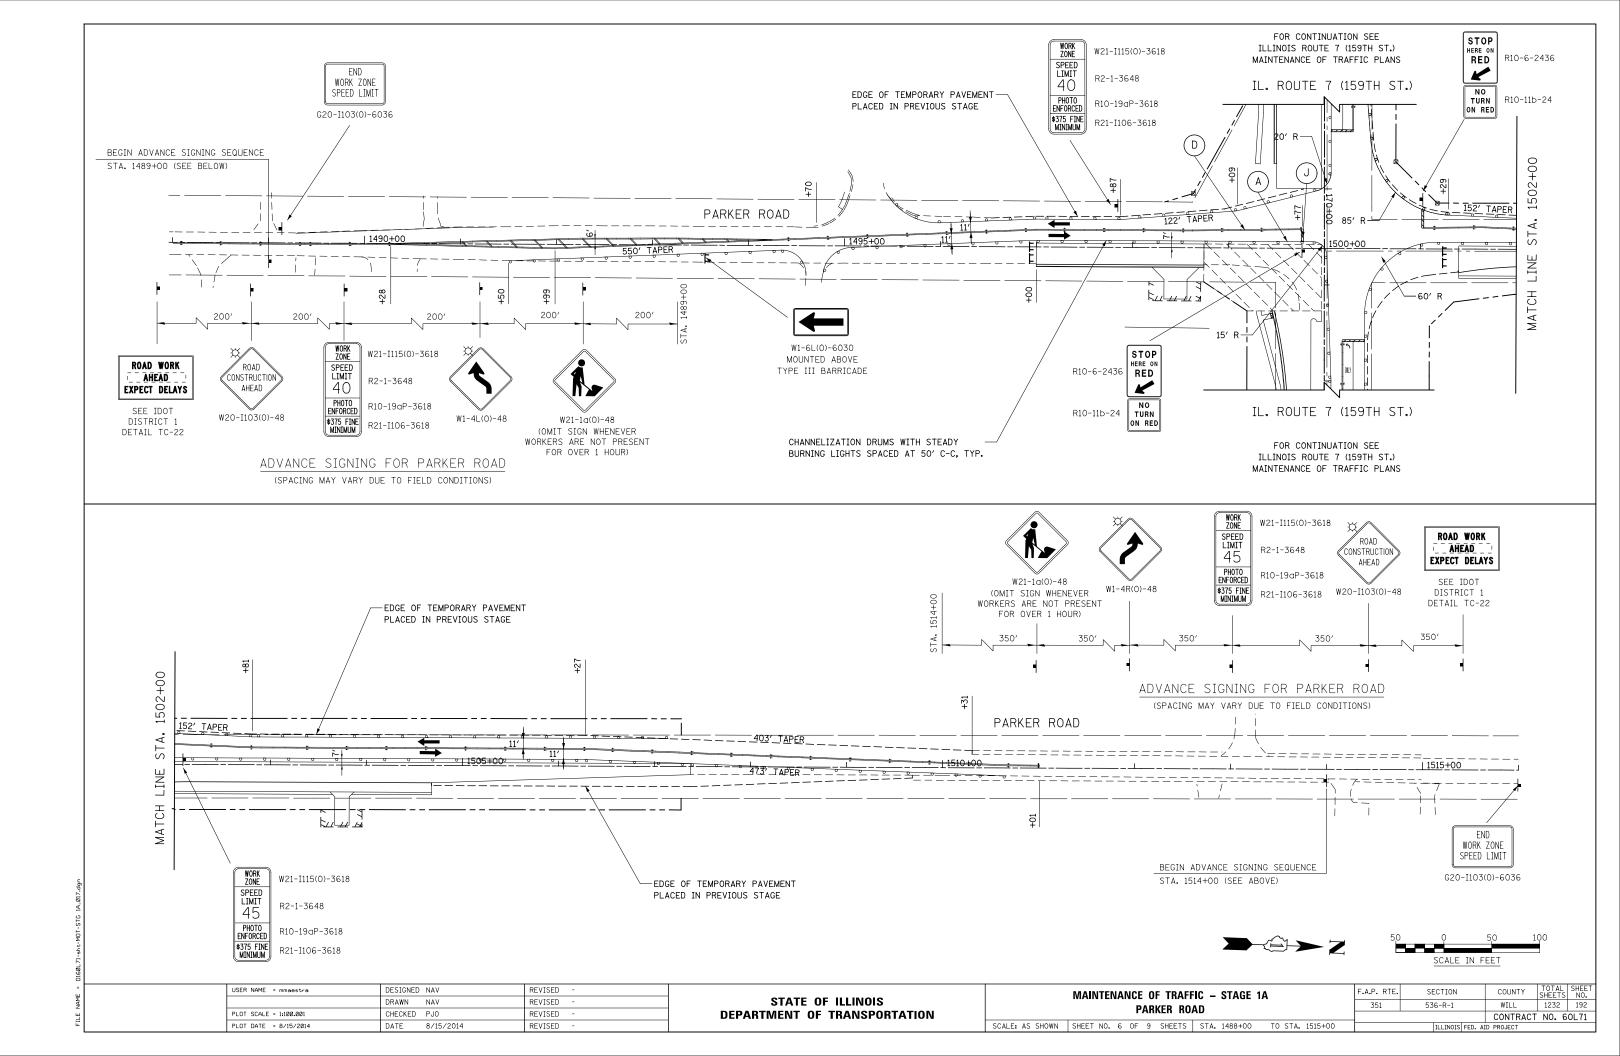





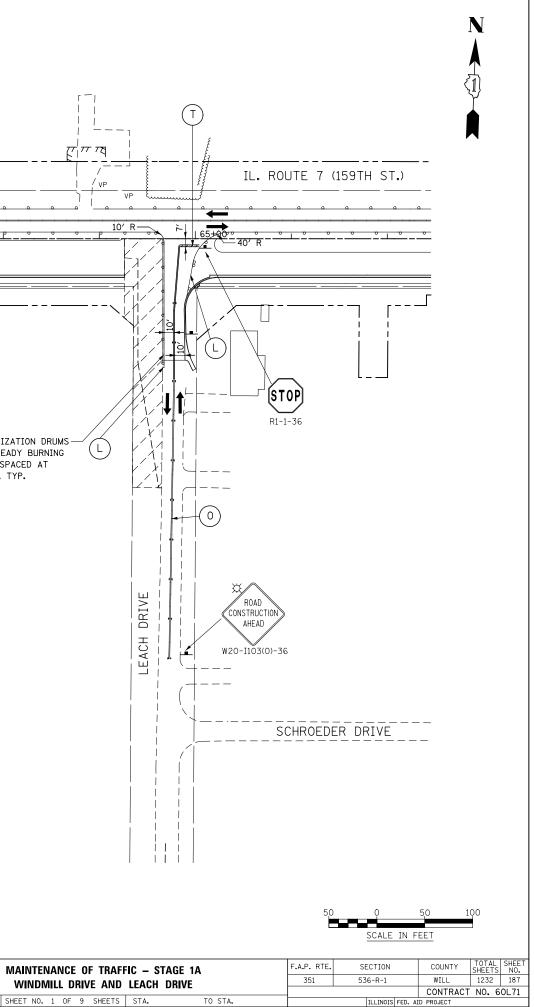

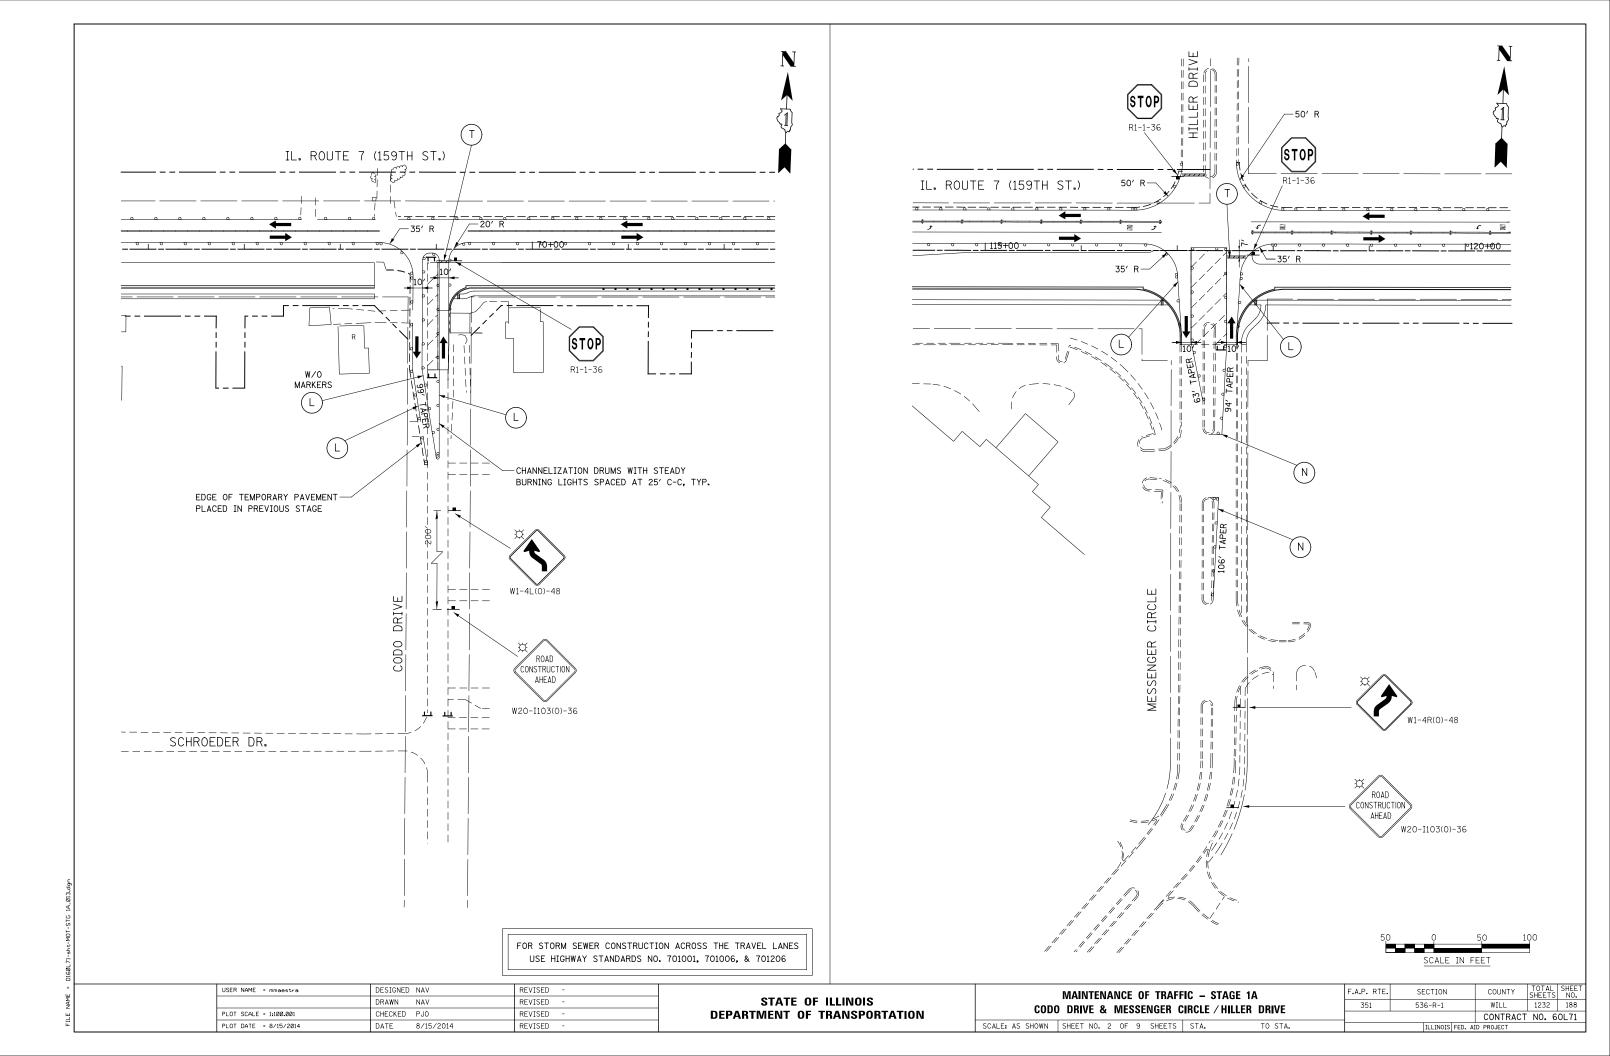


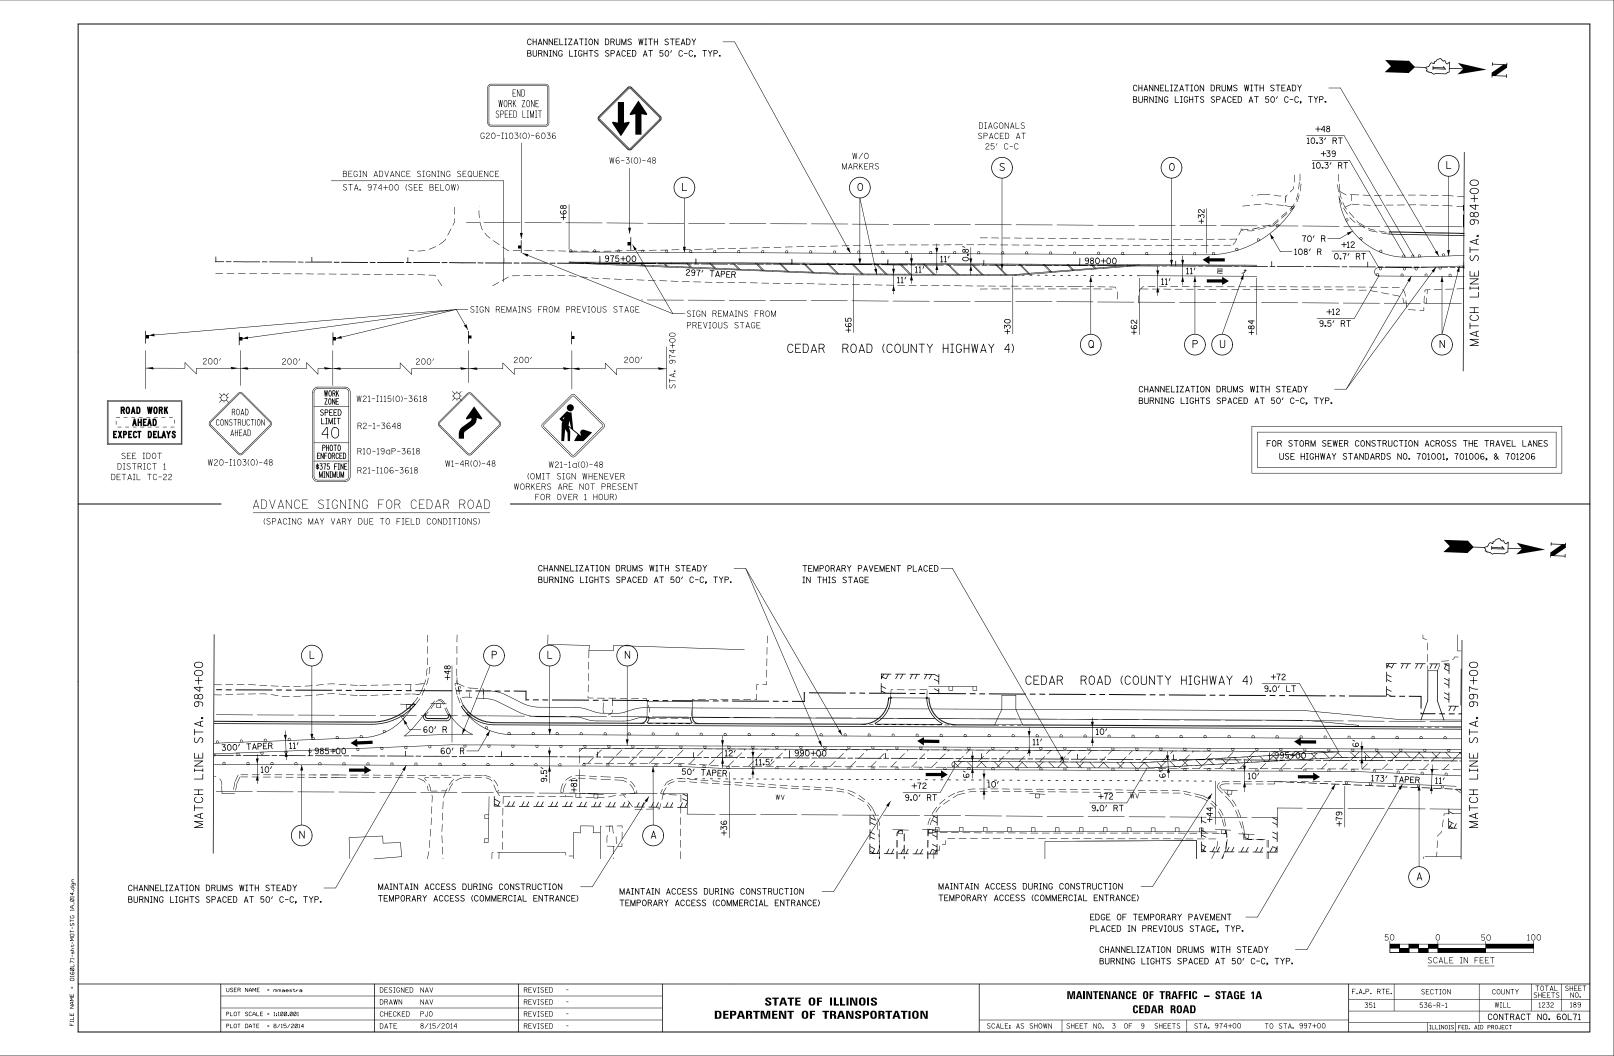

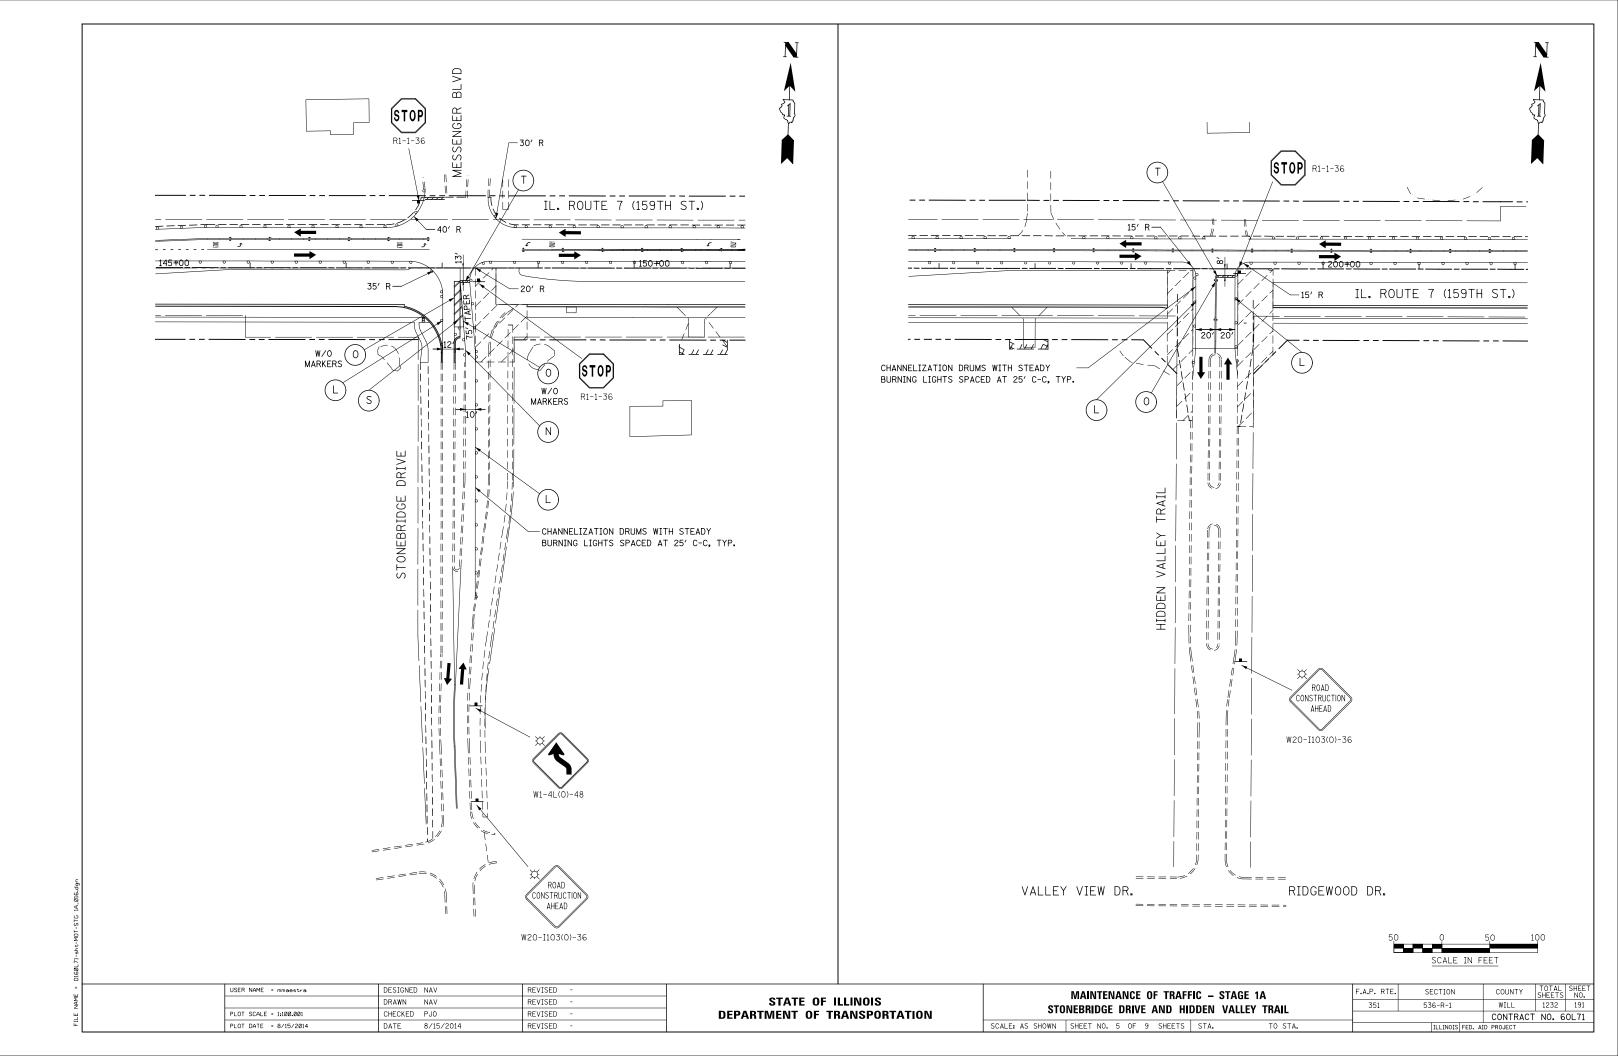


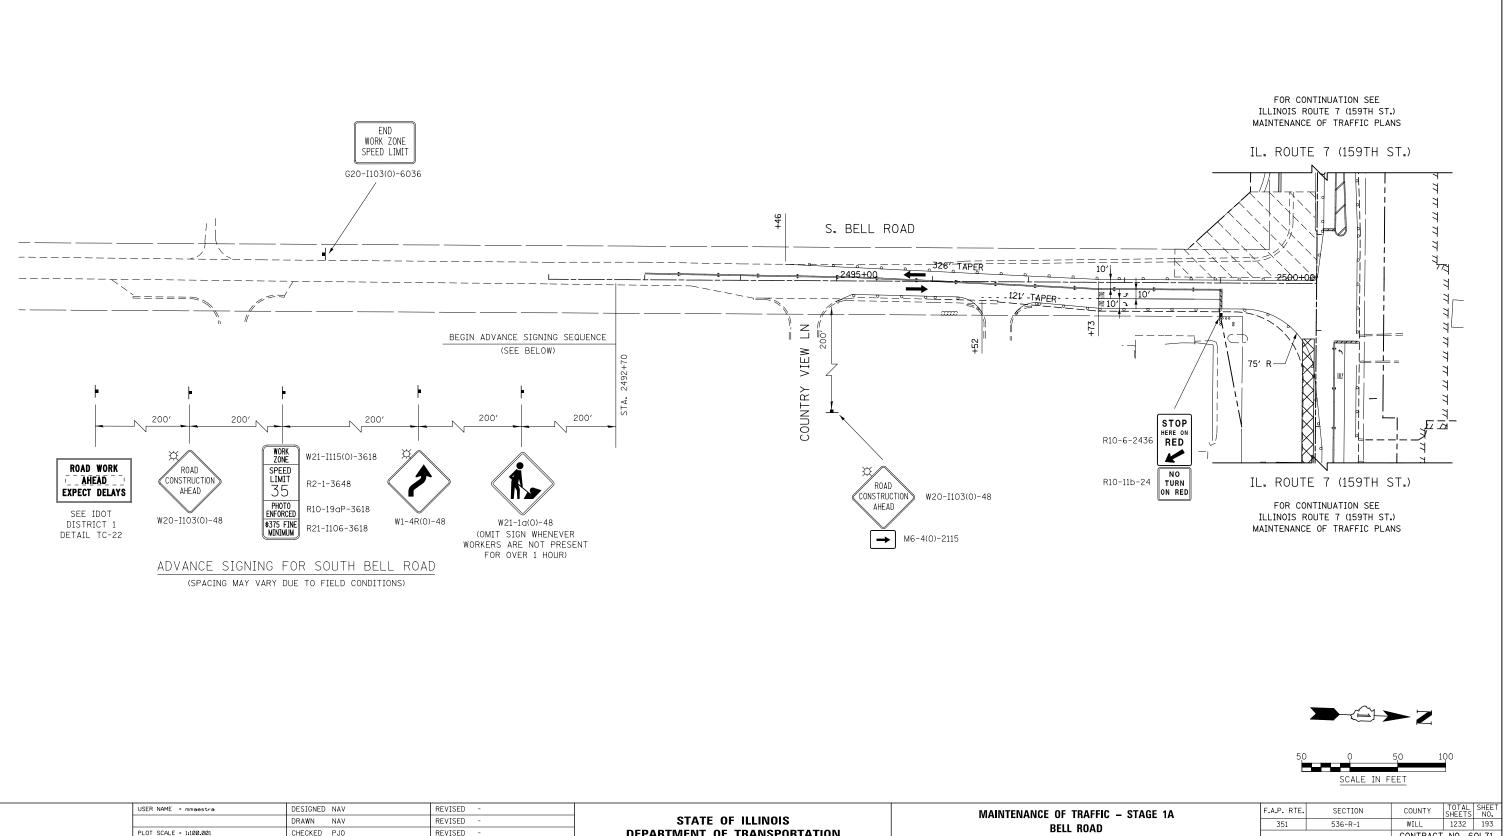


USER NAME = mmaestra	DESIGNED NAV	REVISED -		STATE OF ILLINOIS MAINTENANCE OF TRAFFIC – STAGE 1A DEPARTMENT OF TRANSPORTATION BELL ROAD		IC – STAGE 1A	F.A.P. RTE.	SECTION	COUNTY TOTAL SHEET
	DRAWN NAV	REVISED -	STATE OF ILLINOIS				351	536-R-1	WILL 1232 193
PLOT SCALE = 1:100.001	CHECKED PJO	REVISED -	DEPARTMENT OF TRANSPORTATION			)			CONTRACT NO. 60L71
PLOT DATE = 8/15/2014	DATE 8/15/2014	REVISED -		SCALE: AS SHOWN	SHEET NO. 7 OF 9 SHEETS	STA. TO STA.	ILLINOIS FED. AID PROJECT		

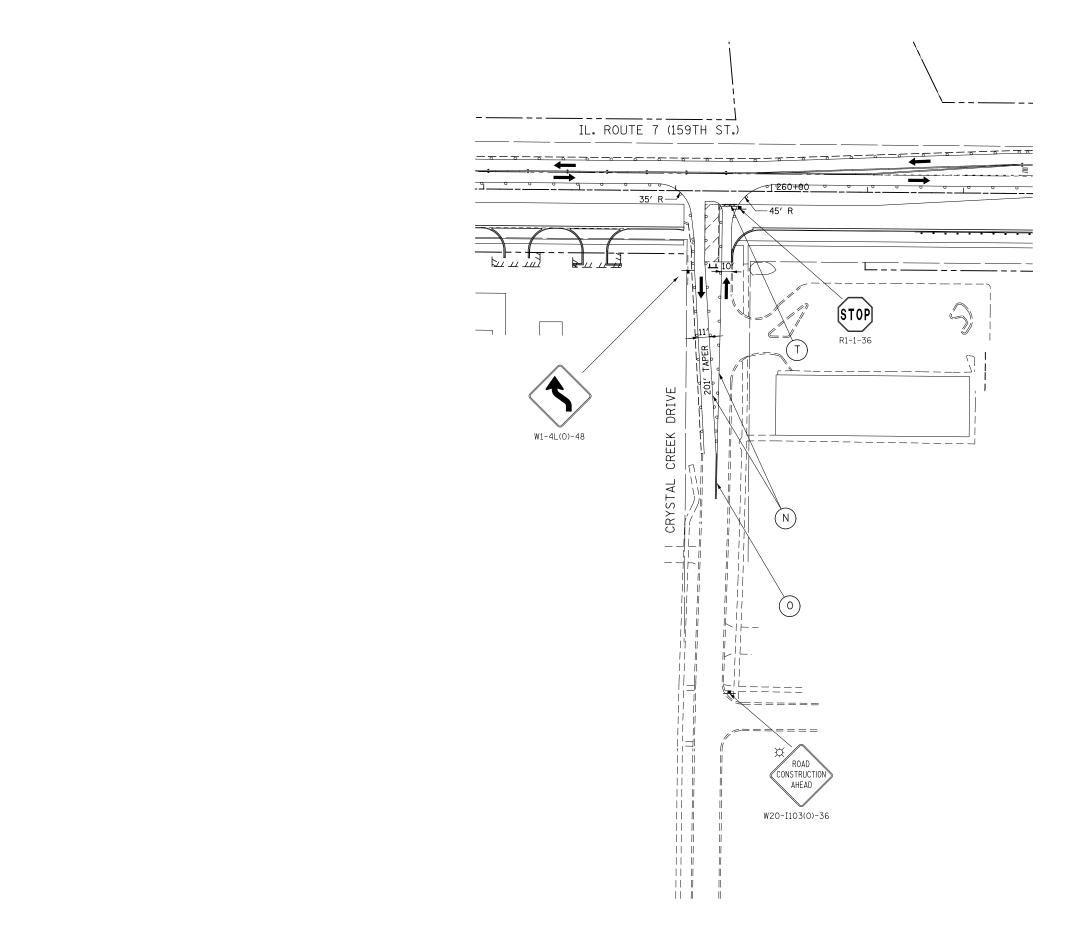


-	USER NAME = mmaestra	DESIGNED NAV	REVISED -		MAINTENANCE OF TRAFFIC – STAGE 1A		SECTION	COUNTY	TOTAL SHEET SHEETS NO.
-		DRAWN NAV	REVISED -	STATE OF ILLINOIS	CRYSTAL CREEK DRIVE	351	536-R-1	WILL	1232 194
-	PLOT SCALE = 1:100.001	CHECKED PJ0	REVISED -	DEPARTMENT OF TRANSPORTATION		CONTRACT NO. 60L71			
	PLOT DATE = 8/15/2014	DATE 8/15/2014	REVISED -		SCALE: AS SHOWN SHEET NO. 8 OF 9 SHEETS STA. TO STA.		ILLINOIS FED.	AID PROJECT	

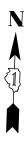

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	SCALE	IN FEET	

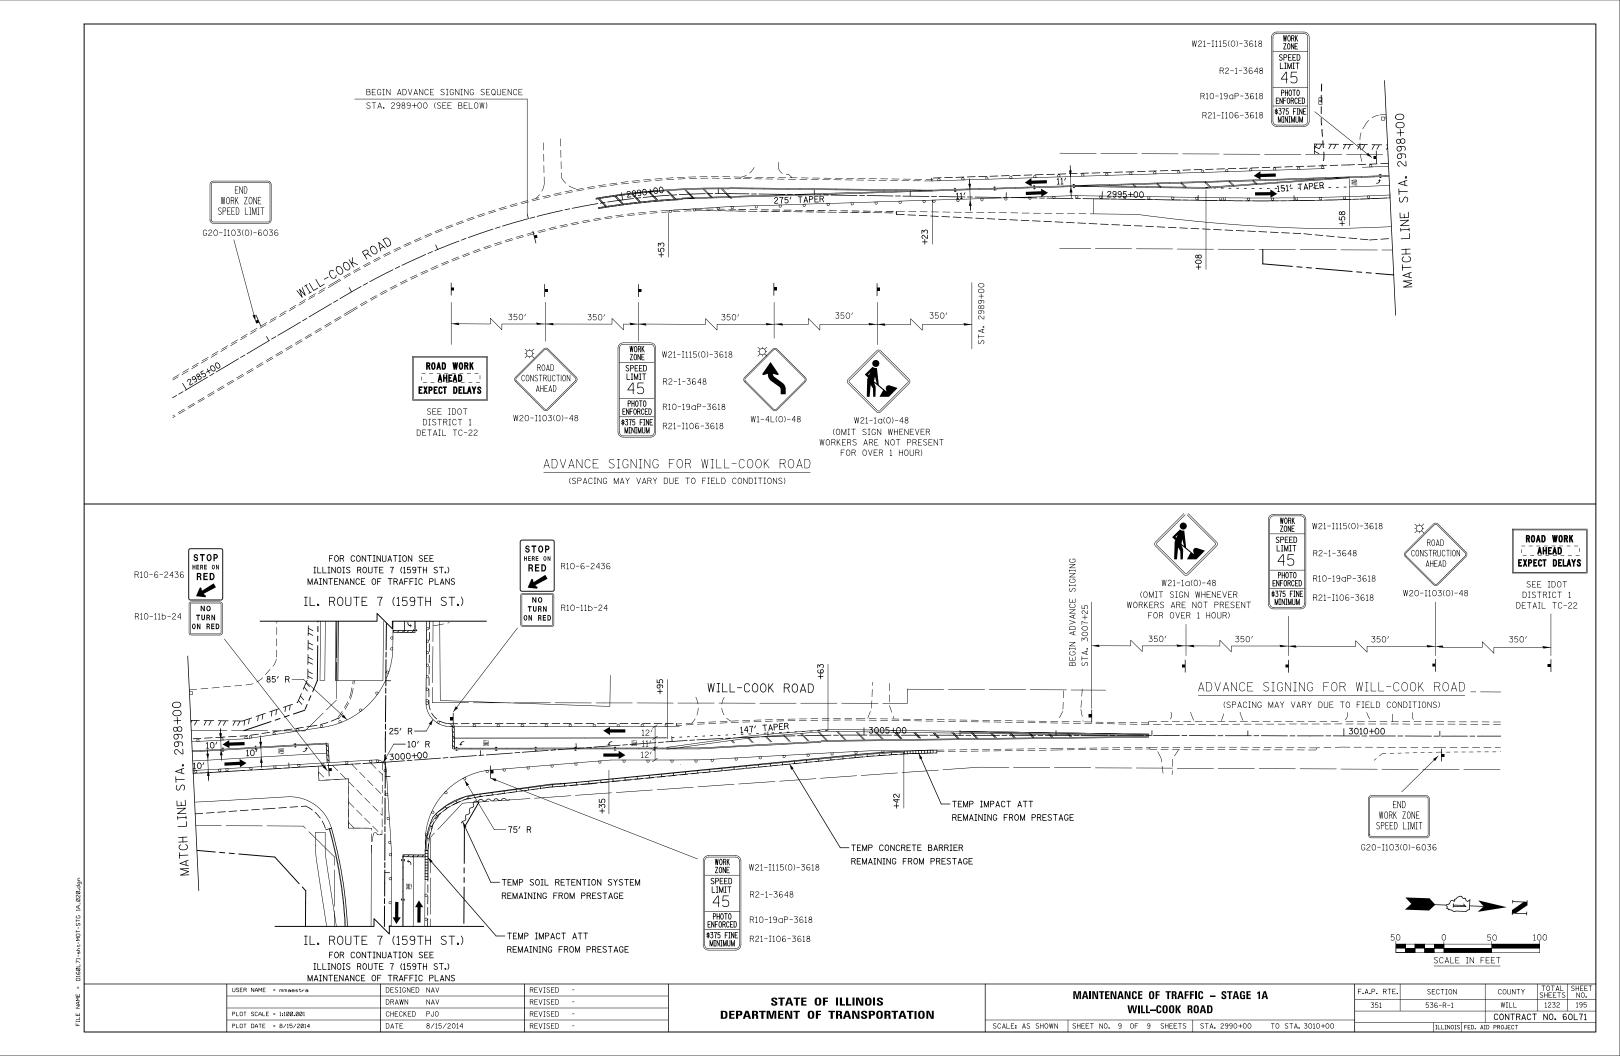


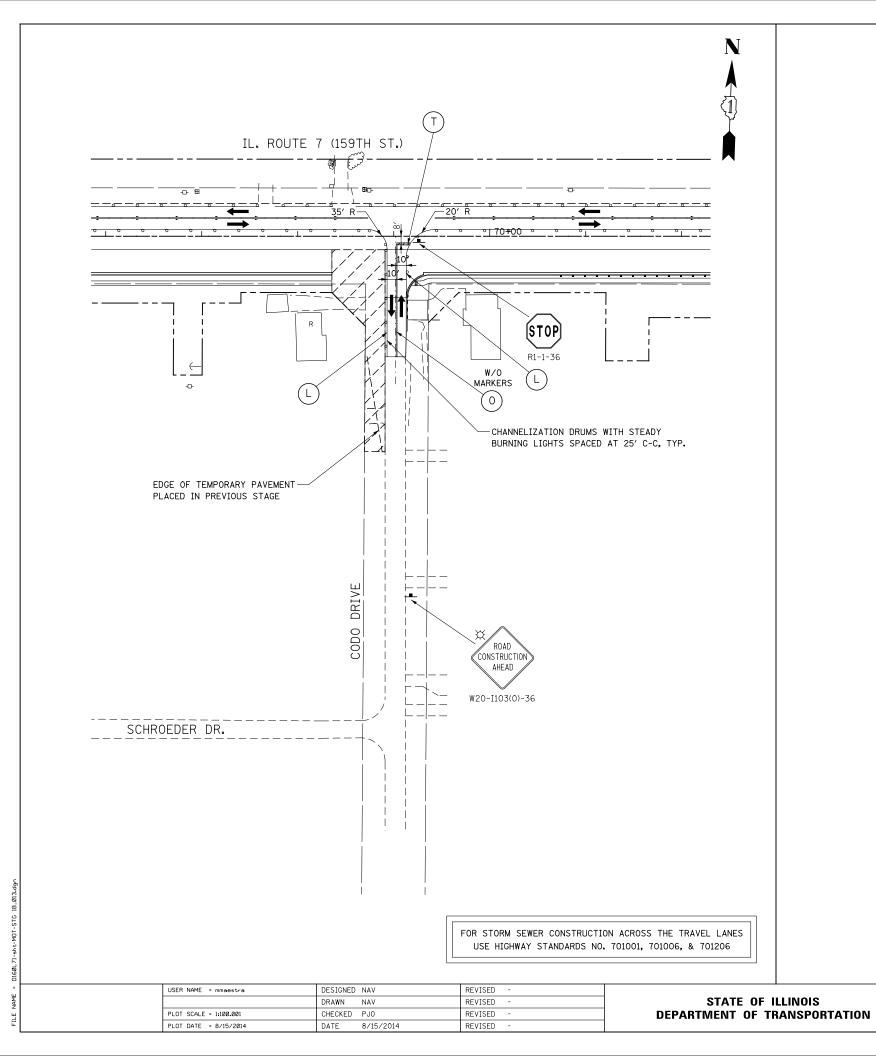



MAIN	ITE	IAI	NCE	OF	1	RAFF	IC
			(	COD	0	DRIV	/E

IC – STAGE 1B E		F.A.P. RTE.	SECTION	COUNTY TOTAL SHEETS		SHEET NO.
		351	351 536-R-1 WILL			196
<b>L</b>				CONTRACT	NO. 6	0L71
STA.	TO STA.		ILLINOIS FED. A	ID PROJECT		

50	Υ		50	100
	SCALE	ΙN	FEET	

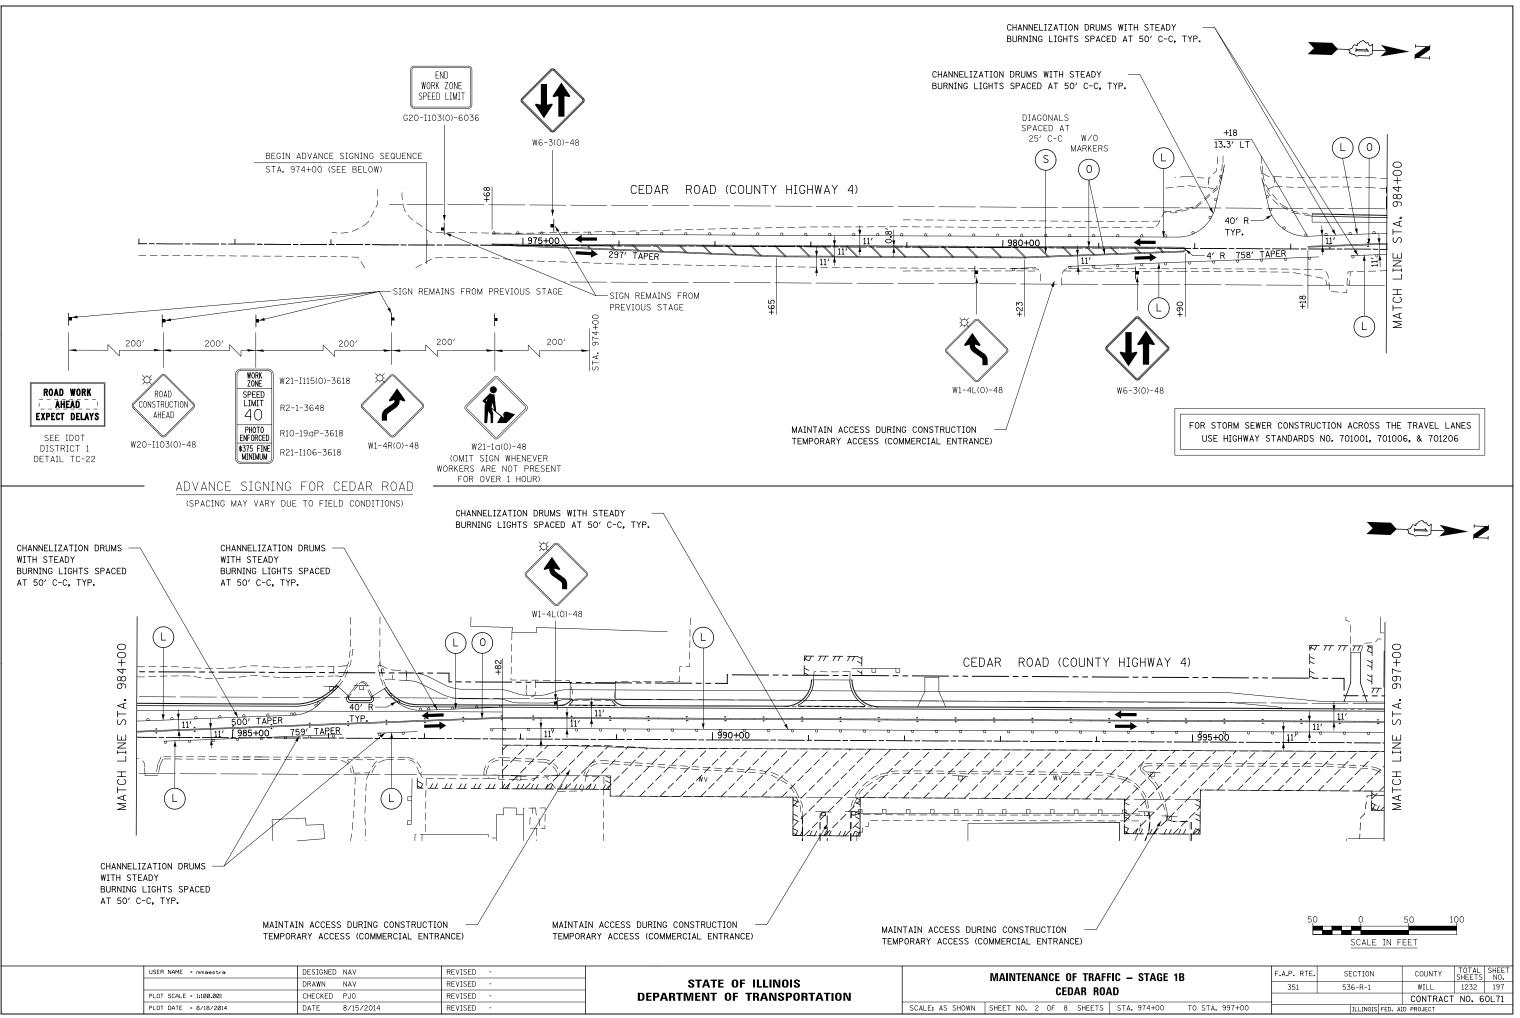

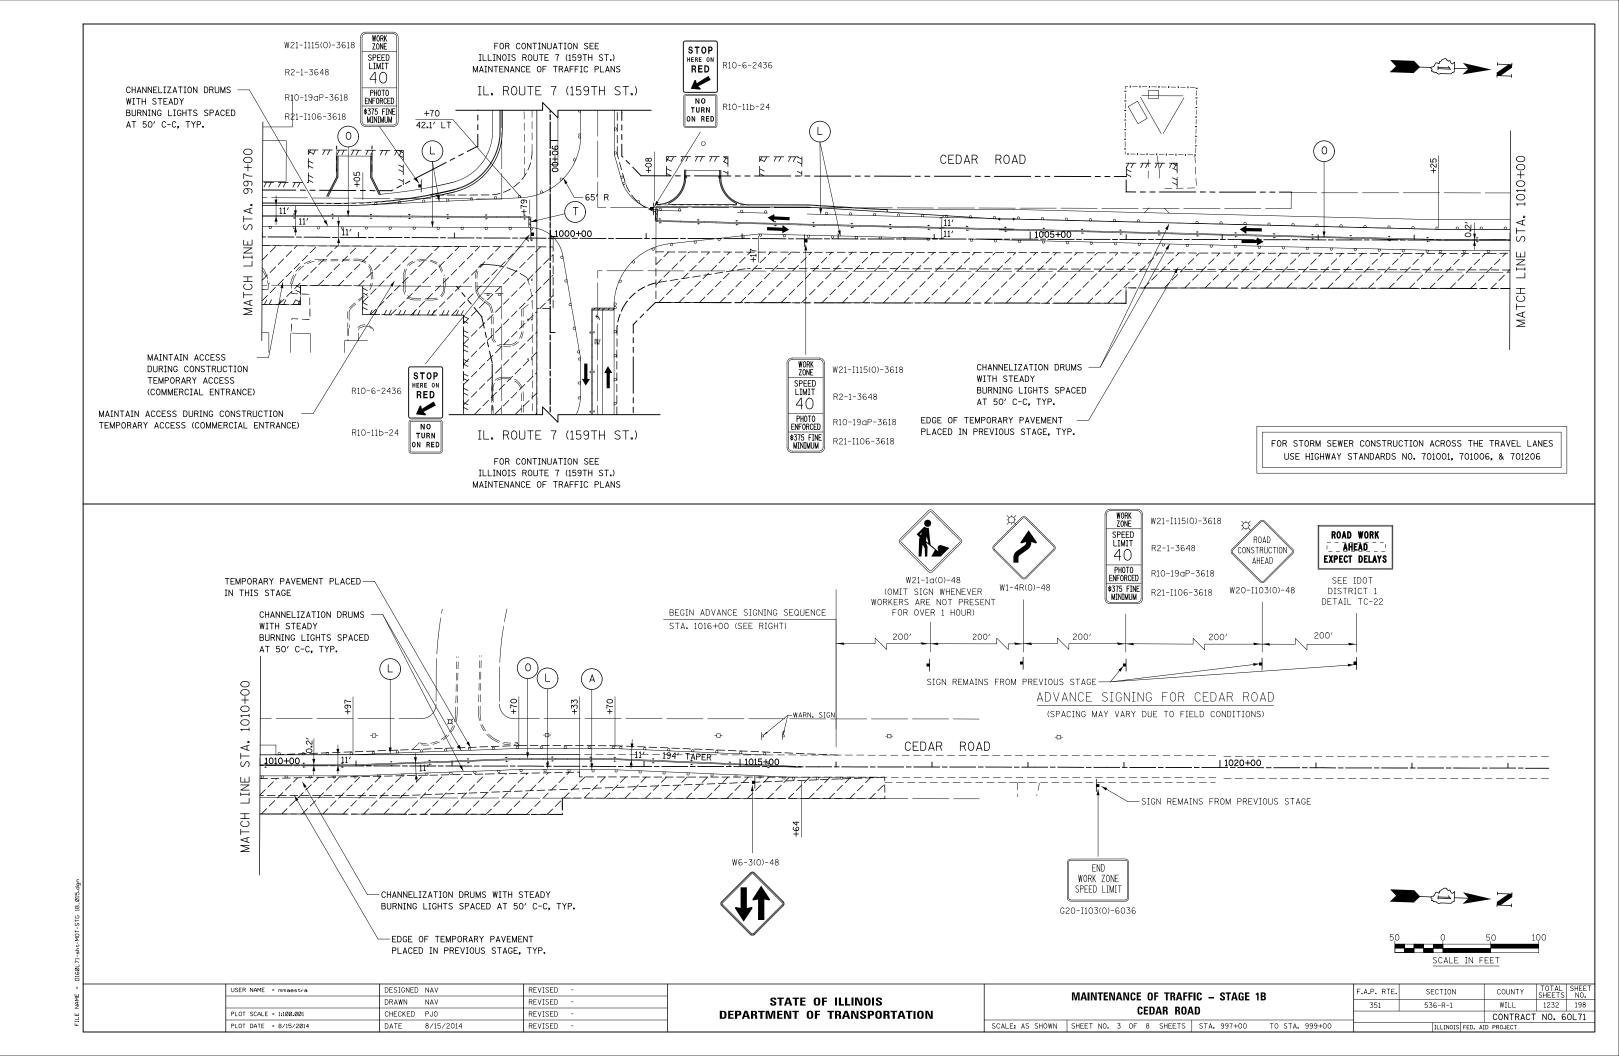

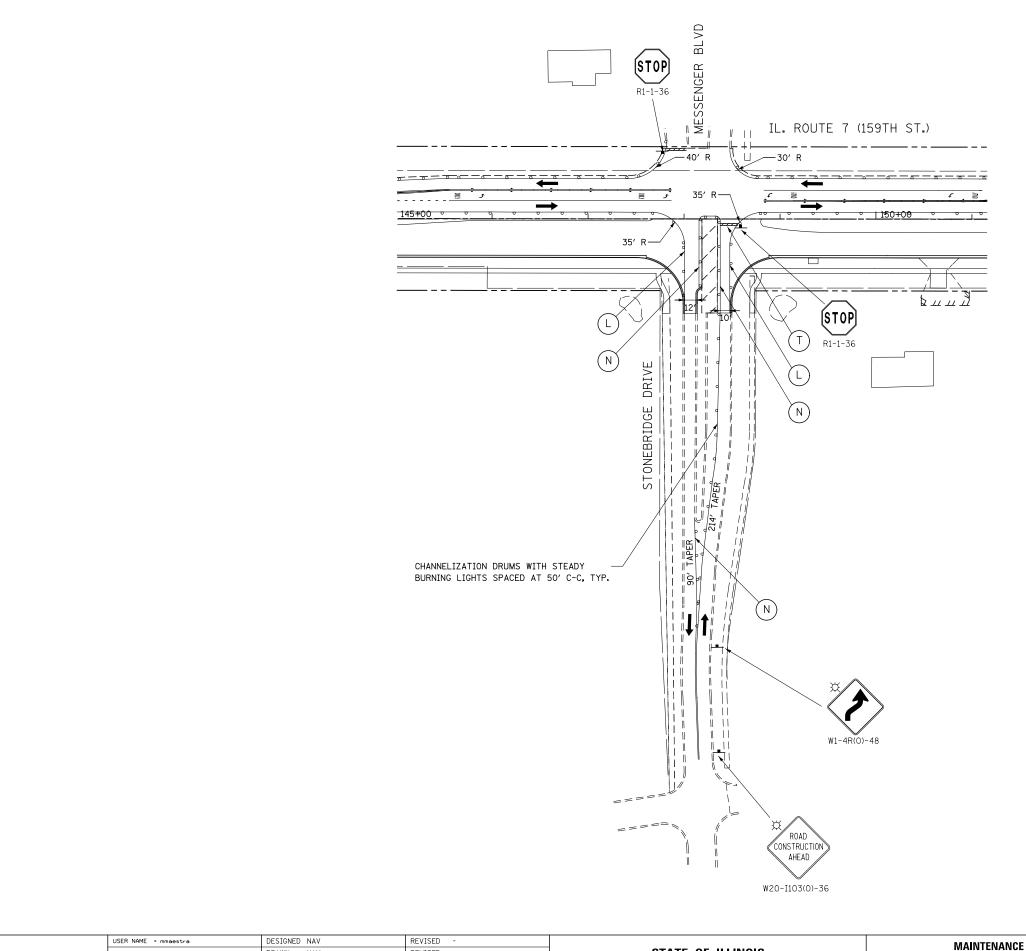

USER NAME = mmæestræ	DESIGNED NAV	REVISED -		MAINTENANCE OF TRAFFIC – STAGE 1B		SECTION	COUNTY TO	OTAL SHEET HEETS NO.
	DRAWN NAV	REVISED -	STATE OF ILLINOIS	STONEBRIDGE DRIVE	351	536-R-1	WILL 1	1232 199
PLOT SCALE = 1:100.001	CHECKED PJO	REVISED -	DEPARTMENT OF TRANSPORTATION	STUNEBRIDGE DRIVE			CONTRACT N	NO. 60L71
PLOT DATE = 8/15/2014	DATE 8/15/2014	REVISED -		SCALE: AS SHOWN SHEET NO. 3 OF 8 SHEETS STA. TO STA.	ILLINOIS FED. AID PROJECT			



50	Q	50	100
	SCALE	IN FEET	

