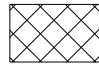

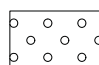



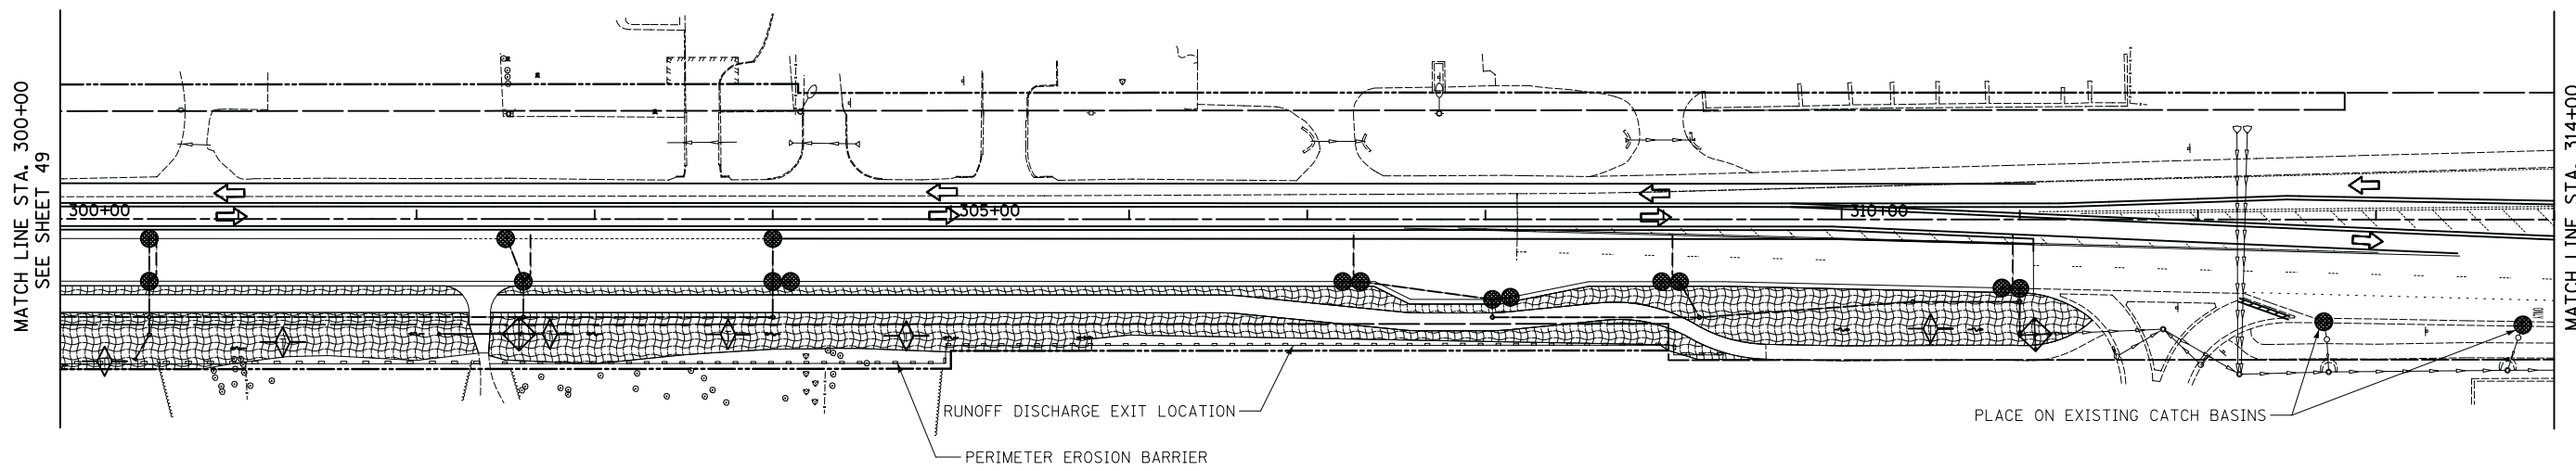
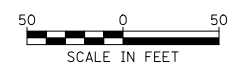
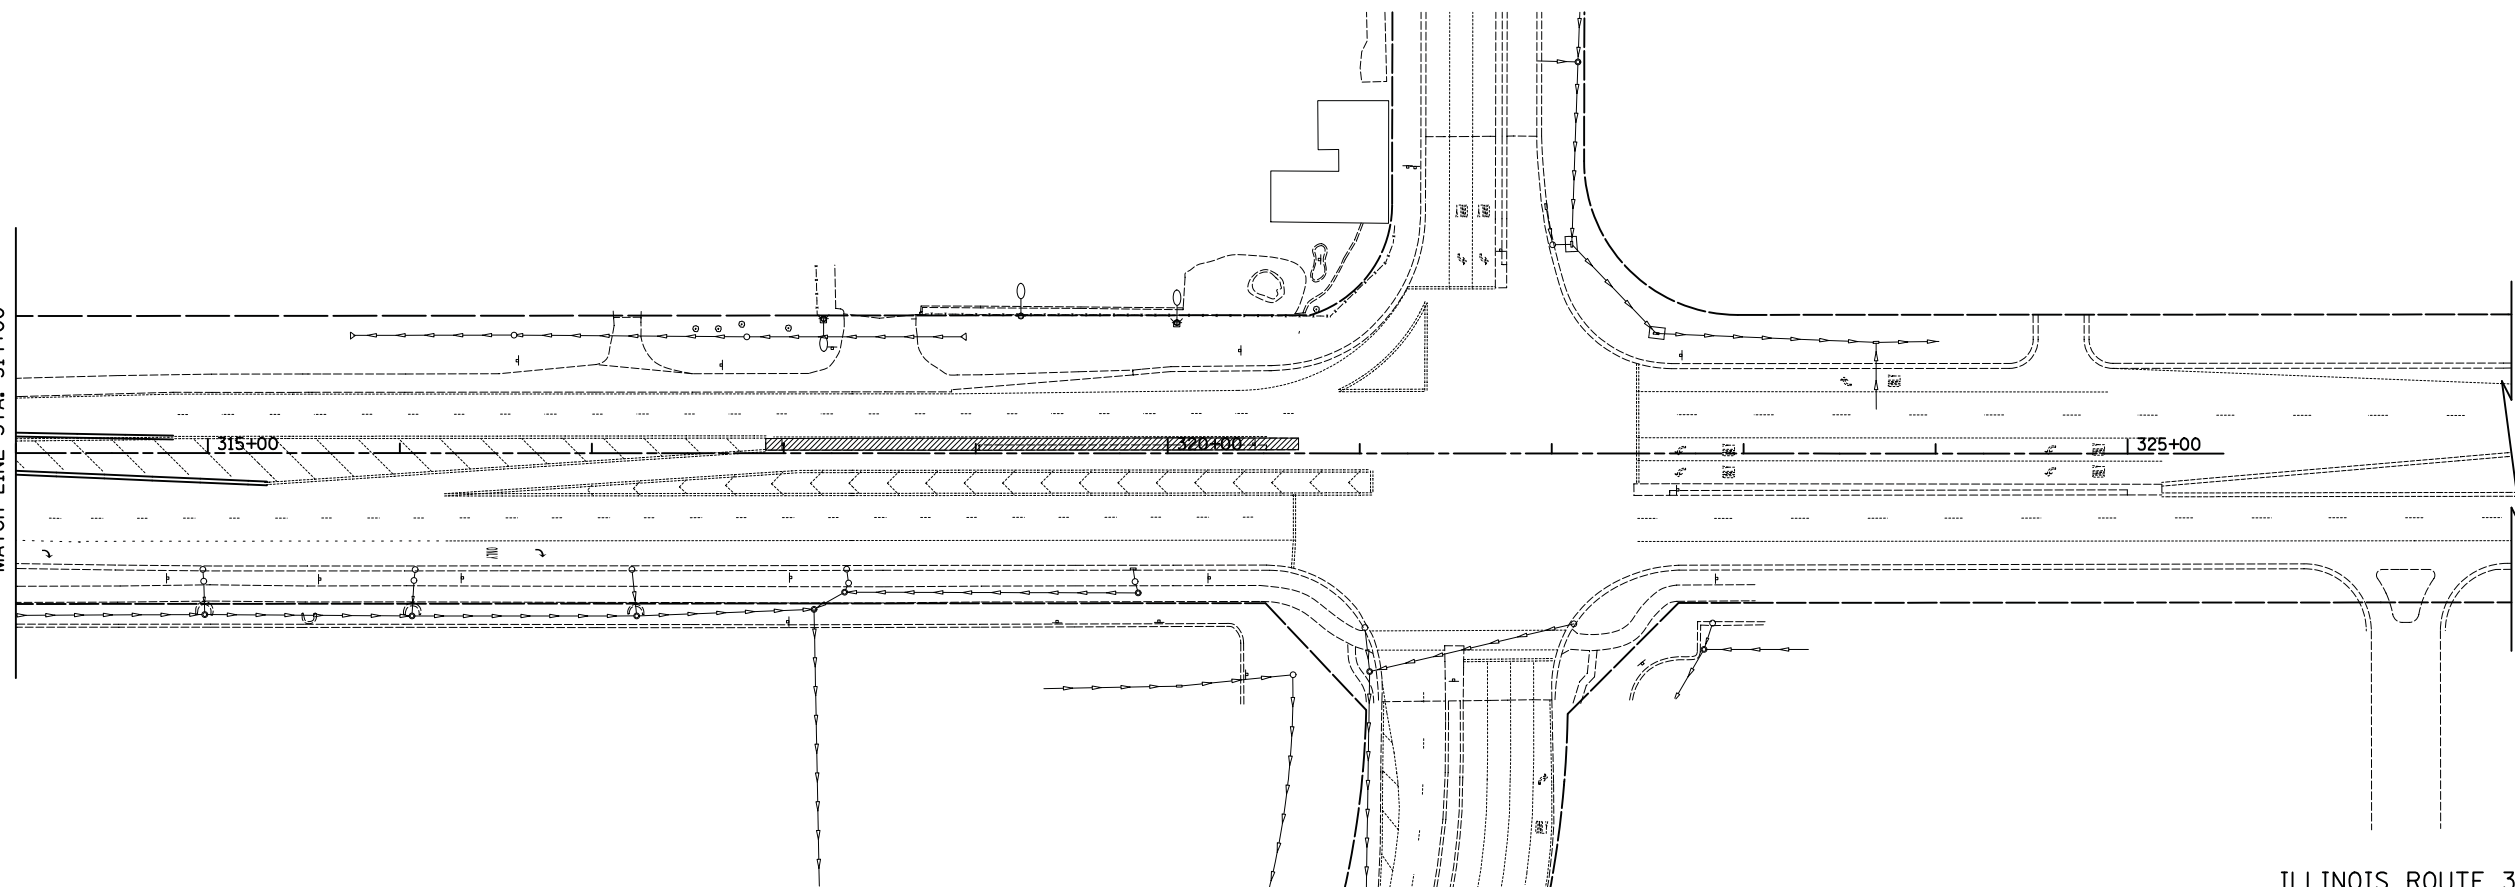


- LEGEND**
-  TEMPORARY PAVEMENT
 -  EROSION CONTROL BLANKET AND TEMPORARY EROSION CONTROL SEEDING
 -  MULCH, METHOD 2 AND TEMPORARY EROSION CONTROL SEEDING

-  PERIMETER EROSION BARRIER PLACED AROUND OPEN GRATE STRUCTURE AND END SECTION IN ACCORDANCE WITH 280001-05
-  INLET FILTERS
-  TEMPORARY DITCH CHECKS



MATCH LINE STA. 314+00
SEE SHEET 49



ILLINOIS ROUTE 31

FILE NAME =
... \2278NG.ERO.S1.02.dgn

USER NAME = kwh
PLOT SCALE = 50.0000' / in.
PLOT DATE = 8/5/2013

DESIGNED - KWH
DRAWN - PML
CHECKED - GAB
DATE - 06/24/2013

REVISED -
REVISED -
REVISED -
REVISED -

**STATE OF ILLINOIS
DEPARTMENT OF TRANSPORTATION**

EROSION AND SEDIMENT CONTROL - STAGE 1A & B

SCALE: 1" = 50' SHEET NO. 4 OF 6 SHEETS STA. 300+00 TO STA. 320+82.66

F.A.P. RTE.	SECTION	COUNTY	TOTAL SHEETS	SHEET NO.
3887	18W&RS-5 (12)	MCHENRY	151	51
CONTRACT NO. 60V72				
FED. ROAD DIST. NO. 1 ILLINOIS FED. AID PROJECT				