



**SHEET NOTES:**  
 1. ALL EXISTING DIMENSIONS AND ELEVATIONS ARE SHOWN FOR REFERENCE ONLY AND SHALL BE VERIFIED PRIOR TO COMMENCEMENT OF CONSTRUCTION AND/OR FABRICATION OF ANY MEMBERS TO DETERMINE ANY CRITICAL DIMENSIONS THAT MAY BE DEPENDENT ON THE EXISTING STRUCTURE.  
 2. SEE SHEETS S-001 AND S-002 FOR GENERAL NOTES AND ABBREVIATIONS.

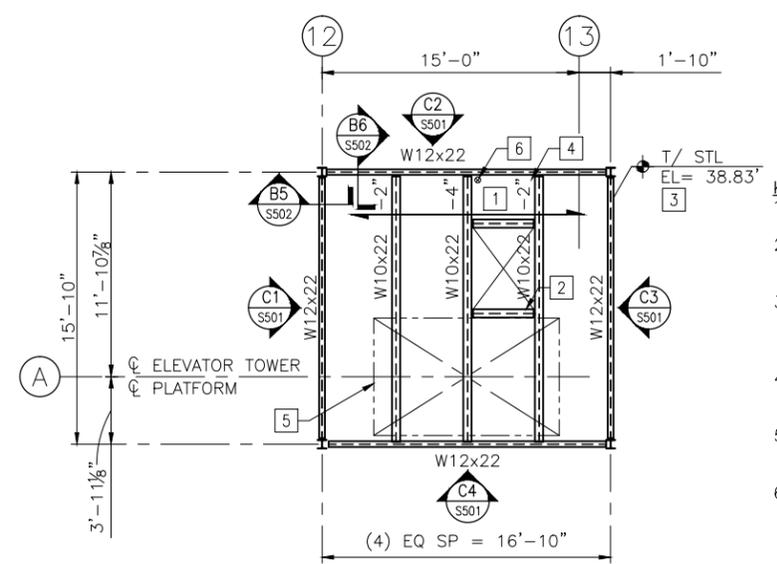



- KEYED NOTES:**
1. WB ROOF DECK.
  2. FRAME ROOF SCUTTLE WITH W10x22, EACH SIDE.
  3. TYPICAL T/ STL ELEVATION ALL AROUND ROOF, UNLESS NOTED OTHERWISE.
  4. LOWER TOP OF STEEL ELEVATION AS INDICATED IN THREE LOCATIONS.
  5. OUTLINE OF ELEVATOR TOWER STRUCTURE BELOW.
  6. ROOF DRAIN. ROOF DRAIN. SEE PLUMBING DRAWINGS.

**B1 ELEVATOR HIGH ROOF FRAMING PLAN**  
 SCALE: 3/16" = 1'-0"

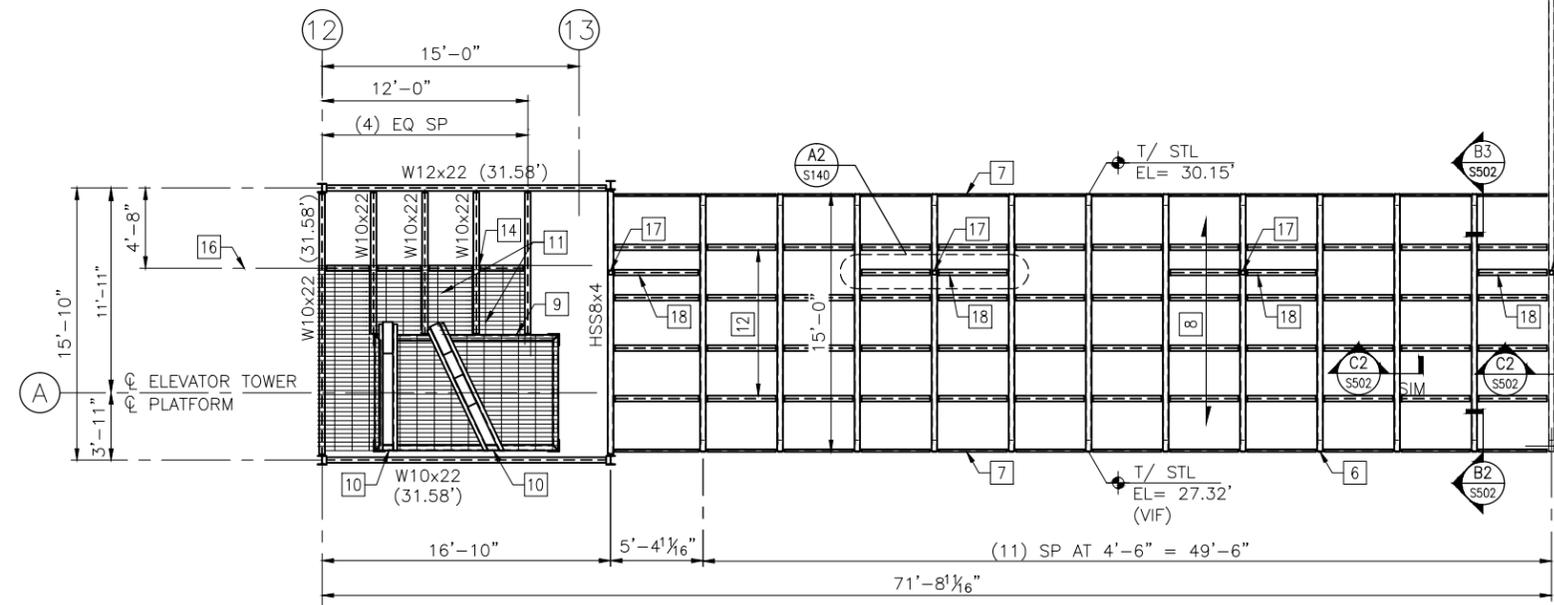


**A1 STATION ROOF FRAMING PLAN**  
 SCALE: 3/16" = 1'-0"

- KEYED NOTES:**
1. EXISTING HSS8x4 FRAME AT 4'-6".
  2. EXISTING 1/4" BENT PLATE AT EAVE BETWEEN HSS8x4 FRAMES.
  3. EXISTING DBL C4 AT RIDGE.
  4. EXISTING WT ROOF PURLINS TO REMAIN.
  5. NEW WT6x8 ROOF PURLINS INFILLED BETWEEN EXISTING WT ROOF PURLINS, UNO.
  6. NEW HSS8x4x3/16 FRAME AT (12) LOCATIONS ALONG CONNECTOR WALKWAY.
  7. 1/2" BENT PLATE
  8. NEW POLYCARBONATE ROOF DECKING.
  9. ELEVATOR TOWER STRUCTURE.
  10. ELEVATOR SHEAVE BEAMS, FINAL DESIGN AND LOCATION OF SHEAVE BEAMS BY ELEVATOR EQUIPMENT MANUFACTURE.
  11. 1" GALVANIZED STEEL GRATING.
  12. PROVIDE WT8x18 ROOF PURLINS THIS AREA, EQUALLY SPACED.
  13. PROVIDE WT8x18 ROOF PURLINS THIS AREA, INFILLED BETWEEN EXISTING WT ROOF PURLINS
  14. SEE ARCHITECTURAL DRAWINGS FOR HANDRAIL LAYOUTS AND DETAILS.
  15. HSS8x3x3/16 ROOF EAVE MEMBER.
  16. C OF (4) W10x22.
  17. HSS3x3x3/16, SS FALL PROTECTION. SEE ARCHITECTURAL DRAWINGS FOR LAYOUT.
  18. HSS6x4x5/16 BRACE AS INDICATED AT EACH PROTECTION STANCHION.

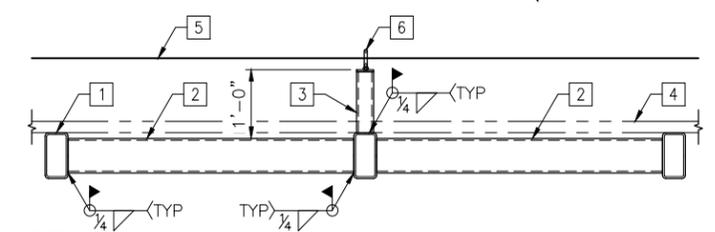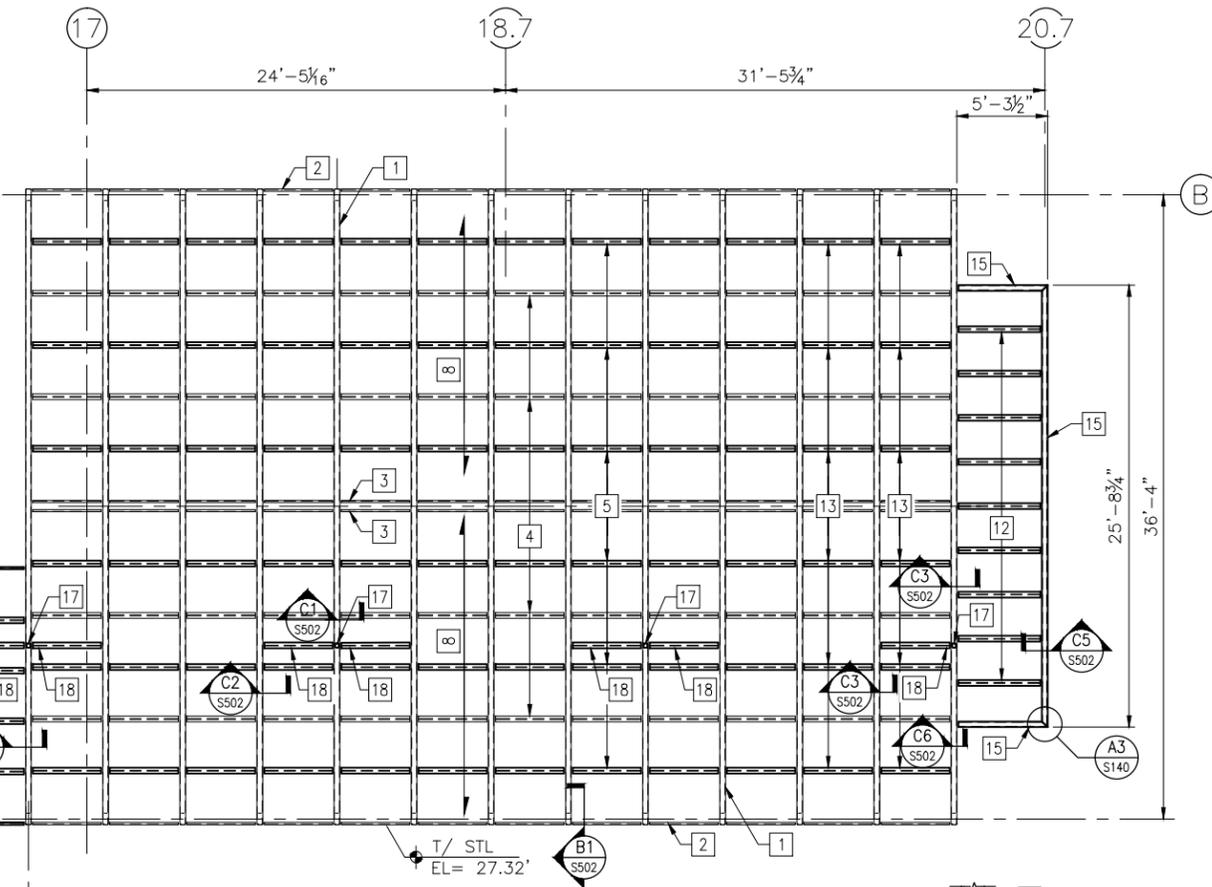


**A2 DETAIL**  
 3/4" = 1'-0"

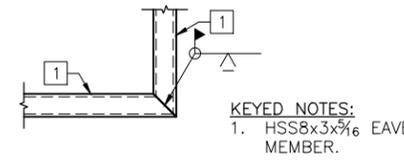

**A3 DETAIL**  
 3/4" = 1'-0"

- KEYED NOTES:**
1. HSS8x3x3/16 EAVE MEMBER.

- KEYED NOTES:**
1. TYPICAL HSS8x4BENT.
  2. HSS6x4x5/16 BRACE AT EACH FALL PROTECTION STANCHION AS INDICATED ON THE ROOF PLAN.
  3. HSS3x3x3/16 FALL PROTECTION STANCHION W/ 3/16 CAP PLATE. COORDINATE LOCATIONS WITH ARCHITECTURAL DRAWINGS.
  4. SEE ARCHITECTURAL DRAWINGS FOR ROOF SYSTEM.
  5. FALL PROTECTION ARRESTER CABLE PASSING THROUGH EYE-BOLT.
  6. 1/2" EYE-BOLT.

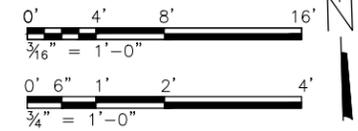

|                      |              |                     |
|----------------------|--------------|---------------------|
| USER NAME = MAC      | DESIGNED KLT | REVISED A 1/20/2014 |
|                      | CHECKED AB   | REVISED ---         |
| PLOT SCALE =         | DRAWN MAC    | REVISED ---         |
| PLOT DATE = 10/28/13 | CHECKED KLT  | REVISED ---         |

**STATE OF ILLINOIS**  
**DEPARTMENT OF TRANSPORTATION**

**PEORIA STREET STATION**  
**STATION ROOF FRAMING**

SHEET NO. S-140 OF 117 SHEETS

|          |                   |                           |                  |                    |
|----------|-------------------|---------------------------|------------------|--------------------|
| MUN 2090 | SECTION 2013-011R | COUNTY COOK               | TOTAL SHEETS 356 | SHEET NO. 205      |
|          |                   |                           |                  | CONTRACT NO. 60W29 |
|          |                   | ILLINOIS FED. AID PROJECT | FED. AID PROJECT |                    |