# 02-28-14 LETTING ITEM 006

FOR INDEX OF SHEETS, SEE SHEET NO. 2

THE PROJECT IS LOCATED IN THE VILLAGES OF ITASCA AND FRANKLIN PARK

# TRAFFIC DATA:

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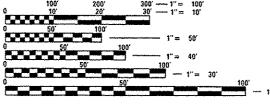
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THORNDALE AVE 2012 ADT = 39,500 POSTED SPEED LIMIT = 45 MPH

FRANKLIN AVE 2010 ADT = 12,600 POSTED SPEED LIMIT = 35 MPH



FULL SIZE PLANS HAVE BEEN PREPARED USING STANDARD ENGINEERING SCALES. REDUCED SIZED PLANS WILL NOT CONFORM TO STANDARD SCALES. IN MAKING MEASUREMENTS ON REDUCED PLANS, THE ABOVE SCALES MAY BE USED.

J.U.L.I.E. JOINT UTILITY LOCATION INFORMATION FOR EXCAVATION 1–800–892–0123 OR 811

PROJECT ENGINEER: DAN WILGREEN (847) 705-4240 PROJECT MANAGER: KEN ENG (847) 705-4247 STATE OF ILLINOIS


**DEPARTMENT OF TRANSPORTATION** 

**DIVISION OF HIGHWAYS** 


# PROPOSED HIGHWAY PLANS

FAP ROUTE 345: ELGIN O'HARE EXPRESSWAY SECTION: 2013–073DM AT VARIOUS LOCATIONS BUILDING DEMOLITION DUPAGE & COOK COUNTIES C-91-115-14

PROJECT: ACPNRS-0345 (058)

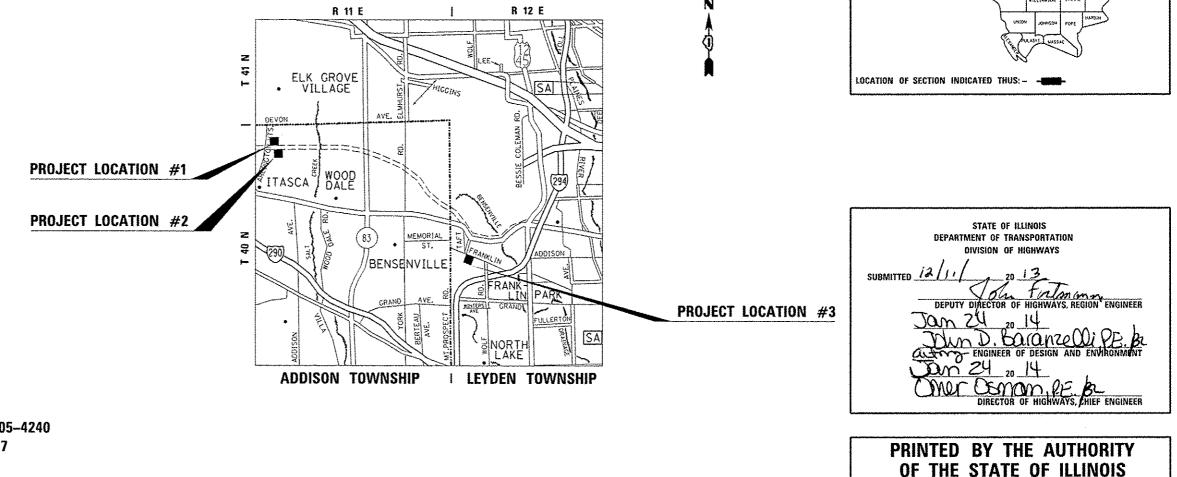

CONTRACT NO. 60X50

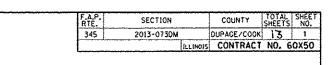

D-91-115-14



### **INDEX OF SHEETS**

# **HIGHWAY STANDARDS**

000001-04 STANDARD SYMBOLS, ABBREVIATIONS AND PATTERNS

701001 -02 OFF-ROAD OPERATIONS, MULTILANE, 15' (4.5 M) TO 24" (600 MM)

701006 105 OFF-ROAD OPERATIONS, 2L, 2W, 15' (4.5 M) TO 24" (600 MM) FROM

280001-07 TEMPORARY EROSION CONTROL SYSTEMS

FROM PAVEMENT EDGE

PAVEMENT FOGE

701901-03 TRAFFIC CONTROL DEVICES

STANDARD NO. DESCRIPTION

### **GENERAL NOTES**

BEFORE STARTING ANY EXCAVATION, THE CONTRACTOR SHALL CALL "J.U.L.I.E." AT (800) 892-0123 OR 811 FOR FIELD LOCATIONS OF BURIED ELECTRIC. TELEPHONE AND GAS UTILITIES. 48 HOUR NOTIFICATION IS REQUIRED.

THE CONTRACTOR SHALL COORDINATE CONSTRUCTION ACTIVITIES WITH UTILITY COMPANIES. AND THE VILLACES OF ITASCA AND FRANKLIN PARK.

IT SHALL BE THE CONTRACTOR'S RESPONSIBILITY TO VERIFY ALL DIMENSIONS AND CONDITIONS EXISTING IN THE FIELD PRIOR TO CONSTRUCTION AND ORDERING OF MATERIALS.

THE CONTRACTOR IS RESPONSIBLE FOR OBTAINING A DEMOLITION PERMIT FROM THE VILLAGES OF ITASCA AND FRANKLIN PARK.

THE CONTRACTOR MUST CONTACT THE VILLAGES OF ITASCA AND FRANKLIN PARK FOR CORRESPONDING UTILITY DISCONNECTION REQUIREMENTS,

BACKFILL USED FOR ANY HOLES, SUCH AS BASEMENTS, SHALL BE FILLED WITH POROUS GRANULAR EMBANKMENT AND SHALL BE INCLUDED IN THE UNIT PRICE FOR BUILDING REMOVAL.

ALL TRAFFIC CONTROL SHALL BE INCLUDED IN THE UNIT PRICE FOR BUILDING REMOVAL AND DEBRIS REMOVAL, EXCEPT FOR TEMPORARY INFORMATION SIGNING.

SIGNING.

IN THE UNIT PRICE FOR BUILDING REMOVAL

ALL PERMIT FEES FOR THE DISCONNECTION OF UTILITIES SHALL BE INCLUDED IN THE UNIT PRICE FOR BUILDING REMOVAL.

(DUPAGE COUNTY)

60143 (DUPAGE COUNTY)

60131 (COOK COUNTY)

1	USER NAME = marazykma	DESIGNED -	REVISED -			
et/px_vork/pvzdat/morazykne/d0372312/01		ORAWN -	REVISED -	STATE OF ILLINOIS	BUILDING DEMOLITION	F.A.P. SECTION COUNTY TOTAL SHEET
	PLOT SCALE + 60.0000 1/ 10.	CHECKED -	REVISED -	DEPARTMENT OF TRANSPORTATION	INDEX OF SHEETS, LIST OF STATE STANDARDS & GENERAL NOTES	
L	PLOT DATE + 12/19/2013	DATE -	REVISED -		FAME A STATE	CONTRACT NO. 60X50
					SCALE: SHEET NO. 1 OF 1 SHEETS STA. TO STA.	FED. ROAD DIST. NO. ILLINOIS FED. ALD PROJECT

### SHEET NO. DESCRIPTION

- 1 TITLE SHEET
- 2 INDEX OF SHEETS, STATE STANDARDS, AND GENERAL NOTES
- 3 SUMMARY OF QUANTITIES
- 4-6 BUILDING DEMOLITION PLAN
- 7-9 LANDSCAPING AND EROSION CONTROL PLAN
- 10-12 PLAT OF HIGHWAYS (FOR INFORMATION ONLY)
- 13 TRAFFIC CONTROL AND PROTECTION FOR SIDE ROADS, INTERSECTIONS, AND DRIVEWAYS (TC-10)

THE CONTRACTOR WILL NOT BE ALLOWED TO SET UP A YARD OR FIELD OFFICE ON STATE PROPERTY WITHOUT WRITTEN PERMISSION FROM THE DEPARTMENT.

CONTRACTOR SHALL INSTALL "TRUCKS ENTERING AND LEAVING HIGHWAY" SIGNS, W21-1105 (MODIFIED) IN EACH DIRECTION ON THORNDALE AVE AND FRANKLIN AVE APPROACHING BUILDING DEMOLITION SITE, THESE SIGNS SHALL BE PAID AS TEMPORARY INFORMATION

DUST CONTROL FOR EACH SITE SHALL BE IN ACCORDANCE TO ARTICLE 107.36 OF THE STANDARD SPECIFICATIONS FOR ROAD AND BRIDGE CONSTRUCTION, AND SHALL BE INCLUDED


LOCATION NUMBER ONE (\*1) IS IDENTIFIED AS: 19W144 THORNDALE AVENUE, ITASCA, IL 60143

LOCATION NUMBER TWO (\*2) IS IDENTIFIED AS: 19W073 THORNDALE AVENUE, ITASCA, IL

LOCATION NUMBER THREE ("3) IS IDENTIFIED AS: 11535 FRANKLIN AVENUE, FRANKLIN PARK, IL


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25000200	SEEDING, CLASS 2	ACRE	2.4	0.1	0.1	2, 2			1							
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25100105	MULCH. METHOD 1	ACRE	2.4	0.1	0. 1	2. 2						ASBESTOS, BU	ILDING NO. 1		.,	
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44000200	ORIVENAY PAVEMENT REMOVAL	SO YO	590	200		3 <del>9</del> 0	*** * *				· · · · · · · · · · · ·	ASBESTOS, BU	ILDING NO. 3			
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44000600	SIDEWALK REMOVAL	SO FT	1776	291	504	981			· · · · · · · · · · · · · · · · · · ·	Ø	20076604	TRAINEES - PR	TRAINING		HOLIR	500
67000400	ENGINEER'S FIELD OFFICE, TYPE A	CAL MO	6	2	2			· · ·								
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20022800	FENCE REMOVAL	FOOT	120	45	· · · · ·	75	·				· · · · · · · · ·					
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ITION PLAN	F.A.P. RTE.	SECTION	COUNTY	TOTAL SHEETS	SHEET NO.	
SCA, IL 60143 (LOCATION 1)	345 2013-073DM		DUPAGE/COOK	13	4	
SCA, IL BOITS (LOCATION I)			CONTRACT	NO. 6	0X50	
STA. TO STA.	ILLINOIS FED. AID PROJECT					

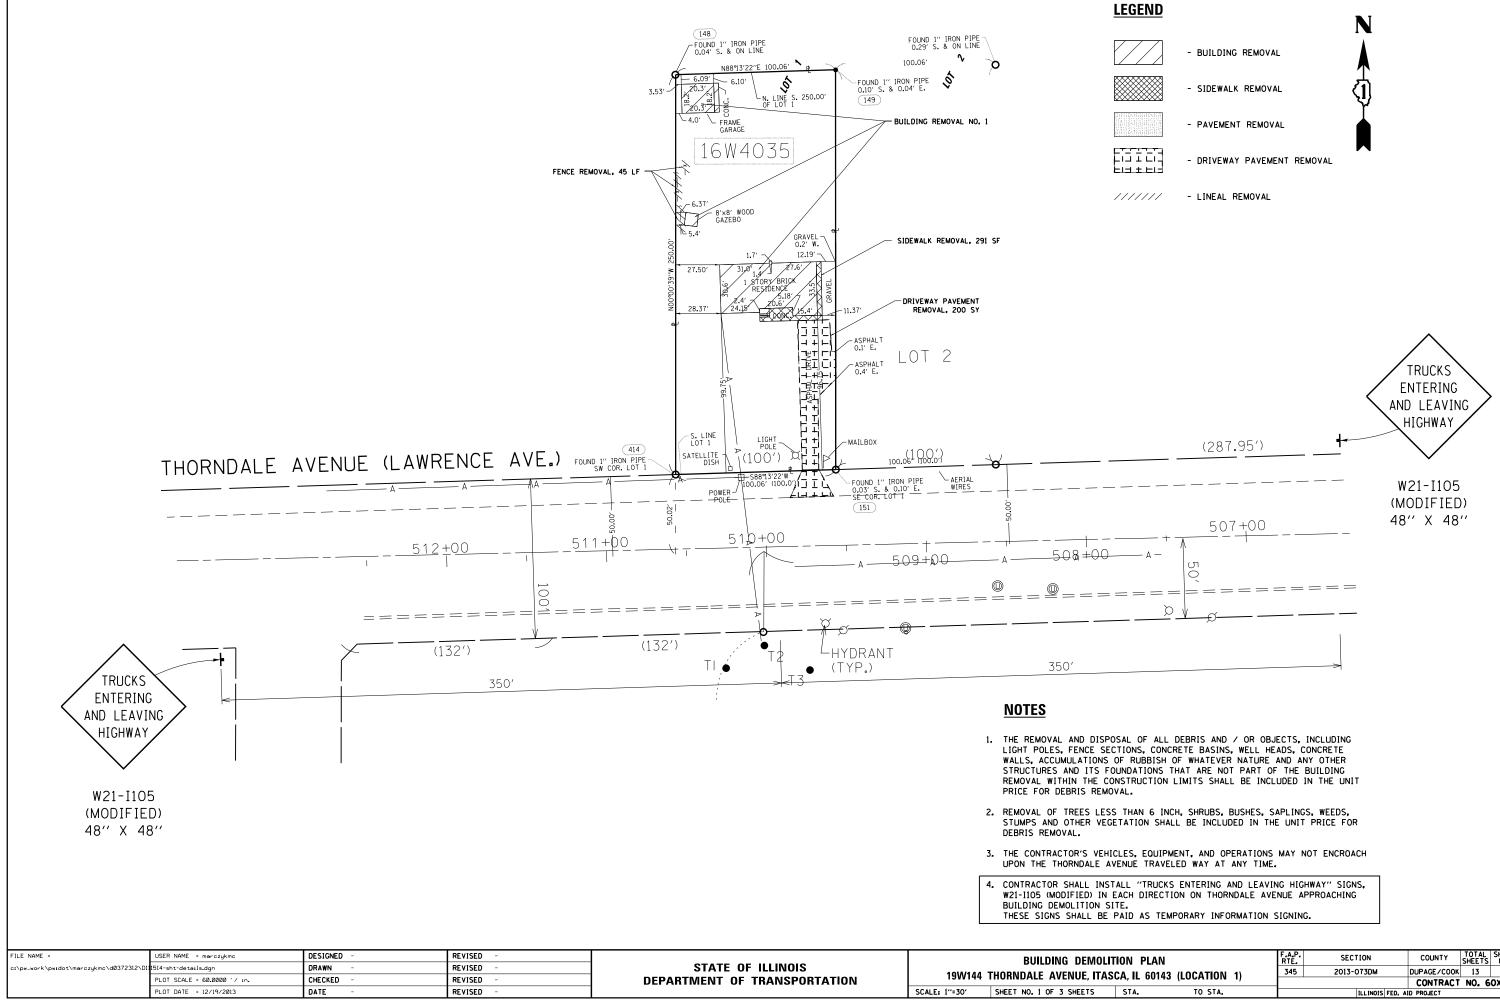

<b>LEGEND</b>	Ν
	- BUILDING REMOVAL
	- SIDEWALK REMOVAL
	- PAVEMENT REMOVAL
L'  - _  ± L _  - _= ± E =	- DRIVEWAY PAVEMENT REMOVAL
///////	- LINEAL REMOVAL
IP NER (129 129	9.71') 9.75'
5	02+00
	 20.05′ 120.0′)


 THE REMOVAL AND DISPOSAL OF ALL DEBRIS AND / OR OBJECTS, INCLUDING LIGHT POLES, FENCE SECTIONS, CONCRETE BASINS, WELL HEADS, CONCRETE WALLS, ACCUMULATIONS OF RUBBISH OF WHATEVER NATURE AND ANY OTHER STRUCTURES AND ITS FOUNDATIONS THAT ARE NOT PART OF THE BUILDING REMOVAL WITHIN THE CONSTRUCTION LIMITS SHALL BE INCLUDED IN THE UNIT PRICE FOR DEBRIS REMOVAL.

2. REMOVAL OF TREES LESS THAN 6 INCH, SHRUBS, BUSHES, SAPLINGS, WEEDS, STUMPS AND OTHER VEGETATION SHALL BE INCLUDED IN THE UNIT PRICE FOR

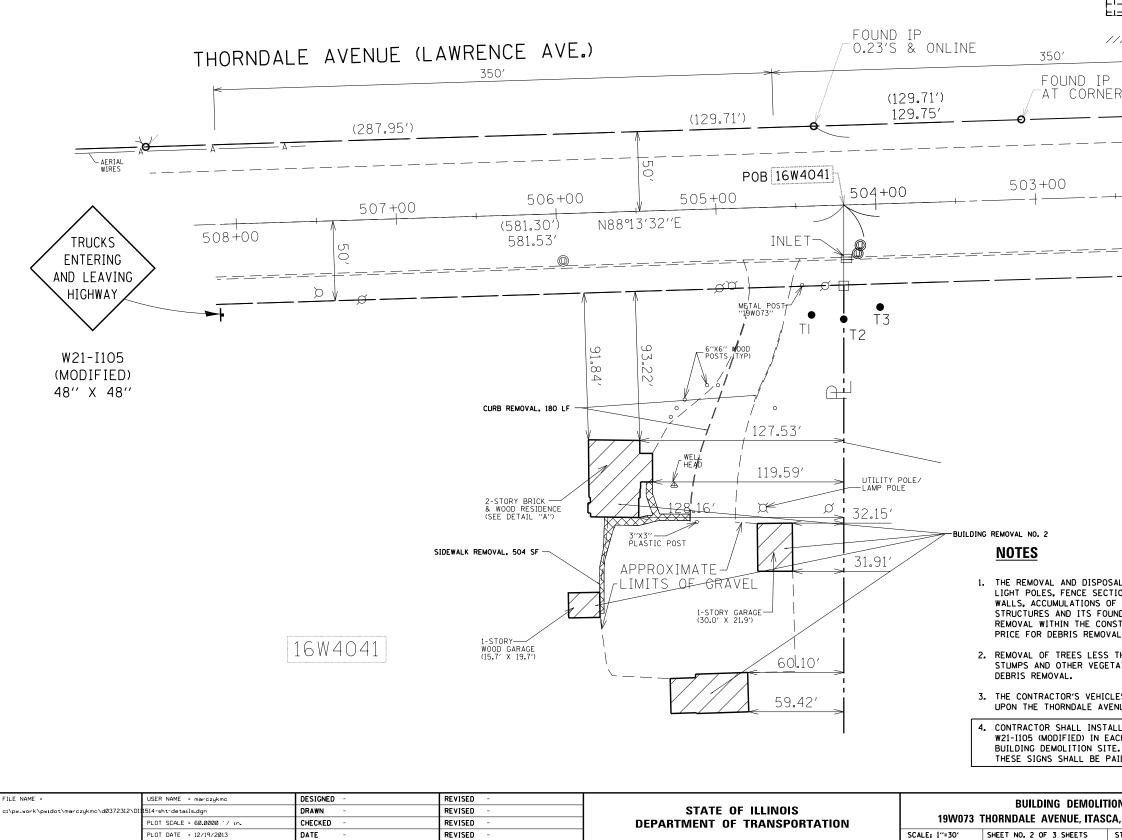3. THE CONTRACTOR'S VEHICLES, EQUIPMENT, AND OPERATIONS MAY NOT ENCROACH UPON THE THORNDALE AVENUE TRAVELED WAY AT ANY TIME.

4. CONTRACTOR SHALL INSTALL "TRUCKS ENTERING AND LEAVING HIGHWAY" SIGNS, W21-I105 (MODIFIED) IN EACH DIRECTION ON THORNDALE AVENUE APPROACHING BUILDING DEMOLITION SITE. THESE SIGNS SHALL BE PAID AS TEMPORARY INFORMATION SIGNING.

LITION PLAN	F.A.P. RTE.	SECTION		COUNTY	TOTAL SHEETS	SHEET NO.
ASCA, IL 60143 (LOCATION 2)	345	2013-073DM		DUPAGE/COOK	13	5
COCATION 2				CONTRACT	NO. 6	0X50
STA. TO STA.		ILLINOIS	FED. A	D PROJECT		

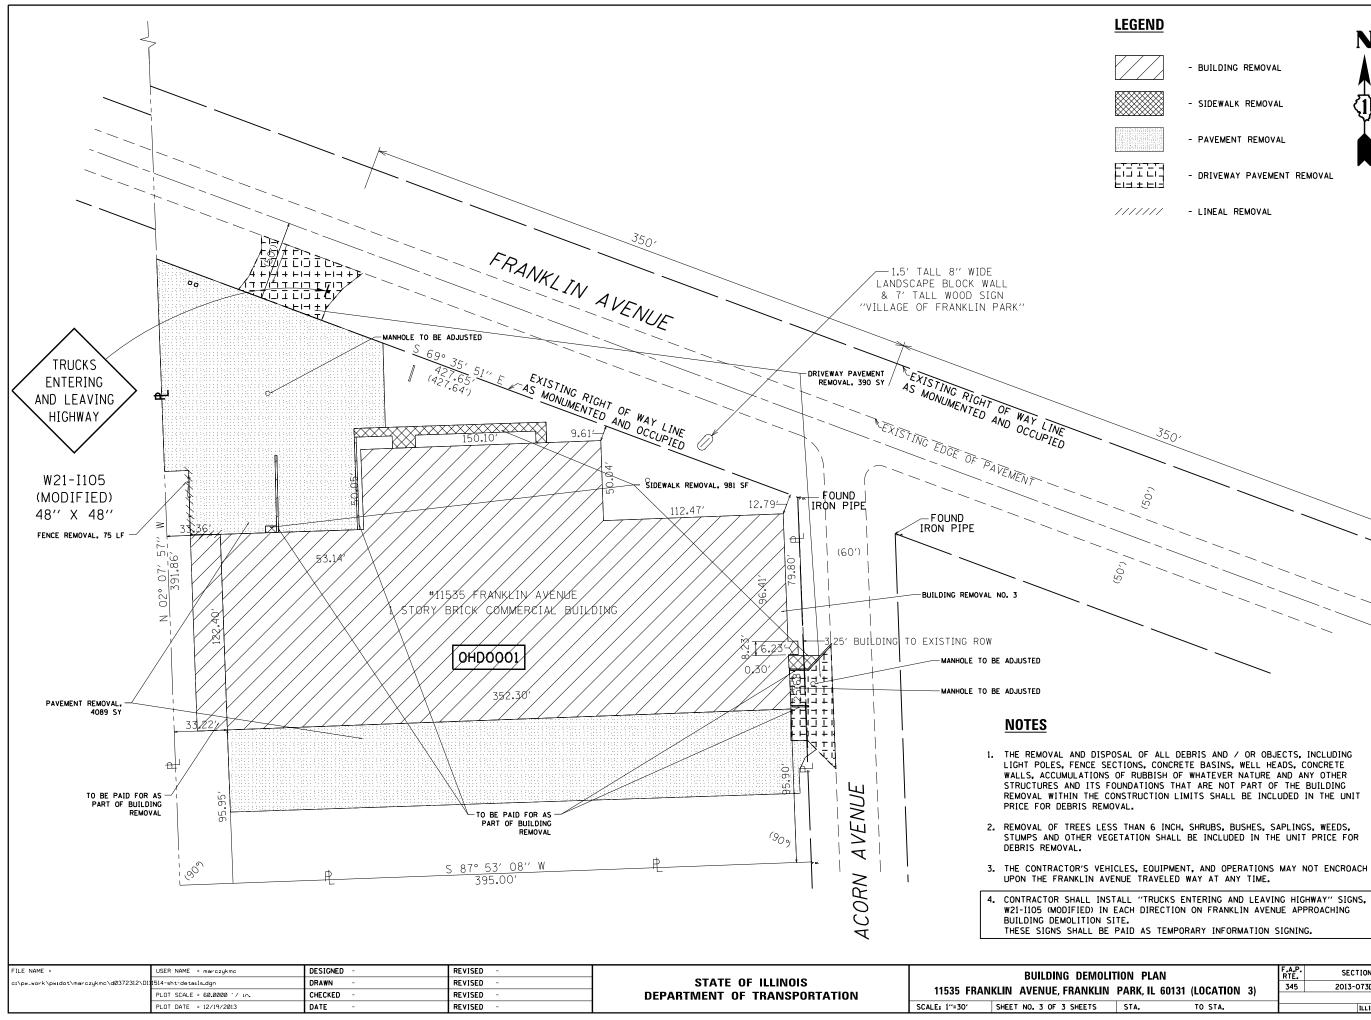

TOTAL SHEE SHEETS NO. SECTION COUNTY DUPAGE/COOK 13 6 2013-073DM CONTRACT NO. 60X50 ILLINOIS FED. AID PROJECT

TRUCKS ENTERING AND LEAVING HIGHWAY

> W21-I105 (MODIFIED) 48'' X 48''



### **EROSION CONTROL GENERAL NOTES**

ALL EROSION CONTROL MEASURES SHALL BE IN ACCORDANCE WITH THE PROCEDURES AND STANDARDS FOR URBAN SOIL EROSION AND SEDIMENTATION CONTROL MANUAL.

SOIL DISTURBANCE SHALL BE CONDUCTED IN SUCH A MANNER AS TO MINIMIZE EROSION. SOIL STABILIZATION MEASURES SHALL CONSIDER THE TIME OF YEAR, SITE CONDITIONS, AND THE USE OF TEMPORARY OR PERMANENT MEASURES.


SOIL EROSION AND SEDIMENTATION CONTROL FEATURES SHALL BE CONSTRUCTED PRIOR TO THE COMMENCEMENT OF UPLAND DISTURBANCE.

TEMPORARY SOIL STABILIZATION SHALL BE APPLIED TO DISTURBED AREAS WITHIN 14 CALENDAR DAYS OF THE END OF THE ACTIVE HYDROLIC DISTURBANCE. PERMANENT STABILIZATION SHALL BE DONE WITHIN 14 DAYS AFTER COMPLETION OF THE FINAL GRADING OF THE SOIL.

ALL TEMPORARY EROSION AND SEDIMENT CONTROL MEASURES SHALL BE REMOVED WITHIN 30 DAYS AFTER FINAL SITE STABILIZATION IS ACHIEVED OR AFTER TEMPORARY MEASURES ARE NO LONGER NEEDED. TRAPPED SEDIMENT AND OTHER DISTURBED SOIL AREAS SHALL BE PERMANENTLY STABILIZED.

ALL TEMPORARY AND PERMANENT EROSION CONTROL MEASURES MUST BE MAINTAINED AND REPAIRED AS NEEDED. THE GENERAL CONTRACTOR WILL BE RESPONSIBLE FOR INSPECTION AND REPAIR DURING CONSTRUCTION. THE OWNER WILL BE RESPONSIBLE IF EROSION CONTROL IS REQUIRED AFTER THE CONTRACTOR HAS COMPLETED THE PROJECT.

THE EROSION CONTROL MEASURES INDICATED ON THE PLANS ARE THE MINIMUM REQUIREMENTS. ADDITIONAL MEASURES MAY BE REQUIRED, AS DIRECTED BY THE ENGINEER OR GOVERNING AGENCY.

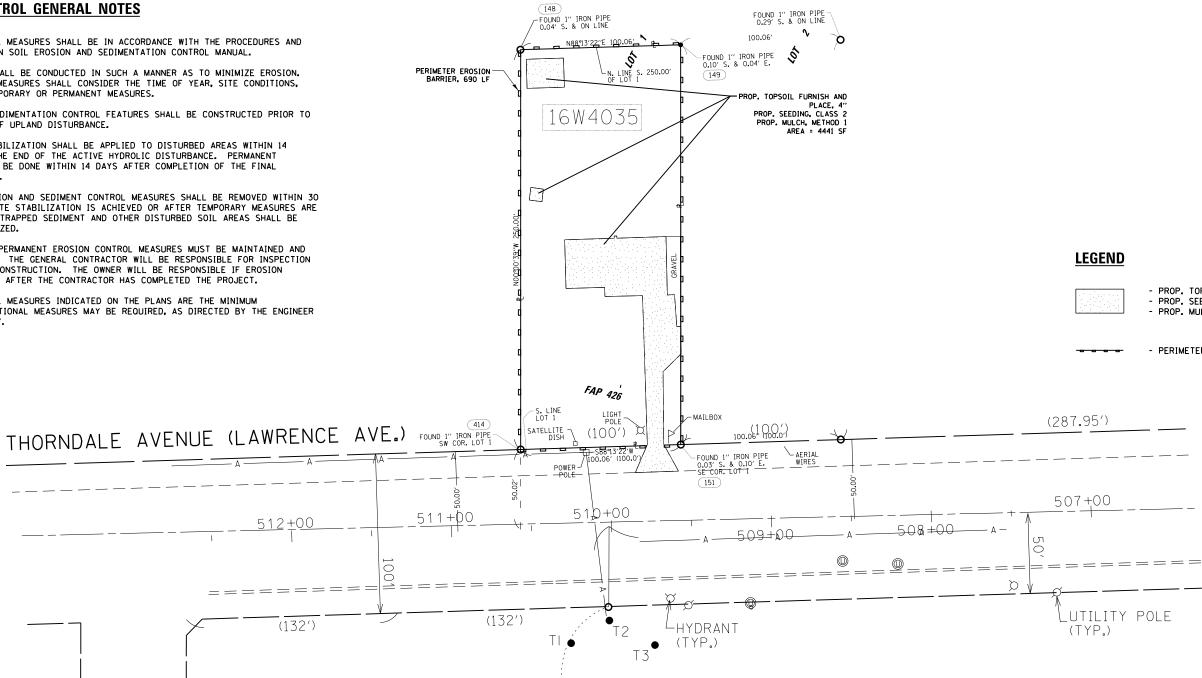


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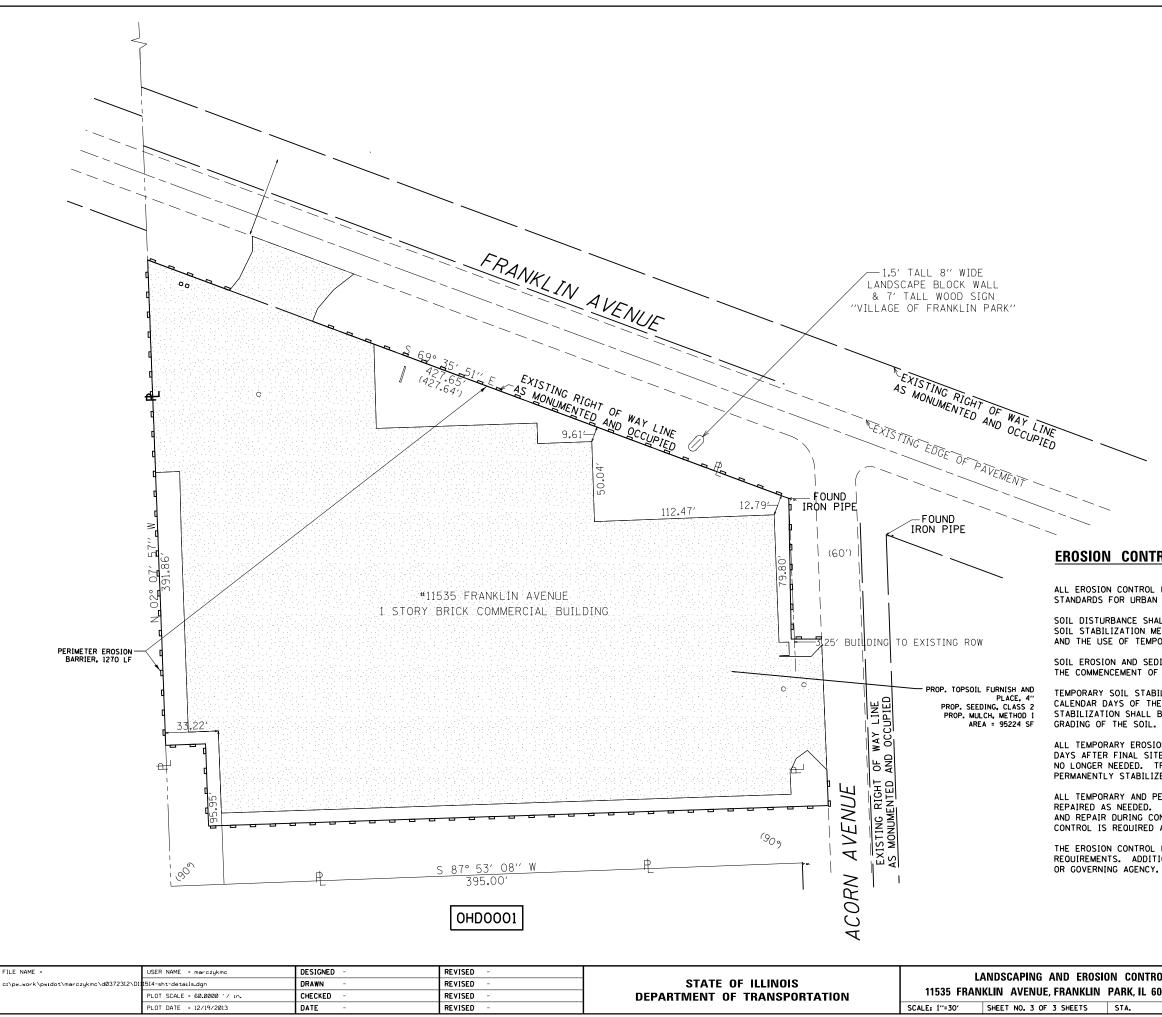


<ul> <li>PROP. TOPSOIL FURNISH AND</li> <li>PROP. SEEDING, CLASS 2</li> <li>PROP. MULCH, METHOD 1</li> </ul>	) PLACE, 4"
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- PERIMETER EROSION BARRIER



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c:\pw_work\pwidot\marczykmc\d0372312\D1	1514-sht-details.dgn	DRAWN -	REVISED -	STATE OF ILLINOIS	19W073 THORNDALE AVENUE, ITAS		
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# **LEGEND**

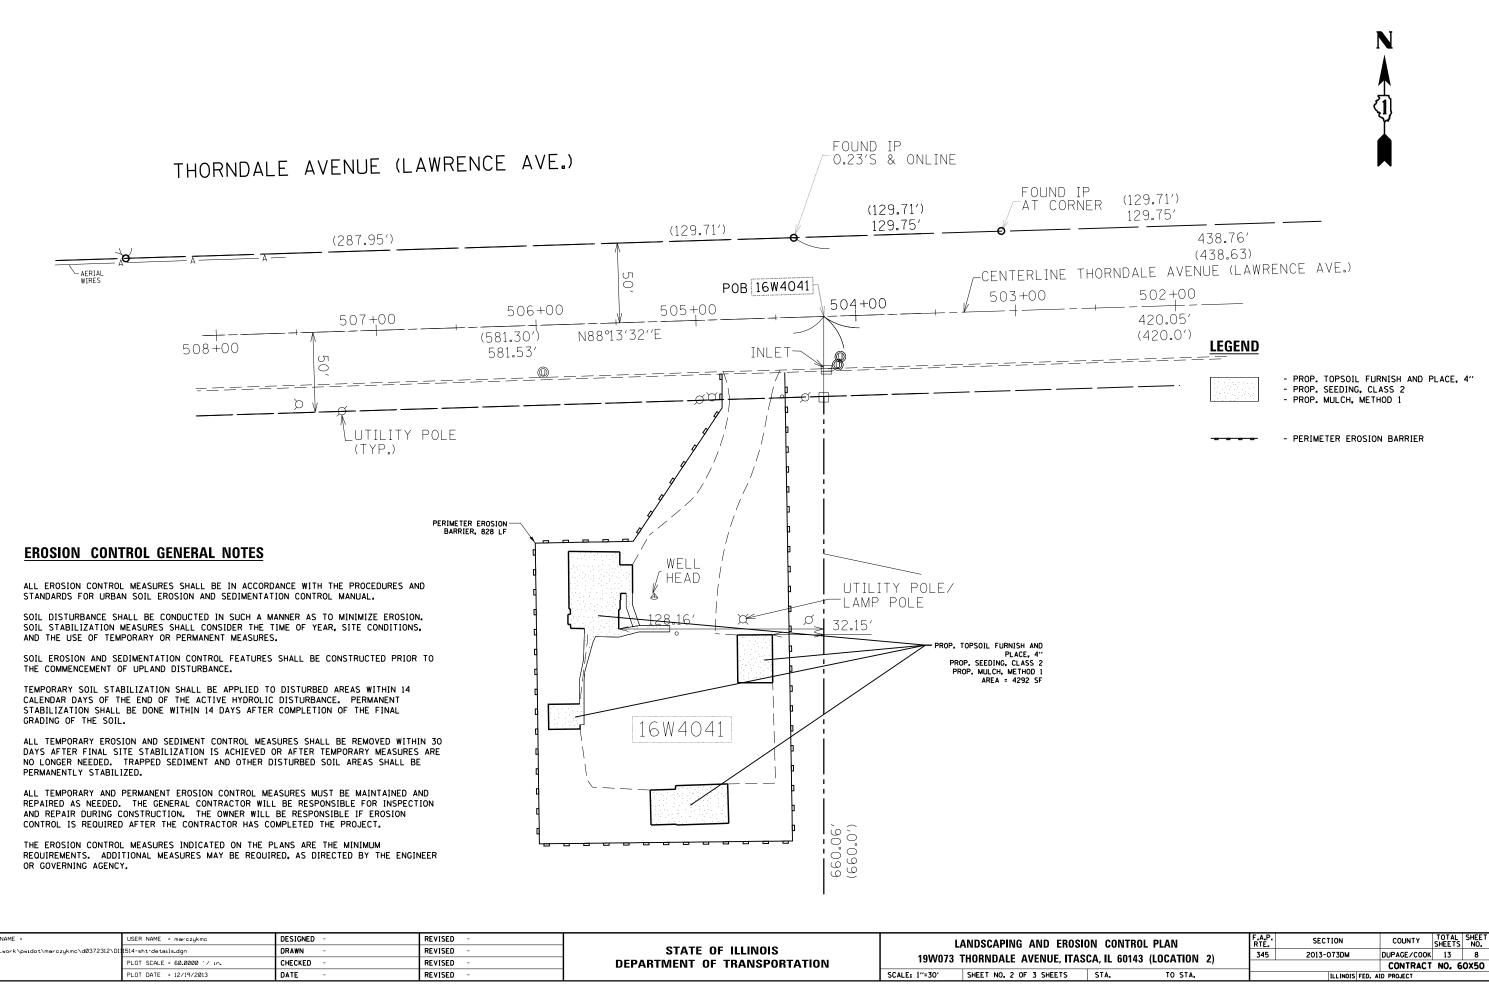- PROP. TOPSOIL FURNISH AND PLACE, 4" - PROP. SEEDING, CLASS 2 - PROP. MULCH, METHOD 1
 - PERIMETER EROSION BARRIER

# **EROSION CONTROL GENERAL NOTES**

ALL EROSION CONTROL MEASURES SHALL BE IN ACCORDANCE WITH THE PROCEDURES AND STANDARDS FOR URBAN SOIL EROSION AND SEDIMENTATION CONTROL MANUAL.

SOIL DISTURBANCE SHALL BE CONDUCTED IN SUCH A MANNER AS TO MINIMIZE EROSION. SOIL STABILIZATION MEASURES SHALL CONSIDER THE TIME OF YEAR, SITE CONDITIONS, AND THE USE OF TEMPORARY OR PERMANENT MEASURES.

SOIL EROSION AND SEDIMENTATION CONTROL FEATURES SHALL BE CONSTRUCTED PRIOR TO THE COMMENCEMENT OF UPLAND DISTURBANCE.


TEMPORARY SOIL STABILIZATION SHALL BE APPLIED TO DISTURBED AREAS WITHIN 14 CALENDAR DAYS OF THE END OF THE ACTIVE HYDROLIC DISTURBANCE. PERMANENT STABILIZATION SHALL BE DONE WITHIN 14 DAYS AFTER COMPLETION OF THE FINAL GRADING OF THE SOIL.

ALL TEMPORARY EROSION AND SEDIMENT CONTROL MEASURES SHALL BE REMOVED WITHIN 30 DAYS AFTER FINAL SITE STABILIZATION IS ACHIEVED OR AFTER TEMPORARY MEASURES ARE NO LONGER NEEDED. TRAPPED SEDIMENT AND OTHER DISTURBED SOIL AREAS SHALL BE PERMANENTLY STABILIZED.


ALL TEMPORARY AND PERMANENT EROSION CONTROL MEASURES MUST BE MAINTAINED AND REPAIRED AS NEEDED. THE GENERAL CONTRACTOR WILL BE RESPONSIBLE FOR INSPECTION AND REPAIR DURING CONSTRUCTION. THE OWNER WILL BE RESPONSIBLE IF EROSION CONTROL IS REQUIRED AFTER THE CONTRACTOR HAS COMPLETED THE PROJECT.

THE EROSION CONTROL MEASURES INDICATED ON THE PLANS ARE THE MINIMUM REQUIREMENTS. ADDITIONAL MEASURES MAY BE REQUIRED, AS DIRECTED BY THE ENGINEER OR GOVERNING AGENCY.


SION CONTROL PLAN	F.A.P. RTE	SECTION	COUNTY	TOTAL SHEETS	SHEET NO.
I PARK, IL 60131 (LOCATION 3)	345	2013-073DM	DUPAGE/COOK	13	9
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PLOT DATE = 12/19/2013

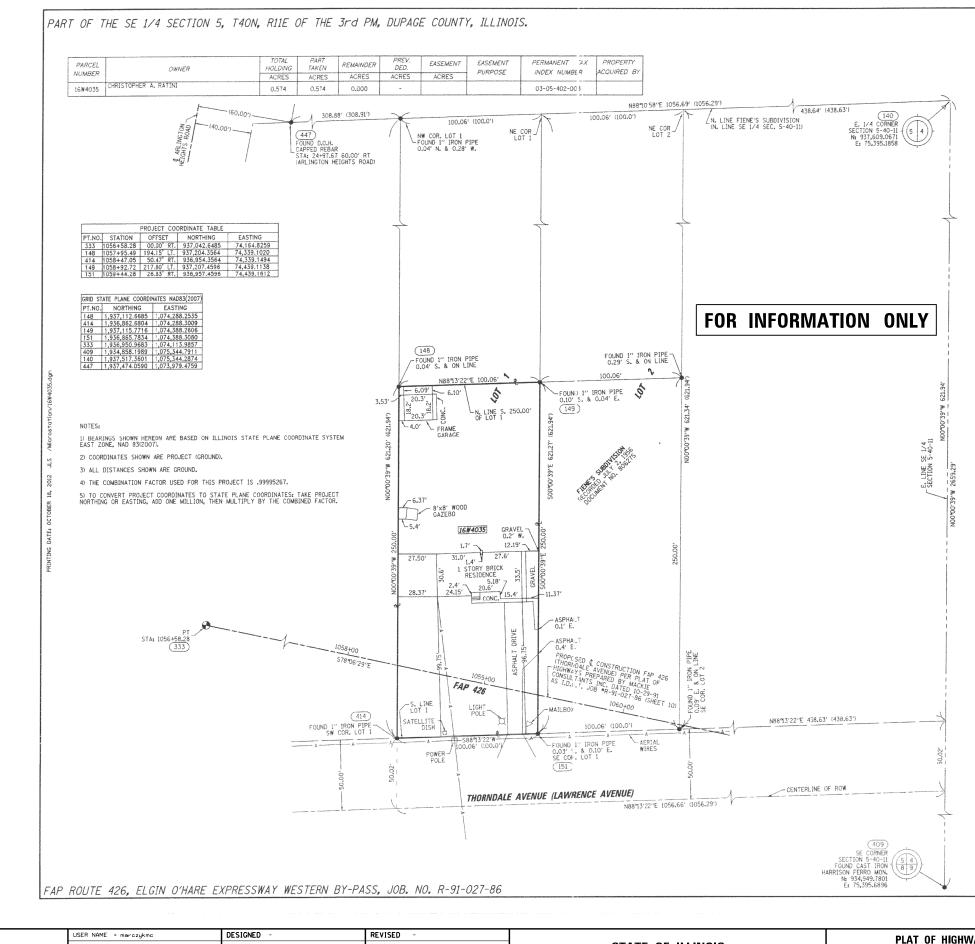
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MAR 03		DEPARTME	NT OF TRANSPORTATION ELGIN-O'HARE EXPRESSWA	m		
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			hone: (847) 696-4060 Fax: (847) 696			
			9575 W. Higgins Road, Sult Rosemont, Illinois	e 700, State		
			SITE DEVELOPMENT E	NGINEERS		
	Π	8	CONSULTING ENGIN			
		UNDARY SURVEY.				
			CURRENT ILLINOIS MINIMUM			
ILLINOI		AL LAND SURVEYOR NO. 03 DATE: NOVEMBER 30, 2012				
process						
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T2 T3 BT1	COLORED PLA	STIC CAP BEARING SURVE	YORS REGISTRATION NUMBER.			
• T1 T2			SET MONUMENTATION. SET 5			
<b>P</b> +		R ROD FOUND O REPLA	CED AFTER CONSTRUCTION			
	Departm	ent of Transportation				
		are referenced to th	he Illinois State Plane Coo			
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		PLATTED LOT LINES PROPERTY (DEED) LINE				
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	0A, IL	CONTROL 2/			CONTRACT	NO.	60X50
	STA.	TO STA.		ILLINOIS FED.	AID PROJECT		

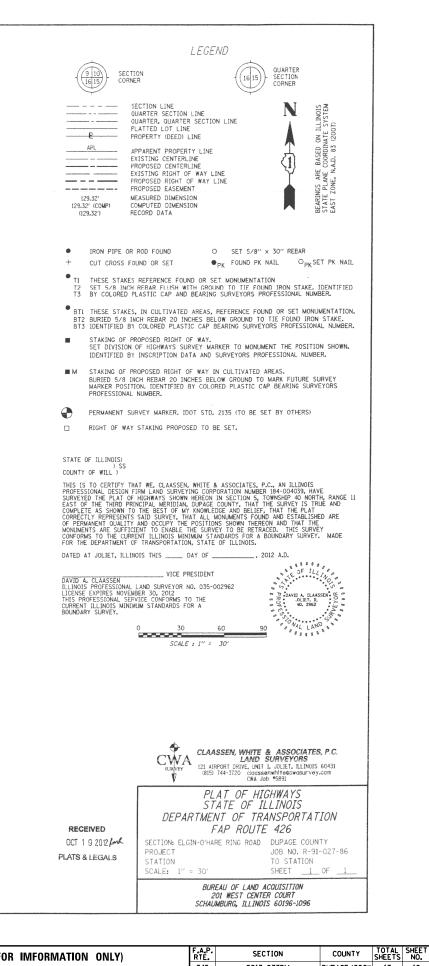

FILE NAME =	USER NAME = marczykmc	DESIGNED -	REVISED -		PI	AT OF HIGHWAYS (FOR IN	
c:\pw_work\pwidot\marczykmc\d0372312\D1	1514-sht-details.dgn	DRAWN -	REVISED -	STATE OF ILLINOIS			
	PLOT SCALE = 60.0000 '/ in.	CHECKED -	REVISED -	DEPARTMENT OF TRANSPORTATION	11535 FRAN	IKLIN AVENUE, FRANKLIN	PAKK, IL
	PLOT DATE = 12/19/2013	DATE -	REVISED -		SCALE:	SHEET NO. 3 OF 3 SHEETS	STA.


PARK, IL 60	131 (LOCATIO	JN 3)		2013-013DM		CONTRACT		
MFORMATIO			F.A.P. RTE. 345	SECTION 2013-073DM		COUNTY PAGE/COOK	SHEETS 13	SHEET NO. 12
and a second		1976 8 and district		yn a'r annan yn anwrag gyddiaddalarau			TOTAL	CHEET
MADE BY			RG, ILLINOIS					
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	STATION SCALE: 1" =	40'	TO S	TATION T 1 OF 1	and the second second second			
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, en en en la fait (	1	PARTMENT	OF ILLING OF TRANSP IARE EXPRES					
GRAEF PROJECT 20063022.37		PLAT (		IWAYS				
PTB 138/001 WORK ORDER 37	GRa	FF	8501 West Higgins I Suite 280 Chicago, IL 60631-2 773 / 399 0112 Illinois Professional Corporation 184-000	801 Design				
				FEB 09 2011				
	AL SERVICE CONFOR A STANDARDS FOR A			RECEIVED				
	SIONAL LAND SURVE ION DATE: 11/30/20							
DATED AT CHICAG	GO, ILLINOIS THIS 9	TH DAY OF F	EBRUARY, A.D.	2011.				
TOWNSHIP 40 NO THAT THE SURVE AND BELIEF, THA MONUMENTS FOUN POSITIONS SHOWN	RTH, RANGE 12 EAST Y IS TRUE AND COM T THE PLAT CORREC D AND ESTABLISHED N THEREON AND THA BE RETRACED, MADE	OF THE THI PLETE AS SH TLY REPRESE ARE OF PER T THE MONUM	RD PRINCIPAL IOWN TO THE INTS SAID SUI IMANENT OUAL IENTS ARE SU	ITY AND OCCUPY THE FFICIENT TO ENABLE				
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IRON PIPE OR F		"MAG" NAIL						
DMP) COMPUTED () RECORDED ( EXISTING B)	DIMENSION		NGS ARE BASE	D ON THE ILLINOIS DEDINATE SYSTEM,				
PROPOSED 1 MEASURED	EASEMENT DIMENSION			2 40 1'' = 40'				
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TO STA.

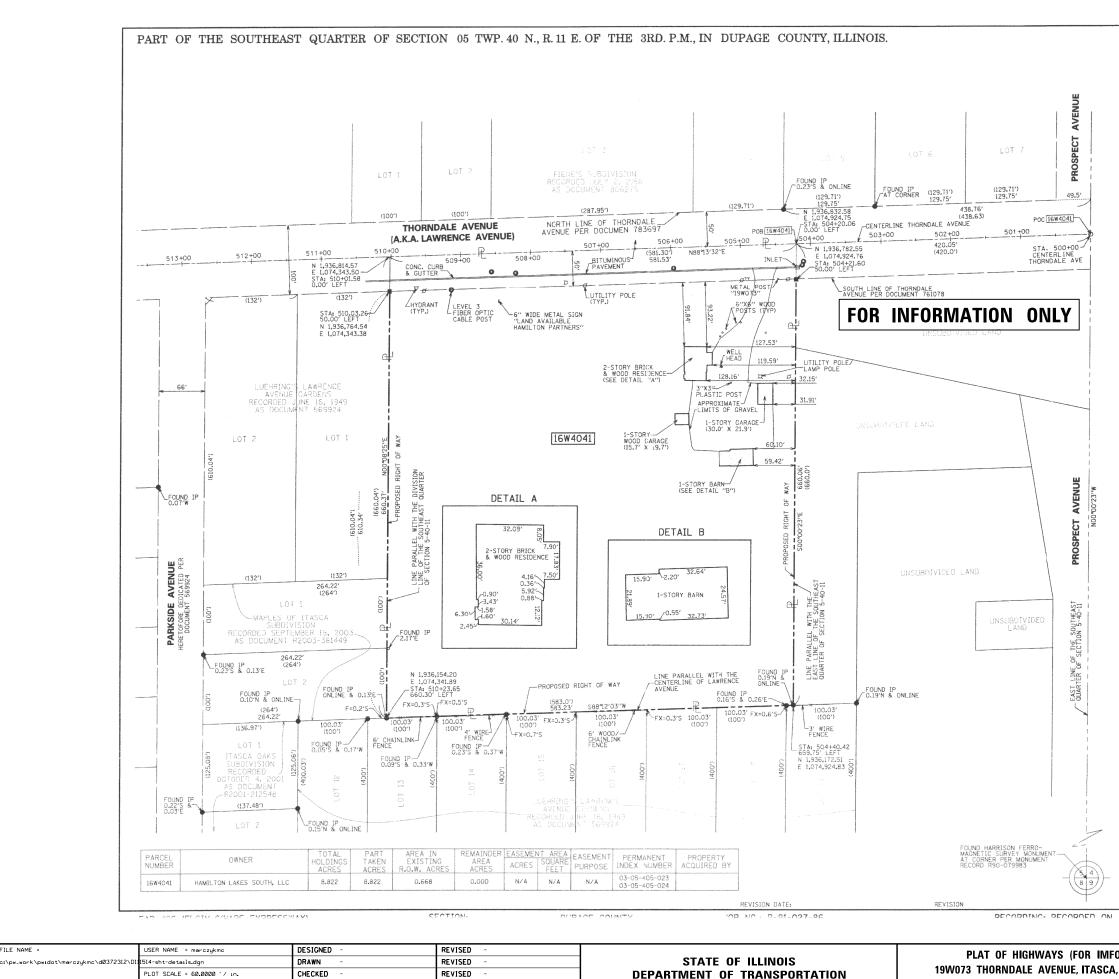ILLINOIS FED. AID PROJECT

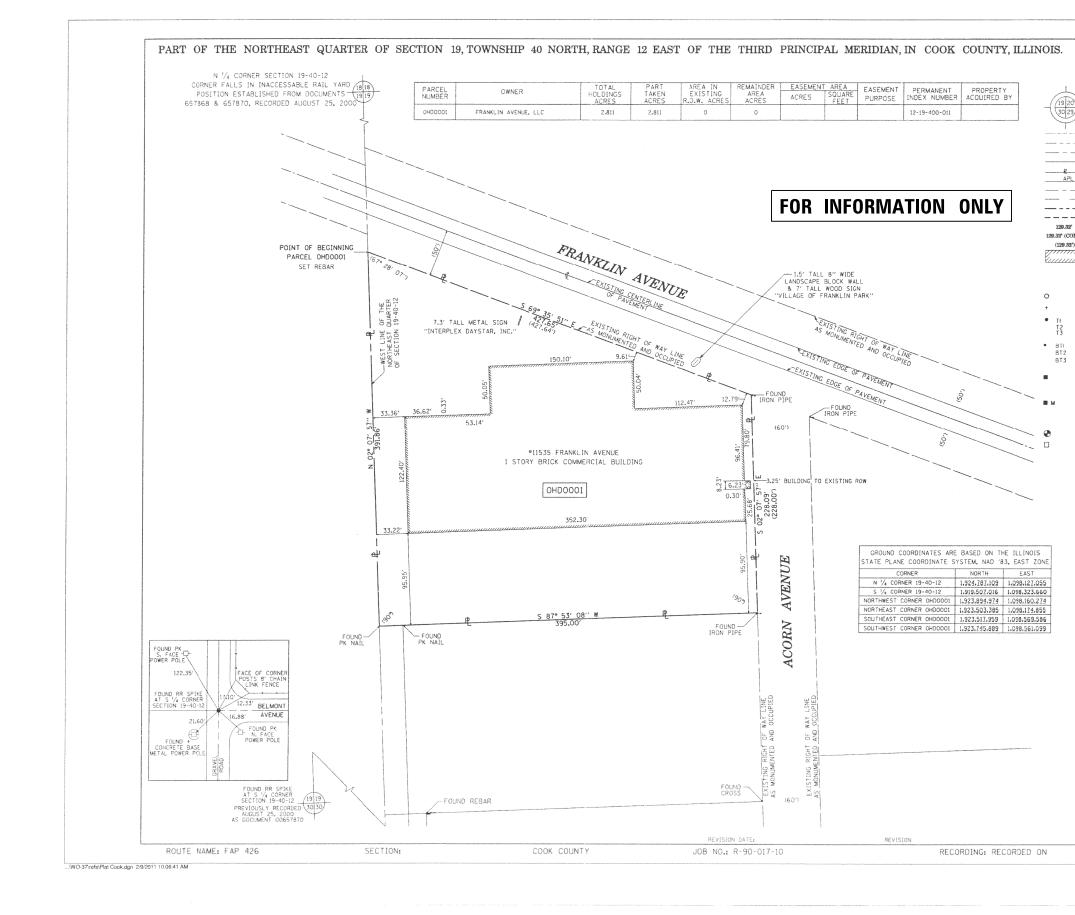	200'± (150 m)	COLLECTOR SPEED LIMIT> 40 MPH (60 km/h)	WITH TWO LIGHTS OF	BARRICADE FLASHING N EACH. 200 VORK AREA	, ·
TRAFFIC CON	TROL	AND	PROTECTION	N FOR	
NOTES: A. <u>for no lane restriction</u>	ON THE	SIDE ROA	D OR DRIVEWAYS		
1. SIDE ROAD WITH A SPEED SHOWN ON THE DRAWING AN					
O) ONE ROAD CONSTRUCTION AND FLAG MOUNTED ON 1 OF THE MAIN ROUTE.					
b) THE CLOSED PORTION OF BLOCKING WITH TYPE I, THE CROSS SECTION OF	TYPE II	OR TYPE	III BARRICADES, 1/3 (		
2. SIDE ROAD WITH A SPEED A AS SHOWN ON THE DRAWING					
<ul> <li>ONE ROAD CONSTRUCTION FLASHER MOUNTED ON IT OF THE MAIN ROUTE.</li> </ul>					
b) THE CLOSED PORTION OF BLOCKING WITH TYPE III OF THE CLOSED PORTION	BARRICA				
3. WHEN THE SIDE ROAD LIES SIGNING AND THE WORK ZO BE USED IN LIEU OF THE (	NE, A SIN	IGLE HEAD	ED ARROW (M6-1) SHALL		
NOIS			TRAFFIC CON	TROL AND	- P

FILE NAME =	USER NAME = marczykmc	DESIGNED - LHA	REVISED - J. OBERLE 10-18-95	·		TRAFFIC CONTROL AND PROTECTION FOR	F.A.P. SECTION	COUNTY TOTAL SHEET
c:\pw_work\pwidot\marczykmc\d0372312\D1	1514-sht-details.dgn	DRAWN -	REVISED - A. HOUSEH 03-06-96				345 2013-0730	M DUPAGE/COOK 13 13
	PLOT SCALE = 60.0000 ' / in.	CHECKED -	REVISED - A. HOUSEH 10-15-96	DEPARTMENT OF TRANSPORTATION		SIDE ROADS, INTERSECTIONS, AND DRIVEWAYS	TC-10	CONTRACT NO. 60X50
	PLOT DATE = 12/19/2013	DATE - 06-89	REVISED -T. RAMMACHER 01-06-00		SCALE: NONE	SHEET NO. 1 OF 1 SHEETS STA. TO STA.	FED. ROAD DIST. NO. 1 ILLIN	OIS FED. AID PROJECT

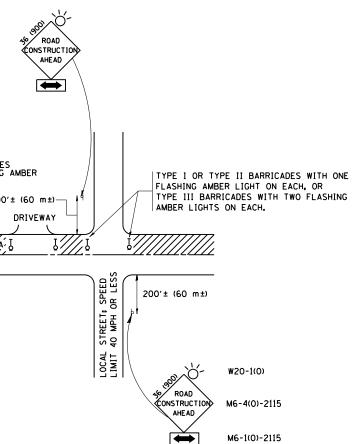

# SIDE ROADS, INTERSECTIONS, AND DRIVEWAYS

B. FOR A LANE CLOSURE ON A SIDE ROAD OR DRIVEWAY:
USE APPLICABLE PORTIONS OF THE TYPICAL APPLICATION OF TRAFFIC
CONTROL DEVICES (STD. 701501, STD. 701606 OR THE APPROPRIATE STANDARD).
THE SPACING OF SIGNS AND BARRICADES SHALL BE ADJUSTED FOR FIELD
CONDITIONS AS DIRECTED BY THE ENGINEER. THE DIRECTIONAL ARROW
SHALL BE COVERED OR REMOVED WHEN NO LONGER CONSISTENT WITH THE
SIDE ROAD LANE CLOSURE.

- C. ADVANCE WARNING SIGNS ARE TO BE OMITTED ON DRIVEWAY UNLESS OTHERWISE NOTED.
- D. THE TRAFFIC CONTROL AND PROTECTION FOR SIDE ROADS, INTERSECTIONS, AND DRIVEWAYS SHALL BE INCIDENTAL TO THE COST OF SPECIFIED TRAFFIC CONTROL STANDARDS OR ITEMS.

All dimensions are in millimeters (inches) unless otherwise shown.