INDEX OF SHEETS

SEE SHEET NO. 2

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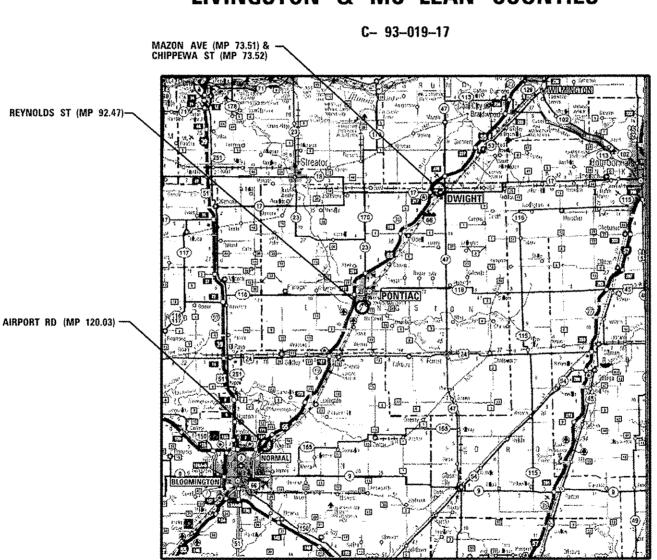
 \circ

03-03-2017 LETTING ITEM 072

STATE OF ILLINOIS DEPARTMENT OF TRANSPORTATION

PROPOSED HIGHWAY PLANS

VARIOUS ROUTES
SECTION D3 D5 HSRR FENCE 2017-001
PROJECT HSR-000 V CO94)
FENCING CONSTRUCTION
LIVINGSTON & MC LEAN COUNTIES





DISTRICT 3 NO. (815) 434–6131
PROJECT ENGINEER: DAVID S. ALEXANDER, P.E.
UNIT CHIEF: BRAD DUNCAN, P.E.

CONTRACT NO. 66F90 AECOM

AECOM
345 EAST ASH AVENUE, SUITE B
DECATUR, ILLINOIS 62526
PH. 217-875-4800

MAZON AVE
CHIPPEWA ST
REYNOLDS ST
AIRPORT RD
PROJECT TOTAL

NET LENGTH GROSS LENGTH
605.20 FT (0.115 MI) 605.20 FT (0.115 MI)
882.58 FT (0.167 MI) 882.58 FT (0.167 MI)
651.43 FT (0.123 MI) 651.43 FT (0.123 MI)
11,568.05 FT (2.191 MI) 11,568.05 FT (2.191 MI)
13,707.26 FT (2.596 MI) 13,707.26 FT (2.596 MI)

ARLIN C. WILLIAMS P.E.
IL. REG. P.E. NO. 062-058574

EXPIRES: 11-30-2017


GRAPHIC SCALE

DOT #290538S DOT #290541A DOT #290759U DOT #290803E MP 73.51 MP 73.52 MP 92.47 MP 120.03

D-93-019-17



FINAL

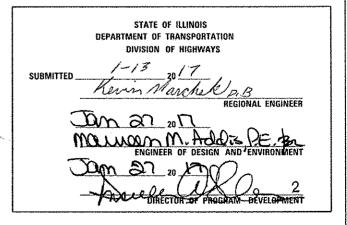

PRINTED BY THE AUTHORITY OF THE STATE OF ILLINOIS

ENGINEERING SCALES. REDUCED SIZED PLANS WILL NOT CONFORM TO STANDARD SCALES. IN MAKING MEASUREMENTS ON REDUCED PLANS, THE ABOVE SCALES MAY BE USED.

FULL SIZE PLANS HAVE BEEN PREPARED USING STANDARD

JOINT UTILITY LOCATION INFORMATION FOR EXCAVATION

J.U.L.I.E.

1-800-892-0123

NET LENGTH GROSS LENGTH
MAZON AVE 505 20 ET (0.115 MI) 605 20 ET (0.115 MI)

INDEX OF SHEETS

1	COVER SHEET
2	INDEX OF SHEETS, HIGHWAY STANDARDS, GENERAL NOTES AND COMMITMENTS
3-4	SUMMARY OF QUANTITIES
5-8	SCHEDULE OF QUANTITIES
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14	MAZON AVE FENCING PLANS
15	CHIPPEWA ST FENCING PLANS
16	REYNOLDS ST FENCING PLANS
17-37	AIRPORT RD FENCING PLANS
38	MAZON AVE UTILITY PLANS
39	CHIPPEWA ST UTILITY PLANS
40	REYNOLDS ST UTILITY PLANS
41-55	FENCING DETAILS

HIGHWAY STANDARDS

STANDARD SYMBOLS, ABBREVIATIONS AND PATTERNS 000001-06 001006 DECIMAL OF AN INCH AND OF A FOOT 664001-02 CHAIN LINK FENCE OFF-RD OPERATIONS, 2L, 2W, MORE THAN 15' (4.5 m) AWAY 701001-02 OFF-RD OPERATIONS, 2L, 2W. 15' (4.5 m) TO 24" (600 mm) FROM PAVEMENT EDGE 701006-05 701301-04 LANE CLOSURE, 2L, 2W, SHORT TIME OPERATIONS TRAFFIC CONTROL DEVICES 701901-06

COMMITMENTS

NONE. December 08, 2016

GENERAL NOTES

- 1. SEEDING SHALL NOT BE PERMITTED AT ANY TIME WHEN THE CROUND IS FROZEN, WET, OR IN AN UNTILLABLE CONDITION. LOCATIONS TO BE SEEDED WILL BE DETERMINED BY THE ENGINEER.
- 2. ONLY THOSE TREES DESIGNATED BY THE ENGINEER OR LISTED IN THE TREE REMOVAL SCHEDULE SHALL BE REMOVED. THE CONTRACTOR SHALL PROTECT ALL REMAINING TREES FROM DAMAGE DUE TO HIS OPERATIONS. TEMPORARY FENCE SHALL BE USED FOR THIS PURPOSE.
- BENCHMARKS FOR THE PROJECT ARE DESCRIBED IN THE PLANS AND ARE BASED ON NORTH AMERICAN VERTICAL DATUM OF 1988 (NAVD 88). ALL BEARINGS AND COORDINATES REFERENCED IN THE PLAN DRAWINGS AND ALL CONTROL COORDINATES ARE BASED ON THE ILLINOIS STATE PLANE COORDINATE SYSTEM, EAST ZONE, NAD 83.
- 4. ABANDONED UNDERGROUND UTILITIES THAT CONFLICT WITH CONSTRUCTION SHALL BE DISPOSED OF OUTSIDE THE LIMITS OF THE RIGHT OF WAY ACCORDING TO ARTICLE 202.03 OF THE STANDARD SPECIFICATIONS AND AS DIRECTED BY THE ENGINEER. THIS WORK WILL NOT BE PAID FOR SEPARATELY, BUT SHALL BE INCLUDED IN THE COST OF APPLICABLE FENCING.
- 5. THE CONTRACTOR SHALL KEEP EXISTING ADJACENT STREETS CLEAN OF DIRT, MUD. AND OTHER DEBRIS AND. WHEN NECESSARY, CLEAN SAID PAVEMENTS ON A DAILY BASIS OR WHEN DIRECTED BY THE ENGINEER. NO EXTRA COMPENSATION SHALL BE ALLOWED THE CONTRACTOR FOR THIS WORK.
- 6. THE SCALE SHOWN ON THE DRAWINGS APPLIES ONLY TO FULL SIZE PLANS AND NOT TO THE REDUCED SIZE PLANS. REDUCED SIZED PLANS CAN BE PRINTED TO SCALE FOR USE IN THE FIELD.
- 7. IT SHALL BE THE CONTRACTOR'S RESPONSIBILITY TO MAINTAIN DRAINAGE FLOWS AT ALL TIMES DURING THE PERFORMANCE OF THE WORK. METHODS USED BY THE CONTRACTOR SHALL BE SUBJECT TO APPROVAL OF THE ENGINEER. THE COST OF MAINTAINING DRAINAGE FLOWS SHALL BE INCLUDED IN
- 8. BEFORE STARTING ANY EXCAVATION, THE CONTRACTOR SHALL CALL "JULIE" AT 1-800-892-0123 OR 811 FOR FIELD LOCATIONS OF BURIED ELECTRIC, TELEPHONE AND GAS FACILITIES. THE CONTRACTOR SHALL CONTACT THE MUNICIPALITY FOR ANY MUNICIPAL OWNED UTILITIES. (MINIMUM 48 HOURS NOTOFICATION IS REQUIRED) THE CONTRACTOR SHALL CALL THE UNION PACIFIC "CALL BEFORE YOU DIG" OPERATION AT 1-800-336-9193 FOR FIELD LOCATIONS OF BURIED FIBER OPTIC CABLES IN UNION PACIFIC RIGHT-OF-WAY.

- EXISTING UTILITIES ARE SHOWN ON THE PLANS ACCORDING TO INFORMATION OBTAINED FROM THE LOCAL AGENCIES, OWNERS, AND FIELD SURVEYS. THE ACCURACY AND COMPLETENESS OF SAID INFORMATION IS NOT CUARANTEED. IT SHALL BE THE CONTRACTOR'S RESPONSIBILITY TO VERIFY THE EXISTENCE, NATURE AND EXACT LOCATIONS OF ALL UTILITY LINES AND APPURTENANCES WITHIN THE LIMITS OF THE IMPROVEMENTS.
- 10. MEMBERS OF JULIE KNOWN TO BE WITHIN THE LIMITS OF THE IMPROVEMENT ARE: 1. NICOR GAS (AGL Resources)

2. COMMONWEALTH EDISON

3. MEDIA COM LLC 4. AT&T

- 5. VILLAGE OF DWIGHT
- 6. SPRINT 7. LEVEL 3 COMMUNICATIONS
- 8. ZAYO CROUP
- 9. FRONTIER COMMUNICATIONS
- 10. ILLINOIS AMERICAN WATER (PONTIAC)
- 11. CENTRAL ILLINOIS REGIONAL BROADBAND NETWORKS
- 12. CITY OF PONTIAC
- 13, CORN BELT ENERGY
- 14. TOWN OF NORMAL
- 15. CITY OF BLOOMINGTON 16. COMCAST
- 17. AMEREN IP
- 18. CITY OF TOWANDA
- 11. NON-MEMBERS OF JULIE KNOWN TO BE WITHIN THE LIMITS OF THE IMPROVEMENT ARE: 1. UNION PACIFIC RAILROAD COMPANY (FIBER OPTIC)
- 12. THE CONTRACTOR SHALL COORDINATE WITH THE UPRR SIGNAL DEPARTMENT FOR ITEMS INSTALLED BY THE UPRR SIGNAL DEPARTMENT.
- NO WORK WHATSOEVER SHALL BE COMMENCED WITHOUT FIRST NOTIFYING JOHN JEROME. UPRR HSR PROGRAM MANAGER, OFFICE PH 816-399-1760. EMAIL: JRJEROMEĐUP.COM
- 14. ALL UTILITY FACILITIES THAT REQUIRE RELOCATION WITHIN STATE, CITY OR RAILROAD R.O.W. SHALL BE RELOCATED BY THE UTILITY COMPANY UNLESS OTHERWISE SHOWN ON PLANS.
- 15. THE CONTRACTOR SHALL VERIFY LOCATIONS AND ELEVATIONS OF EXISTING UTILITIES WHETHER KNOWN OR UNKNOWN PRIOR TO BEGINNING CONSTRUCTION.
- 16. ANY DAMAGE TO THE UNDERGROUND FACILITIES CAUSED BY THE CONTRACTOR SHALL BE REPAIRED TO THE SATISFACTION OF THE ENGINEER AT THE CONTRACTOR'S EXPENSE, INCLUDING TEMPORARY REPAIRS WHICH MAY BE REQUIRED TO KEEP THE FACILTY OPERATIONAL WHILE MATERIAL IS BEING OBTAINED TO MAKE PERMANENT REPAIRS.
- 17. ALL UTILITIES. SCHOOL DISTRICTS, LOCAL POLICE, AND FIRE DEPARTMENTS SHALL BE NOTIFIED BY THE CONTRACTOR PRIOR TO THE START OF CONSTRUCTION.
- 18. THE CONTRACTOR SHALL COMPLY WITH ALL FEDERAL, STATE, COUNTY, AND CITY/ VILLAGE LAWS AND ORDINANCES AND REGULATIONS OF THE DEPARTMENT OF INDUSTRIAL RELATIONS, OSHA, NPDES AND INDUSTRIAL ACCIDENT COMMISSION RELATED TO THE SAFETY AND CHARACTER OF THE WORK, EQUIPMENT AND LABOR PERSONNEL.
- 19. IN ADDITION TO FIELD SURVEYS AND AERIAL MAPS, PLAN DIMENSIONS AND DETAILS RELATIVE TO EXISTING FACILITIES ARE SUBJECT TO CONSTRUCTION VARIATIONS, IT SHALL BE THE CONTRACTOR'S RESPONSIBILITY TO VERIFY SUCH DIMENSIONS AND DETAILS IN THE FIELD, MINOR VARIATIONS SHALL NOT BE CAUSE FOR ADDITIONAL COMPENSATION. THE CONTRACTOR WILL BE PAID FOR THE QUANTITY FURNISHED AT THE UNIT PRICE BID FOR THE WORK.

- ANY UNDERGROUND STRUCTURES SUCH AS CESSPOOLS, CISTERNS, MINING SHAFTS. TUNNELS, SEPTIC TANKS, WELLS, AND PIPELINES NOT LOCATED PRIOR TO CONSTRUCTION SHALL BE BROUGHT TO THE ATTENTION OF THE ENGINEER FOR DETERMINATION OF APPROPRIATE ACTION SUCH AS REMOVAL OR TREATMENT IN A MANNER JUDGED SUITABLE TO THE ENGINEER.
- 21. THE CONTRACTOR SHALL COORDINATE LOCATION OF ALL PROPOSED UTILITIES WITH UPRR TO ASSURE ACCURACY OF UTILITY CONNECTIONS AND COMPLIANCE WITH LOCAL CODES.
- 22. ANY REFERENCE WITHIN THESE PLANS TO A STANDARD SHALL BE INTERPRETED TO MEAN THE EDITION INDICATED BY THE SUB-NUMBER LISTED ON THE LIST OF STANDARDS OR THE COPY INCLUDED IN THESE PLANS.
- ANY EXISTING CONDITIONS FOUND TO BE A VARIANCE WITH THESE DRAWINGS SHALL BE 23 IMMEDIATELY REPORTED TO THE ENGINEER.
- THE CONTRACTOR SHALL PERFORM ALL CONSTRUCTION IN SUCH MANNER AS TO PROTECT ADJACENT EXISTING BUILDINGS. AND OTHER SITE ELEMENTS WHICH ARE TO REMAIN
- THE CONTRACTOR IS RESPONSIBLE FOR THE PRESERVATION OF ALL SURVEY CONTROL MONUMENTS. IN THE EVENT MONUMENTS ARE DAMAGED OR DESTROYED BY THE CONTRACTOR. THE ENGINEER WILL REPLACE THE MONUMENT SOLELY AT THE CONTRACTOR'S EXPENSE.
- 26. THE CONTRACTOR SHALL PROVIDE AS-BUILT DRAWINGS FOR ALL IMPROVEMENTS.
- NO FIELD CHANGES WILL BE PERMITTED WITHOUT DIRECT WRITTEN AUTHORIZATION FROM THE ENGINEER OR HIS REPRESENTATIVE.
- THE CONTRACTOR SHALL COORDINATE WORK WHICH AFFECTS ADJACENT PROPERTY OWNERS. ANY QUESTIONS OR AGREEMENTS BETWEEN ADJACENT PROPERTY OWNERS AND CONTRACTOR SHALL BE MADE IN WRITING, A COPY OF SUCH AGREEMENT SHALL BE PROVIDED TO THE ENGINEER OR HIS REPRESENTATIVE.
- 29. DISPOSAL OF EXISTING FENCE AND PLACEMENT OF TEMPORARY FENCE SHALL NOT BE PAID FOR SEPARATELY, BUT SHALL BE INCLUDED IN THE COST OF FENCE REMOVAL. CONTRACTOR SHALL REUSE SUCH MATERIALS TO THE EXTENT POSSIBLE TO EXTEND REMAINING PRIVATELY OWNED FENCING INTO NEW RAILROAD R.O.W. FENCING ENSURING THAT ADEQUATE ENCLOSURE OF PRIVATELY OWNED AREAS IS ACCOMPLISHED. ANY NEW FENCING MATERIAL REQUIRED. INCLUDING CONCRETE FOOTING, IS TO BE PROVIDED BY THE CONTRACTOR.
- 30. FINAL CONFIGURATION AND ELEVATION OF FENCING IS SUBJECT TO CHANGE FROM THAT WHICH IS SHOWN OR INDICATED WITHIN THE 100% DESIGN PLAN SET, CONTRACTOR WILL BE REQUIRED TO ADJUST THE LOCATION, LENGTH AND ELEVATION OF BOTH NEW SIX (6) FOOT HIGH AND NEW THREE (3) FOOT HIGH FENCING AND GATES IN THE VICINITY OF ROADWAYS AND THE FLASHING LICHT SIGNALS TO ENSURE THAT THE FINAL FENCING AND GATES PROPERLY ADJOINS THE "AS-BUILT" ROADWAYS. ESCAPE PADS AND FLASHING LIGHT SIGNALS. IN THE CASE OF THREE (3) FOOT HIGH FENCING ENDING/BEGINNING ADJACENT TO A FLASHING LIGHT SIGNAL, SUCH FENCING MUST END/BEGIN AT A DISTANCE OF SEVEN (7) FOOT FROM THE CENTER OF THE FLASHING LIGHT SIGNAL MAST.
- 31. THE CONTRACTOR SHALL BE REQUIRED TO ADJUST FENCE POST LOCATIONS TO AVOID UNDERGROUND
- 32. TREE REMOVAL LIMITS HAS BEEN DEFINED AS 25' FROM FENCE LINE WITHIN UPRR R.O.W.

AUSE FOR ADDITIONAL ANTITY ACTUALLY	DEPARTMENT OF TRANSPORTATION DISTRICT THREE AS BUILT INFORMATION		STATE OF ILLINOIS DEPARTMENT OF TRANSPORTATION DISTRICT THREE
	SUPERVISING CONSTRUCTION FIELD ENGINEER	REVIEWED BY:	DISTRICT STUDIES & PLANS ENGINEER
		DATE:	12-20-16
START & END DATES OF CONSTRUCTION:	RESIDENT ENGINEER / TECHNICIAN	EXAMINED BY:	Muhox 97
INSPECTORS:			Nam Phillips RV
			DISTRICE MATERIALS ENGINEER

ATZ OT

USER NAME + duncambd	DESIGNED	-	MCD	REVISED	-
	DRAWN	-	SRS	REVISED	~
PLOT SCALE > 40.0000 1/ in.	CHECKED	-	JAC	REVISED	*
PLOT DATE = 12/19:2016	DATE	-	12-08-16	REVISED	•

STATE OF ILLINOIS DEPARTMENT OF TRANSPORTATION INDEX OF SHEETS, HIGHWAY STANDARDS, COMMITMENTS AND GENERAL NOTES

SHEET 1 OF 1 SHEETS STA.

SCALE: NTS

STATE OF ILLINOIS

SECTION COUNTY D3 D5 HSRR FENCE 2017-001 55 2 CONTRACT NO. 66F90 ILLINOIS FED. AID PROJECT

URBAN

					100% F	EBERAL	· .
		·			00	21	
CODE NO.	ITEM	TINU	TOTAL QUANTITY	MAZON AVENUE	CHIPPEWA STREET	REYNOLDS AVENUE	A I RPORT ROAD
				LI	VINGS.	TÓN	MELEAN
20100110	TREE REMOVAL (6 TO 15 UNITS DIAMETER)	UNIT	347	0	0	0	347
20100210	TREE REMOVAL (OVER 15 UNITS DIAMETER)	UNIT	374	0	0	0	374
66900200	NON-SPECIAL WASTE PISPOSAL	ca 40	425	115			310
67100100	MOBILIZATION	L SUM	l	0. 25	0. 25	0. 25	0.25
66900 450	SPECIAL WASTE PLANS AND REPORTS	L SUM	1	0.5			0,5
Z0013798	CONSTRUCTION LAYOUT	L SUM	1	0. 25	0.25	0, 25	0.25
66900530	SOIL DISPOSAL ANALYSIS	EACH	а	1		····	1
Z0022800	FENCE REMOVAL	FOOT	231	132	99	0	0
Z0048665	RAILROAD PROTECTIVE LIABILITY INSURANCE	L SUM	1	0. 25	0. 25	0. 25	0. 25
X2200015	CHAIN LINK FENCE, 3' (SPECIAL)	F00T	79	0	0	0	79
X6640560	CHAIN LINK FENCE. 6' (SPECIAL)	FOOT	11, 455	0	0	0	11.455
x2200005	DELINEATOR, SPECIAL	EACH	100	41	40	19	0
X27 00008	GATE, SPECIAL, (ESCAPE PAD SWING GATE)	EACH	10	4	4	2	0
X370000 9	GATE, SPECIAL, 3' (16'-0" DOUBLE SWING GATE)	EACH	9	3	3	3	0
X3300016	GATE, SPECIAL. 3' (5'-8 1/2" SINGLE SWING GATE)	EACH	1	0	1	0	0
X2200012	GATE, SPECIAL, 3' (9'-7 1/2" SINGLE SWING GATE)	EACH	1	1	0	0	0
X2200017	GATE, SPECIAL, 6' (16'-0" DOUBLE SWING GATE)	EACH	1	0	0	1	0

* SPECIALTY ITEMS

r					1 44	<u> </u>											
1		USER NAME = #USER#	DESIGNED	- MCD	REVISED -	<u> </u>							F.A.U.	SECTION	COUNTY	TOTAL S'	HEET
	VECOW	,	DRAWN	- SRS	REVISED -	STATE OF ILLINOIS		•	CHARALIS	ARV A	F QUANTITIES		RTE.	Section	- COUNT 1	SHEETS	NO.
- 1		PLOT SCALE > #SCALE#	CHECKED	- 340	DEVICED	•	•	•	o o i ti i i i i	A) 11	LUMITITIES			D3 D5 HSRR FENCE 2017-001		55	3]
- 1			CHECKED	- JAC	WEA12ED -	DEPARTMENT OF TRANSPORTATION									CONTRAC	T NO. 66F	£90
L		PLOT DATE . *DATE*	DATE	- 12-08-16	REVISED -		SCALE: NONE	SHEET 1	OF	2 \$	HEETS STA.	TO STA.		ILLINOIS FED. A	O PROJECT		
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URBAN

Ž					160% F	EPERAL	
					00		
CODE NO.	ITEM	UNIT	TOTAL QUANTITY	MAZON AVENUE	CHIPPEWA STREET	REYNOLDS AVENUE	A I RPORT ROAD
				LI	VINGSTO	DN/	MCLEAN
X22000 14	GATE, TUBULAR 16' SINGLE SWING (SPECIAL)	EACH	2	0	0	0	2
X32000 10	ORNAMENTAL FENCE, 3' (SPECIAL)	FOOT	675	191	268	216	0
X2200011	ORNAMENTAL FENCE, 6' (SPECIAL)	FOOT	1,231	334	539	358	0

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		PLOT SCALE = #SCALE#	CHECKED - JAC	REVISED -	
ı	ednet 3. shesamolquant den 128/2016 3.58.33 PM	PLOT DATE	DATE - 12-08-16	REVISED -	

STATE	0F	ILLINOIS
DEPARTMENT O)F 1	RANSPORTATION

SUMMARY OF QUANTITIE	S	RTE,	03 D5	HSRE	EC
SCALE: SHEET 2 OF 2 SHEETS STA.	TO STA,				

MAZON AV	ENUE IDOT C	ROSSING NO. 290	0538S (MP 73.51)								
POINT	STATION	NORTHERLY	EASTERLY	DESCRIPTION	FENCE REMOVAL	(9'-7½" SINGLE SWING GATE)	GATE, SPECIAL, 3' (16'-0" DOUBLE SWING GATE)	GATE, SPECIAL, (ESCAPE PAD SWING GATE)	ORNAMENTAL FENCE, 3' (SPECIAL)	ORNAMENTAL FENCE, 6' (SPECIAL)	DELINEATOR, SPECIAL
- 1	10:00:00	1 610 400 4006	050 507 7044	DECIN ODNAMENTAL FENCE 2 CDI	F001	EACH	EACH	EACH	FOOT	FOOT	EACH
1	10+00.00	1,612,408.4826		BEGIN ORNAMENTAL FENCE 3 SPL					2.22		
2		1,612,416.2673	958,599.6277	CORNER OF ORNAMENTAL FENCE 3 SPL					8.00		
3		1,612,422.4831	958,604.6639	CORNER OF ORNAMENTAL FENCE 3 SPL					8.00		
4		1,612,451.4731	958,632.2244	END ORNAMENTAL FENCE 3 SPL AND BEGIN GATE SPL 3 (9'-71/2" SGL SWG)					40.00		
5		1,612,455.3998	958,641.7375	END GATE SPL 3 (9'-71/2" SGL SWG) AND BEGIN ORNAMENTAL FENCE 3 SPL		1					
6	10+74.29	1,612,455.6111	958,649.7347	END ORNAMENTAL FENCE 3 SPL AND BEGIN GATE SPL ESC PAD SWG GATE					8.00		
7		1,612,460.4413		END GATE SPL ESC PAD SWG GATE				1			
		1,612,410.1660	958,599.0610	BEGIN FENCE REMOVAL							
		1,612,453.4320	958,640.4390	END FENCE REMOVAL	60						
				DELINEATOR SPL							10
8		1.612.553.2284	958.734.9465	BEGIN GATE SPL ESC PAD SWG GATE							
_	20.00.00	, ,	,					4			
9		1,612,558.0614	958,734.8722	END GATE SPL ESC PAD SWG GATE AND BEGIN ORNAMENTAL FENCE 3 SPL				1	0.00		
10	20+08.00	1,612,557.8502	958,726.8749	END ORNAMENTAL FENCE 3 SPL AND BEGIN GATE SPL 3 16 DBL SWG GATE					8.00		
11		1,612,568.4761	958,713.7656	END GATE SPL 3 16 DBL SWG GATE AND BEGIN ORNAMENTAL FENCE 3 SPL			1				
12		1,612,576.3666	958,715.0847	END ORNAMENTAL FENCE 3 SPL AND BEGIN ORNAMENTAL FENCE 6 SPL					8.00		
13		.,,	958,753.8703	CORNER OF ORNAMENTAL FENCE 6 SPL						56.29	
14		1,612,616.5606	958,786.0313	CORNER OF ORNAMENTAL FENCE 6 SPL						32.16	
15		1,612,721.4800	958,885.7520	CORNER OF ORNAMENTAL FENCE 6 SPL						144.75	
16	22+98.25	1,612,751.8840	958,896.2541	END ORNAMENTAL FENCE 6 SPL						32.17	
				DELINEATOR SPL							11
17		1,612,373.8105	958,615.9414	BEGIN ORNAMENTAL FENCE 3 SPL							
18		.,	958,623.9104	CORNER OF ORNAMENTAL FENCE 3 SPL					8.00		
19				END ORNAMENTAL FENCE 3 SPL AND BEGIN GATE SPL 3 16 DBL SWG GATE					66.17		
20		.,,	,	END GATE SPL 3 16 DBL SWG GATE AND BEGIN ORNAMENTAL FENCE 3 SPL			1				
21		1,612,443.5160	,	END ORNAMENTAL FENCE 3 SPL AND BEGIN GATE SPL ESC PAD SWG GATE					8.00		
22		1,612,447.7386	958,685.1029	END GATE SPL ESC PAD SWG GATE				1			
22A		1,612,456.3436	958,688.9380	BEGIN ORNAMENTAL FENCE 3 SPL							
22B		1,612,459.9677	958,692.3826	END ORNAMENTAL FENCE 3 SPL					5.00		
		1,612,373.8105	958,615.9414	BEGIN FENCE REMOVAL							
		1,612,414.4500	958,667.1860	END FENCE REMOVAL	72						
				DELINEATOR SPL							10
		4 040 554 5407	050 700 0000	DECIN CATE OR EGO DAD CIMO CATE							
23	40+00.00	1,612,554.5137	958,783.6063	BEGIN GATE SPL ESC PAD SWG GATE				4			
24		.,,		END GATE SPL ESC PAD SWG GATE AND BEGIN ORNAMENTAL FENCE 3 SPL				1	0.00		
25		1,612,559.5551		END ORNAMENTAL FENCE 3 SPL AND BEGIN GATE SPL 3 16 DBL SWG GATE			1		8.00		
26		1,612,563.7415	,	END GATE SPL 3 16 DBL SWG GATE AND BEGIN ORNAMENTAL FENCE 3 SPL			1		40.00		
27		1,612,569.6180	958,822.6519	END ORNAMENTAL FENCE 3 SPL AND BEGIN ORNAMENTAL FENCE 6 SPL					16.00	20.40	
28	41+09.28	1,612,619.1960	958,869.7850	END ORNAMENTAL FENCE 6 SPL						68.40	10
				DELINEATOR SPL							10
	TOTALS				132	4	3	4	191.17	333.77	41
	TOTALS				132	I		4	191.17	333.11	41

		US
	AECUM	PL
		PL
Í	District 3 sht-schodules dan 12/8/2016 10:30:37 AM	

_	USER NAME = \$USER\$	DESIGNED -	MCD	REVISED -
		DRAWN -	SRS	REVISED -
ı	PLOT SCALE = \$SCALE\$	CHECKED -	JAC	REVISED -
•	PLOT DATE = \$DATE\$	DATE -	12-08-16	REVISED -

	F. R.									SECTION		COUNTY	TOTAL SHEETS	SHEET NO.
	SCHEDULE OF QUANTITIES								D3 D5 HSRR FENCE 2017	7-001		55	5	
												CONTRACT	NO. 6	6F90
ALE:	NTS	SHEET	1	OF	4	SHEETS	STA.	TO STA.		ILLINOIS F	ED. AIC	PROJECT		

POINT	STATION	NORTHERLY	EASTERLY	DESCRIPTION	FENCE REMOVAL	GATE, SPECIAL, 3' (5'-8½" SINGLE SWING GATE)	GATE, SPECIAL, 3' (16'-0" DOUBLE SWING GATE)	GATE, SPECIAL, (ESCAPE PAD SWING GATE)	ORNAMENTAL FENCE, 3' (SPECIAL)	ORNAMENTAL FENCE, 6' (SPECIAL)	DELINEATOR, SPECIAL
					FOOT	EACH	EACH	EACH	FOOT	FOOT	EACH
1	50+00.00	1,611,566.8463	957,763.1815	BEGIN ORNAMENTAL FENCE 6 SPL							
2	51+68.88	1,611,689.2386	957,879.5384	CORNER OF ORNAMENTAL FENCE 6 SPL						168.88	
3	52+01.04	1,611,697.8621	957,910.5277	END ORNAMENTAL FENCE 6 SPL AND BEGIN GATE SPL 3 16 DBL SWG GATE						32.16	
4	52+17.92	1,611,707.9908	957,924.0249	END GATE SPL 3 16 DBL SWG GATE AND BEGIN ORNAMENTAL FENCE 3 SPL			1				
5	52+97.92	1,611,765.9708	957,979.1458	CORNER OF ORNAMENTAL FENCE 3 SPL					80.00		
6	53+05.92	1,611,765.3328	957,987.1203	END ORNAMENTAL FENCE 3 SPL AND BEGIN GATE SPL ESC PAD SWG GATE					8.00		
7		1,611,768.8723	957,990.4120	END GATE SPL ESC PAD SWG GATE				1			
				DELINEATOR SPL							10
8		1.611.820.2190	958.039.2296	BEGIN GATE SPL ESC PAD SWG GATE							<u> </u>
9	60+00.00	1.611.823.6851	958.042.5986	END GATE SPLESC PAD SWG GATE AND BEGIN ORNAMENTAL FENCE 3 SPL		 		1			
10	60+32.00	1,611,847.0644	,	END ORNAMENTAL FENCE 3 SPL AND BEGIN GATE SPL 3 (5'-81/2" SGL SWG)				'	32.00		
11	60+38.42	1,611,851.7524		END GATE SPL 3 (5'-8½" SGL SWG) AND BEGIN ORNAMENTAL FENCE 3 SPL		1			32.00		
12	60+70.42	1,611,875.1318		END ORNAMENTAL FENCE 3 SPL AND BEGIN ORNAMENTAL FENCE 6 SPL		'			32.00		
13	61+90.68	1.611.962.2941	958.173.5433	CORNER OF ORNAMENTAL FENCE 6 SPL					32.00	120.26	
14	61+94.93	1.611.965.2961		END ORNAMENTAL FENCE 6 SPL						4.25	
14	01+94.93	1,011,905.2901	936,170.3306	DELINEATOR SPL						4.25	10
15		1,611,535.7356		BEGIN ORNAMENTAL FENCE 6 SPL							
16	70+56.29	1,611,576.7838	957,900.0124	CORNER OF ORNAMENTAL FENCE 6 SPL						56.29	
17	70+88.46	1,611,605.8316		CORNER OF ORNAMENTAL FENCE 6 SPL						32.17	
18	72+13.09	1,611,696.1619		END ORNAMENTAL FENCE 6 SPL AND BEGIN ORNAMENTAL FENCE 3 SPL						124.63	
19	72+29.09	1,611,708.6343	957,989.6838	CORNER OF ORNAMENTAL FENCE 3 SPL					16.00		
20	72+37.09	1,611,713.9411	957,995.6702	END ORNAMENTAL FENCE 3 SPL AND BEGIN GATE SPL 3 16 DBL SWG GATE					8.00		
21	72+53.97	1,611,726.6931	958,006.7224	END GATE SPL 3 16 DBL SWG GATE AND BEGIN ORNAMENTAL FENCE 3 SPL			1				
22	72+69.97	1,611,739.3810	,	CORNER OF ORNAMENTAL FENCE 3 SPL					16.00		
23	72+73.97	1,611,741.8816	958,013.3480	END ORNAMENTAL FENCE 3 SPL AND BEGIN GATE SPL ESC PAD SWG GATE					4.00		
24		1,611,745.3478	958,016.7168	END GATE SPL ESC PAD SWG GATE				1			
				DELINEATOR SPL							10
25		1,611,798,2764	958,067.0373	BEGIN GATE SPL ESC PAD SWG GATE							
26	80+00.00	1,611,801.8152		END GATE SPLESC PAD SWG GATE AND BEGIN ORNAMENTAL FENCE 3 SPL				1			
27	80+08.00	1.611.809.3334	958.073.0642	END ORNAMENTAL FENCE 3 SPL AND BEGIN GATE SPL 3 16 DBL SWG GATE				'	8.00		
28	80+24.88	1,611,818.0548	958,087.5108	END GATE SPL 3 16 DBL SWG GATE AND BEGIN ORNAMENTAL FENCE 3 SPL			1		0.00		<u> </u>
29	80+32.88	1,611,822.1894	958,094,3595	CORNER OF ORNAMENTAL FENCE 3 SPL			'		8.00		
30	80+88.43	1,611,862.4500	958,132.6347	END ORNAMENTAL FENCE 3 SPL					55.55		
	55:50.40	1,611,784.5650	,	BEGIN FENCE REMOVAL					55.00		
		1.611.855.9300	958.138.2820	END FENCE REMOVAL	99	 					
		.,,		DELINEATOR SPL							10
	TOTALS				99	1	3	4	267.55	538.64	40



USER NAME = \$USER\$	DESIGNED - MCD	REVISED -
	DRAWN - SRS	REVISED -
PLOT SCALE = \$SCALE\$	CHECKED - JAC	REVISED -
PLOT DATE = \$DATE\$	DATE - 12-08-16	REVISED -

STATE OF	ILLINOIS
DEPARTMENT OF	TRANSPORTATION

	F.A.U. RTE.	SECTION	COUNTY	TOTAL SHEETS	SHEET NO.
SCHEDULE OF QUANTITIES		D3 D5 HSRR FENCE 2017-001		55	6
			CONTRACT	NO. 6	6F90
SCALE: NTS SHEET 2 OF 4 SHEETS STA. TO STA.		ILLINOIS FED. AI	D PROJECT		

POINT	STATION	NORTHERLY	EASTERLY	DESCRIPTION	GATE, SPECIAL, 3' (16'-0" DOUBLE SWING GATE)	GATE, SPECIAL, 6' (16'-0" DOUBLE SWING GATE)	GATE, SPECIAL, (ESCAPE PAD SWING GATE)	ORNAMENTAL FENCE, 3' (SPECIAL)	ORNAMENTAL FENCE, 6' (SPECIAL)	DELINEATOR SPECIAL
					EACH	EACH	EACH	FOOT	FOOT	EACH
1	100+00.00	1,532,148.0013	899,119.2838	BEGIN ORNAMENTAL FENCE 6 SPL						
2	100+08.04	1,532,153.8795	899,124.7715	CORNER OF ORNAMENTAL FENCE 6 SPL					8.04	
3	101+00.64	1,532,237.3901	899,164.7878	END ORNAMENTAL FENCE 6 SPL AND BEGIN ORNAMENTAL FENCE 3 SPL					92.60	
4	101+08.64	1,532,244.6060	899,168.2419	END ORNAMENTAL FENCE 3 SPL AND BEGIN GATE SPL 3 16 DBL SWG GATE				8.00		
5	101+25.52	1,532,259.8270	899,175.5279	END GATE SPL 3 16 DBL SWG GATE AND BEGIN ORNAMENTAL FENCE 3 SPL	1					
6	101+49.52	1,532,281.4747	899,185.8902	CORNER OF ORNAMENTAL FENCE 3 SPL				24.00		
7	101+65.52	1,532,292.2505	899,197.7174	CORNER OF ORNAMENTAL FENCE 3 SPL				16.00		
8	101+97.52	1,532,289.0059	899,229.5524	END ORNAMENTAL FENCE 3 SPL AND BEGIN GATE SPL ESC PAD SWG GATE				32.00		
9		1,532,293.8197	899,229.9895	END GATE SPL ESC PAD SWG GATE			1			
		, ,	,	DELINEATOR SPL						9
10	110+00.00	1,532,375.1390		BEGIN ORNAMENTAL FENCE 3 SPL						
11	110+16.00	1,532,388.2902		CORNER OF ORNAMENTAL FENCE 3 SPL				16.00		
12	110+40.00	1,532,410.3833	,	END ORNAMENTAL FENCE 3 SPL AND BEGIN GATE SPL 3 16 DBL SWG GATE				24.00		
13	110+56.88	1,532,427.0509	,	END GATE SPL 3 16 DBL SWG GATE AND BEGIN ORNAMENTAL FENCE 3 SPL	1					
14	110+88.88	1,532,458.6003	899,268.9359	END ORNAMENTAL FENCE 3 SPL AND BEGIN ORNAMENTAL FENCE 6 SPL				32.00		
15	111+56.75	1,532,519.8123	899,298.2672	END ORNAMENTAL FENCE 6 SPL					67.87	
16	120+00.00	1,532,122.4604	900 206 2956	BEGIN ORNAMENTAL FENCE 6 SPL						
17	120+00.00	1,532,122.4604	899,241.0359	CORNER OF ORNAMENTAL FENCE 6 SPL					80.42	
18	120+80.42	1,532,194.9812	,	CORNER OF ORNAMENTAL FENCE 6 SPL					8.04	
19	120+86.46	1,532,201.7199		END ORNAMENTAL FENCE 6 SPL AND BEGIN GATE SPL 6 16 DBL SWG GATE					8.04	
20	120+96.50	1,532,206.9720	, , , , , , , , , , , , , , , , , , , ,	END GATE SPL 6 16 DBL SWG GATE AND BEGIN ORNAMENTAL FENCE 6 SPL		1			0.04	
21	121+13.40	1,532,224.3037	,	CORNER OF ORNAMENTAL FENCE 6 SPL		I			8.04	
22		1,532,231.5558							8.04	
23	121+29.54 121+69.75	1,532,232.1826	,	CORNER OF ORNAMENTAL FENCE 6 SPL END ORNAMENTAL FENCE 6 SPL AND BEGIN ORNAMENTAL FENCE 3 SPL					40.21	
		, ,	,					10.00	40.21	
24 25	121+85.75	1,532,284.3857 1,532,285,1968	,	CORNER OF ORNAMENTAL FENCE 3 SPL				16.00		
	121+93.75	, ,		END ORNAMENTAL FENCE 3 SPL AND BEGIN GATE SPL ESC PAD SWG GATE			4	8.00		
26		1,532,289.9998	899,267.4681	END GATE SPL ESC PAD SWG GATE			1			40
				DELINEATOR SPL						10
27	130+00.00	1.532.371.8968	899.303.0971	BEGIN ORNAMENTAL FENCE 3 SPL						
28	130+08.00	1,532,379.1123		CORNER OF ORNAMENTAL FENCE 3 SPL				8.00	 	
29	130+24.00	1,532,389,4609		END ORNAMENTAL FENCE 3 SPL AND BEGIN GATE SPL 3 16 DBL SWG GATE				16.00		
30	130+40.88	1,532,400.3754	,	END GATE SPL 3 16 DBL SWG GATE AND BEGIN ORNAMENTAL FENCE 3 SPL	1			10100		
31	130+56.88	1,532,410.7240	,	END ORNAMENTAL FENCE 3 SPL AND BEGIN ORNAMENTAL FENCE 6 SPL				16.00		
32	130+93.75	1,532,443.9744		END ORNAMENTAL FENCE 6 SPL				10.00	36.87	
	TOTALS				3	1	2	216.00	358.17	19



- 1	USER NAME = \$USER\$	DESIGNED - MCD	REVISED -
		DRAWN - SRS	REVISED -
	PLOT SCALE = \$SCALE\$	CHECKED - JAC	REVISED -
•	PLOT DATE = \$DATE\$	DATE - 12-08-16	REVISED -

		61	ישבח		OE OII	ANTITIES		F.A.U. RTE.	SECTION	COUNTY	TOTAL SHEETS	SHEET NO.
SCHEDULE OF QUANTITIES							D3 D5 HSRR FENCE 2017-001		55	7		
										CONTRACT	NO. 6	6F90
ALE: NTS	SHEET	3	OF	4	SHEETS	STA.	TO STA.		ILLINOIS FED. A	ID PROJECT		
							-					


AIRPORT R	OAD IDOT NO	D. 290803E (MP 12	0.03)	T.		I	
POINT	STATION	NORTHERLY	EASTERLY	DESCRIPTION	CHAIN LINK FENCE 3' (SPECIAL)	CHAIN LINK FENCE 6' (SPECIAL)	GATE, TUBULAR 16' SINGLE SWING (SPECIAL)
					FOOT	FOOT	EACH
1	200+00.00	1,409,399.1427	814,674.0954	BEGIN CHAIN LINK FENCE 6 SPL			
2	213+41.86	1,410,261.0377	815,702.5556	CORNER OF CHAIN LINK FENCE 6 SPL		1341.86	
3	213+51.86	1,410,260.2596	815,712.5253	CORNER OF CHAIN LINK FENCE 6 SPL		10.00	
4	230+03.58	1,411,321.1797	816,978.4731	CORNER OF CHAIN LINK FENCE 6 SPL		1651.72	
5	232+47.80	1,411,474.9575	817, 168. 1967	CORNER OF CHAIN LINK FENCE 6 SPL		244.22	
6	232+87.94	1,411,473.3452	817,208.3085	CORNER OF CHAIN LINK FENCE 6 SPL		40.14	
7	237+30.98	1,411,757.9159	817,547.8738	END CHAIN LINK FENCE 6 SPL		443.04	
8	300+00.00	1,412,002.2733	817,808,3168	BEGIN CHAIN LINK FENCE 6 SPL			
9	306+50.00	1.412.419.7765	818,306.5046	CORNER OF CHAIN LINK FENCE 6 SPL		650.00	
10	306+80.00	1,412,448,9880	818.313.3376	CORNER OF CHAIN LINK FENCE 6 SPL		30.00	
11	325+20.84	1,413,631,4011	819,724.2142	CORNER OF CHAIN LINK FENCE 6 SPL		1840.84	
12	325+42.81	1,413,614,5632	819.738.3255	CORNER OF CHAIN LINK FENCE 6 SPL		21.97	
13	325+76.98	1,413,636.5153	819,764.5122	END CHAIN LINK FENCE 6 SPL AND BEGIN CHAIN LINK FENCE 3 SPL		34.17	
14	325+96.98	1.413.635.8589	819.784.5014	END CHAIN LINK FENCE 3 SPL	20.00		
15	325+97.81	1,413,635.8316	819,785.3343	BEGIN GATE TUB 16 S SWING SPL			
16	326+14.23	1,413,638.4603	819,801.5425	END GATE TUB 16 S SWING SPL			1
17		1,413,626.1952	819,773.8390	REMOVABLE BOLLARD			
18		1.413.700.9005	819.860.5242	REMOVABLE BOLLARD			
19	400+00.00	1,413,675,3979	819.844.8003	BEGIN GATE TUB 16 S SWING SPL			
20	400+16.42	1,413,691,2641	819,849,0289	END GATE TUB 16 S SWING SPL			1
21	400+17.25	1,413,692.0693	819,849,2435	BEGIN CHAIN LINK FENCE 3 SPL			'
22	400+76.13	1,413,748.9638	819,864,4069	END CHAIN LINK FENCE 3 SPL AND BEGIN CHAIN LINK FENCE 6 SPL	58.88		
23	425+80.03	1.415.357.5275	821,783,2648	CORNER OF CHAIN LINK FENCE 6 SPL	00.00	2503.90	
24	426+00.03	1,415,360.9904	821,802.9628	CORNER OF CHAIN LINK FENCE 6 SPL		20.00	
25	452+02.84	1,417,032,8767	823,797.8100	CORNER OF CHAIN LINK FENCE 6 SPL		2602.81	
26	452+22.84	1,417,040.5333	823,816.2864	END CHAIN LINK FENCE 6 SPL		20.00	
	TOTALS				78.88	11454.67	2
	IUIALS				/8.88	11454.07	2


AIRPORT ROAD IDOT NO. 290803E (MP 120.03)							
SHEET	TREE REMOVAL (6 TO 15 UNITS	TREE REMOVAL (OVER 15 UNITS					
	DIAMETER) UNIT	DIAMETER) UNIT					
17	10	65					
18		52					
20	37	64					
21	36	30					
22	29	31					
25	30	24					
26	18	108					
27	48						
29	38						
30	9						
31	24						
32	32						
34	6						
35	30						
TOTALS	347	374					

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_	USER NAME = \$USER\$	DESIGNED - MCD	REVISED -
		DRAWN - SRS	REVISED -
	PLOT SCALE = \$SCALE\$	CHECKED - JAC	REVISED -
_	PLOT DATE = \$DATE\$	DATE - 12-08-16	REVISED -

SCHEDULE OF QUANTITIES										F.A.U. RTE.		SE	CTION		COUNTY	TOTAL SHEETS	SHEET NO.
SCHEDULE OF QUANTITIES									D3 D5	HSRR	FENCE 2	017-001		55	8		
															CONTRACT	NO. (6F90
SCALE: NTS	SHEET	4	OF	4	SHEETS	STA.	TO	STA.					ILLINOIS	FED. A	D PROJECT		




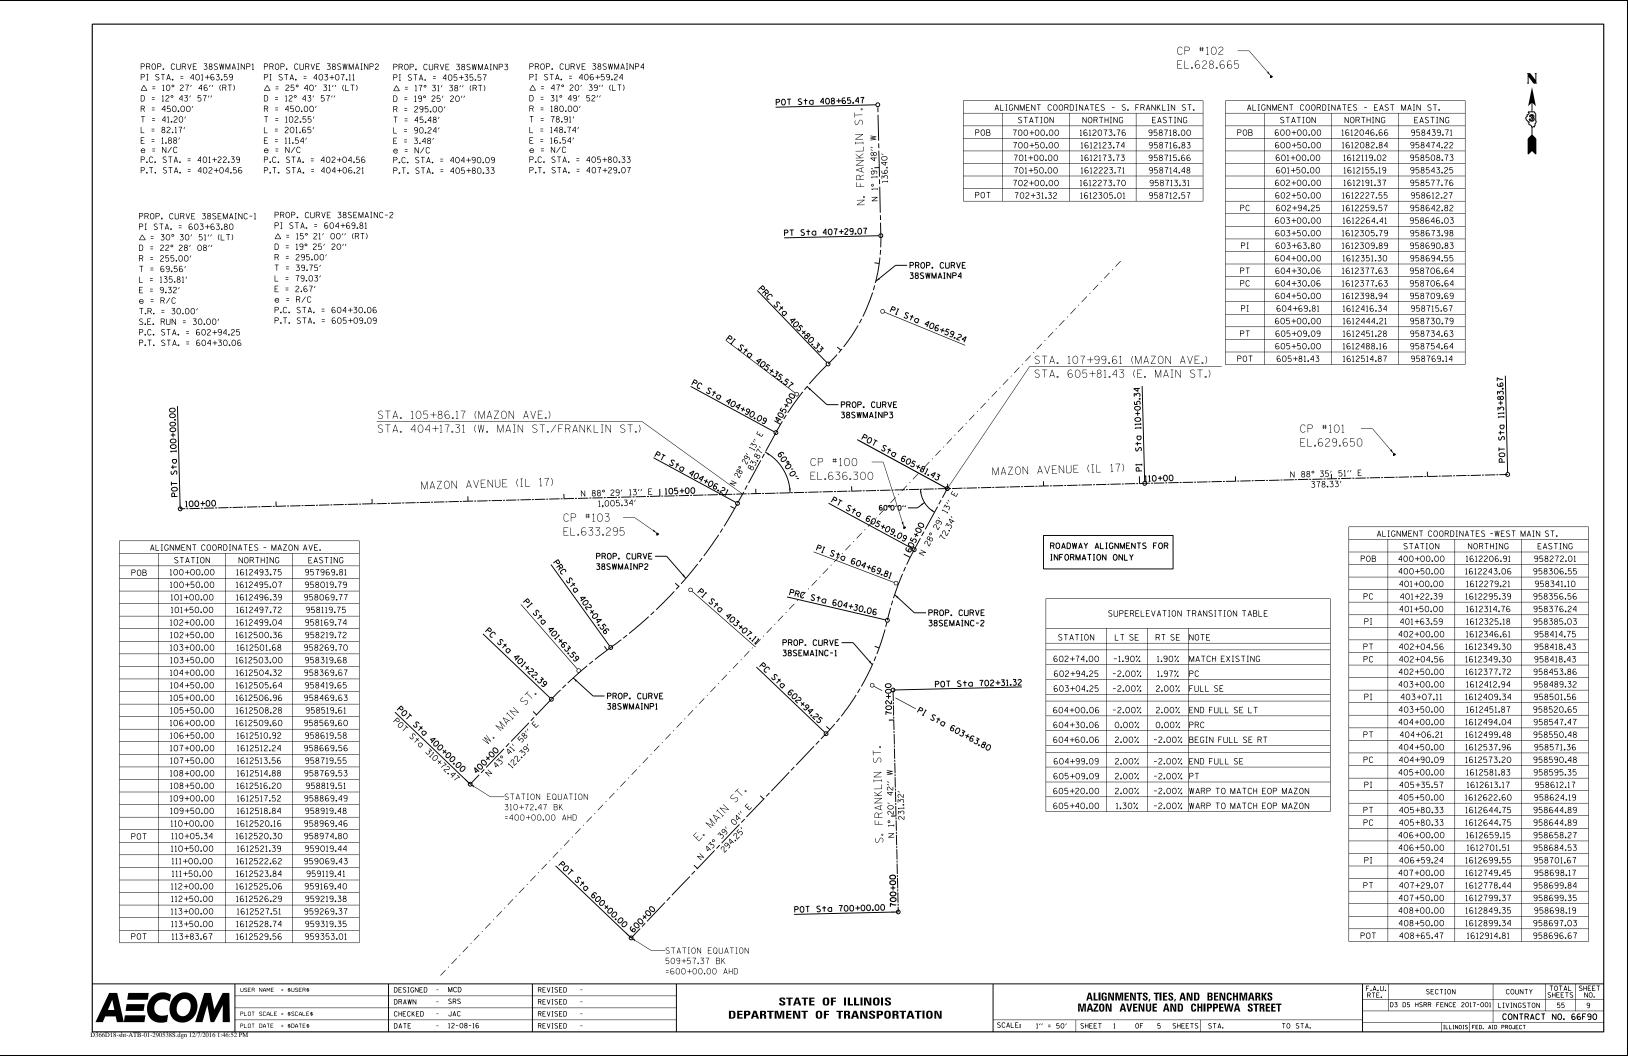

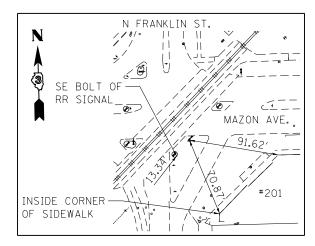CONTROL POINT #100

CUT CROSS IN ISLAND
PAVEMENT


N 1,612,474.291 E 958,724.394 ELEV. 636.300

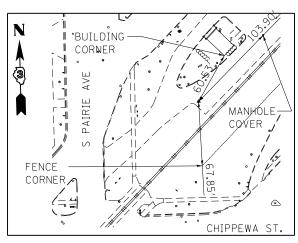

CONTROL POINT #104

CUT CROSS IN PAVEMENT


N 1,611,836.734 E 958,050.591 ELEV. 639.155

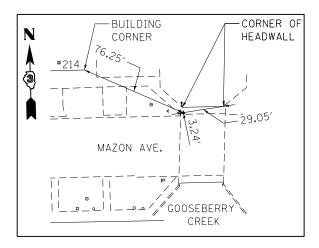

CONTROL POINT #101

CUT CROSS IN SIDEWALK


N 1,612,550.419 E 959,234.750 ELEV. 629.650

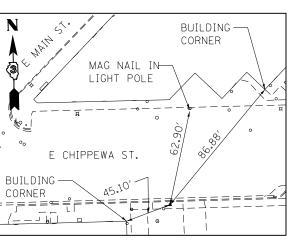

CONTROL POINT #105

CUT CROSS IN SIDEWALK


N 1,611,673.383 E 958,303.424 ELEV. 637.195

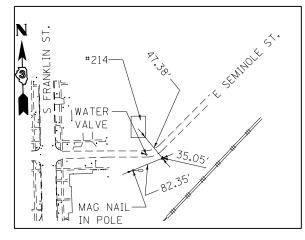

CONTROL POINT #102


IRON ROD WITH CAP

N 1,612,944.121 E 959,106.596 ELEV. 628.665

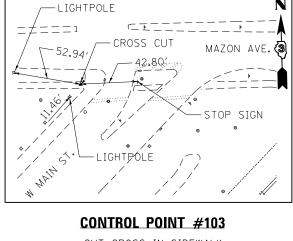

CUT CROSS IN SIDEWALK

N 1,612,467.488 E 958,467.059 ELEV. 633.295

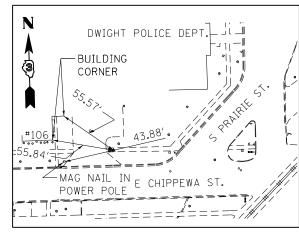


CONTROL POINT #106

CUT CROSS IN SIDEWALK

N 1,611,725.354 E 957,769.586 ELEV. 636.190

SCALE: NONE

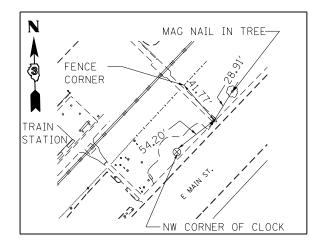

CONTROL POINT #108

CUT CROSS IN NORTH WALKWAY


N 1,612,050.298 E 958,377.629 ELEV. 636.835

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USER NAME = \$USER\$	DESIGNED - MCD	REVISED -
	DRAWN - SRS	REVISED -
PLOT SCALE = \$SCALE\$	CHECKED - JAC	REVISED -
PLOT DATE = \$DATE\$	DATE - 12-08-16	REVISED -
5 PM		

STATE OF ILLINOIS
DEPARTMENT OF TRANSPORTATION

	ALIGNMENTS, TIES, AND BENCHMARKS					F.A.U. RTE.		SECTIO	N	COUNTY	TOTAL SHEETS	SHEET NO.
MAZON AVENUE AND CHIPPEWA STREET						D3 D5	HSRR FENC	E 2017-001	LIVINGSTON	55	10	
WAZUN AVENUE AND CHIFFEVVA STREET										CONTRACT	NO. 6	6F90
	SHEET 2	OF	5 SHEETS	STA.	TO STA.			ILL	INOIS FED. A	ID PROJECT		

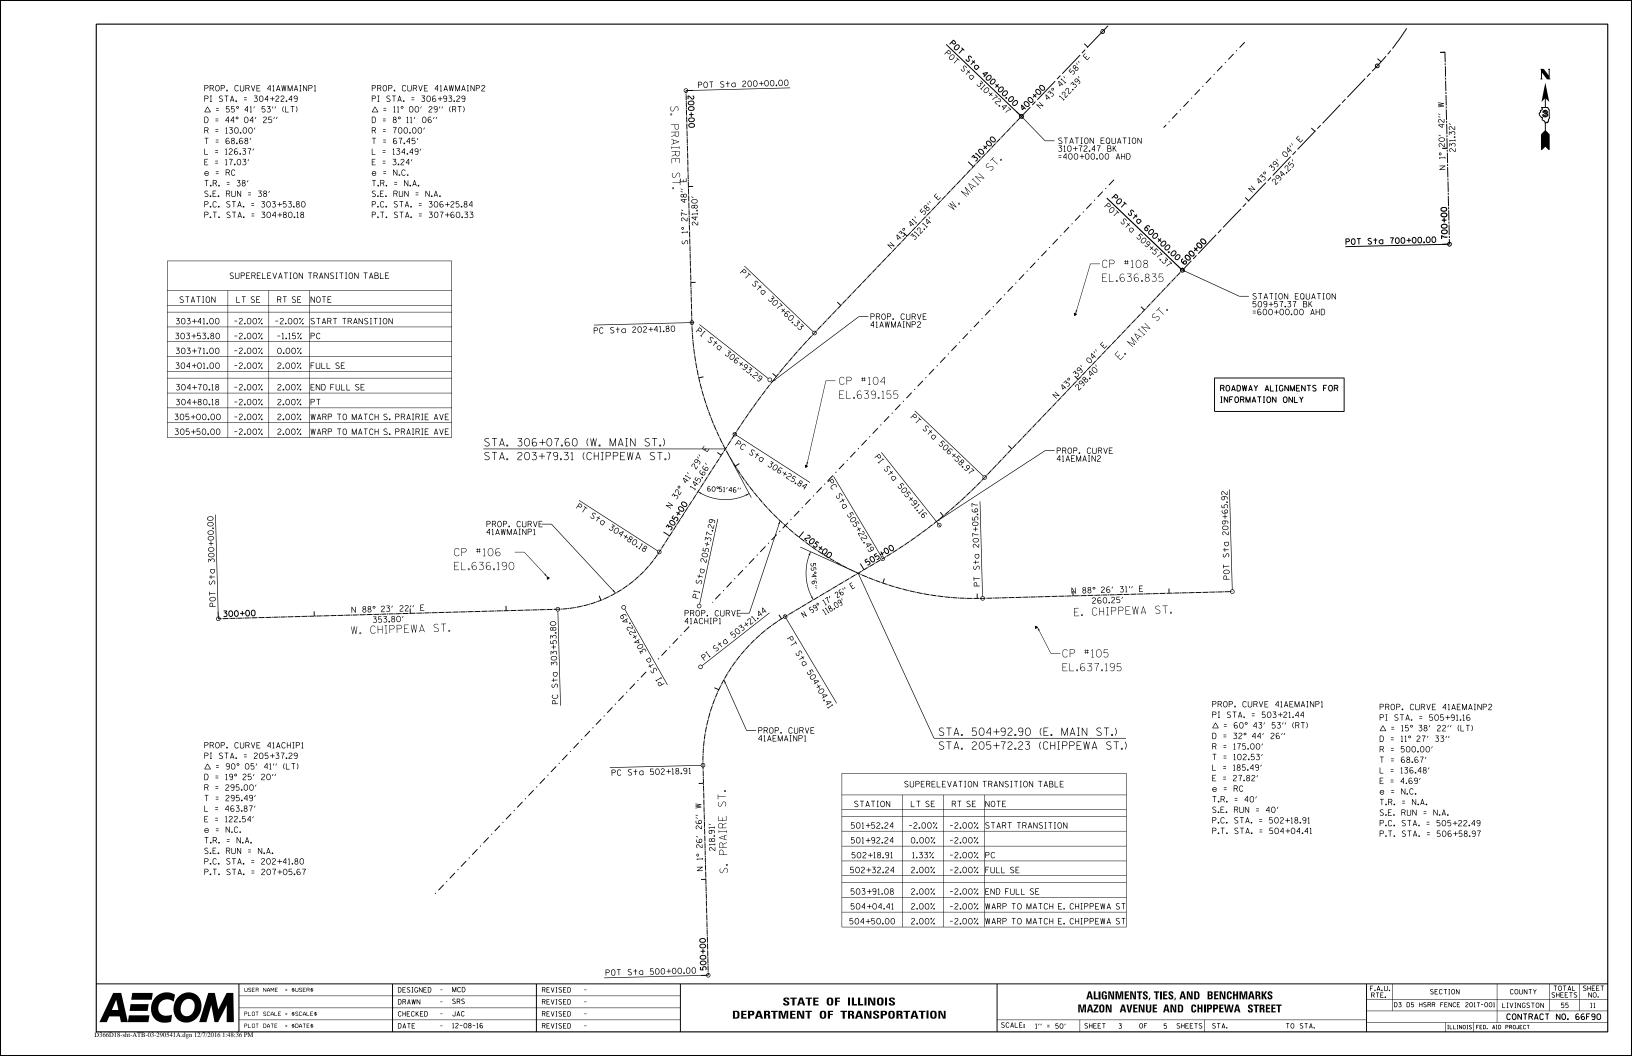

ALIGNMEN1	COORDINATES -	S. PRAIRIE ST. /	E. CHIPPEWA ST.		
	STATION	NORTHING	EASTING		
РОВ	200+00.00	1612233.82	957922.45		
	200+50.00	1612183.83	957923.73		
	201+00.00	1612133.85	957925.01		
	201+50.00	1612083.87	957926.28		
	202+00.00	1612033.88	957927.56		
PC	202+41.80	1611992.10	957928.63		
	202+50.00	1611983.90	957928.95		
	203+00.00	1611934.44	957935.83		
	203+50.00	1611886.84	957950.94		
	204+00.00	1611842.48	957973.88		
	204+50.00	1611802.62	958003.96		
	205+00.00	1611768.40	958040.34		
PI	205+37.29	1611696.71	957936.17		
	205+50.00	1611740.82	958081.97		
	206+00.00	1611720.65	958127.66		
	206+50.00	1611708.47	958176.09		
	207+00.00	1611704.64	958225.88		
PT	207+05.67	1611704.74	958231.55		
	207+50.00	1611705.95	958275.87		
	208+00.00	1611707.30	958325.85		
	208+50.00	1611708.66	958375.83		
	209+00.00	1611710.02	958425.81		
	209+50.00	1611711.38	958475.79		
POT	209+65.92	1611711.82	958491.71		

ALIGNME	ENT COORDINATES	- W. CHIPPEWA S	T./W. MAIN ST.
	STATION	NORTHING	EASTING
POB	300+00.00	1611683.44	957435.24
	300+50.00	1611684.85	957485.22
	301+00.00	1611686.25	957535.20
	301+50.00	1611687.66	957585.18
	302+00.00	1611689.06	957635.16
	302+50.00	1611690.47	957685.14
	303+00.00	1611691.87	957735.12
	303+50.00	1611693.28	957785.10
PC	303+53.80	1611693.39	957788.90
	304+00.00	1611702.78	957833.88
PI	304+22.49	1611695.32	957857.56
	304+50.00	1611729.83	957875.57
PT	304+80.18	1611753.12	957894.65
	305+00.00	1611769.80	957905.36
	305+50.00	1611811.88	957932.37
	306+00.00	1611853.96	957959.37
PC	306+25.84	1611875.71	957973.33
	306+50.00	1611895.81	957986.73
PI	306+93.29	1611932.47	958009.76
	307+00.00	1611935.88	958016.61
	307+50.00	1611973.72	958049.28
PT	307+60.33	1611981.24	958056.36
	308+00.00	1612009.92	958083.77
	308+50.00	1612046.07	958118.31
	309+00.00	1612082.22	958152.86
	309+50.00	1612118.37	958187.40
	310+00.00	1612154.52	958221.94
	310+50.00	1612190.66	958256.49
OT/EQ	310+72.47	1612206.91	958272.01
OT/EQ	400+00.00	1612206.91	958272.01


ALIGN	ENT COORDINATES	- S. PRAIRIE ST.	./E. MAIN ST.
	STATION	NORTHING	EASTING
POB	500+00.00	1611311.99	957945.70
	500+50.00	1611361.98	957944.44
	501+00.00	1611411.96	957943.18
	501+50.00	1611461.95	957941.93
	502+00.00	1611511.93	957940.67
PC	502+18.91	1611530.84	957940.19
	502+50.00	1611561.82	957942.17
	503+00.00	1611609.49	957956.67
ΡI	503+21.44	1611633.34	957937.62
	503+50.00	1611651.15	957984.03
	504+00.00	1611683.40	958022.01
PT	504+04.41	1611685.70	958025.77
	504+50.00	1611708.98	958064.97
	505+00.00	1611734.52	958107.96
PC	505+22.49	1611746.00	958127.30
	505+50.00	1611760.69	958150.55
ΡΙ	505+91.16	1611781.07	958186.33
	506+00.00	1611790.58	958190.61
	506+50.00	1611824.32	958227.48
PT	506+58.97	1611830.75	958233.73
	507+00.00	1611860.44	958262.05
	507+50.00	1611896.62	958296.57
	508+00.00	1611932.79	958331.08
	508+50.00	1611968.97	958365.59
	509+00.00	1612005.15	958400.10
	509+50.00	1612041.33	958434.62
POT/EQ	509+57.37	1612046.66	958439.71
POT/EQ	600+00.00	1612046.66	958439.71


PROJECT BENCHMARK ELEVATIONS DATUM: N. A. V. D. OF 1988										
NO.	DESCRIPTION	STATION OFFSET	COORDINATES	ELEV.						
CP 100	CUT CROSS IN NORTHWEST CORNER OF ISLAND PAVEMENT.	107+53. 42 39. 37′ RT	N 1, 612, 474. 291 E 958, 724. 394	636. 300						
CP 101	CUT CROSS IN CENTER OF SIDEWALK AT NORTHWEST CORNER OF MAZON AVENUE BRIDGE OVER GOOSEBERRY CREEK.	112+65.95 23.74′LT	N 1, 612, 550. 419 E 959, 234. 750	629.650						
CP 102	IRON ROD WITH CAP SOUTHEAST ACROSS SEMINOLE STREET FROM RESIDENCE 214.	111+47.47 420.48′LT	N 1,612,944.121 E 959,106.596	628.665						
CP 103	CUT CROSS IN SIDEWALK CENTER OF SIDEWALK APPROXIMATELY 17 FEET WEST OF CURB IN SOUTHWEST OUADRANT OF WEST MAIN STREET AND MAZON AVENUE.	104+96.39 39.39′RT	N 1,612,467.488 E 958,467.059	633. 295						
CP 104	CUT CROSS IN PAVEMENT AT SOUTHWEST CORNER OF PARKING PAVEMENT OF HISTORICAL SOCIETY BUILDING.	204+57.14 57.42′LT	N 1,611,836.734 E 958,050.591	639. 155						
CP 105	CUT CROSS IN SIDEWALK SOUTH SIDE OF CHIPPEWA STREET AT BUILDING 111.	207+76.66 33.30′ RT	N 1,611,673.383 E 958,303.424	637.195						
CP 106	CUT CROSS IN CENTER OF SIDEWALK APPROXIMATELY 1.5 FEET EAST OF DRIVEWAY TO DWIGHT POLICE DEPARTMENT BUILDING.	303+35.40 32.50′LT	N 1,611,725.354 E 957,769.586	636. 190						
CP 108	CUT CROSS IN SIDEWALK ALONG EAST MAIN STREET AT NORTH WALKWAY CROSSING RAILROAD TRACKS AT TRAIN STATION IN DWIGHT.	509+17.15 47.43′LT	N 1,612,050.298 E 958,377.629	636. 835						


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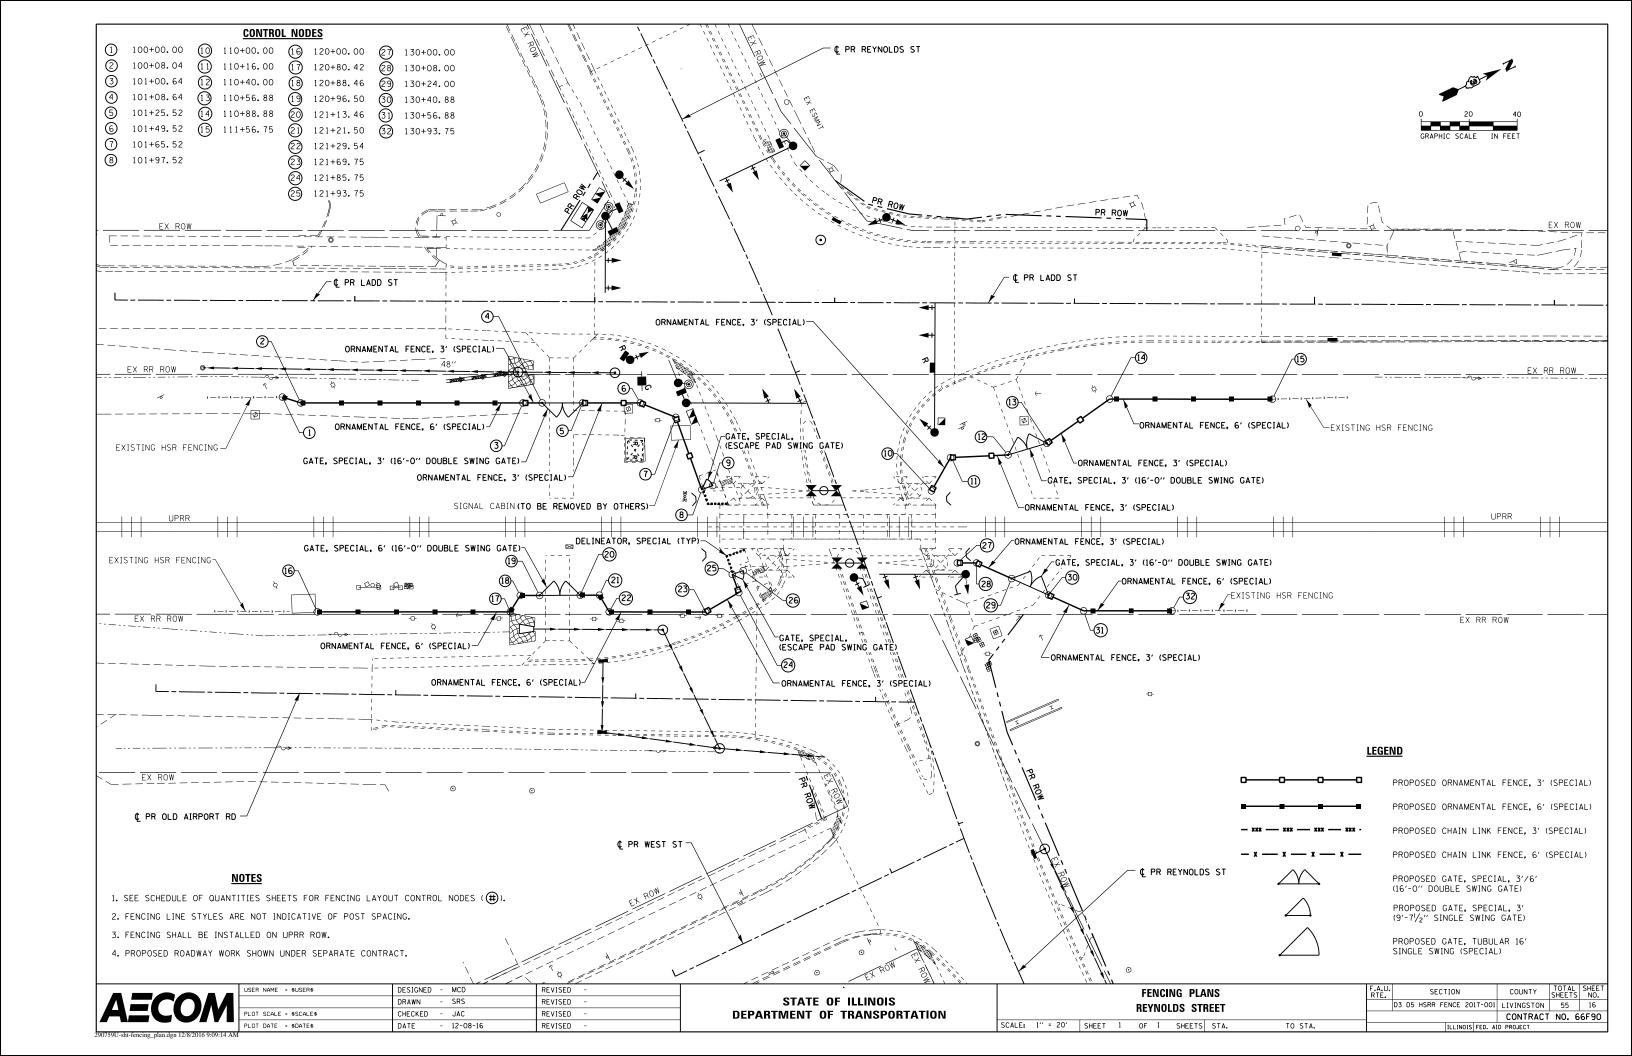
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_	PLOT DATE = \$DATE\$	DATE -	-	12-08-16	REVISED	-


	ALIG	NMEN	ITS, T	IES, AN	F.A.U. RTE.	SECTION	COUNTY	TOTAL SHEETS			
1	MAZOI	ı AVI	MILE	VND (HIPPEWA	CTREET		D3 D5 HSRR FENCE 2017-001	LIVINGSTON	55	12
		v ~v:	LIVUL				CONTRACT	NO. 6	6F90		
SCALE: NONE SI	E: NONE SHEET 4 OF 5 SHEETS STA. TO STA.							ILLINOIS FED. A	D PROJECT		




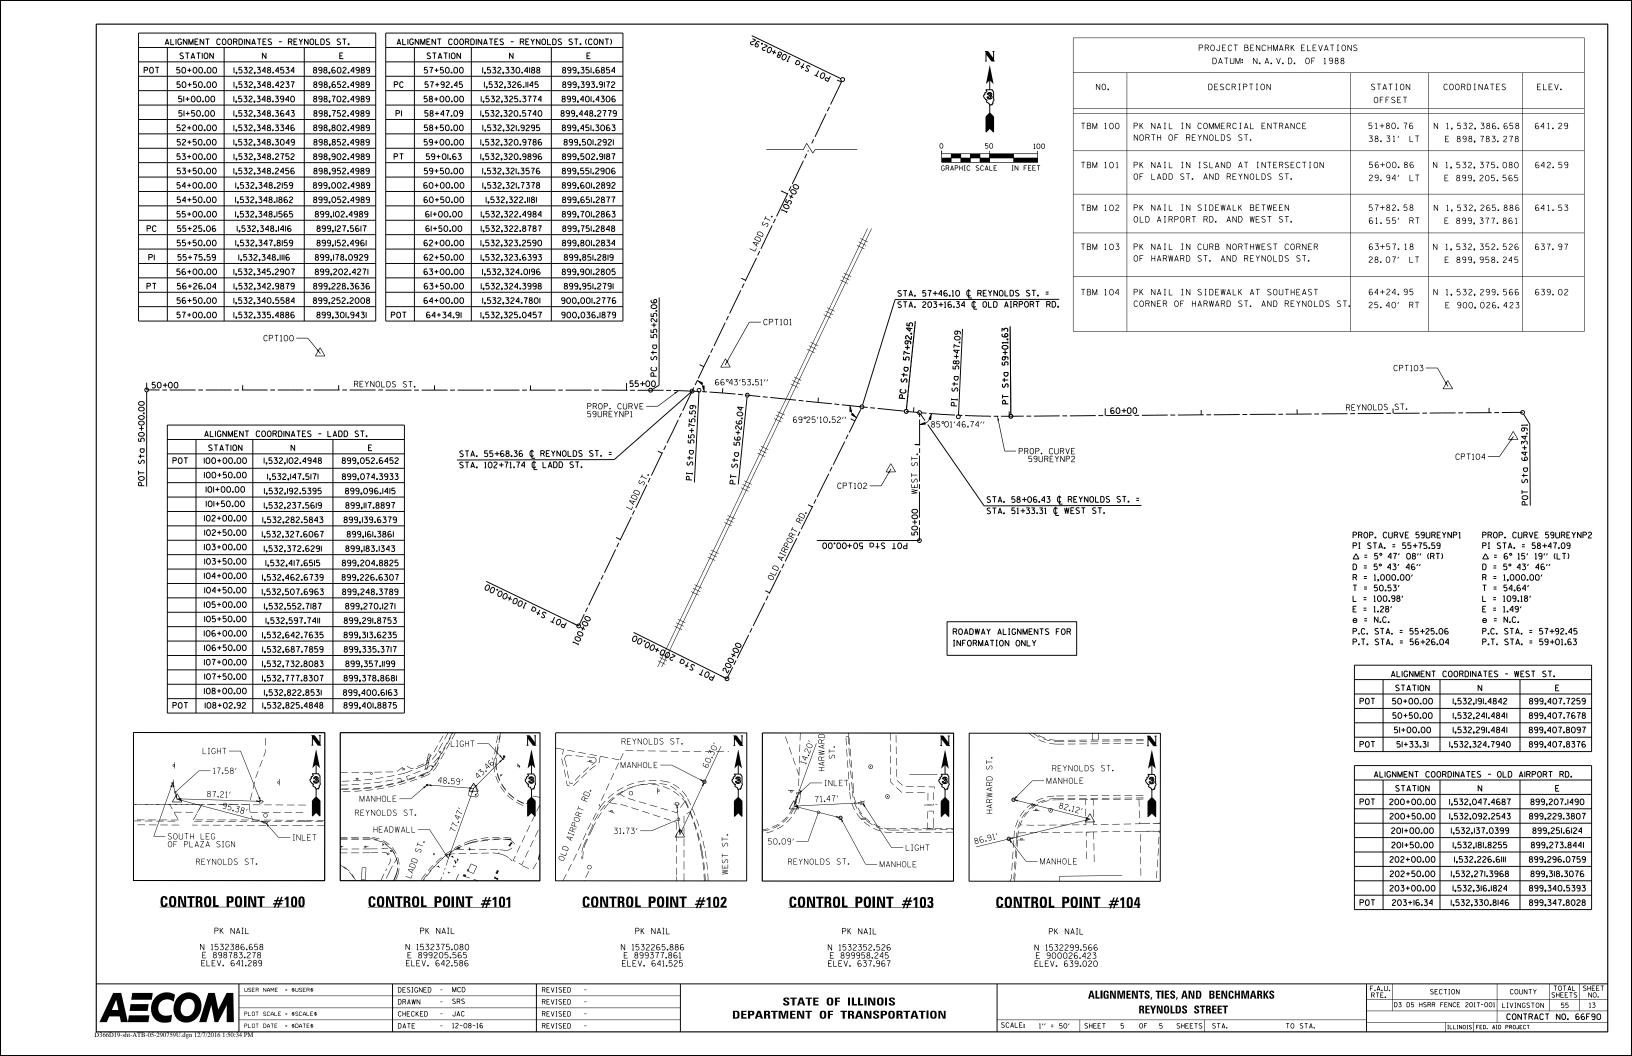


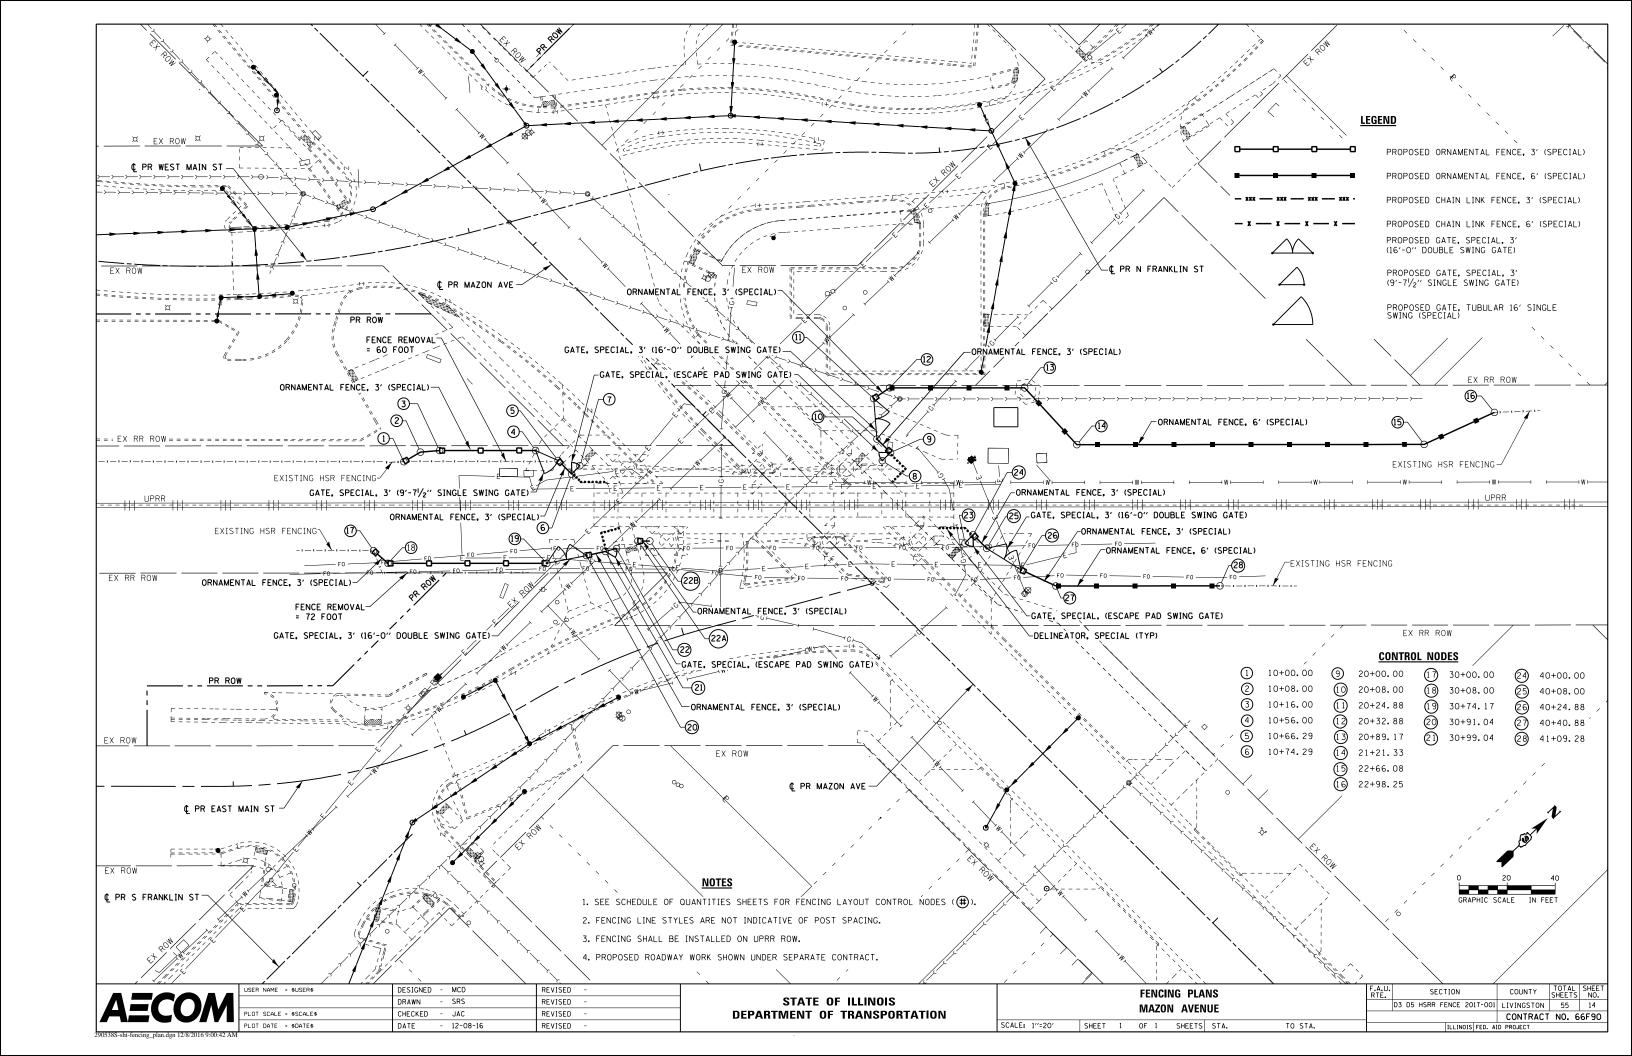


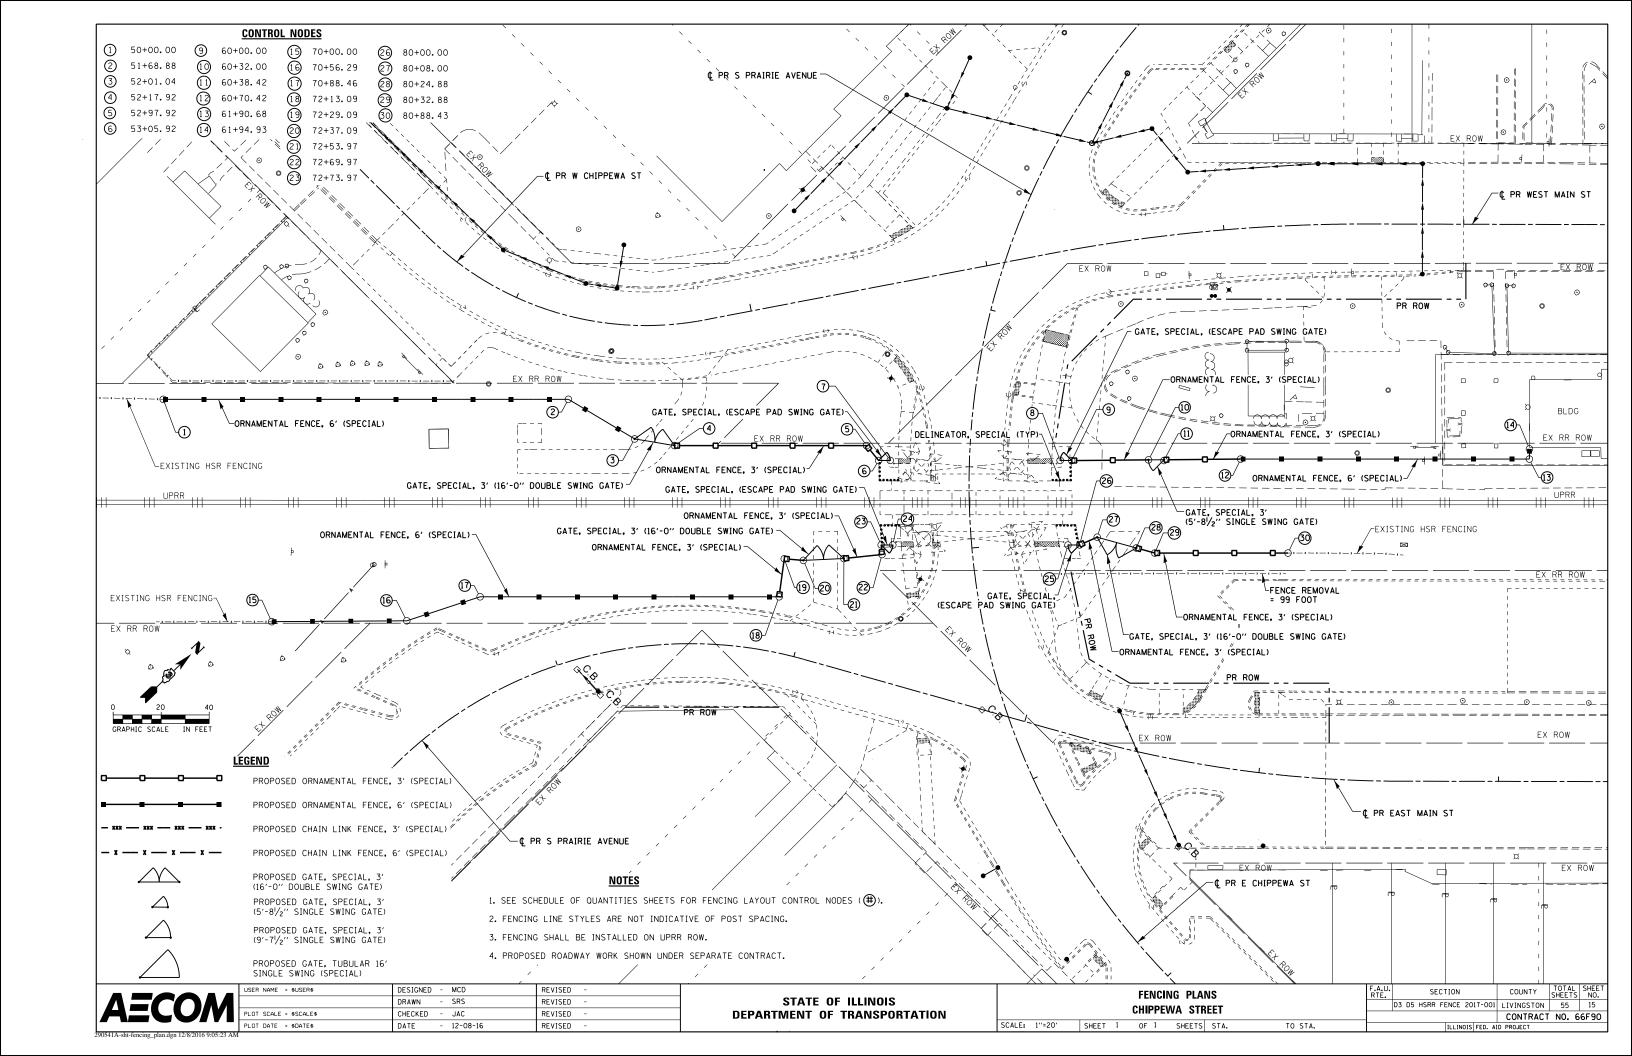


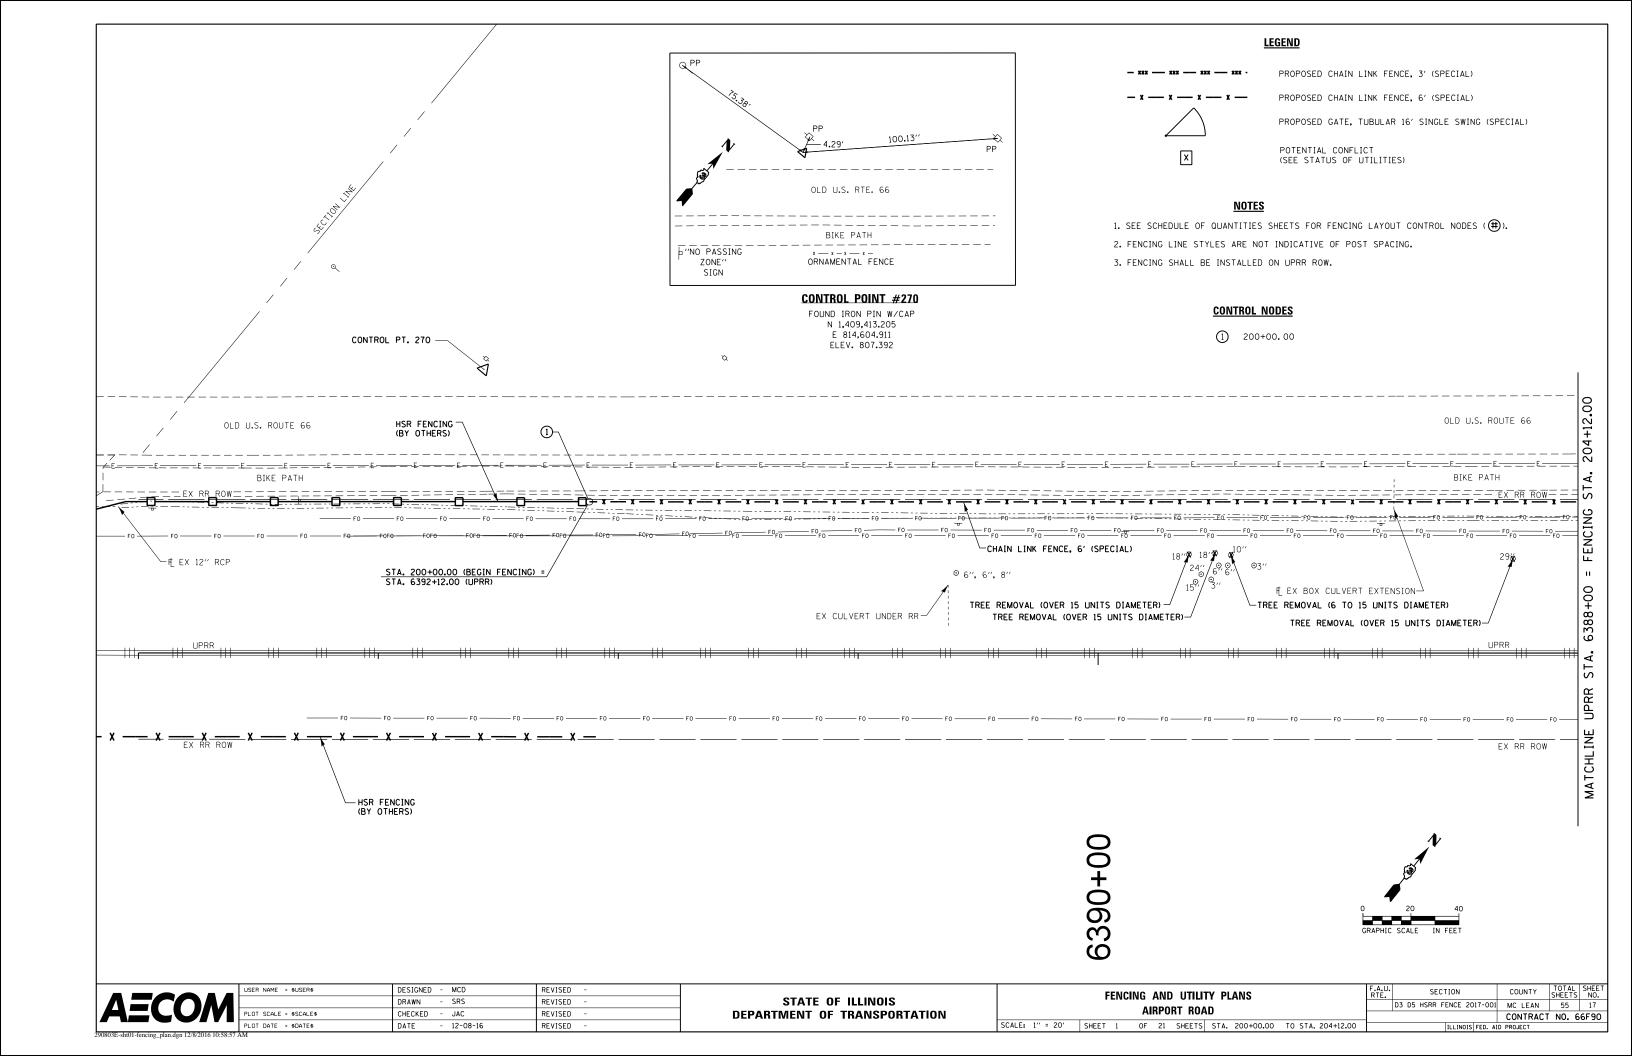


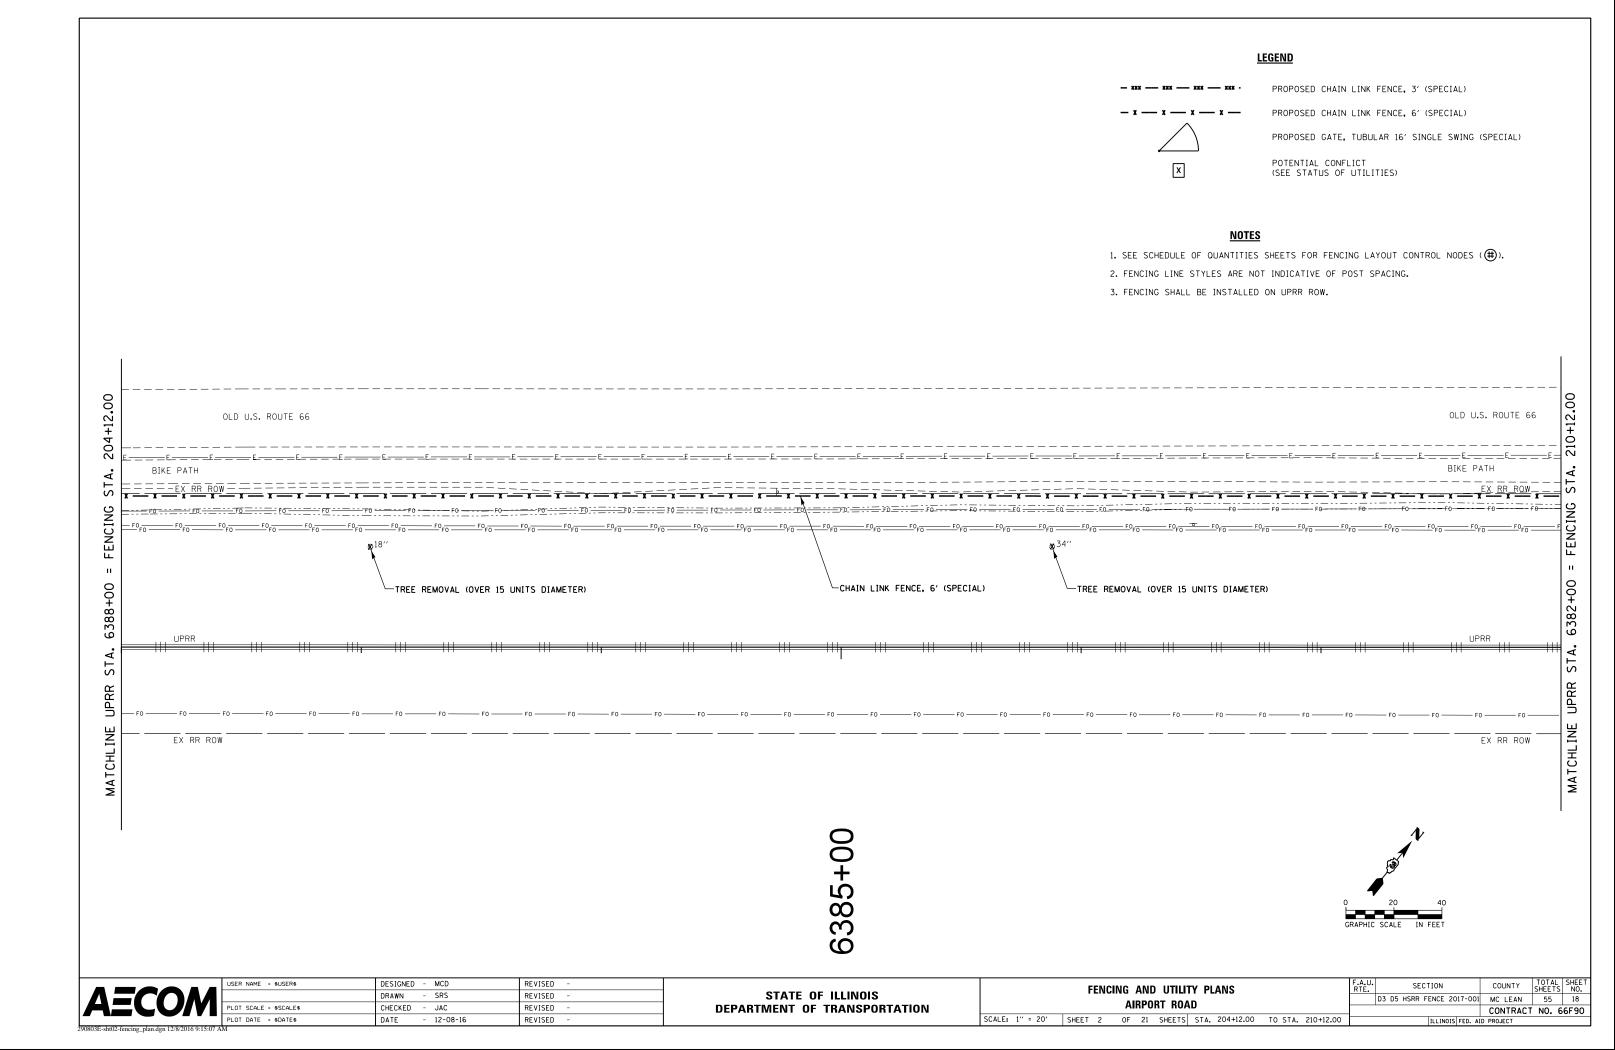


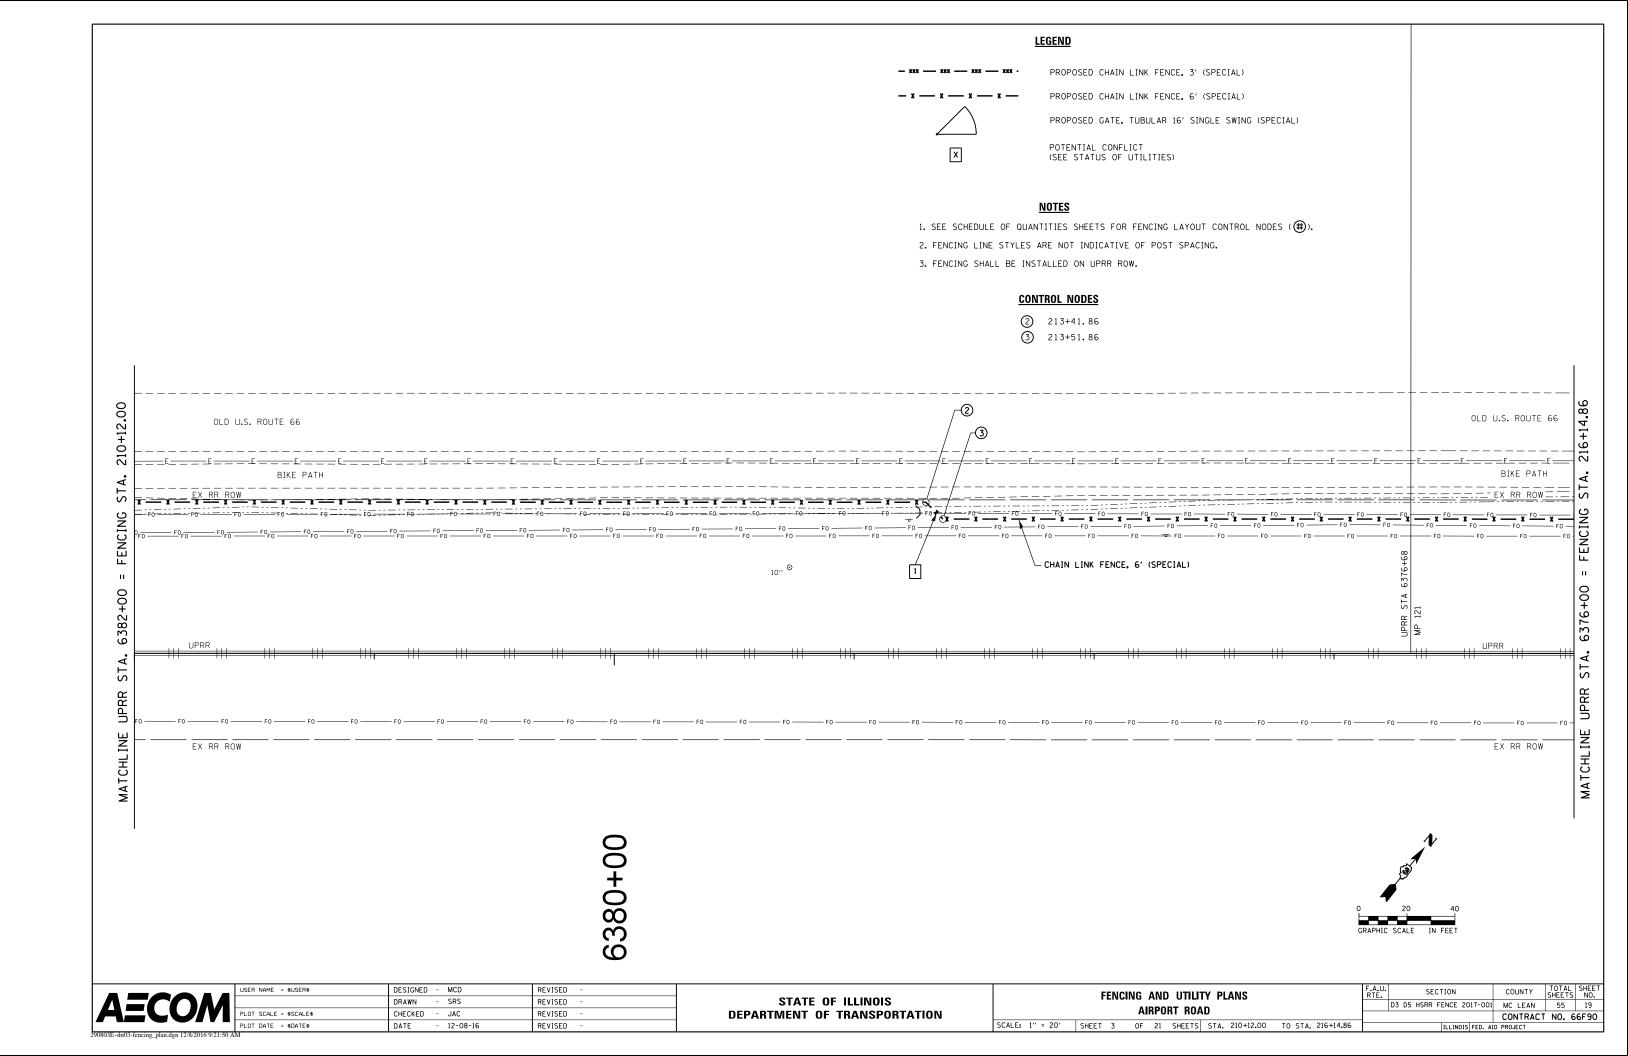

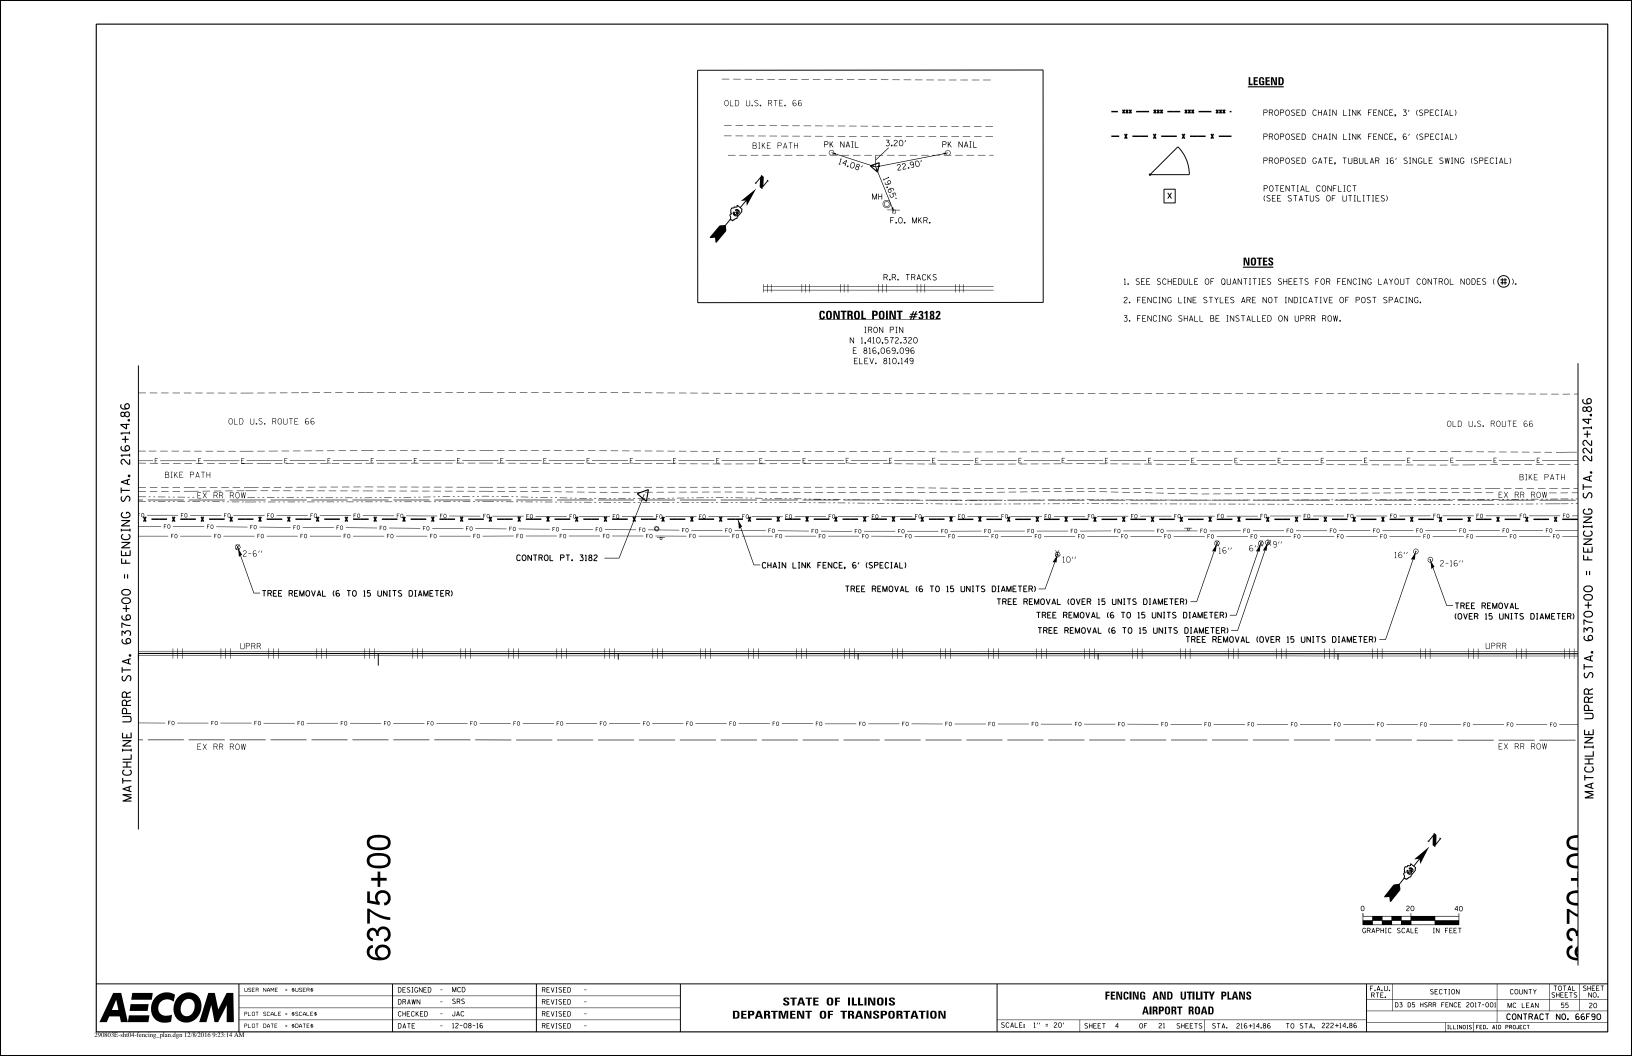

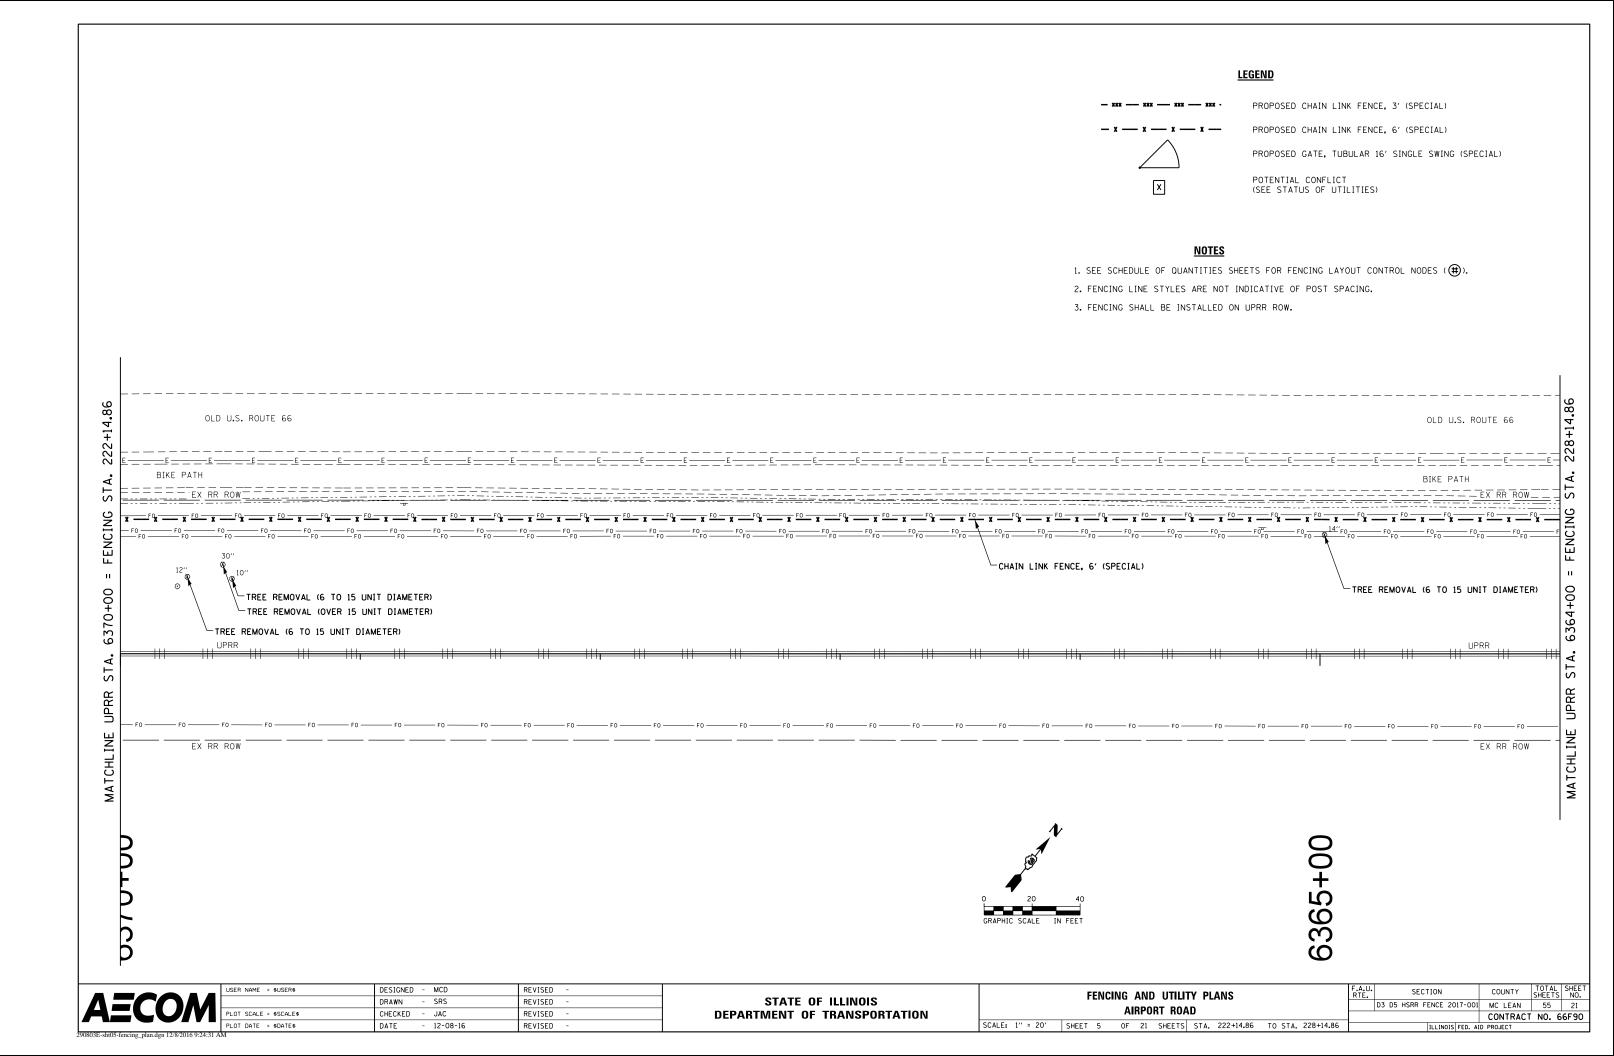

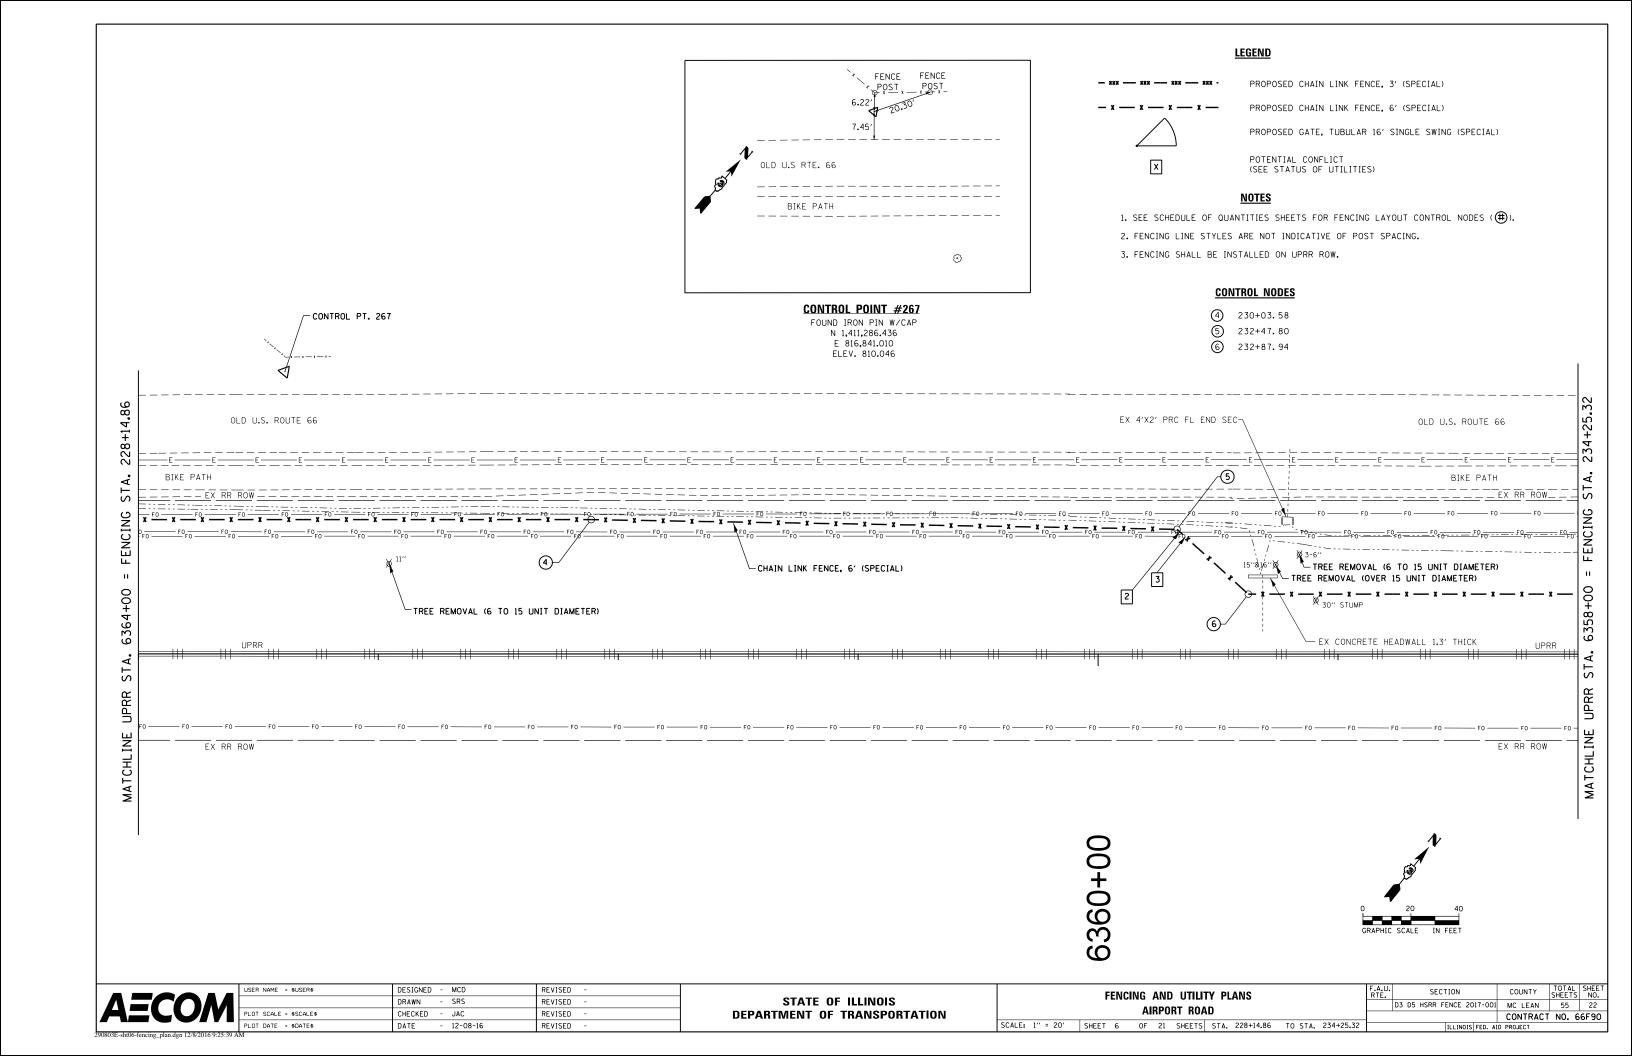

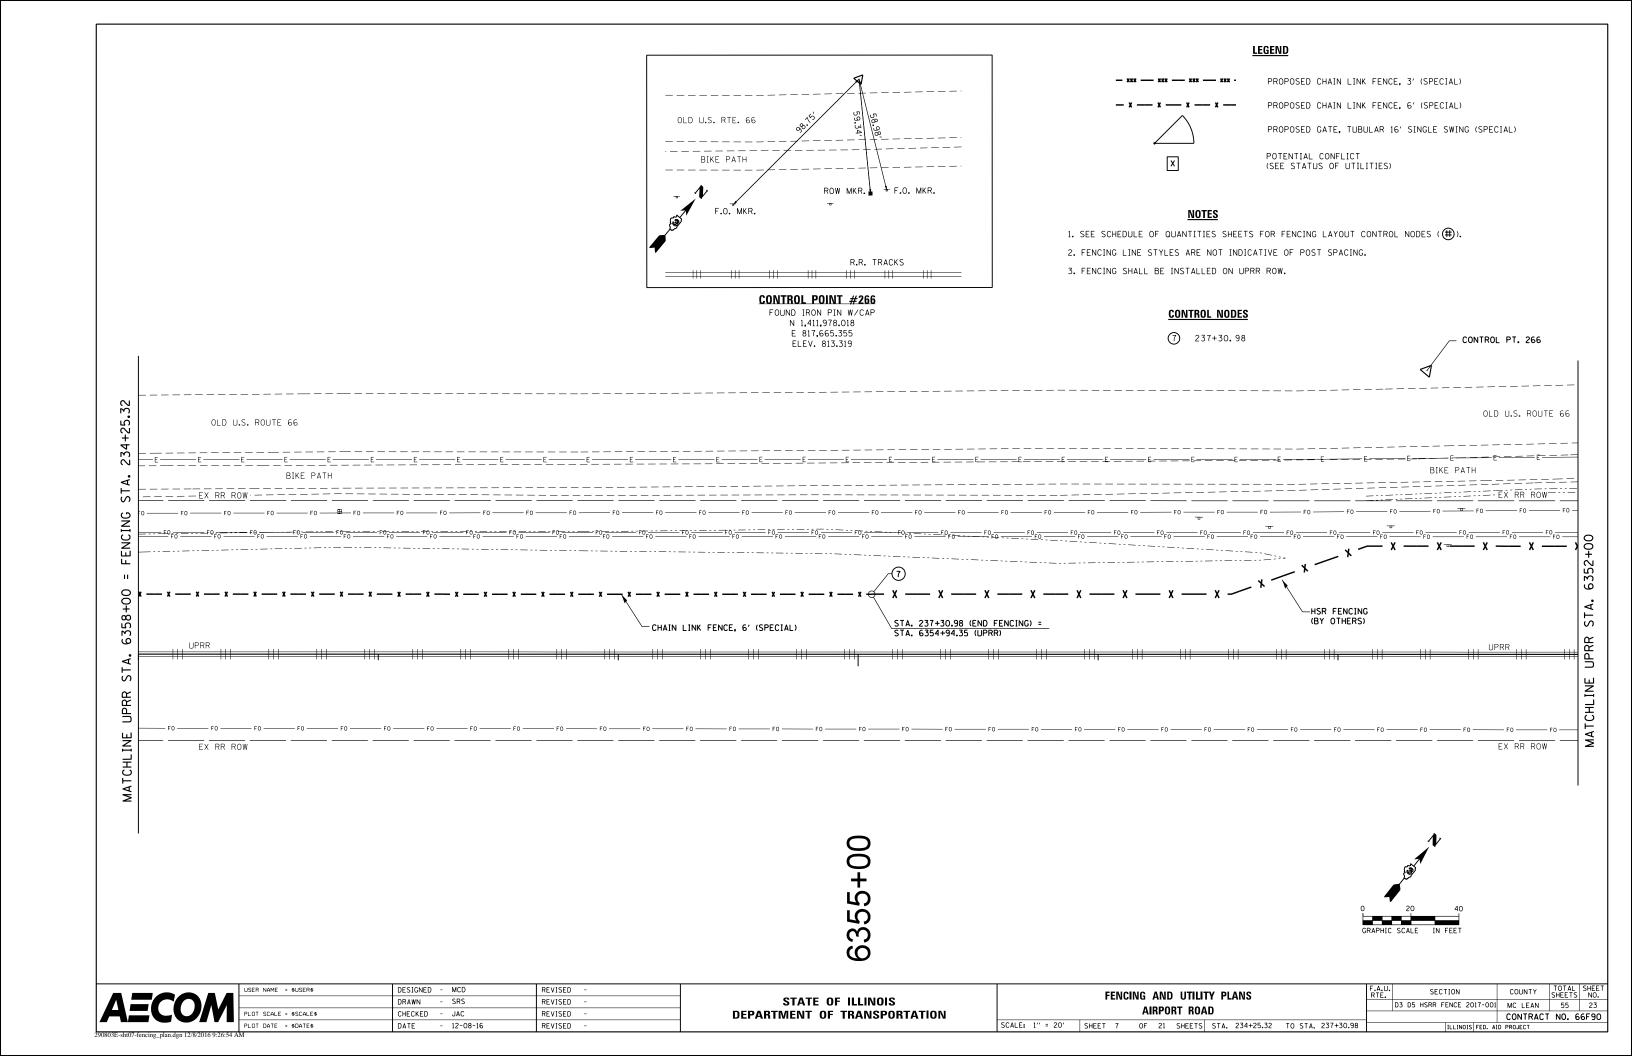



- xxx --- xxx --- xxx --- xxx -

PROPOSED CHAIN LINK FENCE, 3' (SPECIAL)

* -- * -- PROPOSED CHAIN LINK FENCE, 6' (SPECIAL)

PROPOSED GATE, TUBULAR 16' SINGLE SWING (SPECIAL)

×


POTENTIAL CONFLICT (SEE STATUS OF UTILITIES)

<u>Notes</u>


- 1. SEE SCHEDULE OF QUANTITIES SHEETS FOR FENCING LAYOUT CONTROL NODES (#).
- 2. FENCING LINE STYLES ARE NOT INDICATIVE OF POST SPACING.
- 3. FENCING SHALL BE INSTALLED ON UPRR ROW.

CONTROL NODES

8 300+00.00

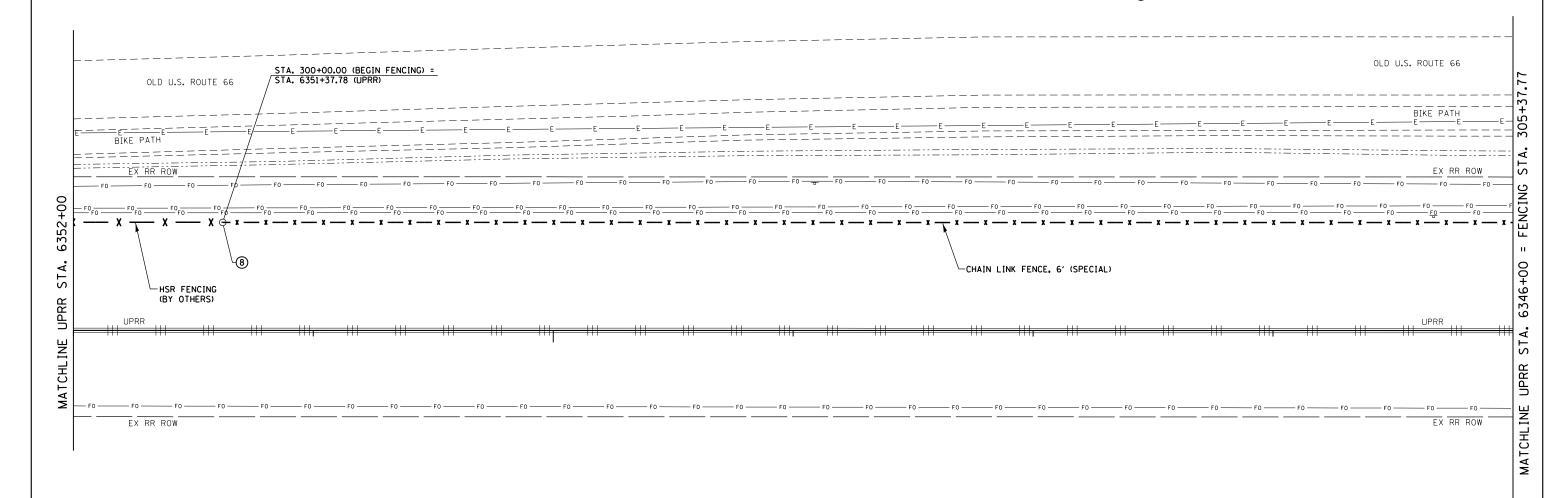

6350+0

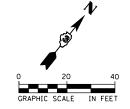


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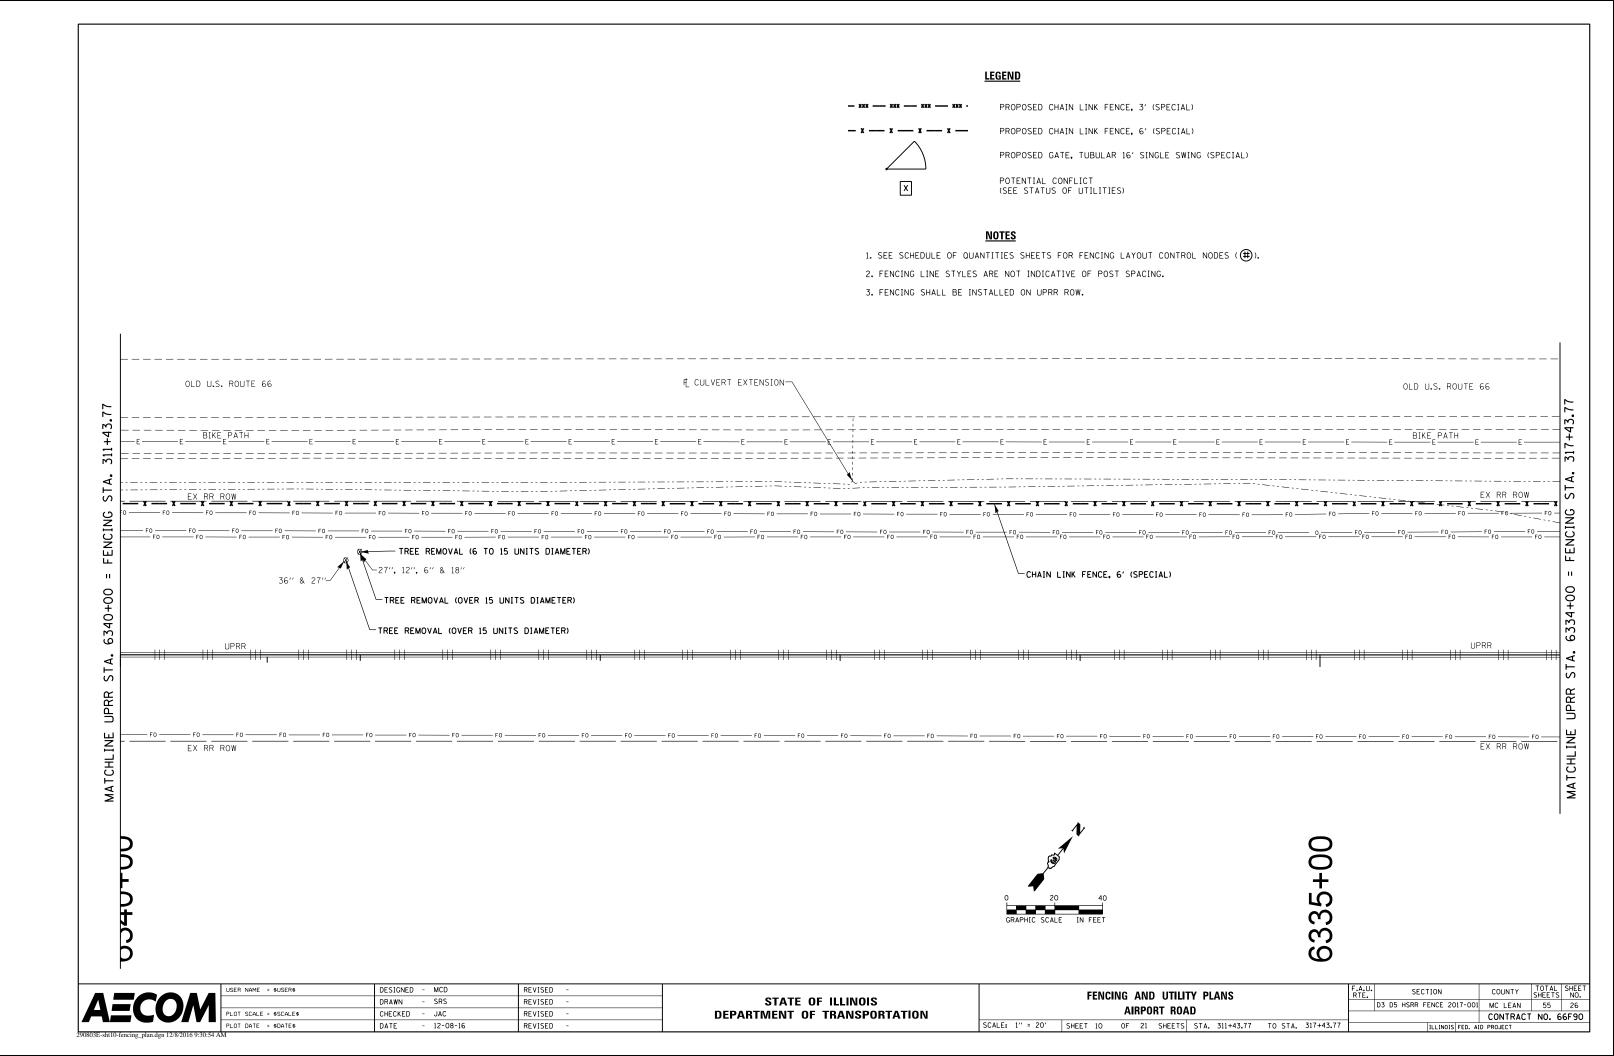
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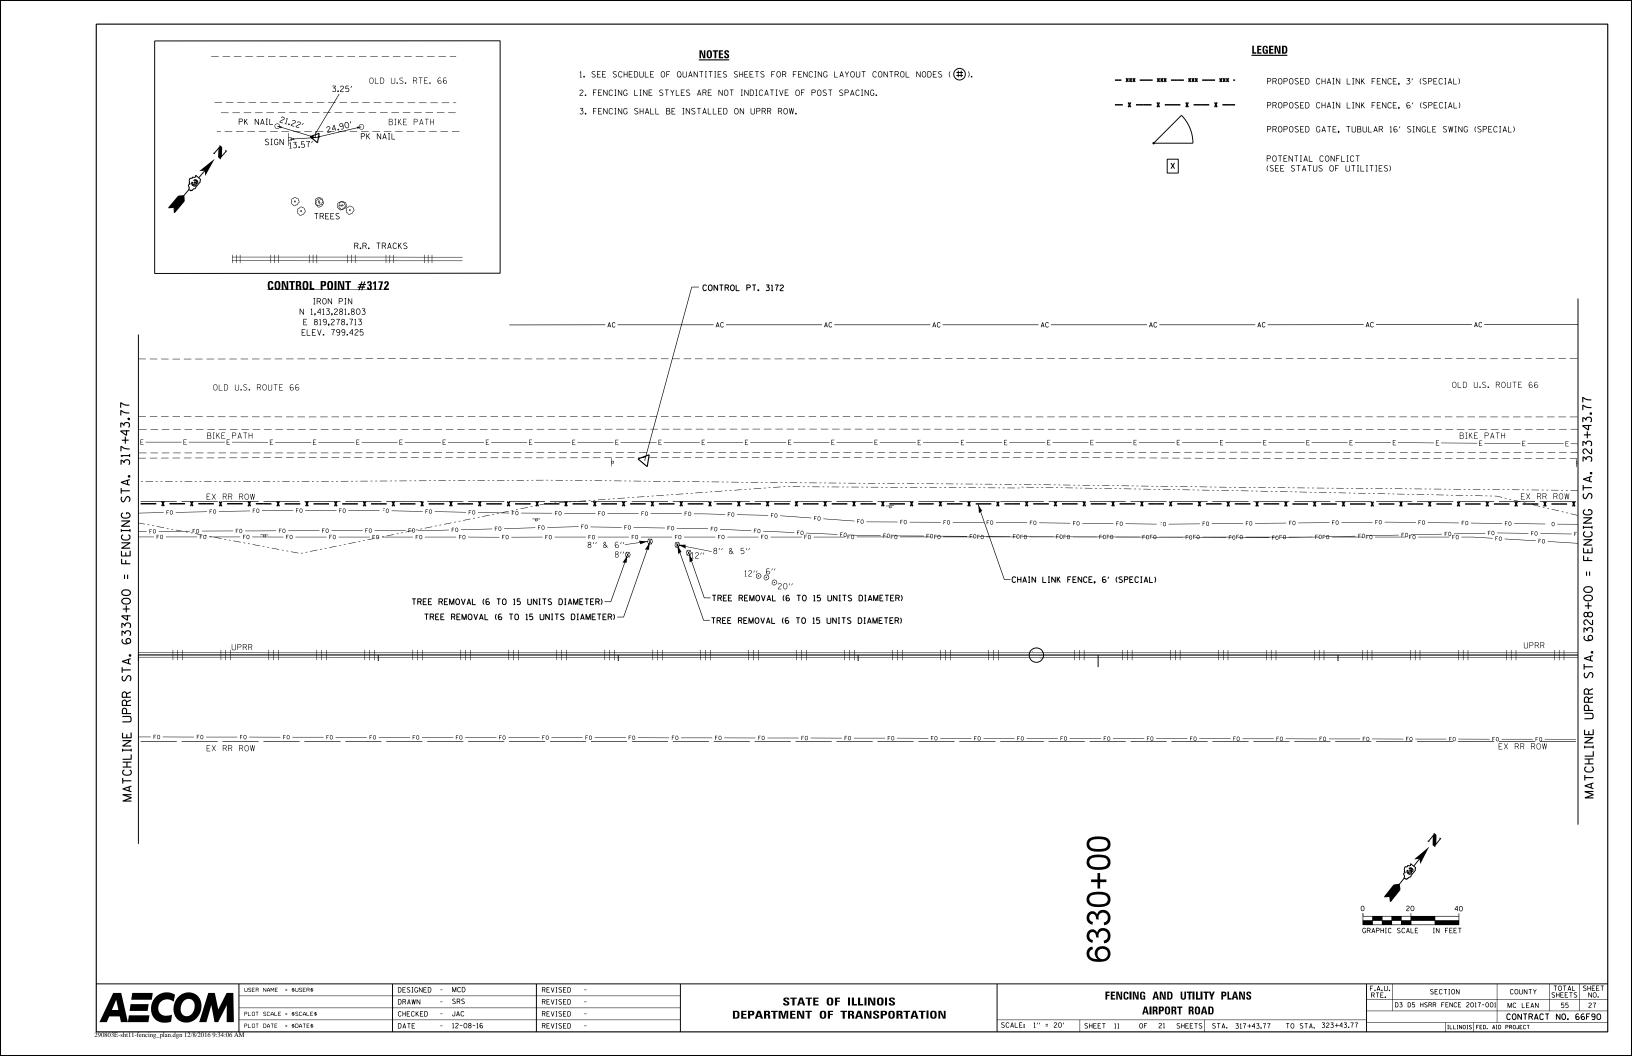
STATE OF ILLINOIS								
DEPARTMENT	0F	TRANSPORTATION						


	FENC			UTILIT	TY PLANS ND		
SCALE: 1" = 20'	SHEET 8	OF	21	SHEETS	STA. 300+00.00	TO STA.	305+37.77


F.A.U. RTE.							COUNTY			TOTA SHEET		SHEI NO
	D3	D5	HSRR	FENCE	20	17-001	Г	мс	LEAN	55	П	24
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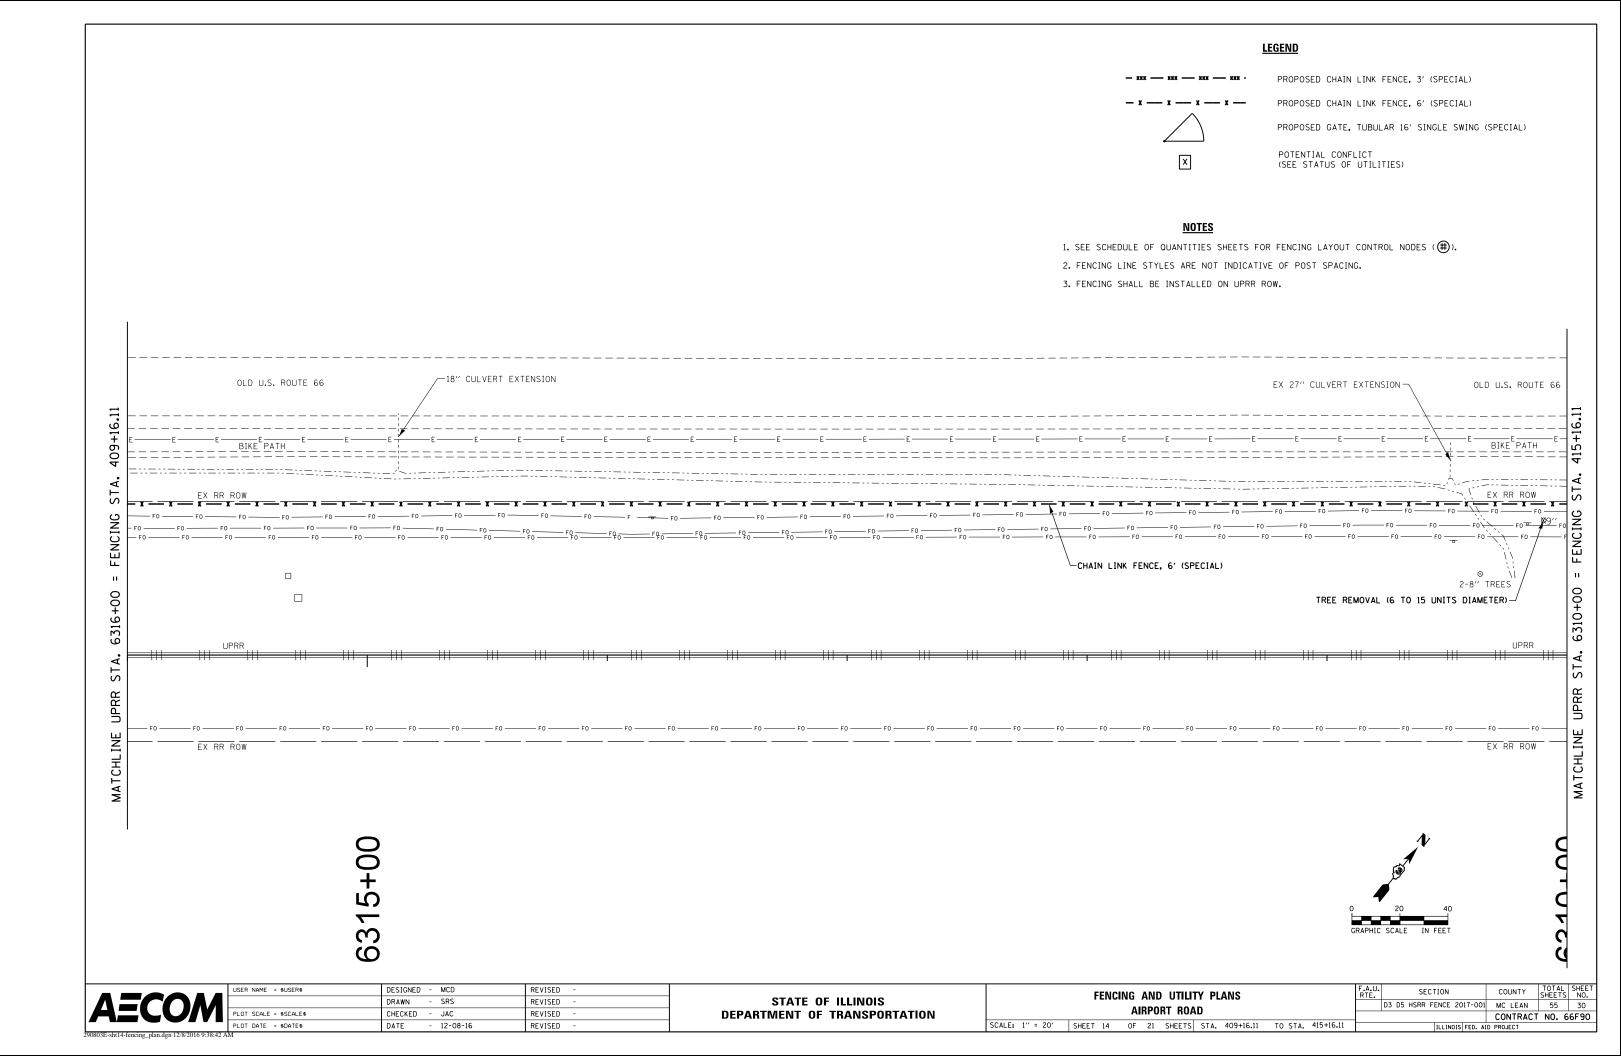







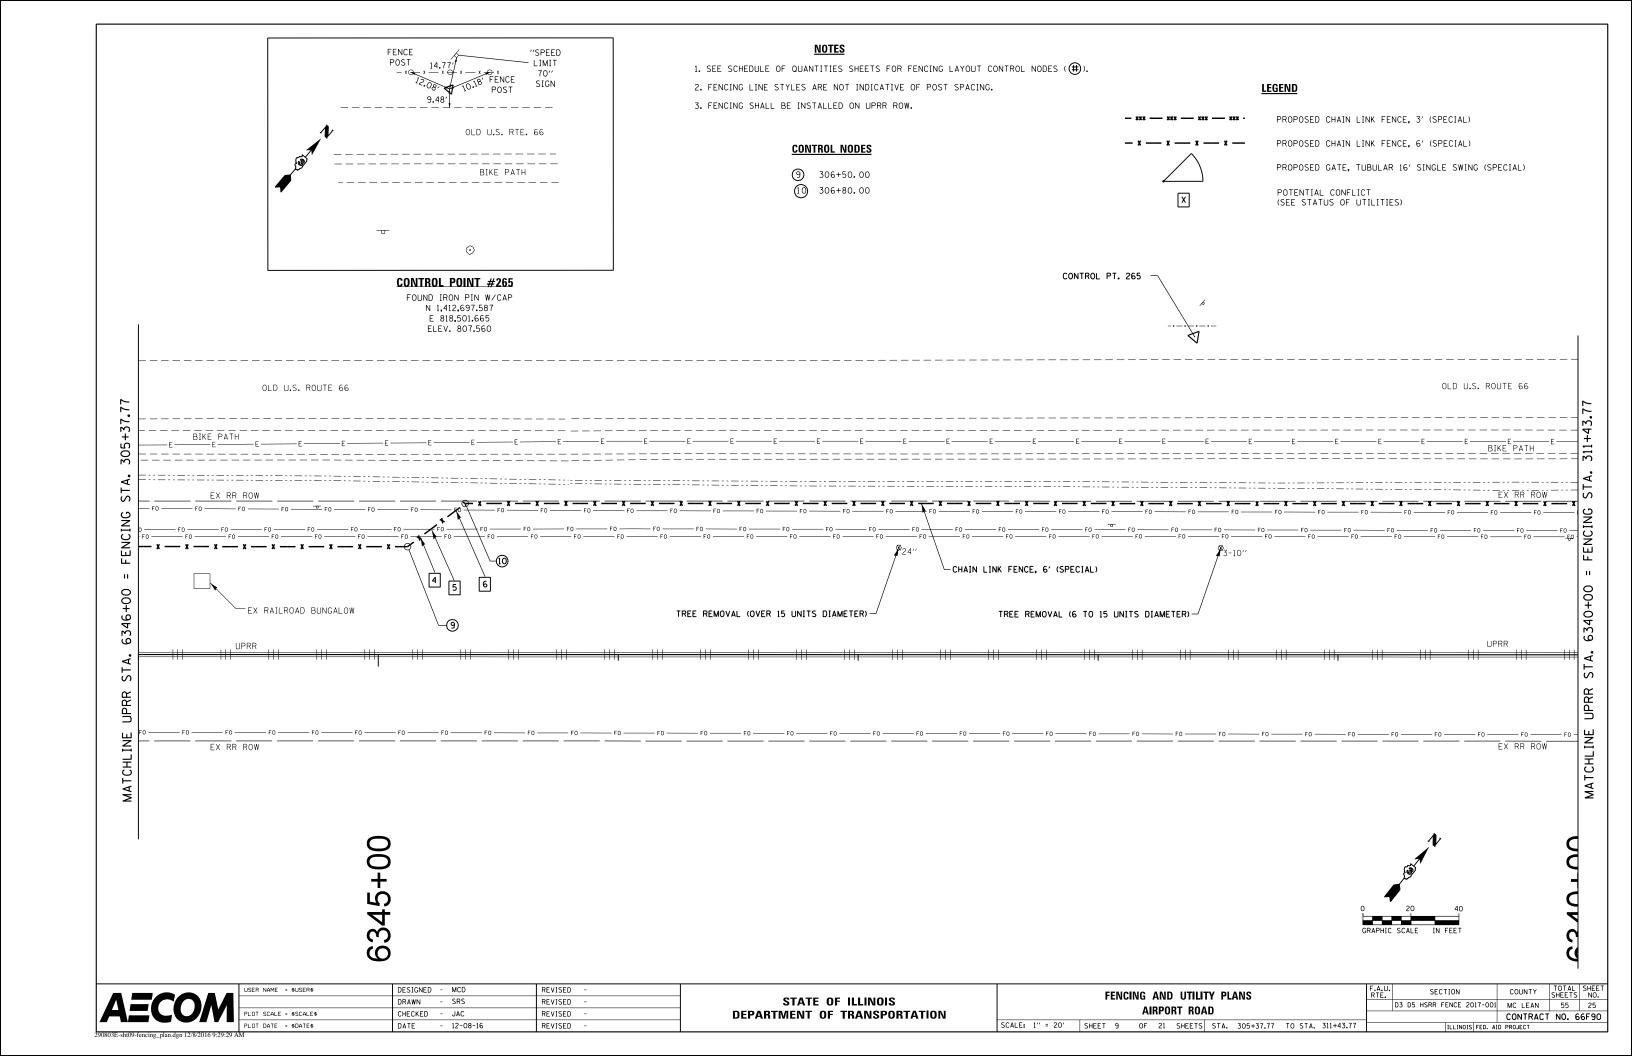

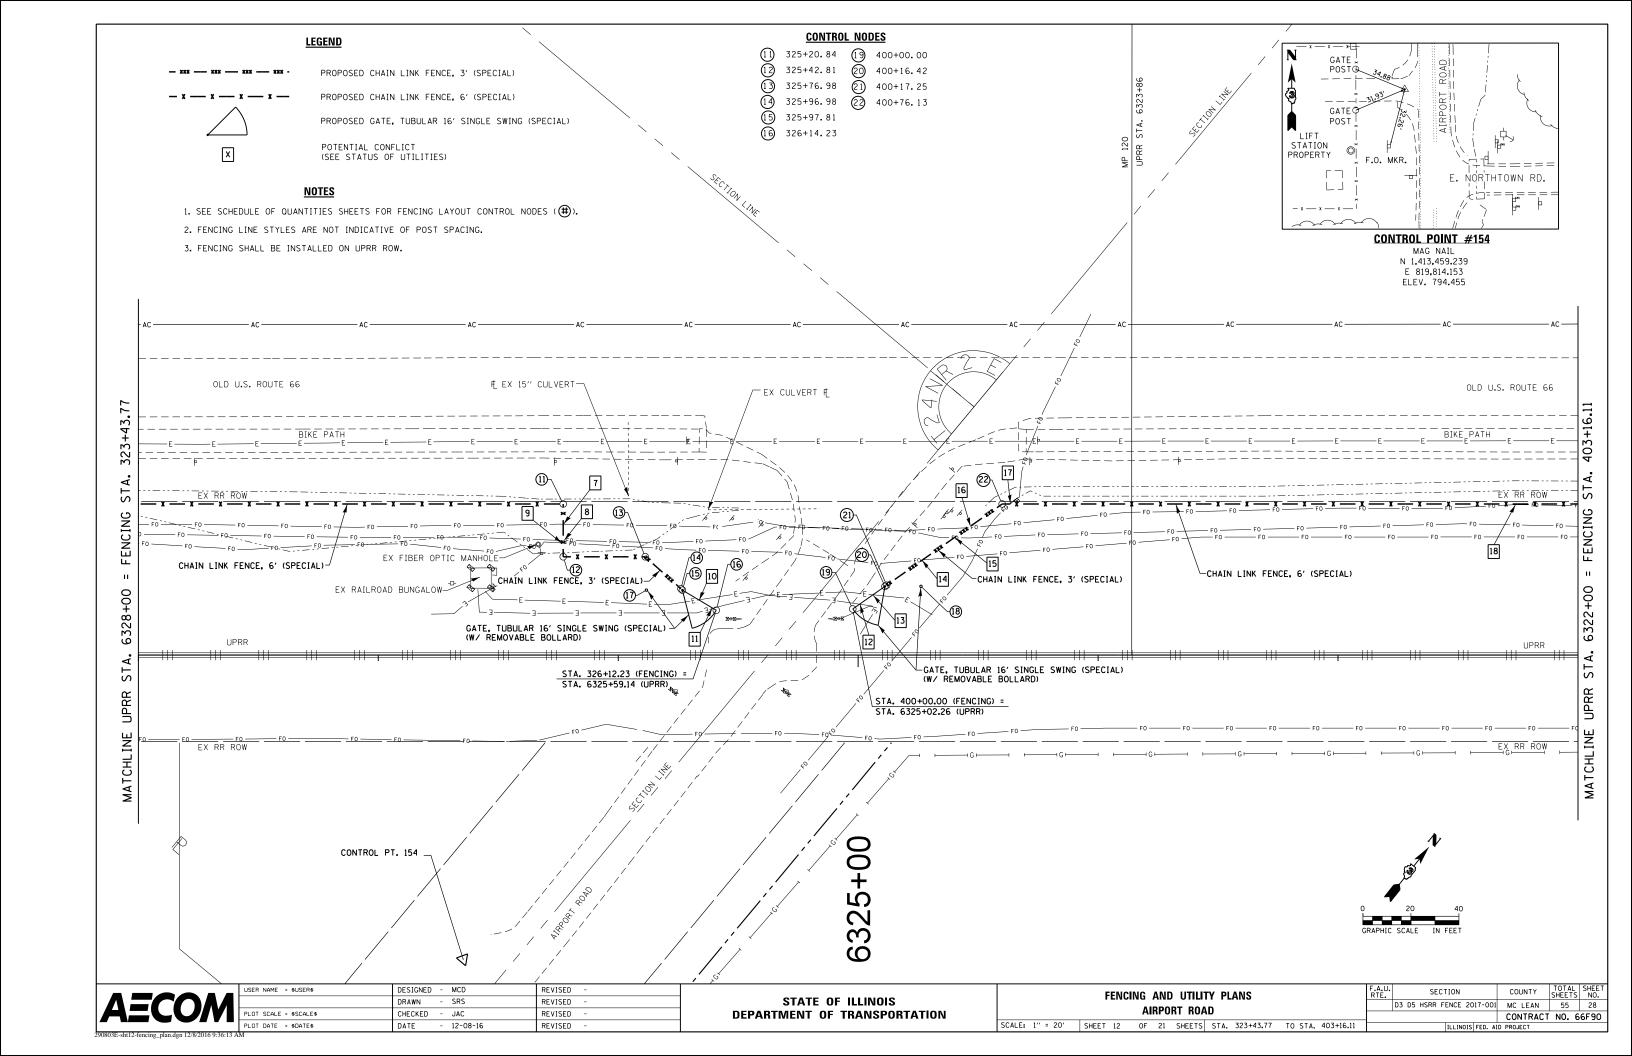

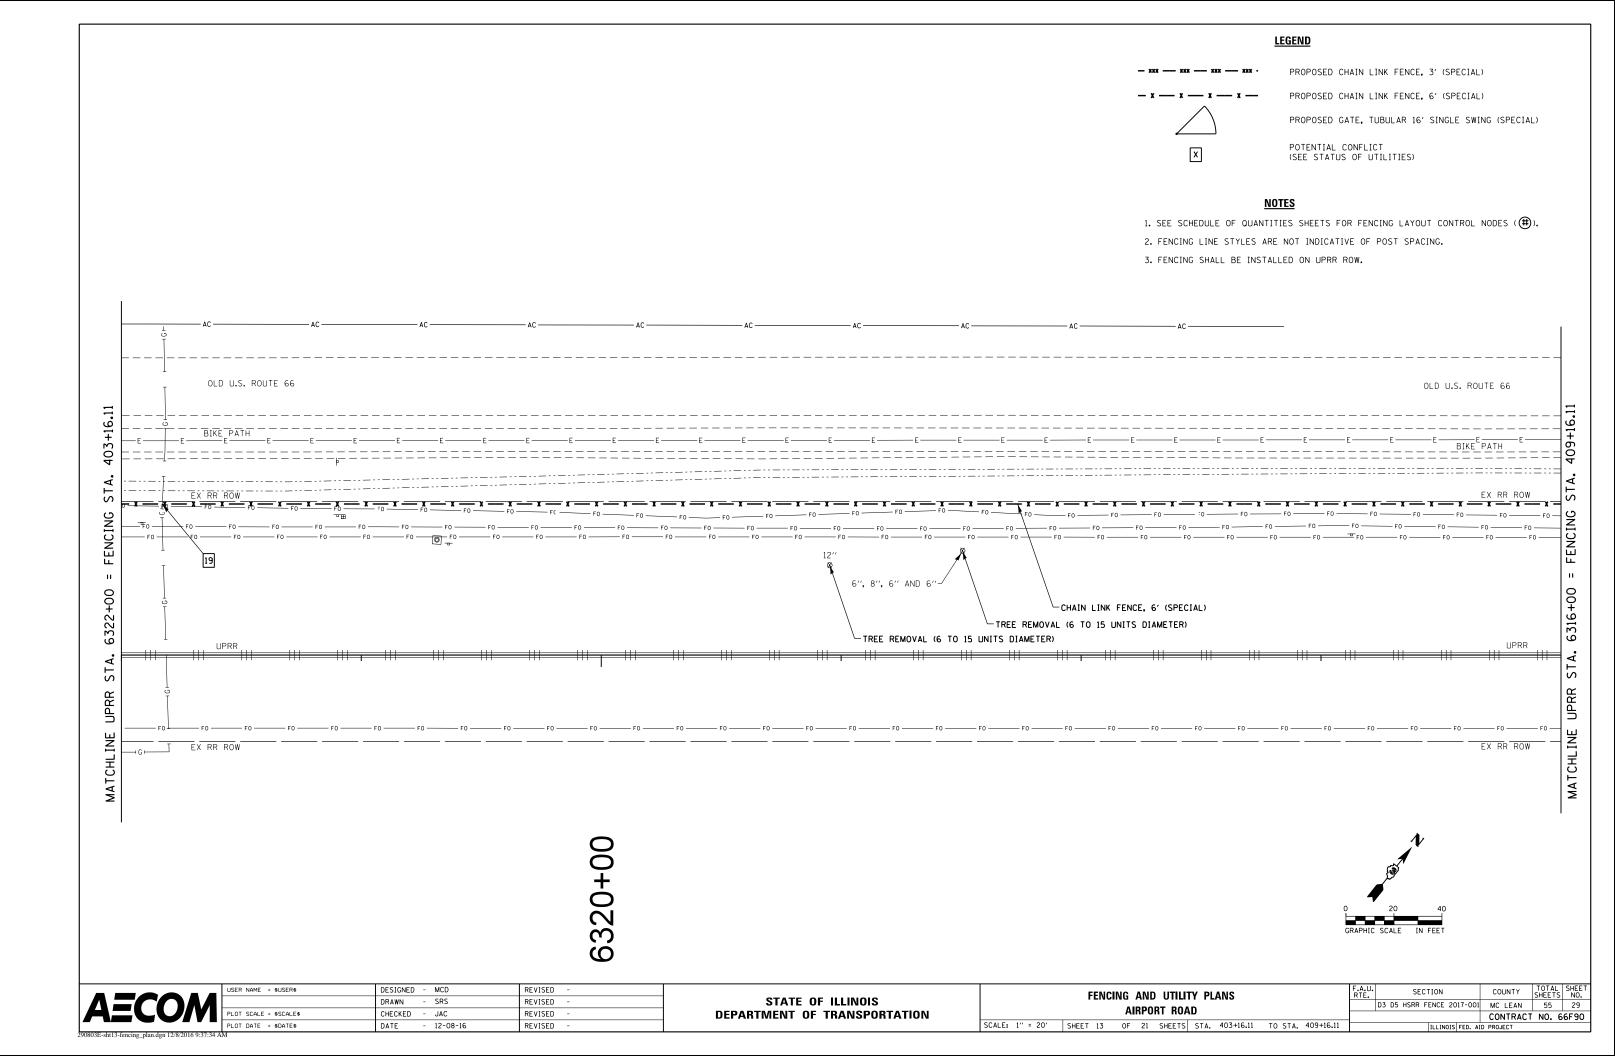

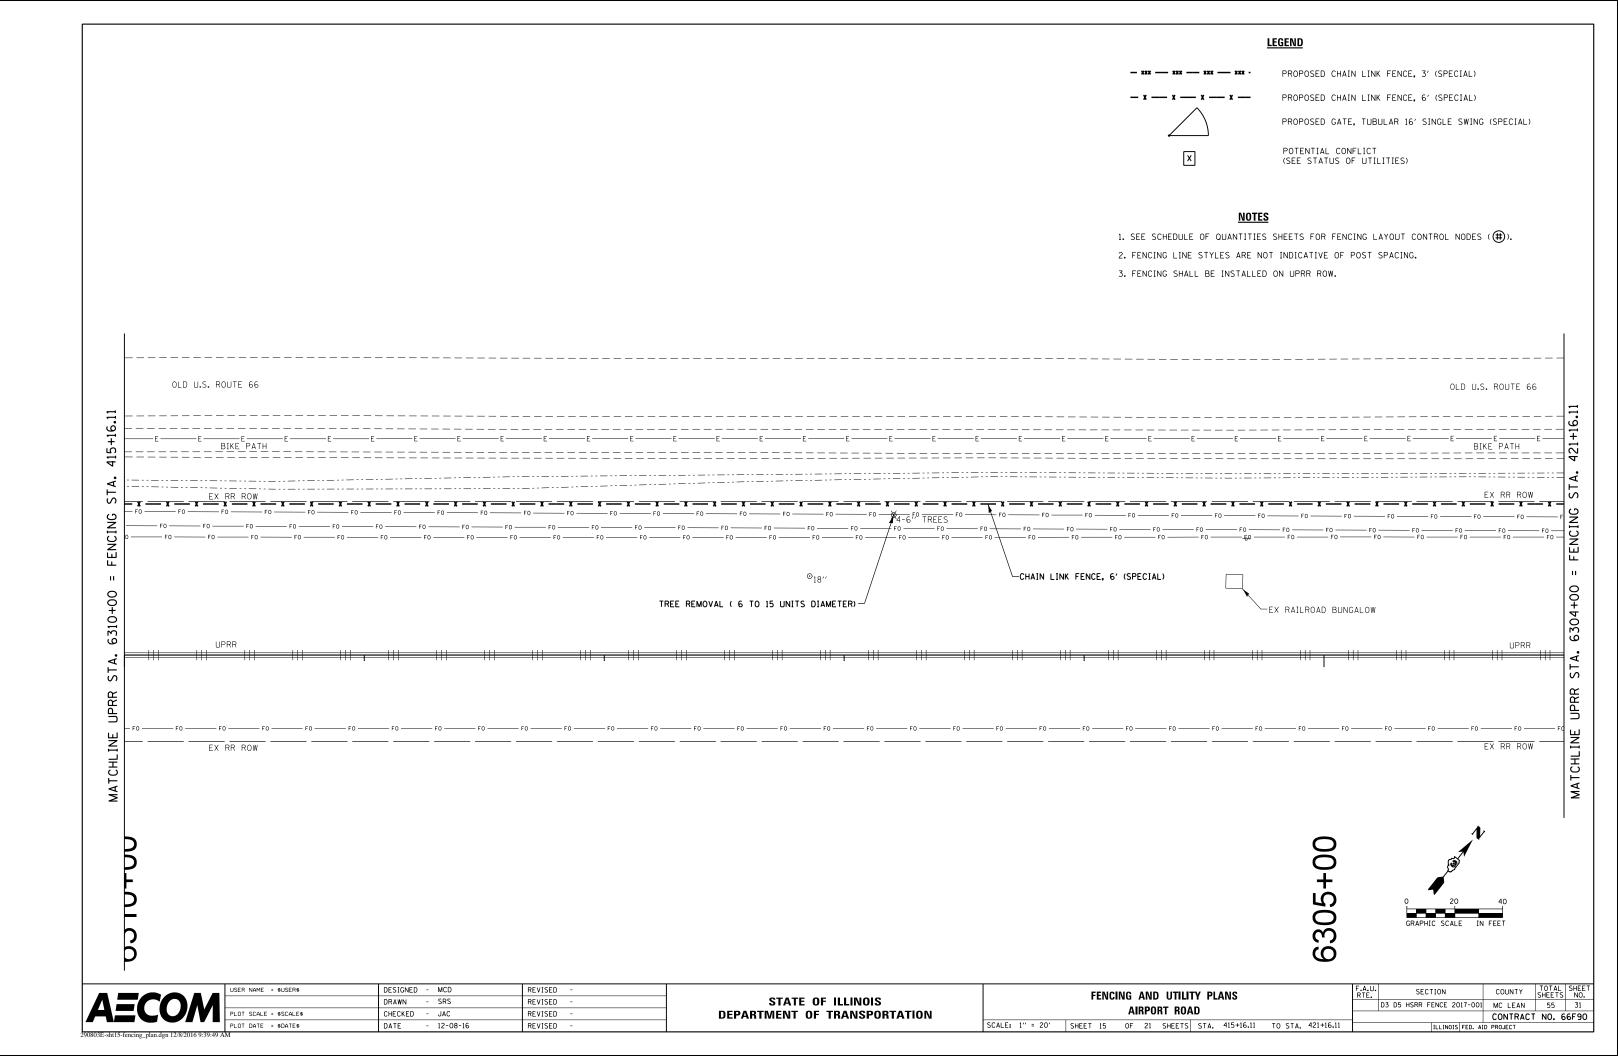



<u>LEGEND</u> PROPOSED CHAIN LINK FENCE, 3' (SPECIAL) PROPOSED CHAIN LINK FENCE, 6' (SPECIAL) PROPOSED GATE, TUBULAR 16' SINGLE SWING (SPECIAL) POTENTIAL CONFLICT (SEE STATUS OF UTILITIES) X <u>NOTES</u> 1. SEE SCHEDULE OF QUANTITIES SHEETS FOR FENCING LAYOUT CONTROL NODES (#). 2. FENCING LINE STYLES ARE NOT INDICATIVE OF POST SPACING. 3. FENCING SHALL BE INSTALLED ON UPRR ROW. **CONTROL NODES** 23 425+80.03 426+00.03 OLD U.S. ROUTE 66 OLD U.S. ROUTE 66 STA. FENCING 10'' & 15''-CHAIN LINK FENCE, 6' (SPECIAL)-6298+00 6304+00 TREE REMOVAL (6 TO 15" UNITS DIAMETER) -TREE REMOVAL (6 TO 15" UNITS DIAMETER) TREE REMOVAL (OVER 15" UNITS DIAMETER) STA. UPRR UPRR MATCHLINE MATCHLINE EX RR ROW SECTION COUNTY TOTAL SHEETS NO.


D3 D5 HSRR FENCE 2017-001 MC LEAN 55 32 USER NAME = \$USER\$ DESIGNED - MCD REVISED FENCING AND UTILITY PLANS STATE OF ILLINOIS DRAWN - SRS REVISED AIRPORT ROAD CHECKED - JAC REVISED **DEPARTMENT OF TRANSPORTATION** SCALE: 1" = 20' SHEET 16 OF 21 SHEETS STA. 421+16.11 TO STA. 427+18.79 DATE - 12-08-16 REVISED


<u>LEGEND</u> PROPOSED CHAIN LINK FENCE, 3' (SPECIAL) PROPOSED CHAIN LINK FENCE, 6' (SPECIAL) PROPOSED GATE, TUBULAR 16' SINGLE SWING (SPECIAL) POTENTIAL CONFLICT (SEE STATUS OF UTILITIES) x **NOTES** 1. SEE SCHEDULE OF QUANTITIES SHEETS FOR FENCING LAYOUT CONTROL NODES (#). 2. FENCING LINE STYLES ARE NOT INDICATIVE OF POST SPACING. 3. FENCING SHALL BE INSTALLED ON UPRR ROW. OLD U.S. ROUTE 66 OLD U.S. ROUTE 66 CHAIN LINK FENCE, 6' (SPECIAL) 6292+00 STA. UPRR MATCHLINE EX RR ROW 6295+00 SECTION COUNTY TOTAL SHEETS NO.


D3 D5 HSRR FENCE 2017-001 MC LEAN 55 33 USER NAME = \$USER\$ DESIGNED - MCD REVISED FENCING AND UTILITY PLANS STATE OF ILLINOIS DRAWN - SRS REVISED AIRPORT ROAD CHECKED - JAC REVISED **DEPARTMENT OF TRANSPORTATION** CONTRACT NO. 66F90 SCALE: 1" = 20' SHEET 17 OF 21 SHEETS STA. 427+18.79 TO STA. 433+18.79 DATE - 12-08-16 REVISED

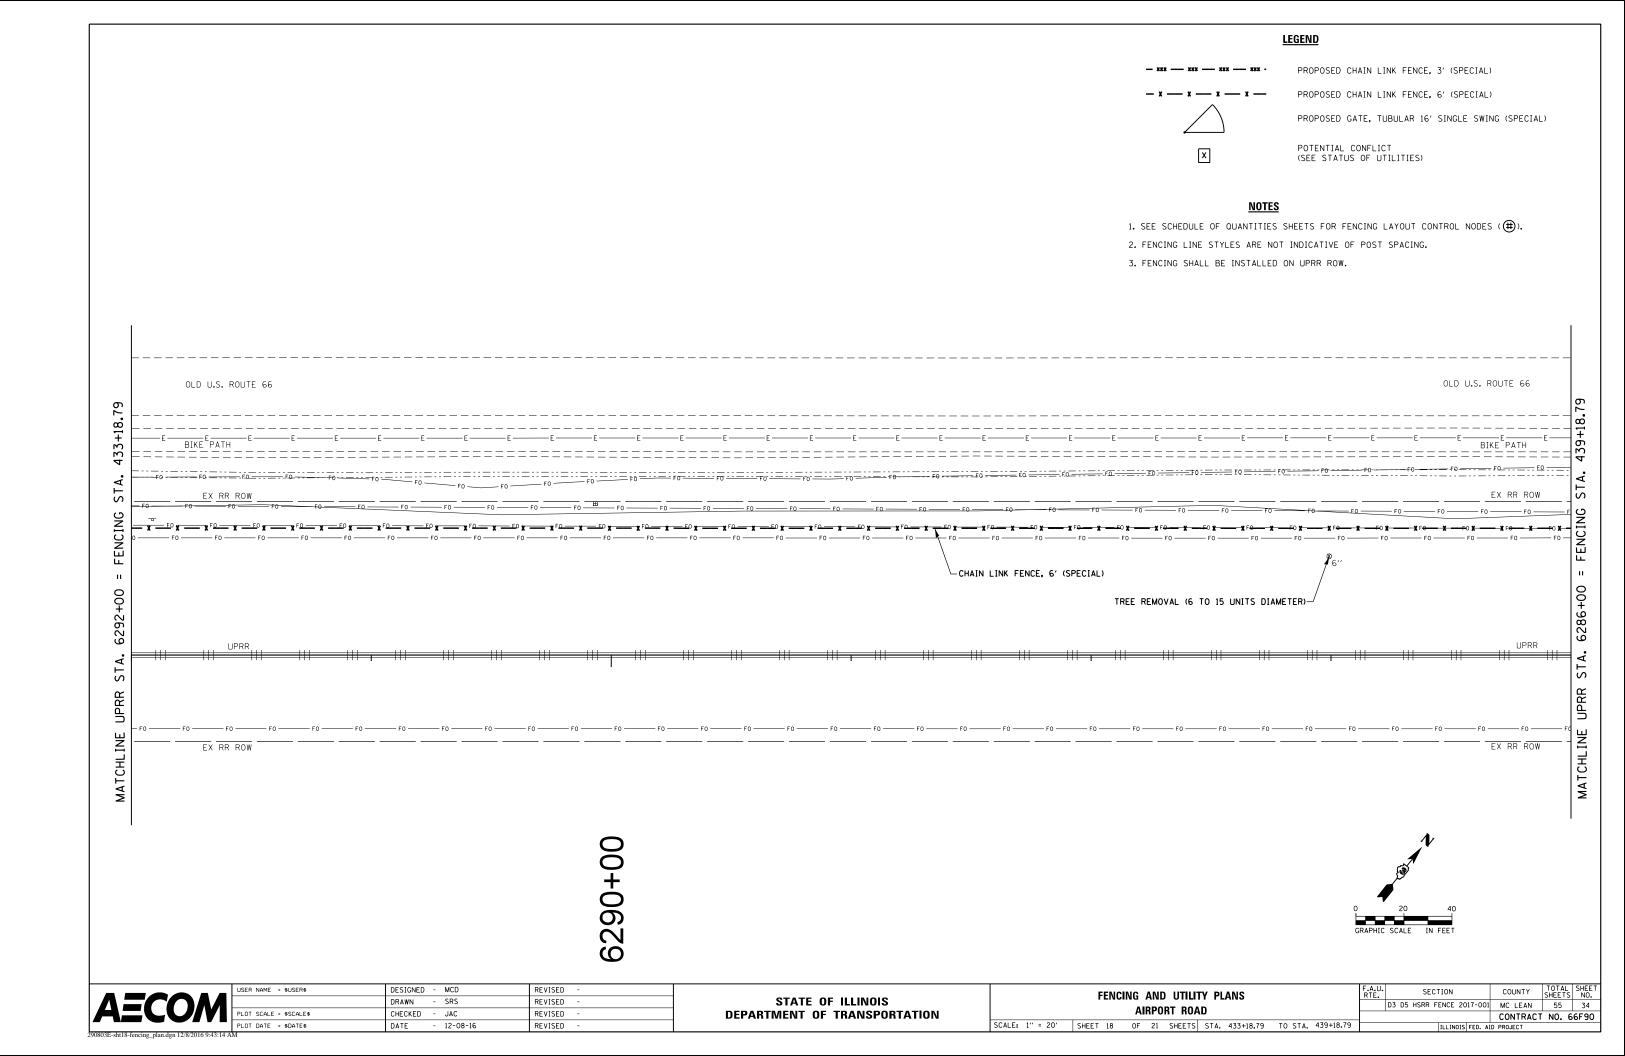


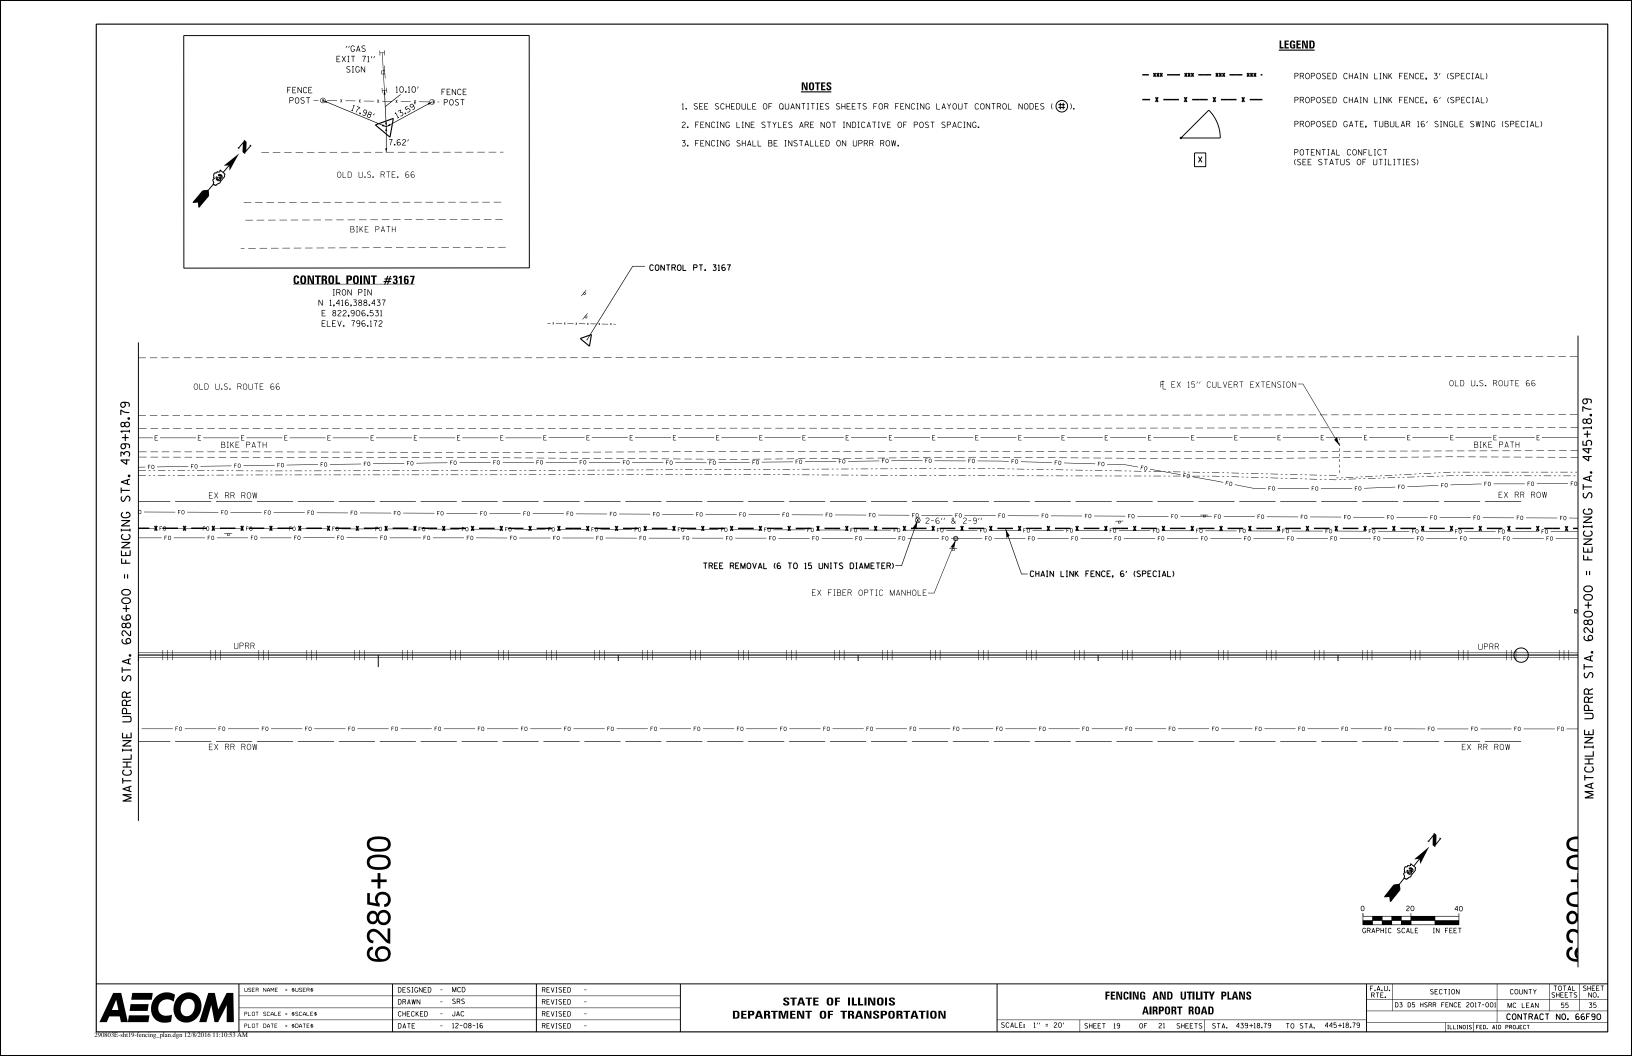


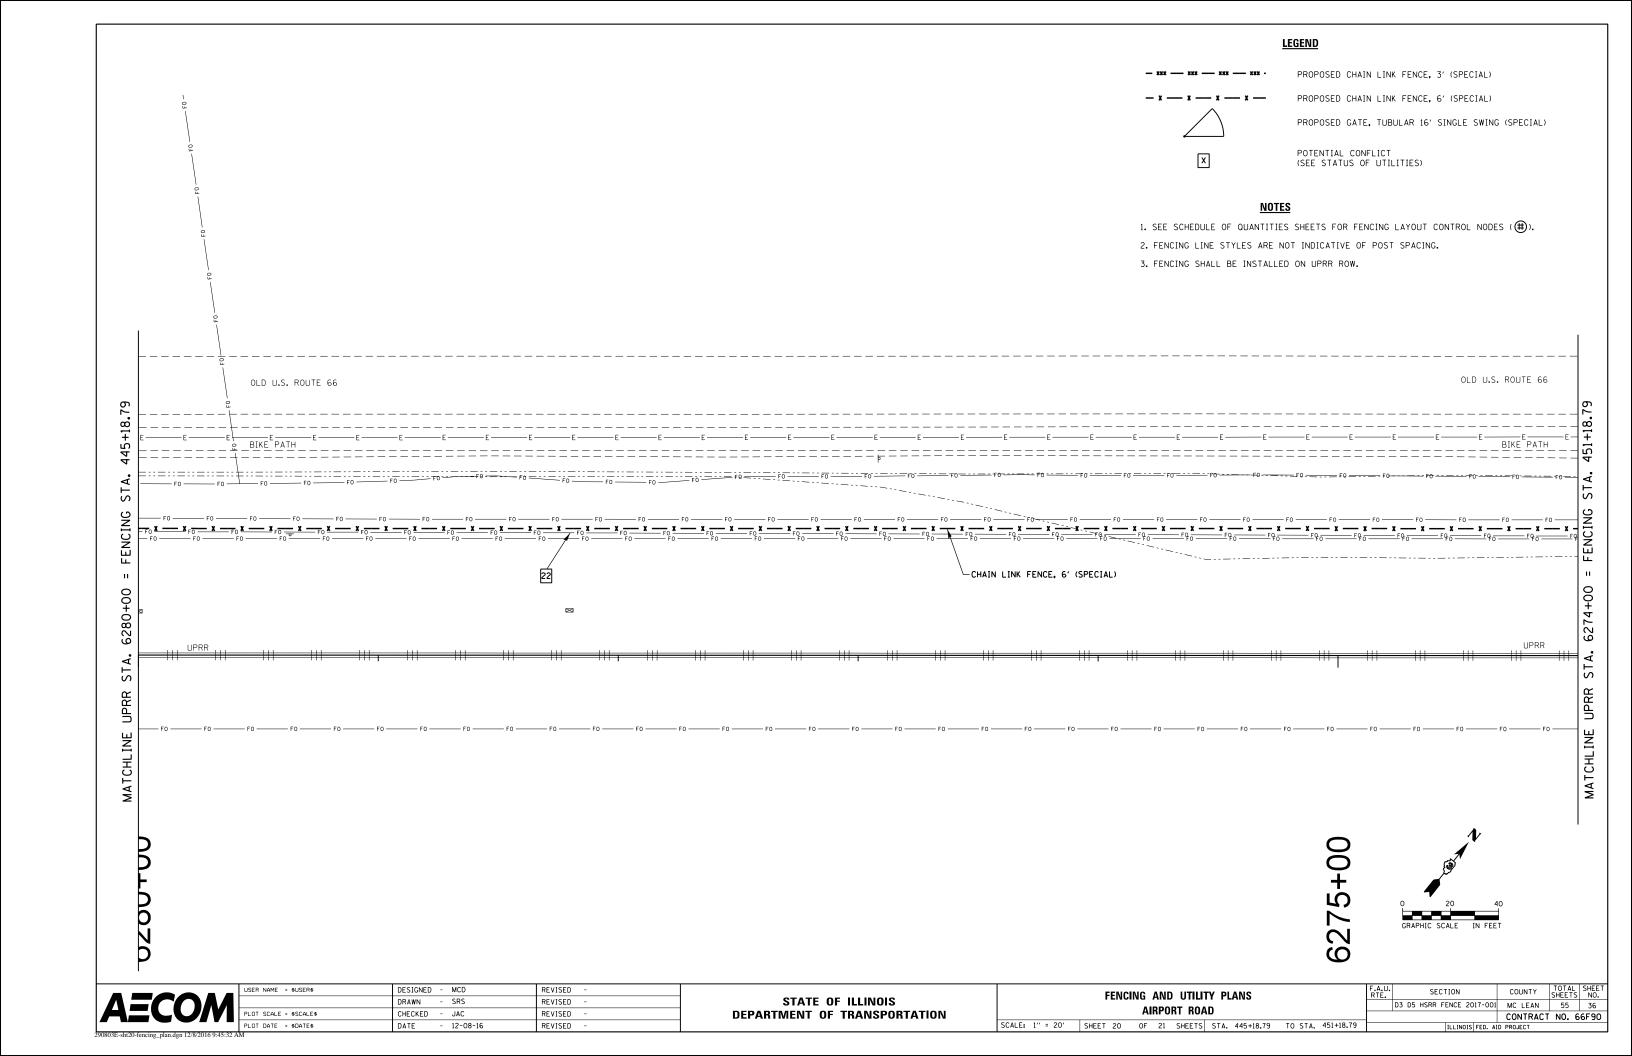


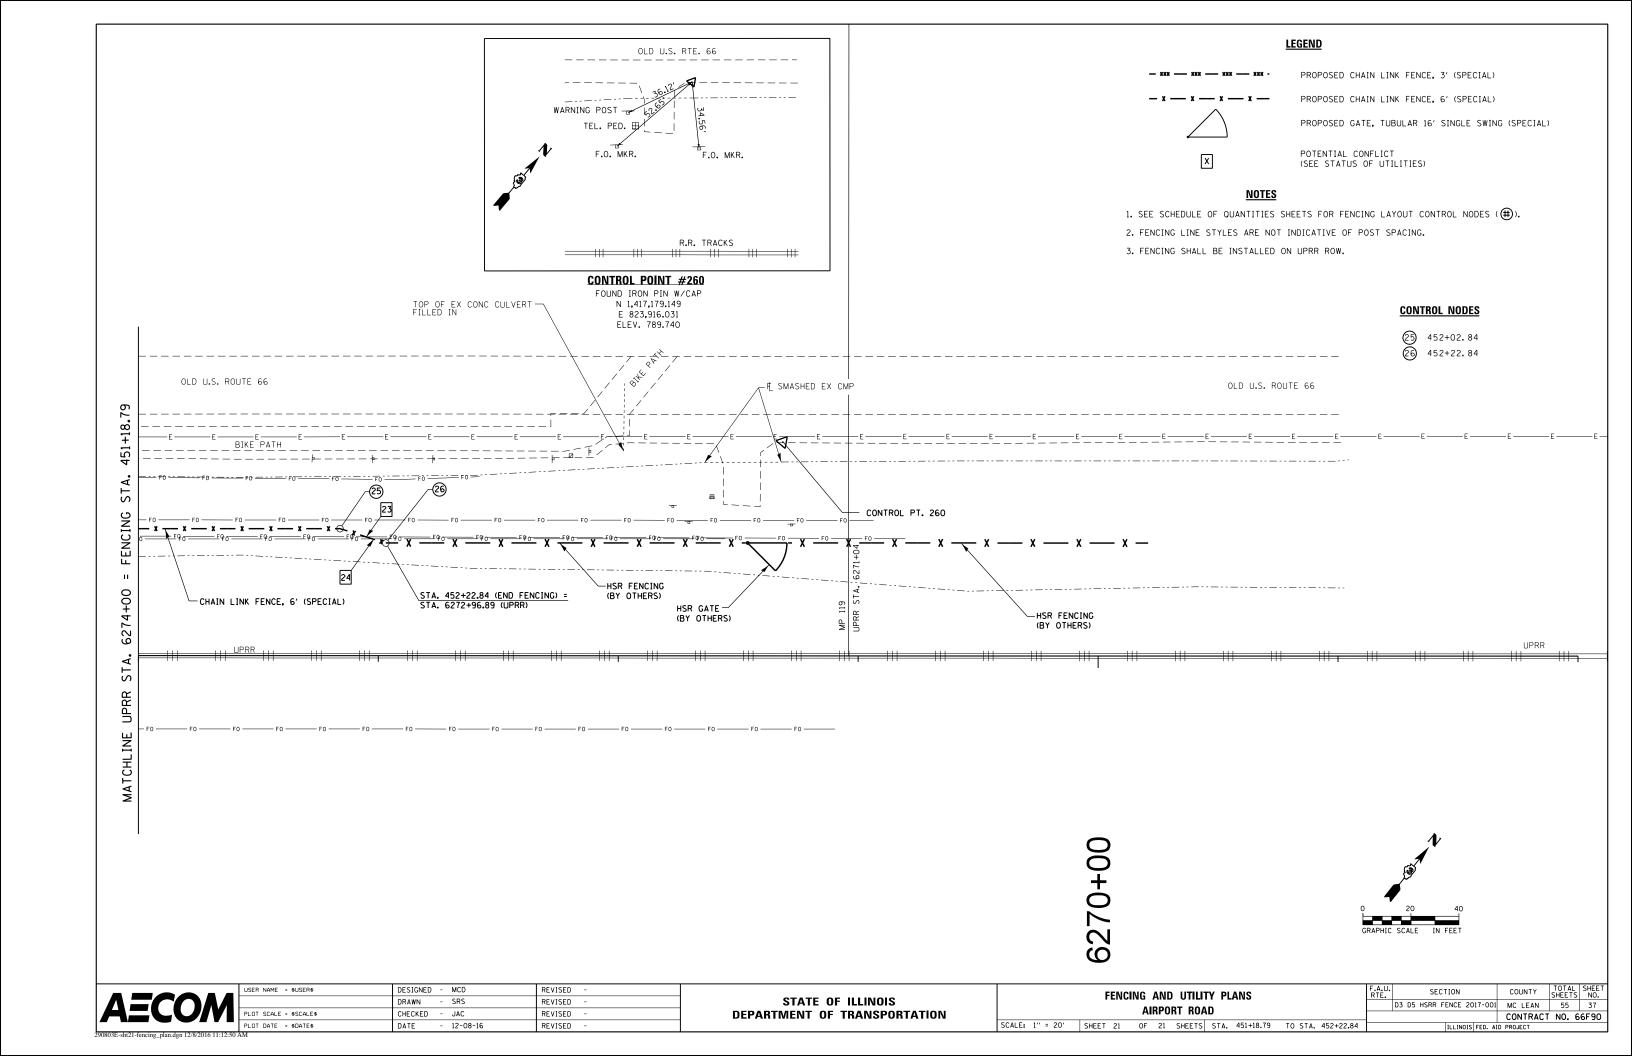

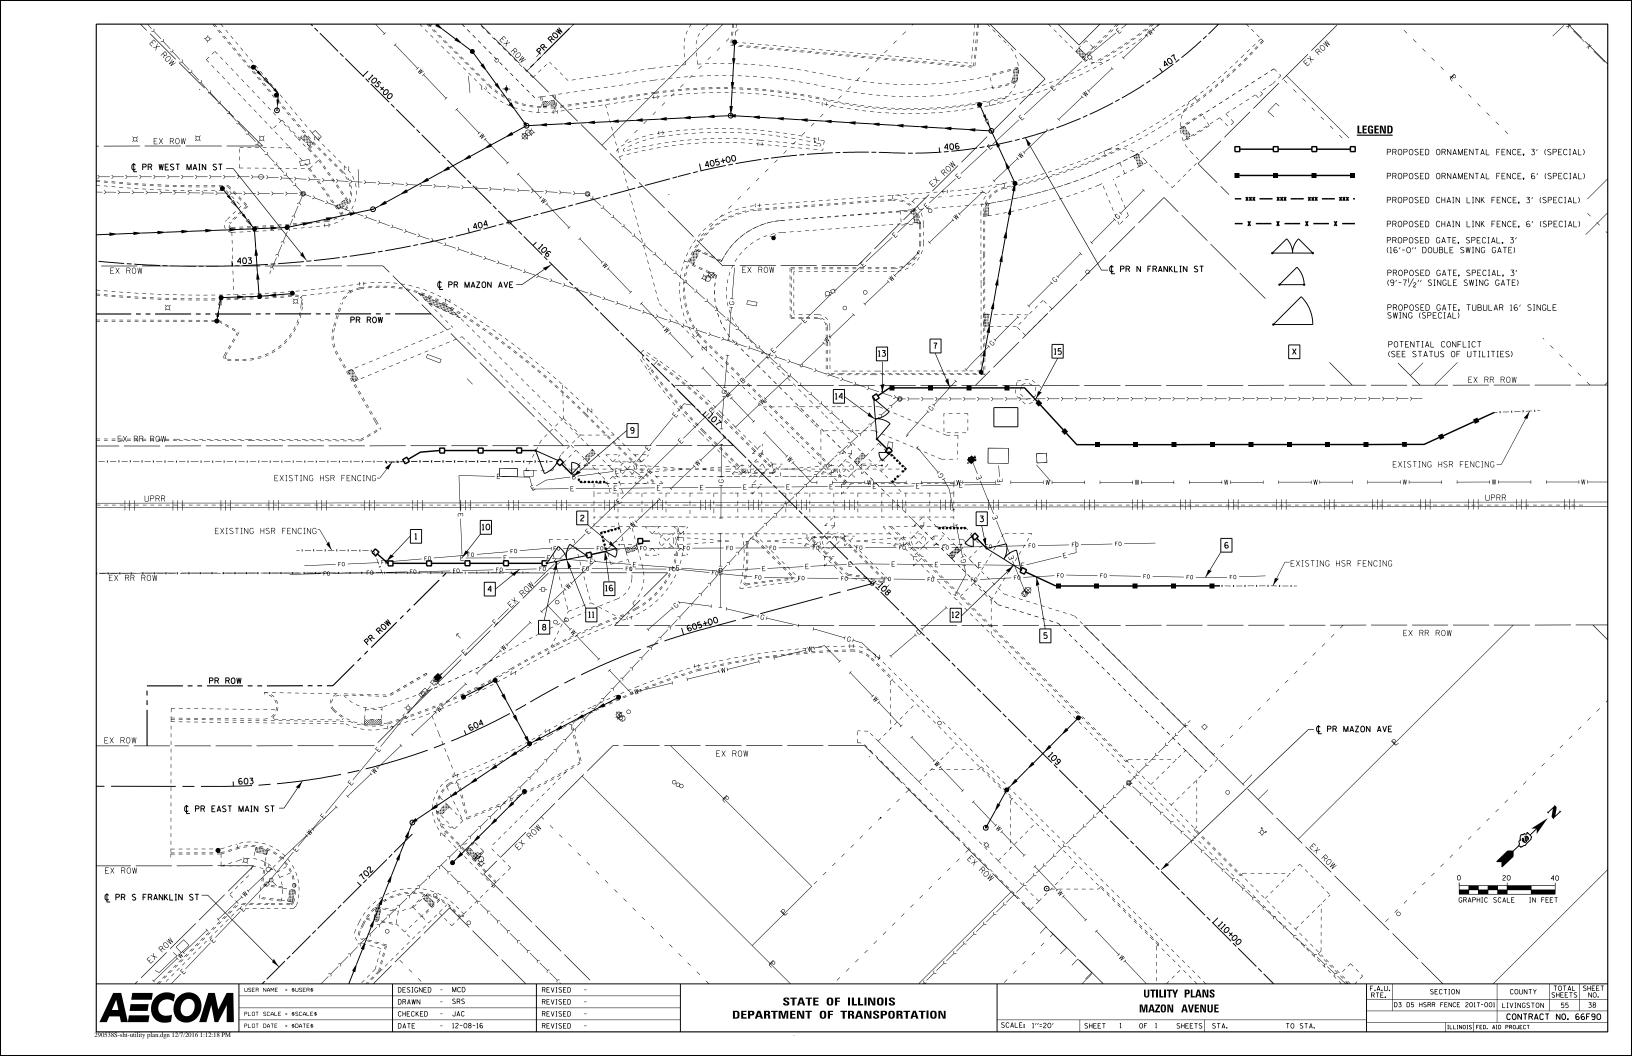

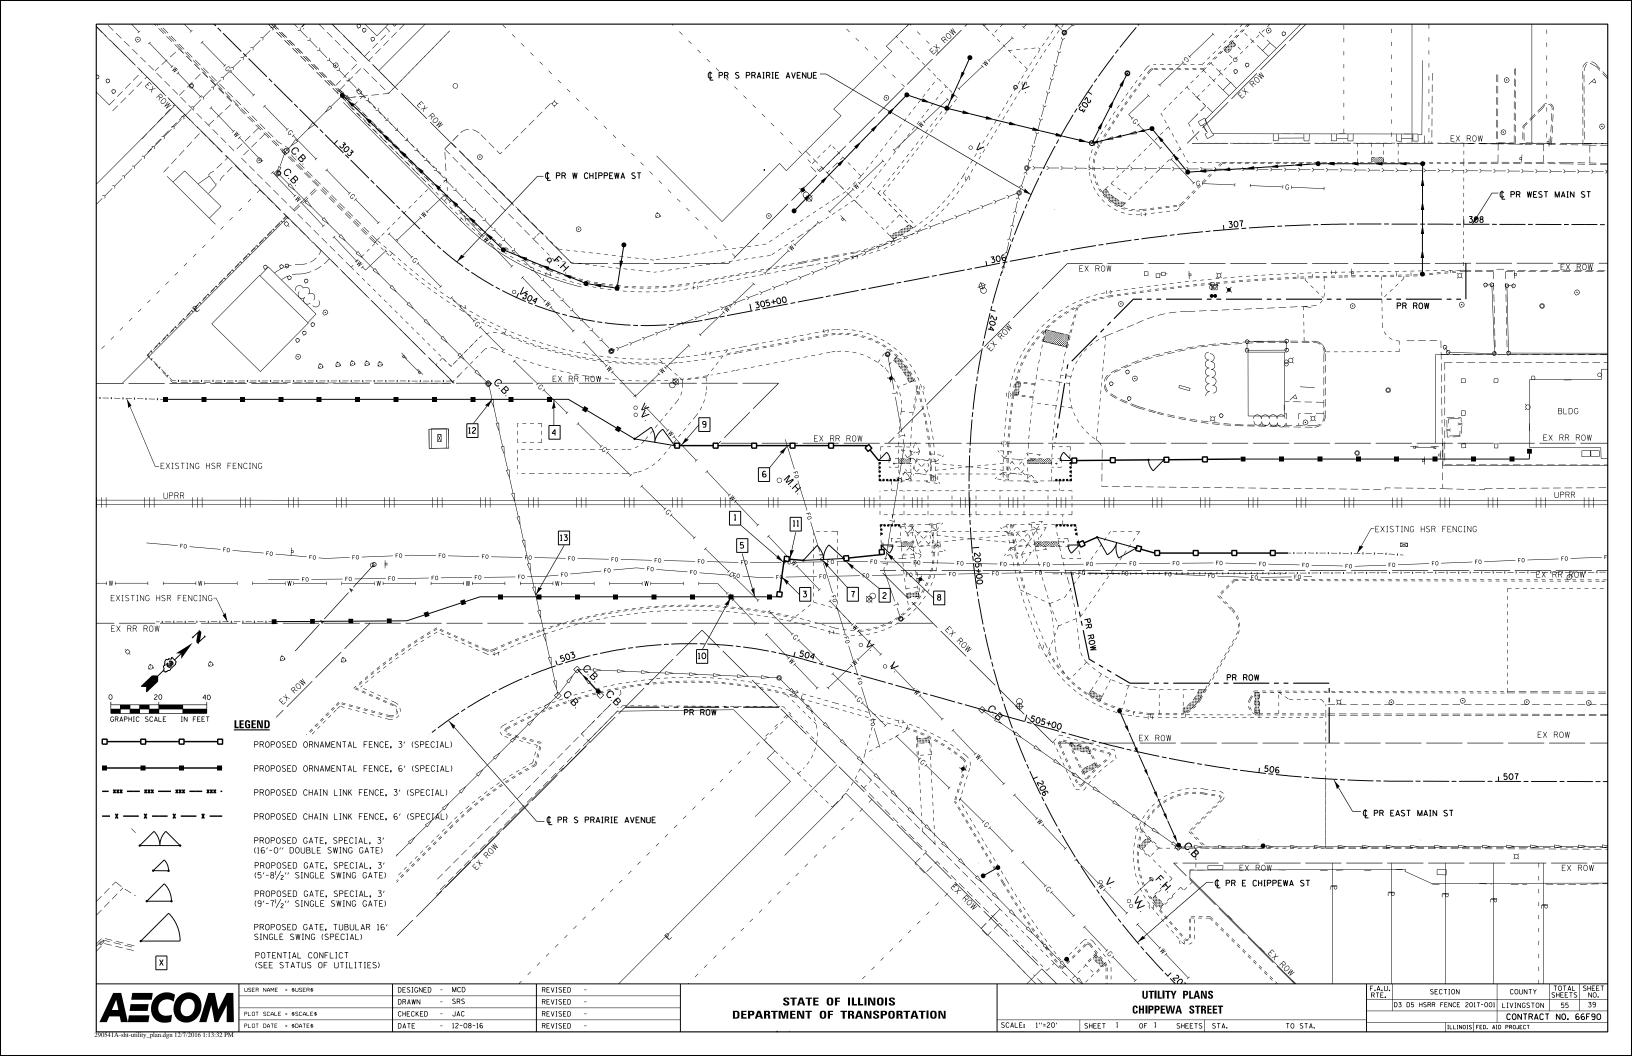

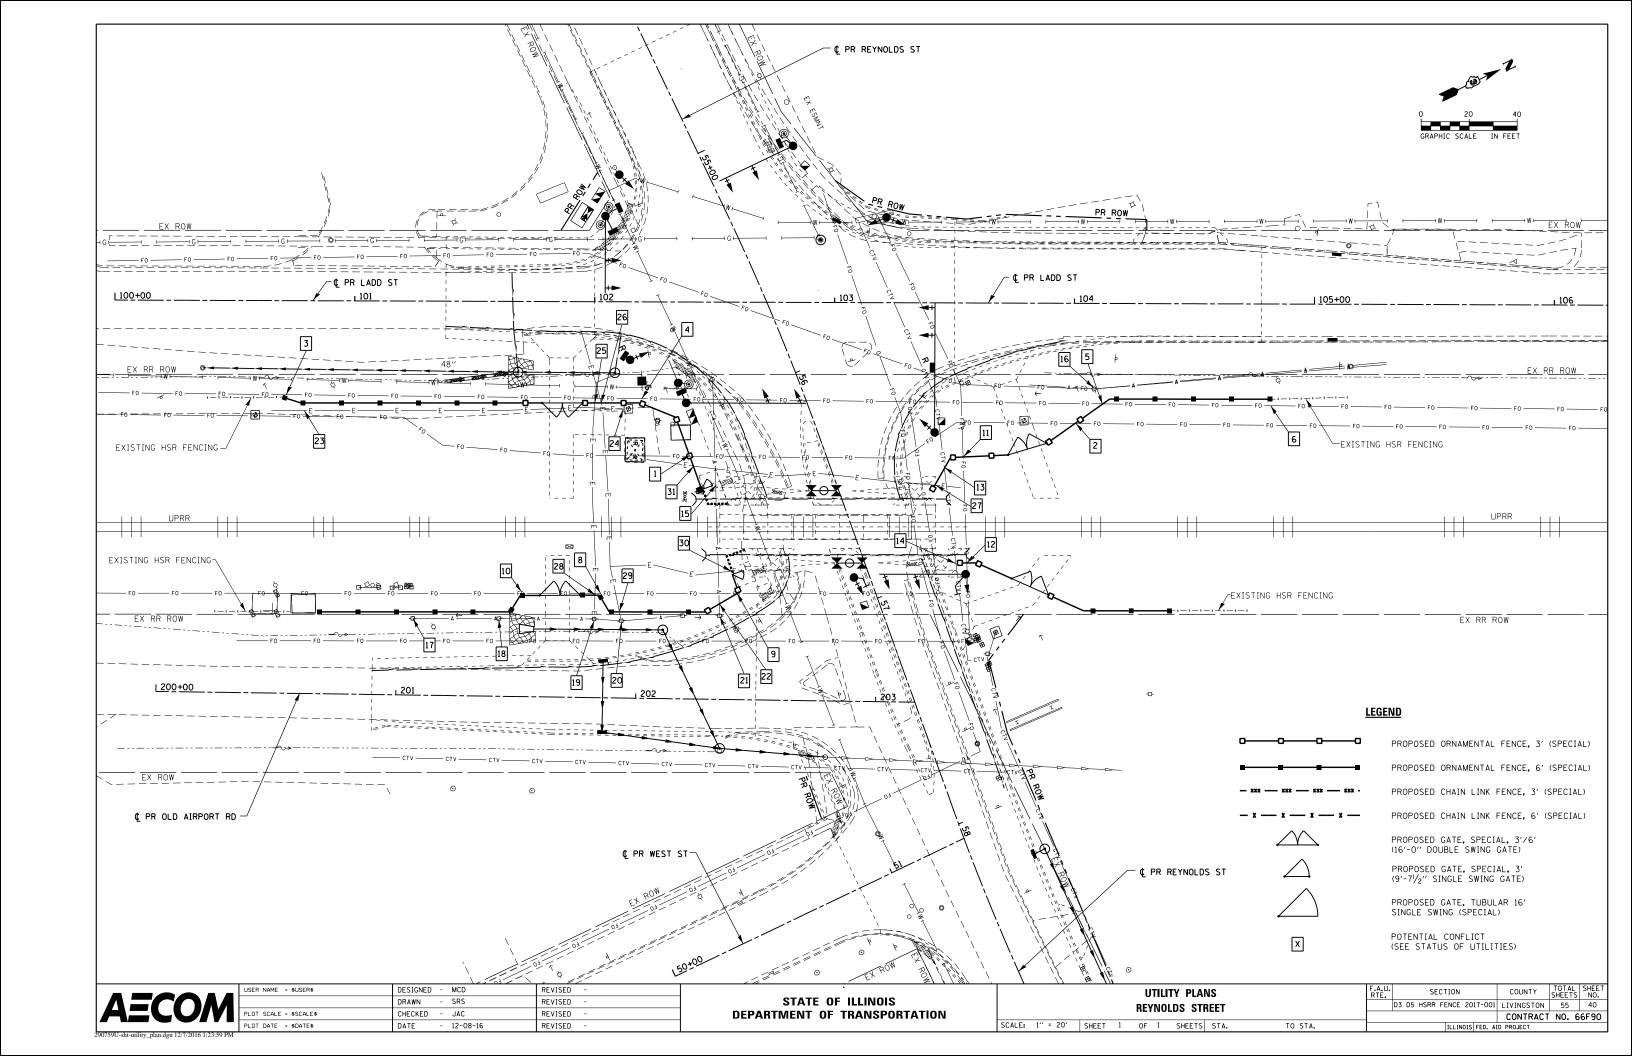

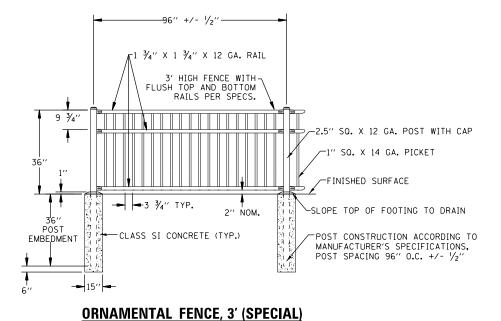


NOT TO SCALE

FOOTING DEPTH BELOW POST (D)

FENCE WIND EXPOSURE B WIND EXPOSURE C

FENCE, SPECIAL, 6' 12" 24"

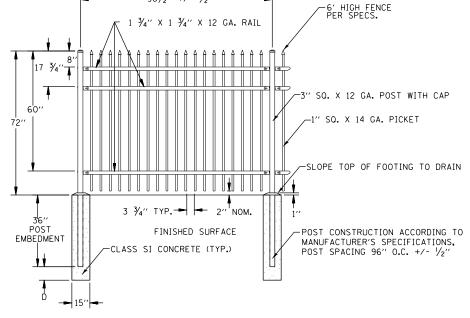

ORNAMENTAL FENCE, 6' (SPECIAL)

—96½'' +/- ½''—

NOT TO SCALE


NOTE: I.) PORTIONS OF FENCE DRAWING IMAGES AS PROVIDED BY AMERISTAR.



USER NAME = \$USER\$	DESIGNED	-	MCD	REVISED -
	DRAWN	-	SRS	REVISED -
PLOT SCALE = \$SCALE\$	CHECKED	-	JAC	REVISED -
PLOT DATE = \$DATE\$	DATE	-	12-08-16	REVISED -

STATE OF ILLINOIS							
DEPARTMENT	0F	TRANSPORTATION					


	MICCELLANGULO FENGINO DETAILO	F.A.U. SECTION COUNTY TOTAL SHEET NO.
	MISCELLANEOUS FENCING DETAILS	D3 D5 HSRR FENCE 2017-001 55 41
		CONTRACT NO. 66F90
SCALE: NTS	SHEET 1 OF 15 SHEETS STA. TO STA.	ILLINOIS FED. AID PROJECT

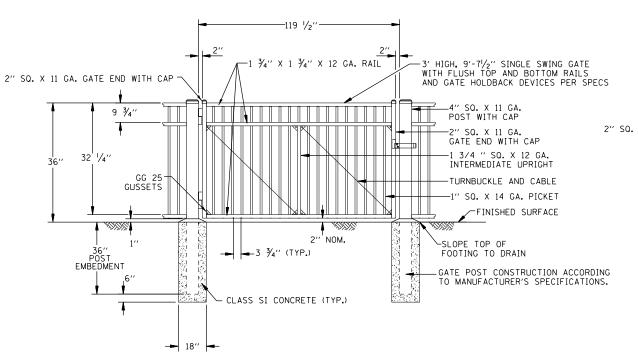

GATE, SPECIAL, 3' (9'-7 1/2" SINGLE SWING GATE)

NOT TO SCALE

- NOTE:
 1.) RAILROAD WILL FURNISH PAD LOCK.
 2.) NO DIG GATE HOLDBACK DEVICE (1 EACH PER SWING GATE SECTION) TO BE INSTALLED INSIDE FENCE LIMITS. SPECIFIC LOCATIONS FOR GATE HOLDBACK DEVICE AT GATE LOCATIONS WHICH COULD HAVE AN IMPACT ON THE AMOUNT OF HORIZONTAL CLEARANCE TO TRACK CENTERLINE TO BE PROVIDED BY THE ENGINEER IN THE FIELD TO ENSURE PROPER HORIZONTAL CLEARANCE IS PROVIDED TO TRACK CENTERLINE FROM GATE WHEN IN THE OPEN POSITION. MINIMIM HORIZONTAL DISTANCE FROM TRACK WHEN IN THE OPEN POSITION. MINIMUM HORIZONTAL DISTANCE FROM TRACK CENTERLINE TO ANY PORTION OF A GATE WHEN IN THE OPEN POSITION IS TEN (10) FOOT.
- ADJUST GRADES AS REQUIRED TO ENSURE A MAXIMUM GAP OF TWELVE (12) INCHES BENEATH ANY PORTION OF GATE AND TO PROVIDE A FULL UNOBSTRUCTED RANGE OF TRAVEL BETWEEN GATE CLOSED AND OPEN POSITION.

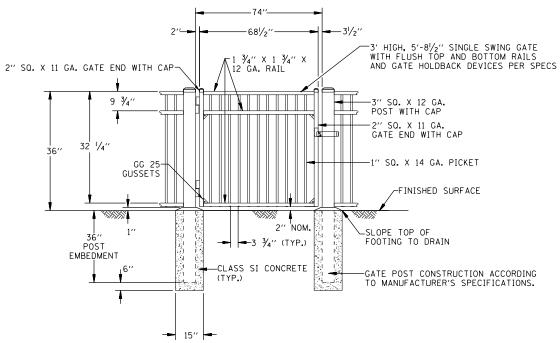


GATE, SPECIAL, 3' (5'-8 1/2" SINGLE SWING GATE)



- RAILROAD WILL FURNISH PAD LOCK.
- NO DIG GATE HOLDBACK DEVICE (I EACH PER SWING GATE SECTION) TO BE INSTALLED INSIDE FENCE LIMITS. SPECIFIC LOCATIONS FOR GATE HOLDBACK DEVICE AT GATE LOCATIONS WHICH COULD HAVE AN IMPACT ON THE AMOUNT OF HORIZONTAL CLEARANCE TO TRACK CENTERLINE TO BE PROVIDED BY THE ENGINEER IN THE FIELD TO ENSURE PROPER HORIZONTAL CLEARANCE IS PROVIDED TO TRACK CENTERLINE FROM GATE WHEN IN THE OPEN POSITION. MINIMUM HORIZONTAL DISTANCE FROM TRACK CENTERLINE TO ANY PORTION OF A GATE WHEN IN THE OPEN POSITION
- IS TEN (10) FOOT.


 ADJUST GRADES AS REQUIRED TO ENSURE A MAXIMUM GAP OF TWELVE (12) INCHES BENEATH ANY PORTION OF GATE AND TO PROVIDE A FULL UNOBSTRUCTED RANGE OF TRAVEL BETWEEN GATE CLOSED AND OPEN POSITION.

PORTIONS OF GATE DRAWING IMAGES AS PROVIDED BY AMERISTAR.

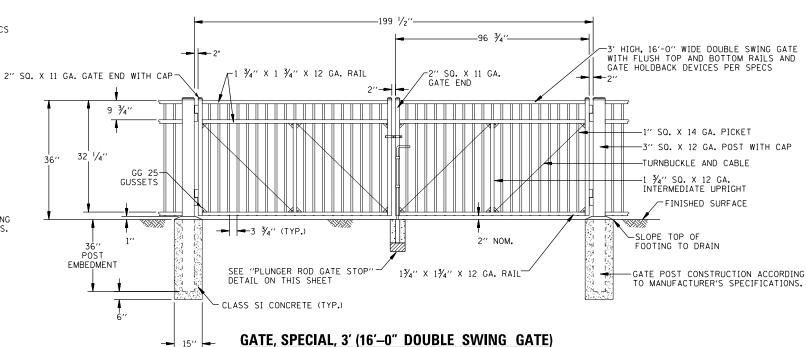

- TE:
 RAILROAD WILL FURNISH PAD LOCK.
 NO DIG GATE HOLDBACK DEVICE (1 EACH PER SWING GATE SECTION) TO
 BE INSTALLED INSIDE FENCE LIMITS. SPECIFIC LOCATIONS FOR GATE
 HOLDBACK DEVICE AT GATE LOCATIONS WHICH COULD HAVE AN IMPACT
 ON THE AMOUNT OF HORIZONTAL CLEARANCE TO TRACK CENTERLINE
 TO BE PROVIDED BY THE ENGINEER IN THE FIELD TO ENSURE PROPER
 HORIZONTAL CLEARANCE IS PROVIDED TO TRACK CENTERLINE FROM
 GATE WHEN IN THE OPEN POSITION, MINIMUM HORIZONTAL DISTANCE
 FROM TRACK CENTERLINE TO ANY PORTION OF A GATE WHEN IN THE
 OPEN POSITION IS TEN (10) FOOT.
- OPEN POSITION IS TEN (10) FOOT.

 ADJUST GRADES AS REQUIRED TO ENSURE A MAXIMUM GAP OF TWELVE (12) INCHES BENEATH ANY PORTION OF GATE AND TO PROVIDE A FULL UNOBSTRUCTED RANGE OF TRAVEL BETWEEN GATE CLOSED AND OPEN POSITION.

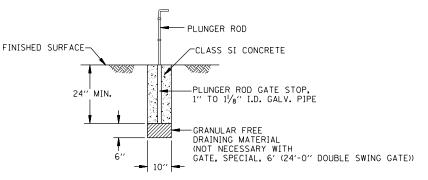


PLUNGER ROD GATE STOP

NOT TO SCALE

USER NAME = \$USER\$ DESIGNED - MCD REVISED DRAWN - SRS REVISED CHECKED REVISED PLOT DATE = \$DATE\$ REVISED DATE - 12-08-16

STATE OF ILLINOIS **DEPARTMENT OF TRANSPORTATION**

SECTION MISCELLANEOUS FENCING DETAILS D3 D5 HSRR FENCE 2017-001 55 42 CONTRACT NO. 66F90 SCALE: NTS SHEET 2 OF 15 SHEETS STA.

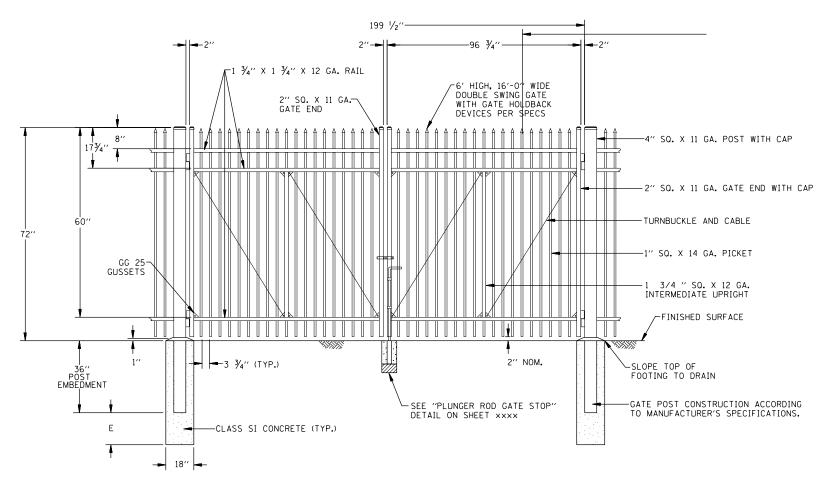

GATE, SPECIAL, 6' (16'-0" DOUBLE SWING GATE)

NOT TO SCALE

FOOTING DEPTH BELOW POST (E)								
GATE WIND EXPOSURE B WIND EXPOSURE								
GATE, SPECIAL, 6'	24′′	36′′						

- NOTE:
 1.) RAILROAD WILL FURNISH PAD LOCK.
 2.) NO DIG GATE HOLDBACK DEVICE (I EACH PER SWING GATE SECTION) TO BE INSTALLED INSIDE FENCE LIMITS. SPECIFIC LOCATIONS FOR GATE HOLDBACK DEVICE AT GATE LOCATIONS WHICH COULD HAVE AN IMPACT ON THE AMOUNT OF HORIZONTAL CLEARANCE TO TRACK CENTERLINE TO BE PROVIDED BY THE ENGINEER IN THE FIELD TO ENSURE PROPER HORIZONTAL CLEARANCE IS PROVIDED TO TRACK CENTERLINE FROM GATE WHEN IN THE OPEN POSITION. MINIMUM HORIZONTAL DISTANCE FROM TRACK CENTERLINE TO ANY PORTION OF A GATE WHEN IN THE OPEN POSITION IS TEN (10) FOOT.
- IS TEN (10) FOOT.


 ADJUST GRADES AS REQUIRED TO ENSURE A MAXIMUM GAP OF TWELVE (12) INCHES BENEATH ANY PORTION OF GATE AND TO PROVIDE A FULL UNOBSTRUCTED RANGE OF TRAVEL BETWEEN GATE CLOSED AND OPEN POSITION.

NOTE:
1.) PORTIONS OF GATE DRAWING IMAGES AS PROVIDED BY AMERISTAR.

		USER NAME = \$USER\$	DESIGNED - MCD	REVISED -						
	$\Lambda = C \cap \Lambda \Lambda$		DRAWN - SRS	REVISED -						
	AECUMI	PLOT SCALE = \$SCALE\$	CHECKED - JAC	REVISED -						
		PLOT DATE = \$DATE\$	DATE - 12-08-16	REVISED -						
1	District 3_HSR Fencing Misc Detail Sheets_IDOT.dgn 12/7/2016 1:29:32 PM									


STATE (OF ILLINOIS
DEPARTMENT O	TRANSPORTATION

	l I I						F.A.U. RTE.	SE	CTION		COUNTY	TOTAL SHEETS	SHEET NO.			
	MISCELLANEOUS FENCING DETAILS								D3 D5 HSRR	FENCE 2	2017-001		55	43		
												CONTRACT	NO.	56F90		
	SCALE:	NTS	SHEET	3	OF	15	SHEETS	STA.	TO STA.			ILL INO	IS FED. AI	D PROJECT		

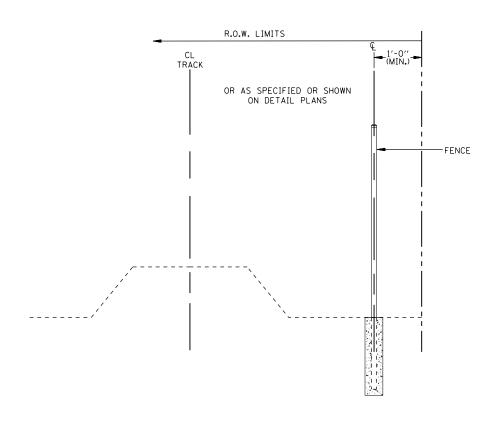


FENCE LOCATION ALONG R.O.W. LIMITS

NOT TO SCALE

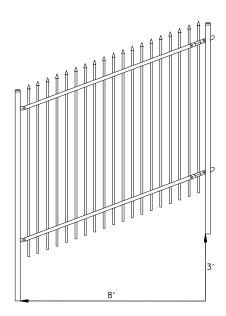


FENCE PANEL FLEXIBILITY

NOT TO SCALE

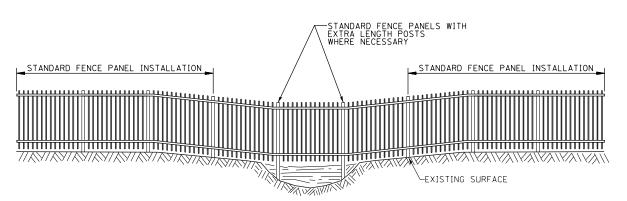

ELEVATION ORNAMENTAL FENCE INSTALLATION OVER SWALE / DITCH

NOT TO SCALE

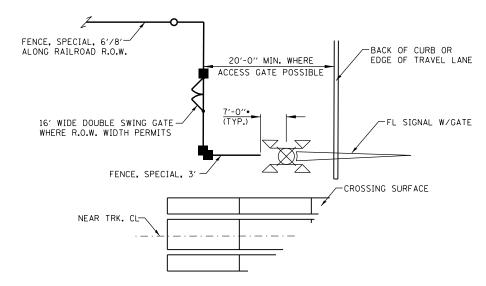

PLAN VIEW AT FL SIGNAL WITHOUT SIDEWALK

NOT TO SCALE

•7'-0" DISTANCE MUST BE MAINTAINED

NOTE: ADJUSTMENTS TO THE FENCE INSTALLATION MAY BE NECESSARY BASED ON SPECIFIC SITE CONDITIONS, BUT IN NO CASE SHALL ANY SECTION OF FENCE OR A FENCE POST BE INSTALLED CLOSER THAN 2.5 FEET FROM ANY PORTION OF THE RAILROAD GATE COUNTERWEIGHT ASSEMBLY WHEN THE GATE IS IN RAISED OR LOWERED POSITION.

NOTE:
1.) PORTIONS OF FENCE DRAWING IMAGE AS PROVIDED BY AMERISTAR.


SCALE: NTS




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	DRAWN - SRS	REVISED -
PLOT SCALE = \$SCALE\$	CHECKED - JAC	REVISED -
PLOT DATE = \$DATE\$	DATE - 12-08-16	REVISED -
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STATE OF	ILLINOIS
DEPARTMENT OF 1	TRANSPORTATION

					F.A.U. RTE.	SECTION		COUNTY	TOTAL SHEETS	SHEET NO.		
MISCELLANEOUS FENCING DETAILS							D3 D5 HSRR FENCE	2017-001		55	44	
										CONTRACT	NO.	66F90
	SHEET 4	OF	15	SHEETS	STA.	TO STA.		TLLIN	DIS FED AT	D PROJECT		

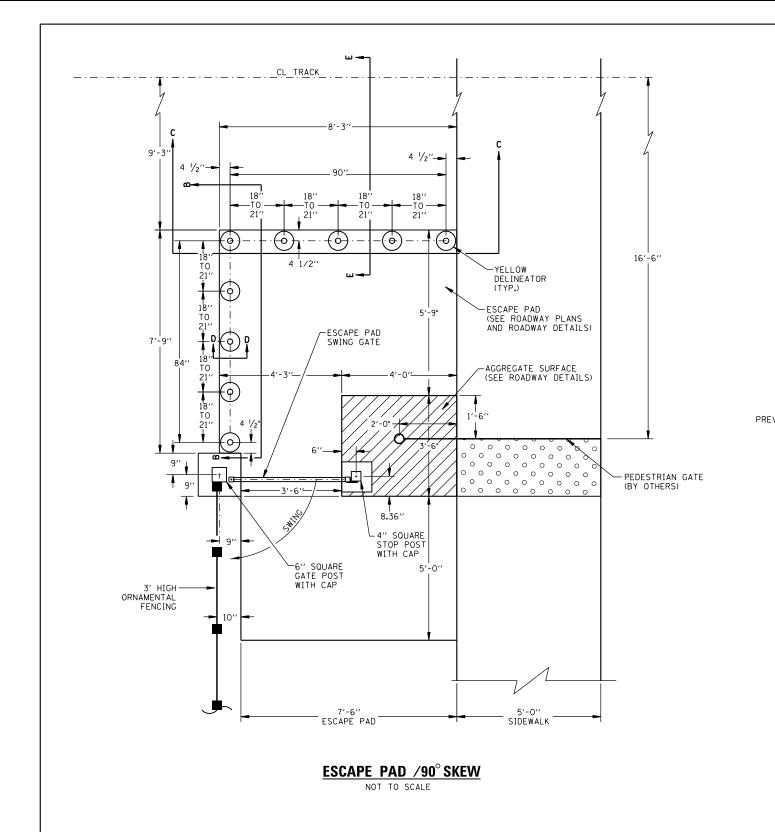

NOTE: AT SKEWED CROSSINGS THE NUMBER OF
DELINEATORS REQUIRED WILL VARY. DELINEATORS
TO BE EQUALLY SPACED ALONG THE OUTSIDE EDGE
OF THE ESCAPE PAD. ENSURE THAT A DELINEATOR
IS LOCATED IN THE CORNER OF THE ESCAPE PAD
AS SHOWN ABOVE. THE REMAINDER OF DELINEATORS
TO BE EQUALLY SPACED BETWEEN THIS CORNER
DELINEATOR AND THE BECINNING AND ENDING DELINEATOR AND THE BEGINNING AND ENDING DELINEATORS, NOT TO EXCEED TWENTY-ONE (21) INCHES.

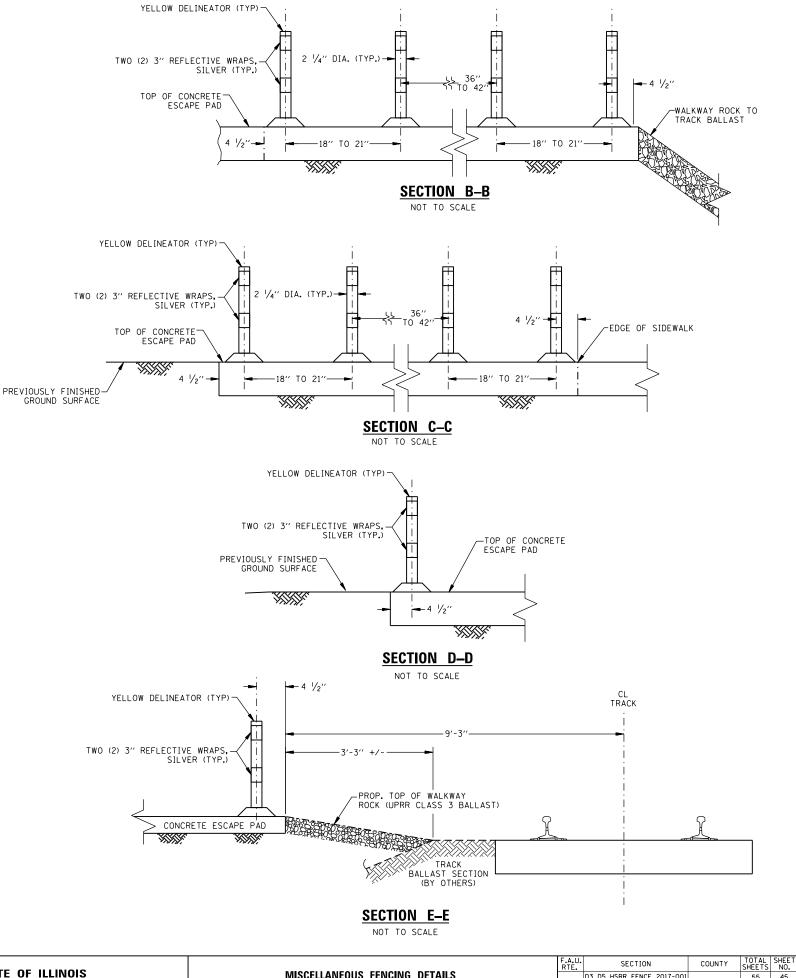



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			DRAWN	-	SRS	REVISED	-
		PLOT SCALE = \$SCALE\$	CHECKED	-	JAC	REVISED	-
		PLOT DATE = \$DATE\$	DATE	-	12-08-16	REVISED	-
D	istrict 3_HSR Fencing Misc Detail Sheets_IDOT.dgn	12/7/2016 1:30:06 PM					


DESTONED - MOD

									RTE.	SE	CTION	COUNTY	SHEETS	S NO.
MISCELLANEOUS FENCING DETAILS										D3 D5 HSRR	FENCE 2017-001		55	45
												CONTRACT	NO.	66F90
SCALE:	NTS	SHEET	5	OF	15	SHEETS	STA.	TO STA.	ILLINOIS FED. AID PROJEC					



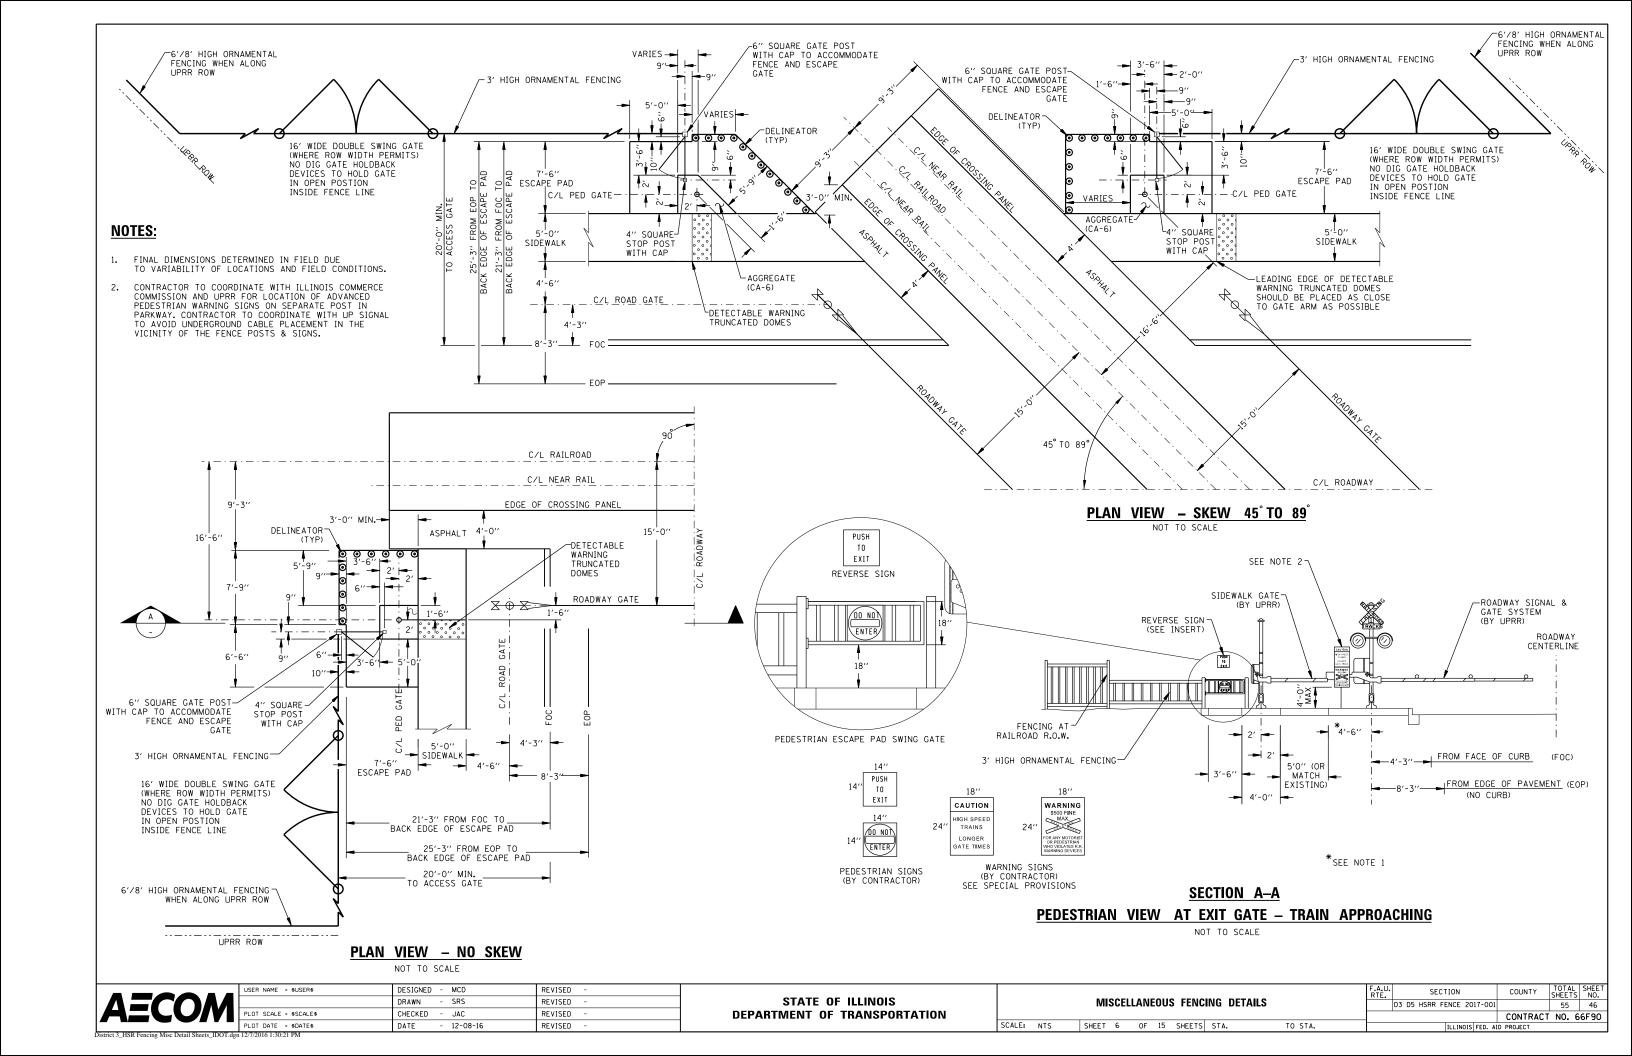

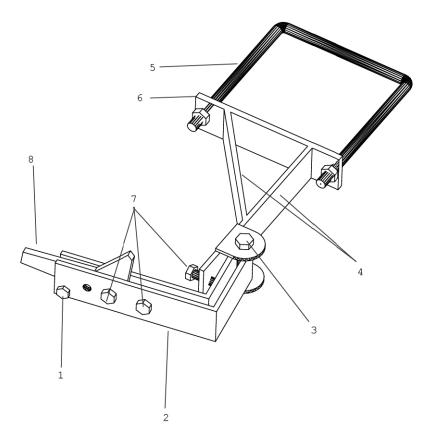- 1. Bolt-1/4"-20 ASTM A307 zinc plated or galvanized
- 2. Arm -3/16" ASTM A36 hot rolled steel
- 3. Bolt 3/8"-16 ASME B18.2.1 grade 5
- 4. Mount arm 3/16 ASTM A36 hot rolled steel
- 5. U-bolt 3/8"
- 6. Mount 1/4" ASTM A36 hot rolled steel
- 7. Bolt 5/16"-18 ASTM A307 zinc plated or galvanized
- 8. Flapper 1/4" ASTM A36 hot rolled steel

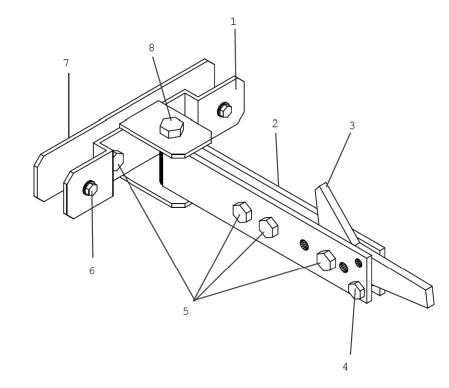

- 1. Mount- 1/8" ASTM A36

 hot rolled steel
- 2. Arm 3/16" ASTM A36
 hot rolled steel
- 3. Flapper 1/4" ASTM A36 hot rolled steel
- 4. Bolt 1/4"-20 ASTM A307 zinc plated or galvanized
- 5. Bolt 5/16-18 ASTM A307 zinc plated or galvanized
- 6. Bolt #10 Self tapping screw
- 7. Pinch plate 1/8" ASTM
 A36 hot rolled steel
- 8. Bolt 3/8"-16 ASMA B18.2.1 grade 5 zinc plated or galvanized

NO DIG ORNAMENTAL HOLDBACK (AS MANUFACTURED BY CHICAGO SUBURBAN FENCE)

NOT TO SCALE

NO DIG 180 DEGREE HOLDBACK (AS MANUFACTURED BY CHICAGO SUBURBAN FENCE)


NOT TO SCALE


ALCUMI	PLOT S	S
2	PLOT (D

USER NAME = \$USER\$	DESIGNED - MCD	REVISED -
	DRAWN - SRS	REVISED -
PLOT SCALE = \$SCALE\$	CHECKED - JAC	REVISED -
PLOT DATE = \$DATE\$	DATE - 12-08-16	REVISED -

STATE OF ILLINOIS DEPARTMENT OF TRANSPORTATION

	.A.U. RTE.	SECTION		COUNTY	
MISCELLANEOUS FENCING DETAILS		[D3 D5 HSRR FENCE	2017-001	
					CONTRAC
SCALE: NTS SHEET 7 OF 15 SHEETS STA. TO	STA.		ILLING	IS FED. AI	D PROJECT

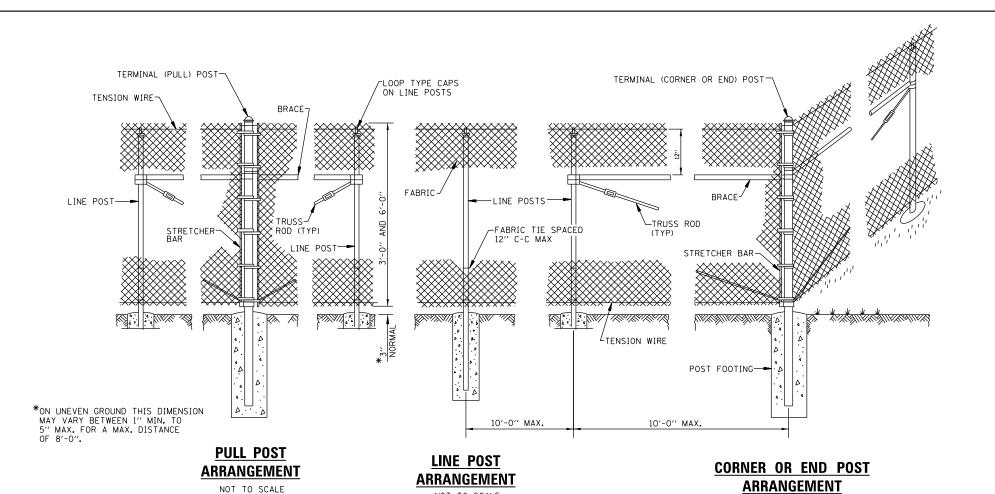

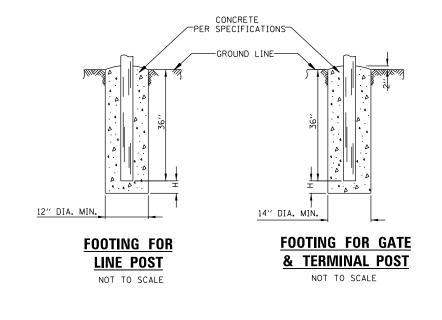


FOOTING DEPTH BELOW POST (H)							
FENCE	WIND EXPOSURE B	WIND EXPOSURE (
CHAIN LINK FENCE, 6'	12''	24''					
CHAIN LINK FENCE, 3'	6"	6′′					


CHAIN LINK FENCE, 3' AND 6'

NOT TO SCALE

NOT TO SCALE

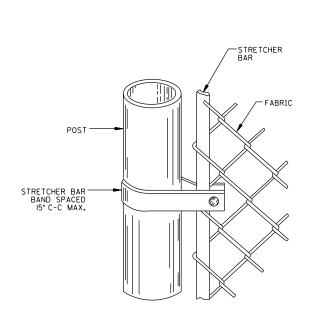

METHOD OF FASTENING STRETCHER BAR TO POST NOT TO SCALE

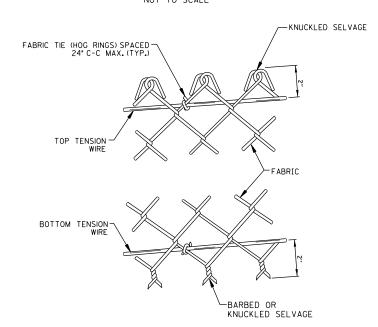

METHOD OF TYING FABRIC TO TENSION WIRES

NOT TO SCALE


GENERAL NOTES

PULL POSTS SHALL BE PLACED AT LOCATIONS DETERMINED BY THE ENGINEER, THEY SHALL BE PLACED AT 660' INTERVALS BETWEEN POSTS TO WHICH THE ENDS OF THE FABRIC ARE CLAMPED OR MIDWAY BETWEEN SUCH POSTS WHEN THE DISTANCE IS LESS THAN 1320' AND GREATER THAN 660'.

X + Y SHALL NOT EXCEED 24", 30", OR 36", AS APPLICABLE. WHEN X IS 0" - 9", 15", OR 21", THEN Y = 15" AND THE POST SHALL BE SHORTENED AS REQUIRED. WHEN X EXCEEDS 9", 15", OR 21", THEN Y SHALL BE DECREASED CORRESPONDINGLY.

POST FOOTING CONCRETE TO BE PER SPECIFICATIONS.

ALL DIMENSIONS ARE IN INCHES UNLESS OTHERWISE SHOWN.

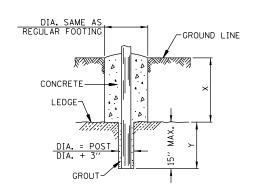


FOOTING FOR POST IN ROCK LEDGE

NOT TO SCALE

A=COM	USER NAME = \$USER\$	DESIGNED - MCD	REVISED -	27477 27 111111212				F.A.U. RTE.	RTE. SECTION COUNTY SE		
		DRAWN - SRS	REVISED -	STATE OF ILLINOIS DEPARTMENT OF TRANSPORTATION		MISCELLANEOUS FENCING DETAILS			RR FENCE 2017-001	55 4	
	PLOT SCALE = \$SCALE\$	CHECKED - JAC	REVISED -					CONTRACT NO. 66F			
	PLOT DATE = \$DATE\$	DATE - 12-08-16	REVISED -		SCALE: NTS	SHEET 8 OF 15 SHEETS STA.	TO STA.	ILLINOIS FED. AID PROJECT		Т	
District 3_HSR Fencing Misc Detail Sheets_IDOT.d	n 12/7/2016 1:33:17 PM		•			·		·			


NOT TO SCALE

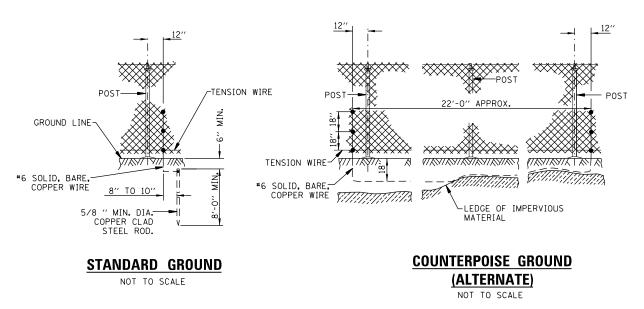

PROTECTIVE ELECTRICAL GROUNDS

NOTE: PROTECTIVE ELECTRICAL GROUNDS TYPICAL FOR ORNAMENTAL FENCE.

NOT TO SCALE

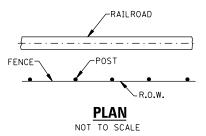




WHEN FENCE LINE HAS A CHANGE IN DIRECTION OF 15° OR MORE, A TERMINAL POST SHALL BE PLACED AS SHOWN ABOVE.

WHERE ANGLE IS LESS THAN 15° AND EXISTING CONDITIONS REQUIRE A TERMINAL POST, THEY SHALL BE PLACED AS DIRECTED BY THE ENGINEER.

INSTALLATION AT CORNERS


NOT TO SCALE

AECOM	USEF	R NAME = \$USER\$	DESIGNED - MCD	REVISED -	OTATE OF HUMOIO	MICCELLANGOUS FENSING DETAILS			COUNTY	TOTAL SHEET SHEETS NO.	
	1 - (DRAWN - SRS	REVISED -	STATE OF ILLINOIS DEPARTMENT OF TRANSPORTATION	MISCELLANEOUS FENCING DETAILS			D3 D5 HSRR FENCE 2017-001		55 49
	PLOT	T SCALE = \$SCALE\$	CHECKED - JAC	REVISED -						CONTRAC1	T NO. 66F90
	PL01	DT DATE = \$DATE\$	DATE - 12-08-16	REVISED -	S		SHEET 9 OF 15 SHEETS STA. TO STA.		ILLINOIS FED. AID PROJECT		
District 3	_HSR Fencing Misc Detail Sheets_IDOT.dgn 12/7/2	2016 1:33:30 PM		•				•	· · ·		

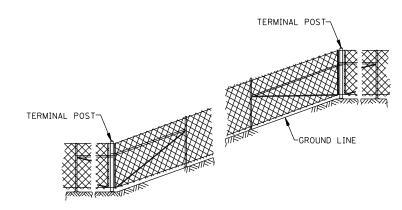


INSTALLATION ON SLOPES

NOT TO SCALE

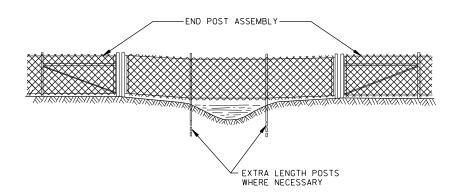


ELEVATION CHAIN LINK FENCE INSTALLATION OVER SWALE / DITCH NOT TO SCALE

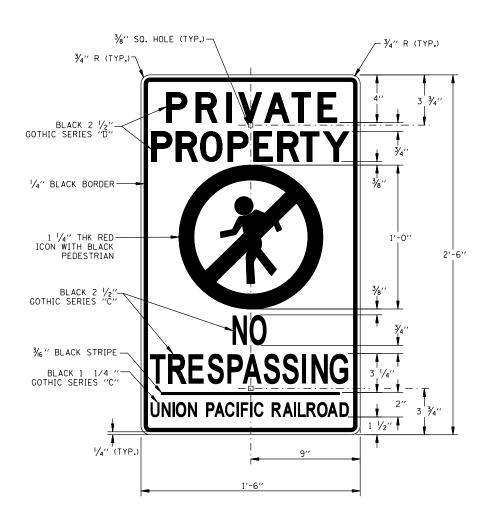

UNION PACIFIC NO TRESPASSING SIGN (UP STD. DWG. 0538A) NOT TO SCALE

NOTES: 1.) SIGN TO BE 3290 SILVER 3M ENGINEER GRADE BACKGROUND, ON 0.080" 3105 SHEET ALUMINUM. 2.) SIGN TO BE MOUNTED TO TUBULAR SWING GATE WITH TWO (2) TAMPER-PROOF ONE-WAY FASTENERS.

TOTAL SHEET NO. 55 50 USER NAME = \$USER\$ DESIGNED - MCD REVISED SECTION STATE OF ILLINOIS MISCELLANEOUS FENCING DETAILS - SRS DRAWN REVISED D3 D5 HSRR FENCE 2017-001 CHECKED - JAC REVISED **DEPARTMENT OF TRANSPORTATION** CONTRACT NO. 66F90 PLOT DATE = \$DATE\$ REVISED SCALE: NTS SHEET 10 OF 15 SHEETS STA. TO STA. DATE - 12-08-16

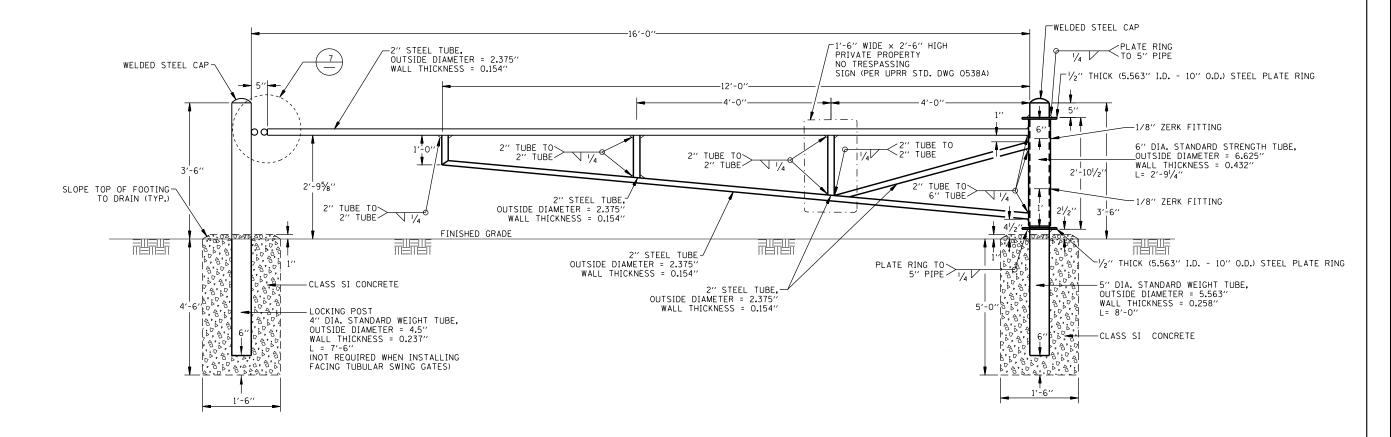

GATE, SPECIAL, (TUBULAR 16' SINGLE SWING)

NOT TO SCALE


NOTES:


- WELD A 3/8" X 2' LONG GRADE 70 HIGH TENSILE STEEL CHAIN FROM 4" DIA. LOCKING POST. RAILROAD WILL FURNISH PAD LOCK. PRIVATE PROPERTY NO TRESPASSING SIGN TO BE PLACED ON SWING GATE ARM AS SHOWN. DRILL TOP AND BOTTOM 2" STEEL TUBES AND ATTACH SIGN WITH 2 (3%")X 3" ZINC PLATED TAMPER-PROOF ONE WAY FASTENERS. NEOPRENE RUBBER WASHERS TO BE PLACED BETWEEN BACK OF SIGN AND STEEL TUBES.


		USER NAME = \$USER\$	DESIGNED - MCD	REVISED
			DRAWN - SRS	REVISED
	AECUM	PLOT SCALE = \$SCALE\$	CHECKED - JAC	REVISED
	7 ()	PLOT DATE = \$DATE\$	DATE - 12-08-16	REVISED
]	District 3_HSR Fencing Misc Detail Sheets_IDOT.dgr	12/7/2016 1:34:25 PM		

STATE OF ILLINOIS
DEPARTMENT OF TRANSPORTATION

I RTÉ								F.A.U. RTE.	SECTION	COUNTY	TOTAL SHEETS	SHEET NO.	
	MISCELLANEOUS FENCING DETAILS								D3 D5 HSRR FENCE 2017-001		55	51	
										CONTRACT	NO. 6	6F90	
SCALE:	NTS	SHEET 11	OF	15	SHEETS	STA.	TO STA.	ILLINOIS FED. AID PROJECT					

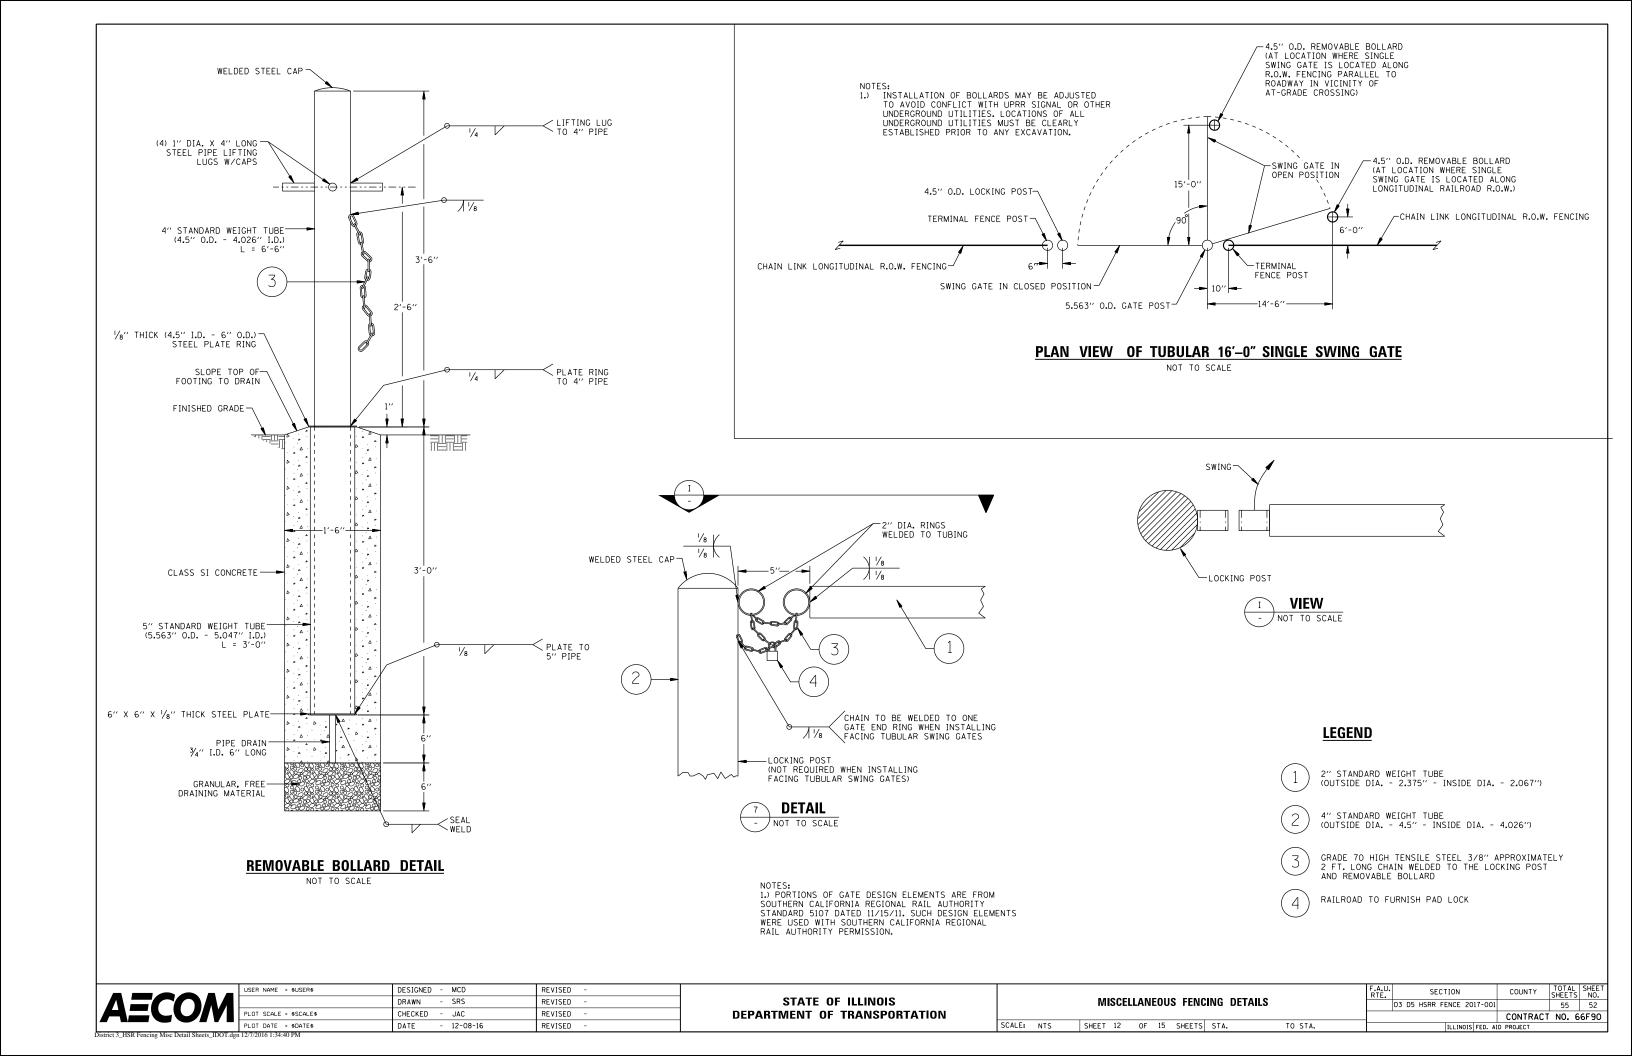

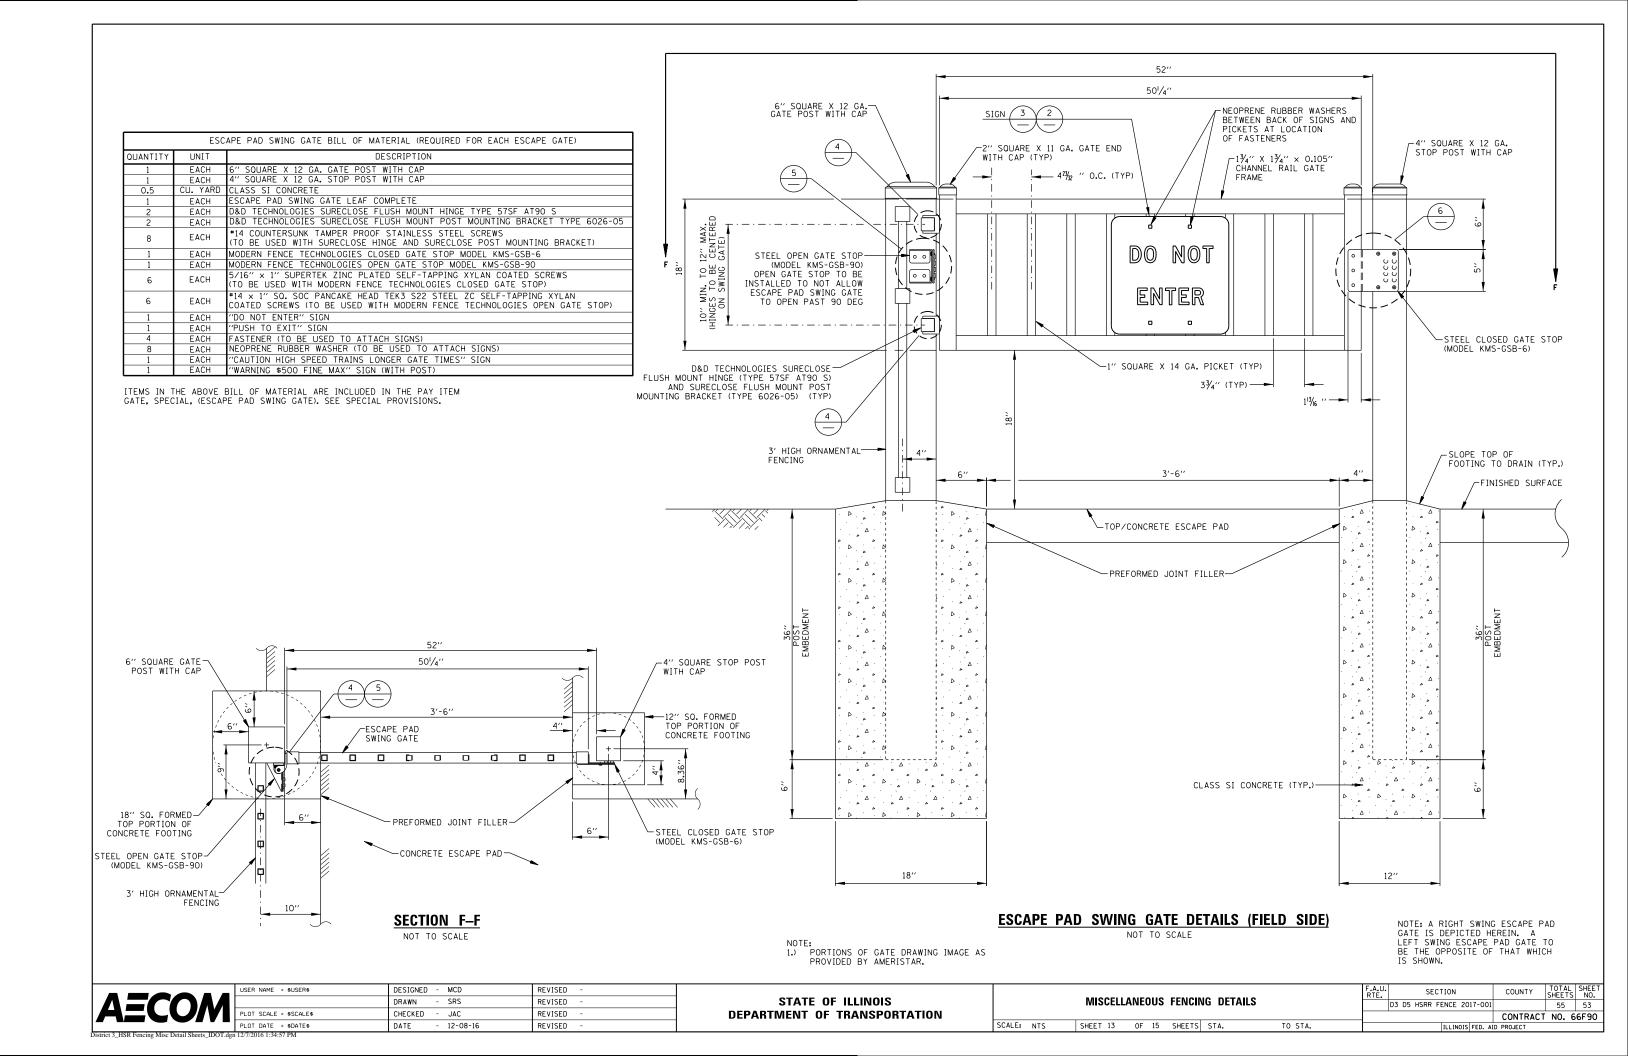


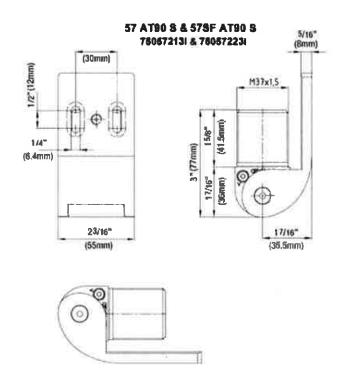


SURECLOSE 57 - FLUSH MOUNT HINGE (TYPE 57SF AT90 S AS MANUFACTURED BY D & D TECHNOLOGIES)

NOT TO SCALE

7515 - Bracket Type: 6026-05 Flush Mount

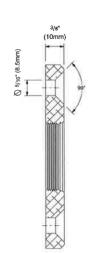


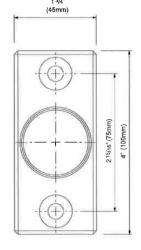



SURECLOSE POST MOUNTING BRACKET – FLUSH MOUNT (TYPE 6026–05 AS MANUFACTURED BY D & D TECHNOLOGIES)


NOT TO SCALE

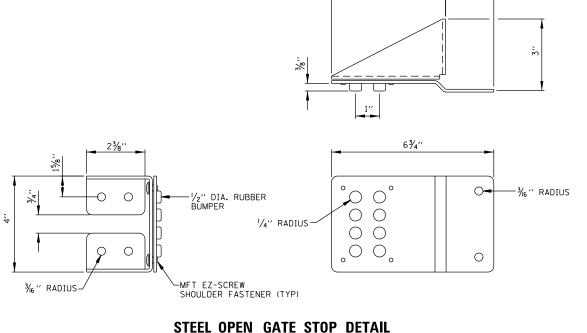

43/4"

STEEL OPEN GATE STOP DETAIL (MODEL KMS-GSB-90 AS MANUFACTURED BY MODERN FENCE TECHNOLOGIES)

NOT TO SCALE

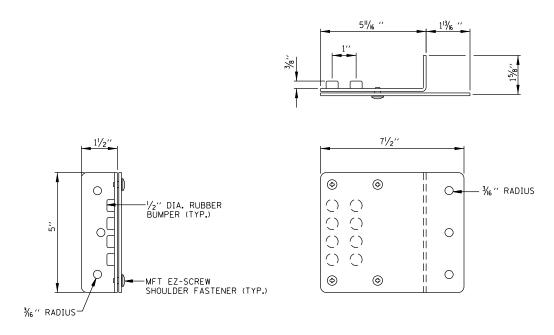

NOTE:
D&D TECHNOLOGIES FLUSH MOUNT SURECLOSE HINGE
AND SURECLOSE FLUSH MOUNT POST MOUNTING BRACKET
TO BE INSTALLED PER MANUFACTURES RECOMMENDATIONS.

CLOSED GATE STOP (MODEL KMS-GSB-6) TO BE FULLY MOUNTED TO GATE ENDS WITH 5*16" X 1" SUPER-TEK ZINC PLATED SELF-TAPPING SCREWS COATED WITH A XYLAN COATING.

OPEN GATE STOP (MODEL KMS-GSB-90) TO BE FULLY MOUNTED TO GATE POST WITH #14 X 1" SO. SOC PANCAKE HEAD TEK3 SS2 STEEL ZC SELF-TAPPING SCREWS WITH A XYLAN COATING.


STEEL CLOSED GATE STOP DETAIL (MODEL KMS-GSB-6 AS MANUFACTURED BY MODERN FENCE TECHNOLOGIES)

NOT TO SCALE

		USER NAME = \$USER\$	DESIGNED - MCD	REVISED -
			DRAWN - SRS	REVISED -
	AECUM	PLOT SCALE = \$SCALE\$	CHECKED - JAC	REVISED -
	<i>7</i> .	PLOT DATE = \$DATE\$	DATE - 12-08-16	REVISED
1	District 3_HSR Fencing Misc Detail Sheets_IDOT.dgn	12/7/2016 1:35:15 PM		

STATE OF ILLINOIS
DEPARTMENT OF TRANSPORTATION

			INO DETAILO	F.A.U. SECTION		COUNTY	TOTAL		
ľ	MISCELLANEOU		D3 D5 HSRR FENCE 2017-001		55	54			
							CONTRACT	NO.	66F90
SCALE: NTS SHEE	ET 14 OF 15	SHEETS	STA.	TO STA.		ILLINOIS FED. A	ID PROJECT		

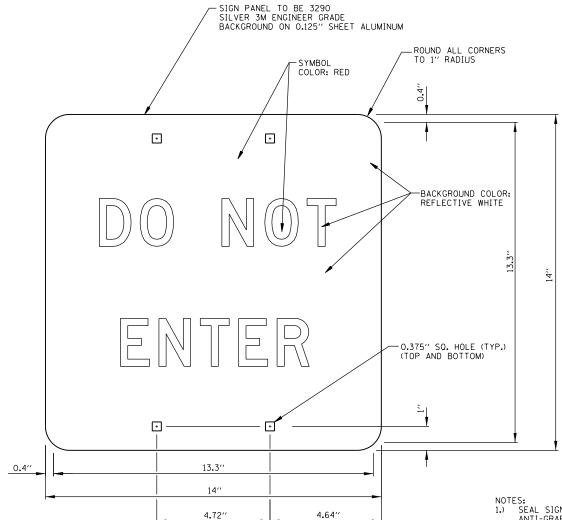

R5-1 STD & MIN;
1.0" Radius, No border, White;
Table of distances between letter and object lefts.






NOT TO SCALE


NOTES: 1.) SEAL SIGNS WITH TRANSPARENT ANTI-GRAFFITI FILM

- 2.) TWO (2) EACH PICKETS TO BE DRILLED WITH TWO (2) HOLES EACH FOR MOUNTING TAMPER-PROOF FASTENERS. CONTRACTOR TO APPLY ENGINEER APPROVED SURFACE COATING PRODUCT TO DRILLED HOLES.
- 3.) SIGNS TO BE MOUNTED BACK TO BACK WITH FOUR (4) TAMPER-PROOF STAINLESS STEEL ONE-WAY FASTENERS. ENGINEER APPROVED NEOPRENE WASHERS TO BE PLACED BETWEEN SIGN SURFACES AND PICKETS PRIOR TO INSTALLATION OF FASTENERS.
- 4.) TYPE ZZ SHEETING IS REQUIRED FOR THE "DO NOT ENTER" SIGN.

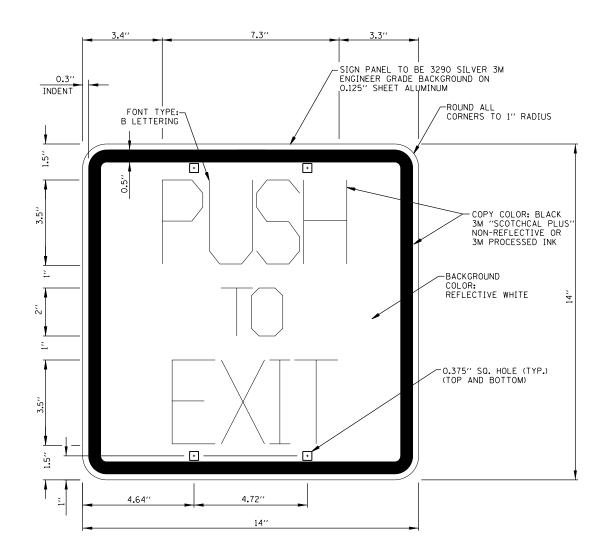

1.0" Radius, 0.5" Border, 0.3" Indent, Black on White; "PUSH" B 75% spacing; "TO" B 75% spacing;

"EXIT" B 75% spacing; Table of distances between letter and object lefts.

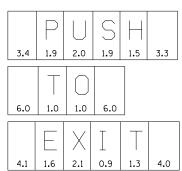

3 ESCAPE PAD SWING GATE SIGN (TRACK SIDE)

NOT TO SCALE

		USER NAME = \$USER\$	DESIGNED - MCD	REVISED
			DRAWN - SRS	REVISED -
	AECUMI	PLOT SCALE = \$SCALE\$	CHECKED - JAC	REVISED
	2	PLOT DATE = \$DATE\$	DATE - 12-08-16	REVISED
Í	District 3_HSR Fencing Misc Detail Sheets_IDOT.dgn	12/7/2016 1:35:32 PM		

STATE OF ILLINOIS
DEPARTMENT OF TRANSPORTATION

		F.A.U. SECTION COUNTY TOTAL SHEET NO.
	MISCELLANEOUS FENCING DETAILS	D3 D5 HSRR FENCE 2017-001 55 55
		CONTRACT NO. 66F90
SCALE: NTS	SHEET 15 OF 15 SHEETS STA. TO STA.	ILLINOIS FED. AID PROJECT