



F.A.I. RTE.	SECTION	COUNTY	TOTAL SHEETS	SHEET NO.
80/94	2626.2-R-1	COOK	452	10
STA.	TO STA.			
FED. ROAD DIST. NO.	ILLINOIS	FED. AID PROJECT		
CONTRACT NO. 62113	INDOT DES. NO. 0100987			

ALL DIMENSIONS IN METERS EXCEPT PAY ITEMS AND UNLESS NOTED OTHERWISE

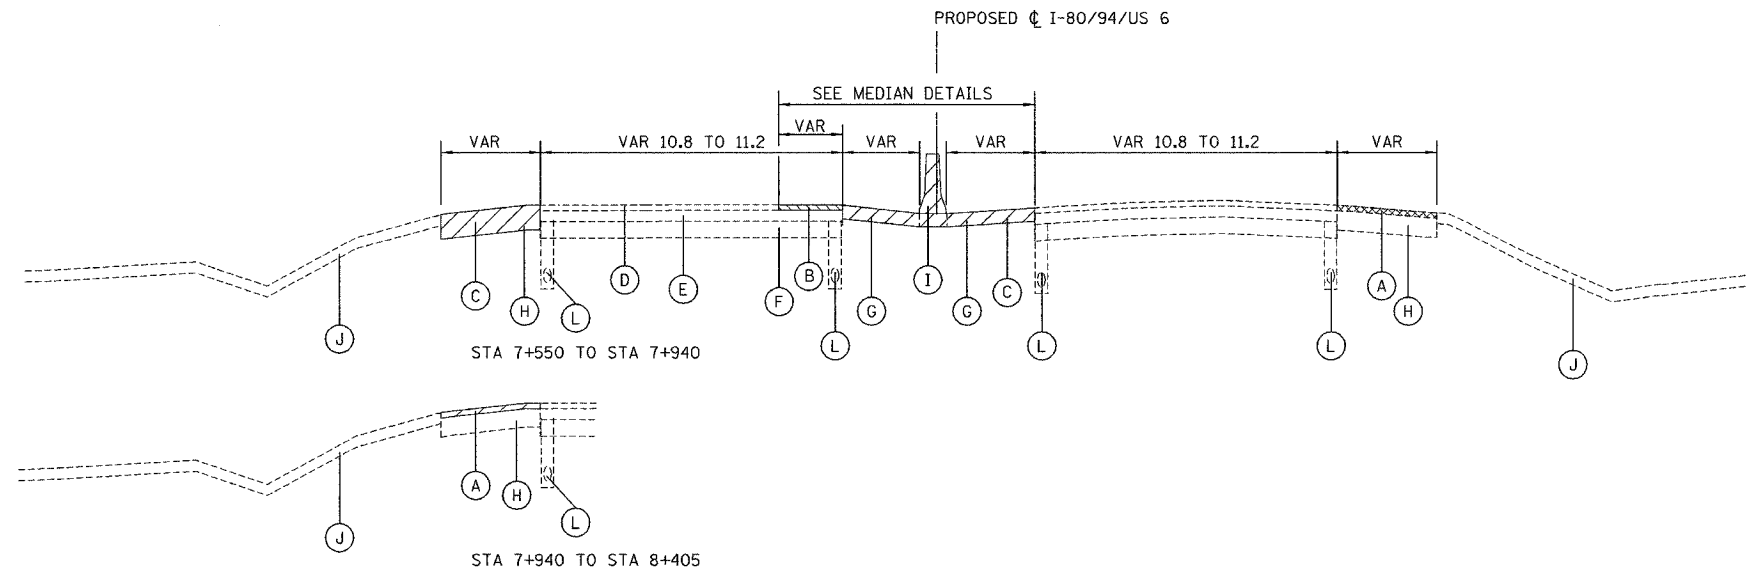


EXISTING TYPICAL SECTION - I-80/94/US 6

LEFT STA 7+550 TO STA 8+405
RIGHT STA 7+550 TO STA 8+197

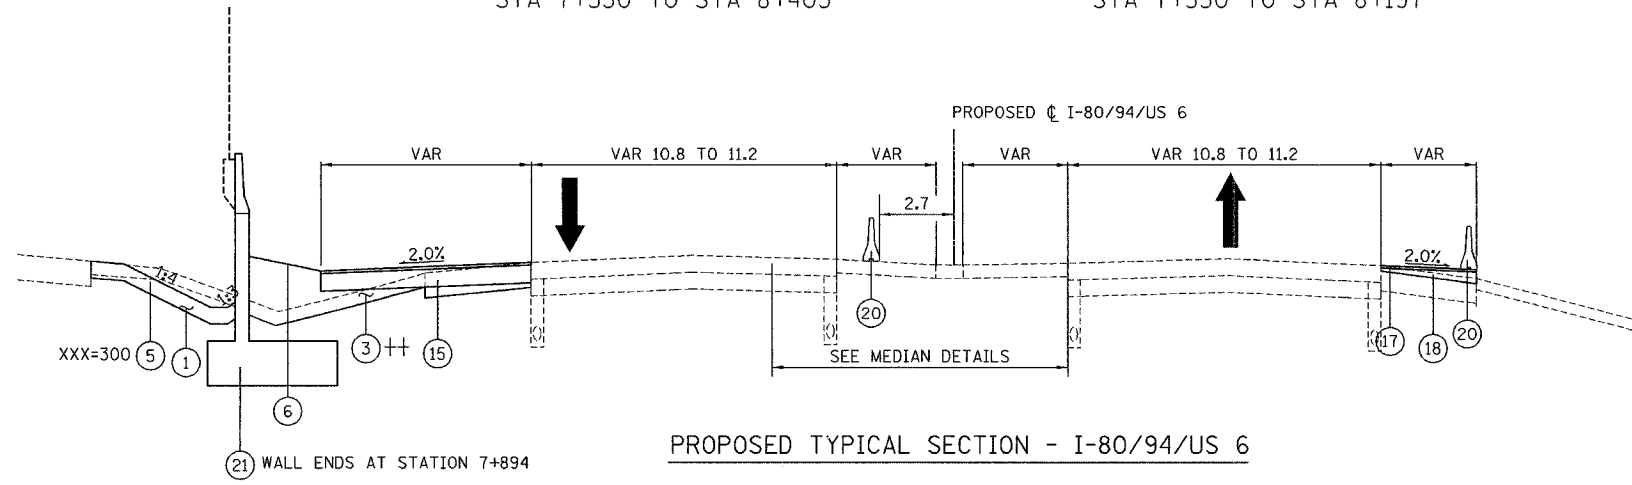

PROPOSED TYPICAL SECTION - I-80/94/US 6

LEFT STA 7+550 TO STA 7+940
RIGHT STA 7+550 TO STA 7+825

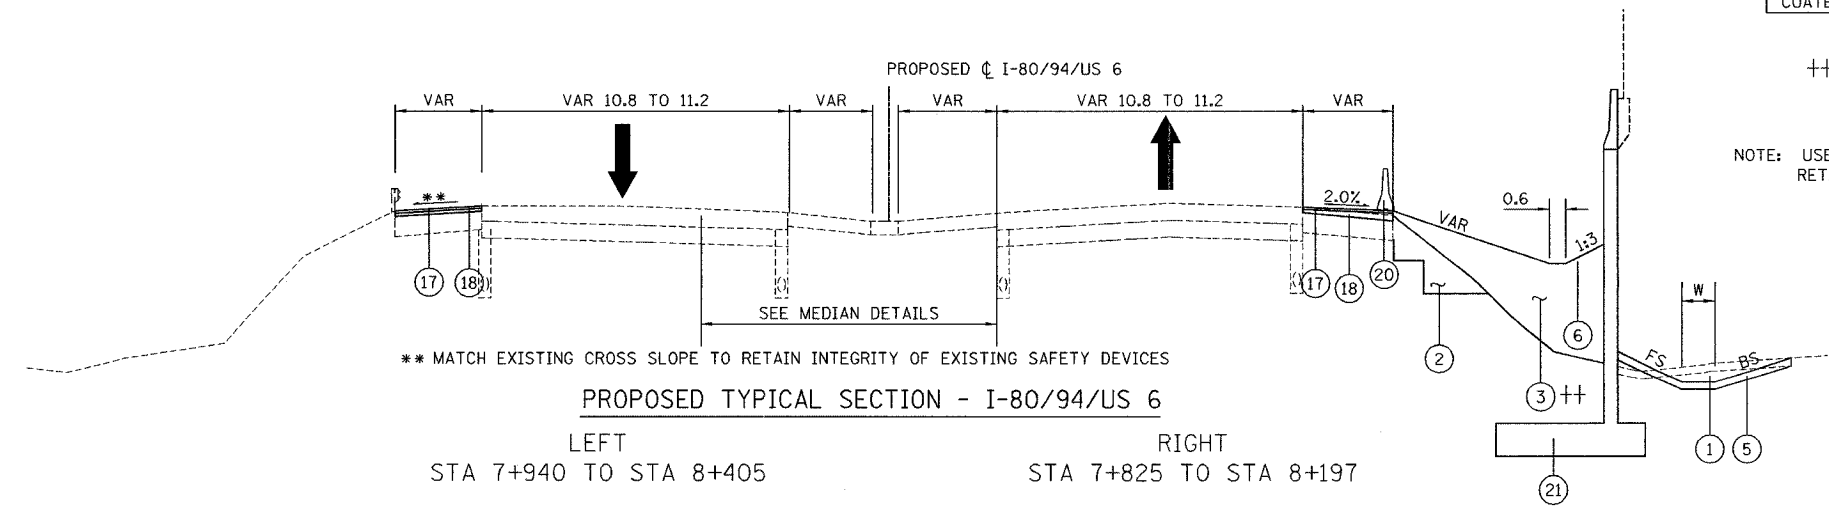

PROPOSED TYPICAL SECTION - I-80/94/US 6

LEFT STA 7+940 TO STA 8+405
RIGHT STA 7+825 TO STA 8+197

EXISTING LEGEND

- A BITUMINOUS SURFACE REMOVAL 95MM
- B BITUMINOUS SURFACE REMOVAL (VARIABLE DEPTH)
- C PAVED SHOULDER REMOVAL
- D BITUMINOUS OVERLAY (150MM & VAR)
- E PORTLAND CEMENT CONCRETE PAVEMENT (275MM & VAR)
- F AGGREGATE SUBGRADE (300MM & VAR)
- G BITUMINOUS PAVEMENT (250MM & VAR)
- H BITUMINOUS PAVEMENT (400MM & VAR)
- I CONCRETE BARRIER
- J EXISTING TOPSOIL (200MM & VAR)
- K RETAINING WALL (TO BE CONSTRUCTED BY OTHER)
- L PAVEMENT UNDERDRAINS (LOCATIONS UNCERTAIN)

REMOVAL ITEM

PROPOSED LEGEND

- 1 EARTH EXCAVATION
- 2 EARTH EXCAVATION (SPECIAL)
- 3 EMBANKMENT
- 4 GEOTECHNICAL FABRIC FOR GROUND STABILIZATION
- 5 TOPSOIL FURNISH AND PLACE, XXX MM & SEEDING, CLASS 2A
- 6 TEMPORARY EROSION CONTROL SEEDING
- 7 SUB-BASE GRANULAR MATERIAL, TYPE B 300MM ++
- 8 STABILIZED SUB-BASE 150MM
- 9 CONTROLLED LOW-STRENGTH MATERIAL
- 10 CONTINUOUSLY REINFORCED PORTLAND CEMENT CONCRETE PAVEMENT 360MM ++
- 11 PAVEMENT REINFORCEMENT 360MM
- 12 PORTLAND CEMENT CONCRETE SHOULDERS - 360MM ++
- 13 PIPE UNDERDRAINS 150MM
- 14 STEEL PLATE BEAM GUARDRAIL, TYPE A
- 15 SHORT TERM PAVEMENT SUPERPAVE (FULL DEPTH)
- 16 WHITEWASHING FOR CONCRETE PAVEMENT
- 17 POLYMERIZED BITUMINOUS CONCRETE SURFACE COURSE, SUPERPAVE, MIX "F", N105 45MM
- 18 BITUMINOUS CONCRETE BINDER COURSE, SUPERPAVE, IL-19.0, N105 50MM & VAR
- 19 TEMPORARY SHEET PILING (REMAIN IN PLACE) (SEE STRUCTURE PLANS)
- 20 TEMPORARY CONCRETE BARRIER (OF THE TYPE SPECIFIED)
- 21 RETAINING WALL (THIS CONTRACT)

LONGITUDINAL JOINTS (LJ)
(INCLUDED IN THE COST OF CRC PAVEMENT OR PCC SHOULDER)
CONSTRUCTION JOINT W/ NO. 25 DEFORMED TIE BARS (EPOXY COATED) 600 mm LONG AT 600 mm CTRS, GROUT IN PLACE
SAWED JOINT W/ NO. 20 DEFORMED TIE BARS (EPOXY COATED) 750 mm LONG AT 750 mm CTRS

++ ITEM SHALL BE CONSTRUCTED IN ACCORDANCE WITH PROVISIONS FOR EXTENDED-LIFE CONCRETE PAVEMENT

NOTE: USE SUPERSTRUCTURE RATING COARSE AGGREGATE FOR CONCRETE USED IN RETAINING WALLS. ARTICLE 1004.01 AGGREGATE QUALITY CLASS B.

BRIDGE OMISSIONS: STA 8+193.7 TO 8+246.2 HOHMAN AVE BRIDGE
STA 8+410.9 TO 8+599.1 LITTLE CAL BRIDGE
STA 8+726.7 TO 8+781.0 HARRISON ST BRIDGE

ILLINOIS DEPARTMENT OF TRANSPORTATION
I-80/94/US 6
KINGERY-BORMAN EXPRESSWAY
BURNHAM ROAD TO US 41
TYPICAL SECTIONS
I-80 /94 /US-6

REVISIONS	
NAME	DATE

SCALE NTS DATE 07/04 DRAWN BY ACE/CAD CHECKED BY TAE



STA 7+825 TO 7+950 W=1.2M XXX=150 FS=1:3; BS=1:4
STA 7+950 TO 8+197 W=0.6M XXX=300 FS=1:4; BS=1:6