

STATE OF ILLINOIS
DEPARTMENT OF TRANSPORTATION
DIVISION OF HIGHWAYS

**PROPOSED
HIGHWAY PLANS**

F.A.P. 351 (IL 7 /159TH STREET)
SECTION (535 B-6R & 536) RS-4
IL 53 (INDEPENDENCE BOULEVARD) TO
I-355 (VETERANS MEMORIAL TOLLWAY) &
AT 2.3 MILES EAST OF IL 53
RESURFACING (3P) & DRAINAGE CORRECTION


F.A.P. RTE.	SECTION	COUNTY	TOTAL SHEETS	SHEET NO.
351	(535 B-6R & 536) RS-4	WILL	35	1
FED. ROAD DIST. NO. 1		ILLINOIS	CONTRACT NO. 60H62	

FOR INDEX OF SHEETS, SEE SHEET NO. 2

THESE IMPROVEMENTS ARE LOCATED
WITHIN THE CITY OF LOCKPORT

TRAFFIC DATA

2007 ADT - 25,100
POSTED SPEED LIMIT - 35 MPH

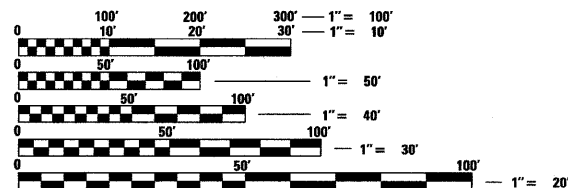


FULL SIZE PLANS HAVE BEEN PREPARED USING STANDARD
ENGINEERING SCALES. REDUCED SIZED PLANS WILL NOT
CONFORM TO STANDARD SCALES. IN MAKING MEASUREMENTS
ON REDUCED PLANS, THE ABOVE SCALES MAY BE USED.

J.U.L.I.E.
JOINT UTILITY LOCATION INFORMATION FOR EXCAVATION
1-800-892-0123
OR 811

CONTRACT NO. 60H62

WILL COUNTY
C-91-760-09

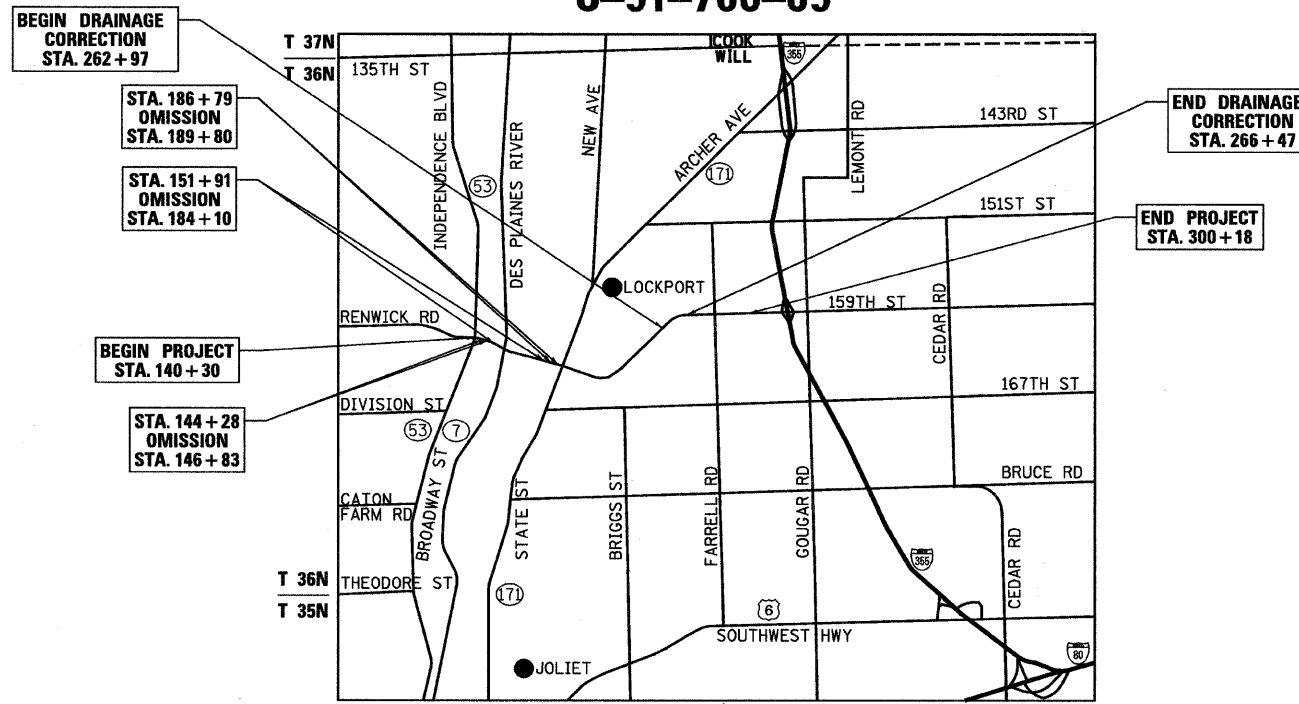

BEGIN DRAINAGE
CORRECTION
STA. 262+97

STA. 186+79
OMISSION
STA. 189+80

STA. 151+91
OMISSION
STA. 184+10

BEGIN PROJECT
STA. 140+30

STA. 144+28
OMISSION
STA. 146+83

END DRAINAGE
CORRECTION
STA. 266+47

END PROJECT
STA. 300+18

Ciorba Group, Inc.
DESIGN FIRM
REGISTRATION NUMBER
184-001016
CONSULTING ENGINEERS
SUITE 402, 5507 NORTH CUMBERLAND AVE
CHICAGO, ILLINOIS 60656 ☎ (773) 775-4009

LOCKPORT & HOMER TOWNSHIP
LOCATION MAP
1" = 5,000'
GROSS LENGTH OF PROJECT = 15,988 FT = 3.03 MI.
NET LENGTH OF PROJECT = 12,213 FT = 2.31 MI.



STATE OF ILLINOIS
DEPARTMENT OF TRANSPORTATION
DIVISION OF HIGHWAYS
SUBMITTED DECEMBER 8, 2009
Diana M. O'Keefe
DEPUTY DIRECTOR OF HIGHWAYS, REGION ENGINEER
January 09 2010
Scott E. Stitt P.E.
ACCESS ENGINEER OF DESIGN AND ENVIRONMENT
January 09 2010
Christine M. Reed
DIRECTOR OF HIGHWAYS, CHIEF ENGINEER

STEPHEN N. SUGG
062-044117
LICENSED
PROFESSIONAL
ENGINEER
OF
Stephen N. Sugg
DATE: 12/7/2009
SEAL EXPIRES: 11/30/2011

**PRINTED BY THE AUTHORITY
OF THE STATE OF ILLINOIS**

DISTRICT 1 DESIGN PLAN PREPARATION ENGINEER: K. ENG (847)705-4247

INDEX OF SHEETS

SHEET NO	DESCRIPTION
1	COVER SHEET
2	INDEX OF SHEETS & STATE STANDARDS
3	GENERAL NOTES
4	SUMMARY OF QUANTITIES
5-6	TYPICAL SECTIONS
7-12	PROPOSED ROADWAY AND PAVEMENT MARKING PLAN
13	DRAINAGE PLAN AND PROFILE
14	EXISTING ROADWAY PLAN
15	PROPOSED ROADWAY PLAN
16	EROSION CONTROL PLAN
17-23	DETECTOR LOOP REPLACEMENT PLANS
24	DETAILS FOR FRAMES AND LIDS ADJUSTMENT WITH MILLING (BD-8)
25	PAVEMENT PATCHING FOR HMA SURFACED PAVEMENT (BD-22)
26	CURB AND GUTTER REMOVAL AND REPLACEMENT (BD-24)
27	BUTT JOINT AND HMA TAPER DETAILS (BD-32)
28	TRAFFIC CONTROL AND PROTECTION FOR SIDE ROADS, INTERSECTIONS, AND DRIVEWAYS (TC-10)
29	TYPICAL APPLICATIONS RAISED REFLECTIVE PAVEMENT MARKERS (SNOW PLOW RESISTANT) (TC-11)
30	DISTRICT ONE TYPICAL PAVEMENT MARKINGS (TC-13)
31	TRAFFIC CONTROL AND PROTECTION AT TURN BAYS (TO REMAIN OPEN TO TRAFFIC) (TC-14)
32	PAVEMENT MARKING LETTERS AND SYMBOLS FOR TRAFFIC STAGING (TC-16)
33	ARTERIAL ROAD INFORMATION SIGN (TC-22)
34	TYPICAL SUPPLEMENTAL SIGNING AND PAVEMENT MARKING TREATMENT FOR RAILROAD CROSSINGS (TC-23)
35	DISTRICT 1 DETECTOR LOOP INSTALLATION DETAILS FOR ROADWAY RESURFACING (TS-07)

STATE STANDARDS

000001-05	STANDARD SYMBOLS, ABBREVIATIONS, AND PATTERNS
280001-05	TEMPORARY EROSION CONTROL SYSTEMS
442201-03	CLASS C AND D PATCHES
482011-03	HMA SHLD. STRIPS/SHLDS. WITH RESURFACING OR WIDENING AND RESURFACING PROJECTS
542301-02	PRECAST REINFORCED CONCRETE FLARED END SECTION
602001-01	CATCH BASIN TYPE A
602401-02	MANHOLE TYPE A
602601-02	PRECAST REINFORCED CONCRETE FLAT SLAB TOP
602701-02	MANHOLE STEPS
604001-03	FRAME AND LIDS, TYPE 1
604091-02	FRAME AND GRATE TYPE 24
606001-04	CONCRETE CURB TYPE B AND COMBINATION CONCRETE CURB AND GUTTER
701006-03	OFF-RD OPERATIONS, 2L, 2W, 15' (4.5 m) TO 24" (600 mm) FROM PAVEMENT EDGE
701301-03	LANE CLOSURE, 2L, 2W, SHORT TIME OPERATIONS
701311-03	LANE CLOSURE, 2L, 2W, MOVING DAY OPERATIONS-DAY ONLY
701501-05	URBAN LANE CLOSURE, 2L, 2W, UNDIVIDED
701606-06	URBAN LANE CLOSURE, MULTILANE, 2W WITH MOUNTABLE MEDIAN
701701-06	URBAN LANE CLOSURE, MULTI LANE INTERSECTION
701801-04	LANE CLOSURE MULTILANE 1W OR 2W CROSSWALK OR SIDEWALK CLOSURE
701901-01	TRAFFIC CONTROL DEVICES
780001-02	TYPICAL PAVEMENT MARKINGS
886001-01	DETECTOR LOOP INSTALLATIONS
886006-01	TYPICAL LAYOUTS FOR DETECTION LOOPS

FILE NAME = N:\PROJ\33668\33668_28\Design\ProposedPlan\33668_28-02a-Index of Sheets.dgn



Ciorba Group, Inc.
 CONSULTING ENGINEERS
 5507 North Cumberland Avenue, Suite 402
 Chicago, Illinois 60658
 Tel. 773.775.4009 Fax 773.775.4014

USER NAME = wjanooster	DESIGNED - AL	REVISED -
	DRAWN - AL	REVISED -
PLOT SCALE = 1:2000' / 1" IN.	CHECKED - SNS	REVISED -
PLOT DATE = 12/10/2009	DATE - 12/11/09	REVISED -

**STATE OF ILLINOIS
 DEPARTMENT OF TRANSPORTATION**

**IL 7 / 159TH STREET
 IL 53 (INDEPENDENCE BLVD) TO I-355 (VETERANS MEMORIAL TOLLWAY)
 INDEX OF SHEETS & STATE STANDARDS**

SCALE: SHEET NO. OF SHEETS STA. TO STA.

F.A.P. RTE.	SECTION	COUNTY	TOTAL SHEETS	SHEET NO.
351	(535 B-6R & 536) RS-4	WILL	35	2
FED. ROAD DIST. NO. 1 [ILLINOIS] FED. AID PROJECT			CONTRACT NO. 60H62	

SUMMARY OF QUANTITIES			URBAN 100% STATE	CONSTRUCTION TYPE CODE	
CODE NO.	DESCRIPTION	UNIT	TOTAL QUANTITY	ROADWAY 1000-2A	DRAINAGE 7007
20101100	TREE TRUNK PROTECTION	EACH	5		5
20200100	EARTH EXCAVATION	CU YD	5		5
20201006	GRADING AND SHAPING SHOULDERS	UNIT	54	54	
20800150	TRENCH BACKFILL	CU YD	313		313
21101615	TOPSOIL FURNISH AND PLACE, 4"	SQ YD	150	150	
25000300	SEEDING, CLASS 3	ACRE	0.1		0.1
25100630	EROSION CONTROL BLANKET	SQ YD	108		108
25200110	SODDING, SALT TOLERANT	SQ YD	150	150	
25200700	SODDING, SPECIAL	SQ YD	40		40
28000400	PERIMETER EROSION BARRIER	FOOT	19,000		19,000
28000510	INLET FILTERS	EACH	4		4
28100105	STONE RIPRAP, CLASS A3	SQ YD	4		4
28200200	FILTER FABRIC	SQ YD	4		4
35300500	PORTLAND CEMENT CONCRETE BASE COURSE 10"	SQ YD	77		77
35501316	HOT-MIX ASPHALT BASE COURSE, 8"	SQ YD	195	33	162
40201000	AGGREGATE FOR TEMPORARY ACCESS	TON	143	35	108
40600200	BITUMINOUS MATERIALS (PRIME COAT)	TON	56.1	56	0.1
40600300	AGGREGATE (PRIME COAT)	TON	278	278	
40600400	MIXTURE FOR CRACKS, JOINTS, AND FLANGEWAYS	TON	104	104	
40600535	LEVELING BINDER (HAND METHOD), N70	TON	25	25	
40600895	CONSTRUCTING TEST STRIP	EACH	2	2	
40600982	HOT-MIX ASPHALT SURFACE REMOVAL - BUTT JOINT	SQ YD	1,198	1,198	
40601005	HOT-MIX ASPHALT REPLACEMENT OVER PATCHES	TON	240	240	
40603085	HOT-MIX ASPHALT BINDER COURSE, IL-19.0, N70	TON	15		15
40603310	HOT-MIX ASPHALT SURFACE COURSE, MIX "C", N50	TON	23	4	19
40603595	POLYMERIZED HOT-MIX ASPHALT SURFACE COURSE, MIX "F", N90	TON	6,792	6,780	12
42300400	PORTLAND CEMENT CONCRETE DRIVEWAY PAVEMENT, 8 INCH	SQ YD	17	17	
42400300	PORTLAND CEMENT CONCRETE SIDEWALK 6 INCH	SQ FT	500	500	
44000100	PAVEMENT REMOVAL	SQ YD	77		77
44000159	HOT-MIX ASPHALT SURFACE REMOVAL, 2 1/2"	SQ YD	69,160	69,160	
44000200	DRIVEWAY PAVEMENT REMOVAL	SQ YD	212	50	162
44000600	SIDEWALK REMOVAL	SQ FT	500	500	
44001700	COMBINATION CONCRETE CURB AND GUTTER REMOVAL AND REPLACEMENT	FOOT	900	900	
44002212	HOT-MIX ASPHALT REMOVAL OVER PATCHES, 3"	SQ YD	1,450	1,450	
44201765	CLASS D PATCHES, TYPE II, 10 INCH	SQ YD	680	680	
44201769	CLASS D PATCHES, TYPE III, 10 INCH	SQ YD	450	450	
44201771	CLASS D PATCHES, TYPE IV, 10 INCH	SQ YD	100	100	
48102100	AGGREGATE WEDGE SHOULDER, TYPE B	TON	165	165	
54213657	PRECAST REINFORCED CONCRETE FLARED END SECTIONS 12"	EACH	1		1
550A0340	STORM SEWERS, CLASS A, TYPE 2 12"	FOOT	340		340
55039700	STORM SEWERS TO BE CLEANED	FOOT	2,500	2,500	

* DENOTES SPECIALTY ITEM

SUMMARY OF QUANTITIES			URBAN 100% STATE	CONSTRUCTION TYPE CODE	
CODE NO.	DESCRIPTION	UNIT	TOTAL QUANTITY	ROADWAY 1000-2A	DRAINAGE 7007
60201340	CATCH BASINS, TYPE A, 4'-DIAMETER, TYPE 24 FRAME AND GRATE	EACH	3		3
60218400	MANHOLES, TYPE A, 4'-DIAMETER, TYPE 1 FRAME, CLOSED LID	EACH	1		1
60219540	MANHOLES, TYPE A, 4'-DIAMETER, TYPE 24 FRAME AND GRATE	EACH	1		1
60262700	INLETS TO BE RECONSTRUCTED	EACH	1	1	
60300305	FRAMES AND LIDS TO BE ADJUSTED	EACH	10	10	
60300310	FRAMES AND LIDS TO BE ADJUSTED (SPECIAL)	EACH	65	65	
60406000	FRAMES AND LIDS, TYPE 1, OPEN LID	EACH	5	5	
60406100	FRAMES AND LIDS, TYPE 1, CLOSED LID	EACH	5	5	
60605000	COMBINATION CONCRETE CURB AND GUTTER, TYPE B-6.24	FOOT	227		227
63000005	STEEL PLATE BEAM GUARD RAIL, TYPE B	FOOT	25		25
63200310	GUARDRAIL REMOVAL	FOOT	25		25
67000400	ENGINEER'S FIELD OFFICE, TYPE A	CAL MO	6	6	
67100100	MOBILIZATION	L SUM	1	1	
70102620	TRAFFIC CONTROL AND PROTECTION, STANDARD 701501	L SUM	1	1	
70102625	TRAFFIC CONTROL AND PROTECTION, STANDARD 701606	L SUM	1	1	
70102635	TRAFFIC CONTROL AND PROTECTION, STANDARD 701701	L SUM	1	1	
70102640	TRAFFIC CONTROL AND PROTECTION, STANDARD 701801	L SUM	1	1	
70300100	SHORT-TERM PAVEMENT MARKING	FOOT	7,330	7,330	
70300210	TEMPORARY PAVEMENT MARKING - LETTERS AND SYMBOLS	SQ FT	3,900	3,900	
70300220	TEMPORARY PAVEMENT MARKING - LINE 4"	FOOT	78,230	78,230	
70300240	TEMPORARY PAVEMENT MARKING - LINE 6"	FOOT	21,270	21,270	
70300250	TEMPORARY PAVEMENT MARKING - LINE 8"	FOOT	1,020	1,020	
70300260	TEMPORARY PAVEMENT MARKING - LINE 12"	FOOT	7,110	7,110	
70300280	TEMPORARY PAVEMENT MARKING - LINE 24"	FOOT	2,850	2,850	
70301000	WORK ZONE PAVEMENT MARKING REMOVAL	SQ FT	18,100	18,100	
78000100	THERMOPLASTIC PAVEMENT MARKING - LETTERS AND SYMBOLS	SQ FT	1,300	1,300	
78000200	THERMOPLASTIC PAVEMENT MARKING - LINE 4"	FOOT	44,000	44,000	
78000400	THERMOPLASTIC PAVEMENT MARKING - LINE 6"	FOOT	7,090	7,090	
78000500	THERMOPLASTIC PAVEMENT MARKING - LINE 8"	FOOT	340	340	
78000600	THERMOPLASTIC PAVEMENT MARKING - LINE 12"	FOOT	2,370	2,370	
78000650	THERMOPLASTIC PAVEMENT MARKING - LINE 24"	FOOT	950	950	
78100100	RAISED REFLECTIVE PAVEMENT MARKER	EACH	820	820	
78300200	RAISED REFLECTIVE PAVEMENT MARKER REMOVAL	EACH	780	780	
88600600	DETECTOR LOOP REPLACEMENT	FOOT	4,050	4,050	
X0322256	TEMPORARY INFORMATION SIGNING	SQ FT	103	103	
40600826	POLYMERIZED LEVELING BINDER (MACHINE METHOD), IL-4.75, N50	TON	2,730	2,730	
XX005656	INLET FILTER CLEANING	EACH	4		4
Z0013798	CONSTRUCTION LAYOUT	L SUM	1	1	
Z0018500	DRAINAGE STRUCTURES TO BE CLEANED	EACH	105	105	
Z0048665	RAILROAD PROTECTIVE LIABILITY INSURANCE	L SUM	1	1	

FILE NAME = N:\PROJ\3368\3368_26\Design\ProposedPlan\3368_26-03-Quantities.dgn




Ciorka Group, Inc.
CONSULTING ENGINEERS
5507 North Cumberland Avenue, Suite 402
Chicago, Illinois 60656
Tel. 773.775.4009 Fax 773.775.4014

USER NAME = alou	DESIGNED - AL	REVISED -
PLOT SCALE = 1:2000' / 1"	DRAWN - AL	REVISED -
PLOT DATE = 12/15/2009	CHECKED - SNS	REVISED -
	DATE = 12/11/09	REVISED -


STATE OF ILLINOIS
DEPARTMENT OF TRANSPORTATION

IL 7 / 159TH STREET
IL 53 (INDEPENDENCE BLVD) TO I-355 (VETERANS MEMORIAL TOLLWAY)
SUMMARY OF QUANTITIES


F.A.P. RTE. 351	SECTION (535 B-6R & 536) RS-4	COUNTY WILL	TOTAL SHEETS 35	SHEET NO. 4
SCALE: SHEET NO. OF SHEETS STA. TO STA.			CONTRACT NO. 60H62	
FED. ROAD DIST. NO. 1 ILLINOIS FED. AID PROJECT				

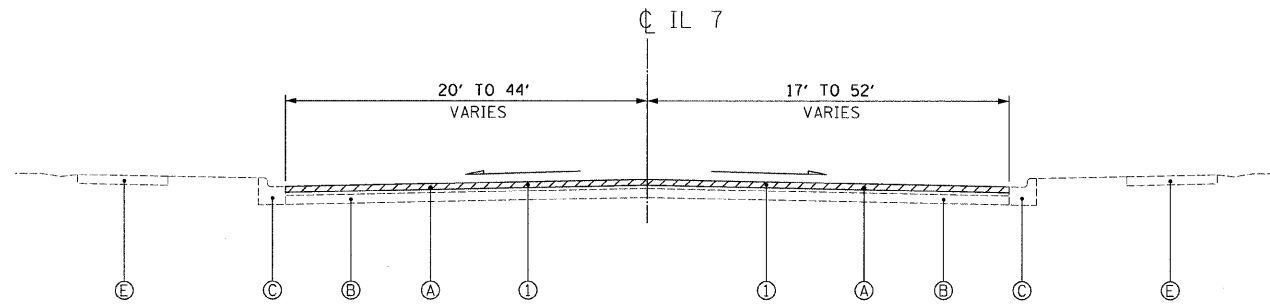


EXISTING TYPICAL SECTION
 STA. 140+30 TO STA. 144+28
 STA. 189+80 TO STA. 214+40
 STA. 226+30 TO STA. 238+29
 STA. 246+46 TO STA. 262+52
 STA. 288+30 TO STA. 300+18

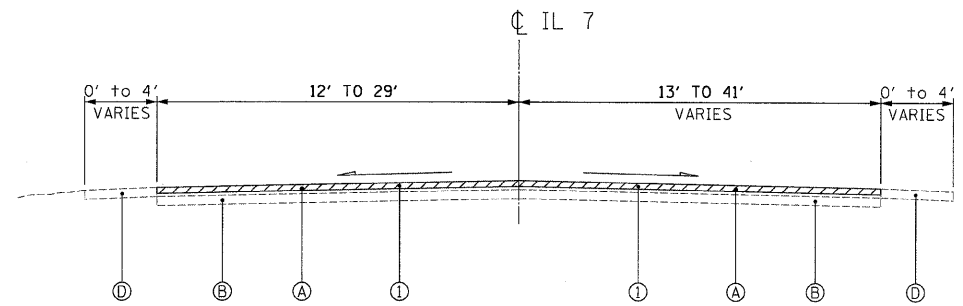

EXISTING TYPICAL SECTION
 STA. 146+83 TO STA. 151+91
 STA. 184+10 TO STA. 186+79
 STA. 214+40 TO STA. 226+30
 STA. 238+29 TO STA. 246+46
 STA. 262+52 TO STA. 288+30

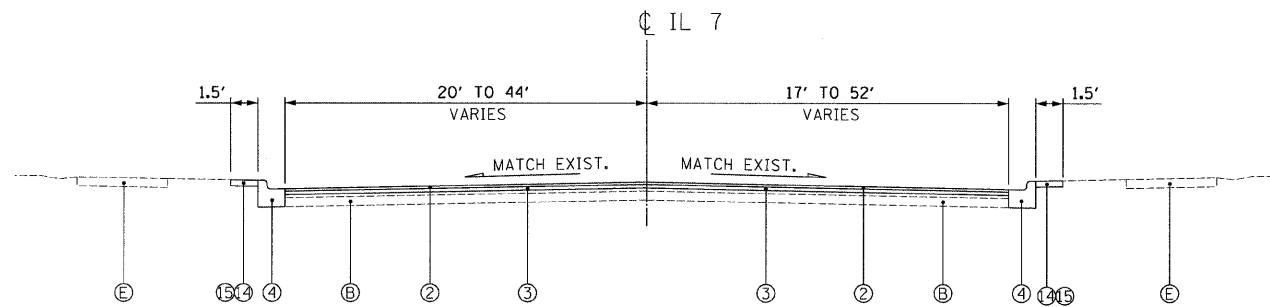

PROPOSED TYPICAL SECTION
 STA. 140+30 TO STA. 144+28
 STA. 189+80 TO STA. 214+40
 STA. 226+30 TO STA. 238+29
 STA. 246+46 TO STA. 262+52
 STA. 288+30 TO STA. 300+18

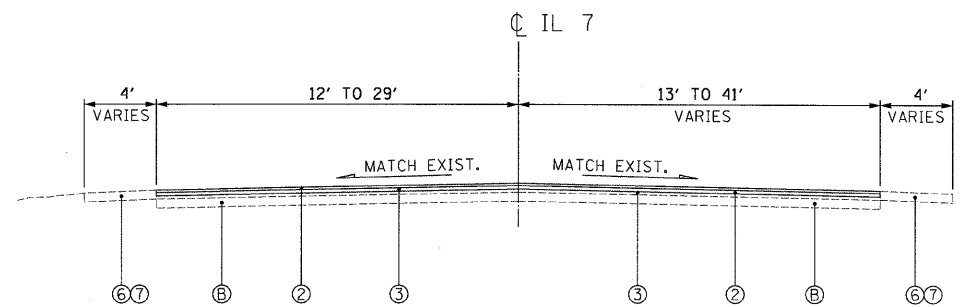

PROPOSED TYPICAL SECTION
 STA. 146+83 TO STA. 151+91
 STA. 184+10 TO STA. 186+79
 STA. 214+40 TO STA. 226+30
 STA. 238+29 TO STA. 246+46
 STA. 262+52 TO STA. 288+30

EXISTING CONDITIONS:

- Ⓐ HOT-MIX ASPHALT SURFACE AND BINDER COURSE, 3" AND VARIES
- Ⓑ PCC BASE COURSE, 10" +/-
- Ⓒ COMBINATION CONCRETE CURB AND GUTTER
- Ⓓ AGGREGATE SHOULDER 6" AND VARIES
- Ⓔ PCC SIDEWALK
- Ⓕ PRIVATE DRIVEWAYS

PROPOSED IMPROVEMENTS:

- ① HOT-MIX ASPHALT SURFACE REMOVAL, 2 1/2"
- ② POLYMERIZED HOT-MIX ASPHALT SURFACE COURSE, MIX "F", N90, 1 3/4"
- ③ POLYMERIZED LEVELING BINDER (MACHINE METHOD), IL-4.75, N50, 3/4"
- ④ COMBINATION CONCRETE CURB AND GUTTER REMOVAL AND REPLACEMENT (AS DIRECTED BY ENGINEER)
- ⑤ CLASS D PATCHES, 10" (DETERMINED BY ENGINEER IN FIELD)
- ⑥ AGGREGATE WEDGE SHOULDER, TYPE B
- ⑦ GRADING AND SHAPING SHOULDERS
- ⑧ PAVEMENT REMOVAL
- ⑨ PORTLAND CEMENT CONCRETE BASE COURSE, 10"
- ⑩ POLYMERIZED HOT-MIX ASPHALT BINDER COURSE, IL-19.0, N90, 2-1/4"
- ⑪ COMBINATION CONCRETE CURB AND GUTTER, TYPE B-6.24, DEPRESSED CURB (TYPICAL)
- ⑫ HOT-MIX ASPHALT BASE COURSE, 6" (AT DRIVEWAYS ONLY)
- ⑬ HOT-MIX ASPHALT SURFACE COURSE, MIX "C", N50, 2" (AT DRIVEWAYS ONLY)
- ⑭ TOPSOIL FURNISH AND PLACE, 4"
- ⑮ SODDING, SALT TOLERANT

A QUANTITY FOR LEVELING BINDER (HAND METHOD) HAS BEEN PROVIDED FOR USE AT PRIVATE ENTRANCES, AROUND HAND HOLES, PRIVATE UTILITY STRUCTURE FRAMES, AND ANY OTHER STRUCTURE FRAMES THAT ARE NOT ABLE TO BE LOWERED UNDER THE ITEM "FRAMES AND LIDS TO BE ADJUSTED (SPECIAL)" AFTER GRINDING OF EXISTING PAVEMENT.

¹ QUANTITIES FOR EARTH EXCAVATION AND AGGREGATE BASE REPAIR HAVE BEEN INCLUDED FOR SUBGRADE FAILURES BELOW THE CLASS D PATCHES

HOT-MIX ASPHALT MIXTURE REQUIREMENTS CHART

OPERATIONS	MIXTURE TYPE	AIR VOIDS @ Ndes
ROADWAY RESURFACING	POLYMERIZED HOT-MIX ASPHALT SURFACE COURSE, MIX "F", N90 (IL-9.5MM)	4% @ 90 GYR
	POLYMERIZED LEVELING BINDER (MACHINE METHOD), IL-4.75, N50	4% @ 50 GYR
ROADWAY RECONSTRUCTION	POLYMERIZED HOT-MIX ASPHALT SURFACE COURSE, MIX "F", N90 (IL-9.5MM)	4% @ 90 GYR
	POLYMERIZED HOT-MIX ASPHALT BINDER COURSE, IL-19, N90	4% @ 90 GYR
MAINTENANCE OF TRAFFIC	LEVELING BINDER (HAND METHOD), N70 (IL-9.5MM)	4% @ 70 GYR
PAVEMENT PATCHING	CLASS D PATCHES, 10" (HMA BINDER IL-19 MM)	4% @ 70 GYR
	HOT-MIX ASPHALT REPLACEMENT OVER PATCHES (HMA BINDER IL-19 MM)	4% @ 70 GYR
DRIVES BEHIND CURB	HOT-MIX ASPHALT SURFACE COURSE, MIX "C", N50 (IL-9.5MM) 2" THICKNESS	4% @ 50 GYR
	HOT-MIX ASPHALT BASE COURSE, 8" (HMA BINDER IL-19 MM)	4% @ 50 GYR

THE UNIT WEIGHT USED TO CALCULATE ALL HMA SURFACE MIXTURE QUANTITIES IS 112 LBS/SQ YD/IN.

CONTRACTOR SHALL PATCH BEFORE MILLING

FOR "AC TYPE" AND "PERCENT RAP" SEE DISTRICT ONE SPECIAL PROVISIONS

FILE NAME = N:\PROJECTS\3386B\3386B_28-Daughn\Proposed\Plan\3386B_28-04-T1.psd.dwg

Ciorba Group, Inc.
 CONSULTING ENGINEERS
 5507 North Cumberland Avenue, Suite 402
 Chicago, Illinois 60656
 Tel. 773.775.4009 Fax 773.775.4014


USER NAME = alau	DESIGNED - AL	REVISED -
PLOT SCALE = 5,0000' / IN.	DRAWN - AL	REVISED -
PLOT DATE = 12/15/2009	CHECKED - SNS	REVISED -
	DATE - 12/11/09	REVISED -

**STATE OF ILLINOIS
 DEPARTMENT OF TRANSPORTATION**



**IL 7 /159TH STREET
 IL 53 (INDEPENDENCE BLVD) TO I-355 (VETERANS MEMORIAL TOLLWAY)
 TYPICAL SECTIONS**

SCALE: SHEET NO. OF SHEETS STA. TO STA.



F.A.P. RTE.	SECTION	COUNTY	TOTAL SHEETS	SHEET NO.
351	(535 B-6R & 536) RS-4	WILL	35	5
CONTRACT NO. 60H62				
FED. ROAD DIST. NO. 1 ILLINOIS FED. AID PROJECT				

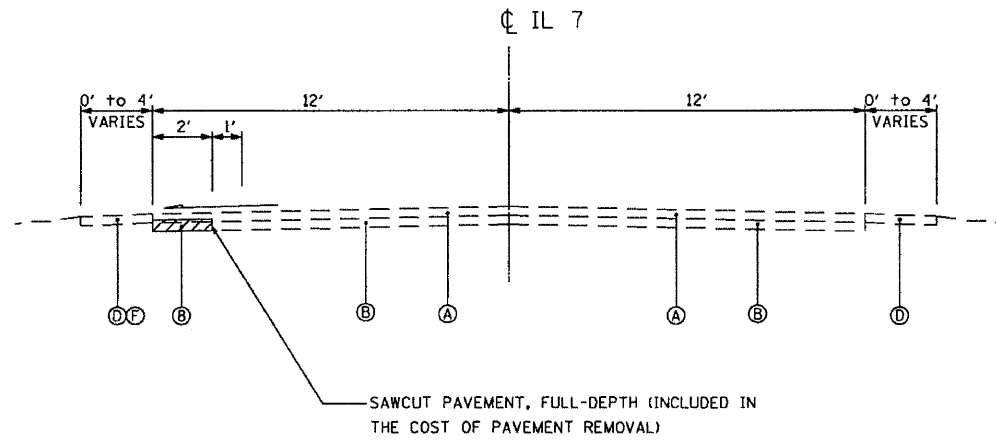

EXISTING TYPICAL SECTION
STA. 263+02 TO STA. 266+47

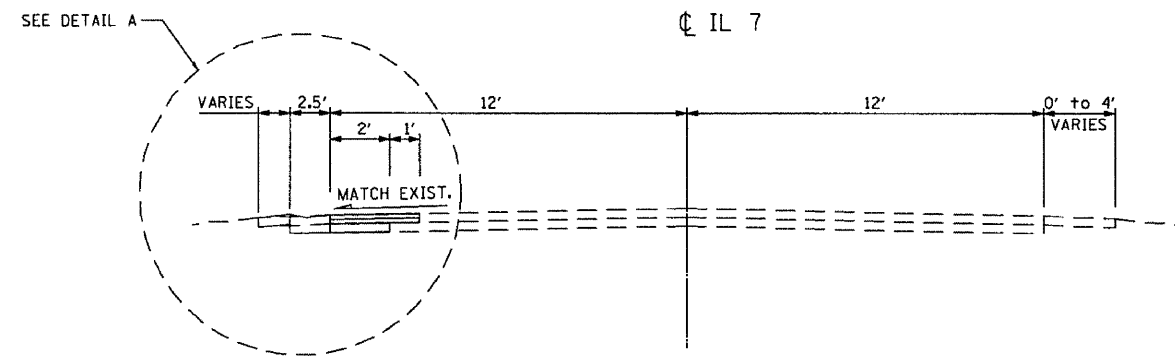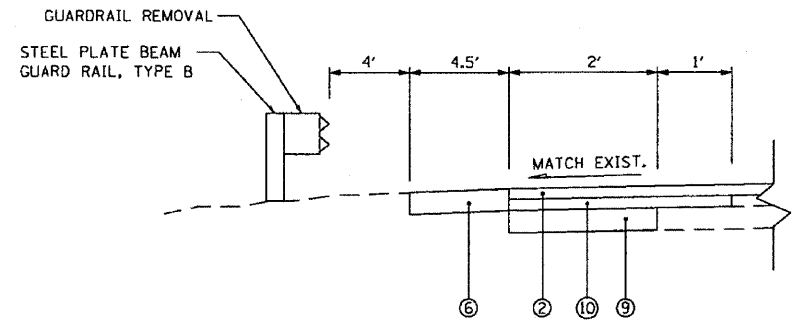

PROPOSED TYPICAL SECTION
STA. 263+02 TO STA. 266+47

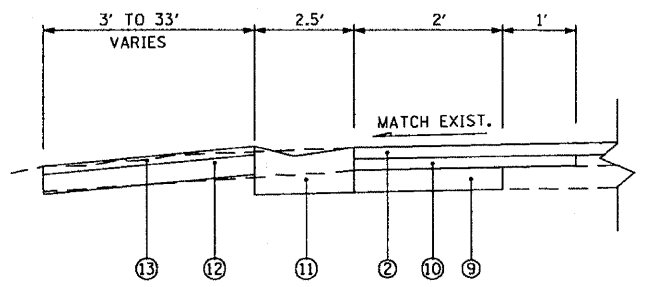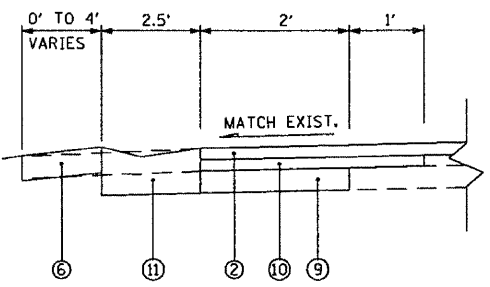

DETAIL A

EXISTING CONDITIONS:

- (A) HOT-MIX ASPHALT SURFACE AND BINDER COURSE, 3" AND VARIES
- (B) PCC BASE COURSE, 10" +/-
- (C) COMBINATION CONCRETE CURB AND GUTTER
- (D) AGGREGATE SHOULDER 6" AND VARIES
- (E) PCC SIDEWALK
- (F) PRIVATE DRIVEWAYS

PROPOSED IMPROVEMENTS:

- (1) HOT-MIX ASPHALT SURFACE REMOVAL, 2 1/2"
- (2) POLYMERIZED HOT-MIX ASPHALT SURFACE COURSE, MIX "F", N90, 1 3/4"
- (3) POLYMERIZED LEVELING BINDER (MACHINE METHOD), IL-4.75, N50, 3/4"
- (4) COMBINATION CONCRETE CURB AND GUTTER REMOVAL AND REPLACEMENT (AS DIRECTED BY ENGINEER)
- (5) CLASS D PATCHES, 10" (DETERMINED BY ENGINEER IN FIELD)
- (6) AGGREGATE WEDGE SHOULDER, TYPE B
- (7) GRADING AND SHAPING SHOULDERS
- (8) PAVEMENT REMOVAL
- (9) PORTLAND CEMENT CONCRETE BASE COURSE, 10"
- (10) POLYMERIZED HOT-MIX ASPHALT BINDER COURSE, IL-19.0, N90, 2-1/4"
- (11) COMBINATION CONCRETE CURB AND GUTTER, TYPE B-6.24, DEPRESSED CURB (TYPICAL)
- (12) HOT-MIX ASPHALT BASE COURSE, 6" (AT DRIVEWAYS ONLY)
- (13) HOT-MIX ASPHALT SURFACE COURSE, MIX "C", N50, 2" (AT DRIVEWAYS ONLY)

A QUANTITY FOR LEVELING BINDER (HAND METHOD) HAS BEEN PROVIDED FOR USE AT PRIVATE ENTRANCES, AROUND HAND HOLES, PRIVATE UTILITY STRUCTURE FRAMES, AND ANY OTHER STRUCTURE FRAMES THAT ARE NOT ABLE TO BE LOWERED UNDER THE ITEM "FRAMES AND LIDS TO BE ADJUSTED (SPECIAL)" AFTER GRINDING OF EXISTING PAVEMENT.

QUANTITIES FOR EARTH EXCAVATION AND AGGREGATE BASE REPAIR HAVE BEEN INCLUDED FOR SUBGRADE FAILURES BELOW THE CLASS D PATCHES

FILE NAME: c:\proj\3368\3368_26\main\proposals\3368_26-05-11.mxd

Ciorba Group, Inc.
CONSULTING ENGINEERS
5507 North Cumberland Avenue, Suite 402
Chicago, Illinois 60658
Tel. 773.775.4009 Fax 773.775.4014


USER NAME: *lanester	DESIGNED: AL	REVISED: -
	DRAWN: AL	REVISED: -
PLOT SCALE: 1/8" = 1' IN.	CHECKED: SNS	REVISED: -
PLOT DATE: 12/3/2009	DATE: 12/11/09	REVISED: -

**STATE OF ILLINOIS
DEPARTMENT OF TRANSPORTATION**

**IL 7 / 159TH STREET
IL 53 (INDEPENDENCE BLVD) TO I-355 (VETERANS MEMORIAL TOLLWAY)
TYPICAL SECTIONS**


SCALE: N.T.S. SHEET NO. 6 OF 35 SHEETS STA. TO STA.

F.A.P. RTE. 351	SECTION (535 B-6R & 536) RS-4	COUNTY WILL	TOTAL SHEETS 35	SHEET NO. 6
FED. ROAD DIST. NO. 1 (ILLINOIS) FED. AID PROJECT			CONTRACT NO. 60H62	

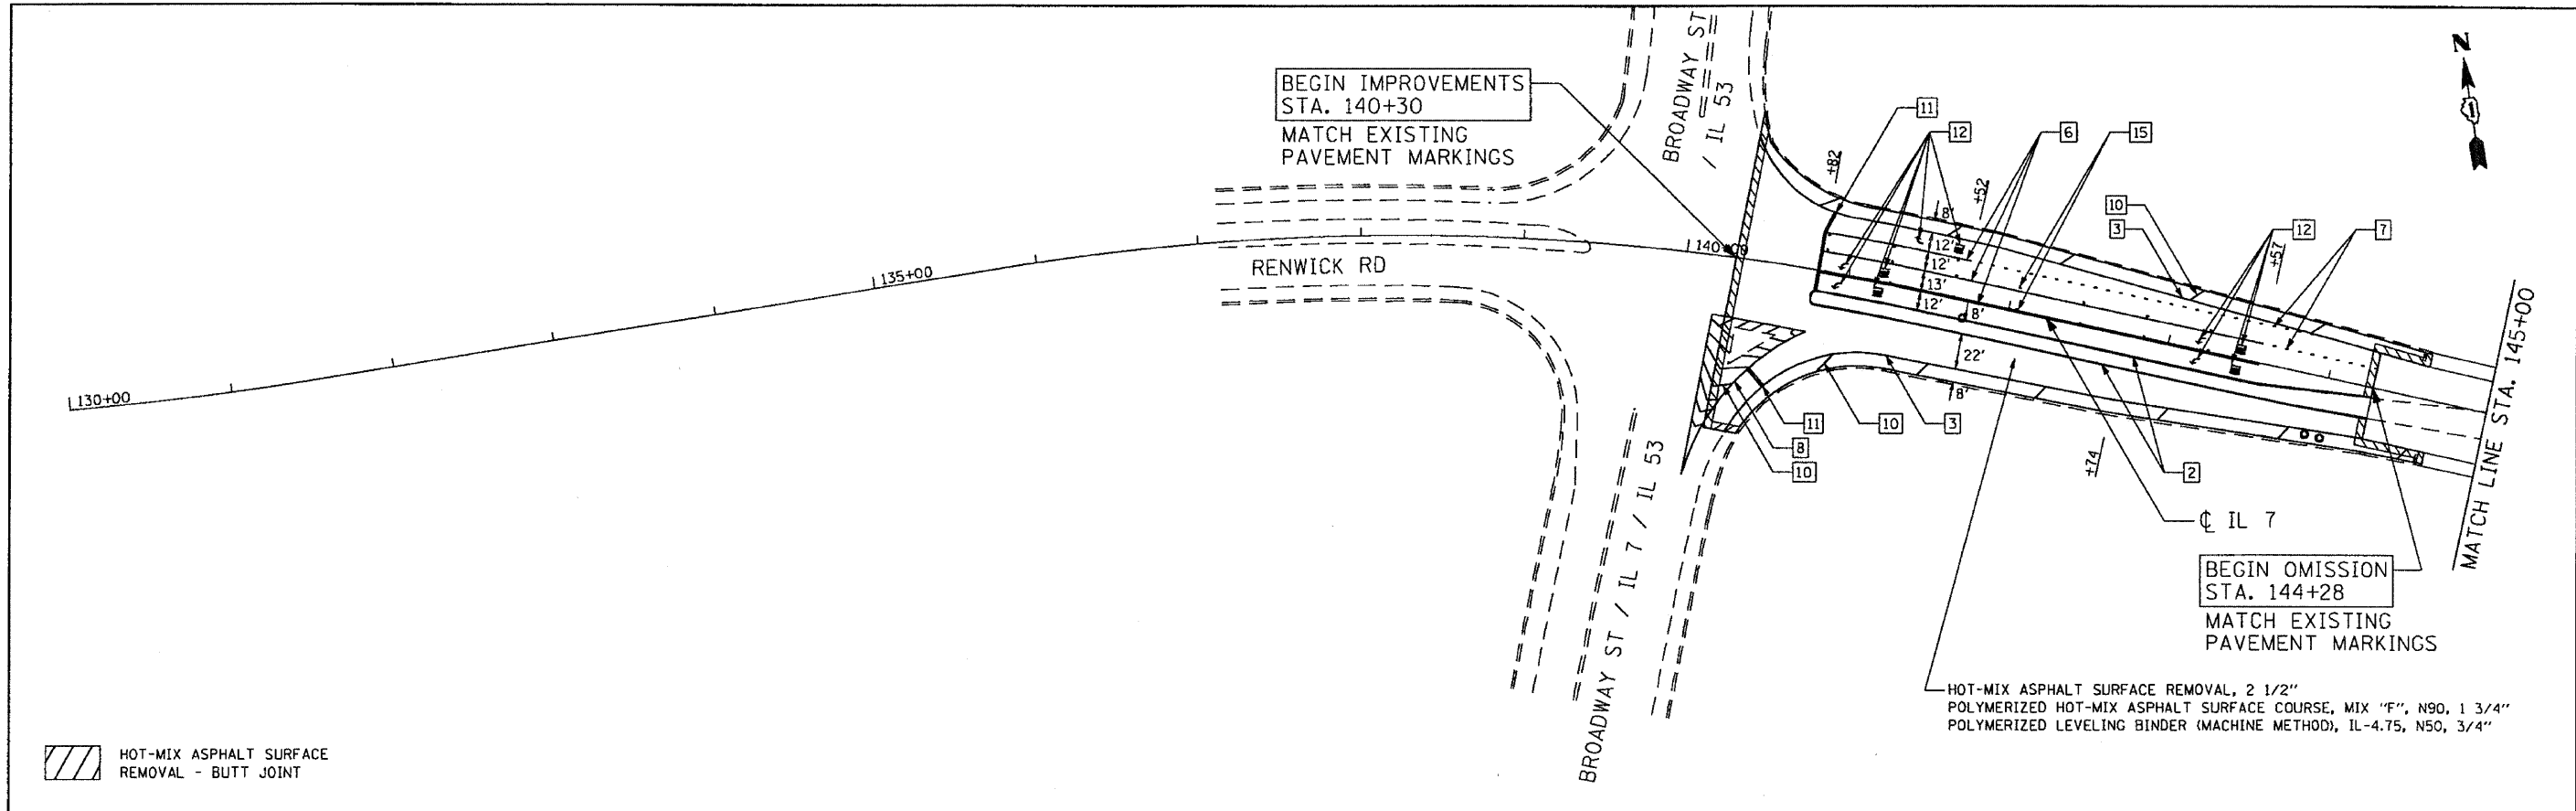

LEGEND:

- | | | | |
|---|--|----|---|
| 1 | THERMOPLASTIC PAVEMENT MARKING - LINE 4" (DOUBLE YELLOW SOLID LINE 11" C-C) | 8 | THERMOPLASTIC PAVEMENT MARKING - LINE 8" (WHITE SOLID LINE) |
| 2 | THERMOPLASTIC PAVEMENT MARKING - LINE 4" (YELLOW SOLID LINE) | 9 | THERMOPLASTIC PAVEMENT MARKING - LINE 12" (YELLOW DIAGONAL LINE) |
| 3 | THERMOPLASTIC PAVEMENT MARKING - LINE 4" (WHITE EDGE LINE) | 10 | THERMOPLASTIC PAVEMENT MARKING - LINE 12" (WHITE SOLID LINE) |
| 4 | THERMOPLASTIC PAVEMENT MARKING - LINE 4" (YELLOW LANE LINE - 10' DASH, 30' SKIP) | 11 | THERMOPLASTIC PAVEMENT MARKING - LINE 24" (WHITE STOP LINE) |
| 5 | THERMOPLASTIC PAVEMENT MARKING - LINE 4" (WHITE LANE LINE - 10' DASH, 30' SKIP) WITH RAISED REFLECTIVE PAVEMENT MARKERS (2 ONE-WAY CRYSTAL MARKER) (80' C-C) | 12 | THERMOPLASTIC PAVEMENT MARKING - LETTERS AND SYMBOLS (TYP.) |
| 6 | THERMOPLASTIC PAVEMENT MARKING - LINE 6" (WHITE SOLID LINE) | 13 | RAISED REFLECTIVE PAVEMENT MARKERS (ONE-WAY AMBER MARKER) (40' C-C) |
| 7 | THERMOPLASTIC PAVEMENT MARKING - LINE 6" (WHITE LANE LINE - 2' DASH, 6' SKIP) | 14 | RAISED REFLECTIVE PAVEMENT MARKERS (TWO-WAY AMBER MARKER) (40' C-C) |
| | | 15 | RAISED REFLECTIVE PAVEMENT MARKERS (ONE-WAY CRYSTAL MARKER) (40' C-C) |

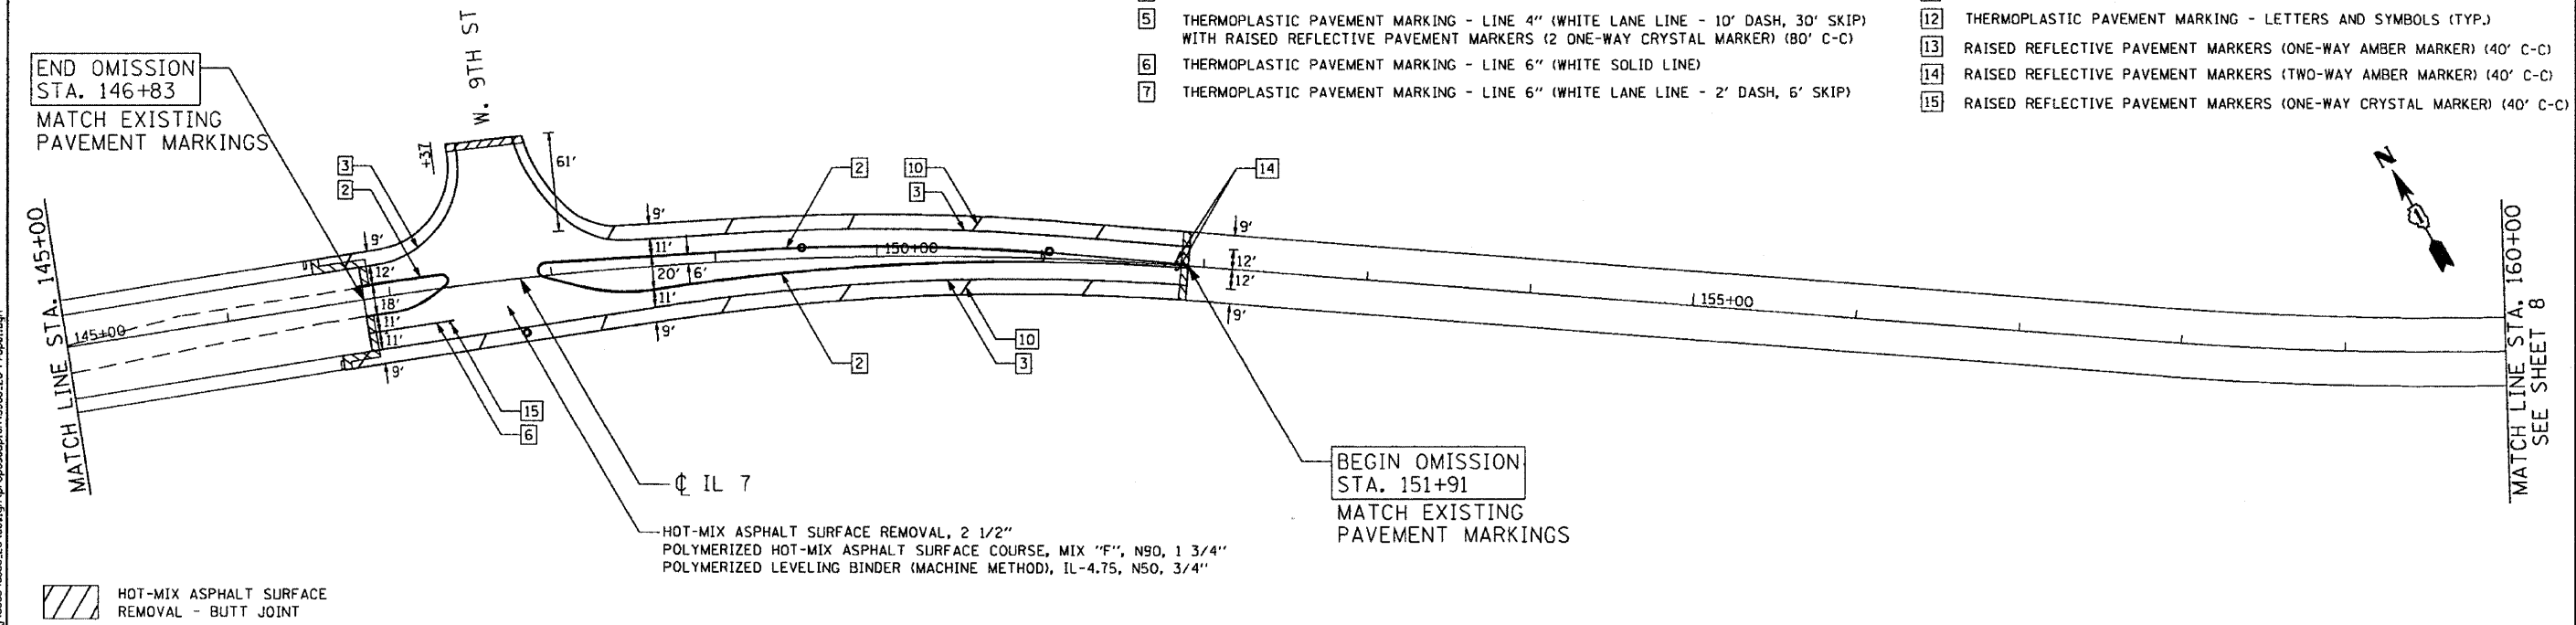

FILE NAME: c:\p\proj\3386\3386_28\dwg\prop\prop\3386_28_P_08.dwg

Ciorba Group, Inc.
 CONSULTING ENGINEERS
 5507 North Cumberland Avenue, Suite 402
 Chicago, Illinois 60658
 Tel. 773.775.4009 Fax 773.775.4014


USER NAME = wlaneaster	DESIGNED - AL	REVISED -
DRAWN - RJR	REVISIONS -	
PLOT SCALE = 100.0000' / IN.	CHECKED - SNS	REVISED -
PLOT DATE = 12/3/2009	DATE = 12/11/09	REVISED -

**STATE OF ILLINOIS
 DEPARTMENT OF TRANSPORTATION**

**IL 7 / 159TH STREET
 IL 53 (INDEPENDENCE BLVD) TO I-355 (VETRANS MEMORIAL TOLLWAY)
 PROPOSED ROADWAY AND PAVEMENT MARKING PLAN**

SCALE: 1"=50' SHEET NO. OF SHEETS STA. TO STA.


F.A.P. RTE. 351	SECTION (535 B-6R & 536) RS-4	COUNTY WILL	TOTAL SHEETS 35	SHEET NO. 7
CONTRACT NO. 60H62			FED. ROAD DIST. NO. 1 ILLINOIS FED. AID PROJECT	

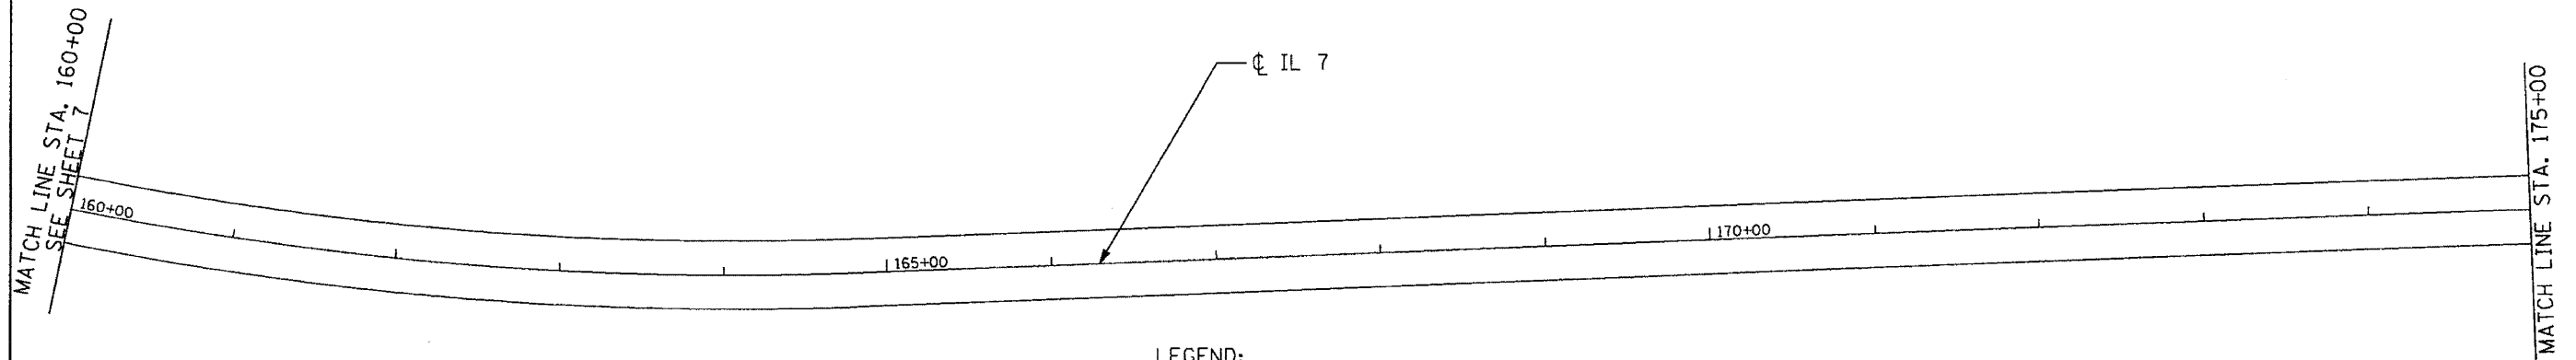

LEGEND:

- | | |
|---|--|
| <ul style="list-style-type: none"> 1 THERMOPLASTIC PAVEMENT MARKING - LINE 4" (DOUBLE YELLOW SOLID LINE 11" C-C) 2 THERMOPLASTIC PAVEMENT MARKING - LINE 4" (YELLOW SOLID LINE) 3 THERMOPLASTIC PAVEMENT MARKING - LINE 4" (WHITE EDGE LINE) 4 THERMOPLASTIC PAVEMENT MARKING - LINE 4" (YELLOW LANE LINE - 10' DASH, 30' SKIP) 5 THERMOPLASTIC PAVEMENT MARKING - LINE 4" (WHITE LANE LINE - 10' DASH, 30' SKIP) WITH RAISED REFLECTIVE PAVEMENT MARKERS (2 ONE-WAY CRYSTAL MARKER) (80' C-C) 6 THERMOPLASTIC PAVEMENT MARKING - LINE 6" (WHITE SOLID LINE) 7 THERMOPLASTIC PAVEMENT MARKING - LINE 6" (WHITE LANE LINE - 2' DASH, 6' SKIP) | <ul style="list-style-type: none"> 8 THERMOPLASTIC PAVEMENT MARKING - LINE 8" (WHITE SOLID LINE) 9 THERMOPLASTIC PAVEMENT MARKING - LINE 12" (YELLOW DIAGONAL LINE) 10 THERMOPLASTIC PAVEMENT MARKING - LINE 12" (WHITE SOLID LINE) 11 THERMOPLASTIC PAVEMENT MARKING - LINE 24" (WHITE STOP LINE) 12 THERMOPLASTIC PAVEMENT MARKING - LETTERS AND SYMBOLS (TYP.) 13 RAISED REFLECTIVE PAVEMENT MARKERS (ONE-WAY AMBER MARKER) (40' C-C) 14 RAISED REFLECTIVE PAVEMENT MARKERS (TWO-WAY AMBER MARKER) (40' C-C) 15 RAISED REFLECTIVE PAVEMENT MARKERS (ONE-WAY CRYSTAL MARKER) (40' C-C) |
|---|--|

HOT-MIX ASPHALT SURFACE REMOVAL - BUTT JOINT

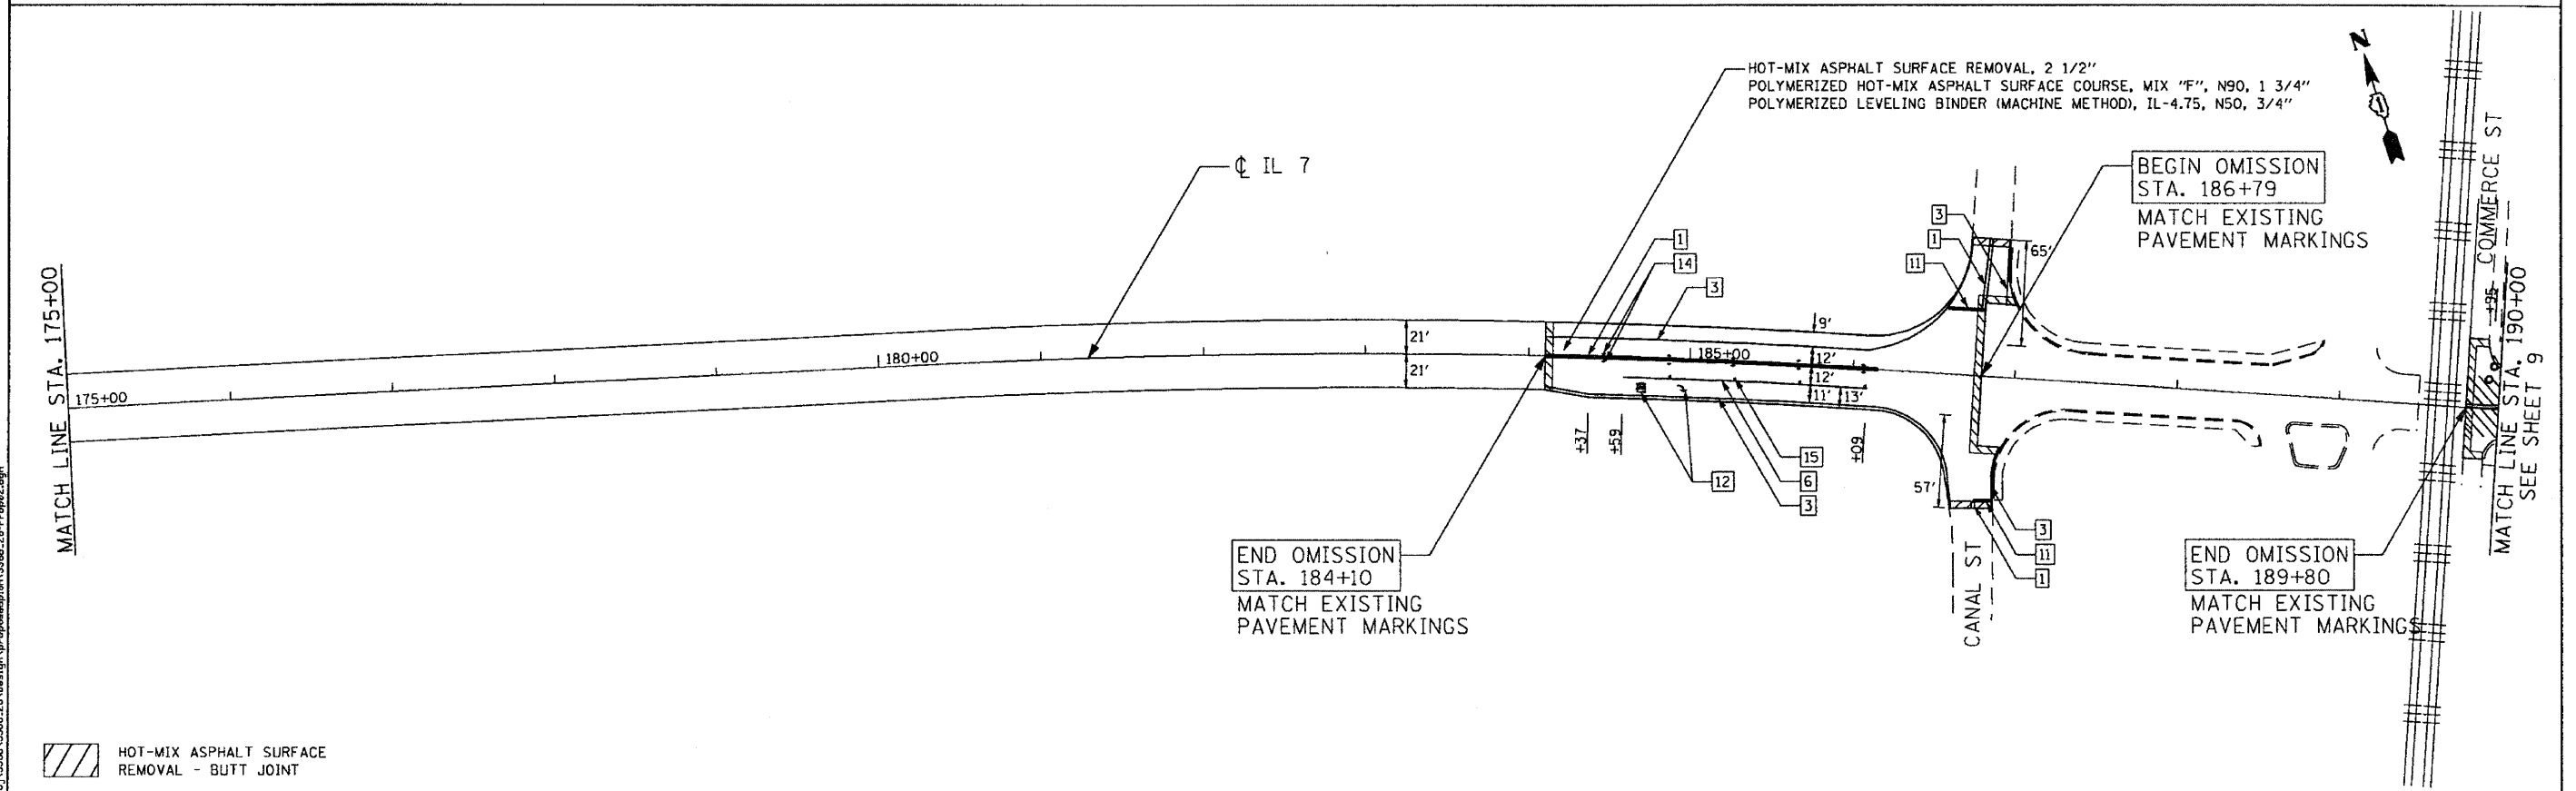

HOT-MIX ASPHALT SURFACE REMOVAL - BUTT JOINT

FILE NAME: c:\p\proj\3266\3266_28\design\proposals\plan\3266_28-PropR2.dwg

Ciorba Group, Inc.
 CONSULTING ENGINEERS
 5507 North Cumberland Avenue, Suite 402
 Chicago, Illinois 60658
 Tel. 773.775.4008 Fax 773.775.4014



USER NAME = wlancoaster	DESIGNED - AL	REVISED -
DRAWN - RJR	REVISIONS -	
PLOT SCALE = 100.0000 / IN.	CHECKED - SNS	REVISED -
PLOT DATE = 12/3/2009	DATE - 12/11/09	REVISED -

**STATE OF ILLINOIS
 DEPARTMENT OF TRANSPORTATION**

**IL 7 / 159TH STREET
 IL 53 (INDEPENDENCE BLVD) TO I-355 (VETERANS MEMORIAL TOLLWAY)
 PROPOSED ROADWAY AND PAVEMENT MARKING PLAN**

SCALE: 1"=50' SHEET NO. OF SHEETS STA. TO STA.

F.A.P. RTE.	SECTION	COUNTY	TOTAL SHEETS	SHEET NO.
351	(535 B-6R & 536) RS-4	WILL	35	8
FED. ROAD DIST. NO. 1 ILLINOIS FED. AID PROJECT			CONTRACT NO. 60H62	

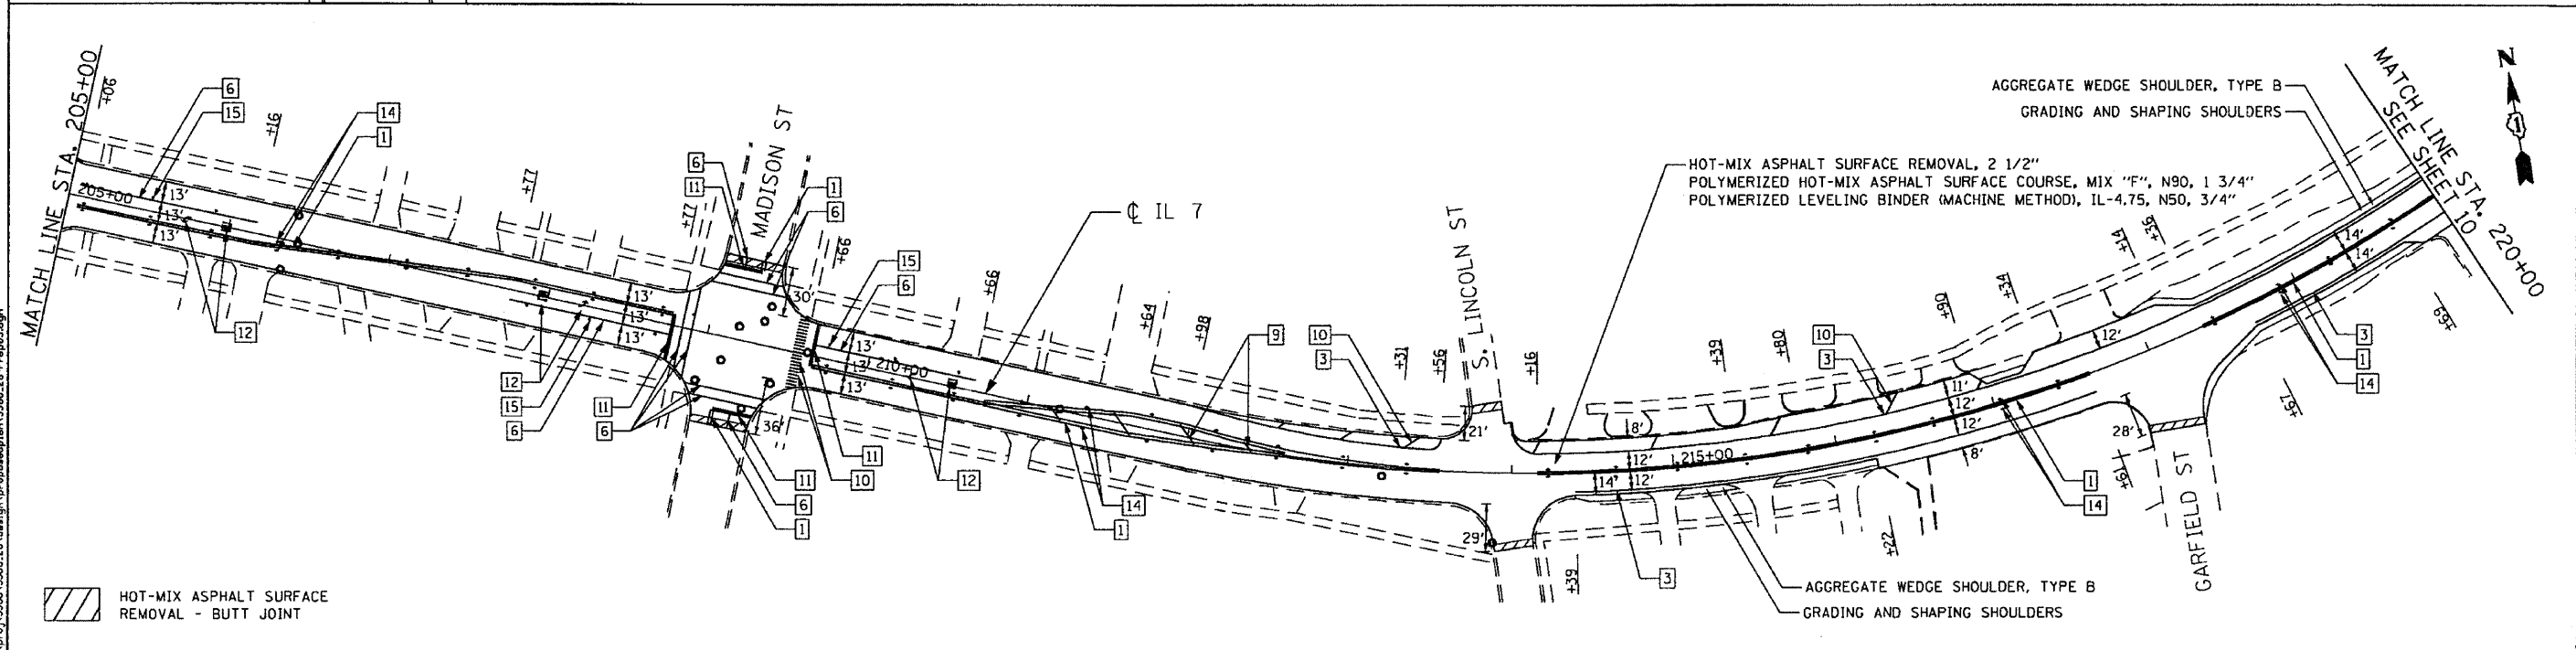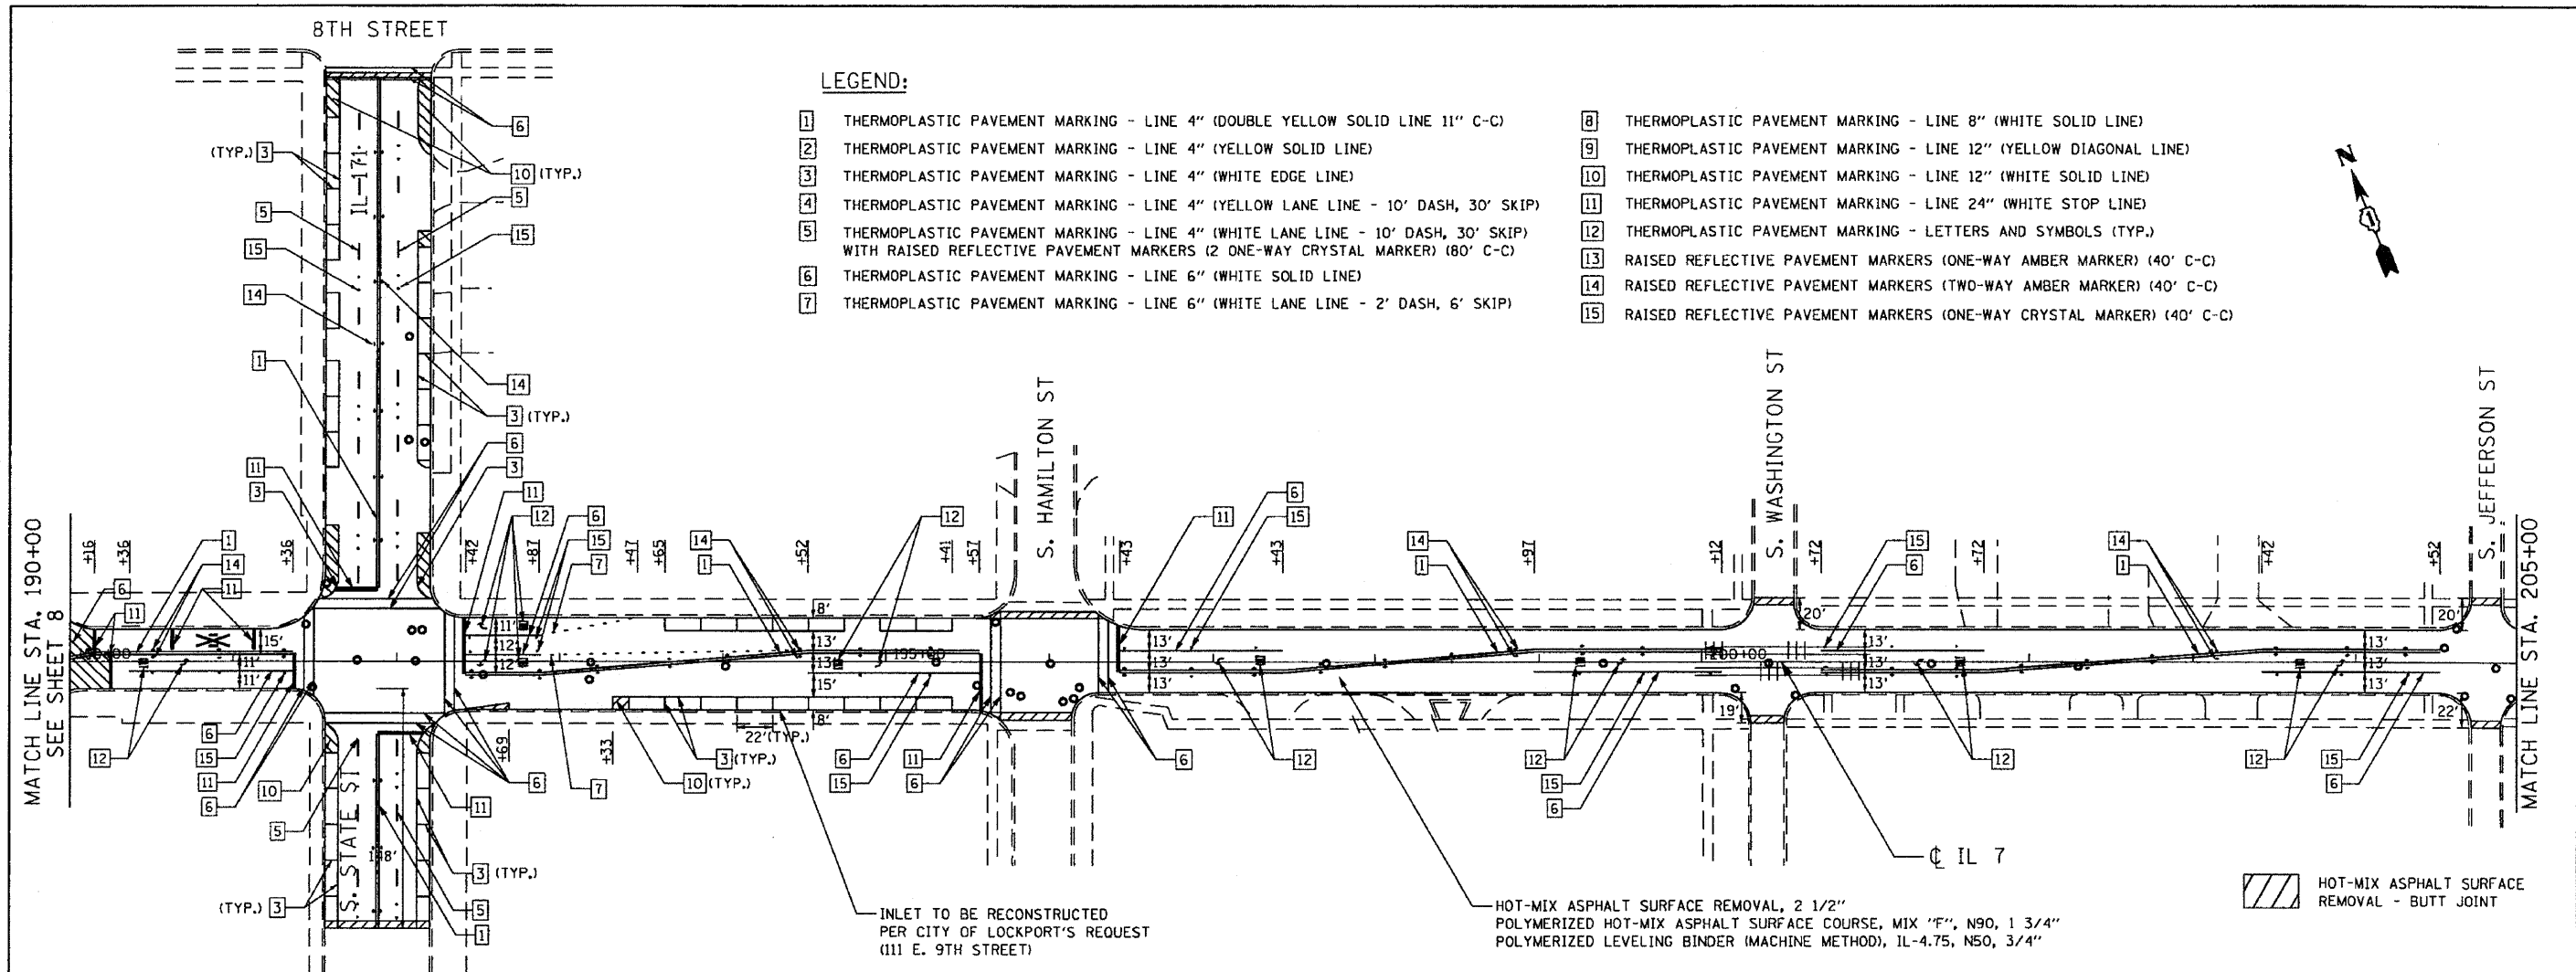

FILE NAME: I:\projects\3368\3368_28\dwg\pav\pavmarking\13368_28_Pav02.dwg
 USER: rjr
 PLOT DATE: 12/3/2009

Ciorba Group, Inc.
 CONSULTING ENGINEERS
 5507 North Cumberland Avenue, Suite 402
 Chicago, Illinois 60658
 Tel. 773.775.4008 Fax 773.775.4014


USER NAME: w Lancaster	DESIGNED: AL	REVISED: -
DRAWN: RJR	CHECKED: SNS	DATE: 12/11/09
PLOT SCALE: 1/8" = 1'-0"	PLOT DATE: 12/3/2009	

**STATE OF ILLINOIS
 DEPARTMENT OF TRANSPORTATION**

**IL 7 / 159TH STREET
 IL 53 (INDEPENDENCE BLVD) TO I-355 (VETERANS MEMORIAL TOLLWAY)
 PROPOSED ROADWAY AND PAVEMENT MARKING PLAN**

SCALE: 1" = 50' SHEET NO. OF SHEETS STA. TO STA.



F.A.P. RTE. 351	SECTION 1535 B-6R & 5361 RS-4	COUNTY WILL	TOTAL SHEETS 35	SHEET NO. 9
FED. ROAD DIST. NO. 1 ILLINDIS			FED. AID PROJECT	

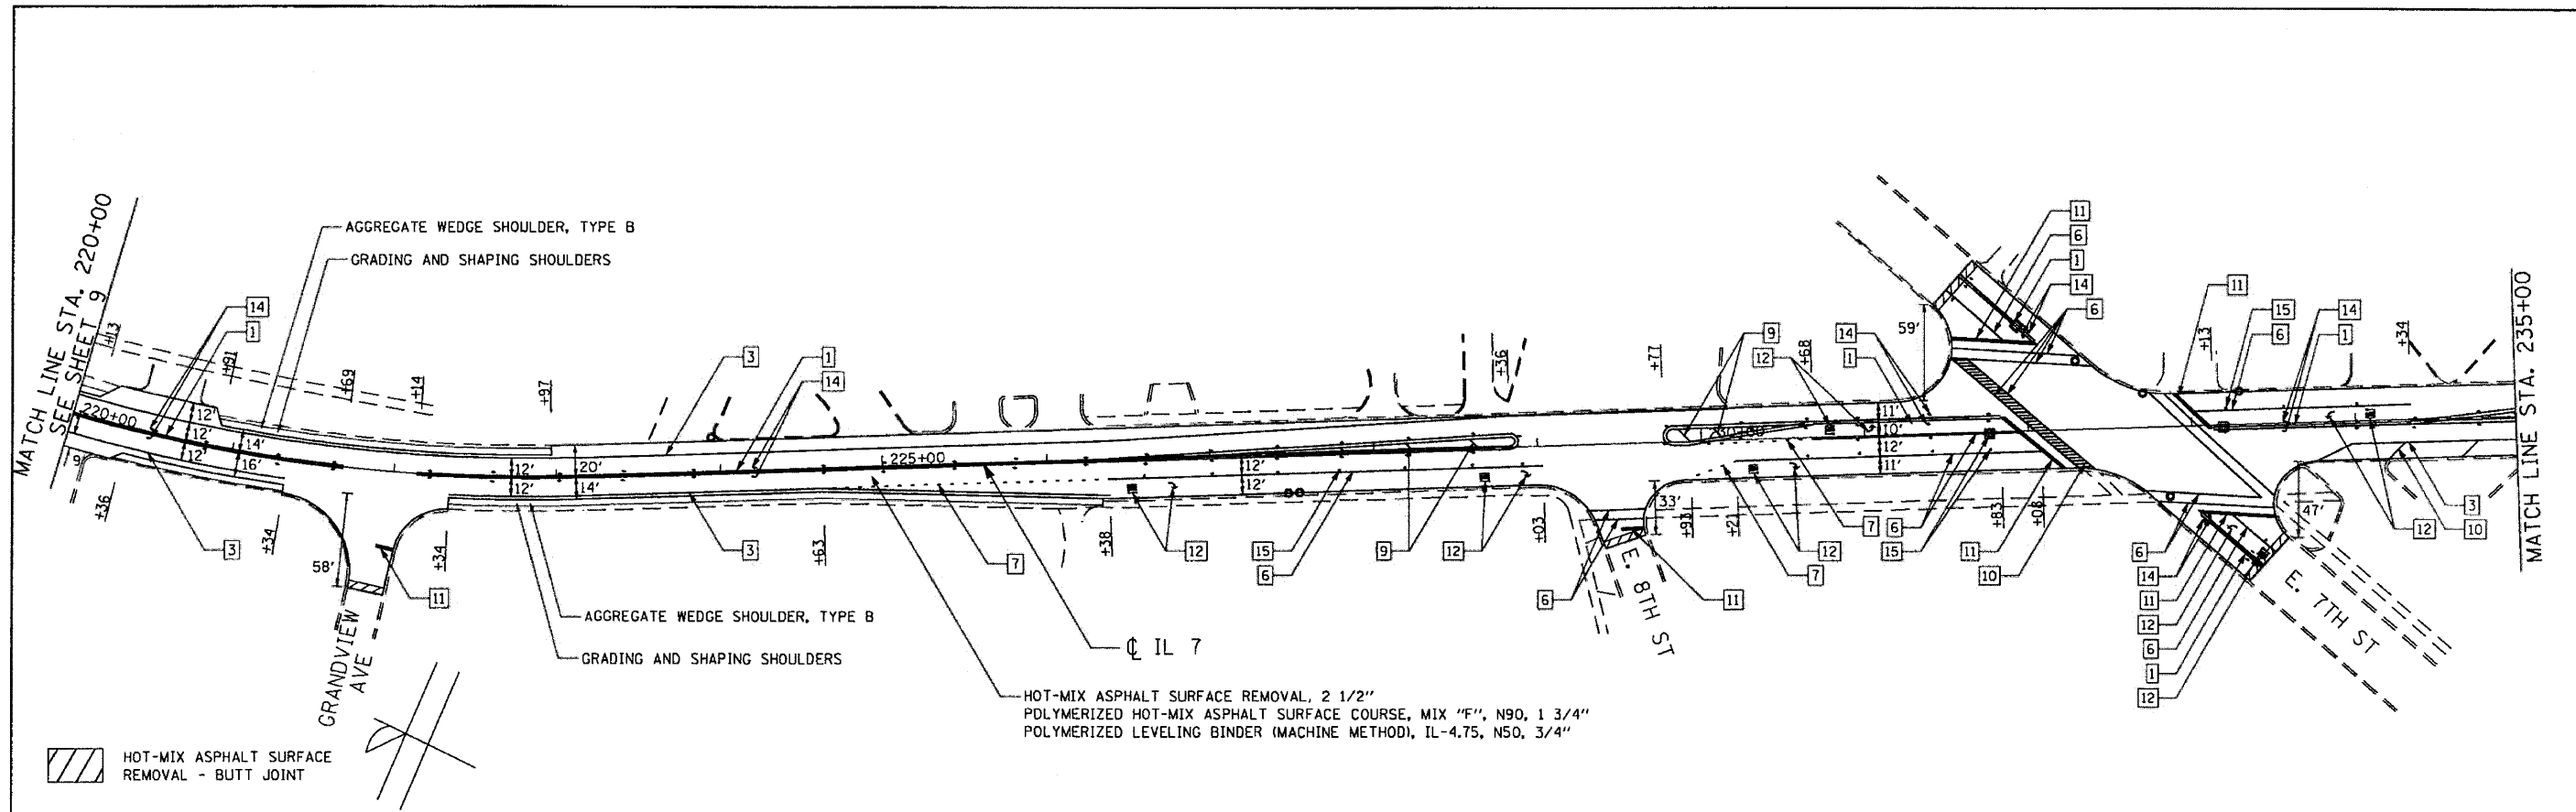

HOT-MIX ASPHALT SURFACE REMOVAL - BUTT JOINT

LEGEND:




- | | |
|---|--|
| <ul style="list-style-type: none"> 1 THERMOPLASTIC PAVEMENT MARKING - LINE 4" (DOUBLE YELLOW SOLID LINE 11" C-C) 2 THERMOPLASTIC PAVEMENT MARKING - LINE 4" (YELLOW SOLID LINE) 3 THERMOPLASTIC PAVEMENT MARKING - LINE 4" (WHITE EDGE LINE) 4 THERMOPLASTIC PAVEMENT MARKING - LINE 4" (YELLOW LANE LINE - 10' DASH, 30' SKIP) 5 THERMOPLASTIC PAVEMENT MARKING - LINE 4" (WHITE LANE LINE - 10' DASH, 30' SKIP) WITH RAISED REFLECTIVE PAVEMENT MARKERS (2 ONE-WAY CRYSTAL MARKER) (80' C-C) 6 THERMOPLASTIC PAVEMENT MARKING - LINE 6" (WHITE SOLID LINE) 7 THERMOPLASTIC PAVEMENT MARKING - LINE 6" (WHITE LANE LINE - 2' DASH, 6' SKIP) | <ul style="list-style-type: none"> 8 THERMOPLASTIC PAVEMENT MARKING - LINE 8" (WHITE SOLID LINE) 9 THERMOPLASTIC PAVEMENT MARKING - LINE 12" (YELLOW DIAGONAL LINE) 10 THERMOPLASTIC PAVEMENT MARKING - LINE 12" (WHITE SOLID LINE) 11 THERMOPLASTIC PAVEMENT MARKING - LINE 24" (WHITE STOP LINE) 12 THERMOPLASTIC PAVEMENT MARKING - LETTERS AND SYMBOLS (TYP.) 13 RAISED REFLECTIVE PAVEMENT MARKERS (ONE-WAY AMBER MARKER) (40' C-C) 14 RAISED REFLECTIVE PAVEMENT MARKERS (TWO-WAY AMBER MARKER) (40' C-C) 15 RAISED REFLECTIVE PAVEMENT MARKERS (ONE-WAY CRYSTAL MARKER) (40' C-C) |
|---|--|

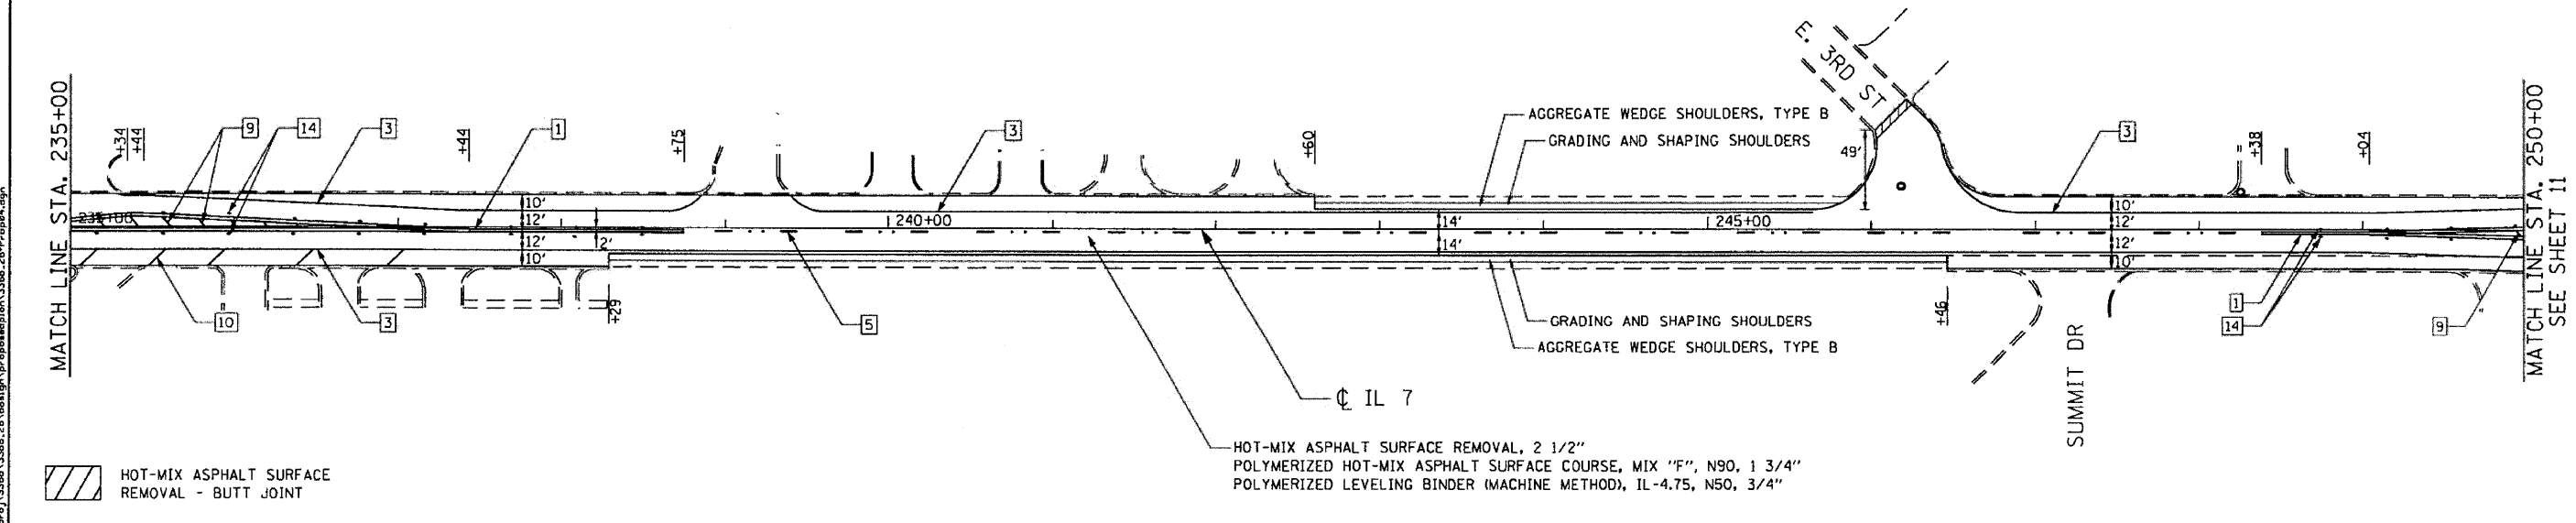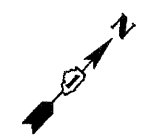

HOT-MIX ASPHALT SURFACE REMOVAL - BUTT JOINT

FILE NAME: c:\p\proj\3388\28\design\proposals\plan\3388-28-Proposed.rdw

<p>Ciorba Group, Inc. CONSULTING ENGINEERS 5507 North Cumberland Avenue, Suite 402 Chicago, Illinois 60658 Tel. 773.775.4009 Fax 773.775.4014</p>	USER NAME = wloncester	DESIGNED - AL	REVISED -	<p>STATE OF ILLINOIS DEPARTMENT OF TRANSPORTATION</p>	IL 7/159TH STREET IL 53 (INDEPENDENCE BLVD) TO I-355 (VETRANS MEMORIAL TOLLWAY) PROPOSED ROADWAY AND PAVEMENT MARKING PLAN			F.A.P. RTE. 351	SECTION (535 B-6R & 536) RS-4	COUNTY WILL	TOTAL SHEETS 35	SHEET NO. 10	
	PLOT SCALE = 100.0000' / IN.	CHECKED - SNS	REVISED -		SCALE: 1"=50'	SHEET NO. OF SHEETS	STA. TO STA.	FED. ROAD DIST. NO. 1 ILLINOIS FED. AID PROJECT					
	PLOT DATE = 12/3/2009	DATE = 12/11/09	REVISED -										

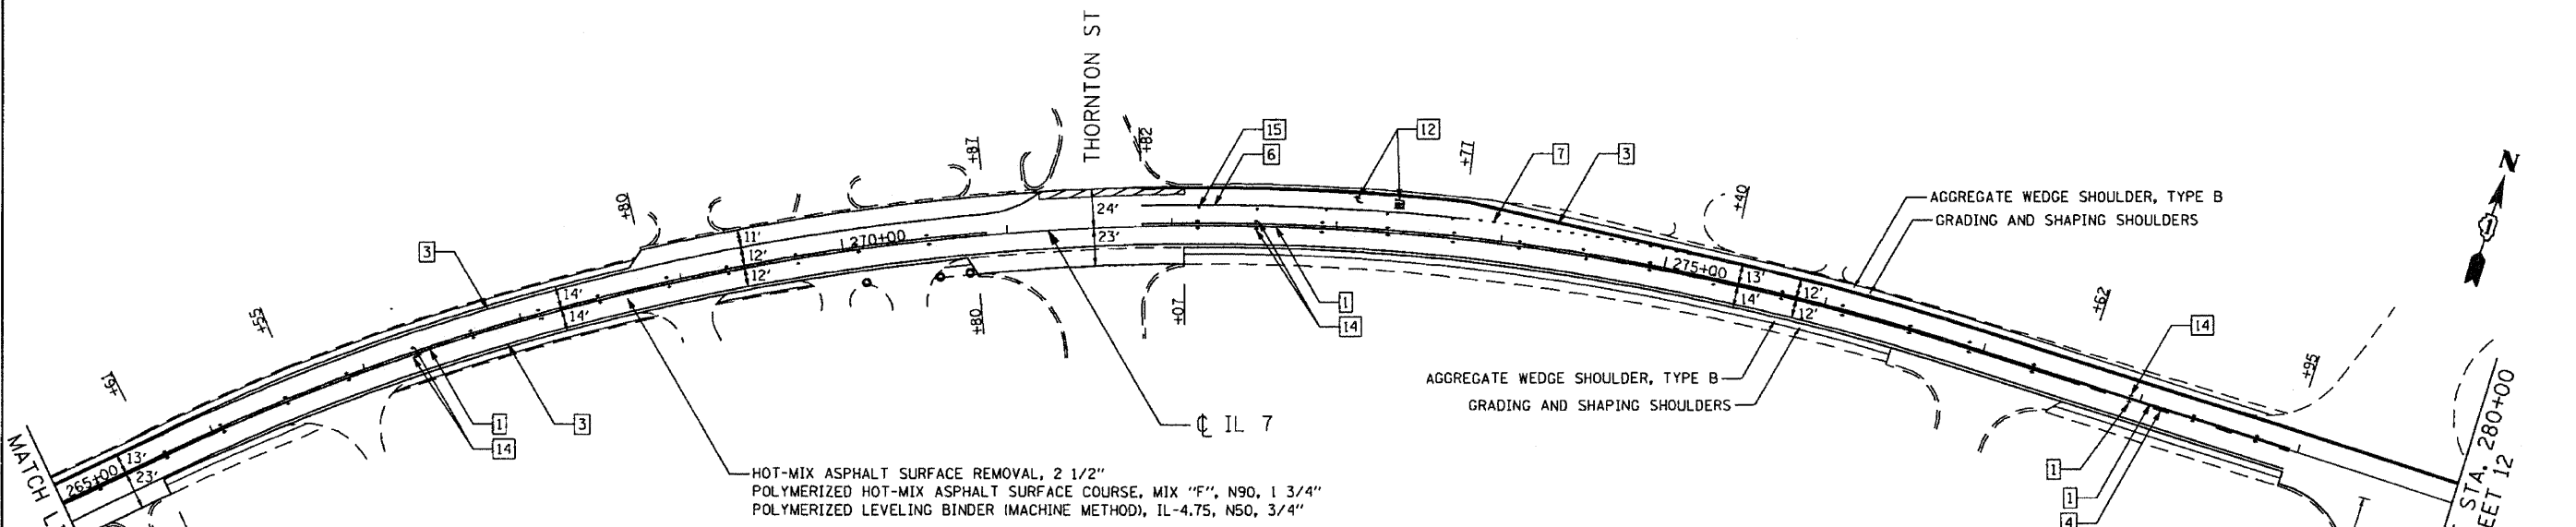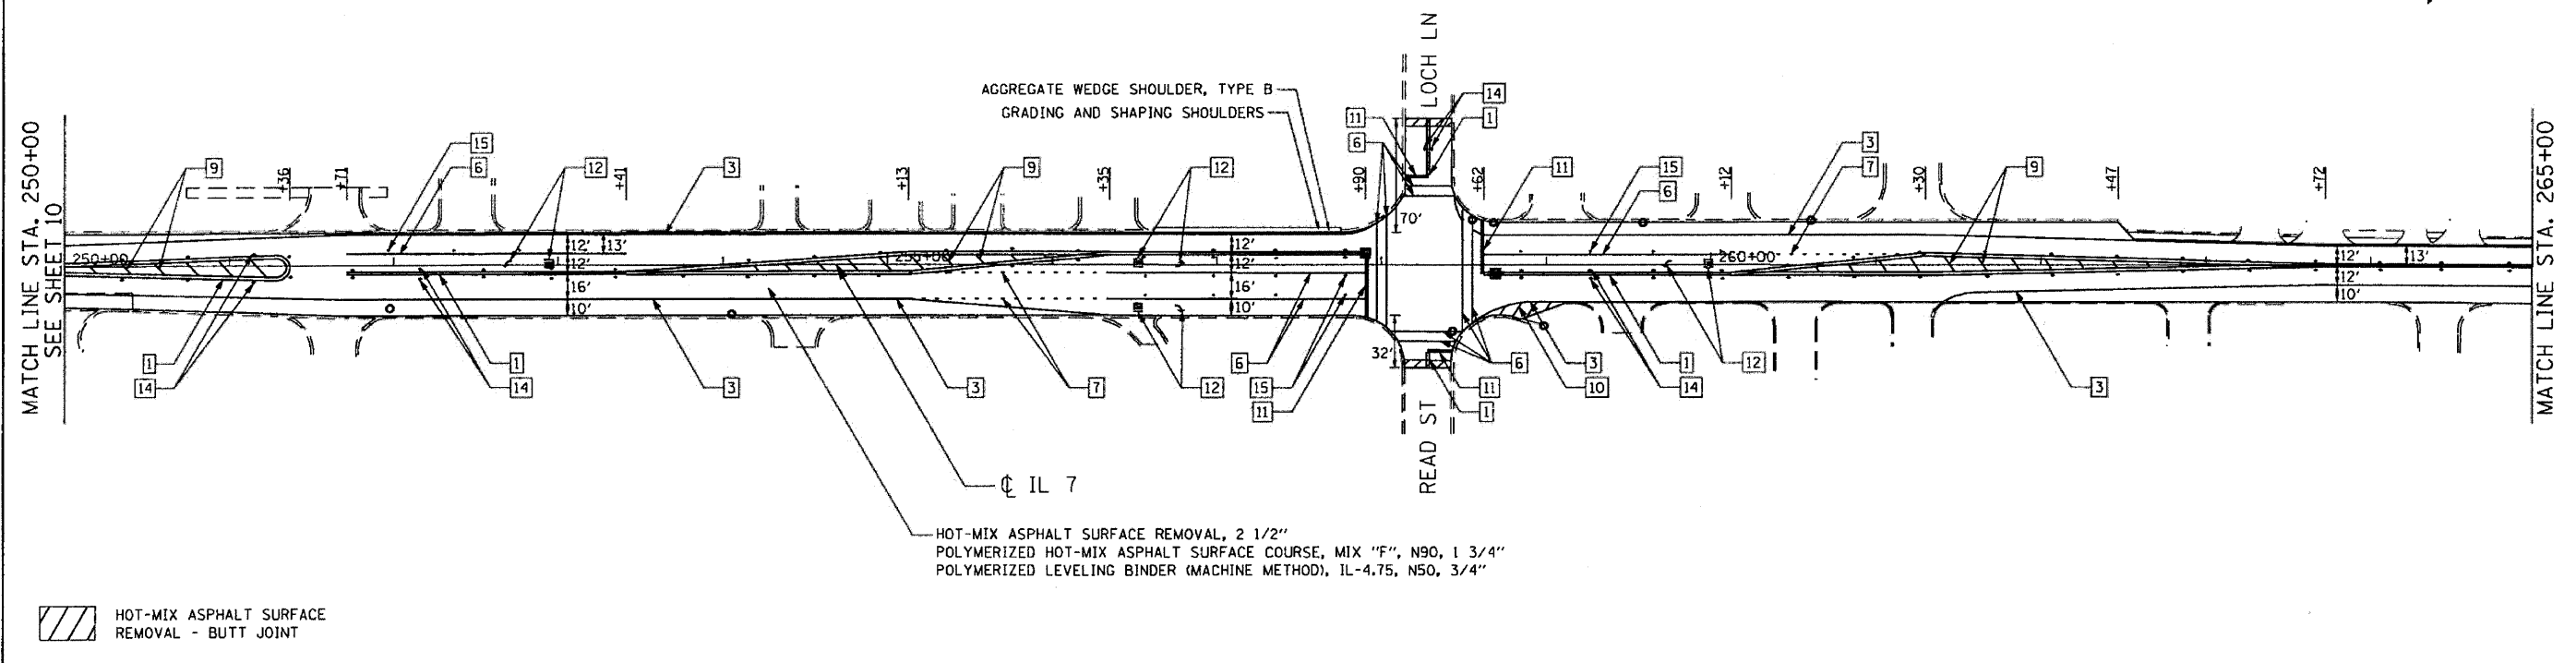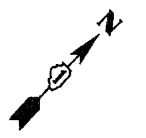

- LEGEND:**
- | | |
|---|--|
| <ul style="list-style-type: none"> 1 THERMOPLASTIC PAVEMENT MARKING - LINE 4" (DOUBLE YELLOW SOLID LINE 11" C-C) 2 THERMOPLASTIC PAVEMENT MARKING - LINE 4" (YELLOW SOLID LINE) 3 THERMOPLASTIC PAVEMENT MARKING - LINE 4" (WHITE EDGE LINE) 4 THERMOPLASTIC PAVEMENT MARKING - LINE 4" (YELLOW LANE LINE - 10' DASH, 30' SKIP) 5 THERMOPLASTIC PAVEMENT MARKING - LINE 4" (WHITE LANE LINE - 10' DASH, 30' SKIP) WITH RAISED REFLECTIVE PAVEMENT MARKERS (2 ONE-WAY CRYSTAL MARKER) (80' C-C) 6 THERMOPLASTIC PAVEMENT MARKING - LINE 6" (WHITE SOLID LINE) 7 THERMOPLASTIC PAVEMENT MARKING - LINE 6" (WHITE LANE LINE - 2' DASH, 6' SKIP) | <ul style="list-style-type: none"> 8 THERMOPLASTIC PAVEMENT MARKING - LINE 8" (WHITE SOLID LINE) 9 THERMOPLASTIC PAVEMENT MARKING - LINE 12" (YELLOW DIAGONAL LINE) 10 THERMOPLASTIC PAVEMENT MARKING - LINE 12" (WHITE SOLID LINE) 11 THERMOPLASTIC PAVEMENT MARKING - LINE 24" (WHITE STOP LINE) 12 THERMOPLASTIC PAVEMENT MARKING - LETTERS AND SYMBOLS (TYP.) 13 RAISED REFLECTIVE PAVEMENT MARKERS (ONE-WAY AMBER MARKER) (40' C-C) 14 RAISED REFLECTIVE PAVEMENT MARKERS (TWO-WAY AMBER MARKER) (40' C-C) 15 RAISED REFLECTIVE PAVEMENT MARKERS (ONE-WAY CRYSTAL MARKER) (40' C-C) |
|---|--|

FILE NAME: s:\projects\33061\33061_28\rdwg\pavement\plan\33061_28_Pav08.dwg

Ciorba Group, Inc.
 CONSULTING ENGINEERS
 5507 North Cumberland Avenue, Suite 402
 Chicago, Illinois 60658
 Tel. 773.775.4000 Fax 773.775.4014


USER NAME: ulancostar	DESIGNED: AL	REVISED: -
PLDT SCALE: 1/8" = 100'-0"	DRAWN: RJR	REVISED: -
PLDT DATE: 12/3/2009	CHECKED: SNS	REVISED: -
	DATE: 12/11/09	REVISED: -

**STATE OF ILLINOIS
 DEPARTMENT OF TRANSPORTATION**

**IL 7 / 159TH STREET
 IL 53 (INDEPENDENCE BLVD) TO I-355 (VETRANS MEMORIAL TOLLWAY)
 PROPOSED ROADWAY AND PAVEMENT MARKING PLAN**


SCALE: 1"=50' SHEET NO. OF SHEETS STA. TO STA.

F.A.P. RTE. 351	SECTION (535 B-6R & 536) RS-4	COUNTY WILL	TOTAL SHEETS 35	SHEET NO. 11
FED. ROAD DIST. NO. 1 ILLINOIS FED. AID PROJECT			CONTRACT NO. 60H62	

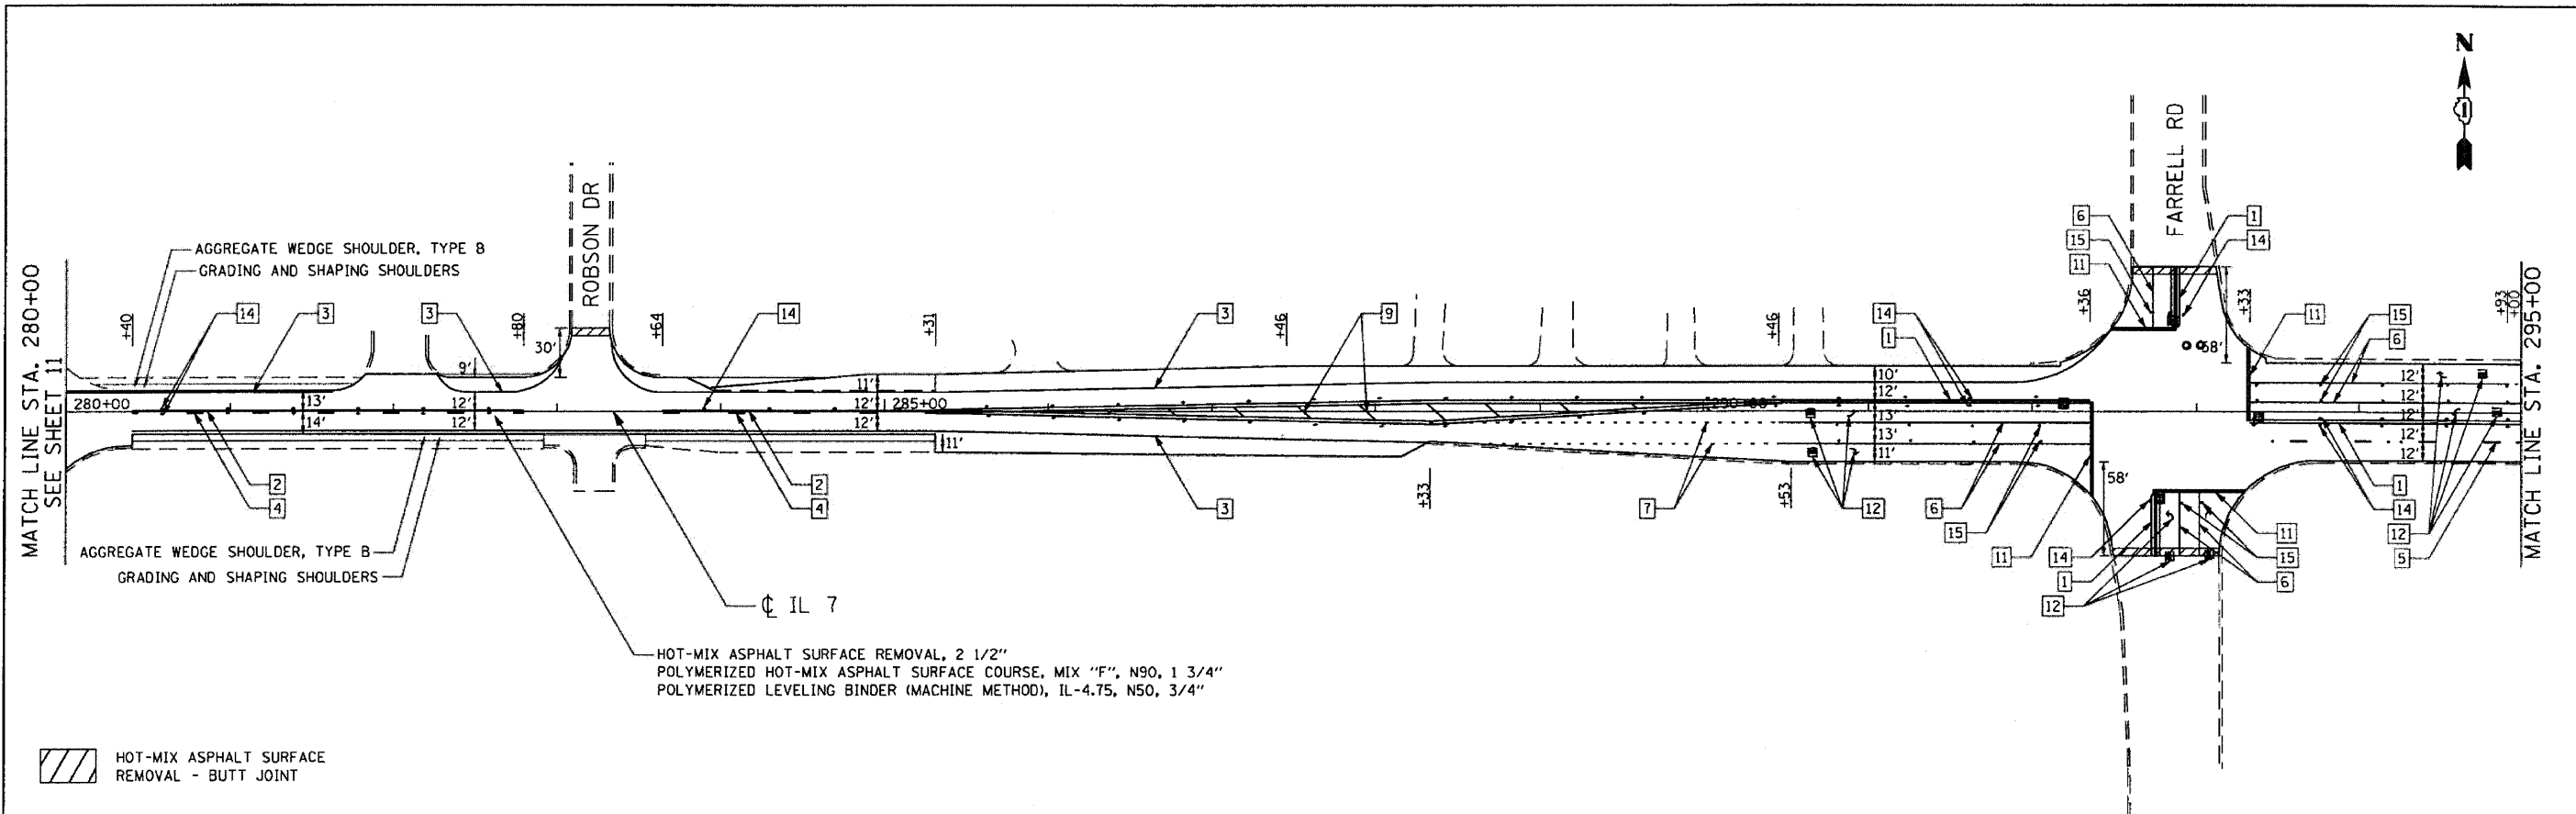

LEGEND:

- 1 THERMOPLASTIC PAVEMENT MARKING - LINE 4" (DOUBLE YELLOW SOLID LINE 11" C-C)
- 2 THERMOPLASTIC PAVEMENT MARKING - LINE 4" (YELLOW SOLID LINE)
- 3 THERMOPLASTIC PAVEMENT MARKING - LINE 4" (WHITE EDGE LINE)
- 4 THERMOPLASTIC PAVEMENT MARKING - LINE 4" (YELLOW LANE LINE - 10' DASH, 30' SKIP)
- 5 THERMOPLASTIC PAVEMENT MARKING - LINE 4" (WHITE LANE LINE - 10' DASH, 30' SKIP) WITH RAISED REFLECTIVE PAVEMENT MARKERS (2 ONE-WAY CRYSTAL MARKER) (80' C-C)
- 6 THERMOPLASTIC PAVEMENT MARKING - LINE 6" (WHITE SOLID LINE)
- 7 THERMOPLASTIC PAVEMENT MARKING - LINE 6" (WHITE LANE LINE - 2' DASH, 6' SKIP)
- 8 THERMOPLASTIC PAVEMENT MARKING - LINE 8" (WHITE SOLID LINE)
- 9 THERMOPLASTIC PAVEMENT MARKING - LINE 12" (YELLOW DIAGONAL LINE)
- 10 THERMOPLASTIC PAVEMENT MARKING - LINE 12" (WHITE SOLID LINE)
- 11 THERMOPLASTIC PAVEMENT MARKING - LINE 24" (WHITE STOP LINE)
- 12 THERMOPLASTIC PAVEMENT MARKING - LETTERS AND SYMBOLS (TYP.)
- 13 RAISED REFLECTIVE PAVEMENT MARKERS (ONE-WAY AMBER MARKER) (40' C-C)
- 14 RAISED REFLECTIVE PAVEMENT MARKERS (TWO-WAY AMBER MARKER) (40' C-C)
- 15 RAISED REFLECTIVE PAVEMENT MARKERS (ONE-WAY CRYSTAL MARKER) (40' C-C)

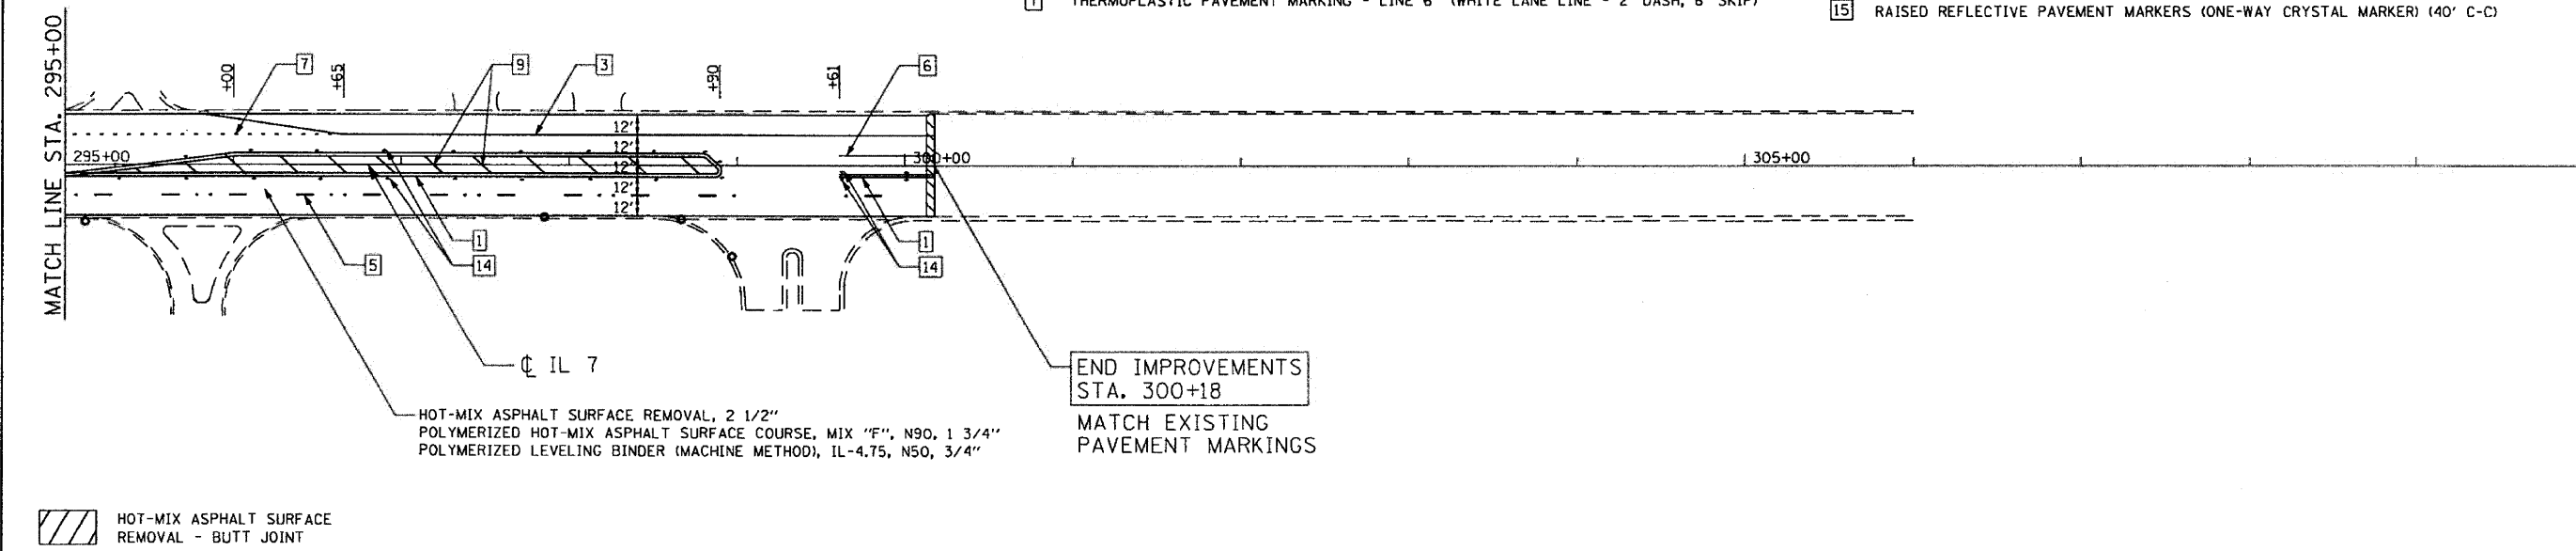

FILE NAME: s:\projects\3186\3186_28\design\proposals\plan\3186_28_Proposed.dwg

Ciorba Group, Inc.
CONSULTING ENGINEERS
5507 North Cumberland Avenue, Suite 402
Chicago, Illinois 60658
Tel: 773.775.4008 Fax: 773.775.4014



USER NAME = wloncstar	DESIGNED - AL	REVISED -
PLDT SCALE = 1/8"=20' / IN.	DRAWN - RJR	REVISED -
PLDT DATE = 12/3/2009	CHECKED - SNS	REVISED -
	DATE = 12/11/09	REVISED -

**STATE OF ILLINOIS
DEPARTMENT OF TRANSPORTATION**

**IL 7 / 159TH STREET
IL 53 (INDEPENDENCE BLVD) TO I-355 (VETERANS MEMORIAL TOLLWAY)
PROPOSED ROADWAY AND PAVEMENT MARKING PLAN**



SCALE: 1"=50' SHEET NO. OF SHEETS STA. TO STA.

F.A.P. RTE.	SECTION	COUNTY	TOTAL SHEETS	SHEET NO.
351	(S35 B-6R & 536) RS-4	WILL	35	12
FED. ROAD DIST. NO. 1 (ILLINOIS) FED. AID PROJECT			CONTRACT NO. 60H62	

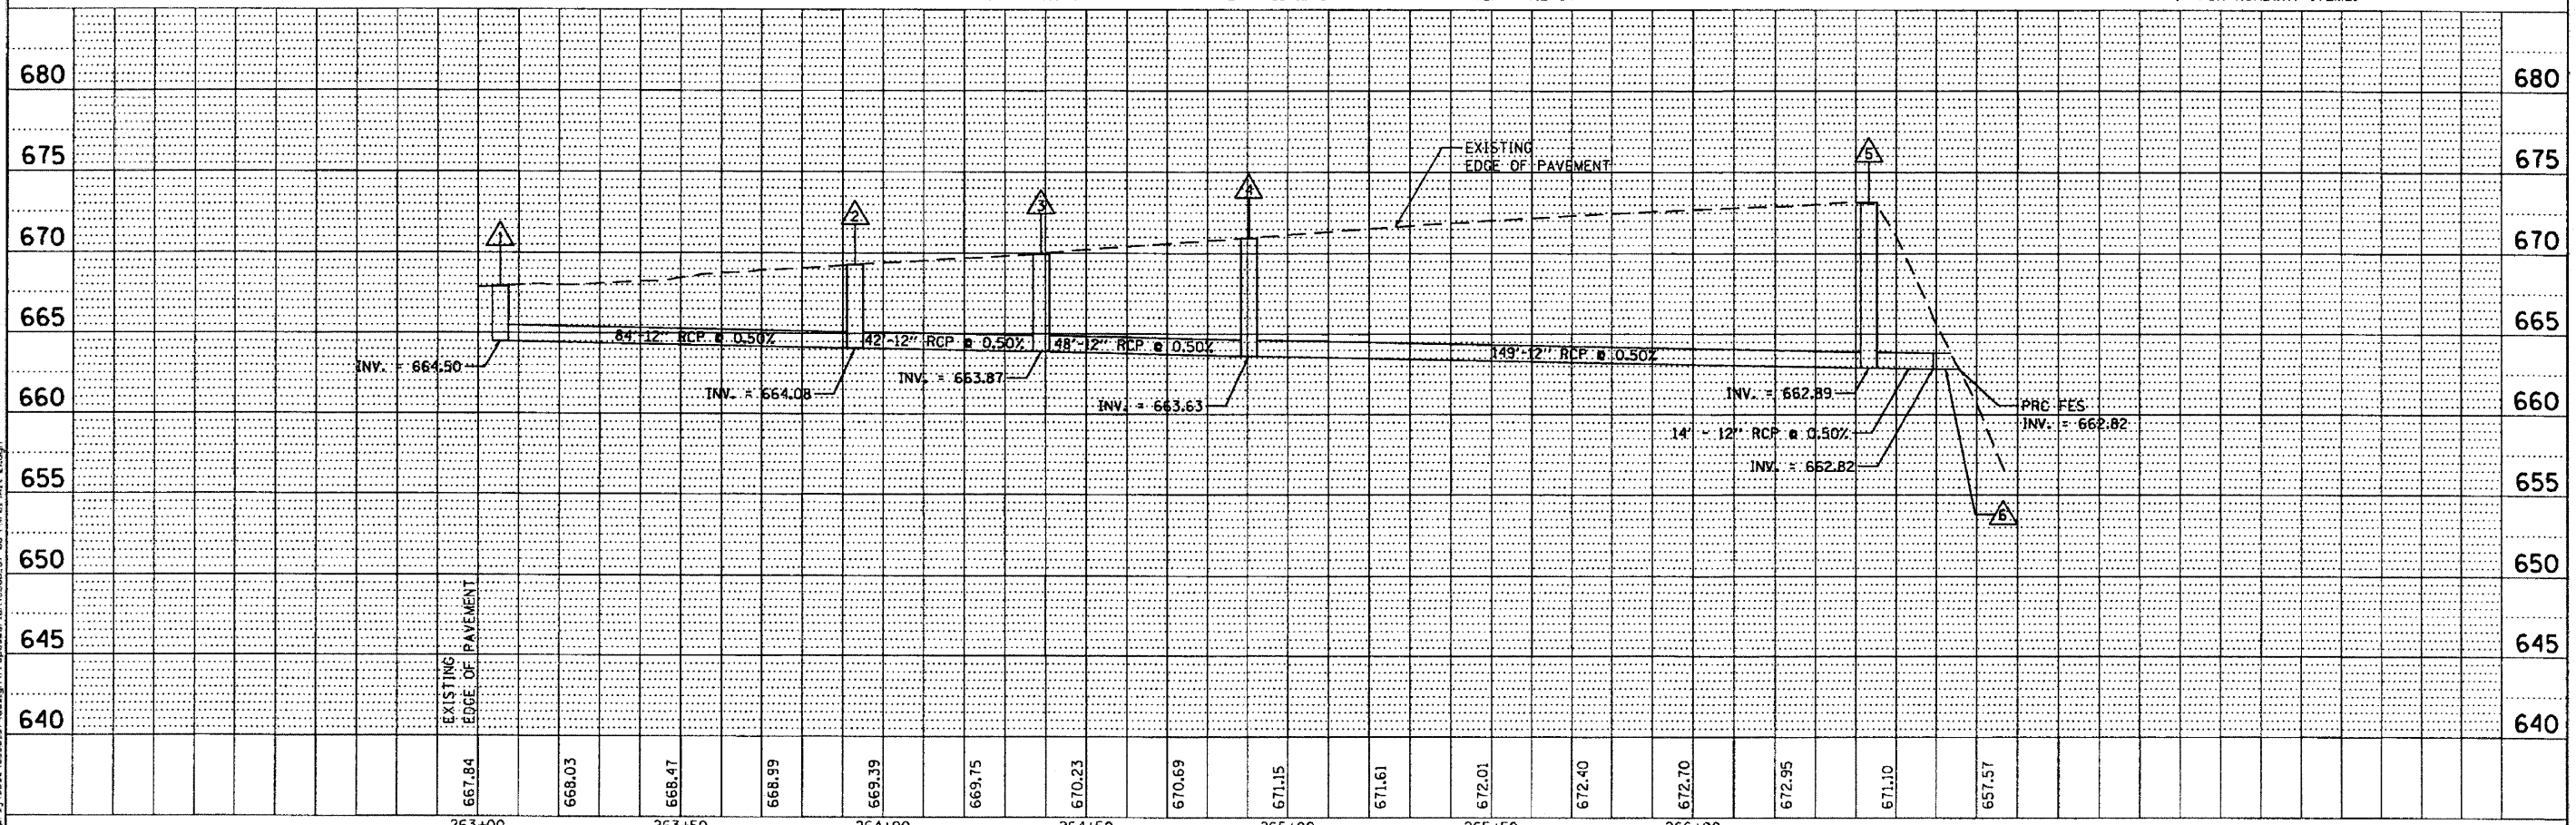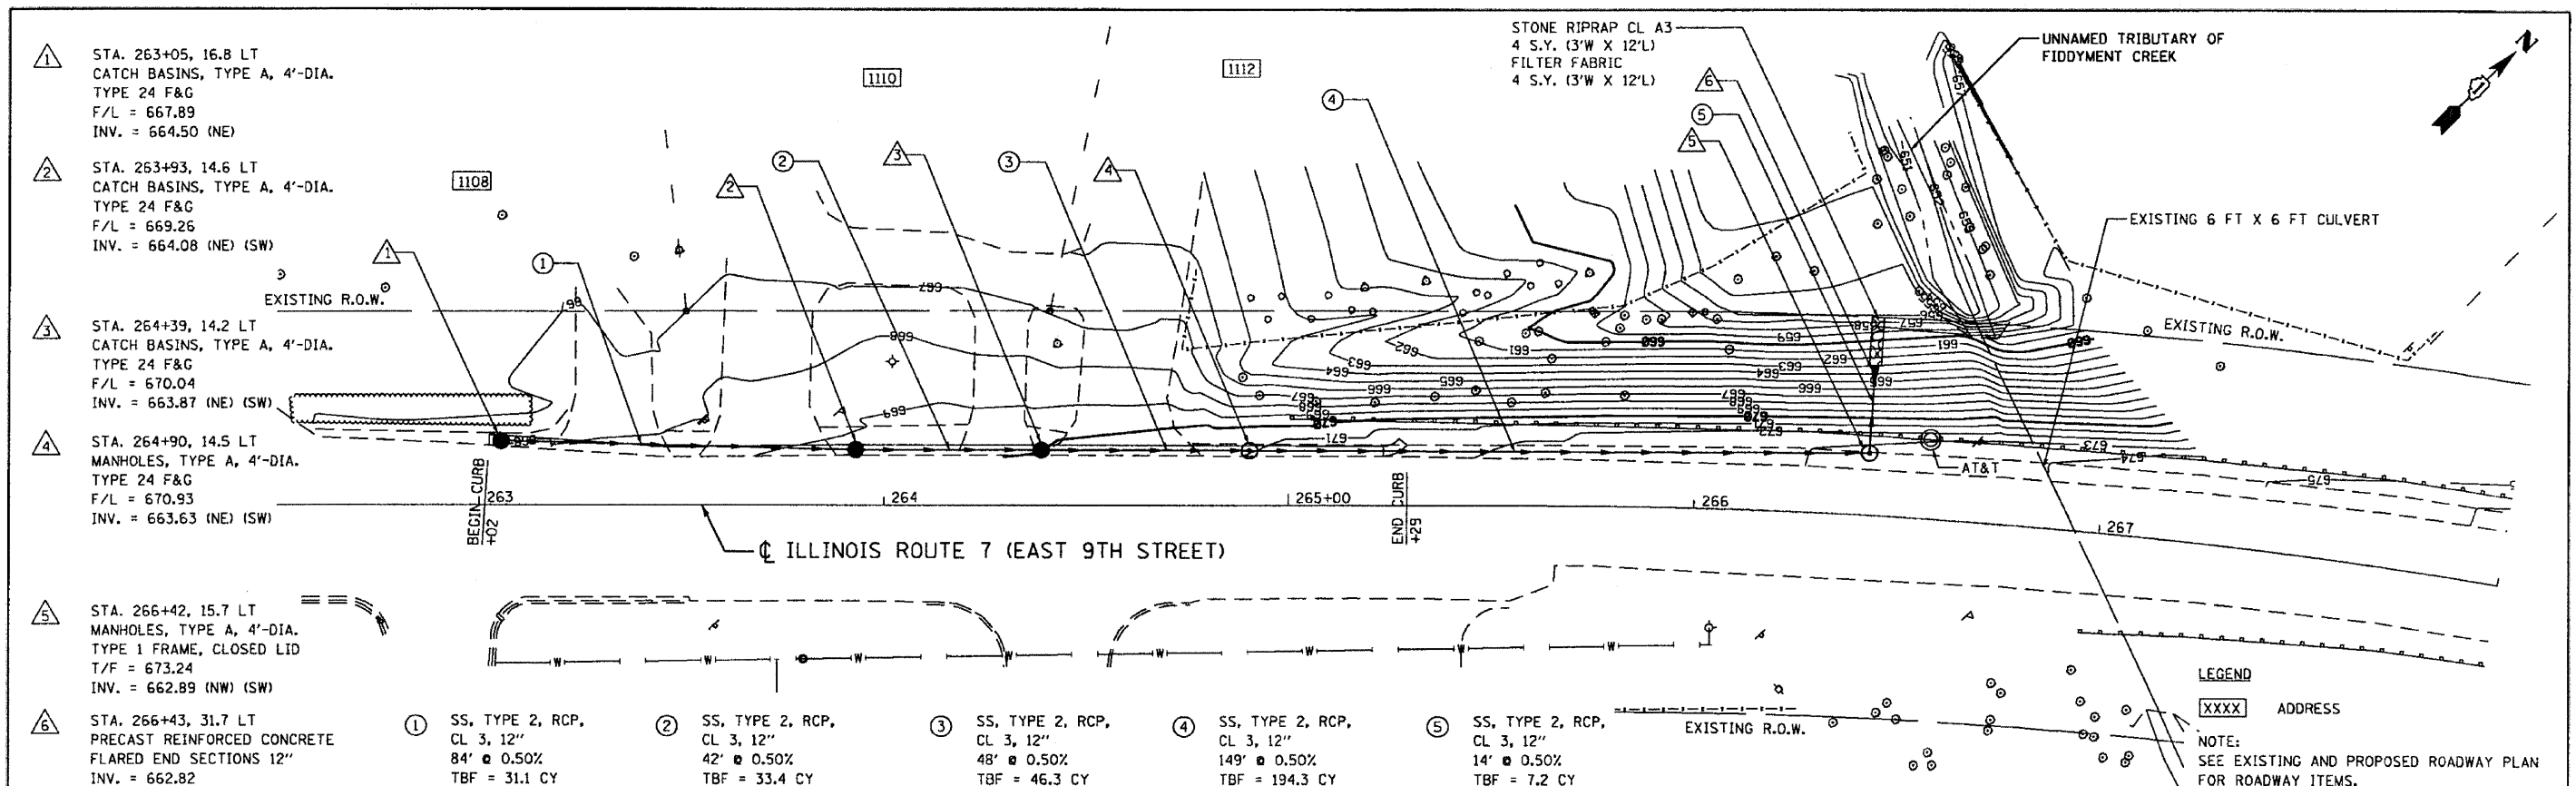

Ciorba Group, Inc. CONSULTING ENGINEERS 5507 North Cumberland Avenue, Suite 402 Chicago, Illinois 60656 Tel. 773.775.4000 Fax 773.775.4014	USER NAME = vlcncastor	DESIGNED - AL	REVISED -	STATE OF ILLINOIS DEPARTMENT OF TRANSPORTATION	IL 53 (INDEPENDENCE BLVD) TO I-355 (VETRANS MEMORIAL TOLLWAY) DRAINAGE PLAN AND PROFILE		F.A.P. RTE.	SECTION	COUNTY	TOTAL SHEETS	SHEET NO.
	PLOT SCALE = 48.0000' / IN.	CHECKED - DMW	REVISED -		351	(535 B-6R & 536) RS-4	WILL	35	13		
	PLOT DATE = 12/3/2009	DATE = 12/11/09	REVISED -		SCALE: 1" = 20' SHEET NO. 13 OF 35 SHEETS STA. 263+50 TO STA. 268+00				CONTRACT NO. 60H62		
	FED. ROAD DIST. NO. 1 ILLINOIS FED. AID PROJECT										

FILE NAME = c:\p09\13068\13068_37_Design\ProposedPlan\13068_37_60H62.dwg

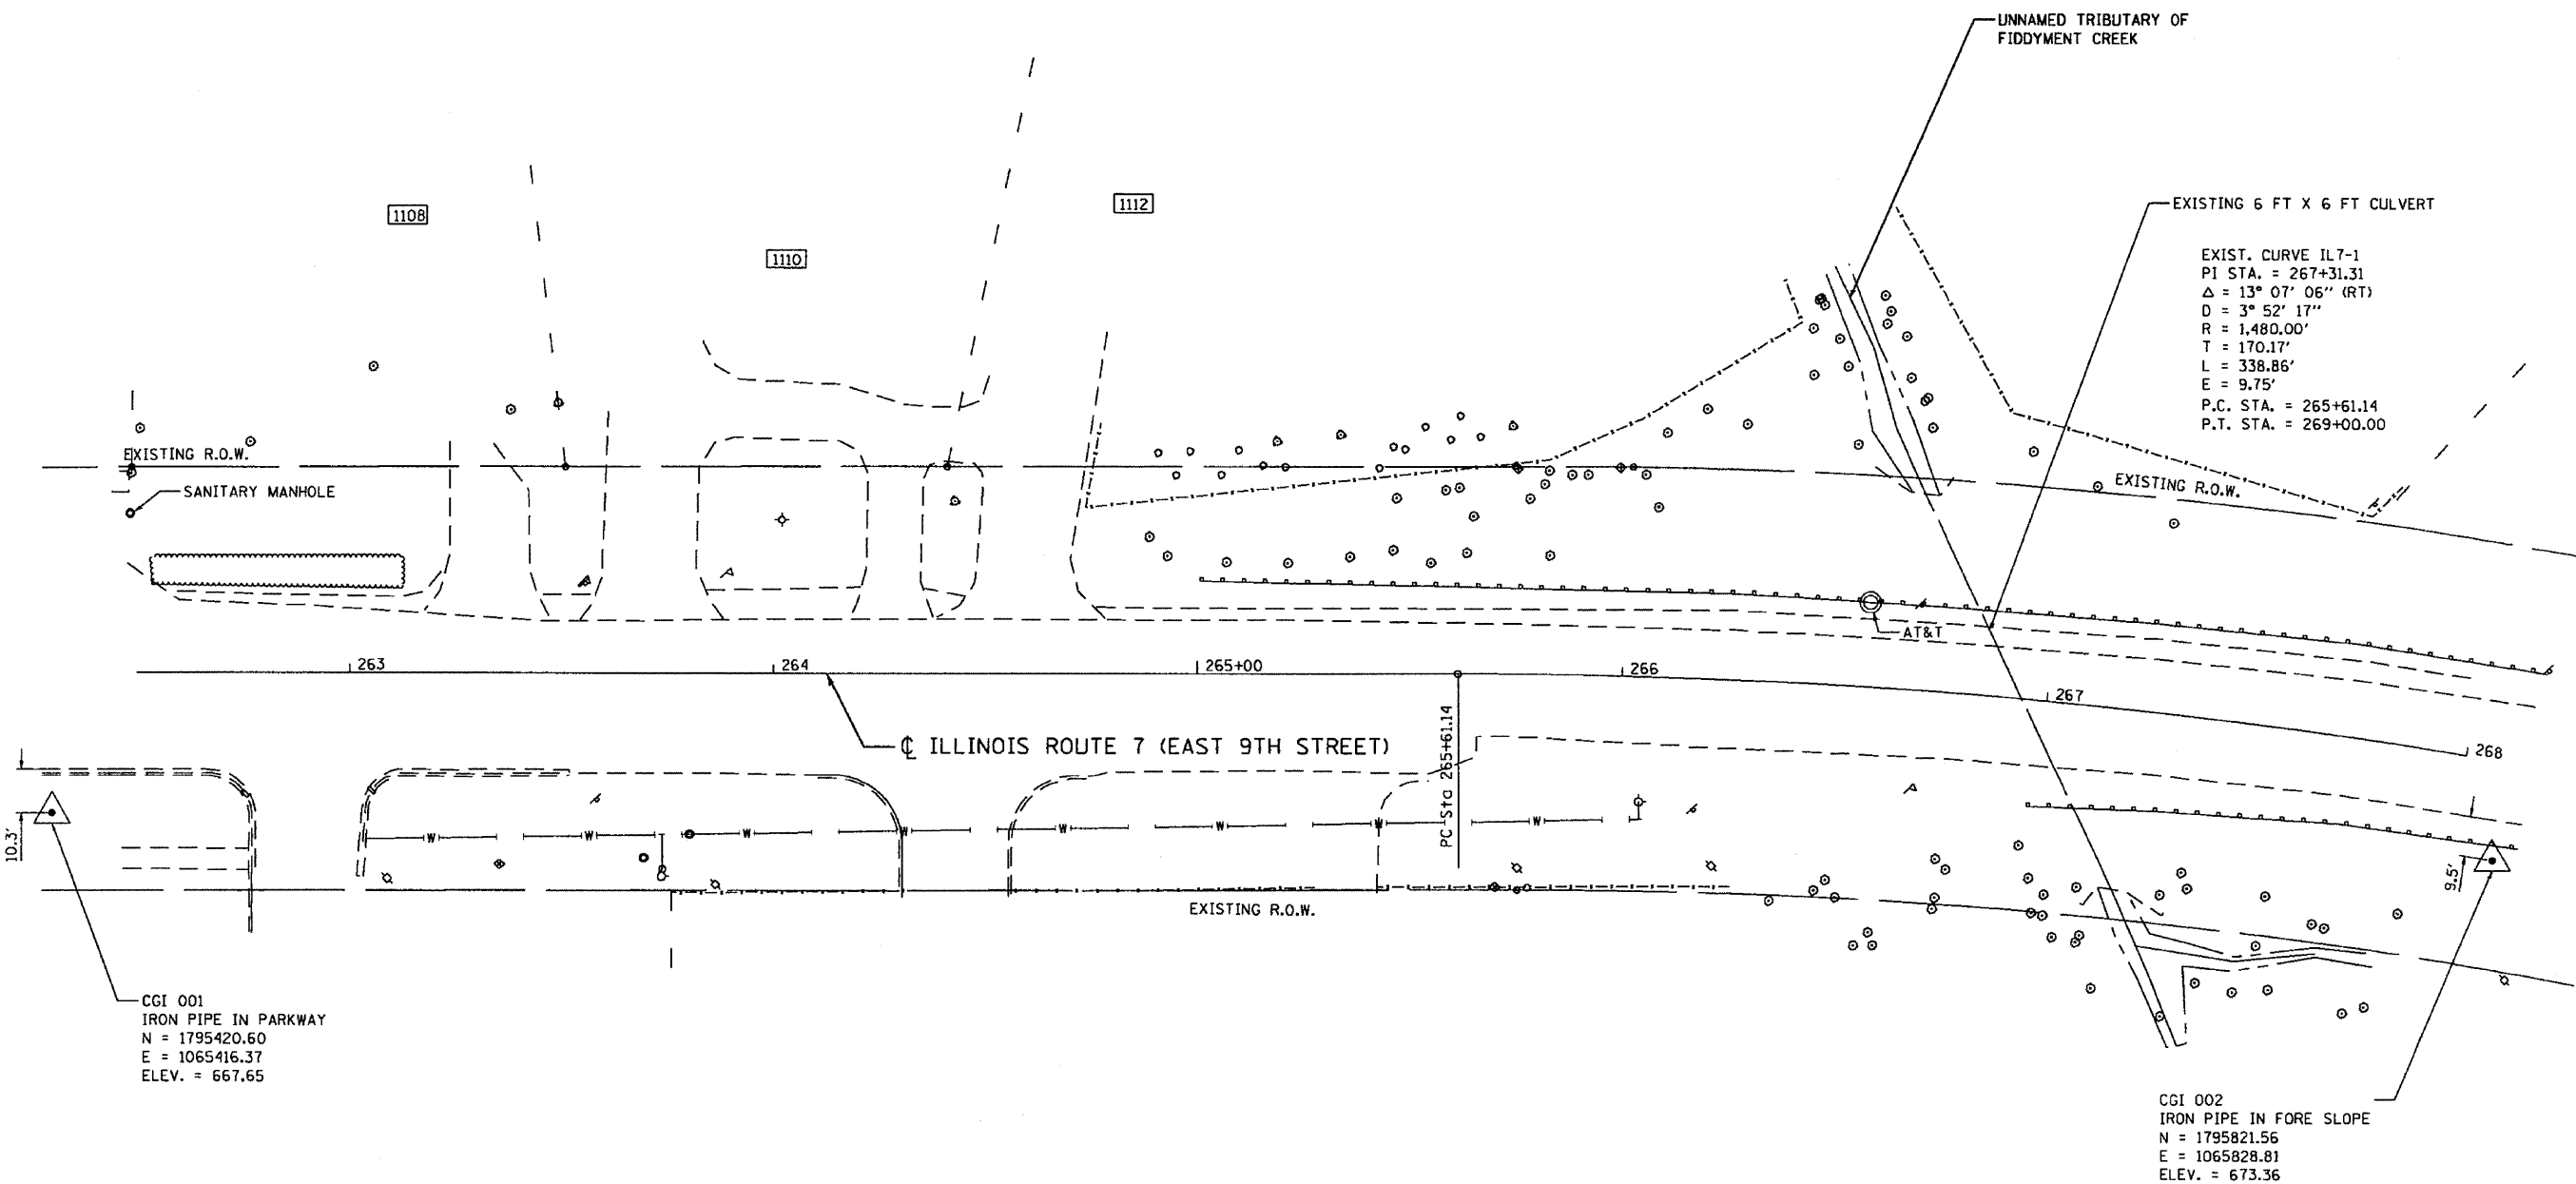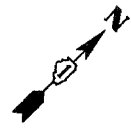

EXIST. CURVE IL7-1
 PI STA. = 267+31.31
 $\Delta = 13^\circ 07' 06''$ (RT)
 $D = 3^\circ 52' 17''$
 $R = 1,480.00'$
 $T = 170.17'$
 $L = 338.86'$
 $E = 9.75'$
 P.C. STA. = 265+61.14
 P.T. STA. = 269+00.00

CGI 001
 IRON PIPE IN PARKWAY
 $N = 1795420.60$
 $E = 1065416.37$
 ELEV. = 667.65

CGI 002
 IRON PIPE IN FORE SLOPE
 $N = 1795821.56$
 $E = 1065828.81$
 ELEV. = 673.36

ILLINOIS ROUTE 7 (EAST 9TH STREET) ALIGNMENT

STATION	NORTHING	EASTING
POT 263+00.00	1,795,493.73	1,065,442.12
PC 265+61.14	1,795,679.26	1,065,625.89
PT 269+00.00	1,795,890.73	1,065,889.72

LEGEND

XXXX ADDRESS

NOTE:
 SEE DRAINAGE PLAN AND PROFILE
 FOR DRAINAGE ITEMS.

FILE NAME: s:\projects\3366\3366-37\Drawings\Proposed\11108-37-06-1-10102-EX-111-21.dwg

CG Ciorba Group, Inc.
 CONSULTING ENGINEERS
 5507 North Cumberland Avenue, Suite 402
 Chicago, Illinois 60658
 Tel. 773.778.4009 Fax 773.778.4014




USER NAME = wloncastor	DESIGNED - AL	REVISED -
PLOT SCALE = 48.0000' / IN.	DRAWN - AL	REVISED -
PLOT DATE = 12/3/2009	CHECKED - DMM	REVISED -
	DATE - 12/11/09	REVISED -

**STATE OF ILLINOIS
 DEPARTMENT OF TRANSPORTATION**

**IL 7 / 159TH STREET
 IL 53 (INDEPENDENCE BLVD) TO I-355 (VETERANS MEMORIAL TOLLWAY)
 EXISTING ROADWAY PLAN**

F.A.P. RTE. 351	SECTION (535 B-6R & 536) RS-4	COUNTY WILL	TOTAL SHEETS 35	SHEET NO. 14
CONTRACT NO. 60H62			FED. ROAD DIST. NO. 1 ILLINOIS FED. AID PROJECT	

SCALE: 1" = 20' SHEET NO. 14 OF 35 SHEETS STA. 263+50 TO STA. 268+00

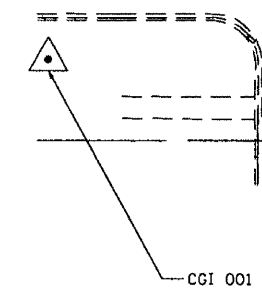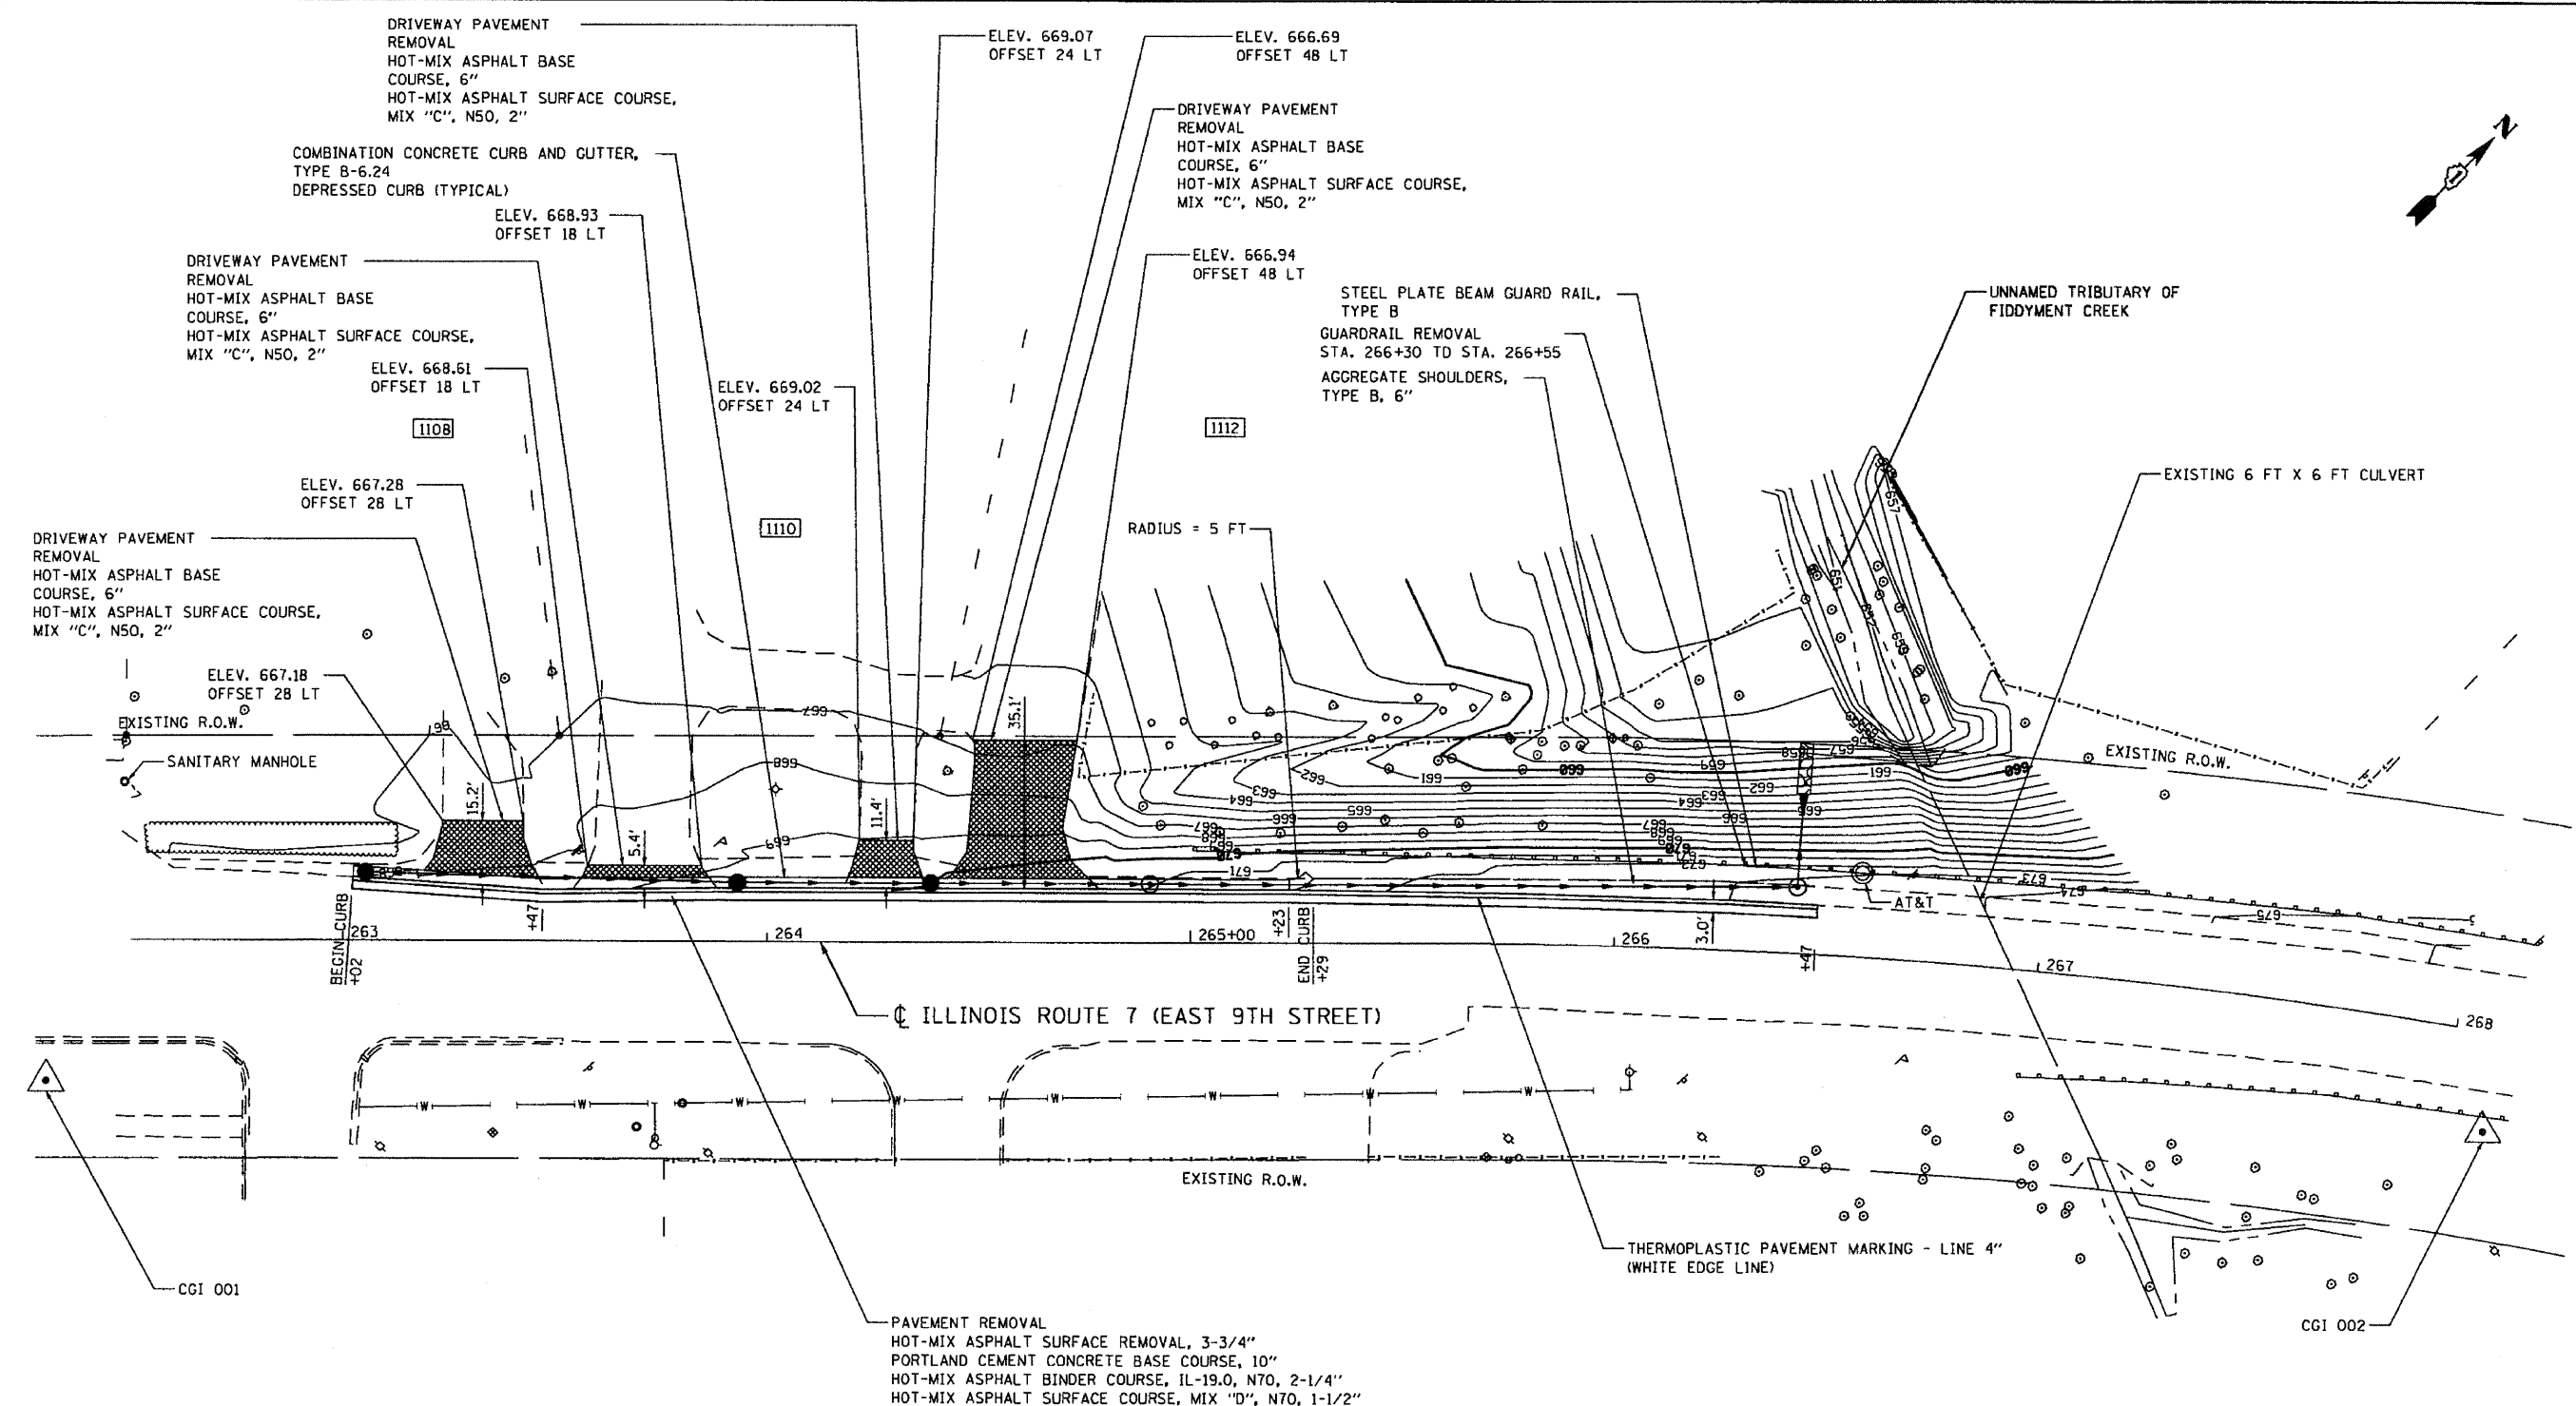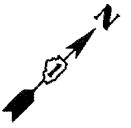

PAVEMENT REMOVAL
 HOT-MIX ASPHALT SURFACE REMOVAL, 3-3/4"
 PORTLAND CEMENT CONCRETE BASE COURSE, 10"
 HOT-MIX ASPHALT BINDER COURSE, IL-19.0, N70, 2-1/4"
 HOT-MIX ASPHALT SURFACE COURSE, MIX "D", N70, 1-1/2"

LEGEND
 XXXX ADDRESS

NOTE:
 SEE DRAINAGE PLAN AND PROFILE FOR DRAINAGE ITEMS.

FILE NAME: I:\PROJECTS\3368\3368_37\Design\Proposed\3368_37-96-2-PWP02_PROJ_IALL_21.dwg

Ciorba Group, Inc.
 CONSULTING ENGINEERS
 5507 North Cumberland Avenue, Suite 402
 Chicago, Illinois 60658
 Tel: 773.775.4009 Fax 773.775.4014





USER NAME = wloncaster	DESIGNED - AL	REVISED -
PLDT SCALE = 48.0000' / IN.	DRAWN - AL	REVISED -
PLDT DATE = 12/9/2009	CHECKED - DMM	REVISED -
DATE = 12/11/09	DATE = 12/11/09	REVISED -

**STATE OF ILLINOIS
 DEPARTMENT OF TRANSPORTATION**

**IL 7 / 159TH STREET
 IL 53 (INDEPENDENCE BLVD) TO I-355 (VETERANS MEMORIAL TOLLWAY)
 PROPOSED ROADWAY PLAN**

F.A.P. RTE.	SECTION	COUNTY	TOTAL SHEETS	SHEET NO.
351	(535 B-6R & 536) RS-4	WILL	35	15
FED. ROAD DIST. NO. 1 [ILLINOIS] FED. AID PROJECT			CONTRACT NO. 60H62	

SCALE: 1" = 20' SHEET NO. 15 OF 35 SHEETS STA. 263+50 TO STA. 268+00

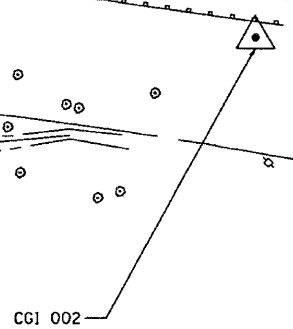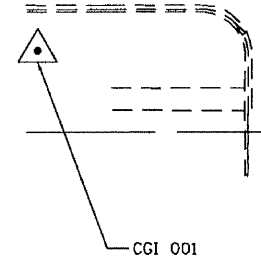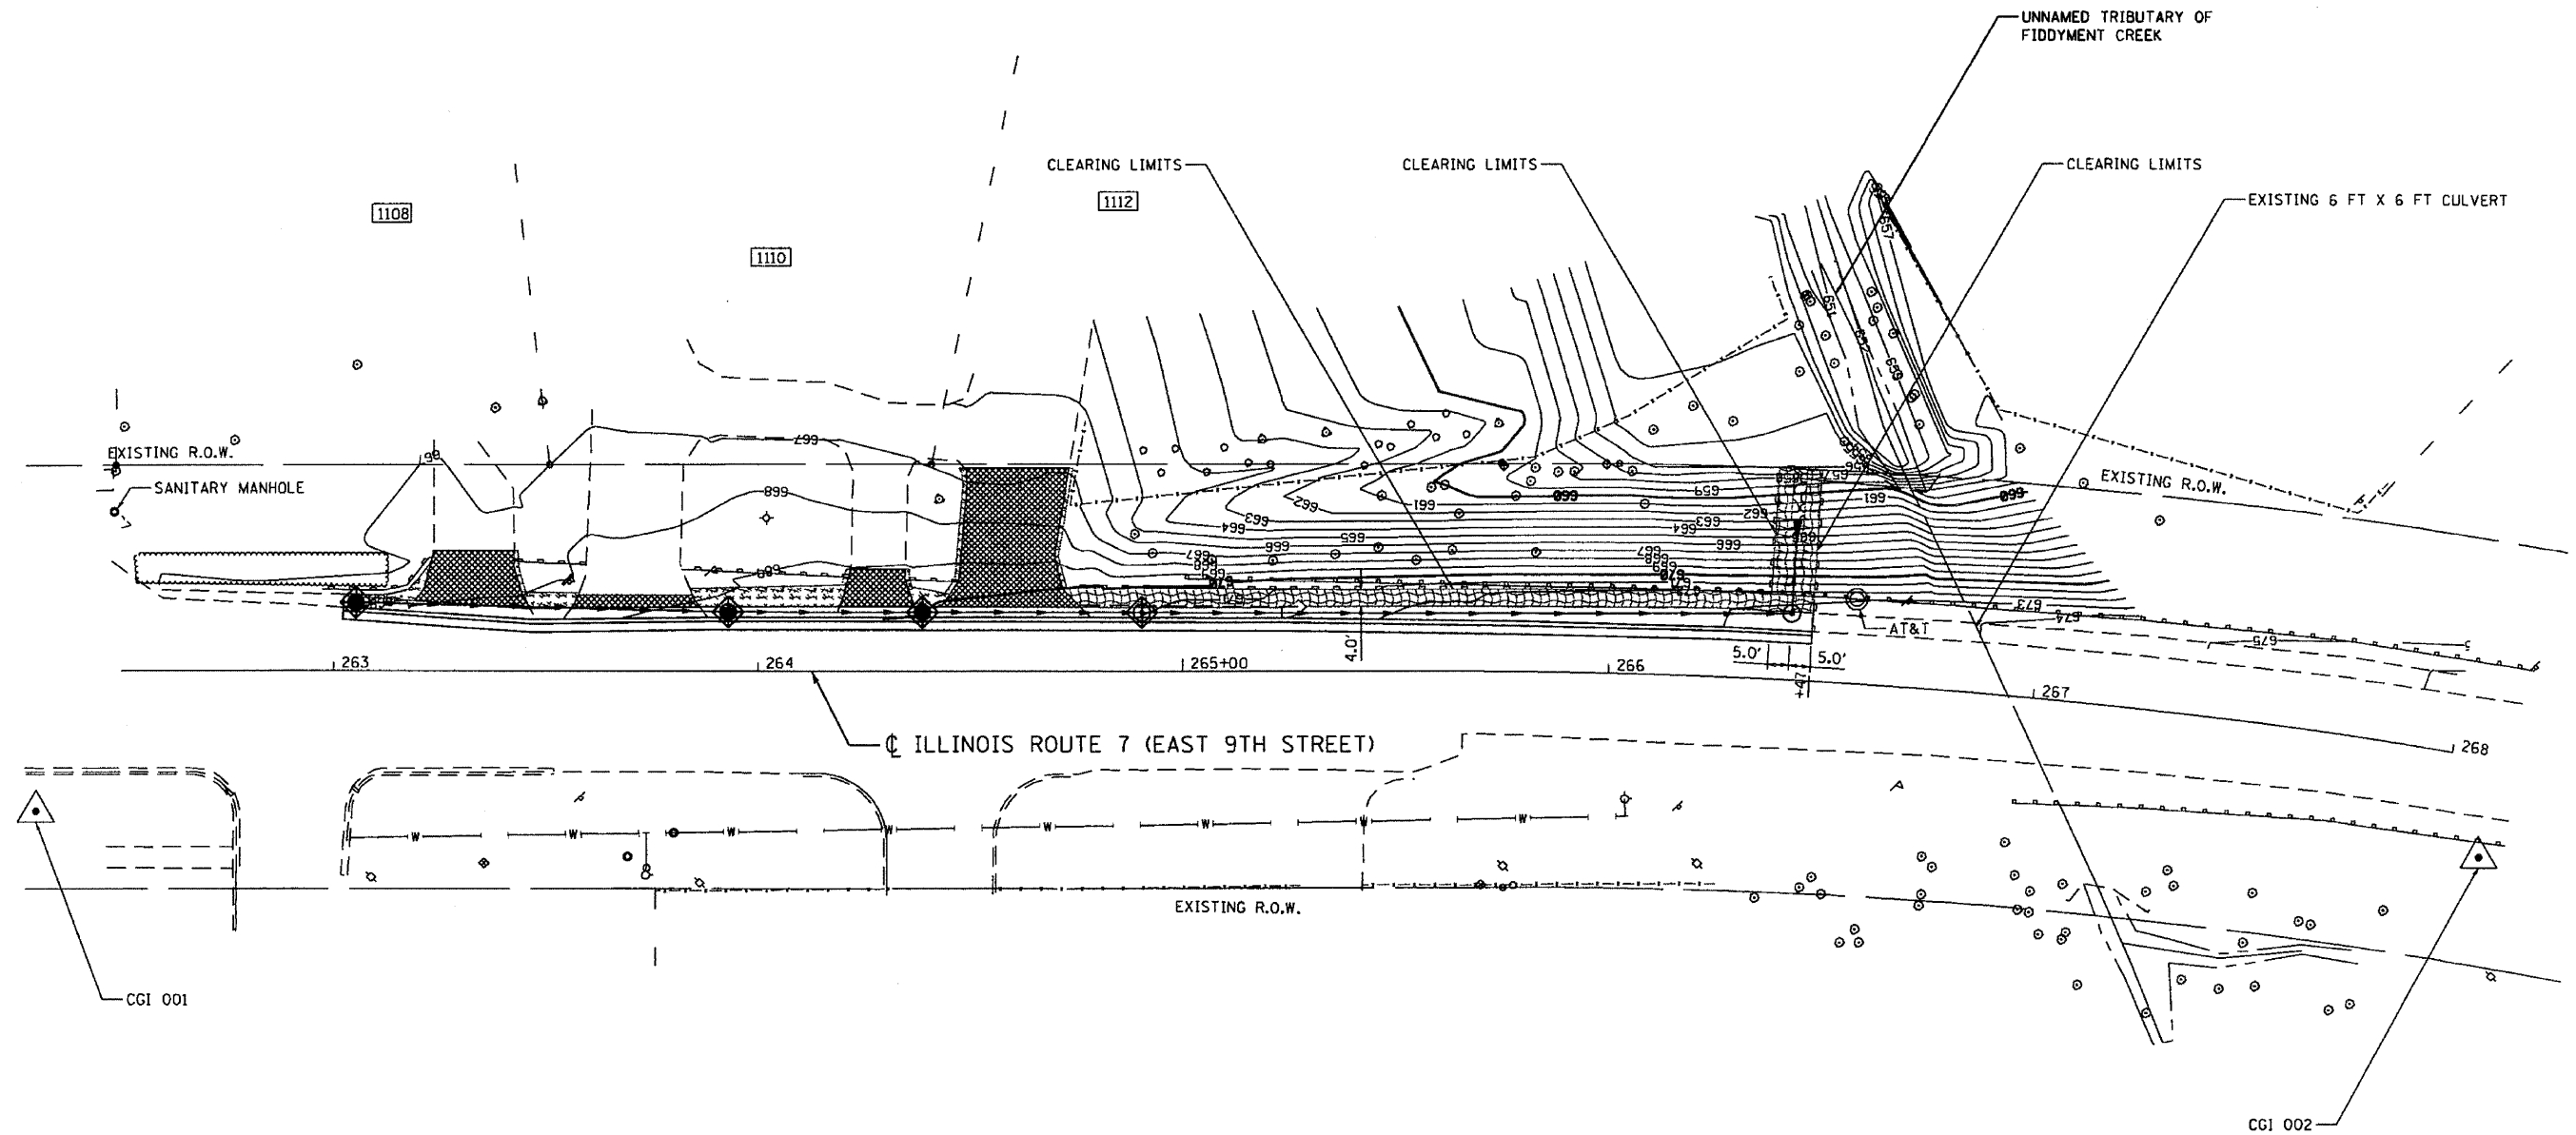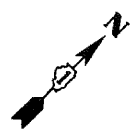

LEGEND

- XXXX ADDRESS
- PERIMETER EROSION BARRIER
- INLET FILTERS
- SODDING, SPECIAL
- SEEDING, CLASS 3 & EROSION CONTROL BLANKET

NOTE:
SEE DRAINAGE PLAN AND PROFILE
FOR DRAINAGE ITEMS.

FILE NAME: c:\p\proj\13386\3386_37\Design\Process\13386_37_06-3-PWP2 (A1).2.dgn

CGI Ciorba Group, Inc.
CONSULTING ENGINEERS
5507 North Cumberland Avenue, Suite 402
Chicago, Illinois 60655
Tel. 773.775.4009 Fax 773.775.4014



USER NAME = wloncoster	DESIGNED - AL	REVISED -
	DRAWN - AL	REVISED -
PLOT SCALE = 48.8800' / IN.	CHECKED - DMM	REVISED -
PLOT DATE = 12/3/2009	DATE = 12/11/09	REVISED -

**STATE OF ILLINOIS
DEPARTMENT OF TRANSPORTATION**

**IL 7 / 159TH STREET
IL 53 (INDEPENDENCE BLVD) TO I-355 (VETRANS MEMORIAL TOLLWAY)
EROSION CONTROL PLAN**

SCALE: 1" = 20' SHEET NO. 16 OF 35 SHEETS STA. 263+50 TO STA. 268+00

F.A.P. RTE. 351	SECTION (535 B-6R & 536) RS-4	COUNTY WILL	TOTAL SHEETS 35	SHEET NO. 16
CONTRACT NO. 60H62			FED. ROAD DIST. NO. 1 [ILLINOIS] FED. AID PROJECT	

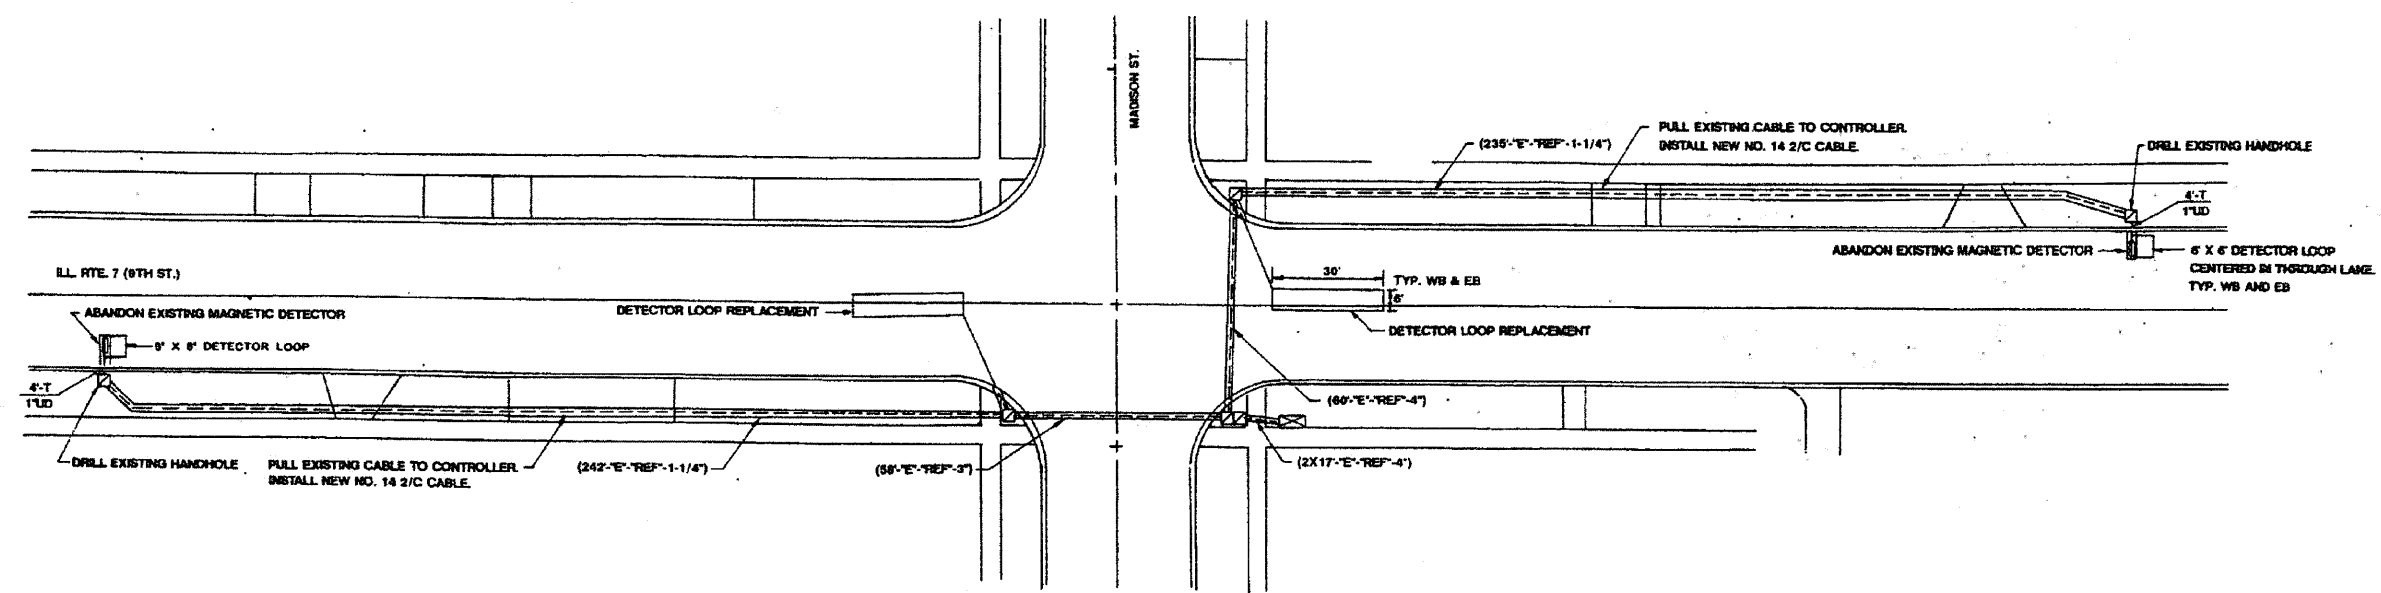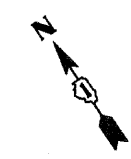

REPLACE ALL DETECTOR LOOPS AS SHOWN
(WITHIN PROJECT LIMITS)

CODE NO.	QUANTITY	UNIT	ITEM
86600600	238	FOOT	DETECTOR LOOP REPLACEMENT

FILE NAME: s:\proj\3560\3560_28\plan\9\911\3560_28_Loop84.dgn

CG Ciorba Group, Inc.
CONSULTING ENGINEERS
5507 North Cumberland Avenue, Suite 402
Chicago, Illinois 60658
Tel. 773.775.4009 Fax 773.775.4014


USER NAME = wloncster	DESIGNED - AL	REVISED -
	DRAWN - AL	REVISED -
PLDT SCALE = 2.0000' / IN.	CHECKED - SNS	REVISED -
PLDT DATE = 12/3/2009	DATE - 12/11/09	REVISED -

**STATE OF ILLINOIS
DEPARTMENT OF TRANSPORTATION**

**IL 7/159TH STREET
IL 53 (INDEPENDENCE BLVD) TO I-355 (VETRANS MEMORIAL TOLLWAY)
DETECTOR LOOP REPLACEMENT PLAN**


F.A.P. RTE.	SECTION	COUNTY	TOTAL SHEETS	SHEET NO.
351	(535 B-6R & 536) RS-4	WILL	35	20
FED. ROAD DIST. NO. 1 ILLINOIS			FED. AID PROJECT	

SCALE: N.T.S. SHEET NO. OF SHEETS STA. TO STA.

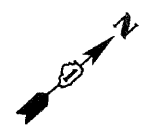

TRAFFIC SIGNAL LEGEND

	PROPOSED	EXISTING
CONTROLLER	[Symbol]	[Symbol]
SERVICE INSTALLATION	[Symbol]	[Symbol]
SIGNAL HEAD	[Symbol]	[Symbol]
SIGNAL HEAD WITH BACKPLATE	[Symbol]	[Symbol]
SIGNAL HEAD, PEDESTRIAN	[Symbol]	[Symbol]
SIGNAL POST	[Symbol]	[Symbol]
MAST ARM ASSEMBLY AND POLE, STEEL	[Symbol]	[Symbol]
MAST ARM ASSEMBLY AND POLE, ALUMINUM	[Symbol]	[Symbol]
COMMON TRENCH	[Symbol]	[Symbol]
UNIT DUCT	[Symbol]	[Symbol]
HANDHOLE	[Symbol]	[Symbol]
HEAVY DUTY HANDHOLE	[Symbol]	[Symbol]
DOUBLE HANDHOLE	[Symbol]	[Symbol]
GDS. CONDUIT IN TRENCH OR PUSHED	[Symbol]	[Symbol]
PEDESTRIAN PUSH-BUTTON DETECTOR	[Symbol]	[Symbol]
DETECTOR LOOP	[Symbol]	[Symbol]
CAST IRON JUNCTION BOX	[Symbol]	[Symbol]
EMERGENCY VEHICLE SYSTEM DETECTOR	[Symbol]	[Symbol]
CONFIRMATION BEACON	[Symbol]	[Symbol]
SIGNAL HEAD OPTICALLY PROGRAMMED	[Symbol]	[Symbol]
CONDUIT SPLICE	[Symbol]	[Symbol]
WOOD POLE	[Symbol]	[Symbol]
RACEWAY FOR MAGNETIC DETECTOR, TYPE I OR TYPE II	[Symbol]	[Symbol]
VEHICLE DETECTOR, NON COMPENSATED MAGNETIC TYPE	[Symbol]	[Symbol]
RAILROAD CONTROL CABINET	[Symbol]	[Symbol]

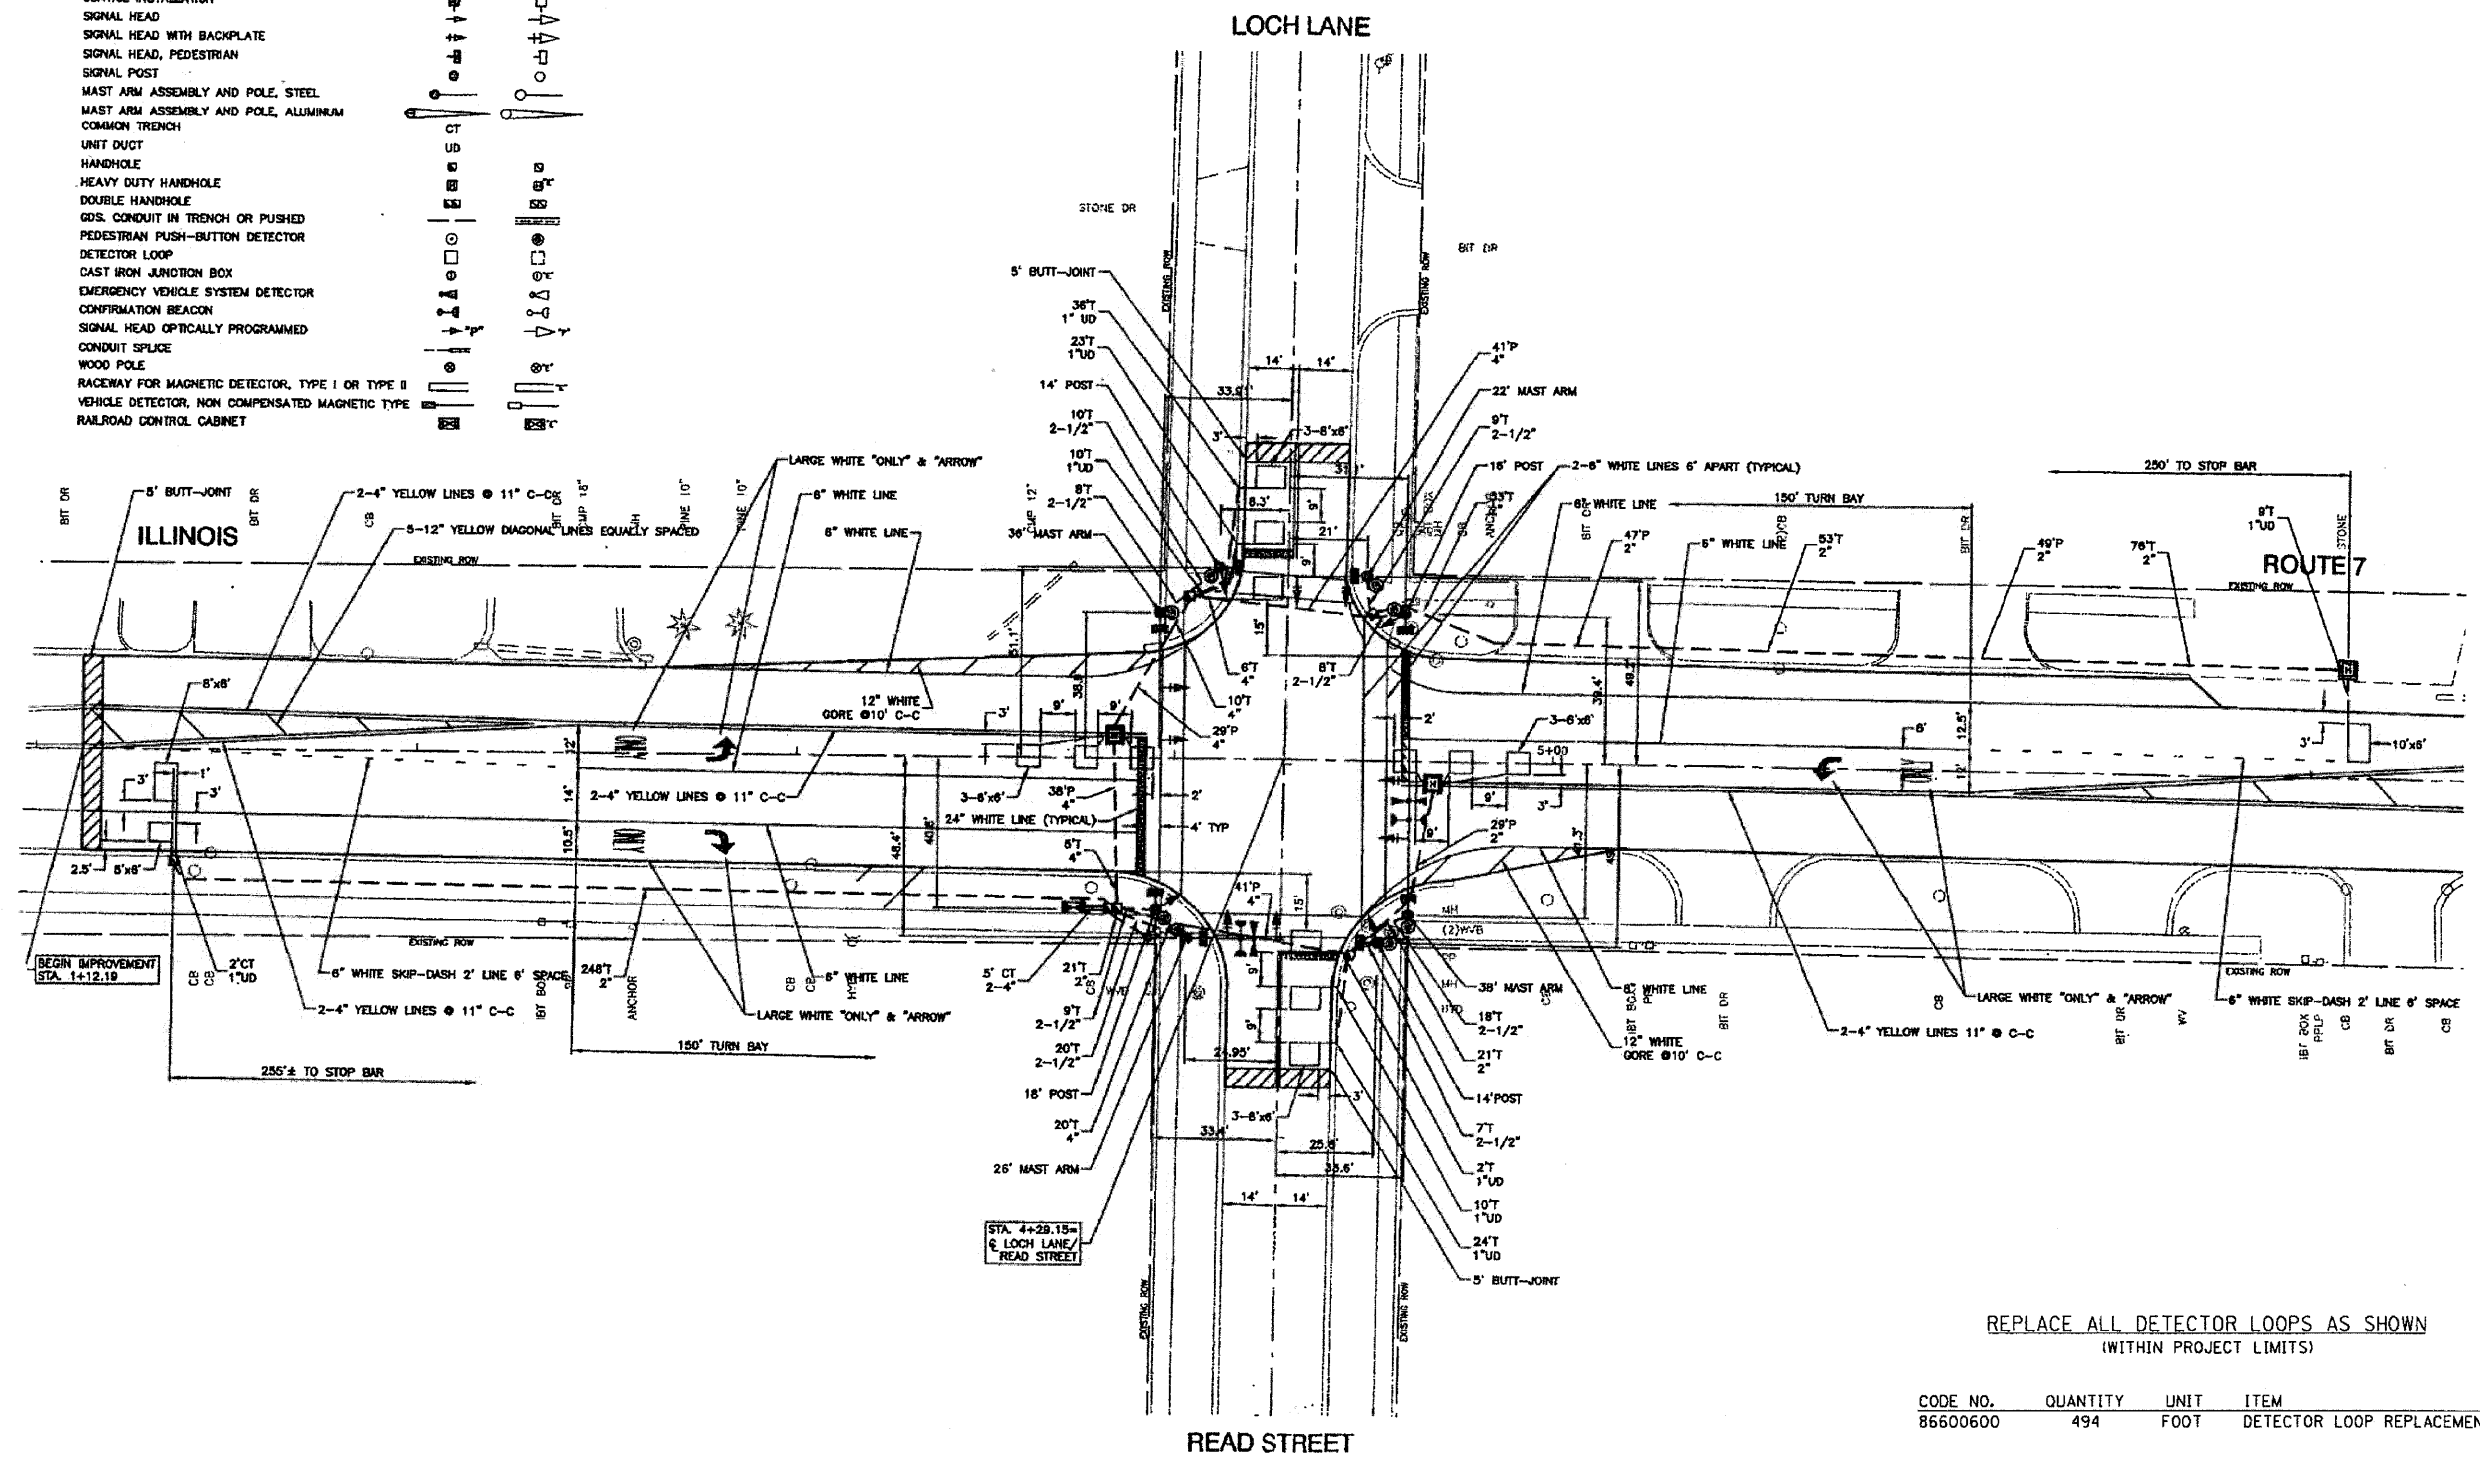

REPLACE ALL DETECTOR LOOPS AS SHOWN
(WITHIN PROJECT LIMITS)

CODE NO.	QUANTITY	UNIT	ITEM
86600600	494	FOOT	DETECTOR LOOP REPLACEMENT

FILE NAME: c:\pwork\33661\33661.dwg; 28-Nov-09 10:35:28 AM; 28-Nov-09 10:35:28 AM; 28-Nov-09 10:35:28 AM

Ciorba Group, Inc.
CONSULTING ENGINEERS
6507 North Cumberland Avenue, Suite 402
Chicago, Illinois 60655
Tel. 773.775.4009 Fax 773.775.4014



USER NAME = wlaneostar	DESIGNED - AL	REVISED -
PLOT SCALE = 2.8880" / IN.	DRAWN - AL	REVISED -
PLOT DATE = 12/3/2009	CHECKED - SNS	REVISED -
	DATE - 12/11/09	REVISED -

**STATE OF ILLINOIS
DEPARTMENT OF TRANSPORTATION**

**IL 7 / 159TH STREET
IL 53 (INDEPENDENCE BLVD) TO I-355 (VETRANS MEMORIAL TOLLWAY)
DETECTOR LOOP REPLACEMENT PLAN**

F.A.P. RTE.	SECTION	COUNTY	TOTAL SHEETS	SHEET NO.
351	(535 B-6R & 536) RS-4	WILL	35	22

SCALE: N.T.S. SHEET NO. OF SHEETS STA. TO STA. TO STA. FED. ROAD DIST. NO. 1 ILLINOIS FED. AID PROJECT CONTRACT NO. 60H62

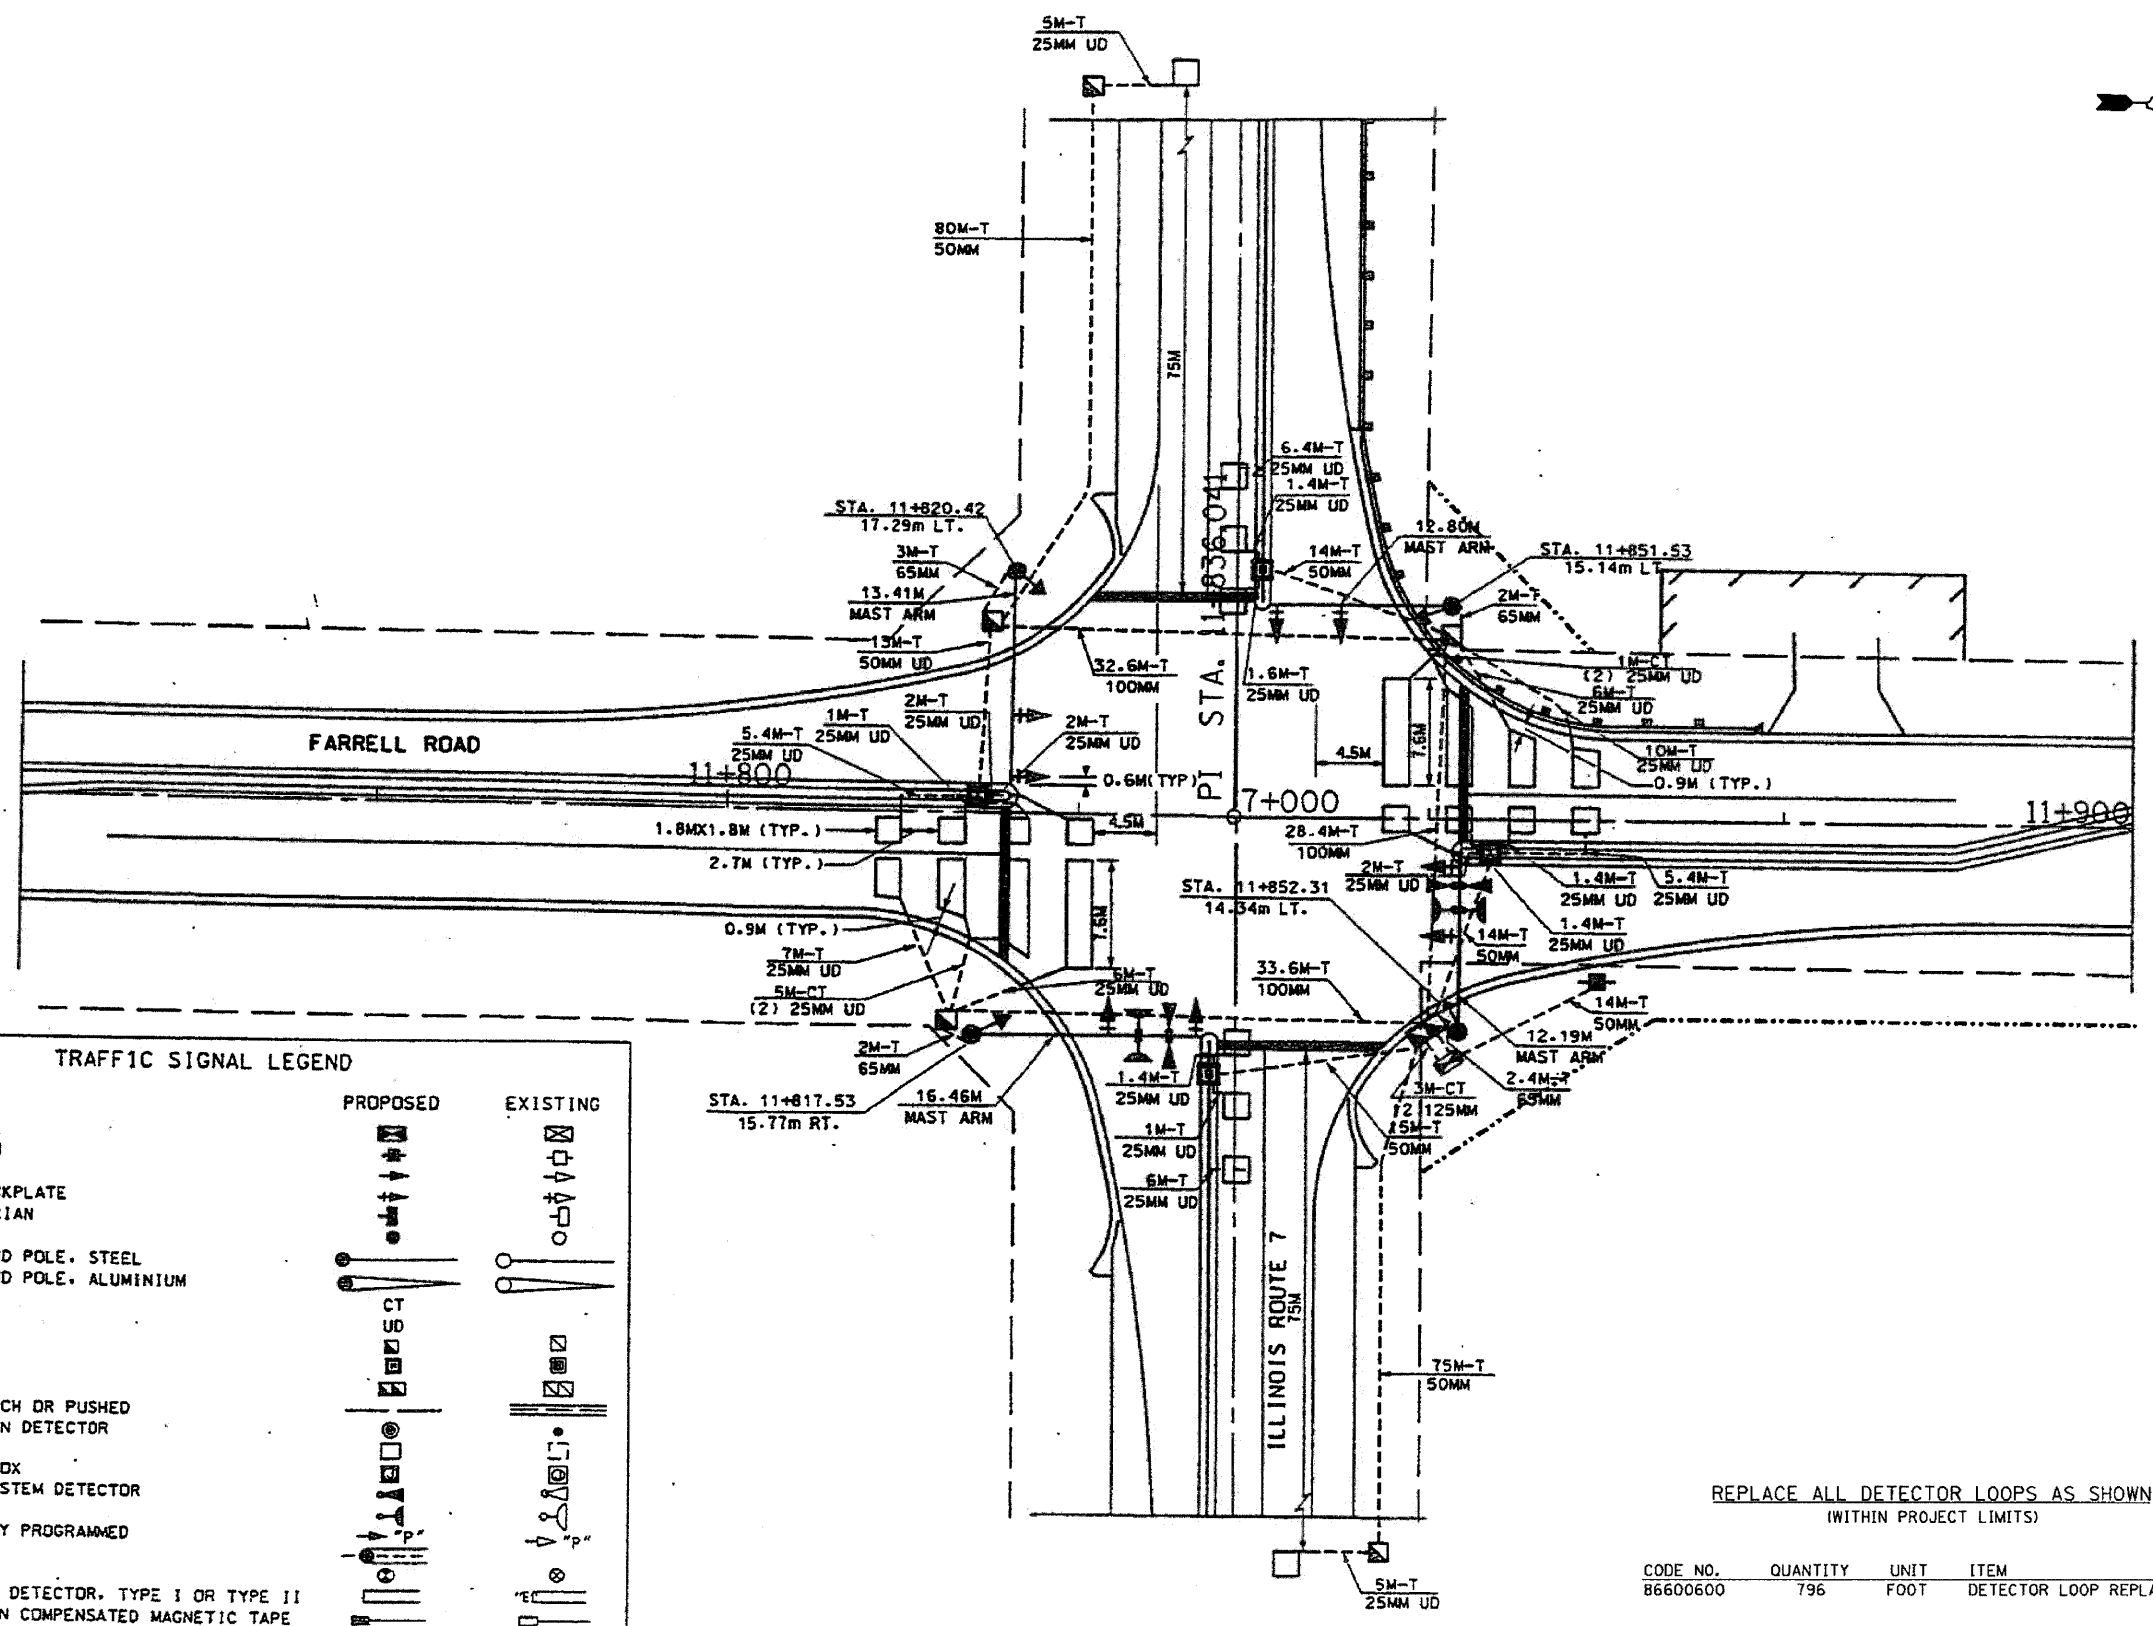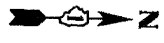

TRAFFIC SIGNAL LEGEND

	PROPOSED	EXISTING
CONTROLLER		
SERVICE INSTALLATION		
SIGNAL HEAD		
SIGNAL HEAD WITH BACKPLATE		
SIGNAL HEAD, PEDESTRIAN		
SIGNAL POST		
MAST ARM ASSEMBLY AND POLE, STEEL		
MAST ARM ASSEMBLY AND POLE, ALUMINIUM		
COMMON TRENCH		
UNIT DUCT		
HANDHOLE		
HEAVY DUTY HANDHOLE		
DOUBLE HANDHOLE		
G.S. CONDUIT IN TRENCH DR PUSHED		
PEDESTRIAN PUSHBUTTON DETECTOR		
DETECTOR LOOP		
CAST IRON JUNCTION BOX		
EMERGENCY VEHICLE SYSTEM DETECTOR		
CONFIRMATION BEACON		
SIGNAL HEAD OPTICALLY PROGRAMMED		
CONDUIT SPLICE		
WOOD POLE		
RACEWAY FOR MAGNETIC DETECTOR, TYPE I OR TYPE II		
VEHICLE DETECTOR, NON COMPENSATED MAGNETIC TAPE		
RAILROAD CONTROL CABINET		

CODE NO.	QUANTITY	UNIT	ITEM
86600600	796	FOOT	DETECTOR LOOP REPLACEMENT

FILE NAME: s:\projects\200603066_20\dwg\plan\signal\113066_20-1000.dwg

Ciorba Group, Inc.
 CONSULTING ENGINEERS
 5507 North Cumberland Avenue, Suite 402
 Chicago, Illinois 60658
 Tel. 773.775.4009 Fax 773.775.4014



USER NAME = ulanecaster	DESIGNED - AL	REVISED -
PLDT SCALE = 2.0000' / IN.	DRAWN - AL	REVISED -
PLDT DATE = 12/3/2009	CHECKED - SNS	REVISED -
	DATE - 12/11/09	REVISED -

**STATE OF ILLINOIS
DEPARTMENT OF TRANSPORTATION**

**IL 7/159TH STREET
IL 53 (INDEPENDENCE BLVD) TO I-355 (VETRANS MEMORIAL TOLLWAY)
DETECTOR LOOP REPLACEMENT PLAN**

F.A.P. RTE.	SECTION	COUNTY	TOTAL SHEETS	SHEET NO.
351	(535 B-6R & 536) RS-4	WILL	35	23
FED. ROAD DIST. NO. 1 ILLINOIS FED. AID PROJECT			CONTRACT NO. 60H62	

SCALE: N.T.S. SHEET NO. OF SHEETS STA. TO STA.

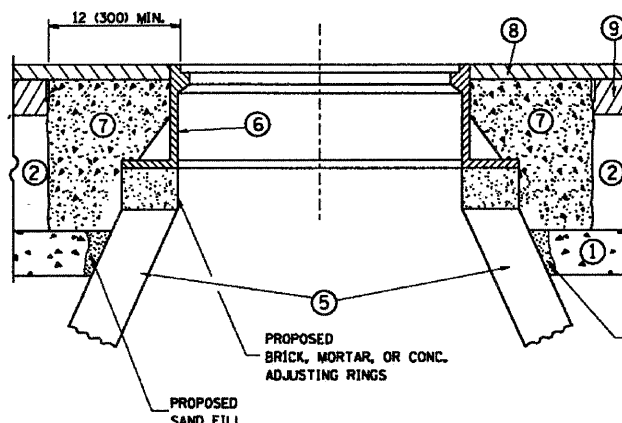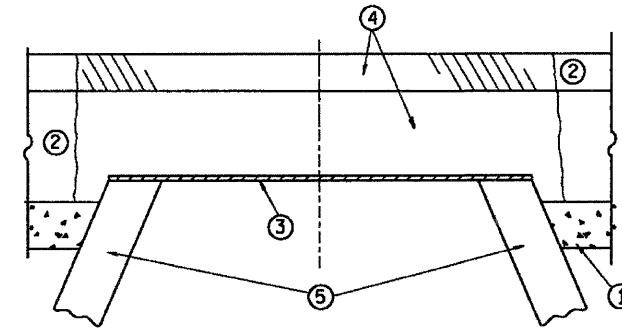

CONSTRUCTION PROCEDURES

- STAGE 1 (BEFORE PAVEMENT MILLING)**
- A) REMOVE A MINIMUM OF 12 (300) OF THE PAVEMENT FROM AROUND THE STRUCTURE.
 - B) REMOVE THE EXISTING FRAME AND LID FROM THE STRUCTURE.
 - C) COVER THE STRUCTURE OPENING WITH A 36 (900) DIAMETER METAL PLATE.
 - D) BACKFILL WITH CRUSHED STONE AND A MINIMUM 1 1/2 (40) THICK HMA SURFACE MIX APPROVED BY THE ENGINEER.
- STAGE 2 (AFTER PAVEMENT MILLING)**
- A) REMOVE THE HMA SURFACE MIX AND CRUSHED STONE.
 - B) INSTALL THE FRAME AND LID; ADJUST THE FRAME TO ITS FINAL SURFACE ELEVATION.
 - C) THE SURROUNDING SPACE SHALL BE FILLED WITH CLASS SI CONCRETE, OR HMA SURFACE COURSE OR HMA BINDER COURSE TO THE ELEVATION OF THE SURFACE OF THE EXISTING BASE COURSE OR THE BINDER COURSE.

THE PROCEDURE EXPLAINED ABOVE SHALL CONFORM TO THE APPLICABLE PORTIONS OF SECTIONS 353, 406, 602, AND 603 OF THE STANDARD SPECIFICATIONS.

LEGEND

- ① SUB-BASE GRANULAR MATERIAL
- ② EXISTING PAVEMENT
- ③ 36 (900) DIAMETER METAL PLATE
- ④ PROPOSED CRUSHED STONE AND HMA SURFACE MIX
- ⑤ EXISTING STRUCTURE
- ⑥ FRAME AND LID (SEE NOTES)
- ⑦ CLASS SI CONCRETE, HMA SURFACE COURSE OR HMA BINDER COURSE
- ⑧ PROPOSED HMA SURFACE COURSE
- ⑨ PROPOSED HMA BINDER COURSE

NOTES:

EXISTING BROKEN FRAMES AND LIDS SHALL BE REMOVED AND DISPOSED OF BY THE CONTRACTOR AND SHALL BE REPLACED AS DIRECTED BY THE ENGINEER. REPLACEMENT FRAMES AND LIDS WILL BE PAID FOR IN ACCORDANCE WITH ARTICLE 109.04 OF THE STANDARD SPECIFICATIONS UNLESS A SEPARATE PAY ITEM HAS BEEN PROVIDED.

IF THE EXISTING LIDS ARE OPEN, THE FRAME WILL BE ADJUSTED TO THE ELEVATION OF THE MILLED PAVEMENT SURFACE PRIOR TO THE MILLING OPERATION. THE FRAME WILL NOT BE REMOVED AND COVERED BY THE METAL PLATE.

CITY OF CHICAGO CASTINGS ARE THE PROPERTY OF THE CITY AND THE CONTRACTOR SHALL NOTIFY THE CITY FOR REMOVAL AND DISPOSITION OF THE CASTINGS.

THE METAL PLATE USED TO COVER THE STRUCTURE SHALL REMAIN THE PROPERTY OF THE CONTRACTOR.

WHEN STRUCTURES ARE TO BE ADJUSTED OR RECONSTRUCTED, THE LOWERING AND RAISING OF THE FRAMES AND LIDS WILL NOT BE PAID FOR SEPARATELY BUT WILL BE INCLUDED IN THE COST OF THE CORRESPONDING PAY ITEM.

LOCATION OF STRUCTURES:


THE CONTRACTOR WILL BE REQUIRED TO KEEP A RECORD OF THE LOCATIONS OF THE BURIED STRUCTURES ACCORDING TO THE STATION AND DISTANCE LEFT OR RIGHT OF THE CENTERLINE OF PAVEMENT. UPON COMPLETION OF THE WORK, THE CONTRACTOR WILL DELIVER THE RECORD TO THE ENGINEER.

BASIS OF PAYMENT: THIS WORK WILL BE PAID FOR AT THE CONTRACT UNIT PRICE PER EACH FOR "FRAMES AND LIDS TO BE ADJUSTED, SPECIAL"
NEW FRAMES AND LIDS, WHEN SPECIFIED, WILL BE PAID FOR SEPARATELY.

DETAILS FOR FRAMES AND LIDS ADJUSTMENT WITH MILLING

ALL DIMENSIONS ARE IN INCHES (MILLIMETERS) UNLESS OTHERWISE SHOWN

FILE NAME = W:\data\22x34\bd08.dgn	USER NAME = goglienob1	DESIGNED - R. SHAH	REVISED - R. SHAH 03-10-95	STATE OF ILLINOIS DEPARTMENT OF TRANSPORTATION	DETAILS FOR FRAMES AND LIDS ADJUSTMENT WITH MILLING	F.A.P. RTE. 351	SECTION (535 B-6R & 536) RS-4	COUNTY WILL	TOTAL SHEETS 35	SHEET NO. 24
	PLOT SCALE = 50.0000' / IN.	CHECKED -	REVISED - A. ABBAS 03-21-9T		SCALE: NONE	SHEET NO. 1 OF 1 SHEETS	CONTRACT NO. BD600-03 (BD-8)	CONTRACT NO. 60H62		
	PLOT DATE = 1/4/2008	DATE - 10-25-94	REVISED - R. WIEDEMAN 05-14-04		STA. TO STA.	FED. ROAD DIST. NO. (ILLINOIS) FED. AID PROJECT				
			REVISED - R. BORO 01-01-0T							

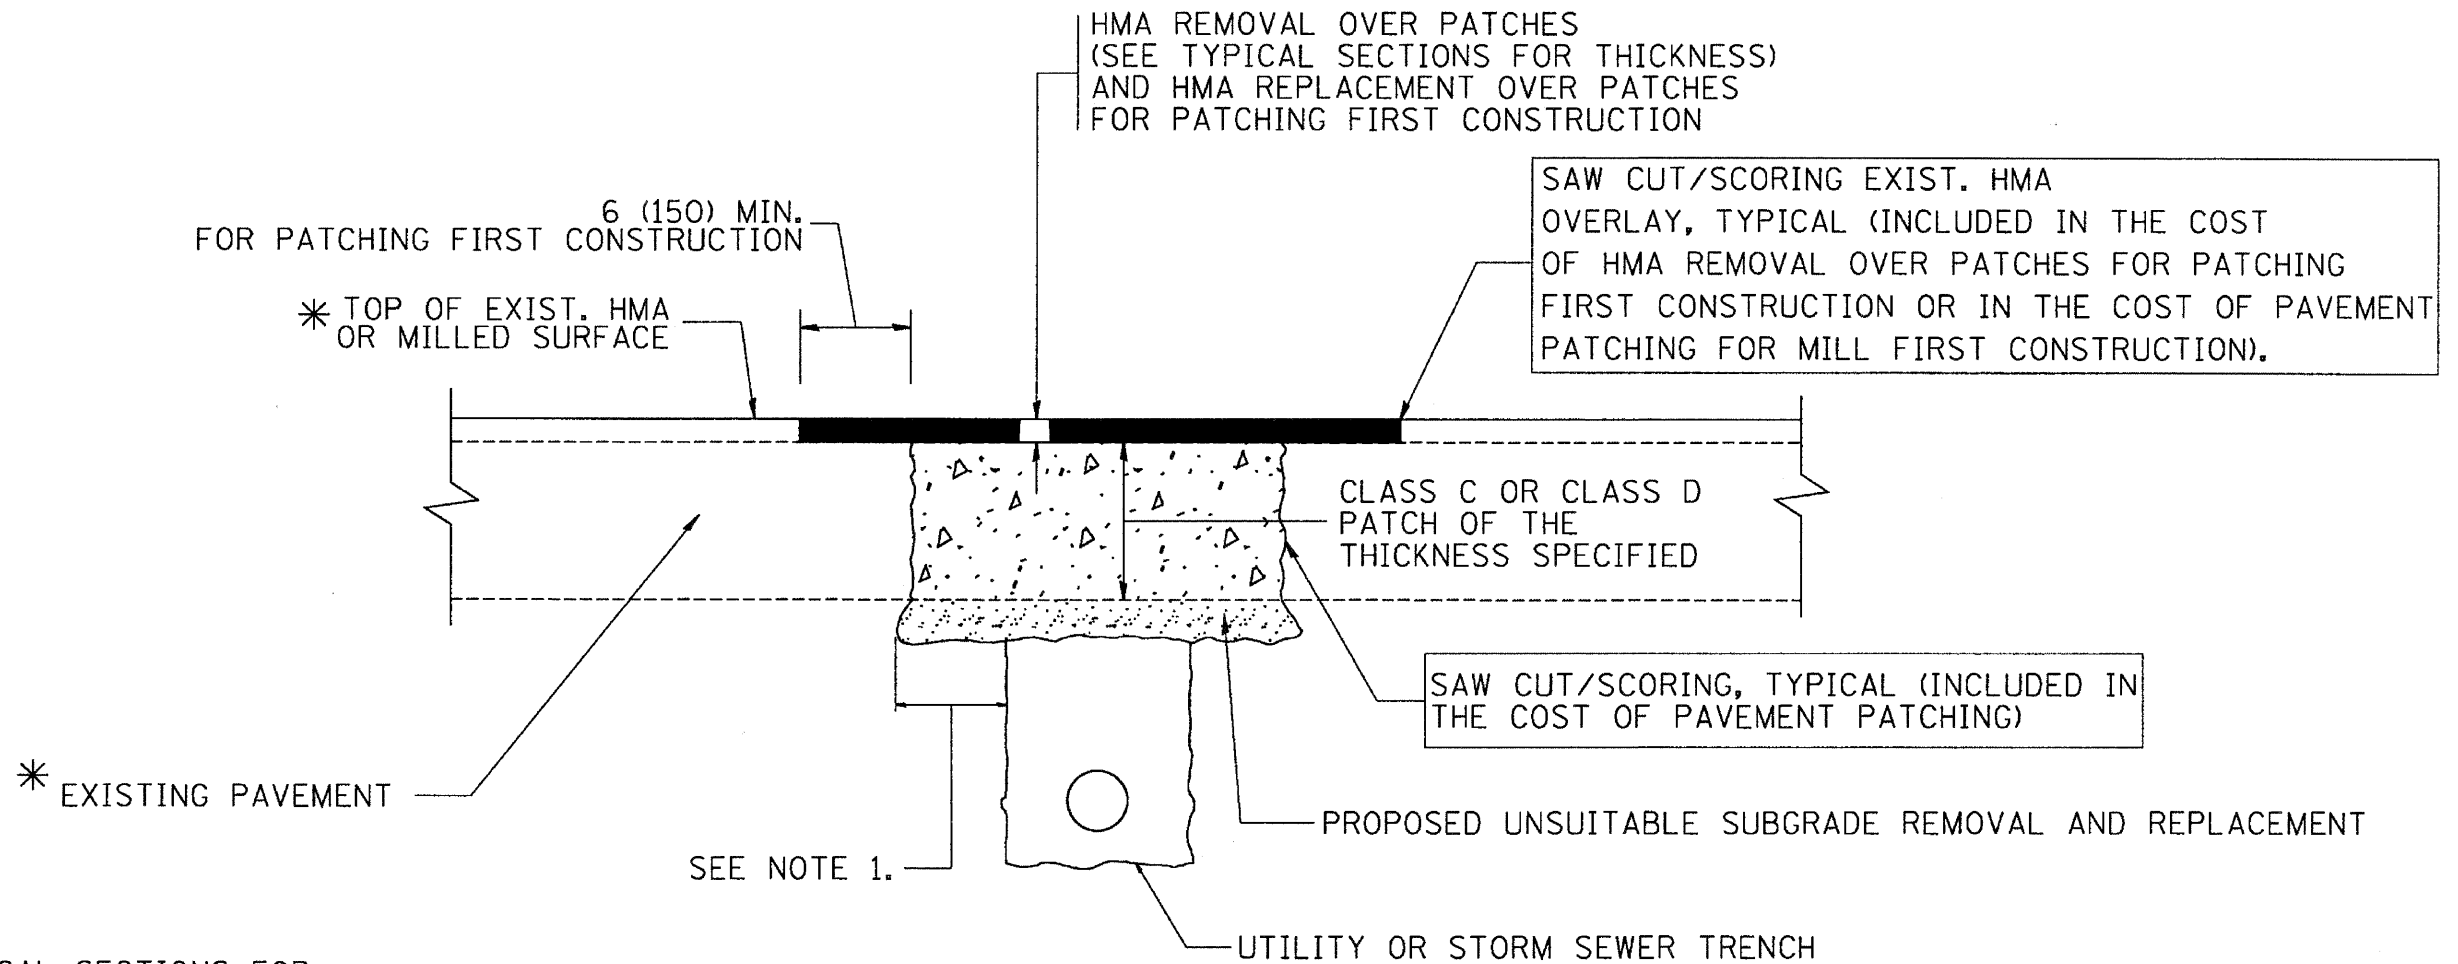

* SEE TYPICAL SECTIONS FOR THICKNESS AND MATERIALS

NOTES:

1. THE WIDTH OF THE FULL DEPTH PATCH OVER A TRENCH SHALL BE 12 (300) WIDER ON EACH SIDE OF THE TRENCH.
2. FOR METHOD OF MEASUREMENT AND BASIS OF PAYMENT, SEE RECURRING SPECIAL PROVISION "PATCHING WITH HOT-MIX ASPHALT OVERLAY REMOVAL".

SEQUENCE OF CONSTRUCTION (PATCHING FIRST)


1. REMOVE THE EXISTING HMA MATERIAL OVER THE AREA TO BE PATCHED.
2. REMOVE AND REPLACE WITH CLASS C OR D PATCH.
3. REPLACE HMA MATERIAL OVER THE AREA TO BE PATCHED.

SEQUENCE OF CONSTRUCTION (MILLING FIRST)

1. MILL HMA FIRST IF THERE IS AT LEAST 4 1/2 INCHES OR MORE OF HMA MATERIAL ON TOP OF THE EXISTING PAVEMENT OR IF THE PAVEMENT IS FULL DEPTH HMA. A MINIMUM OF 2 INCHES OF HMA MATERIAL SHALL BE IN PLACE AFTER MILLING.
2. REMOVE AND REPLACE WITH FULL DEPTH CLASS D PATCHES TO TOP OF MILLED SURFACE.

ALL DIMENSIONS ARE IN INCHES (MILLIMETERS) UNLESS OTHERWISE SHOWN.

FILE NAME = c:\projects\distad22\34\bd22.dgn	USER NAME = beverd	DESIGNED - R. SHAH	REVISED - A. ABBAS 04-27-98	STATE OF ILLINOIS DEPARTMENT OF TRANSPORTATION	PAVEMENT PATCHING FOR HMA SURFACED PAVEMENT			F.A.P. RTE.	SECTION	COUNTY	TOTAL SHEETS	SHEET NO.
		DRAWN -	REVISED - R. BORO 01-01-07		351	(535 B-6R & 536) RS-4	WILL	35	25			
		PLOT SCALE = 58.000' / IN.	REVISED - R. BORO 09-04-07		BD400-04 (BD-22)			CONTRACT NO. 60H62				
		PLOT DATE = 10/27/2008	REVISED - K. ENG 10-27-08		SCALE: NONE	SHEET NO. 1 OF 1 SHEETS	STA.	TO STA.	FED. ROAD DIST. NO. 1 (ILLINOIS) FED. AID PROJECT			

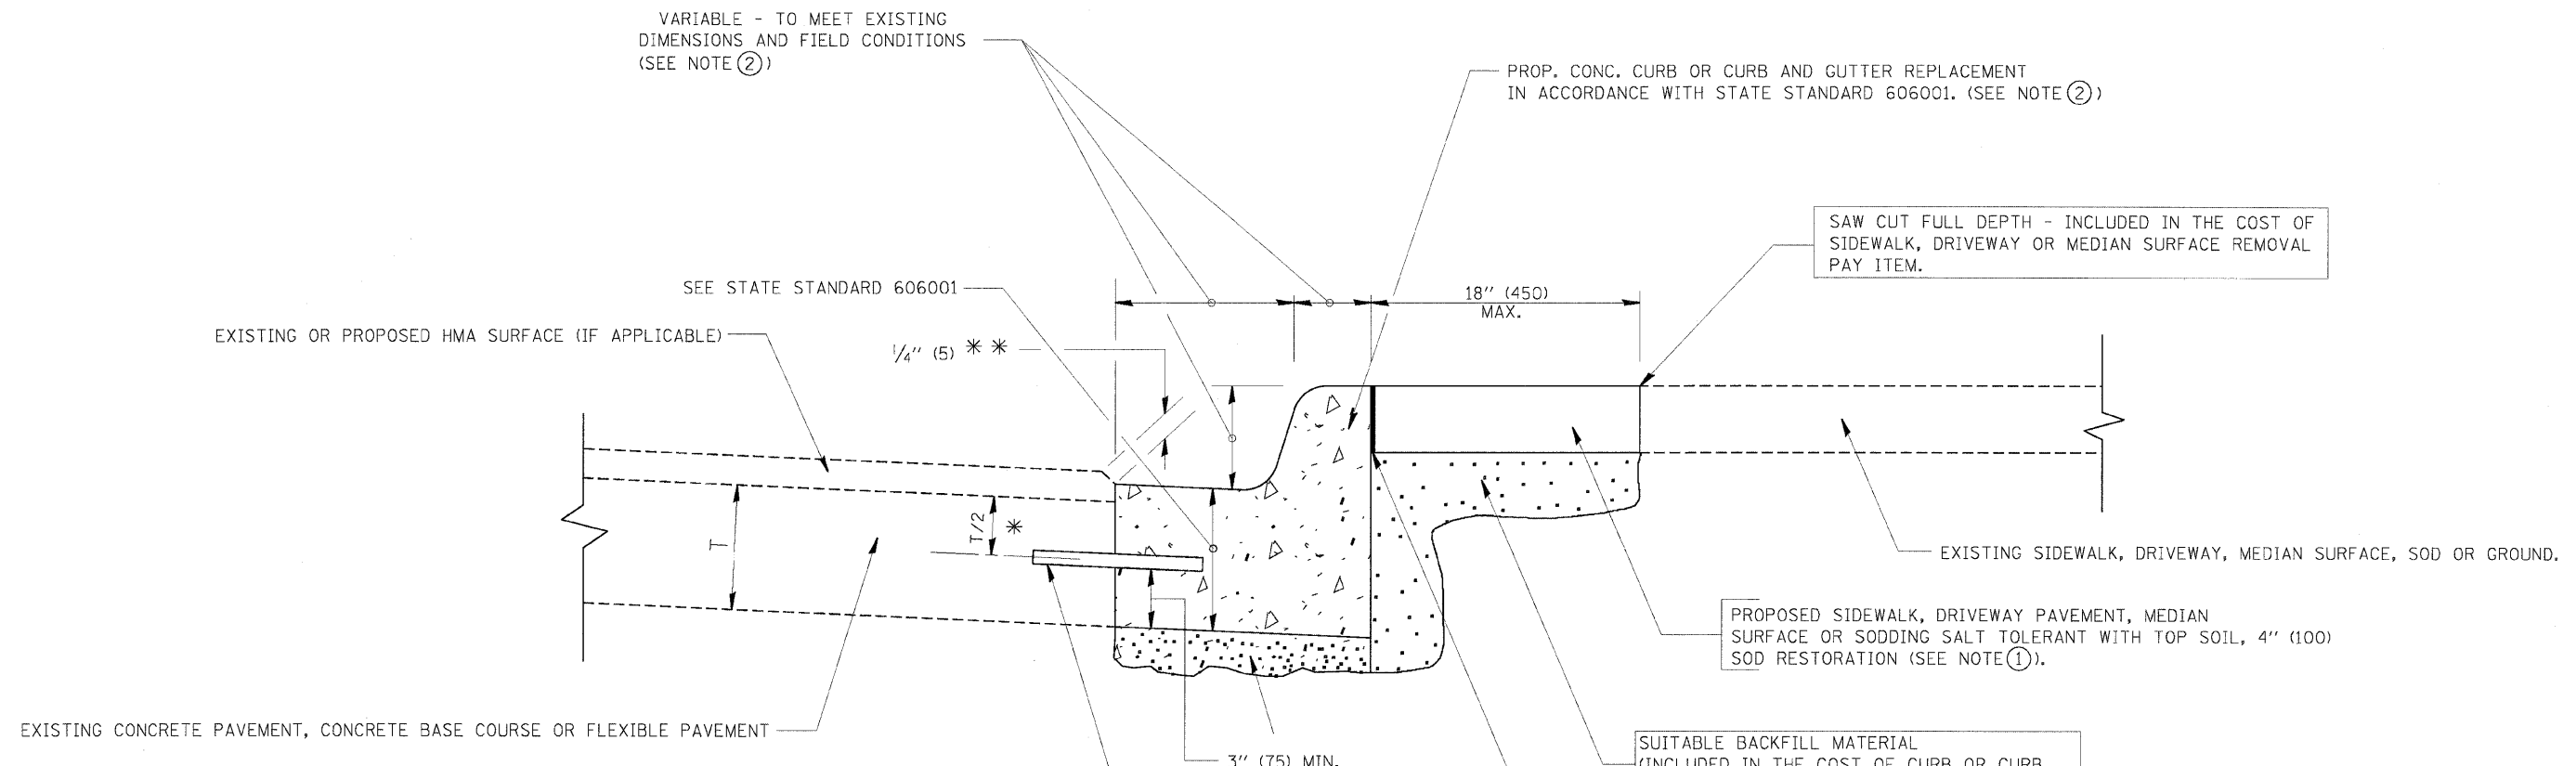

- * 3" (75) MINIMUM FROM TOP AND BOTTOM OF THE CONCRETE PAVEMENT OR BASE COURSE.
 - * * IF THE FINAL SURFACE OF THE PAVEMENT IS CONCRETE, THE GUTTER IS TO BE FLUSH WITH THE PAVEMENT.
- NOTE: ① SIDEWALK, DRIVEWAY PAVEMENT OR MEDIAN SURFACE SHALL BE SIMILAR TO THE MATERIAL BEING REMOVED AND WILL BE PAID FOR SEPARATELY.
- SODDING, SALT TOLERANT AND TOP SOIL, FURNISH AND PLACE 4" WILL BE PAID FOR SEPARATELY,
- ② FERTILIZER FOR THE PLACEMENT OF THE SOD IS NOT REQUIRED
- ③ CURB OR CURB AND GUTTER REPLACEMENT SHALL MATCH THE SHAPE OF THE EXISTING CURB OR CURB AND GUTTER UNLESS OTHERWISE SPECIFIED.
- ④ FOR CURB OR CURB AND GUTTER REMOVAL AND REPLACEMENT ADJACENT TO FLEXIBLE PAVEMENT DELETE EPOXY COATED TIE BARS.
- ⑤ LONGITUDINAL BARS, IF ENCOUNTERED IN THE EXISTING CURB OR CURB AND GUTTER, ARE NOT TO BE REPLACED. CUTTING AND REMOVING LONGITUDINAL BARS SHALL BE INCLUDED IN THE COST OF CURB OR CURB AND GUTTER REMOVAL AND REPLACEMENT.
- ⑥ THE COST OF HMA SURFACE REMOVAL IN THE EXISTING GUTTER FLAG SHALL BE INCLUDED IN THE COST OF THE CURB AND GUTTER REMOVAL AND REPLACEMENT.
- ⑦ THE REMOVAL AND REPLACEMENT OF THE EXISTING CURB OR CURB AND GUTTER SHALL BE DONE IN ACCORDANCE WITH THE APPLICABLE PORTIONS OF SECTION 440 AND 606 OF THE STANDARD SPECIFICATIONS.
- ⑧ THE LOCATIONS OF REMOVAL AND REPLACEMENT OF EXISTING CURB OR CURB AND GUTTER SHALL BE DETERMINED BY THE RESIDENT ENGINEER AT THE TIME OF CONSTRUCTION.


- SUITABLE BACKFILL MATERIAL (INCLUDED IN THE COST OF CURB OR CURB AND GUTTER REMOVAL AND REPLACEMENT)
- PROPOSED 3/4" (20) PREFORMED EXPANSION JOINT AT CONCRETE SIDEWALKS, DRIVEWAYS, AND MEDIANS. (INCLUDED IN THE COST OF CURB OR CURB AND GUTTER REMOVAL AND REPLACEMENT.)
- UNSUITABLE SUB-BASE MATERIAL TO BE REMOVED, IF DIRECTED BY THE ENGINEER, SHALL BE REPLACED WITH EITHER SUB-BASE GRANULAR MATERIAL, TYPE B OR ADDITIONAL THICKNESS OF CONCRETE.
- REMOVAL AND REPLACEMENT 4" (100) OR LESS IS INCLUDED IN THE COST OF CURB OR CURB AND GUTTER REMOVAL AND REPLACEMENT.
- REMOVAL AND REPLACEMENT IN EXCESS OF 4" (100) WILL BE PAID FOR IN ACCORDANCE WITH ARTICLE 109.04 OF THE STANDARD SPECIFICATIONS.
- PROPOSED #6 (20) EPOXY COATED TIE BARS 24" (600) LONG AT 24" (600) CENTERS WILL NOT BE PAID FOR SEPARATELY. DELETE EPOXY COATED TIE BARS IF EXISTING TIE BARS ARE USUABLE AS DETERMINED BY THE ENGINEER. (SEE NOTE ③).

BASIS OF PAYMENT:
 THIS WORK WILL BE PAID FOR AT THE CONTRACT UNIT PRICE PER FOOT (METER) FOR "CURB REMOVAL AND REPLACEMENT" OR "COMBINATION CONCRETE CURB AND GUTTER REMOVAL AND REPLACEMENT".

CURB OR CURB AND GUTTER REMOVAL AND REPLACEMENT


ALL DIMENSIONS ARE IN INCHES (MILLIMETERS) UNLESS OTHERWISE SHOWN.

FILE NAME =	USER NAME = drivkosgn	DESIGNED - A. HOUSEH	REVISED - R. SHAH 10-03-96	STATE OF ILLINOIS DEPARTMENT OF TRANSPORTATION	CURB OR CURB AND GUTTER REMOVAL AND REPLACEMENT	F.A.P. RTE.	SECTION	COUNTY	TOTAL SHEETS	SHEET NO.	
et:\ps_work\psidot\drivkosgn\d0108315\24.dgn		DRAWN -	REVISED - A. ABBAS 03-21-97			351	(535 B-6R & 536) RS-4	WILL	35	26	
PLOT SCALE = 50.000 1/ IN.		CHECKED -	REVISED - M. GOMEZ 01-22-01			BD600-06 (BD-24)					
PLOT DATE = 12/15/2009		DATE - 03-11-94	REVISED - R. BORO 12-15-09			CONTRACT NO. 60H62					
					SCALE: NONE		SHEET NO. 1 OF 1 SHEETS		STA. TO STA.		
FED. ROAD DIST. NO. 1 (ILLINOIS) FED. AID PROJECT											

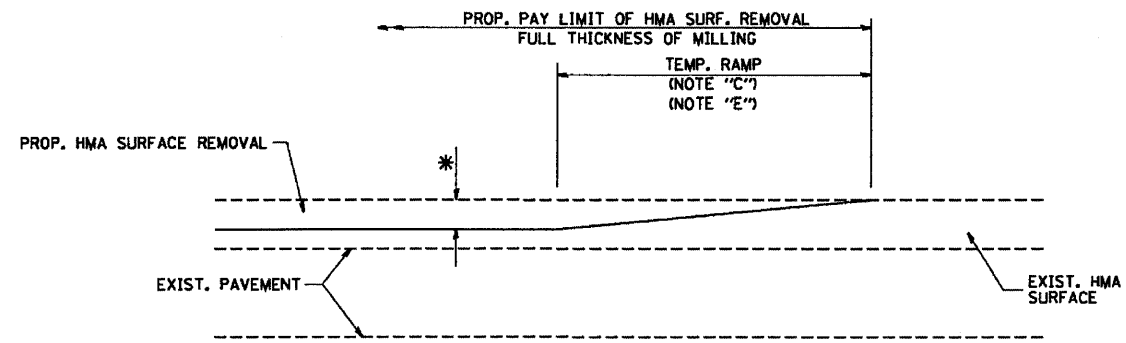

MILLED TEMPORARY RAMP
(FOR BUTT JOINT AND HMA TAPER SEE DETAIL BELOW)


OPTION 1

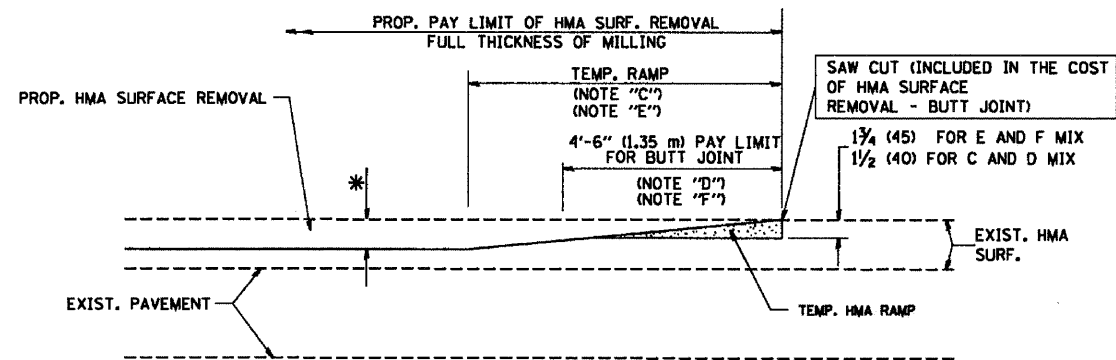

HMA CONSTRUCTED TEMPORARY RAMP
(FOR BUTT JOINT AND HMA TAPER SEE DETAIL BELOW)


OPTION 2

TYPICAL TEMPORARY RAMP

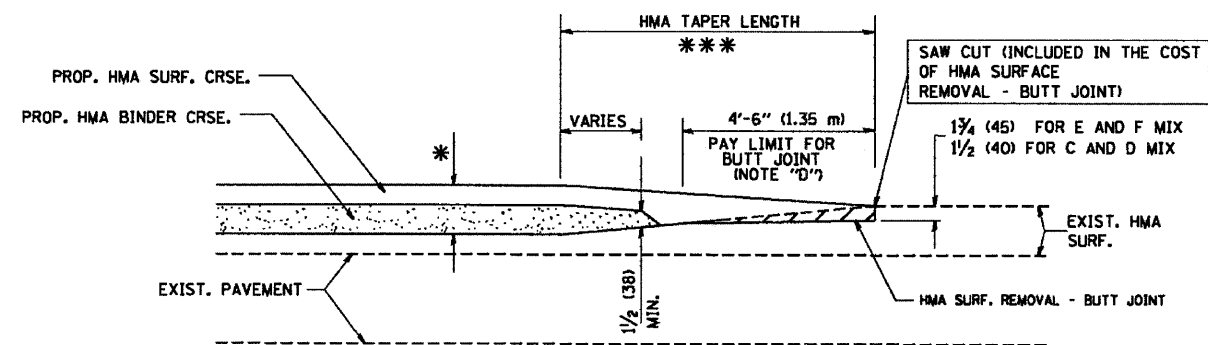


BUTT JOINT AND
HMA TAPER

TYPICAL BUTT JOINT AND HMA TAPER
FOR MILLING AND RESURFACING

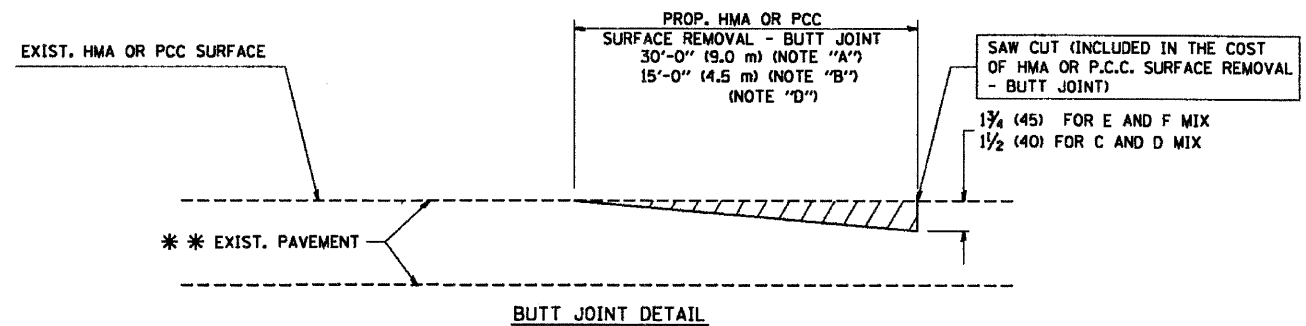

BUTT JOINT DETAIL

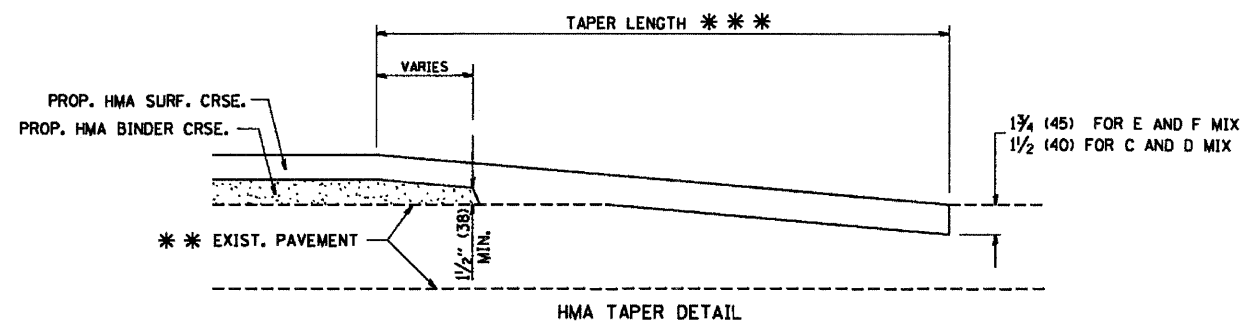

HMA TAPER DETAIL

TYPICAL BUTT JOINT AND HMA TAPER
FOR RESURFACING ONLY

** PC CONCRETE, HMA OR HMA RESURFACED PAVEMENT.

NOTES

- A: MAINLINE ROADWAYS AND MAJOR SIDE ROADS.
 - B: MINOR SIDE ROADS.
 - C: THE TEMP. RAMP SHALL BE CONSTRUCTED IMMEDIATELY UPON REMOVAL OF THE EXISTING HMA SURFACE.
 - D: THE BUTT JOINT SHALL BE CONSTRUCTED IMMEDIATELY PRIOR TO PLACING THE PROPOSED HMA COURSES.
 - E: TAPER THE TEMP. RAMP AT A RATE OF 3'-0" (900 mm) PER 1 INCH (25 mm) OF MILLING THICKNESS.
 - F: INSTALLATION AND REMOVAL OF THE 4'-6" (1.35 m) TEMP. RAMP IS INCLUDED IN COST OF HMA SURFACE REMOVAL - BUTT JOINT
 - G: SEE ARTICLE 406.08 AND 406.14 OF THE STANDARD SPECIFICATIONS FOR "HMA AND/OR PCC SURFACE REMOVAL, BUTT JOINT".
- * SEE TYPICAL SECTIONS FOR MILLING THICKNESS.
- *** 20'-0" (6.1 m) PER 1 (25) RESURFACING (NOTE "A")
10'-0" (3.0 m) PER 1 (25) RESURFACING (NOTE "B")

BASIS OF PAYMENT:

THE BUTT JOINT WILL BE PAID FOR AT THE CONTRACT UNIT PRICE PER SQUARE YARD (SQURE METER) FOR "HOT-MIX ASPHALT SURFACE REMOVAL - BUTT JOINT" OR FOR "PORTLAND CEMENT CONCRETE SURFACE REMOVAL - BUTT JOINT".


ALL DIMENSIONS ARE IN INCHES (MILLIMETERS) UNLESS OTHERWISE SHOWN.

FILE NAME = W:\data\22x34\bd32.dgn	USER NAME = geglennob	DESIGNED - M. DE YONG	REVISED - R. SHAH 10-25-94
		DRAWN -	REVISED - A. ABBAS 03-21-97
	PLOT SCALE = 58.0000' / IN.	CHECKED -	REVISED - M. GOMEZ 04-06-01
	PLOT DATE = 1/4/2008	DATE - 06-13-90	REVISED - R. BORO 01-01-07

STATE OF ILLINOIS
DEPARTMENT OF TRANSPORTATION

BUTT JOINT AND HMA TAPER DETAILS	
SCALE: NONE	SHEET NO. 1 OF 1 SHEETS STA. TO STA.

F.A.P. RTE.	SECTION	COUNTY	TOTAL SHEETS	SHEET NO.
351	(535 B-6R & 536) RS-4	WILL	35	27
BD400-05 BD32		CONTRACT NO.	60H62	
FED. ROAD DIST. NO. 1 ILLINOIS FED. AID PROJECT				

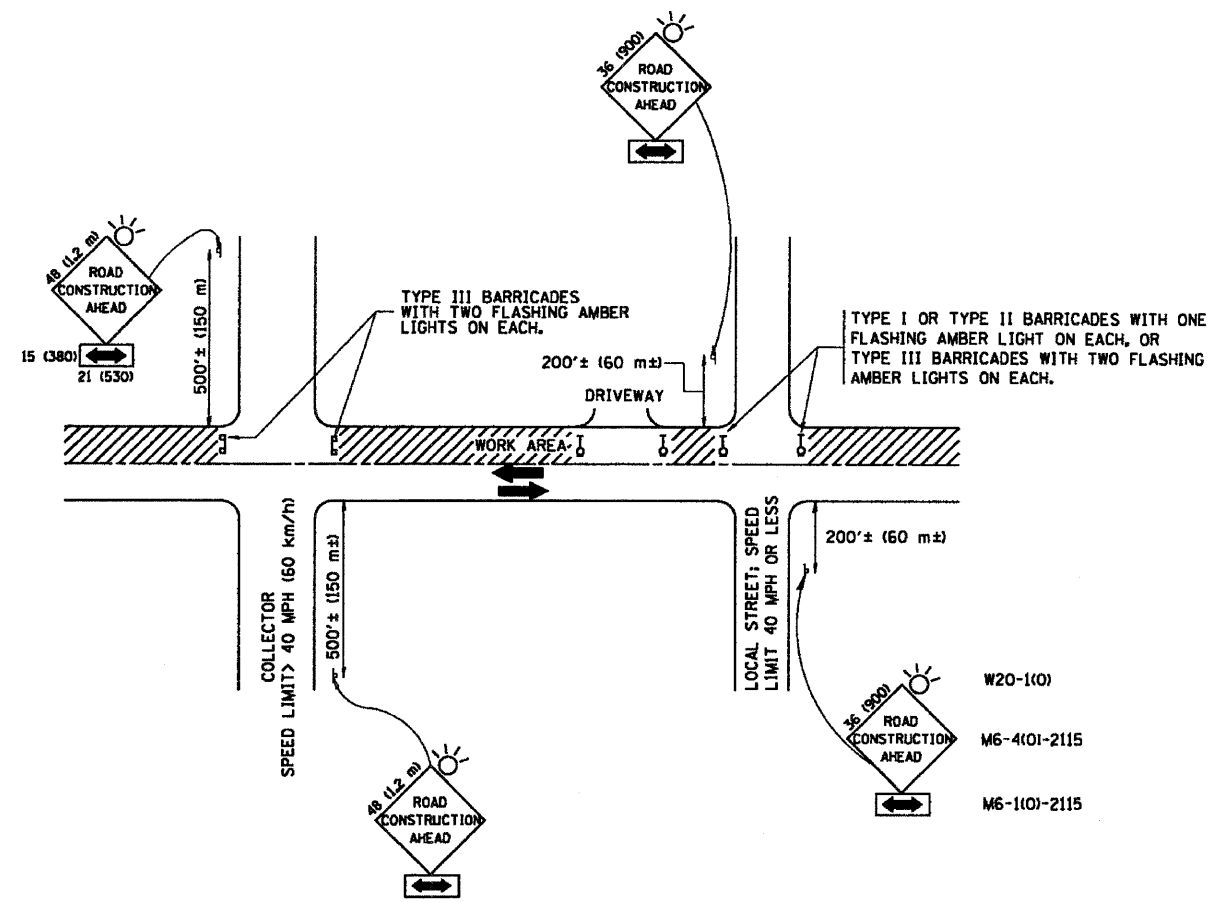

TRAFFIC CONTROL AND PROTECTION FOR SIDE ROADS, INTERSECTIONS, AND DRIVEWAYS

NOTES:

A. FOR NO LANE RESTRICTION ON THE SIDE ROAD OR DRIVEWAYS

1. SIDE ROAD WITH A SPEED LIMIT OF 40 MPH (60 km/h) OR LESS AS SHOWN ON THE DRAWING AND AS DIRECTED BY THE ENGINEER:

a) ONE ROAD CONSTRUCTION AHEAD SIGN 36 x 36 (900x900) WITH A FLASHER AND FLAG MOUNTED ON IT APPROXIMATELY 200' (60 m) IN ADVANCE OF THE MAIN ROUTE.

b) THE CLOSED PORTION OF THE MAIN ROUTE SHALL BE PROTECTED BY BLOCKING WITH TYPE I, TYPE II OR TYPE III BARRICADES, 1/3 OF THE CROSS SECTION OF THE CLOSED PORTION.

2. SIDE ROAD WITH A SPEED LIMIT GREATER THAN 40 MPH (60 km/h) AS SHOWN ON THE DRAWING AND AS DIRECTED BY THE ENGINEER:

a) ONE ROAD CONSTRUCTION AHEAD SIGN 48 x 48 (1.2 m x 1.2 m) WITH A FLASHER MOUNTED ON IT APPROXIMATELY 500' (150 m) IN ADVANCE OF THE MAIN ROUTE.

b) THE CLOSED PORTION OF THE MAIN ROUTE SHALL BE PROTECTED BY BLOCKING WITH TYPE III BARRICADES, 1/2 OF THE CROSS SECTION OF THE CLOSED PORTION.

3. WHEN THE SIDE ROAD LIES BETWEEN THE BEGINNING OF THE MAINLINE SIGNING AND THE WORK ZONE, A SINGLE HEADED ARROW (M6-1) SHALL BE USED IN LIEU OF THE DOUBLE HEADED ARROW (M6-4).

B. FOR A LANE CLOSURE ON A SIDE ROAD OR DRIVEWAY:

USE APPLICABLE PORTIONS OF THE TYPICAL APPLICATION OF TRAFFIC CONTROL DEVICES (STD. T01501, STD. T01606 OR THE APPROPRIATE STANDARD). THE SPACING OF SIGNS AND BARRICADES SHALL BE ADJUSTED FOR FIELD CONDITIONS AS DIRECTED BY THE ENGINEER. THE DIRECTIONAL ARROW SHALL BE COVERED OR REMOVED WHEN NO LONGER CONSISTENT WITH THE SIDE ROAD LANE CLOSURE.

C. ADVANCE WARNING SIGNS ARE TO BE OMITTED ON DRIVEWAY UNLESS OTHERWISE NOTED.

D. THE TRAFFIC CONTROL AND PROTECTION FOR SIDE ROADS, INTERSECTIONS, AND DRIVEWAYS SHALL BE INCIDENTAL TO THE COST OF SPECIFIED TRAFFIC CONTROL STANDARDS OR ITEMS.

All dimensions are in millimeters (inches) unless otherwise shown.


FILE NAME = M:\distatd\22x34\col18.dgn	USER NAME = gegl10n0bt	DESIGNED - LHA	REVISED - J. OBERLE 10-18-95
		DRAWN -	REVISED - A. HOUSEH 03-06-96
		CHECKED -	REVISED - A. HOUSEH 10-15-96
		DATE - 06-89	REVISED - T. RAMMACHER 01-06-00

**STATE OF ILLINOIS
DEPARTMENT OF TRANSPORTATION**

**TRAFFIC CONTROL AND PROTECTION FOR
SIDE ROADS, INTERSECTIONS, AND DRIVEWAYS**


SCALE: NONE SHEET NO. 1 OF 1 SHEETS STA. TO STA.

F.A.P. RTE.	SECTION	COUNTY	TOTAL SHEETS	SHEET NO.
351	(535 8-6R & 536) RS-4	WILL	35	28
TC-10			CONTRACT NO. 60H62	
FED. ROAD DIST. NO. 1 ILLINOIS FED. AID PROJECT				

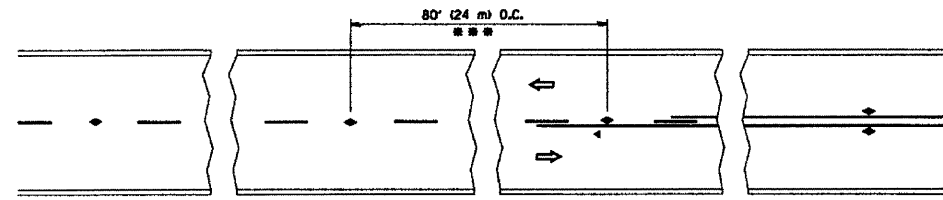


*** REDUCE TO 40' (12 m) O.C. ON CURVES WITH POSTED OR ADVISORY SPEED 45 M.P.H. (70 km/h) OR LESS.


TWO-LANE/TWO-WAY

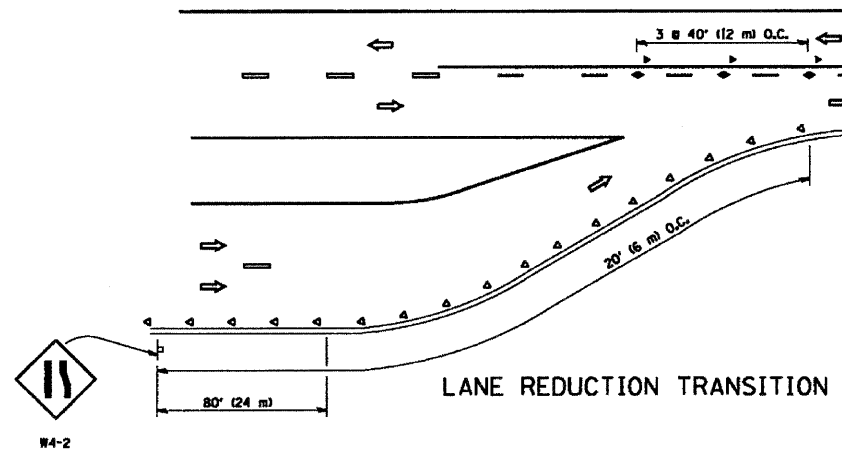


LANE REDUCTION TRANSITION

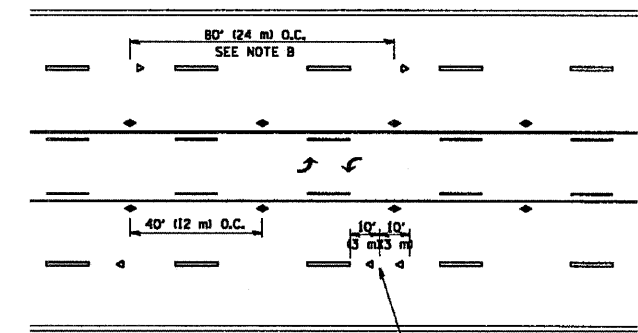

TWO-WAY LEFT TURN

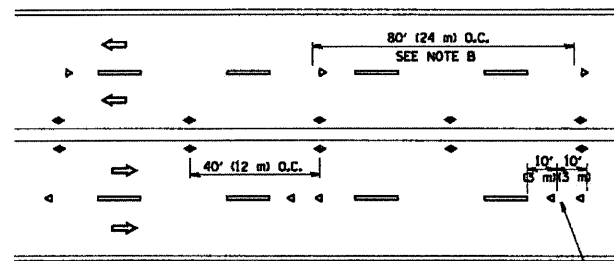

MULTI-LANE/UNDIVIDED

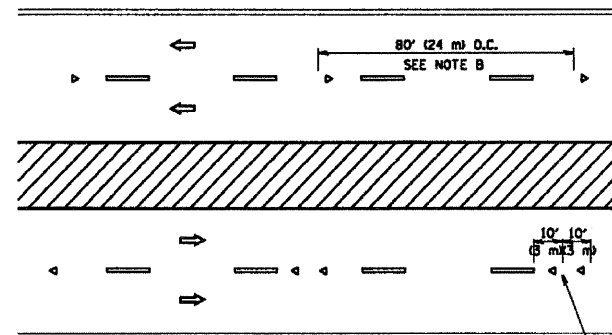

MULTI-LANE/DIVIDED

GENERAL NOTES

1. MARKERS USED WITH DASHED LINES SHALL BE CENTERED IN THE GAP BETWEEN SEGMENTS.
2. MARKERS USED ADJACENT TO SOLID LINES SHALL BE OFFSET 2 TO 3 (50 TO 75) TOWARD TRAFFIC AS SHOWN.
3. MARKERS THROUGH TANGENTS LESS THAN 500' (150 m) IN LENGTH BETWEEN CURVES SHALL BE INSTALLED AT THE LESSER OF THE TWO CURVE SPACINGS.

SYMBOLS


- YELLOW STRIPE
- WHITE STRIPE
- ◀ ONE-WAY AMBER MARKER
- ◀ ONE-WAY CRYSTAL MARKER (W/O)
- ◀ TWO-WAY AMBER MARKER

LANE MARKER NOTES

- A. USE DOUBLE LANE LINE MARKERS SPACED AS SHOWN.
- B. REDUCE TO 40' (12 m) O.C. ON CURVES WHERE ADVISORY SPEEDS ARE 10 M.P.H. (20 km/h) LOWER THAN POSTED SPEEDS.

DESIGN NOTES

1. DOUBLE LANE LINE MARKERS SHALL BE USED UNLESS SPECIFIED OTHERWISE.
2. EXCEPT AS SHOWN ON THE LANE REDUCTION TRANSITION AND FREEWAY EXIT RAMP DETAIL, MARKERS ARE NOT TO BE SPECIFIED ON RIGHT EDGE LINES.
3. THE EXACT MARKER LIMITS, SPACING, AND COLOR SHOULD BE INCLUDED IN THE PLANS.
4. MARKERS SHOULD NOT BE USED ALONGSIDE CURBS EXCEPT FOR EXTREMELY SHORT SECTIONS OF CURBS WHERE NOT MORE THAN TWO MARKERS WOULD BE INVOLVED.



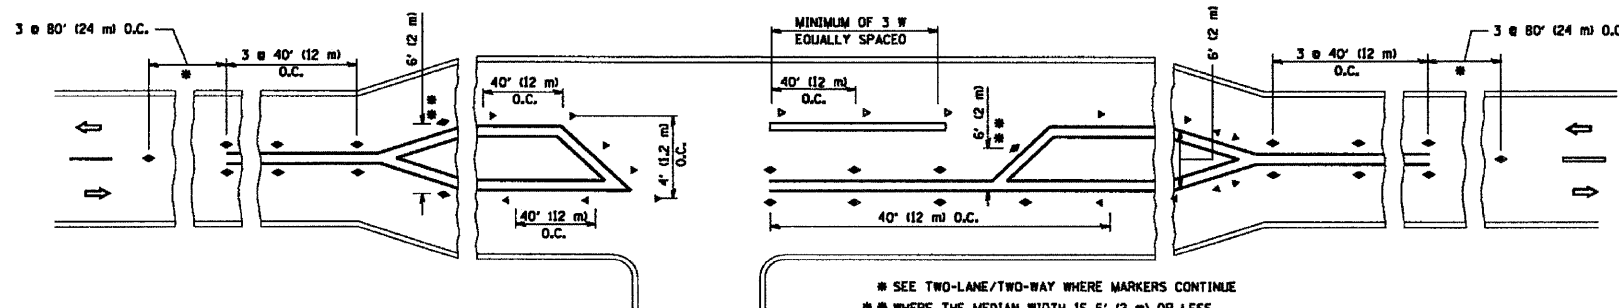


LEFT TURN


* SEE TWO-LANE/TWO-WAY WHERE MARKERS CONTINUE
 ** WHERE THE MEDIAN WIDTH IS 6' (2 m) OR LESS USE TWO-WAY MARKERS.

All dimensions are in inches (millimeters) unless otherwise shown.



FILE NAME = W:\drtatd\22x34\te11.dgn	USER NAME = geg1enob1	DESIGNED - DRAWN -	REVISED - T. RAMMACHER 09-19-94 REVISED - T. RAMMACHER 03-12-99 REVISED - T. RAMMACHER 01-06-00 REVISED -	STATE OF ILLINOIS DEPARTMENT OF TRANSPORTATION	TYPICAL APPLICATIONS RAISED REFLECTIVE PAVEMENT MARKERS (SNOW-PLOW RESISTANT)		F.A.P. RTE. 351	SECTION 1535 B-GR & 5361 RS-4	COUNTY WILL	TOTAL SHEETS 35	SHEET NO. 29	
SCALE: NONE	SHEET NO. 1 OF 1 SHEETS	STA.	TO STA.		TC-11		CONTRACT NO. 60H62					
							FED. ROAD DIST. NO. 1 ILLINOIS FED. AID PROJECT					
PLOT SCALE = 50.000' / IN. PLOT DATE = 1/4/2008		CHECKED - DATE -										

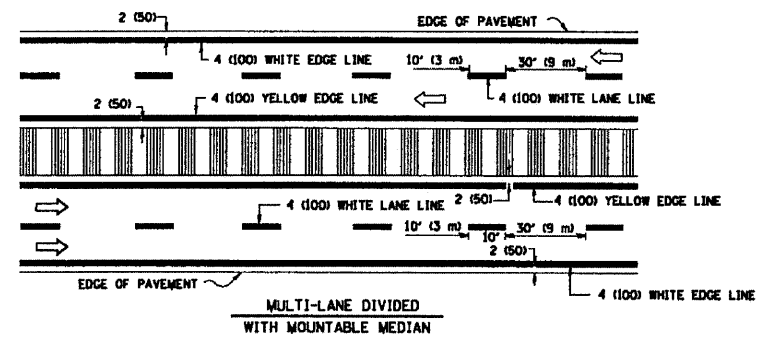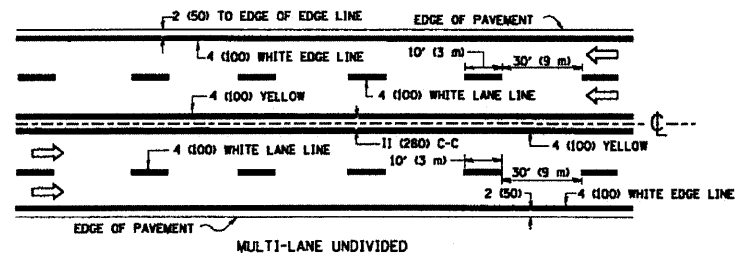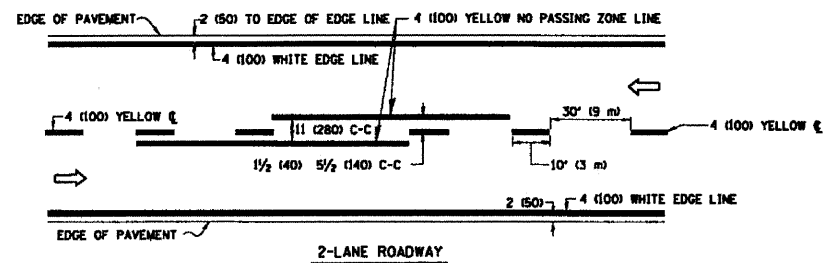


TYPICAL LANE AND EDGE LINE MARKING

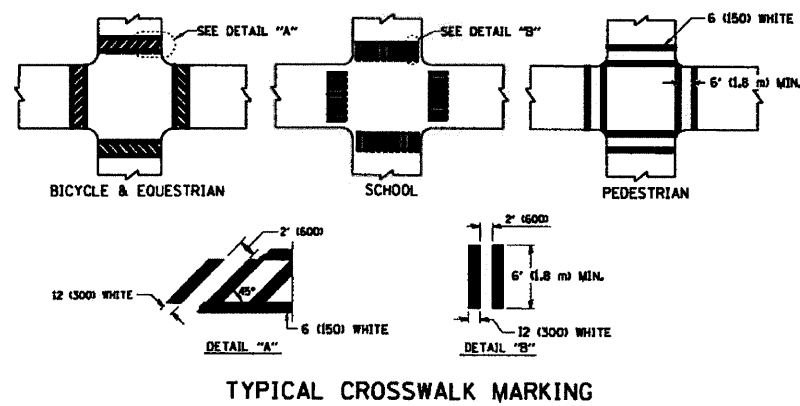


TYPICAL CROSSWALK MARKING

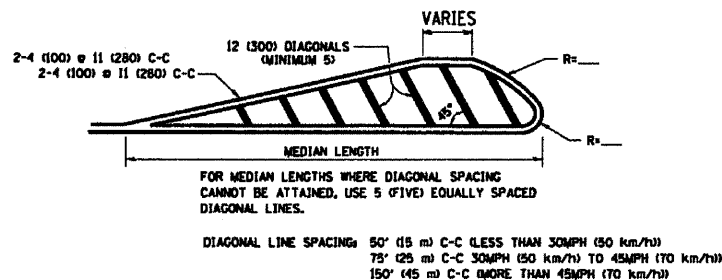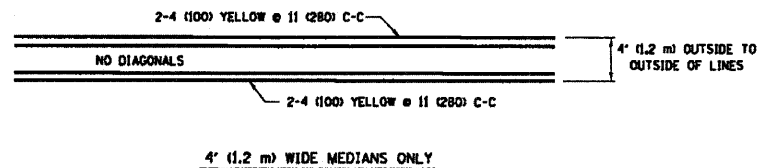

MEDIANS OVER 4' (1.2 m) WIDE

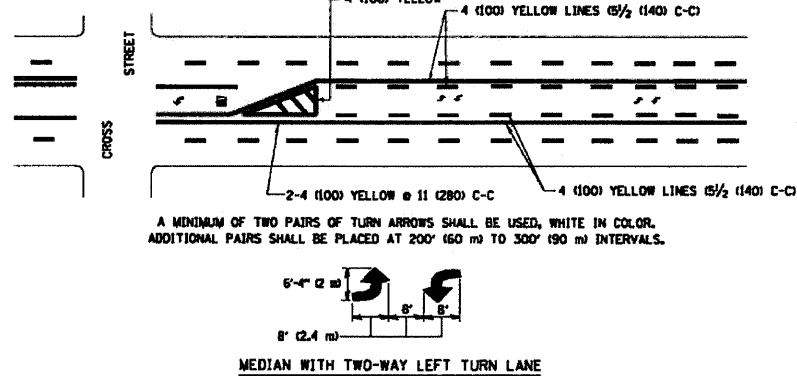


TYPICAL PAINTED MEDIAN MARKING

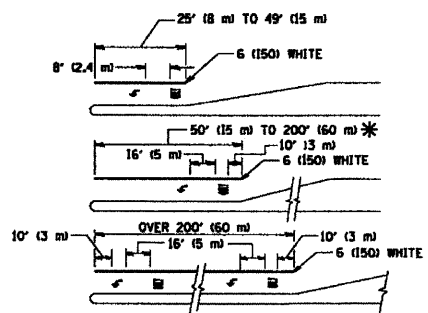


FULL SIZE LETTERS 8" (2.4 m) AND ARROWS SHALL BE USED.
 * AREA = 15.6 SQ. FT. (1.5 m²) □ AREA = 20.8 SQ. FT. (1.9 m²)
 * TURN LANES IN EXCESS OF 400' (120 m) IN LENGTH MAY HAVE AN ADDITIONAL SET OF ARROW - "ONLY" INSTALLED MIDWAY BETWEEN THE OTHER TWO SETS OF ARROW - "ONLY".

TYPICAL LEFT (OR RIGHT) TURN LANE

TYPICAL TURN LANE MARKING

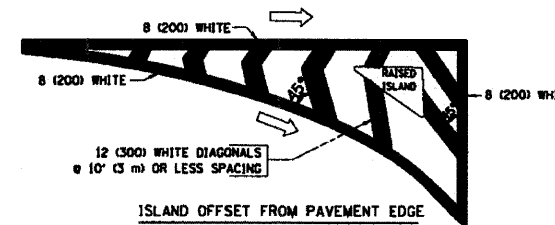

ISLAND OFFSET FROM PAVEMENT EDGE

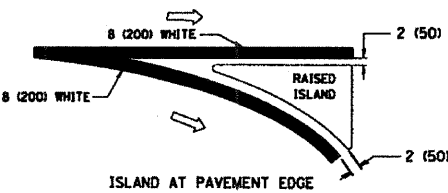



ISLAND AT PAVEMENT EDGE

TYPICAL ISLAND MARKING

TYPE OF MARKING	WIDTH OF LINE	PATTERN	COLOR	SPACING / REMARKS
CENTERLINE ON 2 LANE PAVEMENT	4 (100)	SKIP-DASH	YELLOW	10' (3 m) LINE WITH 30' (9 m) SPACE
CENTERLINE ON MULTI-LANE UNDIVIDED PAVEMENT	2 @ 4 (100)	SOLID	YELLOW	11 (280) C-C
NO PASSING ZONE LINES FOR ONE DIRECTION FOR BOTH DIRECTIONS	4 (100) 2 @ 4 (100)	SOLID SOLID	YELLOW YELLOW	5/2 (140) C-C FROM SKIP-DASH CENTERLINE 11 (280) C-C OMIT SKIP-DASH CENTERLINE BETWEEN
LANE LINES	4 (100) 6 (125) ON FREEWAYS	SKIP-DASH SKIP-DASH	WHITE WHITE	10' (3 m) LINE WITH 30' (9 m) SPACE
DOTTED LINES (EXTENSIONS OF CENTER, LANE OR TURN LANE MARKINGS)	SAME AS LINE BEING EXTENDED	SKIP-DASH	SAME AS LINE BEING EXTENDED	2' (600) LINE WITH 6' (1.8 m) SPACE
EDGE LINES	4 (100)	SOLID	YELLOW-LEFT WHITE-RIGHT	OUTLINE MOUNTABLE MEDIANS IN YELLOW EDGE LINES ARE NOT USED NEXT TO BARRIER CURB
TURN LANE MARKINGS	6 (150) LINE, FULL SIZE LETTERS & SYMBOLS (8" (2.4m))	SOLID	WHITE	SEE TYPICAL TURN LANE MARKING DETAIL
TWO WAY LEFT TURN MARKING	2 @ 4 (100) EACH DIRECTION 8' (2.4m) LEFT ARROW	SKIP-DASH AND SOLID IN PAIRS	YELLOW WHITE	10' (3 m) LINE WITH 30' (9 m) SPACE FOR SKIP-DASH 5/2 (140) C-C BETWEEN SOLID LINE AND SKIP-DASH LINE SEE TYPICAL TWO-WAY LEFT TURN MARKING DETAIL
CROSSWALK LINES (PEDESTRIAN & BICYCLE & EQUESTRIAN) A. DIAGONALS (BIKE & EQUESTRIAN) B. LONGITUDINAL BARS (SCHOOL)	2 @ 6 (150) 12 (300) @ 45° 12 (300) @ 90°	SOLID SOLID SOLID	WHITE WHITE WHITE	NOT LESS THAN 6' (1.8 m) APART 2' (600) APART SEE TYPICAL CROSSWALK MARKING DETAILS.
STOP LINES	24 (600)	SOLID	WHITE	PLACE 4' (1.2 m) IN ADVANCE OF AND PARALLEL TO CROSSWALK, IF PRESENT. OTHERWISE, PLACE AT DESIRED STOPPING POINT, PARALLEL TO CROSSROAD CENTERLINE, WHERE POSSIBLE
PAINTED MEDIANS	2 @ 4 (100) WITH 12 (300) DIAGONALS @ 45° NO DIAGONALS USED FOR 4' (1.2 m) WIDE MEDIANS	SOLID	YELLOW TWO WAY TRAFFIC WHITE ONE WAY TRAFFIC	11 (280) C-C FOR THE DOUBLE LINE SEE TYPICAL PAINTED MEDIAN MARKING.
GORE MARKING AND CHANNELIZING LINES	8 (200) WITH 12 (300) DIAGONALS @ 45°	SOLID	WHITE	DIAGONALS: 15' (4.5 m) C-C (LESS THAN 30MPH (50 km/h)) 20' (6 m) C-C 30MPH (50 km/h) TO 45MPH (70 km/h) 30' (9 m) C-C (OVER 45MPH (70 km/h))
RAILROAD CROSSING	24 (600) TRANSVERSE LINES, "RR" 15 6" (1.8 m) LETTERS, 16 (400) LINE FOR "X"	SOLID	WHITE	SEE STATE STANDARD 780001 AREA OF: "R"=3.6 SQ. FT. (0.33 m ²) EACH "X"=54.0 SQ. FT. (5.0 m ²)
SHOULDER DIAGONALS	12 (300) @ 45°	SOLID	WHITE - RIGHT YELLOW - LEFT	50' (15 m) C-C (LESS THAN 30MPH (50 km/h)) 75' (25 m) C-C (30 MPH (50 km/h) TO 45MPH (70 km/h)) 150' (45 m) C-C (OVER 45MPH (70 km/h))

FOR FURTHER DETAILS ON PAVEMENT MARKING REFER TO STANDARD SPECIFICATIONS FOR ROAD AND BRIDGE CONSTRUCTION AND STATE STANDARD 780001.

All dimensions are in inches (millimeters) unless otherwise shown.

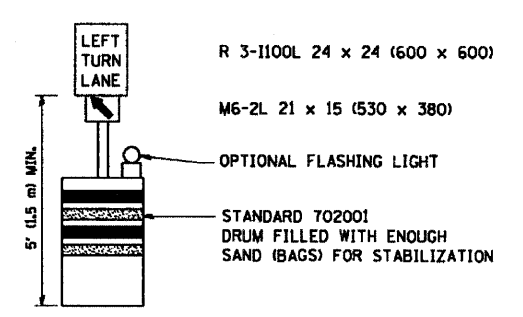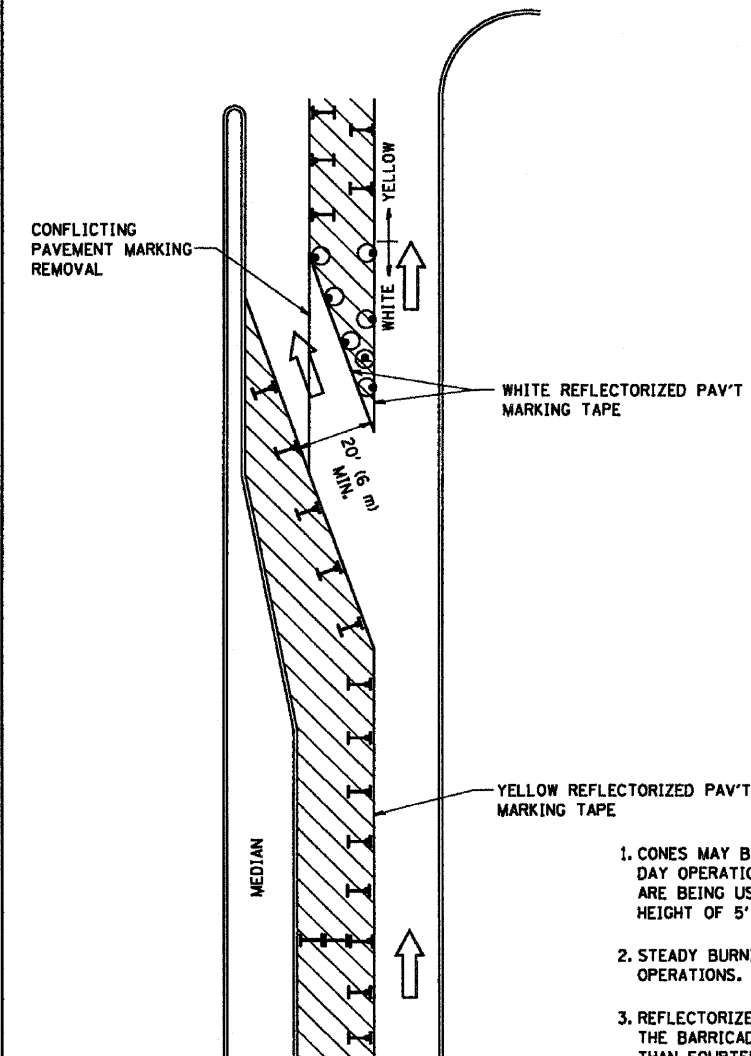

GENERAL NOTES

1. CONES MAY BE SUBSTITUTED FOR BARRICADES OR DRUMS AT HALF THE SPACING DURING DAY OPERATIONS. CONES SHALL BE A MINIMUM OF 28 (710) IN HEIGHT. WHEN CONES ARE BEING USED, THE "LEFT TURN LANE" SIGN MAY BE SKID MOUNTED AT A MINIMUM HEIGHT OF 5' (1.5 m).
2. STEADY BURNING LIGHTS WILL NOT BE REQUIRED ON BARRICADES OR DRUMS FOR DAY OPERATIONS. ALL LIGHTS SHALL BE MONODIRECTIONAL.
3. REFLECTORIZED TEMPORARY PAVEMENT MARKING TAPE SHALL BE PLACED THROUGHOUT THE BARRICADED AREA OF EACH TURN BAY WHERE THE CLOSURE TIME IS GREATER THAN FOURTEEN DAYS.
4. THIS APPLICATION ALSO APPLIES WHEN WORK IS BEING PERFORMED IN THE RIGHT LANE(S) AND THE RIGHT TURN BAY IS TO REMAIN OPEN. UNDER THIS CONDITION, "RIGHT TURN LANE" R3-100 24 x 24 (600 x 600) AND M6-2R 21 x 15 (530 x 380) SHALL BE USED.
5. THESE CONTROLS SHALL SUPPLEMENT MAINLINE TRAFFIC CONTROL FOR LANE CLOSURES.
6. LONGITUDINAL DIMENSIONS MAY BE ADJUSTED TO FIT FIELD CONDITIONS.
7. FORM BT 725 IS REQUIRED.
8. TRAFFIC CONTROL AND PROTECTION AT TURN BAYS (TO REMAIN OPEN TO TRAFFIC) SHALL BE INCLUDED IN THE COST SPECIFIED TRAFFIC CONTROL STANDARDS OR ITEMS.

LEGEND

- WORK AREA
- LANE OPEN TO TRAFFIC
- TYPE I OR II BARRICADE WITH STEADY BURN LIGHT
- DRUM WITH STEADY BURN LIGHT
- DRUM WITH SIGN (WITH OPTIONAL FLASHING LIGHT) SEE DETAIL
- TYPE I OR II CHECK BARRICADE WITH FLASHING LIGHT

All dimensions are in inches (millimeters) unless otherwise shown.


FILE NAME = M:\distr\to\22634\te14.dgn	USER NAME = geglenobt	DESIGNED -	REVISED - T. RAMMACHER 09-08-94
		DRAWN -	REVISED - A. HOUSEH 11-07-95
	PLOT SCALE = 50.0000 "/ IN.	CHECKED -	REVISED - A. HOUSEH 10-12-96
	PLOT DATE = 1/4/2008	DATE -	REVISED - T. RAMMACHER 01-06-00

**STATE OF ILLINOIS
DEPARTMENT OF TRANSPORTATION**


**TRAFFIC CONTROL AND PROTECTION AT TURN BAYS
(TO REMAIN OPEN TO TRAFFIC)**

SCALE: NONE SHEET NO. 1 OF 1 SHEETS STA. TO STA.


F.A.P. RTE.	SECTION	COUNTY	TOTAL SHEETS	SHEET NO.
351	(535 B-6R & 536) RS-4	WILL	35	31
TC-14			CONTRACT NO. 60H62	
FED. ROAD DIST. NO. 1 ILLINOIS FED. AID PROJECT				

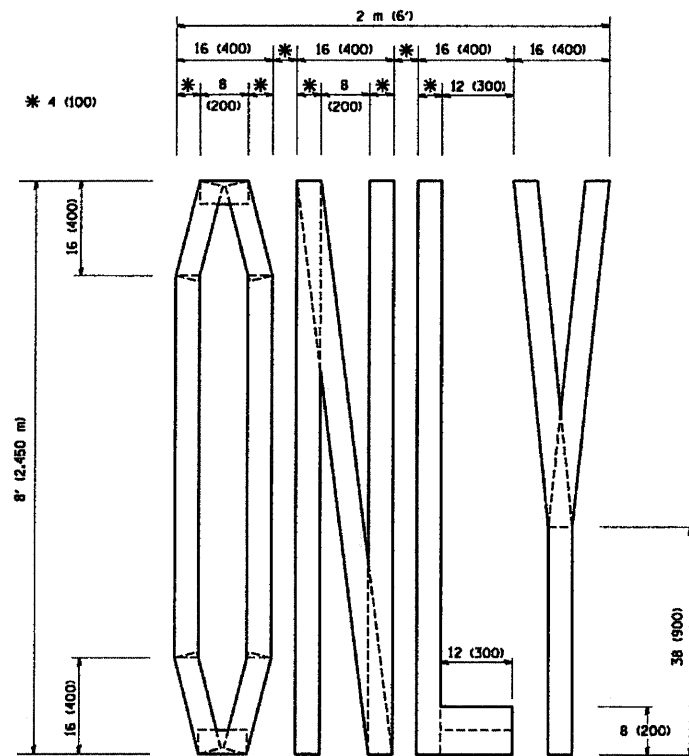

QUANTITY
 4 (100) LINE = 64.1 ft. (19.7 m)
 21.1 sq. ft. (1.97 sq. m)

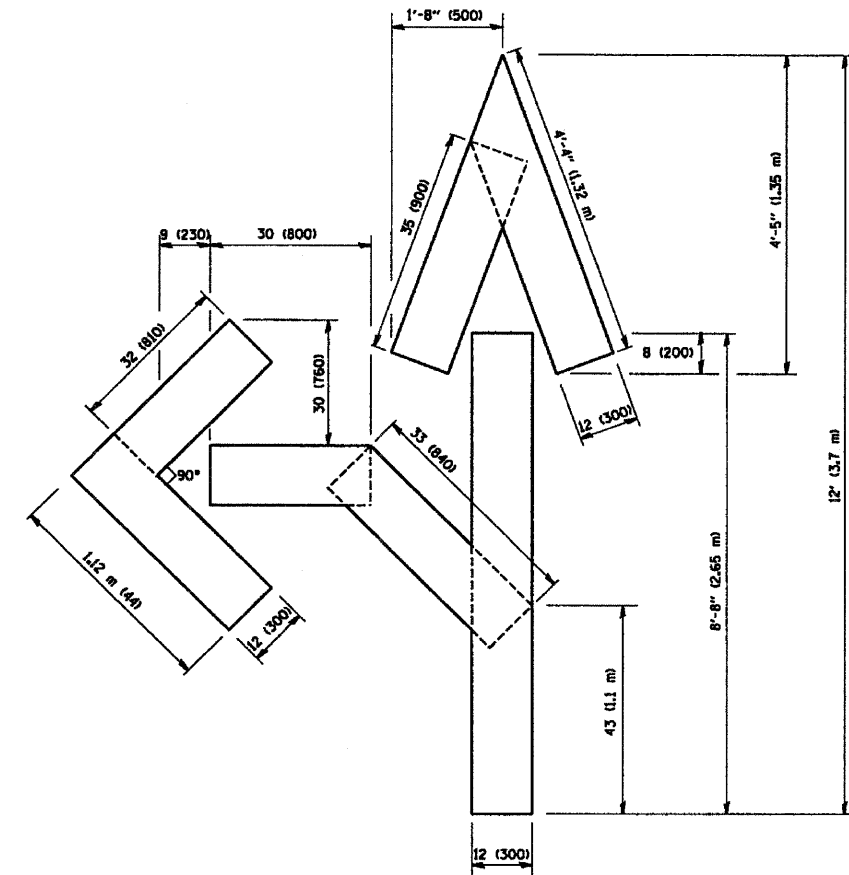


QUANTITY
 4 (100) LINE = 82.5 ft. (25.3 m)
 27.5 sq. ft. (2.53 sq. m)

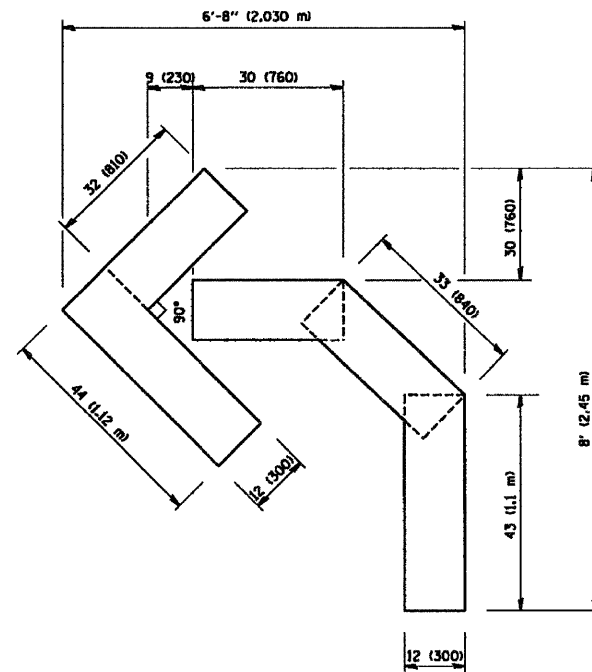

QUANTITY
 4 (100) LINE = 45.5 ft. (13.9 m)
 15.2 sq. ft. (1.39 sq. m)

All dimensions are in inches (millimeters) unless otherwise shown.

FILE NAME = M:\distat\22x34\16.dgn	USER NAME = geglianob	DESIGNED - DRAWN -	REVISED -T. RAMMACHER 06-05-96 REVISED -T. RAMMACHER 11-04-97	STATE OF ILLINOIS DEPARTMENT OF TRANSPORTATION	PAVEMENT MARKING LETTERS AND SYMBOLS FOR TRAFFIC STAGING			F.A.P. RTE.	SECTION	COUNTY	TOTAL SHEETS	SHEET NO.	
	PLOT SCALE = 50.0000' / IN.	CHECKED -	REVISED -T. RAMMACHER 03-02-98		SCALE: NONE	SHEET NO. 1 OF 1 SHEETS	STA.	TO STA.	351	(535 B-6R & 536) RS-4	WILL	35	32
	PLOT DATE = 1/4/2000	DATE - 09-18-94	REVISED -E. GOMEZ 08-28-00						TC-16				
									FED. ROAD DIST. NO. (ILLINOIS) FED. AID PROJECT				CONTRACT NO. 60H62

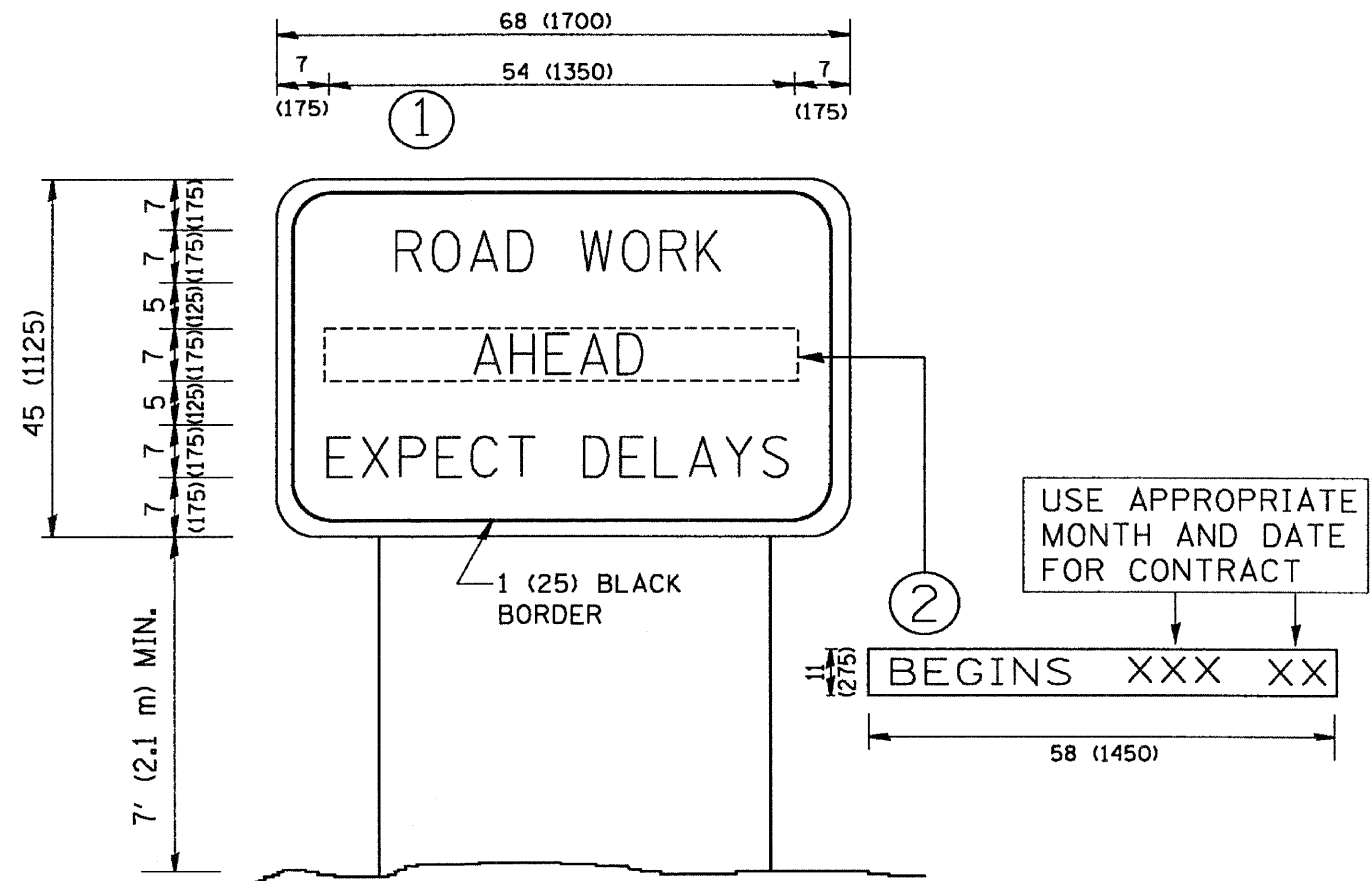


NOTES:

1. USE BLACK LETTERING ON ORANGE BACKGROUND.
2. ERECT SIGNS IN ADVANCE OF THE LOCATION FOR THE "ROAD CONSTRUCTION AHEAD" SIGN AT LOCATIONS AS DIRECTED BY THE ENGINEER.
3. ERECT SIGN ① WITH INSTALLED PANEL ② ONE WEEK PRIOR TO THE START OF CONSTRUCTION.
4. REMOVE PANEL ② SOON AFTER THE START OF CONSTRUCTION.
5. SEE SPECIAL PROVISION FOR "TEMPORARY INFORMATION SIGNING" FOR ADDITIONAL INFORMATION.
6. ONE SIGN ASSEMBLY EQUALS 25.70 SQ. FT. (2.3 SQ. M.)
7. SHALL BE PAID FOR AS TEMPORARY INFORMATION SIGNING.


ALL DIMENSIONS ARE IN INCHES (MILLIMETERS) UNLESS OTHERWISE SHOWN.

FILE NAME = W:\data\d22\34\to22.dgn	USER NAME = geglrenobt	DESIGNED -	REVISED - R. MIRS 09-15-97	STATE OF ILLINOIS DEPARTMENT OF TRANSPORTATION	ARTERIAL ROAD INFORMATION SIGN			F.A.P. RTE.	SECTION	COUNTY	TOTAL SHEETS	SHEET NO.	
		DRAWN -	REVISED - R. MIRS 12-11-97		SCALE: NONE	SHEET NO. 1 OF 1 SHEETS	STA.	TO STA.	351	(535 B-6R & 536) RS-4	WILL	35	33
		PLOT SCALE = 5/8" = 1" IN.	REVISED - T. RAMMACHER 02-02-99						TC-22		CONTRACT NO. 60H62		
		PLOT DATE = 1/4/2000	REVISED - C. JUCIUS 01-31-07						FED. ROAD DIST. NO. 1 ILLINOIS FED. AID PROJECT				


WITH INTERSECTION TRAFFIC SIGNALS

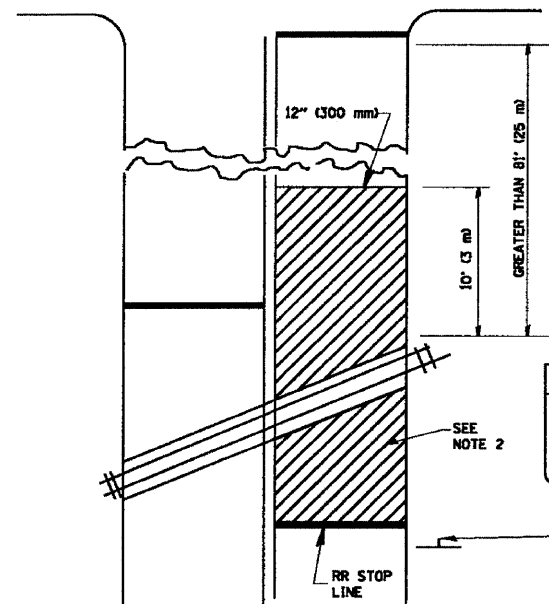

WITH NEAR-SIDE TRAFFIC SIGNALS

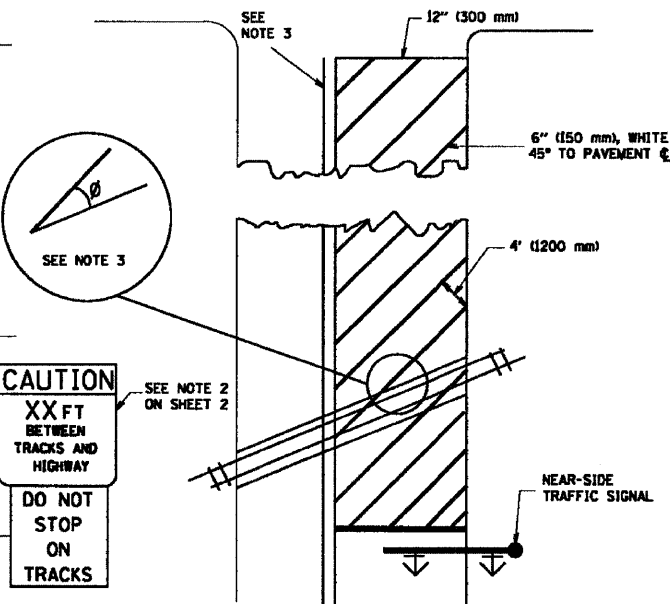

WITH NONSIGNALIZED INTERSECTION
81' (25 m) OR LESS TO CLOSEST RAIL

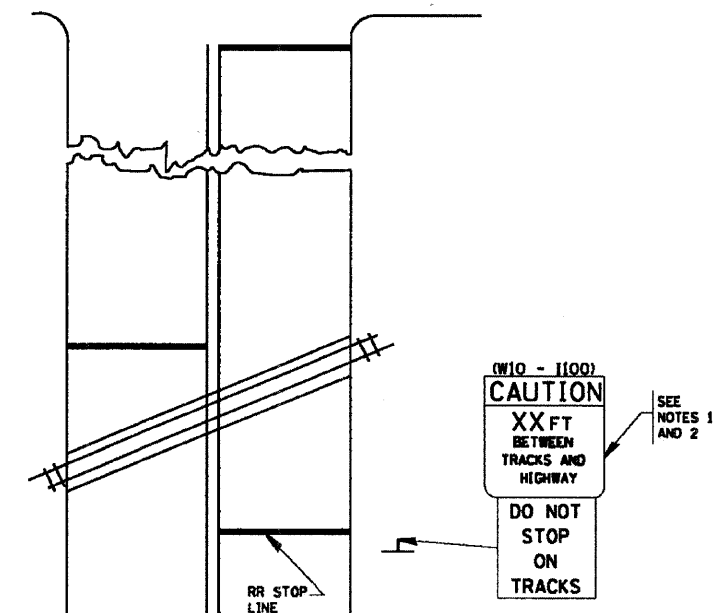

- NOTES:
1. PAVEMENT MARKINGS TO BE INSTALLED ONLY ON APPROACHES TO INTERSECTIONS CONTROLLED BY TRAFFIC SIGNALS WHICH ARE INTERCONNECTED WITH THE RAILROAD WARNING SIGNALS.
 2. WHERE NEAR-SIDE TRAFFIC SIGNALS ARE USED, THE PAVEMENT MARKINGS EXTENDS TO THE INTERSECTION.
 3. WHERE THE ANGLE BETWEEN THE DIAGONAL STRIPES AND THE TRACK (Ø) WOULD BE LESS THAN APPROXIMATELY 20°, THE STRIPES SHOULD BE SLOPED IN THE OPPOSITE DIRECTION FROM THAT SHOWN.


- NOTE 1:
1. DISTANCE TO BE SHOWN ON SIGN MEASURED FROM A POINT 6 FEET (1.8 m) FROM THE RAIL CLOSEST TO THE INTERSECTION TO THE STOP LINE OR CROSSWALK, WHICHEVER IS CLOSEST, ROUNDED DOWN TO THE NEAREST 5 FEET (1.5 m). WHERE THERE IS NO STOP LINE, MEASURE TO POINT WHERE THE DRIVER HAS A VIEW OF APPROACHING TRAFFIC.
 2. THE CLEARANCE SIGN IS ALSO TO BE USED AS AN INTERIM MEASURE AT LOCATIONS WITH INTERCONNECTED INTERSECTION TRAFFIC SIGNALS WHERE IT IS PLANNED TO CHANGE THEM TO NEAR-SIDE SIGNALS AT A FUTURE TIME. IN THIS CASE, THE DISTANCE TO BE SHOWN ON THE SIGN IS MEASURED FROM THE EDGE OF THE STRIPED-OUT AREA INSTEAD OF 6-FEET FROM THE RAIL. THE SIGN IS TO BE REMOVED WHEN THE NEAR-SIDE SIGNALS ARE INSTALLED AND THE PAVEMENT MARKINGS EXTEND TO THE INTERSECTION.

ALL DIMENSIONS ARE IN INCHES (MILLIMETERS) UNLESS OTHERWISE SHOWN.

FILE NAME = W:\distatd\22x34\tc23.dgn	USER NAME = goghenobt	DESIGNED -	REVISED - 01-01-07	STATE OF ILLINOIS DEPARTMENT OF TRANSPORTATION	TYPICAL SUPPLEMENTAL SIGNING AND PAVEMENT MARKING TREATMENT FOR RAILROAD CROSSINGS	F.A.P. RTE. 351	SECTION 1535 B-6R & 5361 RS-4	COUNTY WILL	TOTAL SHEETS 35	SHEET NO. 34		
	PLOT SCALE = 50.000 ' / IN.	DRAWN -	REVISED -			SCALE: NONE	SHEET NO. 1 OF 1 SHEETS	STA.	TO STA.	CONTRACT NO. 60H62		
	PLOT DATE = 1/4/2008	CHECKED -	REVISED -			FED. ROAD DIST. NO. 1 (ILLINOIS) FED. AID PROJECT						
		DATE -	REVISED -									

LOOPS NEXT TO SHOULDERS

PROVIDE A PAVEMENT REPLACEMENT NOTE WHICH SHOULD EQUAL 3' (900 mm) X WIDTH OF PAVED SHOULDER.

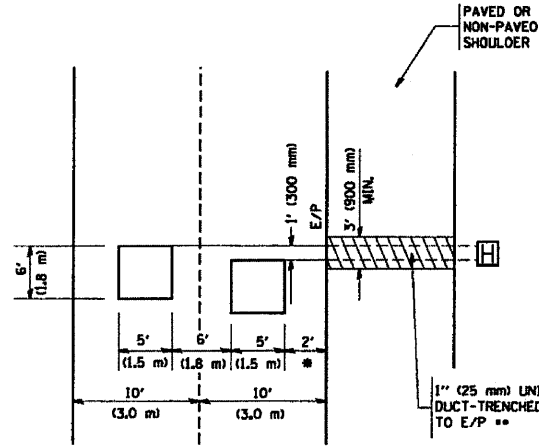


• = (600 mm)

•• UNIT DUCT IS TO BE SHOWN ON PLAN SHEETS BUT SHALL NOT BE INCLUDED IN THE PAY ITEMS.

**LEFT TURN LANES WITH MEDIANS
VOLUME DENSITY ("FAR OUT" DETECTION)
ON SAME APPROACH
(PROTECTED / PERMITTED LEFT TURN PHASING)**


HANDHOLE LOCATION MAY VARY DEPENDING ON GEOMETRICS AND DESIGN OF TRAFFIC SIGNALS. HEAVY-DUTY HANDHOLES TO BE USED WHEN THE MEDIAN IS MOUNTABLE. REFER TO STANDARD S14001 TO ENSURE THAT HANDHOLE FITS IN MEDIAN.

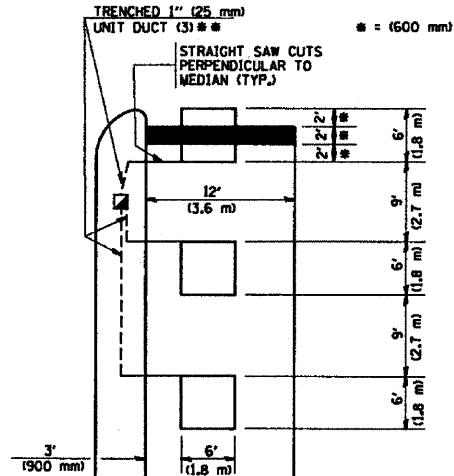

•• UNIT DUCT IS TO BE SHOWN ON PLAN SHEETS BUT SHALL NOT BE INCLUDED IN THE PAY ITEMS.


NOTE: DUAL LEFT TURNS NOT SHOWN REFER TO PLAN SHEET FOR DETECTOR LOOP REPLACEMENT

**LEFT TURN LANES WITHOUT MEDIANS
VOLUME DENSITY ("FAR OUT" DETECTION)
ON SAME APPROACH
(PROTECTED / PERMITTED LEFT TURN PHASING)**

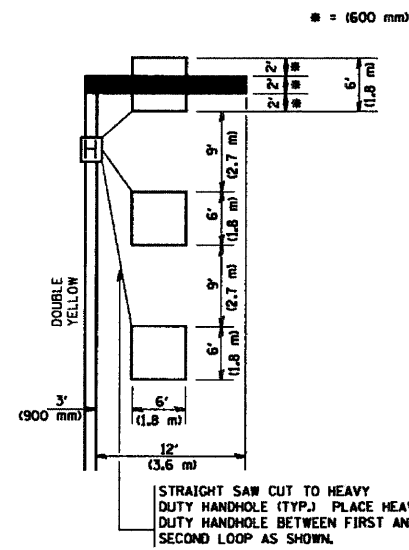


NOTE: DUAL LEFT TURNS NOT SHOWN REFER TO PLAN SHEET FOR DETECTOR LOOP REPLACEMENT

**ARTERIAL-VOLUME DENSITY ("FAR OUT" DETECTION)
CROSS STREET-VOLUME DENSITY ("FAR OUT" DETECTION)**

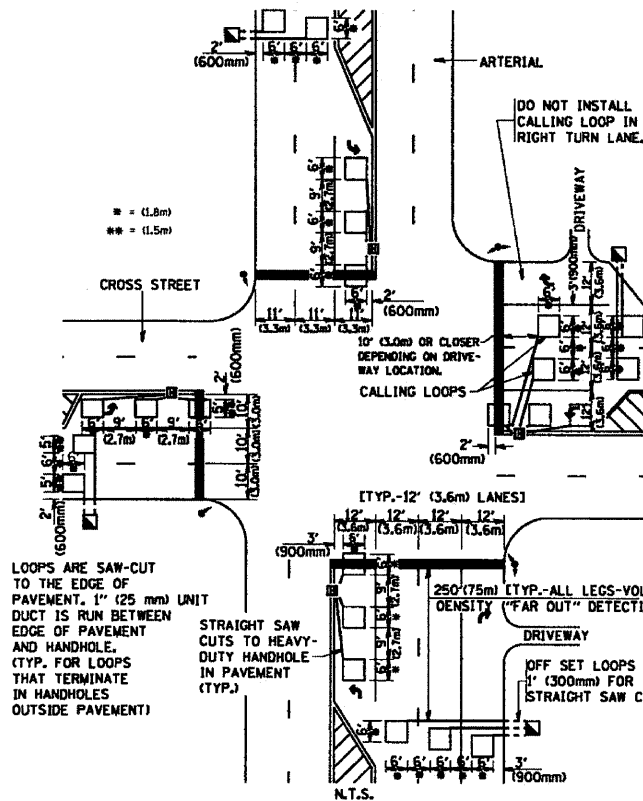

DETAIL 1
N.T.S.

**ARTERIAL-VOLUME DENSITY ("FAR OUT" DETECTION)
CROSS STREET-NON VOLUME DENSITY ("UPTIGHT" PRESENCE DETECTION)**

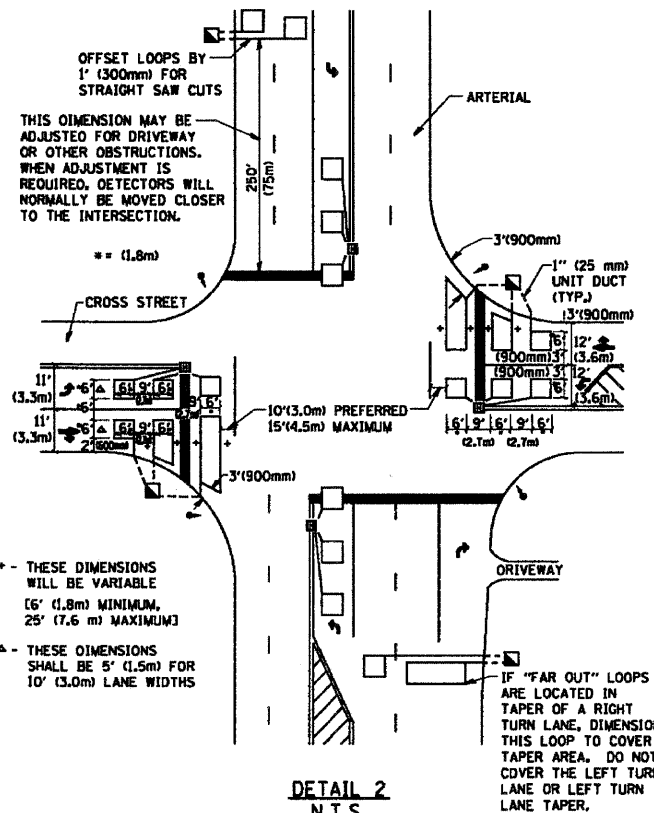

DETAIL 2
N.T.S.

NOTES:

VEHICLES LOOP DETECTORS

- ALL LEAD IN CABLE SHALL BE TWO CONDUCTOR NO. 14 TWISTED, SHIELDED.
- EACH DETECTOR LOOP SHALL HAVE ITS OWN SAW CUT FROM THE LOOP TO THE EDGE OF PAVEMENT OR TO A HANDHOLE IN THE PAVEMENT.
- EACH DETECTOR LOOP SHALL HAVE ITS OWN ONE INCH (25 mm) UNIT DUCT BETWEEN THE EDGE OF PAVEMENT AND THE FIRST HANDHOLE OR JUNCTION BOX. EACH UNIT DUCT RUN SHALL BE SHOWN ON THE PLANS BY THE DESIGNER, BUT SHALL NOT BE PAID FOR SEPARATELY. THIS ITEM IS INCIDENTAL TO THE PAY ITEM FOR DETECTOR LOOPS.
- ONE DIMENSION OF ALL DETECTOR LOOPS SHALL BE SIX FEET (1.8 m)
- EACH LANE OF NON-LOCKING, PRESENCE DETECTION AND EACH LANE OF A DOUBLE LEFT TURN LANE REQUIRES A SEPARATE INDUCTIVE LOOP DETECTOR AND LEAD IN CABLE.
- WHEN NON-LOCKING, PRESENCE DETECTION IS USED, MORE THAN ONE LOOP PER LANE IS REQUIRED BEHIND THE STOP BAR (i.e. 1-1/2, 1-3/4, 2).
- WHEN SYSTEM LOOPS ARE REQUIRED ON AN APPROACH OF AN INTERSECTION, THE LOOPS USED FOR VOLUME DENSITY AND INTERSECTION TIMING SHALL ALSO BE USED AS SYSTEM DETECTORS. EACH ONE OF THESE TYPE OF LOOPS REQUIRES A SEPARATE TWO CONDUCTOR NO. 14 TWISTED SHIELDED CABLE AND A SEPARATE INDUCTIVE LOOP DETECTOR WHEN NEW CONTROLLERS ARE UTILIZED. THE DESIGNER SHALL LABEL THESE TYPES OF LOOPS AS "INTERSECTION AND SAMPLING (SYSTEM) DETECTORS" ON THE SIGNAL LAYOUT, THE INTERCONNECT PLAN AND THE SYSTEM CABLE PLAN. WHEN AN EXISTING CONTROLLER IS UTILIZED FOR THIS TYPE OF DETECTION, THE PAY ITEM "INDUCTIVE LOOP DETECTOR WITH SYSTEM OUTPUT" SHOULD BE USED.

PLACEMENT OF DETECTORS

THE FOLLOWING FIGURES REPRESENT THE MOST COMMON DETECTOR LOOP LOCATIONS AND SIZES. ADJUSTMENTS WILL BE NECESSARY FOR SPECIFIC GEOMETRIC CONSIDERATIONS.

LOCATIONS AND DIMENSIONS OF DETECTOR LOOPS ARE REQUIRED ON ALL SIGNAL LAYOUT PLAN SHEETS.

"FAR OUT" DETECTION REFERS TO LOCKING, PRESENCE TYPE DETECTION LOCATED IN THRU LANES, RIGHT TURN LANES, AND RIGHT TURN LANE TAPER AREAS (IF APPLICABLE), USUALLY 250' (75 m) IN ADVANCE OF STOP BARS. "UPTIGHT" DETECTION REFERS TO NON-LOCKING PRESENCE TYPE DETECTION LOCATED IN ALL LANES AND 10'-15' (3.0 m-4.5 m) BEHIND THE CROSSING STREET'S EDGE OF PAVEMENT EXTENDED.

NOTE:

ALL DETAILS AND NOTES SHOWN ARE FROM THE I.D.O.T. DISTRICT 1 TRAFFIC SIGNAL DESIGN GUIDELINES DATED JANUARY 1995

THIS DRAWING HAS BEEN PREPARED TO ASSIST THE RESIDENT ENGINEER FOR ALL ROADWAY RESURFACING OR S.M.A.R.T. PROJECTS WHERE THE DIMENSIONS ARE NOT SHOWN ON THE PLANS AND THE FINAL LOCATIONS FOR CROSSWALKS OR STOP BARS ARE NOT DETERMINED.

FILE NAME = W:\distatd\22x34\ts07.dgn	USER NAME = goglianobt	DESIGNED -	REVISED -	STATE OF ILLINOIS DEPARTMENT OF TRANSPORTATION	DISTRICT 1 - DETECTOR LOOP INSTALLATION DETAILS FOR ROADWAY RESURFACING	F.A.P. R.T.L.	SECTION	COUNTY	TOTAL SHEETS	SHEET NO.
PLOT SCALE = 50.0000' / IN.	CHECKED - R.K.F.	REVISIONS	REVISIONS			351	(535 B-6R & 536) RS-4	WILL	35	35
PLOT DATE = 1/4/2008	DATE	REVISIONS	REVISIONS			TS-07		CONTRACT NO. 60H62		
						FED. ROAD DIST. NO. 1 (ILLINOIS) FED. AID PROJECT				