

BENCH MARK (BM #1)
SPIKE IN SOUTH FACE OF POWER POLE
AT STA. 664+54.75, 50' LEFT, ELEVATION=881.10



IL. RTE. 64

EXIST. R.O.W.
COLLAPSED RCP
EXISTING STORM SEWER
(3 CM 24" DIA PIPES)
TO BE REMOVED AND
REPLACED WITH 3 24" DIA
R.C.C. PIPES (SEE CROSS
SECTION SHEET FOR
ELEVATIONS AND OTHER
DETAILS)

EXISTING OPEN DITCH
PROPOSED FOR GRADING
& SHAPING, 15' ONLY
EITHER END OF STORM
SEWER.

NOTE:
FOR REGRADING & REPLACEMENT OF STORM SEWER &
PIPE CULVERT, MAINTAIN THE EXISTING ELEVATIONS
AS SHOWN ON THE CROSS SECTIONS.

SEEDING CLASS 2A
& EROSION CONTROL BLANKET

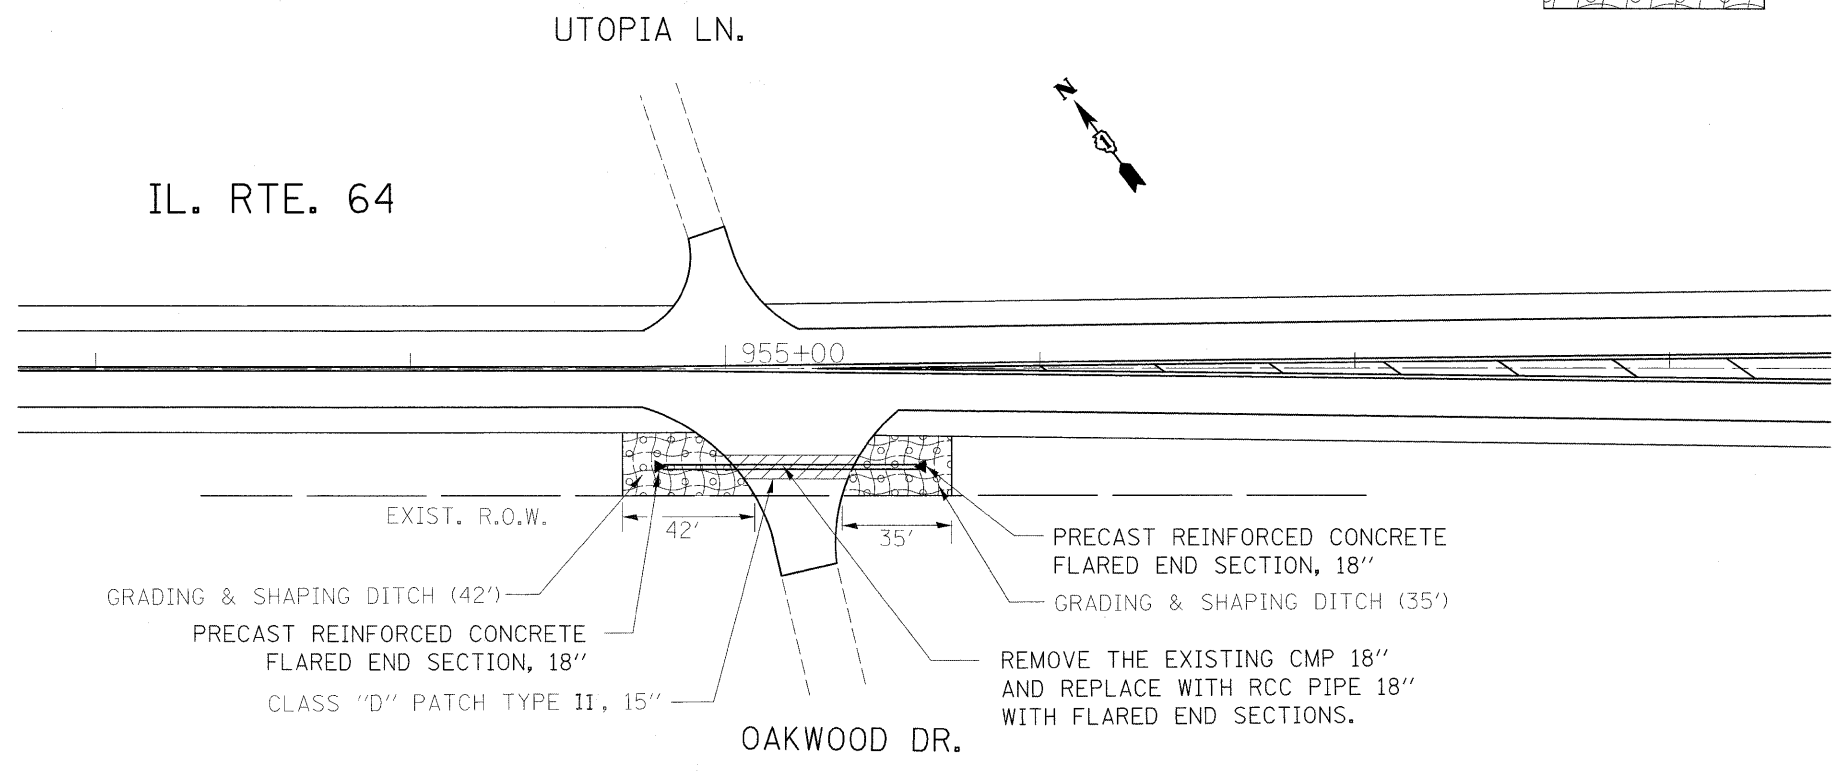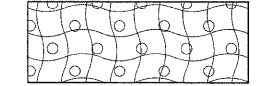

IL. RTE. 64

UTOPIA LN.

955+00

EXIST. R.O.W.
GRADING & SHAPING DITCH (42')
PRECAST REINFORCED CONCRETE
FLARED END SECTION, 18"
CLASS "D" PATCH TYPE II, 15"
OAKWOOD DR.
PRECAST REINFORCED CONCRETE
FLARED END SECTION, 18"
GRADING & SHAPING DITCH (35')
REMOVE THE EXISTING CMP 18"
AND REPLACE WITH RCC PIPE 18"
WITH FLARED END SECTIONS.

FILE NAME =	USER NAME = leysa	DESIGNED -	REVISED -	STATE OF ILLINOIS DEPARTMENT OF TRANSPORTATION	IL. ROUTE 64 @ HANSEN ROAD & OAKWOOD DRIVE DRAINAGE REPAIRS & EROSION CONTROL PLAN	F.A.P. RTE.	SECTION	COUNTY	TOTAL SHEETS	SHEET NO.
ct:\pw_work\pmsdot\leysa\08152433\shd-pla.dgn	PLOT SCALE = 30.0000' / IN.	DRAWN -	REVISED -			307	126 RS-5	KANE	34	19
PLOT DATE = 12/16/2009	CHECKED -	REVISED -	CONTRACT NO. 60100			ILLINOIS FED. AID PROJECT				
	DATE -	REVISED -	SCALE: 1" = 30'			SHEET NO.	OF SHEETS	STA.	TO STA.	

Rev.