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- 22. CONSTRUCTION DETAILS 23. CONSTRUCTION DETAILS
- 24. CONSTRUCTION DETAILS



FULL SIZE PLANS HAVE BEEN PREPARED USING STANDARD ENGINEERING SCALES. REDUCED SIZED PLANS WILL NOT CONFORM TO STANDARD SCALES. IN MAKING MEASUREMENTS ON REDUCED PLANS, THE ABOVE SCALES MAY BE USED.

J.U.L.I.E.

JOINT UTILITY LOCATION INFORMATION FOR EXCAVATION 1-800-892-0123 OR 811



PROJECT MANAGER: LOU ARRIGONI

CONTRACT NO. 63360

## STATE OF ILLINOIS

## DEPARTMENT OF TRANSPORTATION

# PLANS FOR PROPOSED FEDERAL AID HIGHWAY LEHIGH AVENUE AND COMPASS ROAD

INTERSECTION OF COMPASS ROAD AND LEHIGH AVENUE AND INTERSECTION OF LEHIGH AVENUE AND WEST LAKE AVENUE **GLEN-METRA COMMUTER PARKING LOTS** 


> **SECTION:** PROJECT:

08-00169-00-PK

CMM-9003 (191)

**VILLAGE OF GLENVIEW PROJECT E 08-56 COOK COUNTY** 

JOB # C-91-248-09

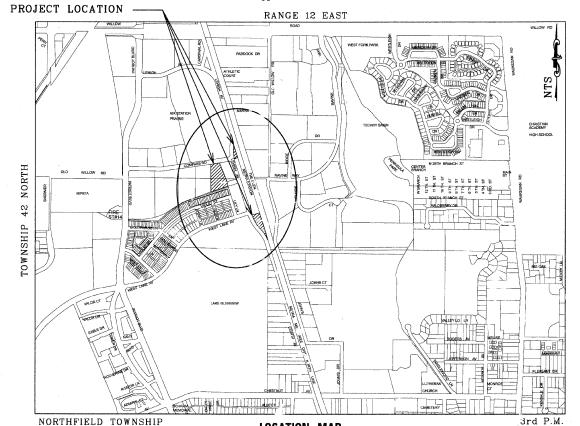

**LOCATION MAP 461 PARKING STALL ADDITION** 

OFF SITE BENCHMARKS

- 1. VILLAGE OF GLENVIEW GPS MONUMENT STATION NO. 14
- 2. VILLAGE OF GLENVIEW GPS MONUMENT STATION NO. 18 ELEV. = 631.10
- 3. VILLAGE OF GLENVIEW GPS MOUNUMENT STATION NO. 55 ELEV. = 636.38

NOTES:

SEE DETAIL SHEET NO. 21 FOR GPS MONUMENT SHEETS


VILLAGE OF GLENVIEW

PROJECT NUMBER F 08-56

SECTION COUNTY соок 08-00169-00-PK ILLINOIS CONTRACT NO. 63360

PLANS PREPARED BY:

LECATION OF SECTION INDICATED THUS: -

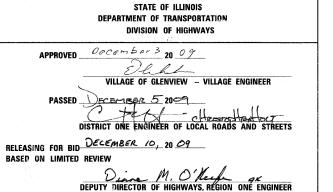

PRINTED BY THE AUTHORITY OF THE STATE OF ILLINOIS

C01 TITLE 08101.SHT 11/25/2009 2:48:23 PM

**ENGINEER: KEVIN** 

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**SSOCIATE** 

FIELD

# LEGEND (CONT.) EXISTING Control Points Right of Way Marker Property Corner/Iron Pipe B-1 SOIL BORING AND NUMBER LEGEND (CONT.) PAVEMENT REMOVAL SIDEWALK REMOVAL CURB AND GUTTER REMOVAL

Mail Box Tree Stump Evergreen Tree 0  $\odot$ Decidous Tree (0) (P) 0 Manhole Flared End Section 0 Catch Basin Water Mete Water Buffalo Box Valve Vault Fire Hydrant Watermain Reduce

Unknown B-Box

Utility Pedistal

Gas Buffalo Box

Double Hand Hole

Heavy Duty Hand Hole High Mast Light

Light Pole

Utility Control Box

Inlet pipe protection

Sanitary Sewer

Combined Sewe

Storm Sewer

WATERMAIN

Fence

Guardrail

Underground Fiber Optic Line

Cable Tv

Underground Electric line

CONTOUR

TREELINE / BUSH LINE

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OVERFLOW ROUTE 

STATE STANDARDS

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720011-01 METAL POSTS FOR SIGNS, MARKERS & DELINEATORS
729001-01 APPLICATIONS OF TYPES A & B METAL POSTS (FOR SIGNS & MARKERS
701606-06 URBAN LANE CLOSURE, MULTILAND, 2W WITH MOUNTABLE MEDIAN
424001-05 CURB RAMPS FOR SIDEWALKS

PROP. PARKING LOT PAVEMENT

PROP. SIDEWALK

PROPOSED RESTORATION AREAS

STABILIZED CONSTRUCTION ENTRANCE

PROP. HANDICAP RAMP

PROP. SPOT GRADES

DRAINAGE ROUTE FLOW ARROW

PARKING AISLE STALL TOTAL

LIGHTING IMPROVMENT SCHEDULE CALL OUT

STORM SEWER IMPROVEMEN SCHEDULE CALL OUT

> SIGNAGE IMPROVEMENT SCHEDULE CALL OUT

## **ABBREVIATIONS**

HIGH POINT FIRE HYDRANT INVERT ELEVATION APPROX APPROXIMATE BACK OF CURB BOTTOM OF PIPE BACK TO BACK LINER FOOT BENCHMARK LOW POINT CULVERT END. SECTION CORRUGATED METAL PIPE MANHOLE CENTER LINE NOT IN CONTRACT CONCRETE NORMAL WATER ELEVATION CULVERT DUCTIL IRON POLY VINYL CHLORIDE PROPERTY LINE PROP EDGE OF CONCRETE BADIUS OR RIM REINFORCED CONCRETE PIPE EDGE OF PAVEMENT B.O.W. RIGHT OF WAY EDGE TO EDGE RAILROAD ELEV. OR EL. EASEMENT SQUARE FEET SQUARE YARD F.E.S. FLARED END SECTION SIDEWALK FINISHED FLOOR ELEVATION FACE TO FACE STATION TOP OF FOUNDATION ELEVATION HIGH DENSITY POLYETHLENE PIPE HIGH WATER ELEVATION TRANSMISSION TOWER BASE VITRIFIED CLAY PIPE TO BE DETERMINED CURB REMOVAL LIMITS

GENERAL NOTES

- THE COST OF ABIDING BY THE PROVISIONS OF PERMITS ISSUED BY VARIOUS AGENCIES WILL BE CONSIDERED INCIDENTAL TO THE CONTRACT. ALLASSOCIATED BONDING REQUIREMENTS AND COSTS ARE INCIDENTAL TO THE CONTRACT.
- 2. ALL EXCESS EXCAVATED MATERIAL WILL BE DISPOSED OF OFF-SITE BY THE CONTRACTOR IN A LEGAL MATTER.
- 3. THE CONTRACTOR WILL PRESERVE AND PROTECT PROPERTY MARKERS, SECTION CORNERS, SURVEY MARKS AND BENCHMARKS SUCH AS STONES, PIPES OR DIHER MONUMENTS ENCOUNTERED. IF THE CONTRACTOR MUST RELOCATE THE PROPERTY MARKERS OR MONUMENTS, THEIR LOCATION SHALL BE REFERENCED BY AN ILLINOIS PROFESSIONAL LAND SURVEYOR AND THE OWNER NOTIFIED BEFORE MOVING. ALL PROPERTY MARKERS AND MONUMENTS RELOCATED DURING CONSTRUCTION SHALL BE RE-ESTABLISHED BY AN ILLINOS PROFESSIONAL LAND SURVEYOR AT THE CONTRACTOR'S EXPENSE.
- 4. OMIT
- ALL OPEN EXCAVATIONS SHALL BE BARRICADED AND POSTED WITH WARNING LIGHTS DURING WORKING HOURS. OPEN EXCAVATIONS ARE NOT PERMISSABLE DURING NON-WORKING HOURS OR AFTER EACH WORK DAY HAS BEEN COMPLETED.
- . ALL DIMENSIONS REFER TO BACK OF CURB: CENTERLINE OF MANHOLE, PIPE OR STRUCTURE, OR AS INDICATED,
- ALL APPLICABLE PROVISIONS OF THE CURRENT OCCUPATIONAL SAFETY AND HEALTH ACT ARE HEREIN
- 8. THE CONTRACTOR WILL SUBSCRIBE TO ALL GOVERNING REGULATIONS AND SHALL OBTAIN ALL NECESSARY PUBLIC AGENCY PERMITS.
- THE CONTRACTOR IS SOLELY AND COMPLETEY RESPONSIBLE FOR JOB SITE CONDITIONS DURING THE COURSE OF CONSTRUCTION OF THIS PROJECT. INCLUDING THE SAFETY OF ALL PERSONS AND PROPERTY. THIS REQUIREMENT SHALL APPLY CONTINUOUSLY AND NOT BE LIMITED TO NORMAL WORKING HOURS. THE CONTRACTOR SHALL DEFEND. INDEMNIFY. AND HOLD THE VILLAGE OF CLENVIEW AND POSTL-YORE AND ASSOCIATES INC. AND EMPLOYEES, PRESENT. PAST. AND FUTURE. HARMLESS FROM LIABILITY. READ ALLEGED. IN CONNECTION WITH THE LIABILITY ARISING FROM THE SOLE NEGLIGENCE OF THE ABOVE NAMED ENTITIES.
- 10. THE CONTRACTOR SHALL PROVIDE FOR THE SAFE AND ORDERLY PASSAGE OF TRAFFIC AND PEDESTRIANS WHERE HE OPERATES IN AND ABOUT PUBLIC THOROUGHFARES AND ADJACENT PROPERTY. THE CONTRACTOR IS RESPONSIBLE FOR ALL CONSTRUCTION TRAFFIC CONTROL. THE ILLINOIS DEPARTMENT OF TRANSPORTATION STANDARD DETAILS AND NOTES FOR TRAFFIC CONTROL SHALL APPLY.
- ALL CONSTRUCTION SHALL BE DONE IN ACCORDANCE WITH THE DETAILS IN THE PLANS. THE SPECIAL PROVISIONS INCLUDED IN THE CONTRACT DOCUMENTS AND THE LATEST EDITION OF THE FOLLOWING ILLINOIS SPECIFICATIONS: "THE STANDARD SPECIFICATIONS FOR ROAD AND BRIDGE CONSTRUCTION".
- 12. PRIOR TO COMMENCEMENT OF CONSTRUCTION THE CONTRACTOR SHALL VERIFY ALL DIMENSIONS AND CONDITIONS AFFECTING THEIR WORK WITH THE ACTUAL CONDITIONS AT THE JOBSITE. IN ADDITION. THE CONTRACTOR MUST VERIFY THE ENGINEER'S LINE AND GRADE STAKES. IF THERE ARE ANY DISCREPENCIES FROM WHAT IS SHOWN ON THE CONSTRUCTION PLANS. HE MUST IMMEDIATELY REPORT SAME TO THE ENGINEER BEFORE DOING ANY WORK: OTHERWISE THE CONTRACTOR ASSUMES FULL RESPONSIBILTY. IN THE EVENT OF DISAGREEMENT BETWEEN THE CONSTRUCTION PLANS. SPECIAL PROVISIONS, STANDARD SPECIFICATIONS AND/ORD ETAILS. THE CONTRACTOR SHALL SECURE WRITTEN INSTRUCTIONS FROM THE ENGINEER PRIOR TO PROCEEDING WITH ANY PART OF WORK AFFECTED OMISSION OR DISCREPENCIES. FAILING TO SECURE SUCH INSTRUCTIONS. THE CONTRACTOR WILL BE CONSIDERED TO HAVE PROCEEDED AT HIS OWN RISK AND EXPENSE. IN THE EVENT OF ANY DOUBT OR QUESTION ARISING WITH RESPECT TO THE MEANING OF THE CONSTRUCTION PLANS AND/OR SPECIFICATIONS, THE DECISION OF THE ENGINEER SHALL BE FINAL AND CONCLUSIVE.
- IT IS THE CONTRACTOR'S RESPONSIBILITY TO ASCERTAIN EXISTING FIELD CONDITIONS PRIOR TO BIDDIN ON THE PROJECT.
- 14. BEFORE STARTING ANY EXCAVATION. THE CONTRACTOR SHALL CALL "JULIE" (JOINT UTILTY LOCATION INFORMATION FOR EXCAVATION) AT 8-1-1 OR (800) 892-0123 ( 48 HOUR NOTIFICATION REQUIRED).
- 15. THE CONTRACTOR WILL NOT BE ALLOWED TO SET UP A YARD OR FIELD OFFICE ON STATE OR VILLAGE PROPERTY WITHOUT THE WRITTEN PERMISSION OF THE DEPARTMENT OR VILLAGE.
- 16. EXISTING PAVEMENT AND DRIVEWAY PAVEMENT TO REMAIN IN PLACE SHALL BE SAW CUT FULL DEPTH TO PROVIDE A NEAT VERTICAL FACE BETWEEN THE PROPOSED AND EXISTING AND WILL BE CONSIDERED INCIDENTAL TO THE CONTRACT.
- 17. IT WILL BE THE CONTRACTOR'S RESPONSIBILTY TO NOTIFY METRA AND THE VILLAGE OF GLENVIEW WHEN ACCESS TO THE METRA STATION ENTRANCES WILL BE TEMPORARILY CLOSED DUE TO CONSTRUCTION ACTIVITY. EVERY EFFORT SHALL BE MADE TO ACCOMMODATE ACCESS TO THESE PROPERTIES.
- 18. THE CONTRACTOR WILL BE REQUIRED TO TEMPORARILY RESET ALL SUCH SIGNS THAT INTERFERE WITH CONSTRUCTION OPERATIONS. ALL SUCH SIGNS MUST BE MAINATAINED STRAIGHT AND CLEAN FOR THE DURATION OF THE TEMPORARY SETTING AND MUST BE ERECTED AT A TEMPORARY LOCATION IN A WORKMANLIKE MANNER AND BE VISIBLE TO THE TRAFFIC FOR WHICH IT IS INTENDED. THIS WORK WILL NOT BE PAID FOR SEPARATELY. BUT SHALL BE INCLUDED IN THE UNIT BID PRICES OF THE CONTRACT.

LIGHTING NOTES

- 1. THE CONTRACTOR PROPOSING TO PERFORM THE ELECTRICAL WORK SHALL VISIT THE JOB SITE AND FULLY INFORM HIMSELF OF ALL CONDITIONS AFFECTING THE WORK. OR COST THEREOF. AND EXAMINE THE DRAWINGS AND SPECIFICATIONS PRIOR TO SUBMITTING HIS BIO.
- ALL ELECTRICAL DRAWINGS ARE TO BE READ IN CONJUNCTION WITH THE PROJECT SPECIFICATIONS AND ALL OTHER DRAWINGS RELATED TO THE PERFORMANCE OF THE WORK.
- 3. THE CONTRACTOR RESPONSIBLE FOR THE EXECUTION OF THIS WORK SHALL BECOME THOROUGHLY FAMILIAR WITH THE PROJECT SPECIFICATIONS BEFORE COMMENCING THE WORK. THE PROJECT SPECIFICATIONS AND DRAWINGS FORM THE BASIS OF THIS CONTRACT REQUIREMENTS AND INCLUDE THE TYPE AND GRADE OF MATERIALS TO BE INSTALLED, EQUIPMENT TO BE FURNISHED. THE MANNER BY WHICH TO BE INSTALLED, AND WHERE TO BE LOCATED. IN THE EVENT OF A CONTLICT BETWEEN THE PROJECT SPECIFICATIONS AND DRAWINGS. SPECIFICATIONS GOVERN UNLESS THE ARCHITECT/ENGINEER DIRECTS OTHERWISE.
- THE ELECTRICAL CONTRACTOR SHALL CHECK CAREFULLY ALL CONSTRUCTION DRAWINGS AND SPECIFICATIONS THAT ARE PART OF THIS PROJECT TO INSURE THAT NO FIXTURE. DUTLET. ALARM STATION. OR CONTROL AND POWER WIRING IS OMNITION. HE SHALL CONSULT ALL TRADES FURNISHING EQUIPMENT AND OBTAIN FROM THEM ALL DATA. IN SOME CASES, EQUIPMENT FIXTURES, AND DEVICES ARE SHOWN ONLY. ASCERTAIN AND PROVIDE THE WIRING AND CONTROL STATIONS REQUIRED FOR THE PROPER FUNCTION OF BUILDING EQUIPMENT. NO EXTRA CHARGES SHALL BE ACCEPTED BY THE OWNER BIDDING FOR SUCH EQUIPMENT AND LABOR.
- 5. EQUIPMENT LABELS AND INSTRUCTIONS REGARDING THE APPLICATION AND INSTALLATION OF THE LISTED EQUIPMENT SHALL BE FOLLOWED TO INSURE THAT THE EQUIPMENT IS BEING INSTALLED IN ACCORDANCE WITH THE MANUFACTURER'S LISTING INSTRUCTIONS. THE TEMPERATURE RAINO OF THE EQUIPMENT TERMINATIONS MUST BE CAREFULLY CORRELATED WITH THE CONDUCTOR AMPACITY TO PREVENT OVERHEATING AND PREMATURE FAILURE.
- 6. ALL WORK IS TO BE DONE IN ACCORDANCE WITH THE LATEST REQUIREMENTS OF THE APPLICABLE CODES AND REGULATIONS.
- ALL LIGHTING FIXTURES ARE TO BE LOCATED AS REQUIRED ON THE JOB TO CLEAR PIPING, EQUIPMENT, AND/OR MECHANICAL UNITS.
- 8. FURNISH AND INSTALL EQUIPMENT LOCAL DISCONNECT SWITCHES IN STRICT COMPLIANCE WITH CODE REQUIREMENTS.
- 9. ALL OUTDOOR RECEPTACLES SHALL BE "W.P." AND "GF1" TYPE.
- 10. ALL OUTDOOR ENCLOSURES SHALL BE NEMA 3R CORROSION RESISTANT AND GASKETED.
- 11. ALL AC POWER WIRING SHALL BE #6 CONDUCTORS IN  $1^1/4^{\prime\prime}$  CONDUIT MINIMUM. UNLESS NOTED OTHERWISE. PROVIDE ALL WIRING AS REQUIRED SO NO OUTLET FIXTURE OR SYSTEM IS LEFT INCOMPLETE.
- 12. ALL CONDUITS SHALL RUN CONCEALED. EXCEPT IN THE EQP'T RMS.
- 13. CONDUIT IS MINIMUM SCH. 40 UNDER GRASS, SCH 80 UNDER PAVEMENT, AND RGD GALVANIZED STEEL ABOVE
- 14. BOLT SPACES FOR LIGHT POLES IN THE CONCRETE FOUNDATIONS SHALL BE PER MANUFACTURER'S SPECIFICATIONS. SUBMIT SHOP DRAWINGS FOR REVIEW.

SOIL EROSION CONTROL NOTES

- ALL SEDIMENT SHALL BE PREVENTED FROM ENTERING ANY EXISTING STORM DRAINAGE SYSTEM OR WATERWAYS IN ACCORDANCE WITH THE EROSION CONTROL MEASURES INDICATED ON THE DRAWINGS AND PROJECT SPECIFICATIONS. THE CONTRACTOR IS RESPONSIBLE FOR DUST AND MUD CONTROL DUE TO THE INSTALLATION OF THE NEW WORK. REASONABLE CLEANLINESS SHALL BE MAINTAINED DURING THE WORK DAY. THE CONTRACTOR SHALL CLEAN STREETS, WITHOUT DELAY, AT THE DIRECTION OF THE ENGINEER. AT THE END OF EACH DAY THE CONTRACTOR SHALL CLEAN UP ALL MUD OR SOIL WHICH HAS BEEN TRACKED ONTO PUBLIC STREETS. OR AS REQUIRED BY THE AUTHORITIES HAVING JURISDICTION OVER THE PROJECT. NO ADDITIONAL COMPENSATION WILL BE PROVIDED FOR DAILY SOIL AND MUD REMOVAL.
- 2. ANY LODSE MATERIAL DEPOSITED IN THE FLOW LINE OF DRAINAGE STRUCTURES, WHICH OBSTRUCTS THE NATURAL FLOW OF WATER MUST BE REMOVED AT THE CLOSE OF EACH WORKING DAY. PRIOR TO THE ACCEPTANCE OF THIS IMPROVEMENT, ALL DRAINAGE STRUCTURES SHALL BE FREE OF DIRT AND DEBBIS. THIS WORK WILL NOT BY PAID FOR SEPARATLEY, BUT SHALL BE CONSIDERED AS INCLUDED IN THE UNIT BID PRICES OF THE CONTRACT.
- 3. PRIOR TO COMMENCEMENT OF ANY CONSTRUCTION OPERATION. A SIX (6) FOOT HIGH CHAIN LINK FENCE WITH A LOCKED GATE. INSTALLED PURSUANT TO THE VILLAGE ORDINANCENO. 4192. SHALL BE ERECTED AROUND THE ENTIRE AREA OF CONSTRUCTION. TOGETHER WITH APPLICABLE SOIL EROSION CONTROL MEASURES AS SHOWN ON THE SOIL EROSION CONTROL PLANS.
- THE CONTRACTOR WILL BE RESPONSIBLE FOR REMOVING SEDIMENT RESULTING FROM THIS PROJECT FROM ALL SEWERS, CULVERTS, AND DRAINAGE DITCHES.
- . ALL REQUIRED SILT FENCING AND INLET PIPE PROTECTION SHALL BE IN PLACE PRIOR TO DISTURBANCE OF ANY SOILS.
- . NO DISTURBANCE SHALL BE ALLOWED OUTSIDE THE LIMITS OF CONSTRUCTION.
- 7. DISTURBED AREAS THAT ARE TO BE RESTORED TO A VECETATED CONDITION SHALL RECIEVE A MINIMUM OF 4 INCHES OF TOP SOIL. THE SURFACE OF THE SPREAD TOPSOIL SHALL BE FREE OF ROCKS AND STONES LARGER THAN  $^{1}\!_{2}$  INCH DIAMETER.
- DISTURBED AREAS ARE TO BE RE-SODDED IN NO INSTANCE SHALL ERODABLE/BARE AREAS BE ALLOWED TO AND WITHOUT VEGETATION OR MULCH FOR A PERIOD OF MORE THAN 14 DAYS.
- 9. THE ENGINEER WILL INSPECT THE SODDED AREAS 60 DAYS AFTER SODDING. TO RECIEVE FINAL ACCEPTANCE, AREAS NOT ESTABLISHED, IN THE OPINION OF THE ROKINEER SHALL BE RE-SODDED. RE-INSPECTION SHALL OCCUR AFTER 30 DAYS. ACCEPTANCE CRITERIA WILL REMAIN THE SAME. ALL WATERING AND RE-SODDED UNTIL FINAL ACCEPTANCE IS THE RESPONSIBILITY OF THE CONTRACTOR.
- THE GRADING CONSTRUCTION OF THE SITE IMPROVEMENTS SHALL NOT CAUSE PONDING OF STORM WATER. ALL AREAS ADJACENT TO THE IMPROVEMENTS SHALL BE GRADED TO PROVIDE POSITIVE DRAINAGE.
- 11. INSTALL INLET AND PIPE PROTECTION AROUND ALL EXISTING AND PROPOSED STORM SEWER STRUCTURES THAT COLLECT SURFACE RUNOFF.
- 12. ALL EARTHWORK AND EROSION CONTROL WORK SHALL COMPLY WITH "ILLINOIS PROCEDURES AND STANDARDS PER URBAN SOIL AND SEDIMAENT CONTROL" AND THE VILLAGE OF GLENVIEW STANDARDS
- 13. SOIL DISTURBANCE SHALL BE MONITOR DAILY AND AFTER A RAIN EVENT OF 1.2" OR MORE OF EVIDENCE OF SILT INTRUSION AND OTHER ADVERSE ENVIRONMENTAL IMPACT WICH SHALL BE CORRECTED IMMEDIATELY UPON DISCOVERY OR PER DISCOVERY OF THE OFFICE OF THE CONTRACTOR. SEDIMENT DEPOSITS SHOULD BE REMOVED FROM SILT FENCING AFTER EACH RAINFALL. SILT DEPOSITS MUST BE REMOVED WHEN THE LEVEL OF DOPOSITION REACHES APPROXIMATELY ON HALF THE HEIGHT OF THE BARRIER.
- 14. SOIL EROSION AND SEDIMENT CONTROL FEATURES SHALL BE CONSTRUCTED PRIOR TO THE COMMENCEMENT OF UPLAND DISTURBANCE.
- 15. ANY CONSTRUCTION ACCESS DRIVES SHALL BE GRADED TO DRAIN INTO THE SITE. ALL MUD SHALL BE REMOVED FROM TIRES BEFORE LEAVING THE SITE AND ROADS SHALL BE KEPT CLEAR OF MUD AND DEBRIS AT ALL TIMES.
- 16. SILT FENCE LOCATIONS SHOWN ARE THE MILMUM PROTECTION REQUIREMENTS. THE CONTRACTOR IS REQUIRED TO INSTALL ADDITIONAL DEVICES AT HIS EXPENSE TO MINIMIZE EROSION. ADDITIONAL EROSION CONTROL DEVICES MAY BE REQUIRED AS DETERMINED BY THE ENGINEER.
- 17. THE CONSTRUCTION ENTRANCE SHALL BE MAINTAINED IN A CONDITION, WHICH WILL PREVENT TRACKING SEDIMENT ONTO PUBLIC RIGHT-OF-WAY OR ROADWAYS MUST BE REMOVED IMMEDIATELY.

UTILITIES NOTES

- THE CONTRACTOR SHALL BE RESPONSIBLE FOR THE PROTECTION OF ALL UNDERGROUND AND SURFACE UTILITIES
  EVEN IF THEY ARE NOT SHOWN ON THE PLANS. ANY UTILITY THAT IS DAMAGED DURING CONSTRUCTION SHALL
  BE REPAIRED OR REPLACED AT THE CONTRACTOR'S EXPENSE TO THE SATISFACTION OF THE ENGINEER OR
  VILLAGE.
- 2. THE CONTRACTOR SHALL BE RESPONSIBLE FOR CONTACTING THE OWNERS OF ALL UTILITIES PRIOR TO CONSTRUCTION TO DETERMINE THE LOCATION OF ALL UTILITY EQUIPMENT. THE CONTRACTOR SHALL COOPERATE WITH ALL UTILITY OWNERS IN ACCORDANCE WITH STANDARD SPECIFICATIONS. IF UTILITY RELOCATION, ADJUSTMENT, OR PROTECTION IS NECESSARY. THE VILLAGE OF GLENVIEW CANNOT BE HELD RESPONSIBLE AND CHARGED BY THE CONTRACTOR FOR ANY DELAYS.
- 3. THE LOCATION OF EXISTING DRAINAGE STRUCTURES AND ANY OTHER PUBLIC UTILITIES AS SHOWN ON THE PLANS IS APPROXIMATE AND THEIR EXACT LOCATION TO BE DETERMINED IN THE FIELD BY THE CONTRACTOR. THIS WORK SHALL BE CONSIDERED AS INCLUDED IN THE UNIT BID PRICES OF THE CONTRACT AND NO ADDITIONAL COMPENSATION WILL BE ALLOWED.
- THE CONTRACTOR SHALL USE ALL NECESSARY PRECAUTIONS AND PROTECTION MEASURES REQUIRED TO MAINTAIN EXISTING UTILITIES, SEWERS, AND APPURTENCES THAT MUST BE KEPT IN OPERATION.
- THE CONTRACTOR SHALL INSURE THAT ALL WATER SYSTEM VALVE, VALVE VALUES, AND SANITARY SEWER MANHOLES REMAIN READILY ACCESSABLE TO THE VILLAGE FOR EMERGENCY OPERATIONS. THE LOCATION OF ALL WATER AND SANITARY FACILITIES SHALL BE MARKED AND READILY VISIBLE AT ALL TIMES.
- 6. A CURRENT COLOR DVD RECORD AND TYPE-WRITTEN TRANSCRIPTION OF AN INTERNAL INSPECTION OF THE NEWLY CONSTRUCTED STORM SEWER SHALL BE SUBMITTED TO THE VILLAGE. ALL PUBLIC AND PRIVATE LINES SHALL BE RECORDED. THE CAMERA MUST BE CENTERED IN THE PIPE AND THE LENS OF THE CAMERA ROTATED TO VIEW ALL SERVICES. ALL SERVICE CONNECTIONS MUST BE NOTED IN THE TELEVISION REPORT. WHEN THE PROPOSED STORM SEWER SYSTEM IS TO CONNECT TO AN EXISTING STORM SEWER ABUTTING THE PROPERTY. THE EXISTING SEWER AS DIRECTED BY THE VEM MUST ALSO BE TELEVISED AND REPORTED. THE LEVISION GET THE EXISTING SYSTEM MUST BE CONDUCTED DURING THE ENGINEERING PLAN REVIEW STAGE AND THE DVD AND WRITTEN REPORT SUBMITTED AS PART OF THE REVIEW PROCESS. THE CONTRACTOR SHALL COORDINATE THE TELEVISING OF EXISTING CONTIGUOUS SEWERS WITH THE VEM AND PUBLIC WORKS DEPARTMENT.
- 7. STORM SEWER MANHOLES ARE TO BE PRECAST REINFORCED CONCRETE CONCENTRIC TYPE WITH A MINIMUM 48" 1.0. BARREL SECTION. THE CONTRACTOR SHALL USE RESTRICTED DEPTH DRAINAGE STRUCTURES (FLAT SLAB TOP) WHEN HEIGHT RESTRICTIONS REQUIRE A SHALLOW STRUCTURE. STEPS SHALL BE MADE OF STEEL REINFORCED PLASTIC USING APPROVED PLASTIC MEETING ASTM DAIOI. TYPE II. GRADE 4910B DVER A #3 GRADE 60. ASTM A615 REINFORCING BAR. A MAXIMUM OF 8" OF ADJUSTING RINGS SHALL BE USED.
- 8. MAIN LINE STORM SEWERS SHALL BE CONSTRUCTED OF ONE OF THE FOLLOWING:

  (A) PRECAST REINFORCED CONCRETE PIPE, IDDT CLASS IV WITH "O-RING" JOINTS (ASIM-C-361) AND RUBBER GASKETS. LIFTING HOLES SHALL NOT BE ALLOWED ON PIPES LESS THAN 84" IN DIAMETER.

  (B) PVC PIPE, RIGID. (MIN. SDR 26. PUSH-ON GASKET JOINTS).

  (C) DUCTILE IRON PIPE. (CLASS 52), MINIMUM, WITH RUBBER GASKETS.
- 9. ALL UTILITY AND SERVICE TRENCHES UNDER OR WITHIN THE ZONE OF INFLUENCE OF PAVED SURFACES SHALL BE BACKFILLED WITH CRUSHED CA-7 COARSE AGGREGATE UPON DIRECTION OF THE ENGINEER AND SHALL BE PROPERLY COMPACTED. UNLESS OTHERWISE DIRECTED BY THE VILLAGE BOINEERING DEPARTMENT. BACKFILL UNDER EXISTING PAVEMENTS WHERE AN OFEN CUT OF THE PAVEMENT HAS BEEN APPROVED. SHALL BE FLEXIBLE FILL WHICH MEETS THE IDDIT STANDARDS OF CONTROLLED LOW STRENGTH MATERIAL (CLSM) MIXTURE 1.
- 10. OMI
- 11. ALL ELEVATIONS ARE TOP OF CURB, UNLESS OTHERWISE NOTED.
- 12. ALL STORM STRUCTURES WITH PIPE ELEVATIONS OF 630.00 OR LOWER MUST HAVE BOOTED CONNECTIONS PER DETAILS ON SHEET NO. 20


PLANS PREPARED BY:	SURVEY	- DJG	DESIGNED -	DJG	REVISED	- 10/05/09 PER BLRS	WILLAGE OF CLERIVIEW		F.A. RTE.	SECTION	COUNTY	TOTAL SHEET SHEETS NO.
Postl-Yore and Associates, Inc	UTILITIES -	- JC	DRAWN ~	DJG	REVISED		VILLAGE OF GLENVIEW	GENERAL NOTES AND LEGENDS	NA	08-00169-00-PK	COOK	24 2
OSTI YOTO 20 IL GUICTO MONTO M	CHECKED	- DJG	CHECKED -	LVA	REVISED		PROJECT E 08-56			A STATE OF THE STA	CONTRAC	T NO. 63360
Will WANTED POPULATION THE BEAUTION	DATE	- 04-23-09	DATE -	09-17-09	REVISED	-	FNUJLUI L 00-30	SCALE: NONE SHEET NO. 2 OF 24 SHEETS		ILLINOIS FED. AI	PROJECT	


									CC	CTION TYPE ODE
SPECIALTY ITEMS	SPECIAL PAY	/ ITEM #	PAY ITEM	UNIT	SOUTH LOT QUANTITY	NORTH LOT QUANTITY	COMPASS LOT QUANTITY	TOTAL QUANTITY	ROADWAY 100-2A	LIGHTING Y030-1E
TIEMS	202		EARTH EXCAVATION	CU YD	1,202	1,073	4,687	6,962	6,962	2
			REMOVAL AND DISPOSAL OF UNSUITABLE MATERIAL	CU YD	121 121	108 108	469 469	698 698	698 698	
	207		POROUS GRANULAR EMABANKMENT, SUBGRADE TRENCH BACKFILL	CUYD	19	7	633	659	659	
	210	001000	GEOTECHNICAL FABRIC FOR GROUND STABILIZATION	SQ YD	265	288	1,329	1,882	1,882	2
0			SODDING, SALT TOLERANT (SPECIAL) TRANSPLANTED SALVAGED SHRUBS	SQ YD EACH	798 25	898 25	2,998 0	4,694 50	4,694 50	
			PERIMETER EROSION BARRIER	FOOT	833	779	1,818	3,430	3,430	
	280	000500	INLET AND PIPE PROTECTION	EACH	7	4	17	28	28	
		101400	RIPRAP FILTER FABRIC	SQ YD SQ YD	36 36	0	0 0	36 36	36 36	
			AGGREGATE BASE COURSE, TYPE B 4"	SQ YD	1,929	2,371	2,736	7,036	7,036	
			HOT-MIX ASPHALT BASE COURSE, 4"	SQ YD	1,929	2,371	2,736	7,036	7,036	
			BITUMINOUS MATERIALS (PRIME COAT) AGGREGATE (PRIME COAT)	GALLON TON	675 5	830	958 7	2,463 18	2,463 18	
			HOT-MIX ASPHALT BINDER COURSE, IL-19.0, N50	TON	270	332	384	986	986	
			HOT-MIX ASPHALT SURFACE COURSE, MIX "D", N50	TON-	163	200	230	593	593	
			PORTLAND CEMENT CONCRETE PAVEMENT 6" PORTLAND CEMENT CONCRETE SIDEWALK 5 INCH, SPECIAL	SQ YD SQ FT	0 551	0 228	45 3,025	45 3,804	45 3.804	
			COMBINATION CURB AND GUTTER REMOVAL	FOOT	373	77	133	583	583	3
			SIDEWALK REMOVAL	SQFT	596	0	451	1,047	1,047	
	740		PAVEMENT REMOVAL (SPECIAL) STORM SEWERS, CLASS A, TYPE 3, 12"	SQ YD	0	0	148	148	148	<b></b>
	550	ORO 640	O LOTHNO CAVELLO, CANADA	FOOT	0	. 0	197	197	197	<u> </u>
			GEOTECHNICAL FABRIC FOR FRENCH DRAINS	SQ YD	0	. 0	437	437	437	
			CATCH BASINS, TYPE A, 4' DIAMETER, WITH SPECIAL FRAME AND GRATE CATCH BASINS, TYPE C, WITH SPECIAL FRAME AND GRATE	EACH EACH	0	0	<u>4</u> 5	5	5	,
	* 602	2 <b>387</b> 00	INLETS, TYPE A, WITH SPECIAL FRAME AND GRATE	EACH	11	1	0	2	2	
			FRAMES AND LIDS TO BE ADJUSTED (SPECIAL) COMBINATION CONCRETE CURB AND GUTTER, TYPE B-6.12 (SPECIAL)	EACH FOOT	2 1,111	2 1,102	3 3,486	7 5,699	7 5,699	<del></del>
			TEMPORARY FENCE	FOOT	833	779	1,621	3,233	3,233	
	671	100100	MOBILIZATION	L SUM	0	0	0	1	1	
			TRAFFIC CONTROL AND PROTECTION, STANDARD 701606	L SUM SQ FT	0 31.75	0 6.25	0 6.25	1 44	1 44	<del> </del>
			SIGN PANEL - TYPE 1 REMOVE SIGN PANEL	EACH	1	0.25	0.23	1	1	<u> </u>
	729	900100	METAL POST - TYPE A	FOOT	36	33	174	243	243	
0			THERMOPLASTIC PAVEMENT MARKING - LINE 4"	FOOT	953	986	5,343	7,282	7,282 59	
0			THERMOPLASTIC PAVEMENT MARKING - LINE 6" THERMOPLASTIC PAVEMENT MARKING - LINE 24"	FOOT	59 27	16	0 12	59 55	55	
Ö	* 783	300405	THERMOPLASTIC PAVEMENT MARKING REMOVAL	FOOT	330	0	0	330	330	)
0			CONDUIT IN TRENCH, 1 1/4" DIA., GALVANIZED STEEL	FOOT	0	0	2,000	2,000		2,00
0			HANDHOLE LIGHT POLE FOUNDATION	EACH EACH	0	0	23 22	23 23	<del>                                     </del>	1
		002920	TREE, CELTIS OCCIDENTALIS (COMMON HACKBERRY), 2 1/2" CALIPER,	EACH	2	2	7	11		1
0	720	002920	BALLED AND BURLAPPED		-		<u> </u>	''	11	<del> </del>
0	A20	004616	TREE, GLEDITSIA TRIACANTHOS INERMIS (THORNLESS COMMON HONEYLOCUST), 2" CALIPER, BALLED AND BURLAPPED	EACH	1	1	3	5	5	i
	A20	005420	TREE, LIRIODENDRON TULIPIFERA (TULIP TREE), 2 1/2" CALIPER, BALLED	EACH	1	1	4	6		
_ ^	Act	003420	AND BURLAPPED	<del> </del>		1	·		6	<del> </del>
0	A20	006520	TREE, QUERCUS BICOLOR (SWAMP WHITE OAK), 2 1/2" CALIPER, BALLED AND BURLAPPED	EACH	2	2	13	17	17	4
0	A20	007120	TREE, QUERCUS RUBRA (RED OAK), 2 1/2" CALIPER, BALLED AND BURLAPPED	EACH	. 1	1	4	6		
. 0	A20	007620	TREE, TAXODIUM DISTICHUM (COMMON BALD CYPRESS), 2 1/2" CALIPER,	EACH	2	2	9	13	10	
		007000	BALLED AND BURLAPPED TREE, TILIA AMERICANA (AMERICAN LINDEN/ BASSWOOD), 2 1/2" CALIPER,	EACH	1	1	3	5	13	<del> </del>
0			BALLED AND BURLAPPED TREE, QUERCUS MACROCARPA (BURR OAK), CONTAINER GROWN,	<u> </u>					5	<b></b>
0	A20	C056G3	3 GALLON SHRUB, SYRINGA PATULA MISS KIM (MISS KIM MANCHURIAN LILAC), 30"	EACH	1	1	3	5	5	
0			HEIGHT, 5-GALLON CONTAINER	EACH	25	25	0	50	50	
0			REMOVAL OF POLE FOUNDATION, CONCRETE	SQ YD EACH	0	0	20	20	20	
			STABILIZED CONSTRUCTION ENTRANCE	SQ YD	251	134	167	552	552	1
	* X0;	322917	PROPOSED STORM SEWER CONNECTION TO EXISITNG MANHOLE	EACH	1	1	2	4	4	
0	7,00		EXISTING LIGHT POLE FOUNDATION ADJUSTMENT ELECTRICAL CABLE IN CONDUIT, TRIPLEX NO. 6, 2-1C AND NO. 8, 1-1C	FOOT	2	0	0 2,176	2,176		2,1
0			TOPSOIL FURNISH AND PLACE, 4" (SPECIAL)	SQ YD	798	898	2,955	4,651	4,651	2.,1
			HOT-MIX ASPHALT SURFACE REMOVAL - BUTT JOINT	SQ YD	342	54	89	485	485	
	* XX	001249	ORNAMENTÁL FENCE TREE ULMUS ACCOLADE (HYBRID ELM) 3" CALIPER, BALLED AND	FOOT	0	46	0	46	46	<del> </del>
٥			BURLAPPED	EACH	2	2	9	13	13	
			STORM SEWER, DUCTILE IRON PIPE, CLASS 5212"	FOOT	68	29	0	97	97	
<u> </u>			ELECTRICAL CONNECTION TO EXISTING LIGHTING SYSTEM DETECTABLE WARNINGS	EACH SQ FT	0	0	1 12	1 18	18	
	* Z00	048665	RAILROAD PROTECTIVE LIABILITY INSURANCE	LSUM	0	0	0	1	1	
0			AERIAL MOUNTED PARKING STALL NUMBER SIGNS	EACH	0	0	86	86	86	
	* XX00	08128 08129	AGGREGATE BASE COURSE, TYPE B, CA7, 6" AGGREGATE BASE COURSE, TYPE B, CA7, 8"	SQ YD SQ YD	0	0 0	4,442 3,958	4,442 3,958	4,442 3,958	
	* XX00	08330	BIOSWALE	SQ YD	Ö	Ö	1,386	1,386	1,386	
	* -		X				<u> </u>		<u> </u>	<del></del>
0	* XX00	1883	FARE COLLECTION MACHINE	EACH	0	0	2	2	2	
0	* XX00	8332	FARE COLLECTION MACHINE SHELTER GROUND MOUNTED PARKING STALL NUMBER SIGNS	L SUM EACH	0 32	0 33	1 105	1 170	1 170	
•	* XX00	08334	HANDICAP STALL RESTRIPING AND SIGNAGE	EACH	4	0	0	4	4	ļ.
	* 2800	00510	INLET FILTERS	EACH	7	4	17	28	28	
-	1 X X 00		PERVIOUS ASPHALT, 4" PERVIOUS CONCRETE, 6"	SQ YD SQ YD	0	0	3,958 4,442	3,958 4,442	3,958 4,442	
0	* XXXX	02065	LIGHTING UNIT COMPLETE	EACH	0	0	22	22		
			STORM SEWERS, SPECIAL 6"	FOOT	0	0	765	765	765	4


PLANS PREPARED BY:	SURVEY -	DJG	DESIGNED - DJG	REVISED ~ 10/05/09 PER BLRS
Postl-Yore and Associates, Inc.	UTILITIES -	- JC	DRAWN - DJG	REVISED
POSETY YORK TO A MANAGEMENT HOLD SUPER HOLD SUPER TO ANGEL TO ANGE	CHECKED -	DJG	CHECKED - LVA	REVISED
Will Walkform concern The Management	DATE -	04-23-09	DATE - 09-17-09	REVISED -


VILLAGE OF	<b>GLENVIEW</b>
PROJECT	E 08-56


SUMMARY OF QUANTITIES		SECTION	COUNTY	SHEETS	SHEET NO.
SUMMARY OF QUANTITIES	NA	08-00169-00-PK	COOK	24	3
			CONTRACT	NO. 6	3360
SCALE: NONE SHEET NO. 3 OF 24 SHEETS		ILLINOIS FED. AI	D PROJECT		

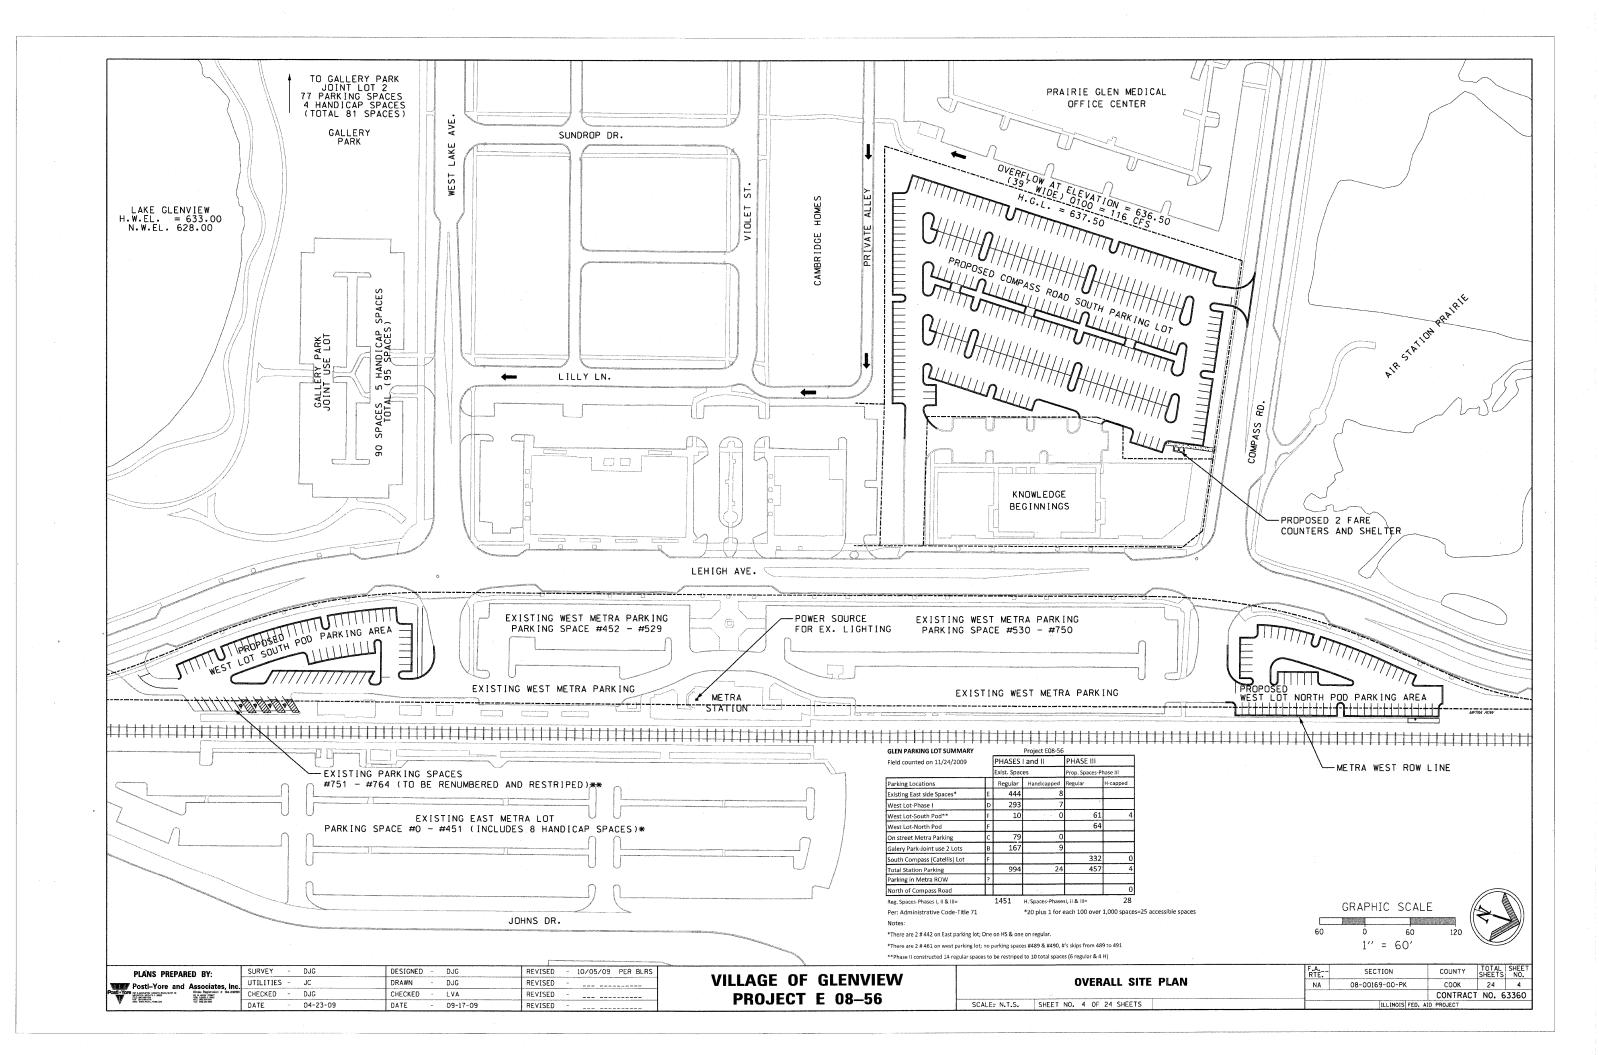


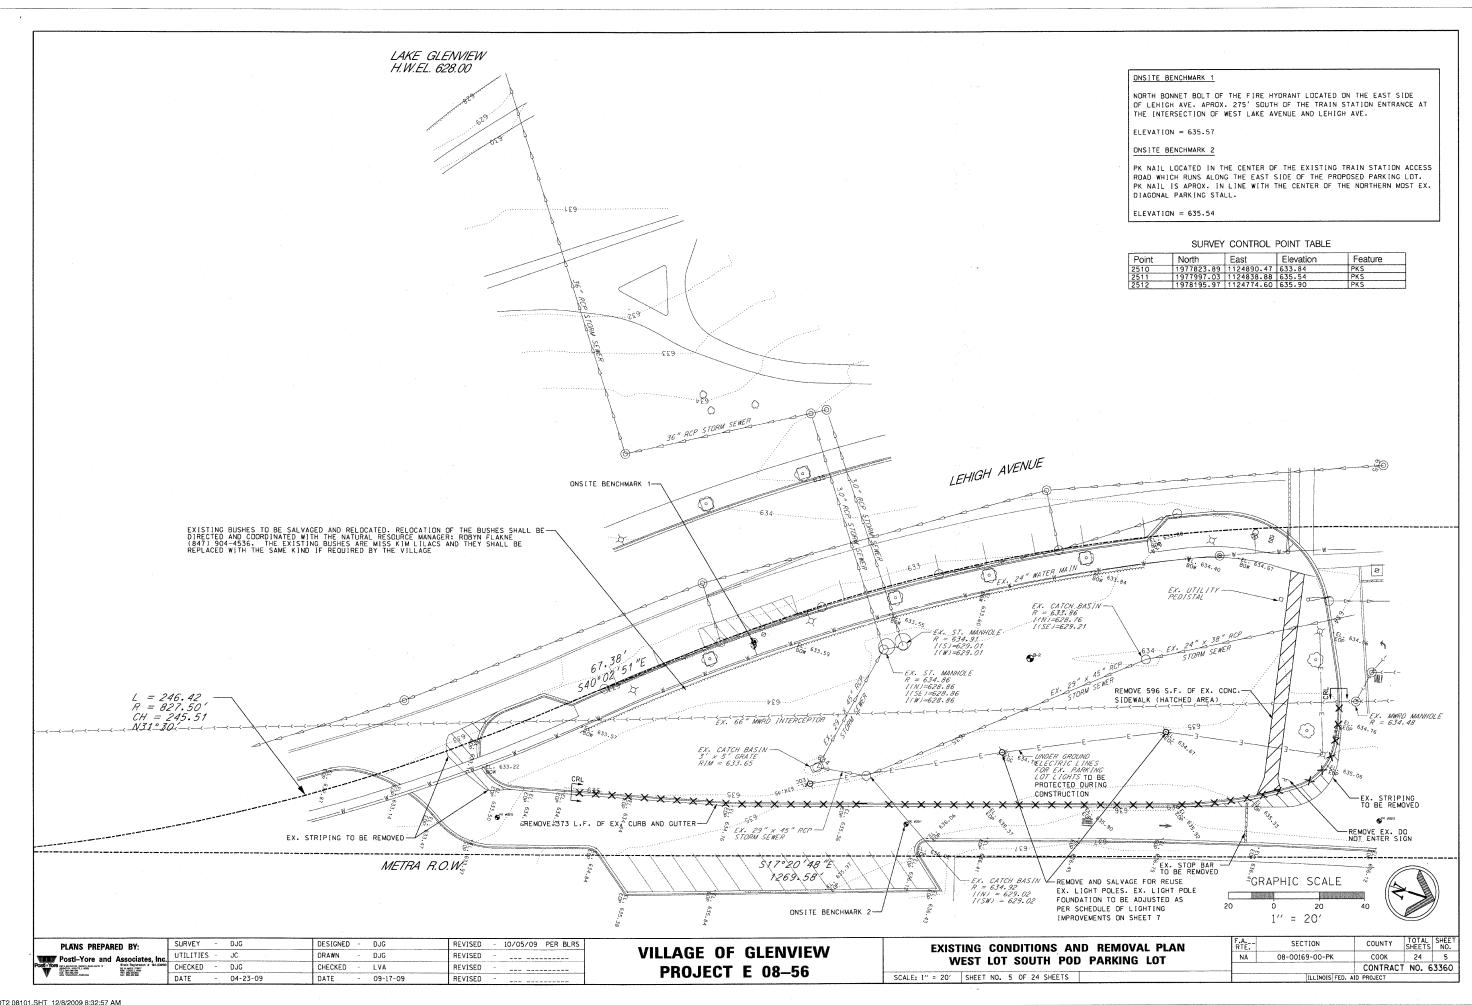

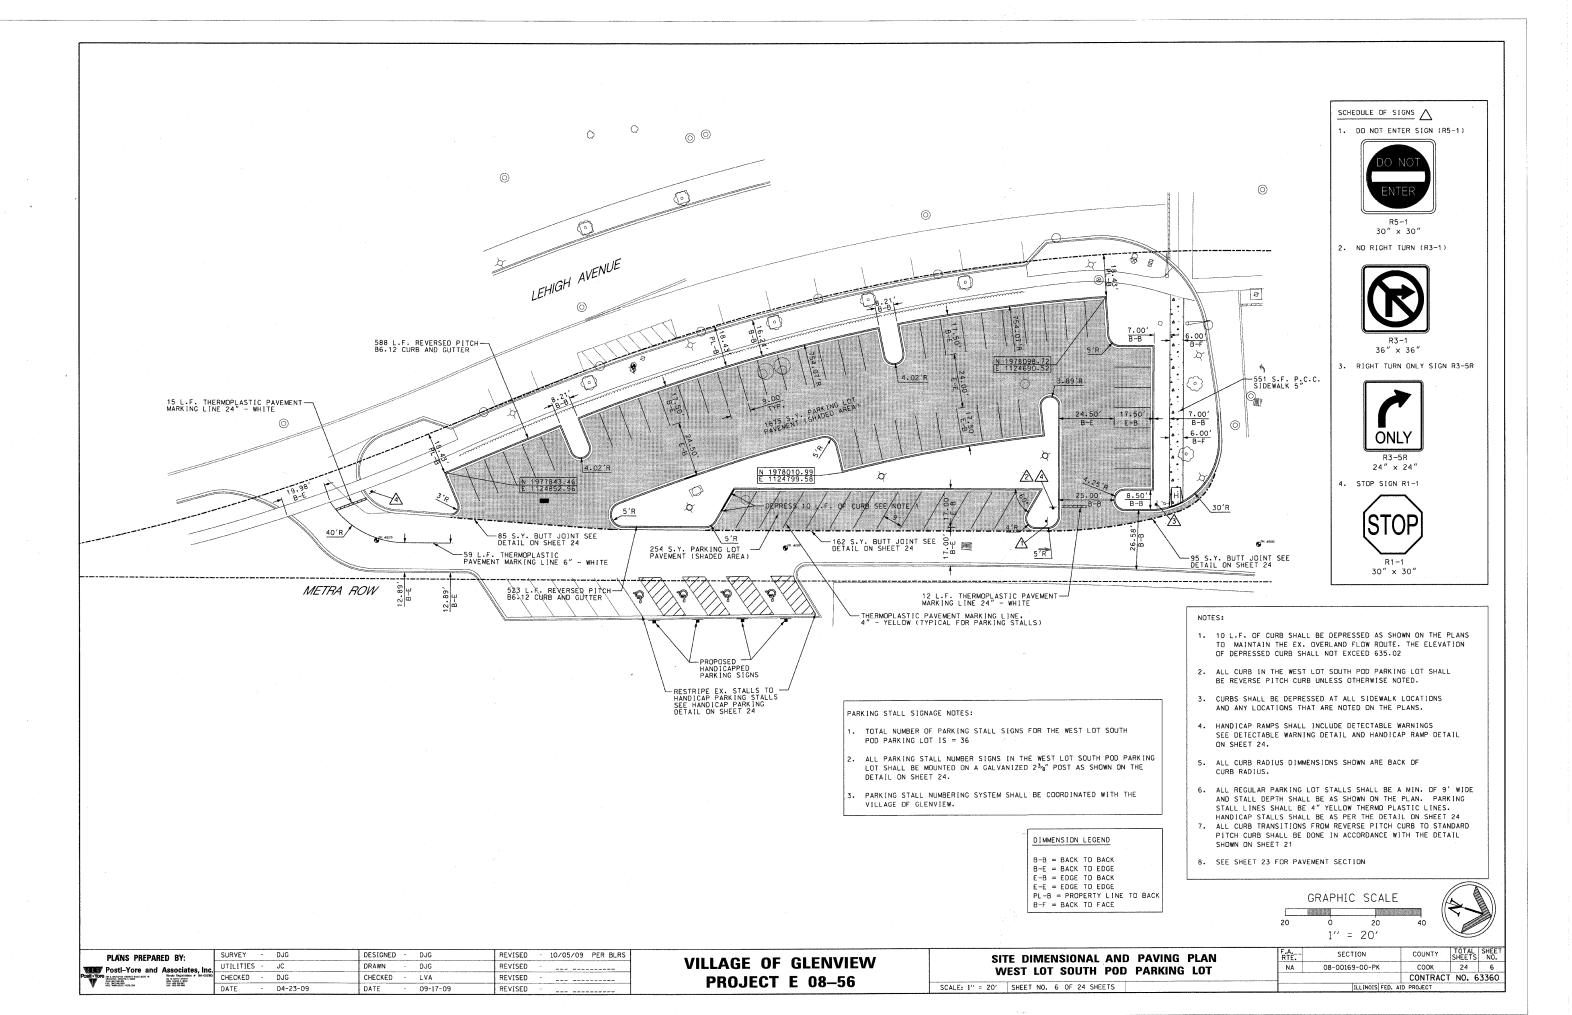

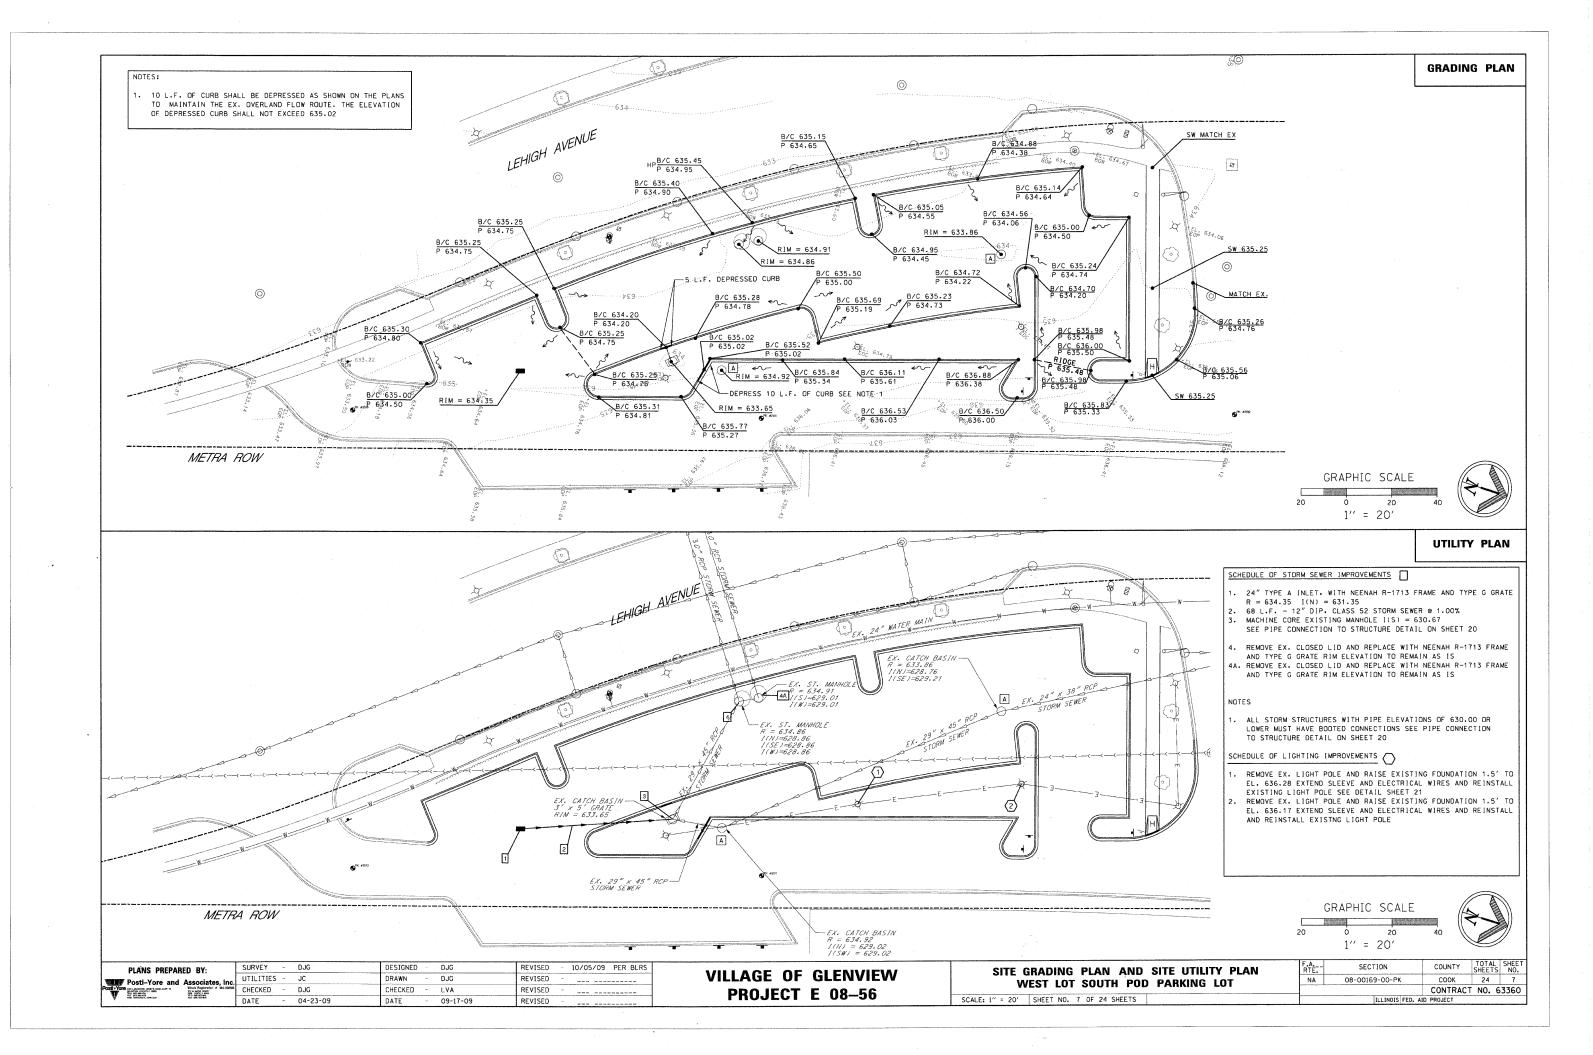

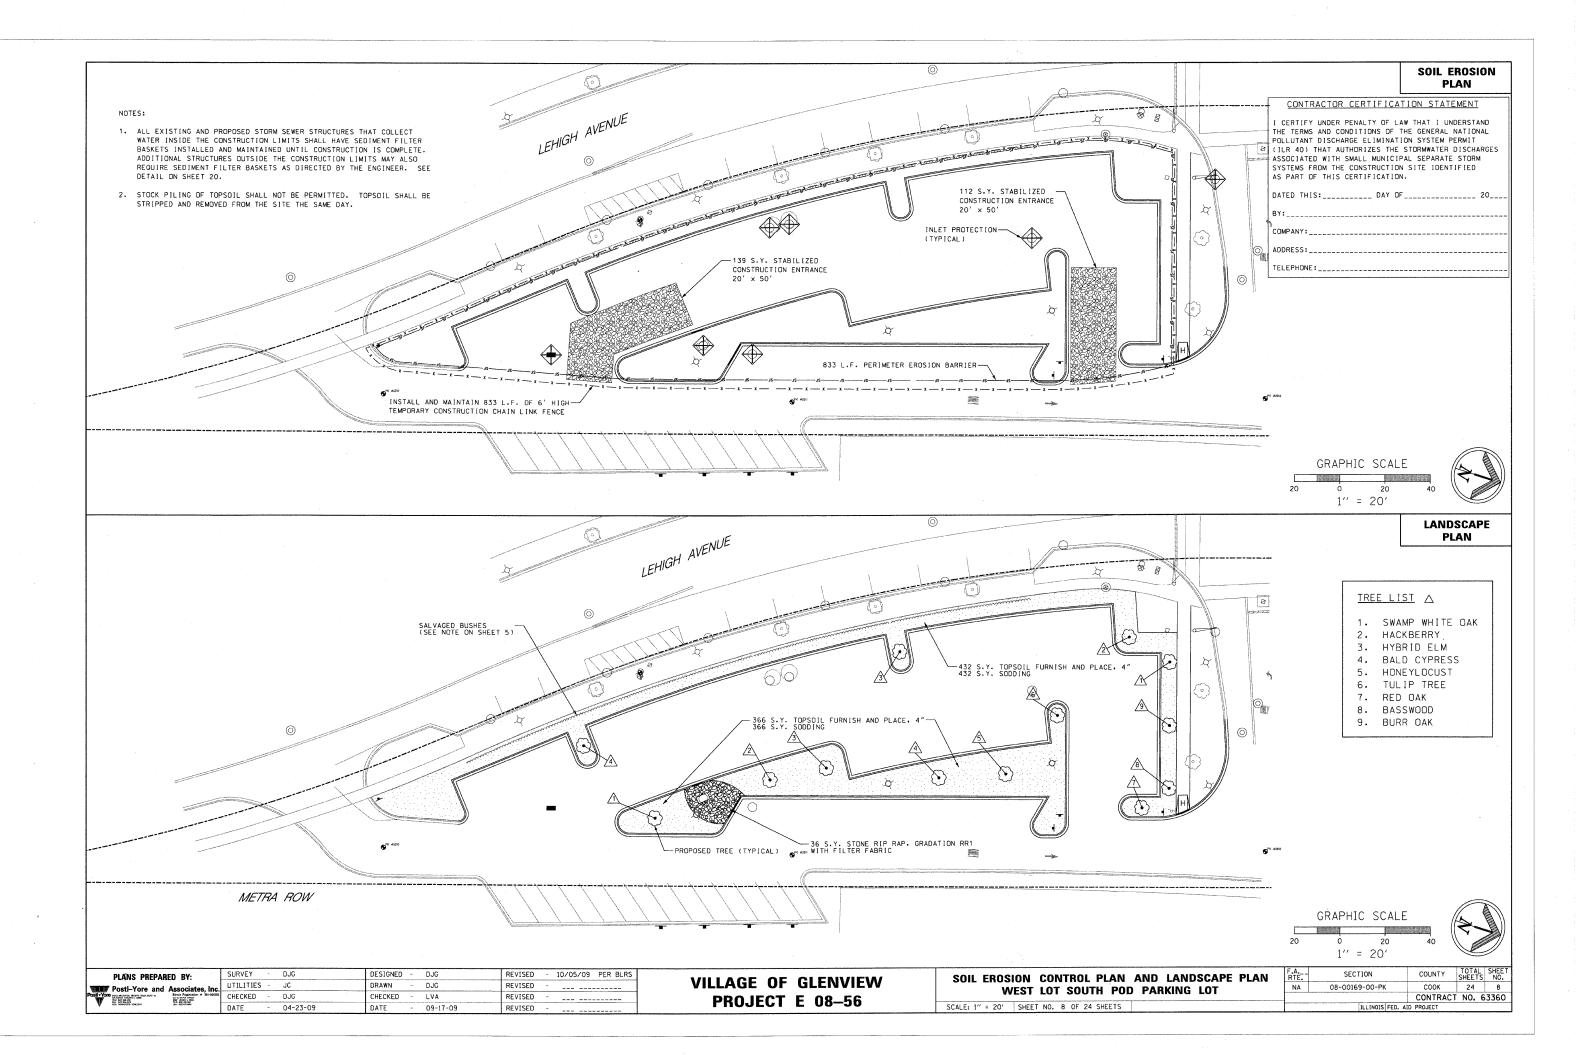

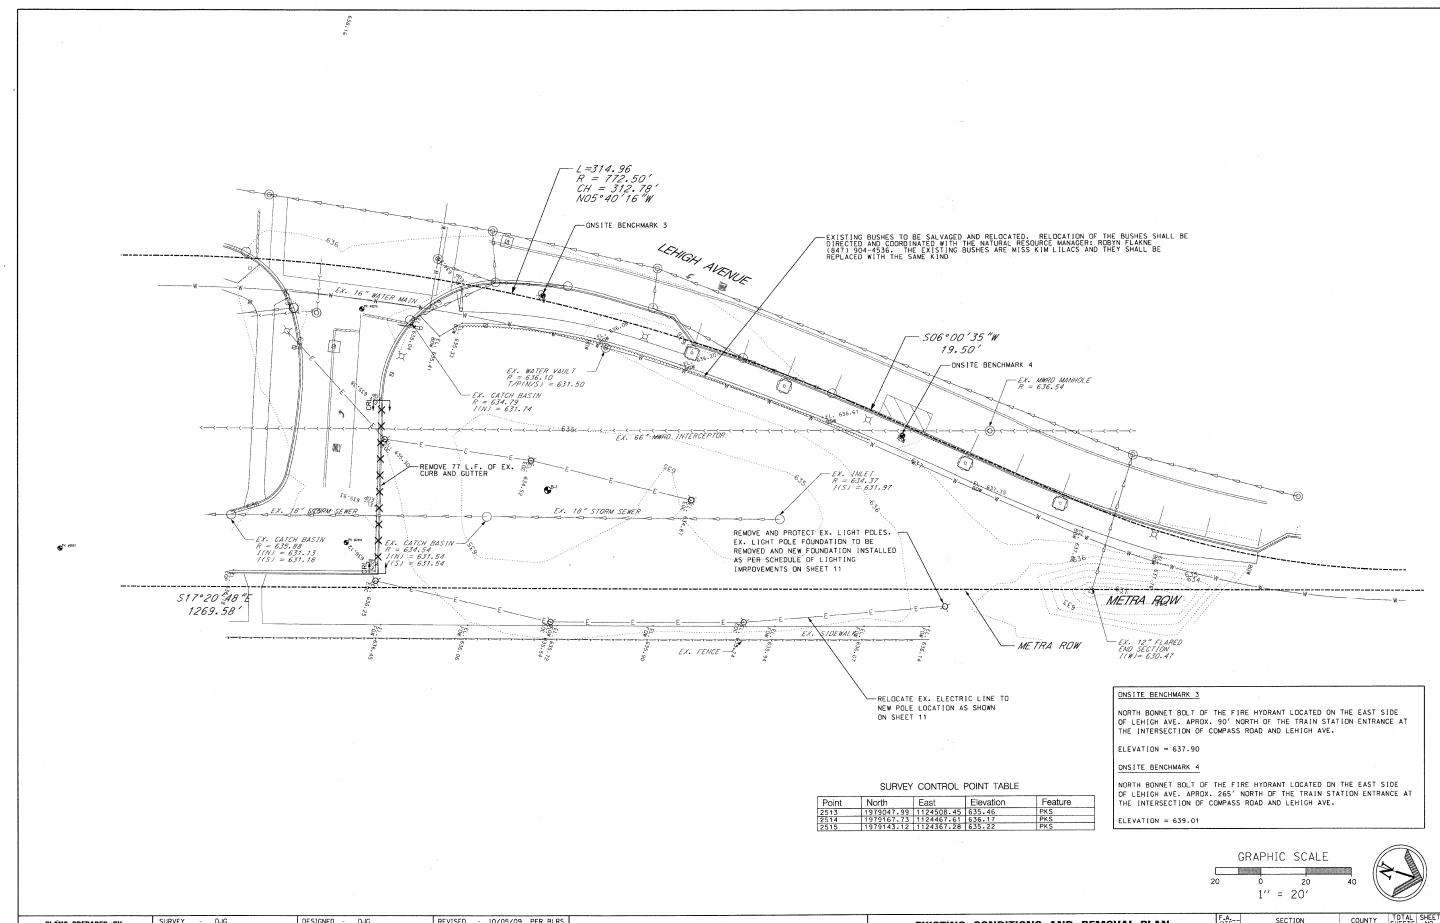

PLANS PREPARED BY:	SURVEY	-	DJG	DESIGNED	-	DJG	KENIZED	-	10/05/09 PER BERS
Postl-Yore and Associates, Inc.	UTILITIES	-	JC	DRAWN	-	DJG	REVISED	-	
SST YOP BY A JUNE TO RECEIVE BOARD, SUIT IN SECURITY STATE OF THE PROPERTY OF		-	DJG	CHECKED	-	LVA	REVISED	_	
W MAN POST NOW COM THE RES AS THE	DATE	-	04-23-09	DATE	-	09-17-09	REVISED	-	

VILLAGE OF GLENVIEW PROJECT E 08-56

			AND REMOVAL PLAN OD PARKING LOT
SCALE: 1" = 20'	SHEET NO.	9 OF 24 SHEETS	S


F.A RTÉ.	SECTION	COUNTY	TOTAL SHEETS	SHEET NO.
NA	08-00169-00-PK	COOK	24	9
		CONTRACT	NO. 6	3360
	ILLINOIS FED. A	ID PROJECT		

PARKING STALL SIGNAGE NOTES:


- 1. TOTAL NUMBER OF PARKING STALL SIGNS FOR THE WEST LOT NORTH POD PARKING LOT IS = 33
- 2. ALL PARKING STALL NUMBER SIGNS IN THE WEST LOT NORTH POD PARKING LOT SHALL BE MOUNTED ON A GALVANIZED  $2^{3}/\!g''$  POST AS SHOWN ON THE DETAIL ON SHEET 24.
- 3. PARKING STALL NUMBERING SYSTEM SHALL BE COORDINATED WITH THE

#### NOTES:

- 1. ALL CURB IN THE WEST LOT NORTH POD PARKING LOT SHALL BE REVERSE PITCH CURB UNLESS OTHERWISE NOTED.
- CURBS SHALL BE DEPPRESSED AT ALL SIDEWALK LOCATIONS AND ANY LOCATIONS THAT ARE NOTED ON THE PLANS.
- 3. HANDICAP RAMPS SHALL INCLUDE DETECTABLE WARNINGS SEE DETECTABLE WARNING DETAIL AND HANDICAP RAMP DETAIL ON SHEET 24.
- 4. ALL CURB RADIUS DIMMENSIONS SHOWN ARE BACK OF CURB RADIUS.
- 5. ALL PARKING LOT STALLS SHALL BE A MIN. OF 9' WIDE AND STALL DEPTH SHALL BE AS SHOWN ON THE PLAN. PARKING STALL LINES SHALL BE 4" YELLOW THERMO PLASTIC LINES
- 6. ALL CURB TRANSITIONS FROM REVERSE PITCH CURB TO STANDARD PITCH CURB SHALL BE DONE IN ACCORDANCE WITH THE DETAIL SHOWN ON SHEET 21
- 7. SEE SHEET 23 FOR PAVEMENT SECTION

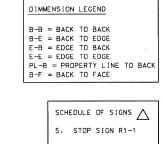

R1-1

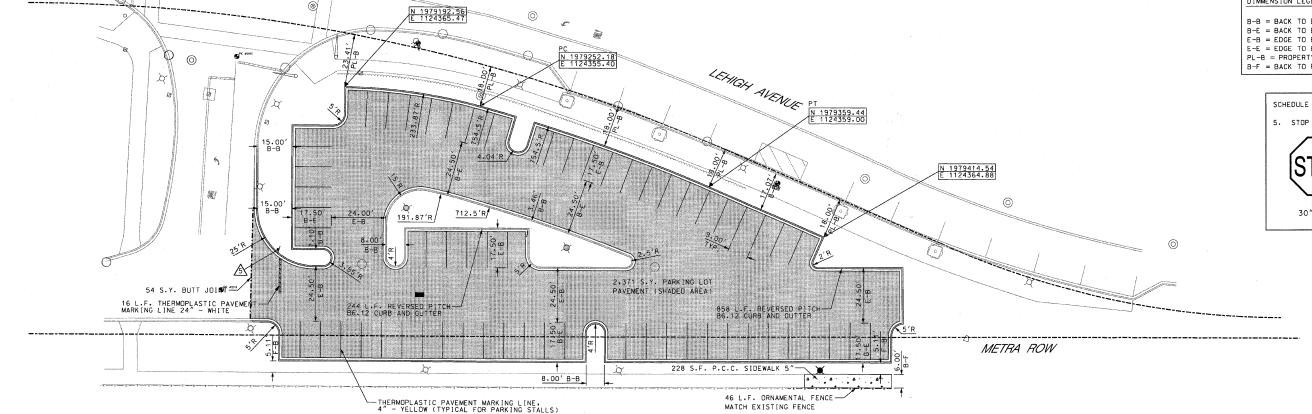

GRAPHIC SCALE

1" = 20"


//		
ГҮ	TOTAL SHEETS	SHEET NO.
,	24	10


PLANS PREPARED BY:	SURVEY -	DJG	DESIGNED	-	DJG	REVISED	-	10/05/09 PER BLF
Posti-Yore and Associates, Inc.	UTILITIES -	JC	DRAWN	-	DJG	REVISED	-	
OSET YOPE IN A MARKETON HOSETS ROAD, FUTC IN AND A THE PROPERTY AND A	CHECKED -	DJG	CHECKED	- '	LVA	REVISED	-	
A AN AND AND AND AND AND AND AND AND AND	DATE -	04-23-09	DATE	-	09-17-09	REVISED	-	


**VILLAGE OF GLENVIEW** PROJECT E 08-56


	E DIMENSIONAL EST LOT NORTH		
SCALE: 1" = 20'	SHEET NO. 10 OF 24 SHE	ETS	


Ė.	SECTION	COUNTY	SHEETS	NO.
A	08-00169-00-PK	COOK	24	10
		CONTRACT	NO. 6	3360
	ILLINOIS FED. A	ID PROJECT		

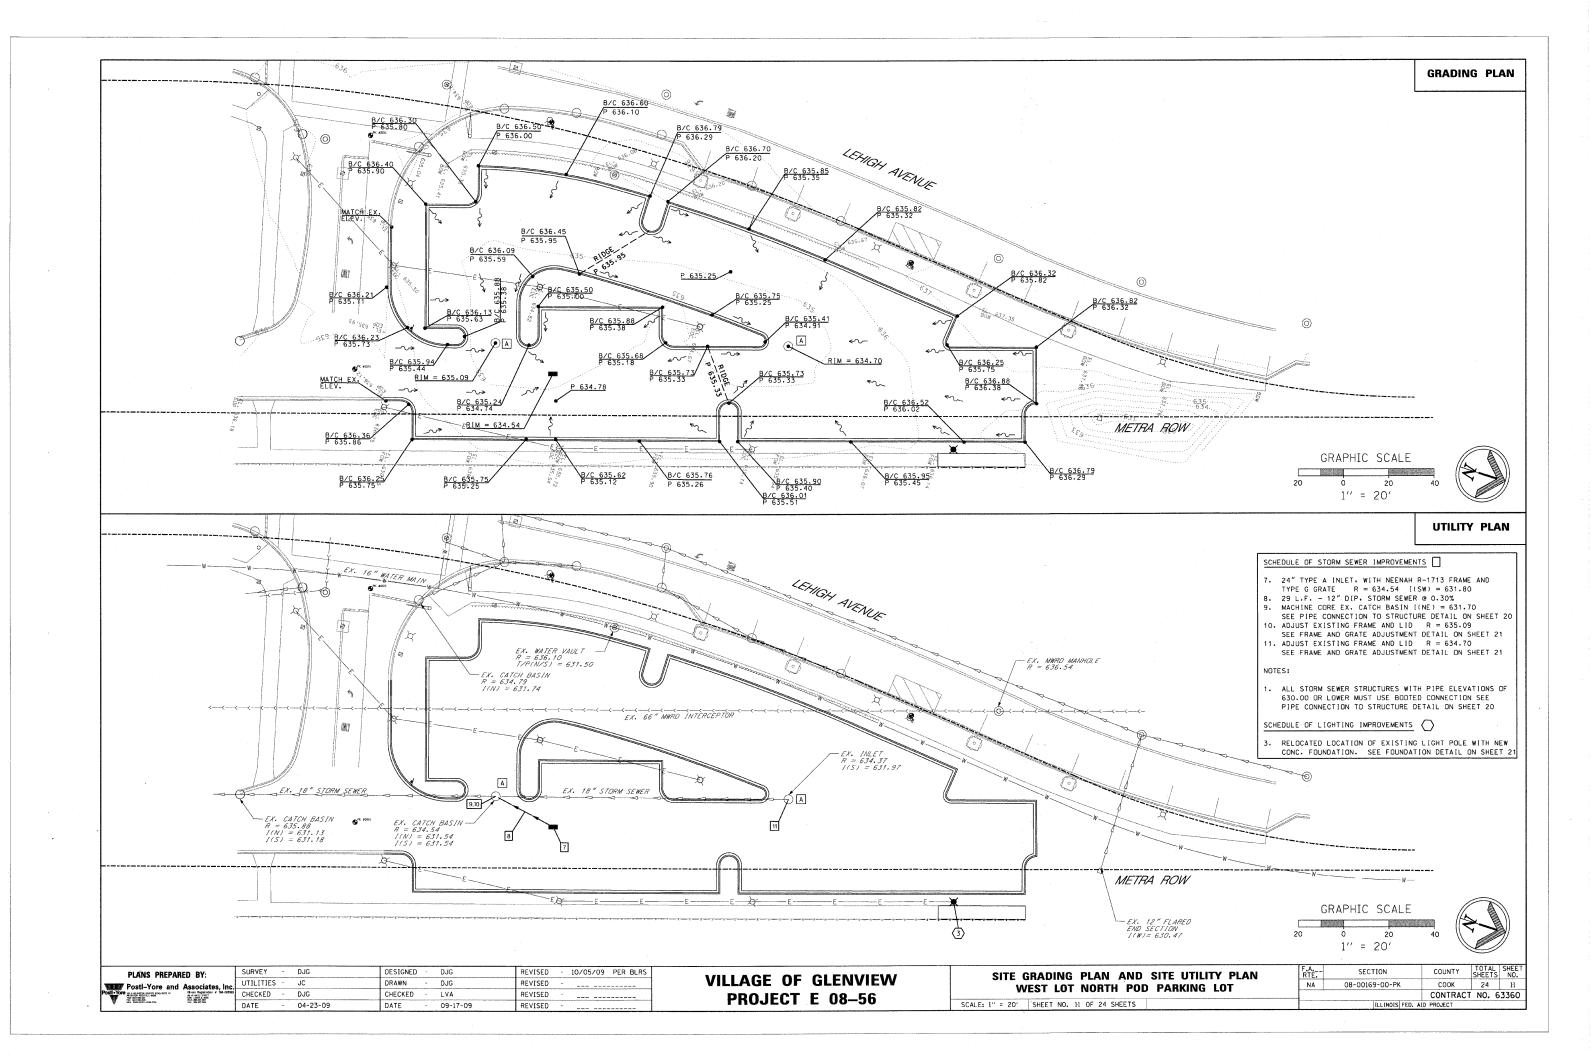

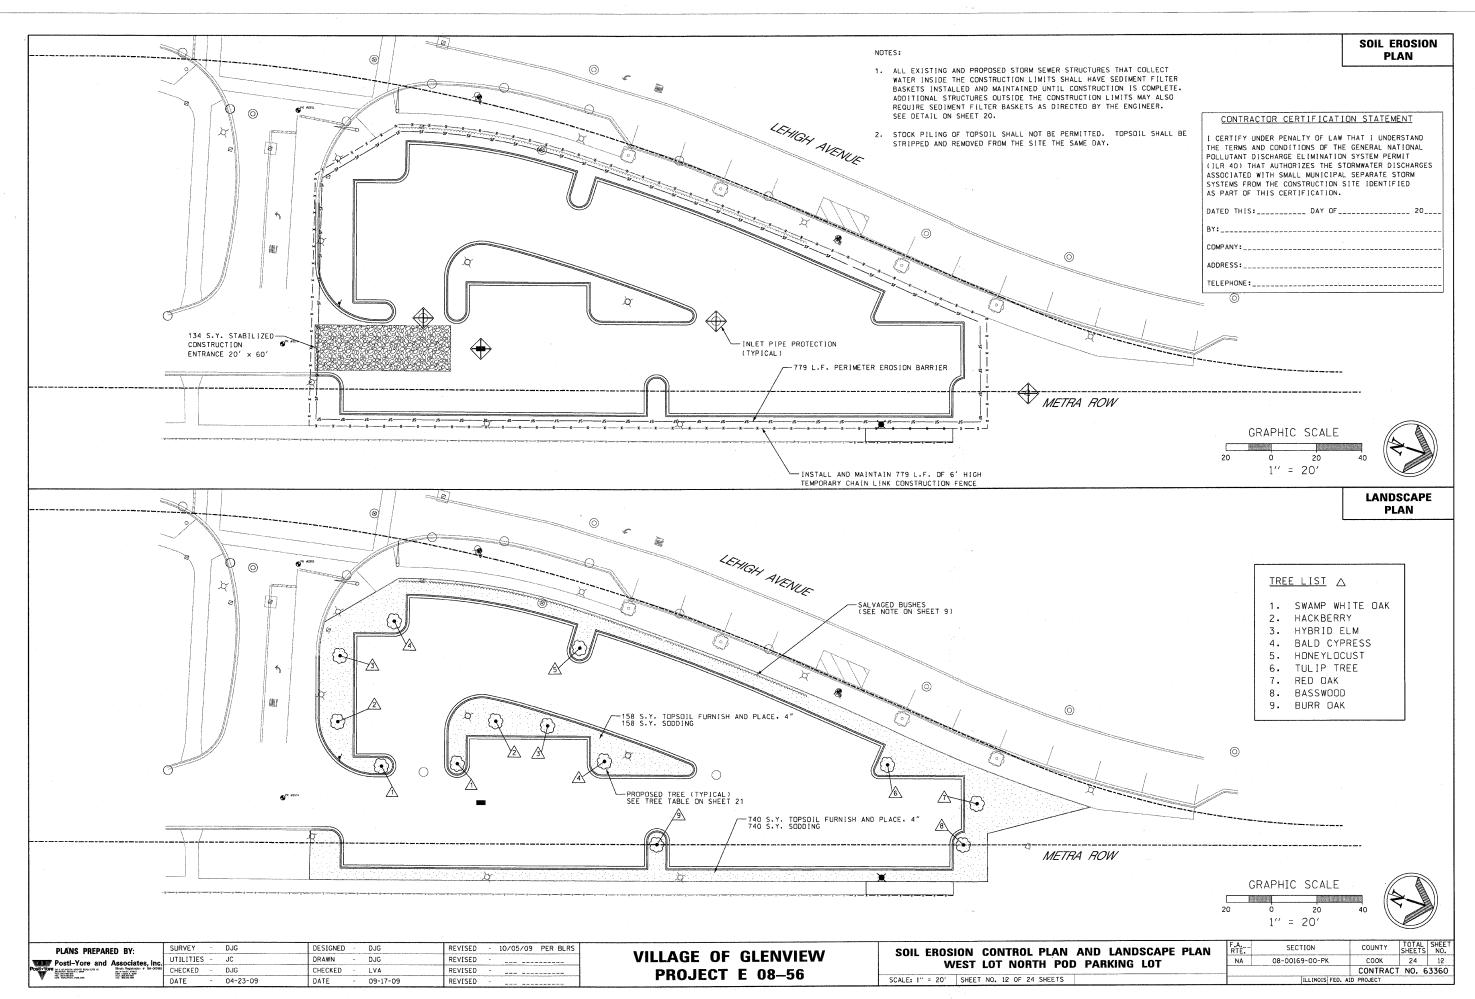


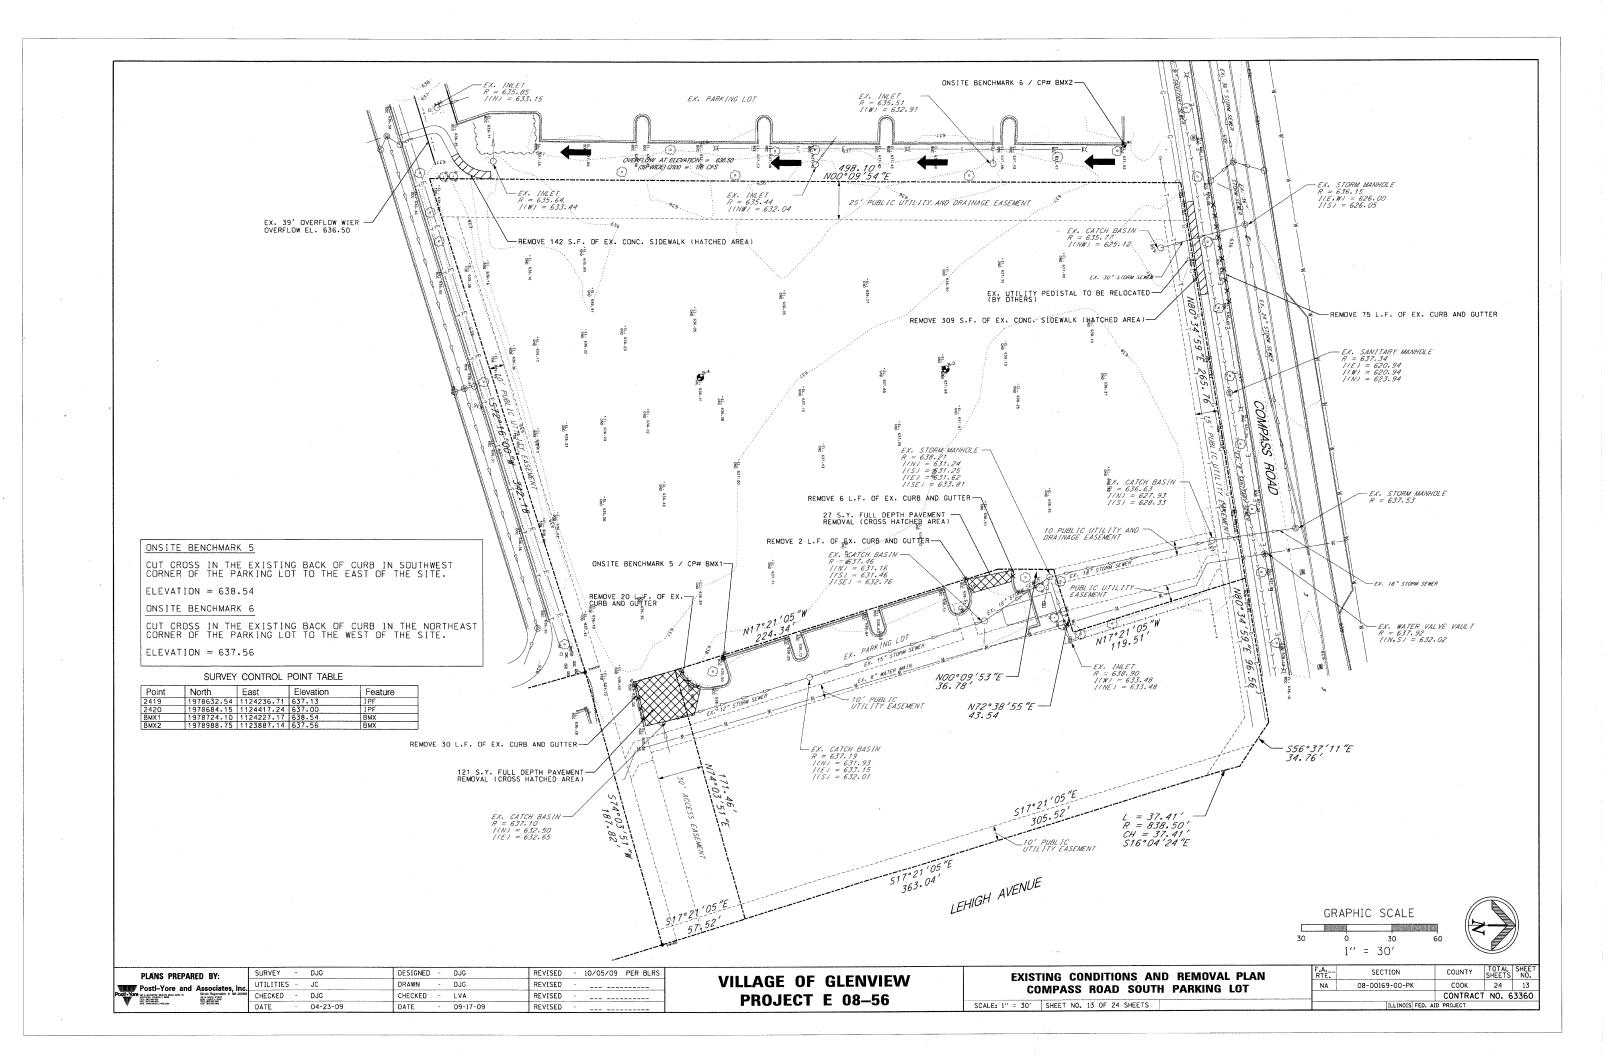


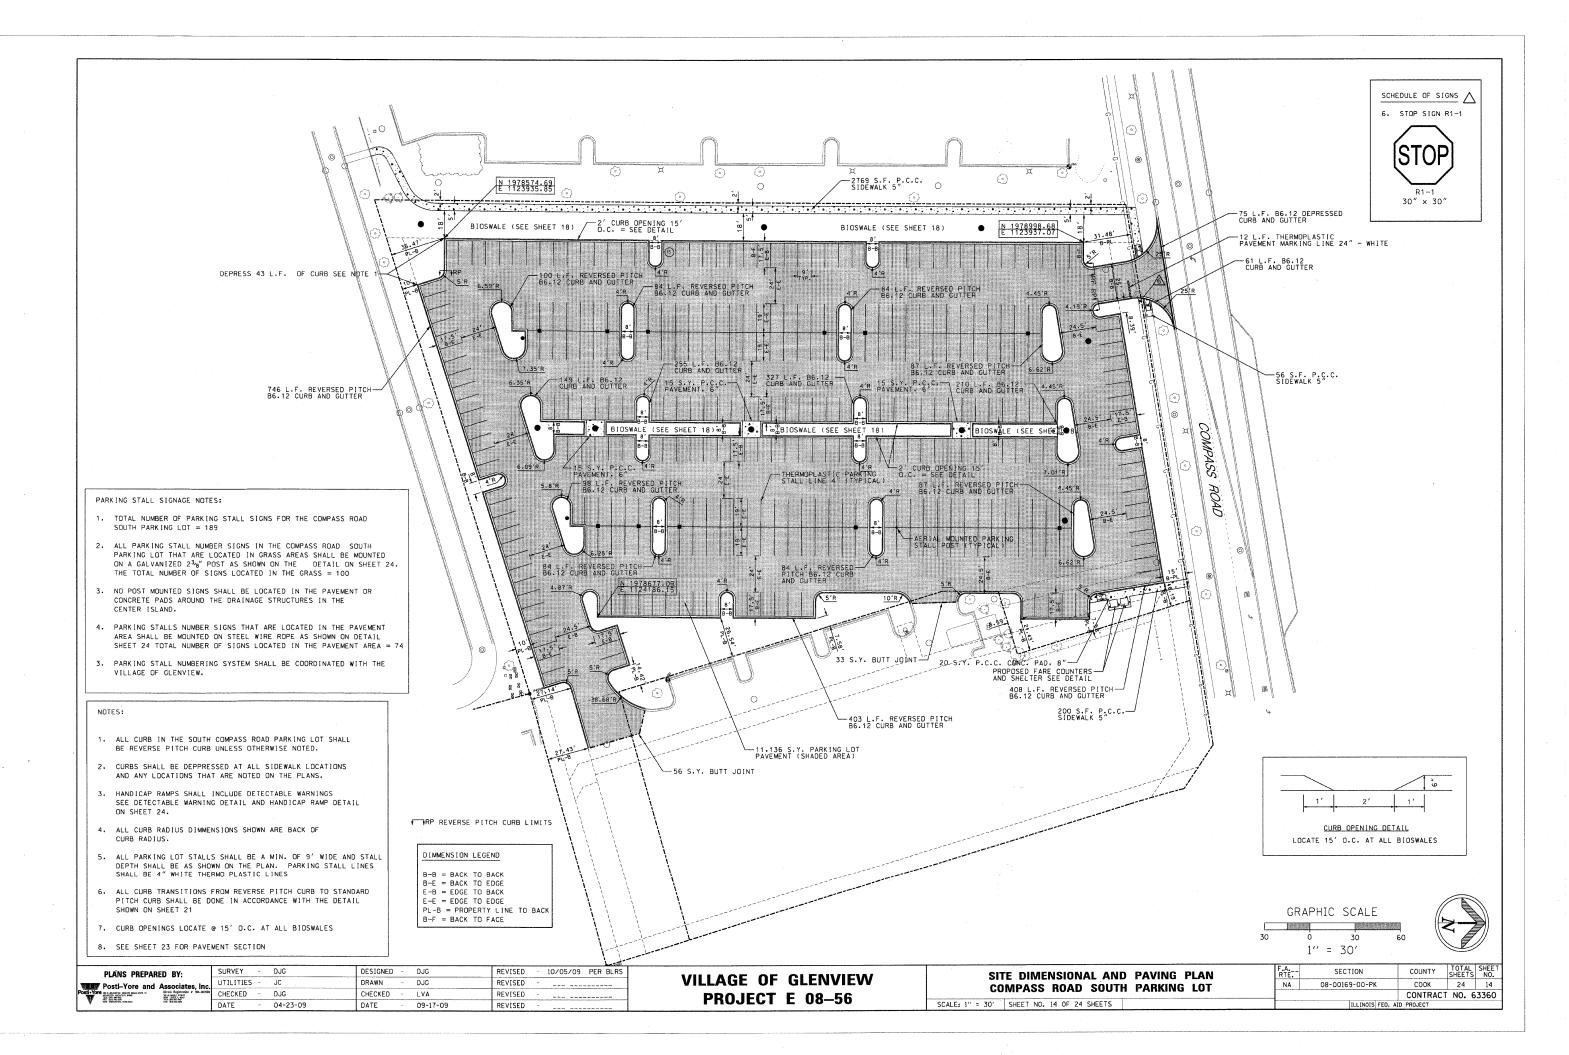


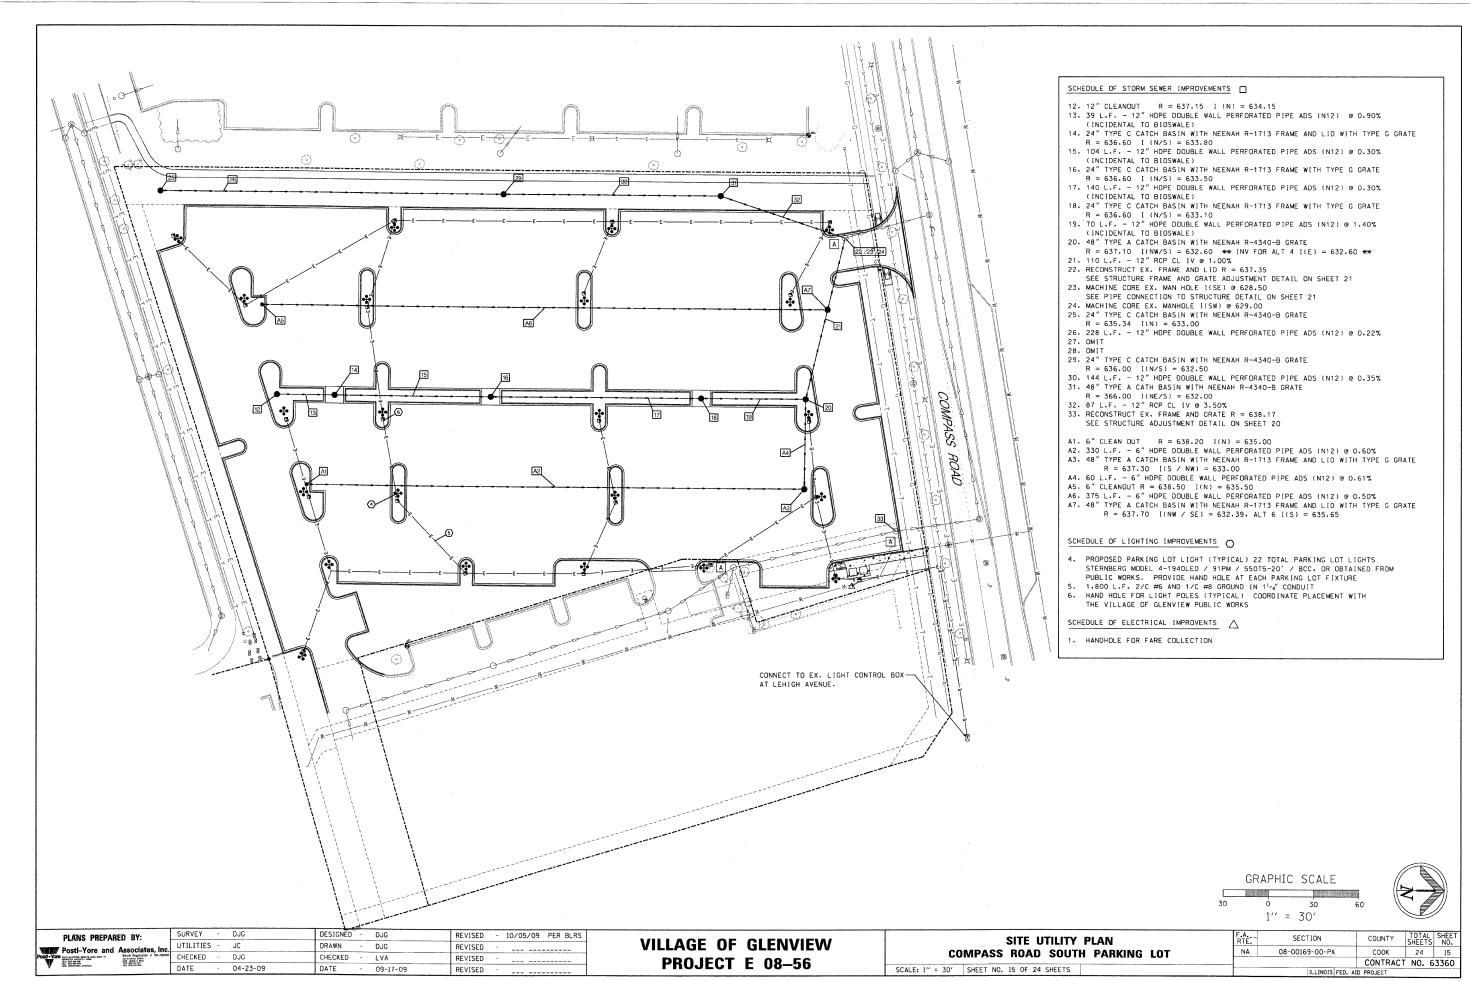



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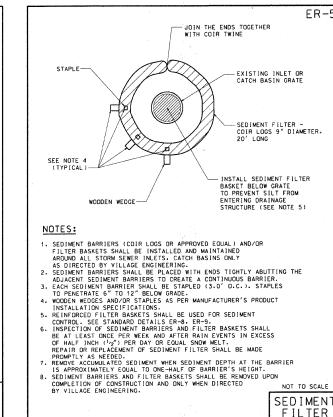


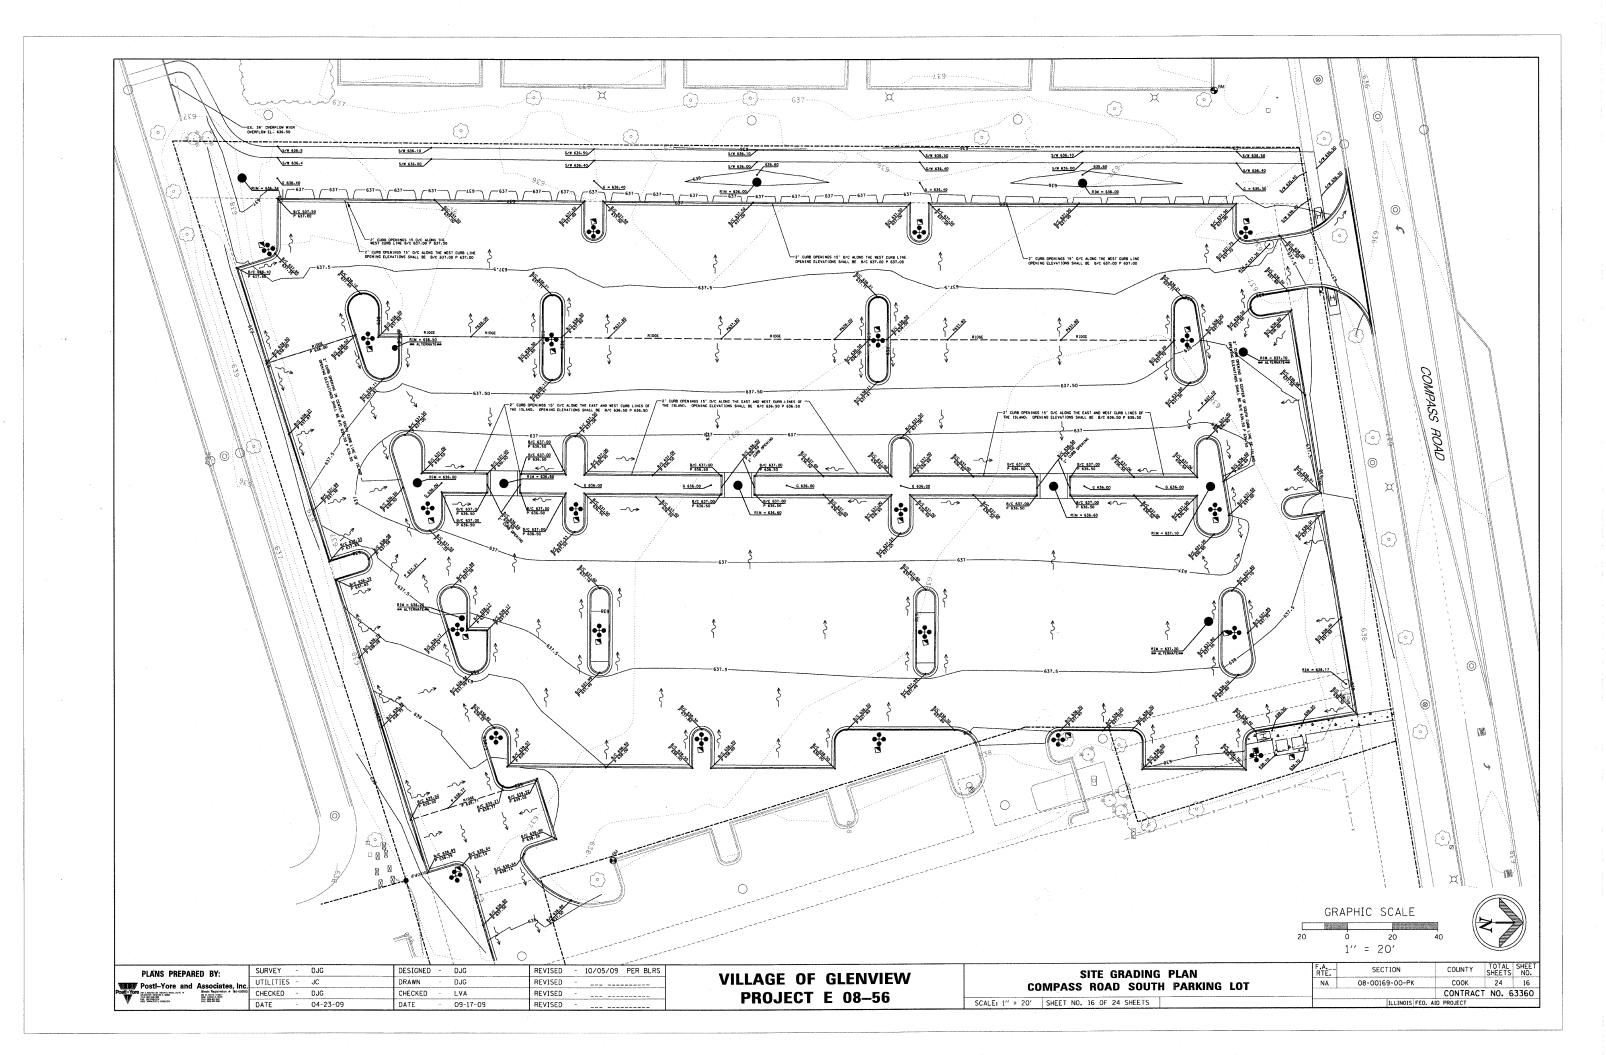


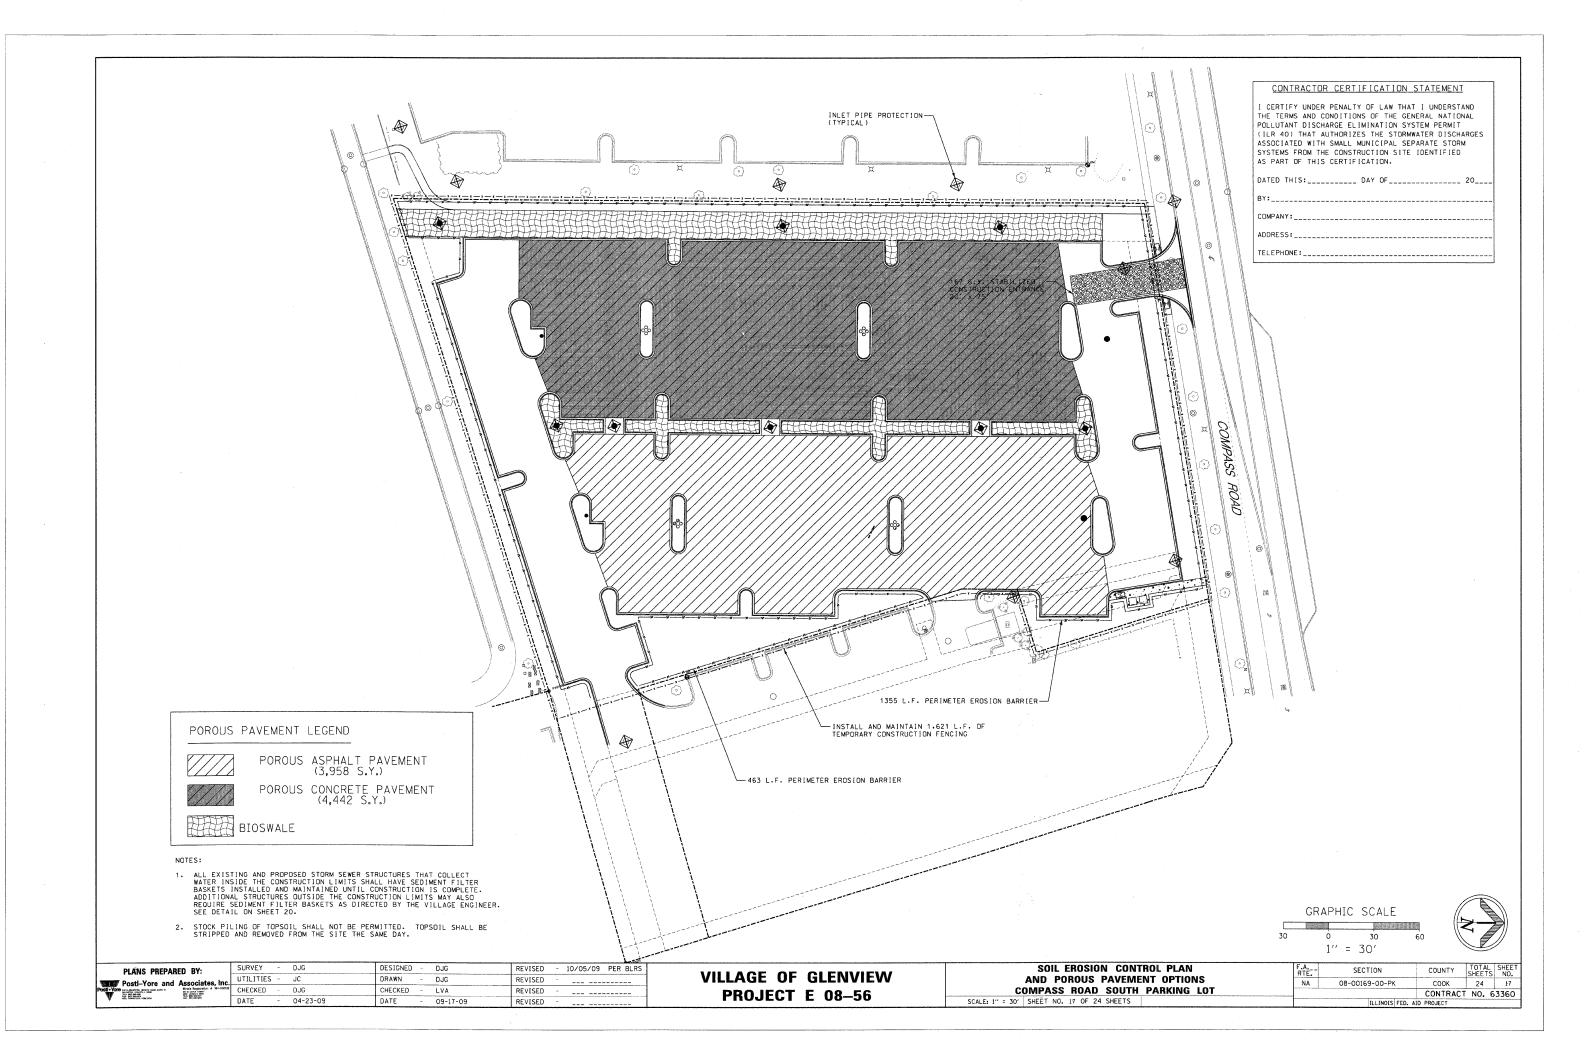


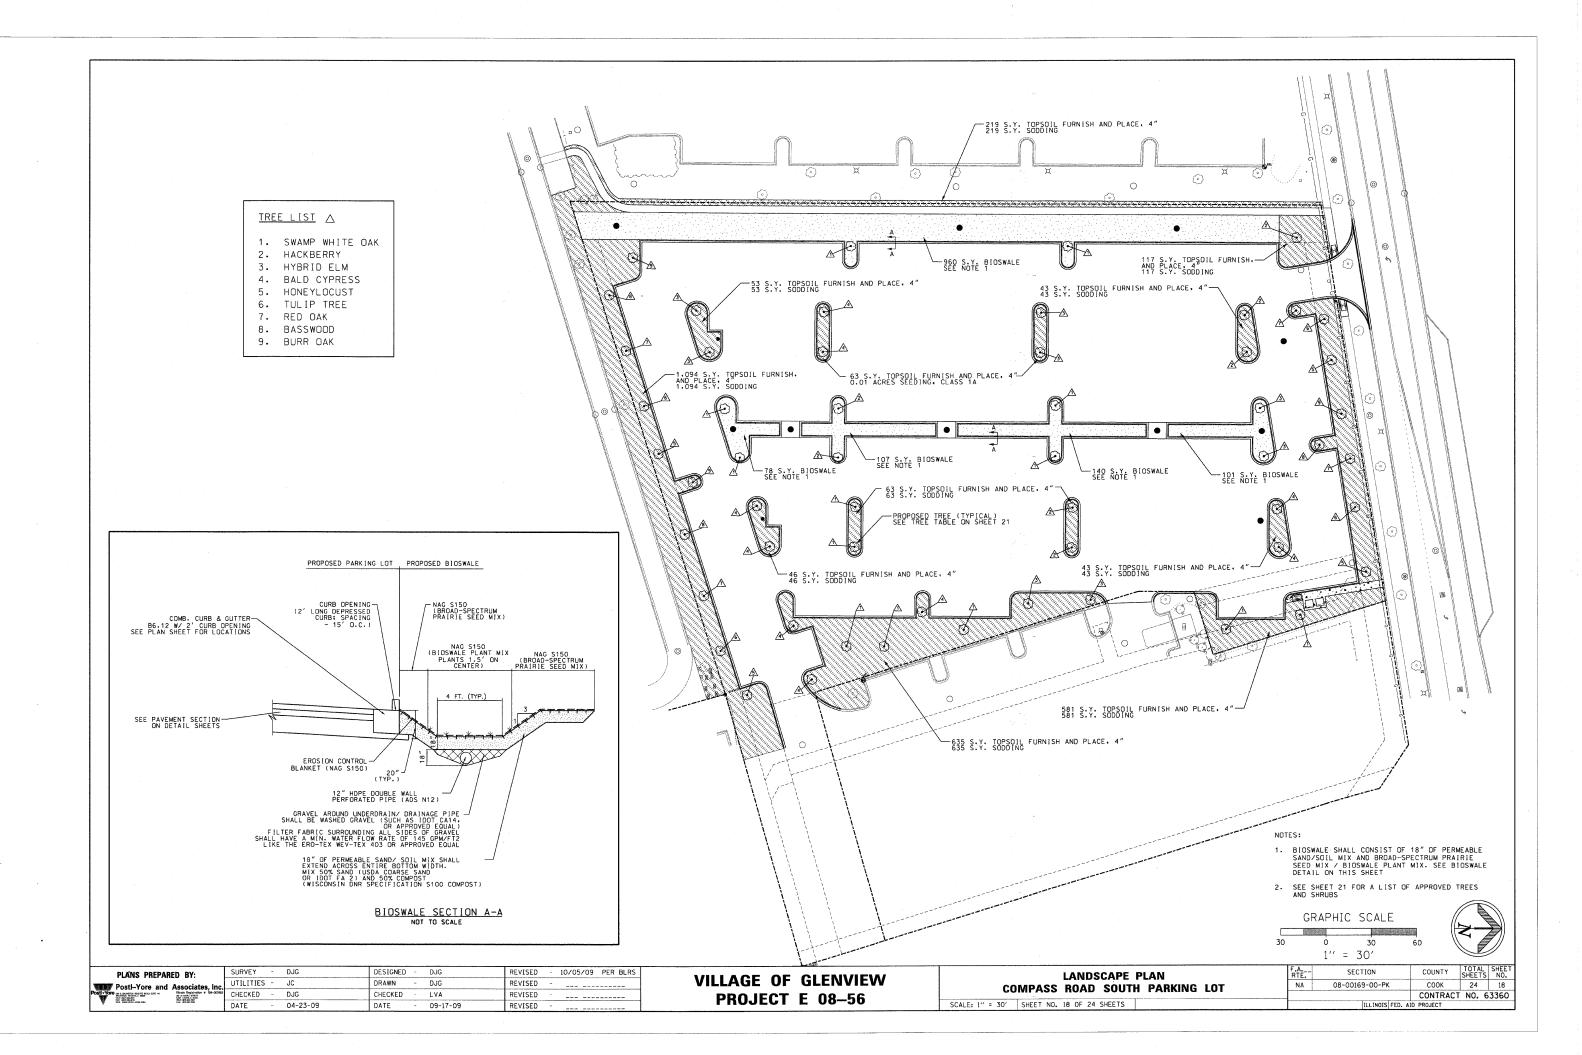

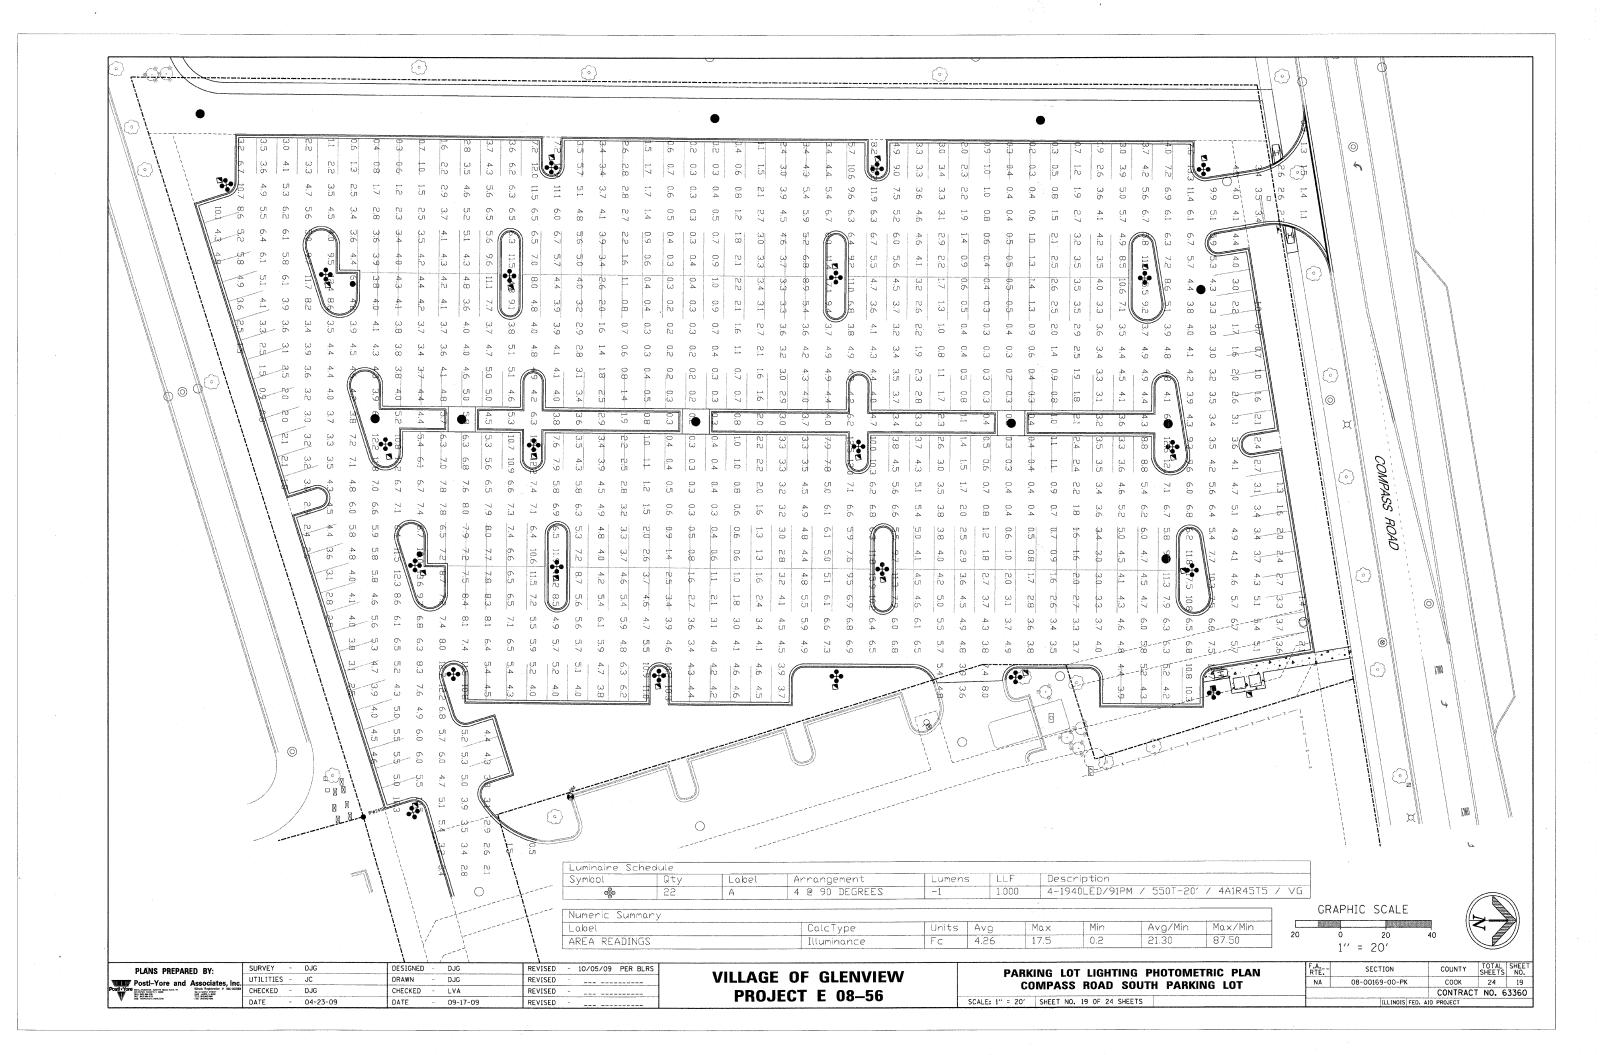

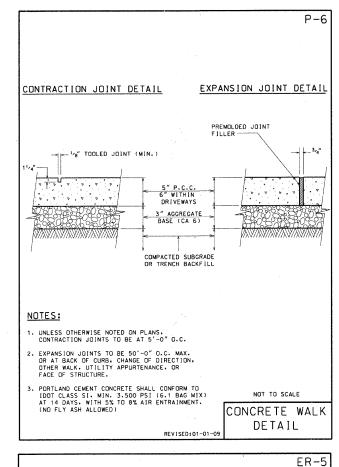

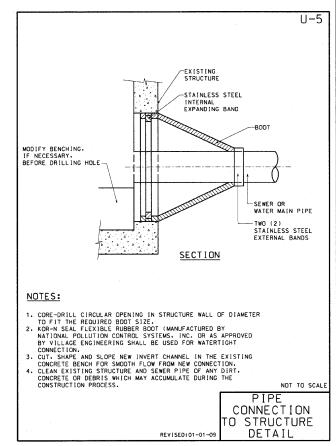

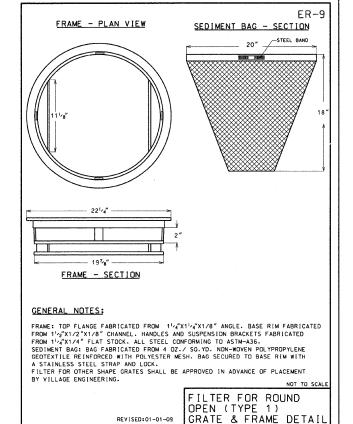



VILLAGE OF GLENVIEW PROJECT E 08-56

ER-4

-EXISTING PAVEMENT

- 5:1 SLOPE (TYP)

GROUND

NOT TO SCALE

STABILIZED CONSTRUCTION

ENTRANCE

DETAIL

- MOUNTABLE BERM (TIED INTO SILT FENCE!

100' MIN

PL AN SILT FENCE-

2008.000

© A← ELEVATION

TO EXTEND FULL WIDTH OF ENTRANCE

SECTION A-A

L GEOTEXTILE FILTER FABRIC SHALL BE PLACED OVER THE CLEARED AREA PRIOR TO PLACING COARSE AGGREGATE C. COARSE AGGREGATE OF CRUSHED CONCRETE) SHALL MEET 100T GRADATION FOR CA-ICRUSHED AGGREGATE.

3. STABILIZED CONSTRUCTION ENTRANCE SHALL BE INSTALLED, PRIOR TO ONSET OF CONSTRUCTION OPERATIONS AND SHALL BE MAITAINED THROUGHOUT THE PROJECT.

4. CONSTRUCTION ENTRANCE SHALL BE REMOVED UPON COMPLETION OF CONSTRUCTION AND ONLY WHEN DIRECTED BY VILLAGE ENGINEERING.

\_10' MIN\_

PREPARED SUBGRADE

COARSE AGGREGATE

EXISTING GROUND -


FILTER FABRIC --


FILTER FABRIC---


NOTES:

DETAIL

REVISED:01-01-

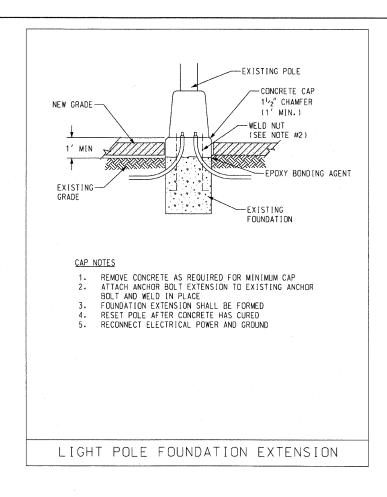

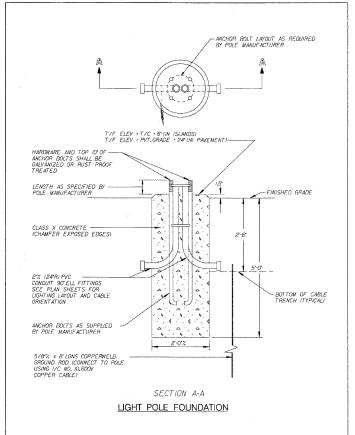

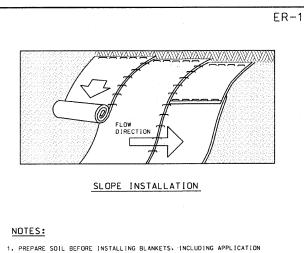

- NOTES:

  1. PREPARE SOIL BEFORE INSTALLING BLANKETS. INCLUDING APPLICATION OF LIME, FERTILIZER, AND SEED.

  2. BEGIN AT THE TOP OF THE SLOPE (OR CHANNEL) BY ANCHORING THE BLANKET IN A 6" DEEP X 6" WIDE TRENCH. BACKFILL AND COMPACT THE TRENCH AFTER STAPLING.

  3. ROLL THE BLANKETS DOWN (STARTING AT DOWNSTREAM PROCEEDING UPSTREAM) HORIZONTALLY ACROSS THE SLOPE.

  4. THE EDOES OF PARALLEL BLANKETS MUST BE STAPLED WITH AN APPROXIMATE (WIN) 4" OVERLAP.


  5. WHEN BLANKETS WIST BE SPLICED DOWN THE SLOPE. PLACE BLANKETS END OVER END (SHINGLE STYLE) WITH APPROXIMATELY A (MIN) 6" OVERLAP. USE A DOUBLE ROW OF STAGGERED STAPLES 4" APART TO SECURE BLANKETS.


  1. IN HIGH FLOW CHANNEL APPLICATIONS. A STAPLE CHECK SLOT IS RECOMMENDED AT 30 TO 40 FOOT INTERVALS. USE A ROW OF STAPLES 4" APART OVER ENTIRE WIDTH OF THE CHANNEL. PLACE A SECOND ROW 4" BELOW THE FIRST ROW IN A STAGGERED PATTERN.


  7. THE TERMINAL END OF THE BLANKETS MUST BE ANCHORED IN A 6" DEEP X 6" WIDE TRENCH. BACKFILL AND COMPACT THE TRENCH AFTER STAPLING.

SCALE: NONE

**EROSION** CONTROL BLANKET DETAIL

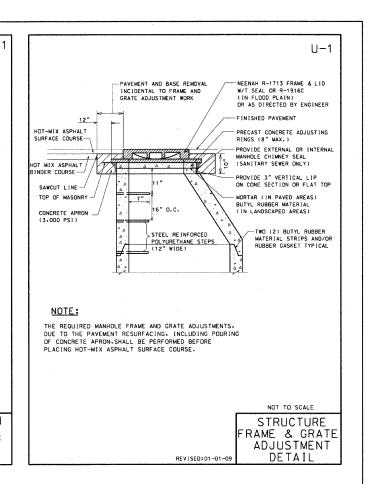

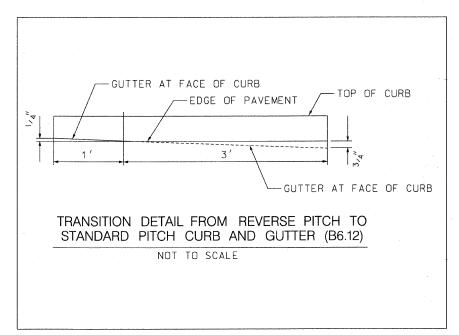


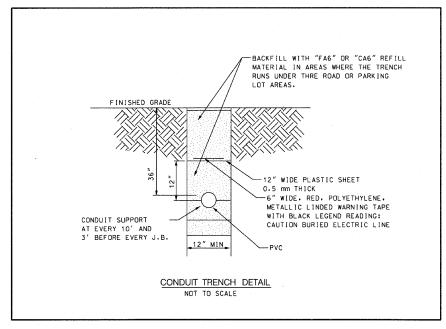

PLANS PREPARED BY:	SURVEY	-	DJG	DESIGNED		DJG .	REVISED	-	10/05/09	PER BLRS
Postl-Yore and Associates, I	c UTILITIES	-	JC	DRAWN	-	DJG	REVISED	-		
OST YOF OF A ALMANON AGENTS BOAD, SURE TO SO IN AMERICAN AND SO IN A		-	DJG	CHECKED	-	LVA	REVISED	-		
ME SICE SEE SEE MEE WARRY TO THE COM MEE WARRY TO THE WARRY TO THE COM MEE WARRY TO THE	DATE	-	04-23-09	DATE	-	09-17-09	REVISED			

**VILLAGE OF GLENVIEW** PROJECT E 08-56

STATE OF ILLINOIS DEPARTMENT OF TRANSPORTATION		SECTION	COUNTY	TOTAL	SHEET NO.	
		08-00169-00-PK	COOK	24	21	
			CONTRACT	NO.	63360	
SHEET NO. 21 OF 24 SHEETS   ILLINOIS FED. AID PROJECT						

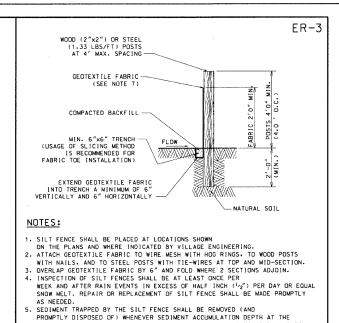

SILT FENCE IS APPROXIMATELY EQUAL TO TWELVE (12) INCHES (DNE-HALF OF SILT FENCE HEIGHT).

6. MATERIAL (GEOTEXTILE & POST) INSTALLATION, MAINTENANCE, AND SILT FENCE REMOVAL SHALL COMPLY WITH AASHTO, M 288 REQUIREMENTS.


7. THE FABRIC FOR SILT FENCE SHALL BE A WOVEN FABRIC MEETING THE REQUIREMENTS OF AASHTO M 288 (TABLE 7) FOR UNSUPPORTED SILT FENCE WITH LESS THAN 50 PERCENT GEOTEXTILE ELONGATION.


8. SILT FENCE SHALL BE MAINTAINED IN PLACE UNTIL COMPLETION OF CONSTRUCTION AND THE UPSLOPE AREA HAS BEEN STABILIZED.


AND SHALL BE REMOVED ONLY WHEN DIRECTED BY VILLAGE ENGINEERING.

SILT FENCE DETAIL REVISED:01-01-09

DEPRESSED CURB AT DRIVEWAYS. SIDEWALK RAMP SHOWN ON PLANS 1.5" AT DRIVEWAYS 0.5" AT SIDEWALK RAMPS 2-#6X18" LONG SMOOTH DOWEL BARS. WITH GREASED CAPS AT EXPANSION JOINTS. -IDOT CA 6 CRUSHED (3/4" THICK BITUMINOUS STONE BASE (3"MIN) (INCIDENTAL TO CURB & GUTTER) ∠ 2-#4 EPOXY COATED BARS. CONTINUOUS.AT UTILITY TRENCH CROSSING. EXCEPT ACROSS EXPANSION JOINTS. (SEE NOTE 5) 1. 2" DEEP CONTRACTION JOINTS SHALL BE PLACED AT 15' INTERVALS. AND SHALL BE GROOVED WITH AN EDGING TOOL. SEE ARTICLES 420.05 AND 606 OF IDDT STANDARD SPECIFICATIONS. 2. EXPANSION JOINTS SHALL BE PLACED AT 60' (MAX) INTERVALS, AT ALL P.C.'S AND P.T.'S. CURB RETURNS. AND AT THE END OF EACH POUR. 3. P.C.C. SHALL CONSIST OF IDOT CLASS SI (6.1 BAG) CONCRETE MIX.
WITH 5% TO 8% AIR ENTRAINMENT. AND A MINIMUM COMPRESSIVE
STRENGTH OF 3.500 PSI AT 14 DAYS.(NO FLY ASH ALLOWED) 4. PROVIDE 2 #6X24" LONG TIE BARS AT CONNECTIONS BETWEEN EXISTING AND NEW CURB & GUTTER. 5. CURBS. SPANNING UTILITY TRENCHES. SHALL BE CONSTRUCTED WITH TWO #4 REINFORCEMENT BARS.WHICH EXTEND FIVE (5) FEET BEYOND THE TRENCH WALLS. B-6.12 CURB & GUTTER DETAIL

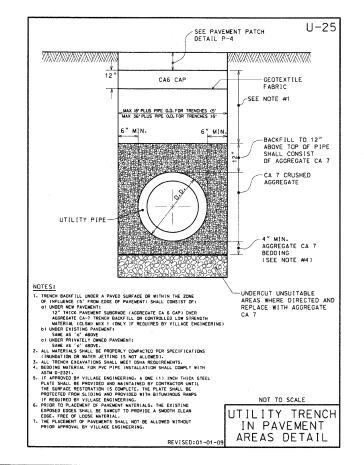

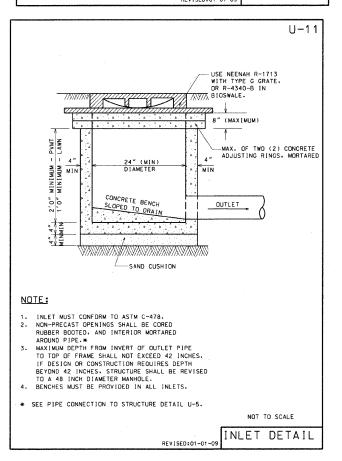

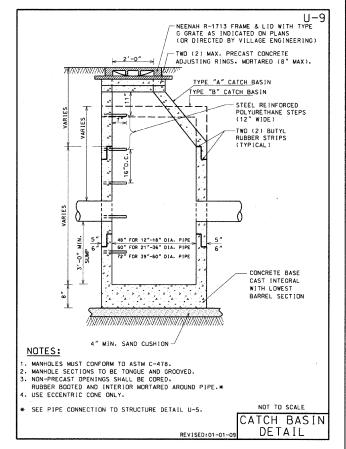

TOTAL SHEE SHEETS NO.


CONTRACT NO. 63360


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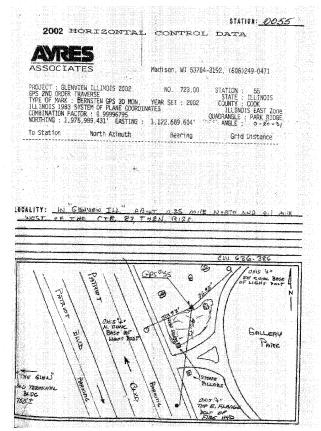
,	PLANS PREPARED BY:	SURVEY	-	DJG	DESIGNED	-	DJG	REVISED	-	10/05/09	PER BLRS
	Postl-Yore and Associates, Inc.	UTILITIES	-	JC	DRAWN	-	DJG	REVISED	-		
	Postl + Yore on a security sacc, one is		-	DJG	CHECKED	-	LVA	REVISED	140		
W 122	With Wall Politics Section Section 2014	DATE	-	04-23-09	DATE	-	09-17-09	REVISED	-		


**VILLAGE OF GLENVIEW** PROJECT E 08-56

SECTION STATE OF ILLINOIS 08-00169-00-PK **DEPARTMENT OF TRANSPORTATION** SCALE: NONE SHEET NO. 22 OF 24 SHEETS ILLINOIS FED. AID PROJECT



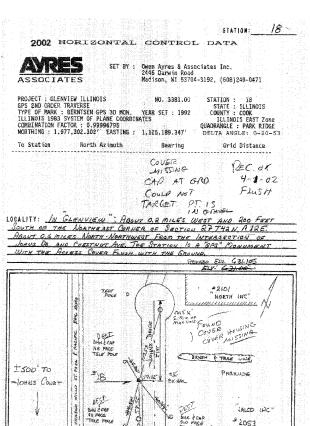

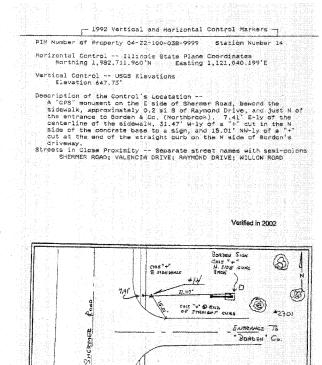


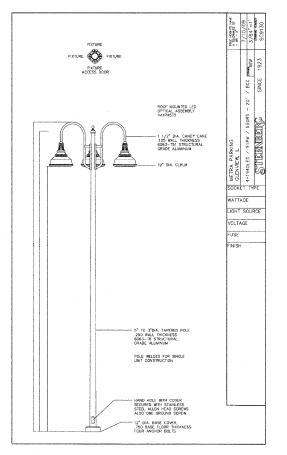



HOT-MIX ASPHALT MIXTURE REQUIREMENTS								
MIXTURE TYPE	AIR VOIDS @Ndes							
FULL DEPTH PAVEMENT								
HOT-MIX ASPHALT SURFACE COURSE MIX "D", N50 (IL 9.5 mm); 1.5"	4% @ 50 GYR.							
HOT-MIX ASPHALT BINDER COURSE IL 19, N50; 2.5"	4% @ 50 GYR.							
HMA BASE COURSE (HMA BINDER IL-19 MM); 4"	4% @ 50 GYR.							

THE UNIT WEIGHT USED TO CALCULATE ALL HMA SURFACE MIXTURE QUANTITIES IS 112 LBS/SQ YD / IN.

THE "AC TYPE" FOR POLYMERIZED HMA MIXES SHALL BE "SBS/SBR PG 70-22" AND FOR NON POLYMERIZED HMA THE "AC TYPE" SHALL BE "PG 64-22" UNLESS MODIFIED BY DISTRICTON SPECIAL PROVISIONS. FOR "PERCENT OF RAP" SEE DISTRICT ONE SPECIAL PROVISIONS.

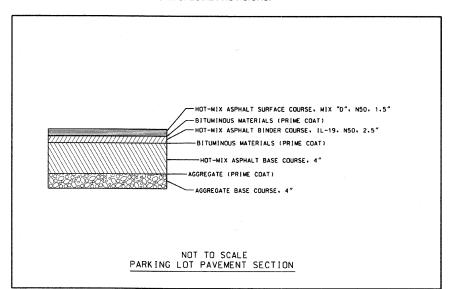

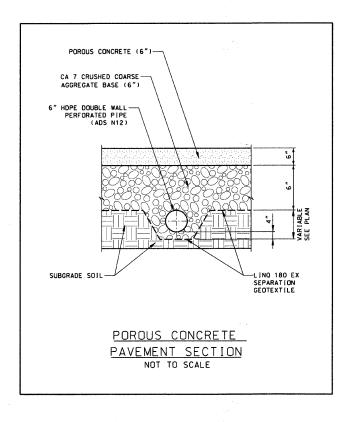

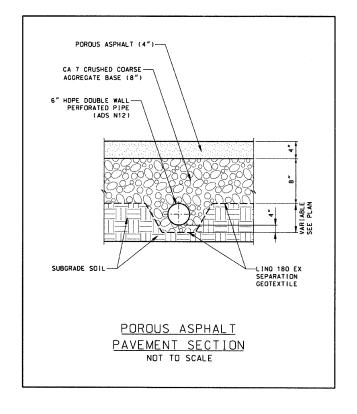



PLANS PREPARED	BY: SUR	VEY ~	DJG	DESIGNED		DJG	REVISED	-	10/05/09	PER BLRS
		ITIES -	JC	DRAWN	-	DJG	REVISED	~		
Bootly Vore		CKED -	DJG	CHECKED	-	LVA	REVISED	-		
Wes managest rest can	DAT	E -	04-23-09	DATE	-	09-17-09	REVISED	-		

VILLAGE OF GLENVIEW PROJECT E 08-56


	STATE OF ILLINOIS
	DEPARTMENT OF TRANSPORTATION
SCALE: NONE	SHEET NO. 23 OF 24 SHEETS


RTE.	SECTION	COUNTY	TOTAL SHEETS	SHEET NO.						
NA	08-00169-00-PK	COOK	24	23						
CONTRACT NO. 63360										
ILLINOIS FED. AID PROJECT										

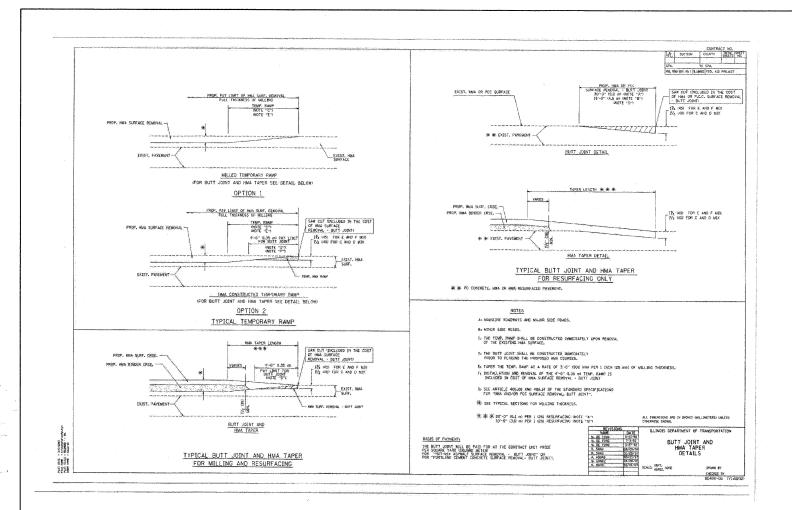


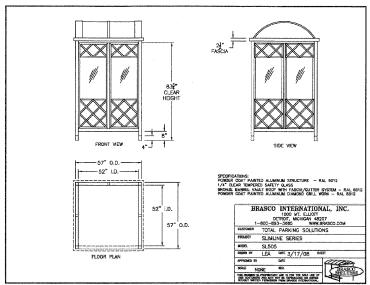

FAIR COLLECTION SHELTER DETAIL

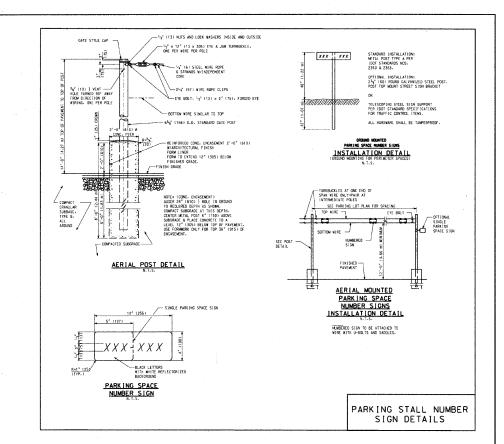

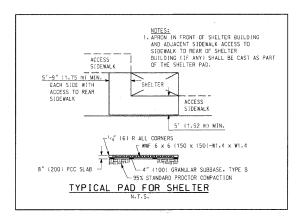

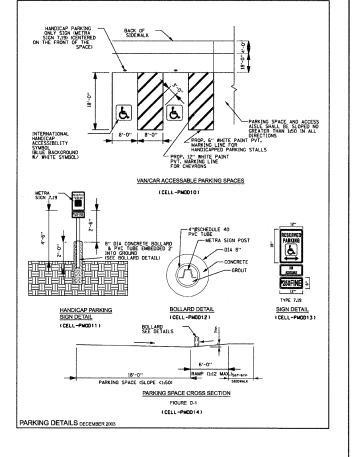

PLANS PREPARED BY:	SURVEY ~	DJG	DESIGNED	-	DJG	REVISED	-	10/05/09	PER BLRS
Posti-Yore and Associates, Inc.	UTILITIES -	JC	DRAWN	-	DJG	REVISED	-		
Posti + Yore and Assert House four Aure H Street Registration + 184-Correct Minorice House, a seek		DJG	CHECKED	-	LVA	REVISED	-		
The set of the collection of the set of the se	DATE -	04-23-09	DATE		09-17-09	REVISED	-		

VILLAGE OF GLENVIEW PROJECT E 08-56