STATE OF ILLINOIS FOR INDEX OF SHEETS, SEE SHEET NO. 2 DEPARTMENT OF TRANSPORTATION PROJECT LOCATED IN McHENRY **DIVISION OF HIGHWAYS** AND NUNDA TOWNSHIPS. TRAFFIC DATA PLANS FOR PROPOSED ADT (2007) = 13,600SPEED LIMIT = RANGES FROMFEDERAL AID PROJECT 30 TO 45 MPH LOCATION 1 - CHARLES J. MILLER ROAD TO IL. RTE 120 - 45 MPH LOCATION 2 - IL RTE. 120 TO LINCOLN ROAD - 40 MPH LOCATION 3 - LINCOLN ROAD TO WEST HOWELL ROAD - 45 MPH (CHAPEL HILL ROAD) FAU ROUTE 167 LOCATION 4 - WEST HOWELL ROAD TO BAY ROAD - 45 MPH LOCATION 5 - BAY ROAD TO ST. JOHNS/JOHNSBURG ROAD - 30 MPH **CHARLES J. MILLER ROAD (FAU 3860) TO SOUTH OF JOHNSBURG ROAD (FAU 168) OMISSIONS** (1) EXIST/PROP. INTERSECTION IMPROVEMENTS FROM STA. 3+00 TO STA. 8+41.43 RESURFACING (2) EXIST. IMPROVEMENTS FROM STA. 37+00 TO STA. 92+19.55 **SECTION NO.: 09-00366-00-RS** (3) EXIST./PROP. INTERSECTION IMPROVEMENTS FROM STA. 107+80.36 TO STA. 132+76.28 (4) EXIST. IMPROVEMENTS FROM STA. 169 + 28.43 TO STA. 186 + 52.89 PROJECT NO.: ARA-9003(475) (5) EXIST. INTERSECTION IMPROVEMENTS FROM STA. 192+20.48 TO STA. 210+47.51 JOB NO.: C-91-058-10 (6) EXIST. BRIDGE IMPROVEMENTS FROM STA. 217 + 24.53 TO STA. 223 + 85.08 **McHENRY COUNTY** (7) EXIST PROP. INTERSECTION IMPROVEMENTS FROM STA. 223+73.66 TO STA. 239+04.58 RESURFACING ENDS STA. 232 + 73.66 RESURFACING ENDS **BRIDGE OMMISSION** STA. 192 + 20.48 (31) 217 + 24.53 TO 223 + 85.08 **JOHNSBURG** WENGART RD. RESURFACING BEGINS SEDGE 12 STA. 210 + 47.51 MEADOW eriry RESURFACING BEGINS BAY RO STA. 186 + 52.89 RESURFACING ENDS STA. 107 + 80.36 **RESURFACING BEGINS** STA. 92 + 19.55 RESURFACING ENDS STA. 169 + 28.43 RESURFACING ENDS 27 STA. 37 + 00 RESURFACING BEGINS **RESURFACING BEGINS** STA. 132 + 76.28 LAKEMOOR STA. 8 + 41.43 Z FULL SIZE PLANS HAVE BEEN PREPARED USING STANDARD Lilymoor (120 ENGINEERING SCALES. REDUCED SIZED PLANS WILL NOT CONFORM TO STANDARD SCALES. IN MAKING MEASUREMENTS ON REDUCED PLANS, THE ABOVE SCALES MAY BE USED. 44 J.U.L.I.E. JOINT UTILITY LOCATION INFORMATION FOR EXCAVATION 1-800-892-0123 WOK ST Exp. 1430/2011 OR 811 **LOCATION MAP** 3rd P.M. (NOT TO SCALE) MCHENRY AND NUNDA TOWNSHIPS **GROSS LENGTH OF PROJECT = 22,432.23 LF** = 4.25 MILES (INTERMITTENT SECTIONS) NET LENGTH OF IMPROVEMENT = 10,204.72 LF = 1.93 MILES CONTRACT NO. 63380

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| FAUL | SECTION | COUNTY | TOTAL SHEET | SHEE



STATE OF ILLINOIS DEPARTMENT OF TRANSPORTATION DIVISION OF HIGHWAYS

APPROVED DECEMBER 2 20 09

MCHENRY COUNTY, COUNTY ENGINEER

PASSED DESPRISER 3 2009

DISTRICT | ENGINEER OF LOCAL ROADS & STREETS

RELEASING FOR BID

BASED ON LIMITED

REVIEW DECEMBER 4, 20 09

DIM M. O'Keft at DEPUTY DIRECTOR OF HIGHWAYS, REGION 1 ENGINEER

PRINTED BY THE AUTHORITY OF THE STATE OF ILLINOIS

INDEX OF SHEETS

SHEET NO.	TITLE
1 2	COVER SHEET INDEX OF SHEETS, STANDARDS,
	AND GENERAL NOTES
3	SUMMARY OF QUANTITIES AND DRIVEWAY DETAIL
4	TYPICAL SECTIONS AND HMA MIXTURE REQUIREMENTS
5-14	PROPOSED PLAN
15	BD-32 BUTT JOINTS AND HMA TAPER DETAILS
16	TC-10 TRAFFIC CONTROL AND PROTECTION FOR SIDE ROADS,
	INTERSECTIONS, AND DRIVEWAYS
17	TC-13 DISTRICT ONE TYPICAL PAVEMENT MARKINGS
18	TC-18 SIGNING FOR FLAGGING OPERATIONS AT WORK ZONE OPENING
19	TC-22 ARTERIAL ROAD INFORMATION SIGN

LISTS OF STANDARDS

000001-05	ABBREVIATIONS, SYMBOLS AND PATTERN
442201-03	CLASS C AND D PATCHES
482011-03	HMA SHLD. STRIPS/SHLDS. WITH RESURFACING OR WIDENING AND RESURFACING PROJECTS
701011-02	OFF-ROAD MOVING OPERATIONS, 2L, 2W DAY ONLY
701201-03	LANE CLOSURE, 2L, 2W, DAY ONLY, FOR SPEED >=45 MPH
701306-02	LANE CLOSURE, 2L, 2W, SLOW MOVING OPERATIONS DAY ONLY, FOR SPEEDS >= 45 MPH
701311-03	LANE CLOSURE, 2L, 2W, MOVING OPERATIONS-DAY ONLY
701501-05	URBAN LANE CLOSURE, 2L 2W, UNDIVIDED
701901-01	TRAFFIC CONTROL DEVICES
781001-03	TYPICAL APPLICATIONS RAISED REFLECTIVE PAVEMENT MARKERS
BLR 24-2	MAILBOX TURNOUTS FOR LOCAL ROADS

GENERAL NOTES


- 1. ALL CONSTRUCTION SHALL BE DONE IN ACCORDANCE WITH THE DETAILS IN THE PLANS, THE SPECIAL PROVISIONS INCLUDED IN THE CONTRACT DOCUMENTS, AND THE LATEST EDITION OF THE FOLLOWING STATE OF ILLINOIS SPECIFICATIONS: "THE STANDARD SPECIFICATIONS FOR ROAD AND BRIDGE CONSTRUCTION" (REFERRED TO AS THE "STANDARD SPECIFICATIONS"). THE "SUPPLEMENTAL SPECIFICATIONS AND RECURRING SPECIAL PROVISIONS". THE "MANUAL ON UNIFORM TRAFFIC CONTROL DEVICES FOR STREETS AND HIGHWAYS" AND THE "MANUAL OF TEST PROCEDURES FOR MATERIALS".
- 2. BARRICADES: THE CONTRACTOR SHALL PROVIDE AND INSTALL TWO (2) WEIGHTED SAND BAGS ON EACH TYPE I OR TYPE II BARRICADE USED FOR ONE (1) WEIGHTED SAND BAG ACROSS EACH BOTTOM RAIL.
- 3. ANY SIGNS THAT ARE IN CONFLICT WITH THE PROPOSED CONSTRUCTION SHALL BE REMOVED AND REPLACED IN ACCORDANCE WITH COUNTY STANDARDS AND INCLUDED IN THE COST OF THE CONTRACT.
- 4. THE CONTRACTOR SHALL BE RESPONSIBLE FOR THE PROTECTION OF ALL UNDERGROUND OR SURFACE UTILITIES EVEN THOUGH THEY MAY NOT BE SHOWN ON THE PLANS. ANY UTILITY THAT IS DAMAGED DURING CONSTRUCTION SHALL BE REPAIRED OR REPLACED AT THE CONTRACTOR'S EXPENSE TO THE SATISFACTION OF THE ENGINEER OR UTILITY COMPANY.
- 5. UTLITY LOCATIONS HAVE NOT BEEN SHOWN ON THE PLANS. THE CONTRACTOR SHALL CALL "J.U.L.I.E." AT 800-892-0123 OR 811 FOR FIELD LOCATIONS OF BURRIED ELECTRIC, PHONE, AND GAS FACILITIES PRIOR TO BEGINNING CONSTRUCTION. (48-HOUR NOTIFICATION REQUIRED)
- 6. THE CONTRACTOR SHALL COORDINATE CONSTRUCTION ACTIVITIES WITH UTILITY COMPANIES AND THE ENGINEER.
- 7. THE CONTRACTOR SHALL NOTIFY IDOT BUREAU OF MATERIALS (PHONE (847)-705-4337) AT LEAST 24 HOURS PRIOR TO THE PLACEMENT OF HMA OR CONCRETE.
- 8. SAW CUTTING OF PAVEMENTS, SHOULDERS, ETC. SHALL BE TO FULL DEPTH EXCEPT SIDEROADS AND DRIVEWAYS (1/2" SAW CUT)
 AND SHALL RESULT IN A CLEAN, STRAIGHT EDGE ON THE PORTION REMAINING. ALL SAWCUTTING SHALL BE CONSIDERED
 INCLUDED IN THE COST OF THE CONTRACT.
- 9. ALL MAILBOXES IMPACTED AS PART OF THE PROJECT, PER SECTION 107.20 OF THE IDOT STANDARD SPECIFICATIONS, SHALL BE RELOCATED AND WILL NOT BE PAID FOR SEPARATELY, BUT SHALL BE CONSIDERED AS INCLUDED IN THE COST OF THE CONTRACT.
- 10. THE CONTRACTOR SHALL MAINTAIN ACCESS TO RESIDENTS DRIVEWAY AT ALL TIMES.

- 11. THE CONTRACTOR SHALL UTILIZE A MECHANICAL SWEEPER TO CLEAN STREETS AFFECTED BY CONTRACTOR'S OPERATIONS, INCLUDING HAUL ROUTE, AT ALL TIMES. THIS WORK SHALL BE INCLUDED IN THE COST OF CONSTRUCTION.
- 12. THE CONTRACTOR SHALL BE RESPONSIBLE FOR DISPOSING OF ALL SURPLUS MATERIALS RELATED TO THE JOB AFTER COMPLETING THE PAVING PROJECT.
- 13. THE THERMOPLASTIC PAVEMENT MARKINGS MAY BE ADJUSTED FROM THE PLANS BY THE ENGINEER. THERMOPLASTIC PAVEMENT MARKINGS SHALL BE INSTALLED BY HAND-OPERATED METHOD ONLY.
- 14. CONTRACTOR SHALL INSTALL NOTCHED WEDGE LONGITUDINAL JOINTS IN ACCORDANCE TO SUPPLEMENTAL SPECIFICATIONS SECTION 406. A MINIMUM OF 600 POUNDS COMPACTION IS REQUIRED.
- 15. CONTRACTOR SHALL KEEP ONE LANE OF TRAFFIC OPEN AT ALL TIMES.
- 16. MAILBOX TURNOUTS SHALL BE PAVED INACCORDANCE WITH STANDARD BLR 24-2 OR TO A DIMENSION CONFORMING TO EXISTING CONDITIONS WITH THE APPROVAL OF THE ENGINEER. HMA MAILBOX TURNOUT SHALL NOT BE MEASURED FOR PAYMENT, BUT RESURFACING WITH HMA MIX SHALL BE PAID FOR AT THE CONTRACT UNIT PRICE PER TON.
- 17. DRIVEWAY TURNOUTS SHALL BE CONSTRUCTED TO A THREE (3) FOOT WIDTH OR WHATEVER DIMENSION IS NECESSARY TO CREATE AND MAINTAIN SATISFACTORY RIDING CONDITION. THESE GUIDELINES ARE VARIABLE ONLY WITH APPROVAL OF THE ENGINEER. HMA DRIVEWAY TURNOUTS SHALL NOT BE MEASURED FOR PAYMENT, BUT THE HMA MIX USED FOR RESURFACING SHALL BE PAID FOR AT THE CONTRACT UNIT PRICE PER TON.

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\$FILEL\$		DRAWN -	REVISED -	MCHENRY COUNTY DIVISION OF TRANSPORTATION INDEX OF SHEETS, STATE STANDARDS, AND GENERAL NOTES	ა,	0167	09-00366-00-RS	MCHENRY	19 2			
l	PLOT SCALE = \$SCALE\$	CHECKED -	REVISED -	CHAPEL HILL ROAD IMPROVEMENTS	AND GENERAL NUTES			0.01	05 00500 00 115	CONTRAC	CT NO. 63380	
	PLOT DATE = \$DATE\$	DATE -	REVISED -		SCALE: N.T.S	SHEET NO. OF SHEETS	STA.	TO STA.	FED. ROAD	DIST. NO. ILLINOIS FED.		


		SUMMARY OF QUANTITIES		TOTAL QUANTITIY	LOCATION 1 MILLER RD	LOCATION 2 IL RTE 120-	LOCATION 3 LINCOLN RD	LOCATION 4 W HOWELL RD	LOCATION 5 BAY RD - ST
	CODE NO.	ITEM DESCRIPTION	UNIT	(1000)	-IL RTE 120	LINCOLN RD	-W HOWELL RD	-BAY RD	JOHNS RD
	40600100	BITUMINOUS MATERIALS (PRIME COAT)	GALLON	5,149	1,364	962	1,662	255	906
	40600300	AGGREGATE PRIME COAT	TON	64	17	12	21	3	11
	40600635	LEVELING BINDER (MACHINE METHOD), N70	TON	32	8	6	10	2	6
	40600895	CONSTRUCTING TEST STRIP	EACH	2	0	0	2	0	0
	40600982	HOT-MIX ASPHALT SURFACE REMOVAL-BUTT JOINT	SQ YD	456	116	73	73	37	157
	40603085	HOT-MIX ASPHALT BINDER COURSE, IL-19.0, N70	TON	4,056	1,074	758	1,309	201	714
	40603340	HOT-MIX ASPHALT SURFACE COURSE, MIX "D", N70	TON	2,704	716	505	873	134	476
	44000196	HOT-MIX ASPHALT SURFACE REMOVAL, SPECIAL	SQ YD	33,864	8,524	6,014	10,390	1,593	5,663
	44201721	CLASS D PATCHES, TYPE III, 6 INCH	SQ YD	16	0	0	0	16	0
	44201723	CLASS D PATCHES, TYPE IV, 6 INCH	SQ YD	306	85	60	104	0	57
	67100100	MOBILIZATION	LSUM	1	0.2	0.2	0.2	0.2	0.2
	70100450	TRAFFIC CONTROL&PROTECTION,STANDARD 701201	LSUM	1	0.2	0.2	0.2	0.2	0.2
	70100460	TRAFFIC CONTROL&PROTECTION, STANDARD 701306	LSUM	11	0.2	0.2	0.2	0.2	0.2
	70102620	TRAFFIC CONTROL&PROTECTION,STANDARD 701501	LSUM	1	0.2	0.2	0.2	0.2	0.2
*	78000200	THERMOPLASTIC PAVEMENT MARKING - LINE 4"	FOOT	33,610	11,034	6,154	9,539	1,283	5,600
*	78000400	THERMOPLASTIC PAVEMENT MARKING - LINE 6"	FOOT	655	188	48	419	0	0
*	78000600	THERMOPLASTIC PAVEMENT MARKING - LINE 12"	FOOT	90	0	90	0	0	0
*	78000650	THERMOPLASTIC PAVEMENT MARKING - LINE 24"	FOOT	372	133	55	57	17	110
*	78300200	RAISED REFLECTIVE PAVEMENT MARKER REMOVAL	EACH	38	0	36	0	2	0
	XX002870	AGGREGATE SHOULDERS, TYPE B (SPECIAL)	SQ YD	2,965	545	635	1,540	245	0
	X0322256	TEMPORARY INFORMATION SIGNING	SQ FT	110	22	22	22	22	22
	X7030200	SHORT-TERM PAVEMENT MARKING (SPECIAL)	FOOT	7,406	2,079	1,119	2,656	413	1,139



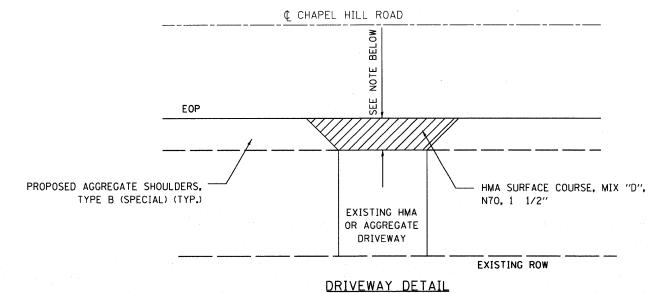

NOTE: 3' MAX. WHEN MATCHING EXISTING DRIVEWAY OR WHATEVER DIMENSION IS NECESSARY TO CREATE AND MAINTAIN A SATISFACTORY RIDING CONDITION. VARIABLE DIMENSIONS ARE SUBJECT TO ENGINEER APPROVAL.

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\$FILEL\$		DRAWN -	REVISED -	McHENRY COUNTY DIVISION OF TRANSPORTATION	AND DRIVEWAY DETAIL		0167	09-00366-00-RS	MCHENRY	19 3				
· ·	PLOT SCALE = \$SCALE\$	CHECKED -	REVISED -	CHAPEL HILL ROAD IMPROVEMENTS		AND DRIVEWAY DETAIL				CONTRAC	T NO. 63380			
	PLOT DATE = \$DATE\$	DATE -	REVISED -		SCALE: 1"=50"	SHEET NO.	OF	SHEETS	STA.	TO STA.	FED. ROAD	DIST. NO. ILLINOIS FEE	. AID PROJECT	

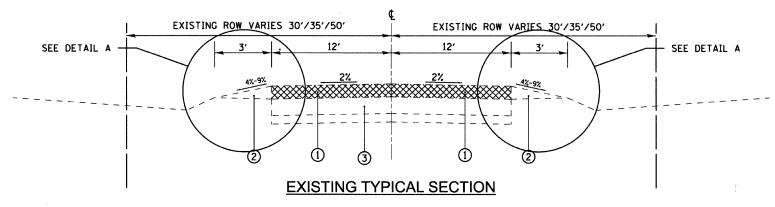

CHAPEL HILL ROAD


STA. 8+41.43 TO STA. 37+00 (CORRUGATED BITUMINOUS SHOULDERS) (SEE DETAIL A)

STA. 92+19.55 TO STA. 107+80.36 (BITUMINOUS SHOULDERS) (SEE DETAIL A)

STA. 132+76.28 TO STA. 169+28.43

STA. 186+52.89 TO STA. 192+20.48

STA. 210+47.51 TO STA. 232+73.66

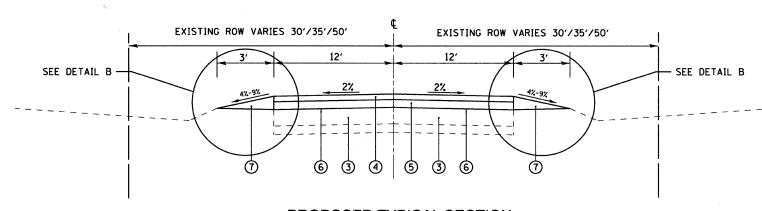

PROPOSED TYPICAL SECTION

CHAPEL HILL ROAD

STA. 8+41.43 TO STA. 37+00 (BITUMINOUS SHOULDERS) (SEE DETAIL B)

STA. 92+19.55 TO STA. 107+80.36 (BITUMINOUS SHOULDERS) (SEE DETAIL B)

STA. 132+76.28 TO STA. 169+28.43

STA. 186+52.89 TO STA. 192+20.48

STA. 210+47.51 TO STA. 232+73.66

LEGEND

- 1) HOT-MIX ASPHALT SURFACE REMOVAL, (SPECIAL), 3 3/4"
- 2 EXISTING AGGREGATE SHOULDERS/BITUMINOUS SHOULDERS
- 3 EXISTING HMA BASE COURSE
- (4) PROPOSED HOT-MIX ASPHALT SURFACE COURSE, MIX D. N70, 1/2"
- (5) PROPOSED HOT-MIX ASPHALT BINDER COURSE, IL-19.0, N70, 21/4"
- 6 PROPOSED BITUMINOUS MATERIALS (PRIME COAT) AND AGGREGATE (PRIME COAT)
- (7) PROPOSED AGGREGATE SHOULDERS, TYPE B. (SPECIAL)
- (8) EXISTING CORRUGATED SHOULDERS/BITUMINOUS SHOULDERS

NOTE:

PROPOSED LEVELING BINDER (MACHINE METHOD), N70 (AS NECESSARY FOR SLOPE CORRECTION, 3/4" MINIMUM)

OMISSIONS

EXIST./PROP. INTERSECTION IMPROVEMENTS FROM STA. 3+00 TO STA. 8+41.43

EXIST. IMPROVEMENTS FROM STA. 37+00 TO STA. 92+19.55


EXIST./PROP. INTERSECTION IMPROVEMENTS FROM STA. 107+80.36 TO STA. 132+76.28

EXIST. IMPROVEMENTS FROM STA. 169+28.43 TO STA. 186+52.89

EXIST. INTERSECTION IMPROVEMENTS FROM STA. 192+20.48 TO STA. 210+47.51

EXIST. BRIDGE FROM STA. 217+24.53 TO STA. 223+85.08

EXIST./PROP. INTERSECTION IMPROVEMENTS FROM STA. 223+73.66 TO STA. 239+04.58

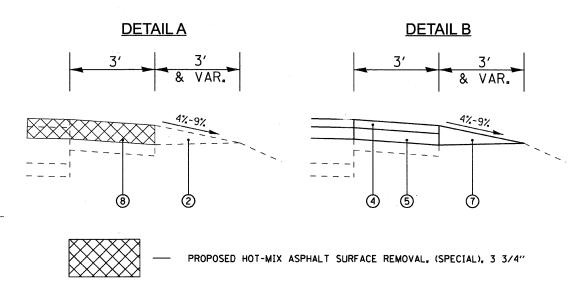


NOTE: CONTRACTOR SHALL MILL BEFORE PATCHING.

HOT-MIX ASPHALT MIXTURE REQUIREMENTS	3
MIXTURE TYPE	AIR VOIDS • NODES
PAVEMENT RESURFACING:	
HOT-MIX ASPHALT SURFACE COURSE, MIX "D", N70 (IL 9.5 mm)	4% e 70 GYR.
HOT-MIX ASPHALT BINDER COURSE, IL-19.0, N70	4% e 70 GYR.
SLOPE CORRECTION:	
LEVELING BINDER (MACHINE METHOD), N70 (IL 9.5 mm)	4% e 70 GYR.
PATCHING:	
CLASS D PATCHES (HMA BINDER IL-19mm)	4% @ 70 GYR.

THE UNIT WEIGHT USED TO CALCULATE ALL HMA SURFACE MIXTURE QUANTITIES IS 112 LBS/SQ YD/IN.


THE "AC TYPE" FOR POLYMERIZED HMA MIXES SHALL BE "SBS/SBR PG70-22" AND NON-POLEMERIZED HMA. THE "AC TYPE" SHALL BE "PG 64-22 UNLESS MODIFIED BY DISTRICT ONE SPECIAL PROVISIONS. FOR "PERCENT OF RAP" SEE DISTRICT ONE SPECIAL PROVISIONS.


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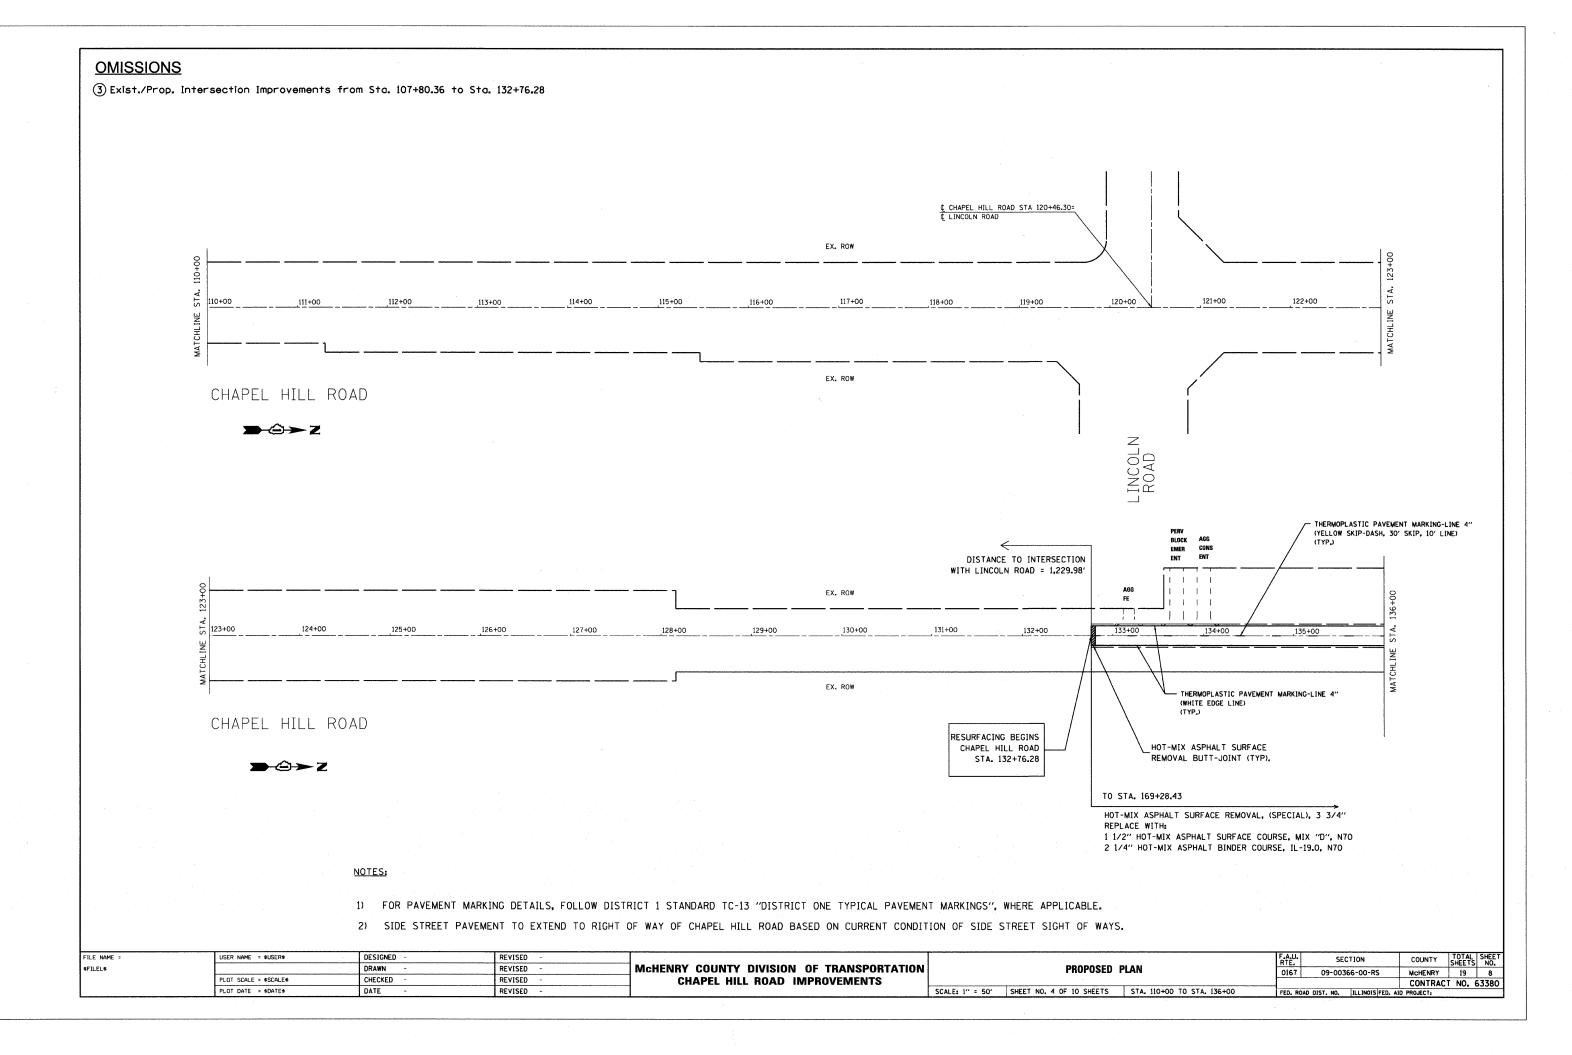


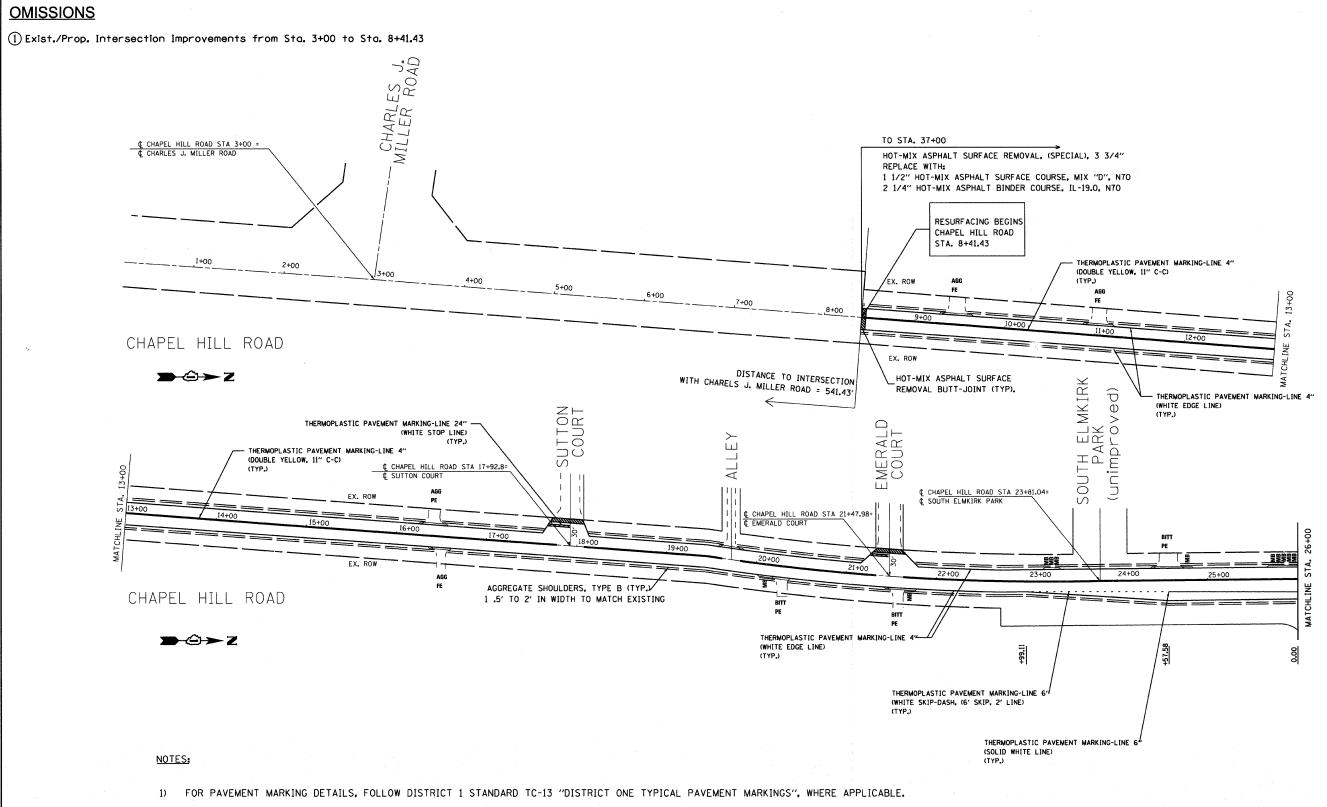
2) SIDE STREET PAVEMENT TO EXTEND TO RIGHT OF WAY OF CHAPEL HILL ROAD BASED ON CURRENT CONDITION OF SIDE STREET SIGHT OF WAYS,


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\$F	ILEL\$		DRAWN -	REVISED -	McHENRY COUNTY DIVISION OF TRANSPORTATION	PROPOSED PLAN	0167 09-00366-00-RS McHENRY	19 5
		PLOT SCALE = \$SCALE\$	CHECKED -	REVISED -	CHAPEL HILL ROAD IMPROVEMENTS	<u>i</u>	CONTRACT	T NO. 63380
		PLOT DATE = \$DATE\$	DATE -	REVISED -		SCALE: 1" = 50' SHEET NO. 1 OF 10 SHEETS STA. 1+00 TO STA. 26+00	FED. ROAD DIST. NO. ILLINOIS FED. AID PROJECT	



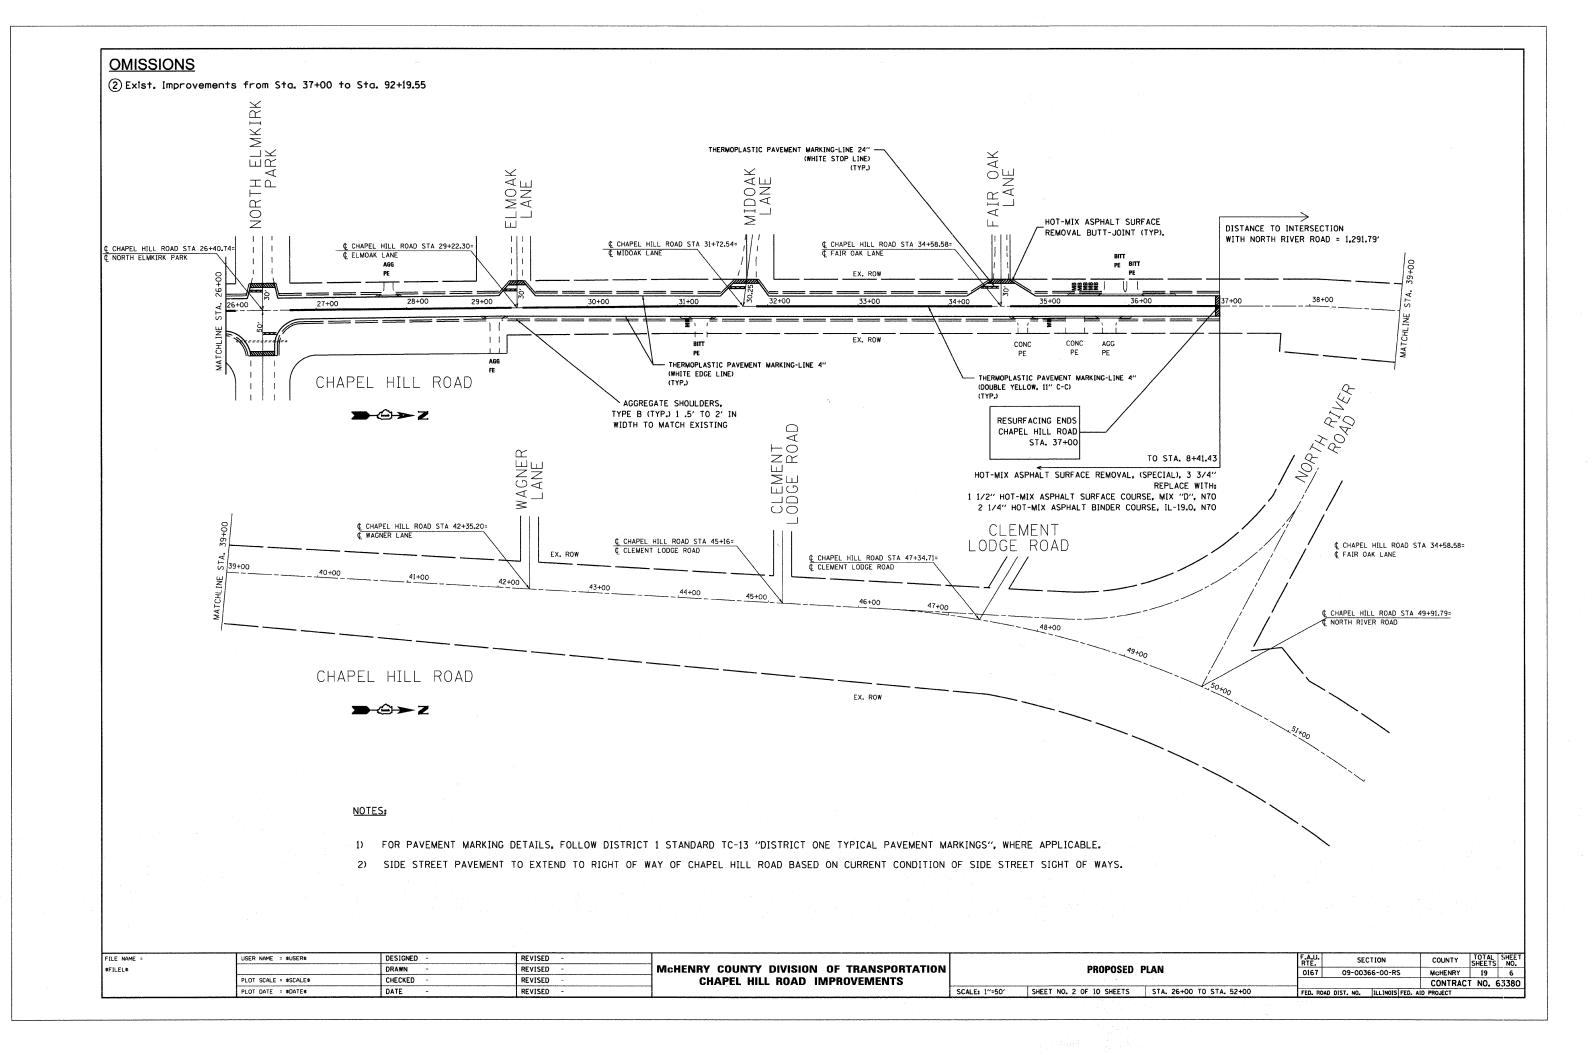

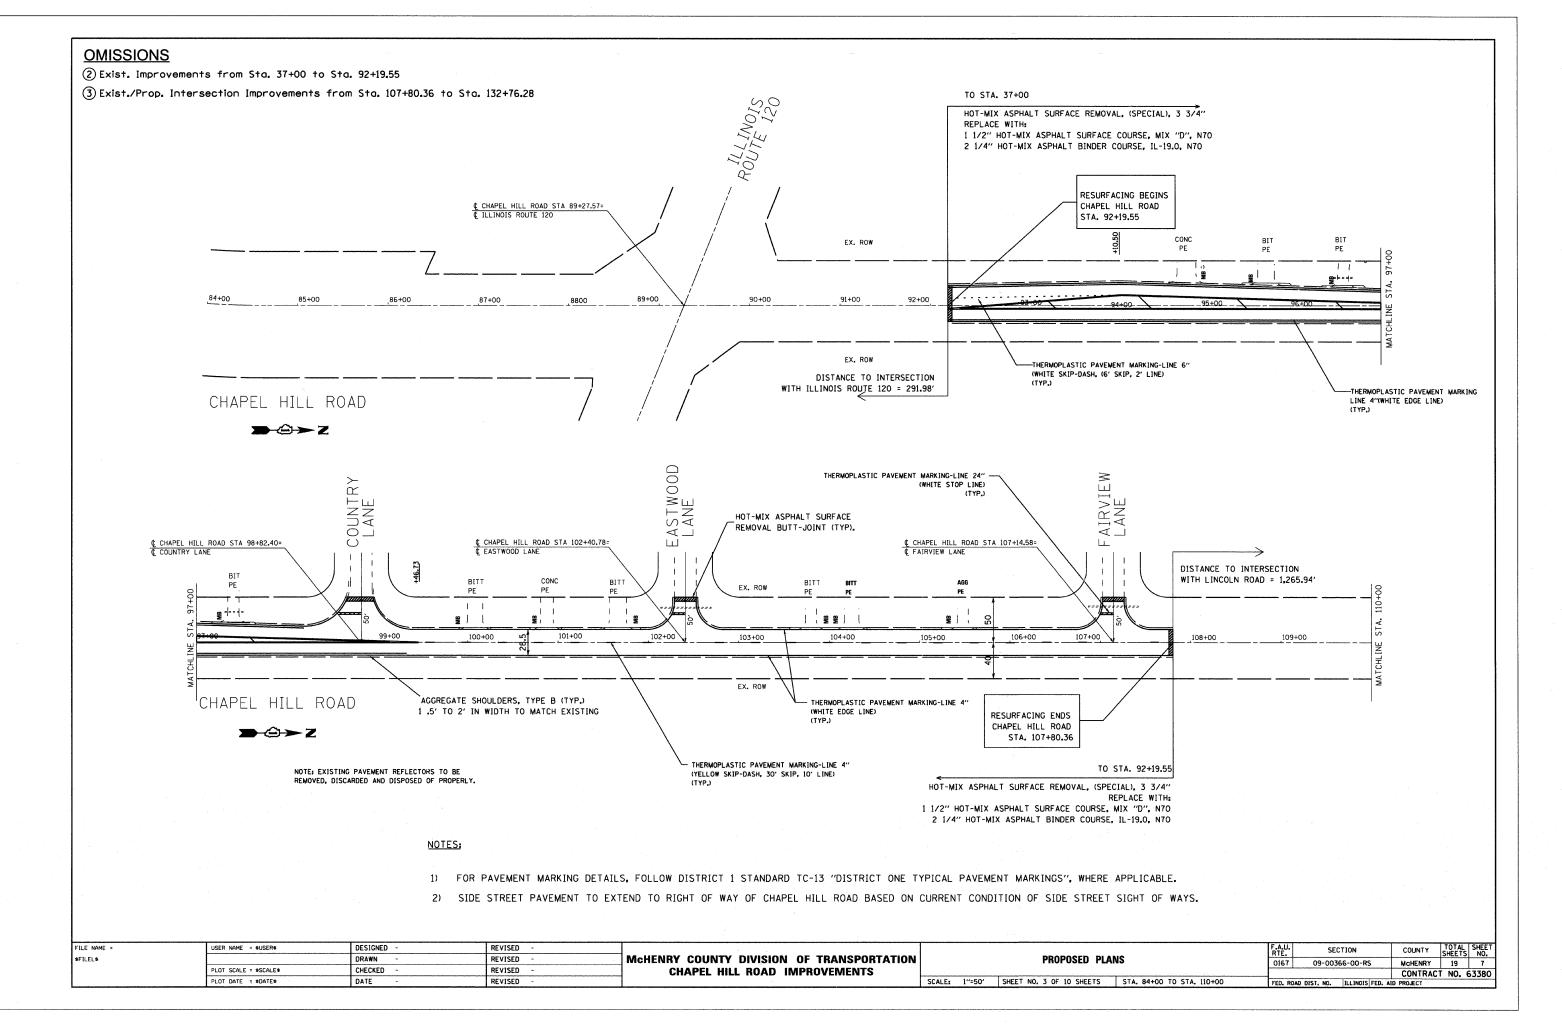

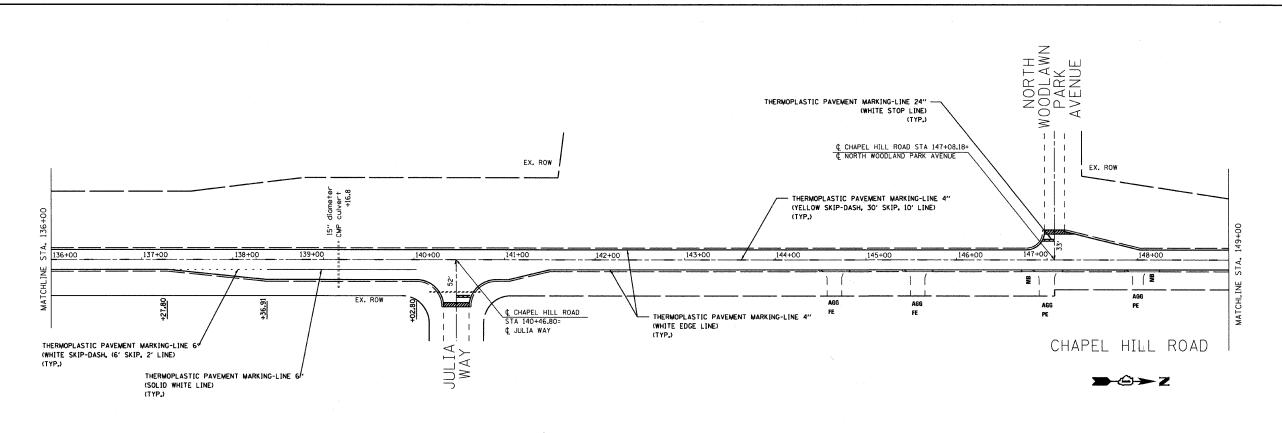


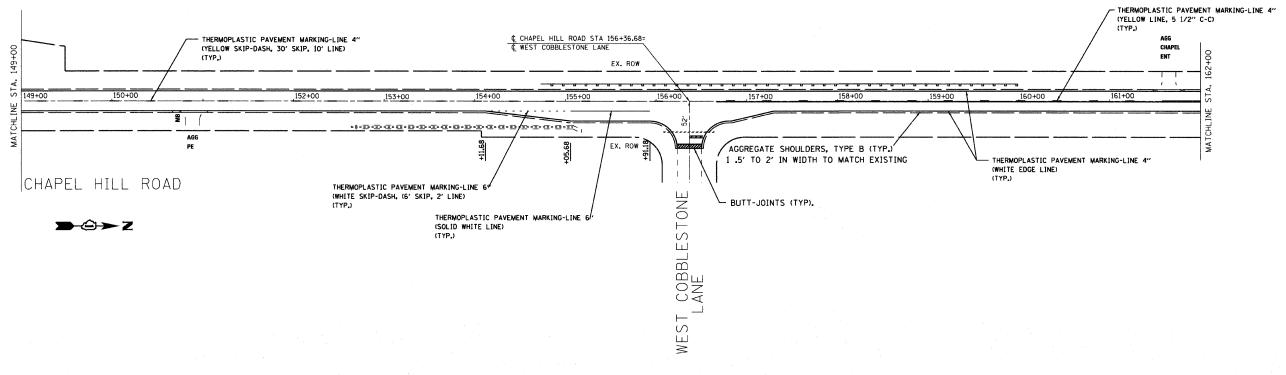


NOTES:

- 1) FOR PAVEMENT MARKING DETAILS, FOLLOW DISTRICT 1 STANDARD TC-13 "DISTRICT ONE TYPICAL PAVEMENT MARKINGS", WHERE APPLICABLE.
- 2) SIDE STREET PAVEMENT TO EXTEND TO RIGHT OF WAY OF CHAPEL HILL ROAD BASED ON CURRENT CONDITION OF SIDE STREET SIGHT OF WAYS.

FILE NAME =	USER NAME = \$USER\$	DESIGNED -	REVISED -				F.A.U.	SECTION	COUNTY	TOTAL SHEET SHEETS NO.
\$FILEL\$		DRAWN ~	REVISED -	McHENRY COUNTY DIVISION OF TRANSPORTATION	PROPOSED PLAN	0167	09-00366-00-RS	MCHENRY	19 9	
	PLOT SCALE = \$SCALE\$	CHECKED -	REVISED -	CHAPEL HILL ROAD IMPROVEMENTS	SCALE: 1"=50" SHEET NO. 5 OF 10 SHEETS STA. 136+00 TO STA. 162+00		10.01	0.5 0.000 0.0		T NO. 63380
	PLOT DATE = \$DATE\$	DATÉ -	REVISED -				STA. 136+00 TO STA. 162+00	FED. ROAD	DIST. NO. ILLINOIS FED. AI	D. AID PROJECT

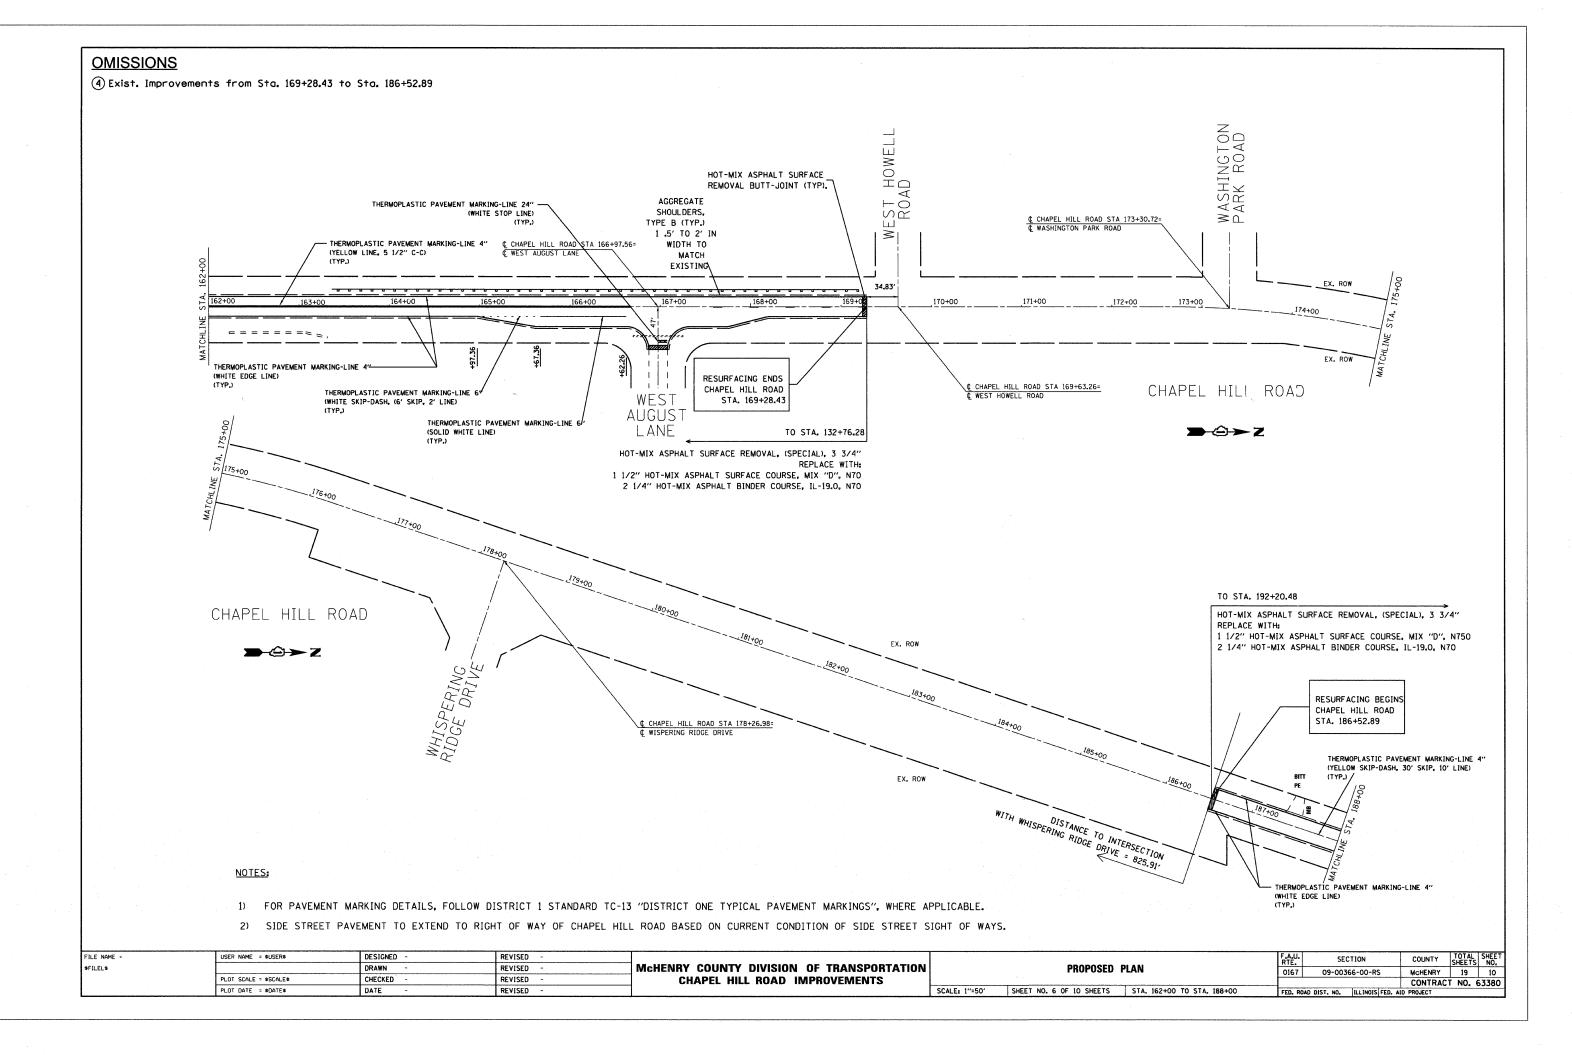

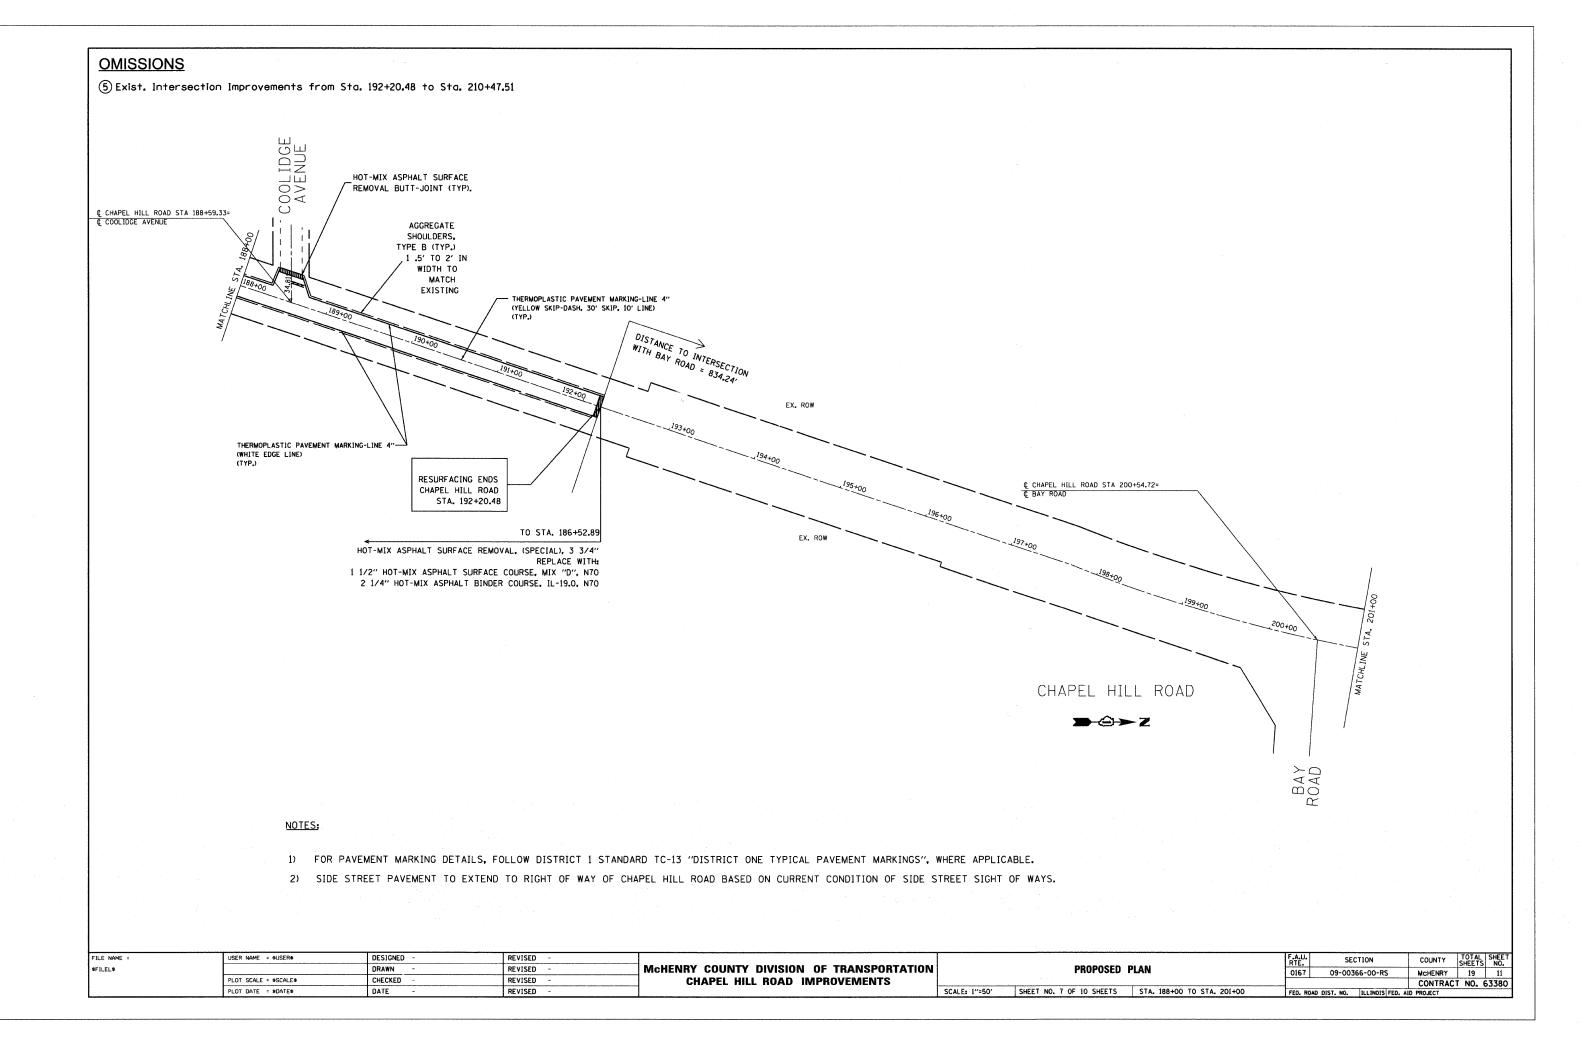

OMISSIONS (5) Exist. Intersection Improvements from Sta. 192+20.48 to Sta. 210+47.51 AGGREGATE SHOULDERS, TYPE B (TYP.) 1 .5' TO 2' IN WIDTH TO MATCH EXISTING THERMOPLASTIC PAVEMENT MARKING-LINE 4 (DOUBLE YELLOW, 11" C-C) (TYP.) CHAPEL HILL ROAD STA 211+23.17= CHARNBROOK DRIVE DISTANCE TO INTERSECTION | THERMOPLASTIC PAVEMENT MARKING-LINE 4 (WHITE EDGE LINE) THERMOPLASTIC PAVEMENT MARKING-LINE 24" (WHITE STOP LINE) (TYP.) HOT-MIX ASPHALT SURFACE REMOVAL BUTT-JOINT (TYP). CHARNBROOK DRIVE 201+00 RESURFACING BEGINS CHAPEL HILL ROAD 204+00 STA. 210+47.51 TO STA. 232+73.66 CHAPEL HILL ROAD HOT-MIX ASPHALT SURFACE REMOVAL, (SPECIAL), 3 3/4" REPLACE WITH: 1 1/2" HOT-MIX ASPHALT SURFACE COURSE, MIX "D", N7O 2 1/4" HOT-MIX ASPHALT BINDER COURSE, IL-19.0, N7O NOTES: 1) FOR PAVEMENT MARKING DETAILS, FOLLOW DISTRICT 1 STANDARD TC-13 "DISTRICT ONE TYPICAL PAVEMENT MARKINGS", WHERE APPLICABLE. 2) SIDE STREET PAVEMENT TO EXTEND TO RIGHT OF WAY OF CHAPEL HILL ROAD BASED ON CURRENT CONDITION OF SIDE STREET SIGHT OF WAYS. COUNTY TOTAL SHEETS NO. MCHENRY 19 12 FILE NAME = USER NAME = \$USER\$ DESIGNED -REVISED SECTION PROPOSED PLAN MCHENRY COUTY DIVISION OF TRANSPORTATION \$FILEL\$ DRAWN REVISED 09-00366-00-RS 0167

CHAPEL HILL ROAD IMPROVEMENTS

SCALE: 1"=50" SHEET NO. 8 OF 10 SHEETS STA. 201+00 TO STA. 214+00

CONTRACT NO. 63380

FED. ROAD DIST. NO. ILLINOIS FED. AID PROJECT

PLOT SCALE = *SCALE*


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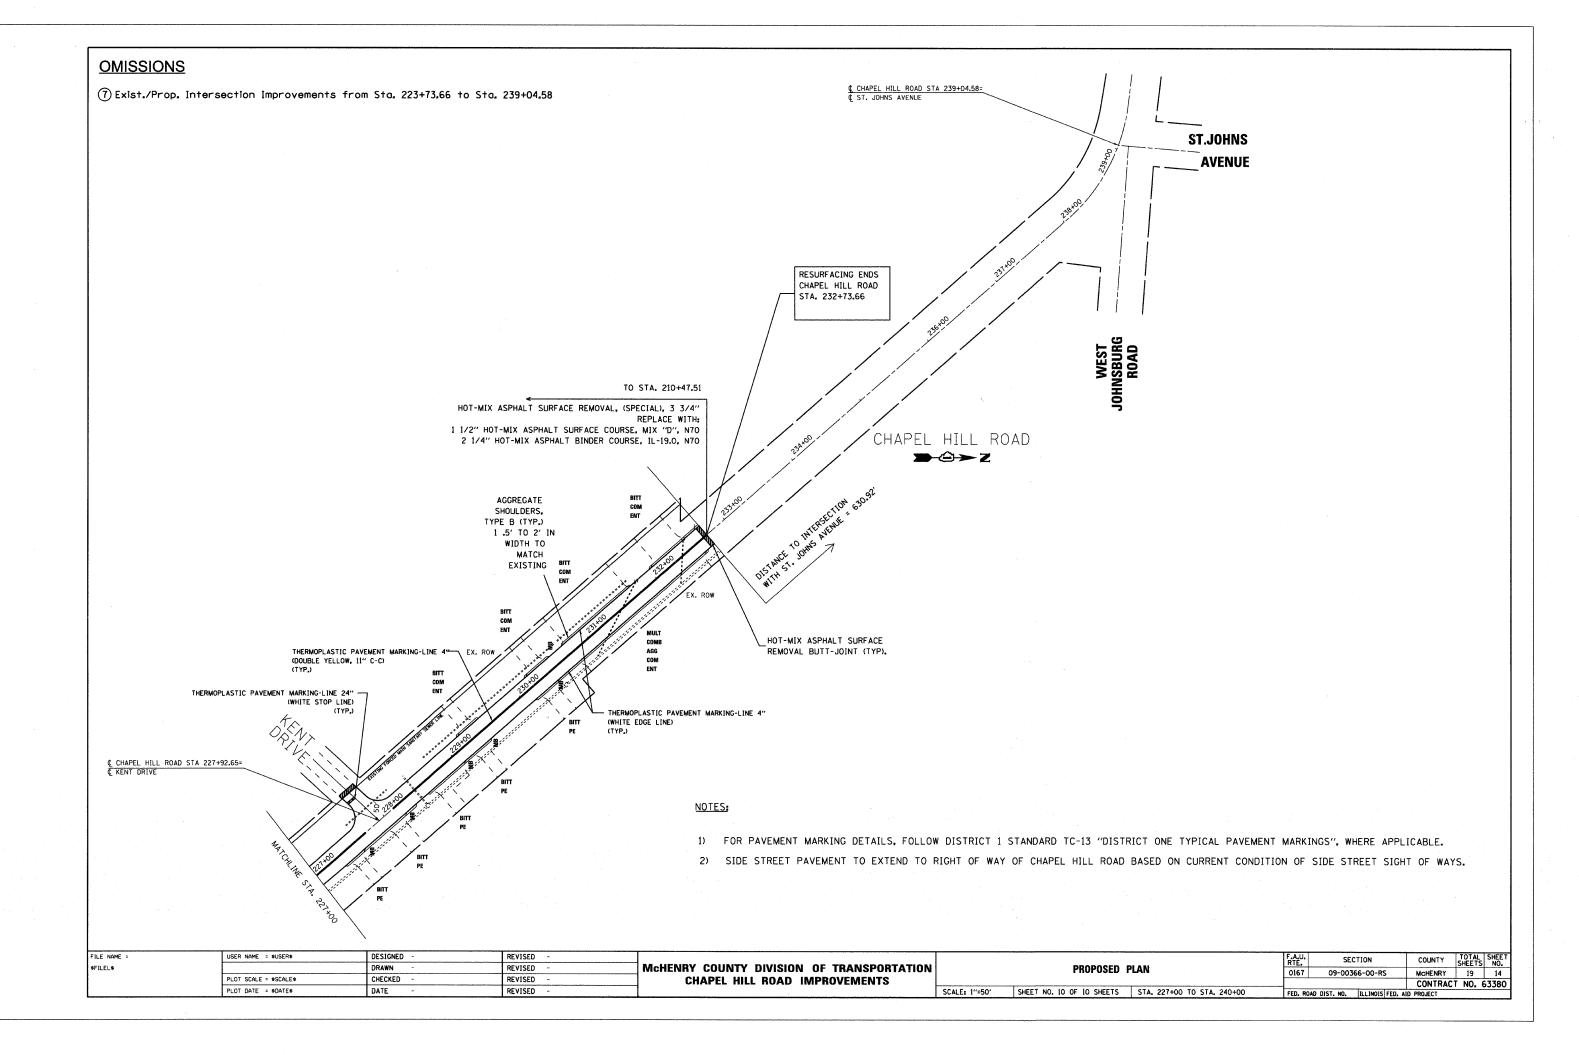
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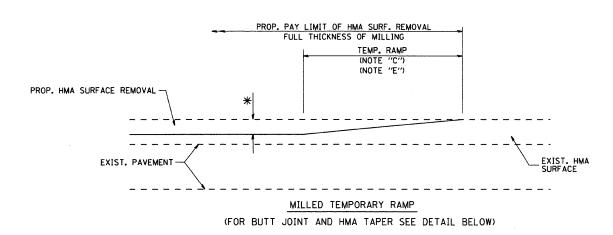
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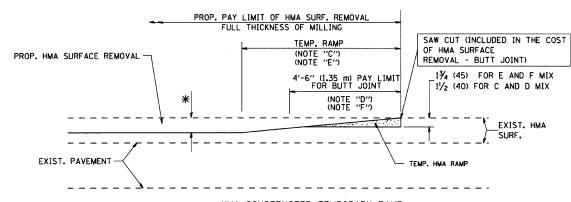
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OPTION 1




HMA CONSTRUCTED TEMPORARY RAMP

(FOR BUTT JOINT AND HMA TAPER SEE DETAIL BELOW)

OPTION 2

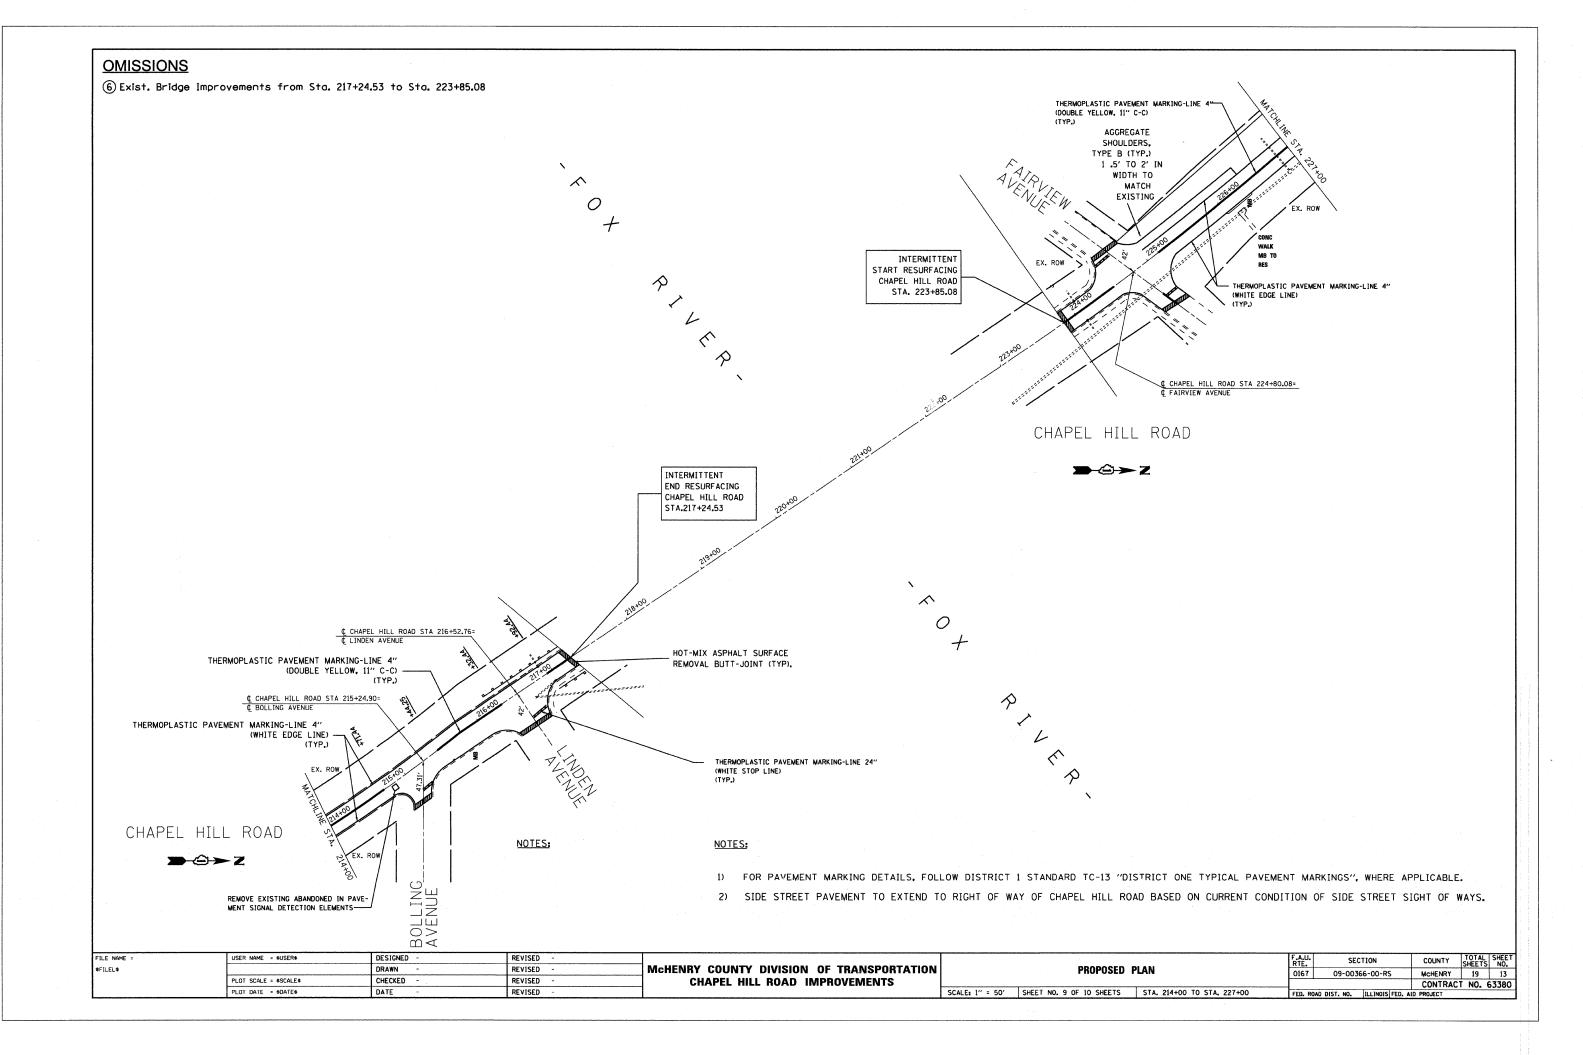TYPICAL TEMPORARY RAMP

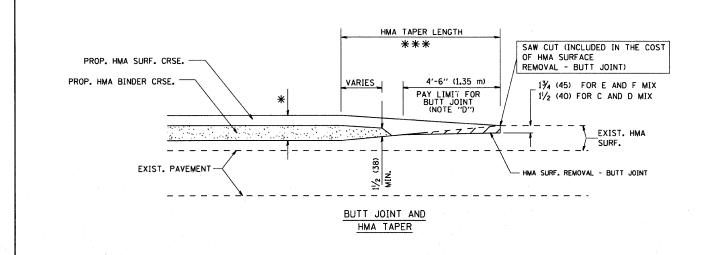

TYPICAL BUTT JOINT AND HMA TAPER FOR MILLING AND RESURFACING


FILE NAME = SUSER NAME = SUSERS DESIGNED - M. DE YONC REVISED - R. SHAH 10-25-94


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| DRAWN - REVISED - A. ABBAS 03-21-97

| PLOT SCALE = SCALES | CHECKED - CHECKED - REVISED | REVISED - M. GOMEZ 04-06-01
| PLOT DATE = SDATES | DATE - 06-13-90 | REVISED - R. BORO 01-01-07

STATE OF ILLINOIS
DEPARTMENT OF TRANSPORTATION



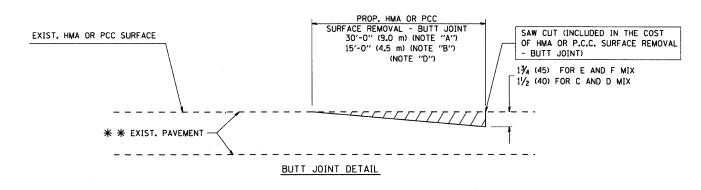

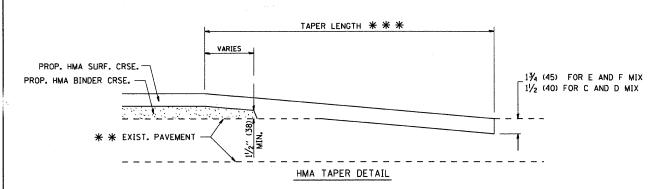TYPICAL BUTT JOINT AND HMA TAPER FOR RESURFACING ONLY

* * PC CONCRETE, HMA OR HMA RESURFACED PAVEMENT.


NOTES

- A: MAINLINE ROADWAYS AND MAJOR SIDE ROADS.
- B: MINOR SIDE ROADS.
- C: THE TEMP. RAMP SHALL BE CONSTRUCTED IMMEDIATELY UPON REMOVAL OF THE EXISTING HMA SURFACE.
- D: THE BUTT JOINT SHALL BE CONSTRUCTED IMMEDIATELY PRIOR TO PLACING THE PROPOSED HMA COURSES.
- E: TAPER THE TEMP. RAMP AT A RATE OF 3'-0" (900 mm) PER 1 INCH (25 mm) OF MILLING THICKNESS.
- F: INSTALLATION AND REMOVAL OF THE 4'-6" (1.35 m) TEMP. RAMP IS INCLUDED IN COST OF HMA SURFACE REMOVAL BUTT JOINT
- G: SEE ARTICLE 406.08 AND 406.14 OF THE STANDARD SPECIFICATIONS FOR "HMA AND/OR PCC SURFACE REMOVAL, BUTT JOINT".
- * SEE TYPICAL SECTIONS FOR MILLING THICKNESS.

BASIS OF PAYMENT:

THE BUTT JOINT WILL BE PAID FOR AT THE CONTRACT UNIT PRICE PER SOUARE YARD (SOUARE METER) FOR "HOT-MIX ASPHALT SURFACE REMOVAL - BUTT JOINT" OR FOR "PORTLAND CEMENT CONCRETE SURFACE REMOVAL- BUTT JOINT".

ALL DIMENSIONS ARE IN INCHES (MILLIMETERS) UNLESS OTHERWISE SHOWN.

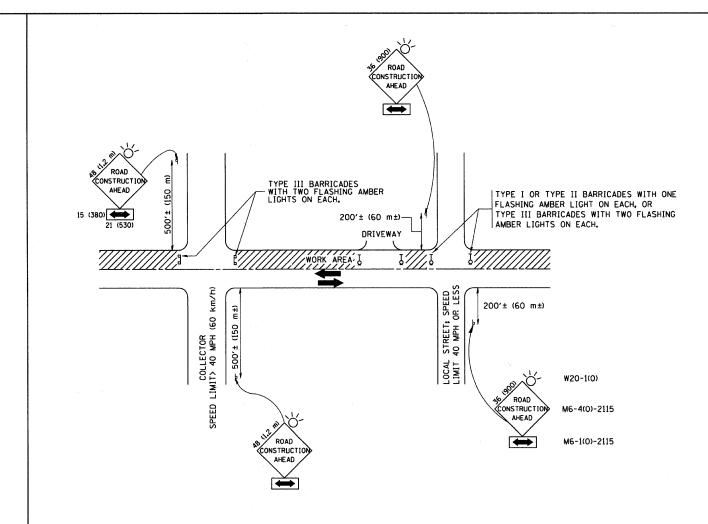

TRAFFIC CONTROL AND PROTECTION FOR SIDE ROADS, INTERSECTIONS, AND DRIVEWAYS

NOTES:

- A. FOR NO LANE RESTRICTION ON THE SIDE ROAD OR DRIVEWAYS
- 1. SIDE ROAD WITH A SPEED LIMIT OF 40 MPH (60 km/h) OR LESS AS SHOWN ON THE DRAWING AND AS DIRECTED BY THE ENGINEER:
- O) ONE ROAD CONSTRUCTION AHEAD SIGN 36 x 36 (900×900) WITH A FLASHER AND FLAG MOUNTED ON IT APPROXIMATELY 200' (60 m) IN ADVANCE OF THE MAIN ROLLIF
- b) THE CLOSED PORTION OF THE MAIN ROUTE SHALL BE PROTECTED BY BLOCKING WITH TYPE I, TYPE II OR TYPE III BARRICADES, 1/3 OF THE CROSS SECTION OF THE CLOSED PORTION.
- 2, SIDE ROAD WITH A SPEED LIMIT GREATER THAN 40 MPH (60 km/h) AS SHOWN ON THE DRAWING AND AS DIRECTED BY THE ENGINEER:
- O) ONE ROAD CONSTRUCTION AHEAD SIGN 48 x 48 (1.2 m x 1.2 m) WITH A FLASHER MOUNTED ON IT APPROXIMATELY 500' (150 m) IN ADVANCE OF THE MAIN POLITE
- b) THE CLOSED PORTION OF THE MAIN ROUTE SHALL BE PROTECTED BY BLOCKING WITH TYPE III BARRICADES, 1/2 OF THE CROSS SECTION OF THE CLOSED PORTION.
- 3. WHEN THE SIDE ROAD LIES BETWEEN THE BEGINNING OF THE MAINLINE SIGNING AND THE WORK ZONE, A SINGLE HEADED ARROW (MG-1) SHALL BE USED IN LIEU OF THE DOUBLE HEADED ARROW (MG-4).

B. FOR A LANE CLOSURE ON A SIDE ROAD OR DRIVEWAY:

USE APPLICABLE PORTIONS OF THE TYPICAL APPLICATION OF TRAFFIC CONTROL DEVICES (STD. 701501, STD. 701606 OR THE APPROPRIATE STANDARD). THE SPACING OF SIGNS AND BARRICADES SHALL BE ADJUSTED FOR FIELD CONDITIONS AS DIRECTED BY THE ENGINEER. THE DIRECTIONAL ARROW SHALL BE COVERED OR REMOVED WHEN NO LONGER CONSISTENT WITH THE SIDE ROAD LANE CLOSURE.

- C. ADVANCE WARNING SIGNS ARE TO BE OMITTED ON DRIVEWAY UNLESS OTHERWISE NOTED.
- D. THE TRAFFIC CONTROL AND PROTECTION FOR SIDE ROADS, INTERSECTIONS, AND DRIVEWAYS SHALL BE INCIDENTAL TO THE COST OF SPECIFIED TRAFFIC CONTROL STANDARDS OR ITEMS.


All dimensions are in millimeters (inches) unless otherwise shown.

FILE NAME =	USER NAME = \$USER\$	DESIGNED - LHA	REVISED - H. OBERLE 10-18-95
\$FILEL\$		DRAWN -	REVISED - A. HOUSEH 03-06-96
	PLOT SCALE = \$SCALE\$	CHECKED -	REVISED - A. HOUSEH 10-15-96
	PLOT DATE = \$DATE\$	DATE - 06-89	REVISED -T. RAMMACHER 01-06-0

STATE OF ILLINOIS DEPARTMENT OF TRANSPORTATION

	TRAFFIC CONTROL AND PROTECTION FOR	F.A.U. RTE.	SECTIO
	SIDE ROADS, INTERSECTIONS, AND DRIVEWAYS	0167	09-00366-0 TC-10
_	SCALE: N.T.S. SHEET NO. 1 OF 1 SHEETS STA. TO STA.	FED. R	DAD DIST. NO. 1 ILL

FED. ROA	AD DIST. NO. 1 ILLINOIS FEE	. AID PRO	JECT			Ī
	TC-10	CON	TRACT	NO. 63	380	
0167	09-00366-00-RS	Mo	CHENRY	19	16	
RTE.	SECTION	С	OUNTY	SHEETS	NO.	

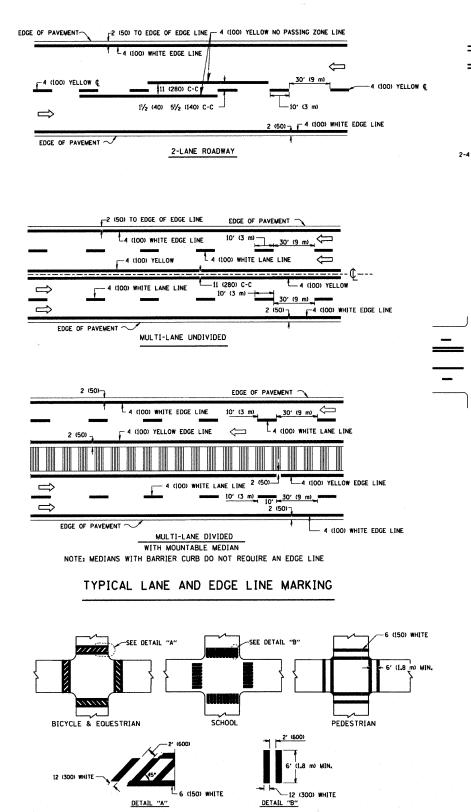


2-4 (100) YELLOW © 11 (280) C-C

NO DIAGONALS

4' (1.2 m) OUTSIDE TO OUTSIDE OF LINES


2-4 (100) YELLOW © 11 (280) C-C

4' (1.2 m) WIDE MEDIANS ONLY

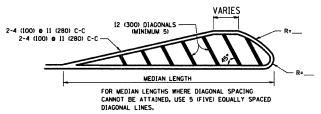


DIAGONAL LINE SPACING: 50' (15 m) C-C (LESS THAN 30MPH (50 km/h))
75' (25 m) C-C 30MPH (50 km/h) TO 45MPH (70 km/h))
150' (45 m) C-C (MORE THAN 45MPH (70 km/h))

MEDIANS OVER 4' (1.2 m) WIDE

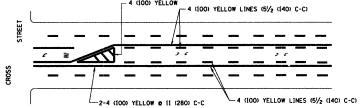


A MINIMUM OF TWO PAIRS OF TURN ARROWS SHALL BE USED, WHITE IN COLOR. ADDITIONAL PAIRS SHALL BE PLACED AT 200' (60 m) TO 300' (90 m) INTERVALS.

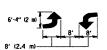

MEDIAN WITH TWO-WAY LEFT TURN LANE

TYPICAL PAINTED MEDIAN MARKING

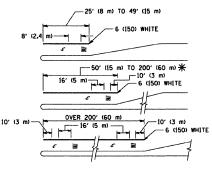


FULL SIZE LETTERS 8' (2.4 m) AND ARROWS SHALL BE USED.

The AREA = 15.6 SO. FT. (1.5 m²) | AREA = 20.8 SO. FT. (1.9 m²)

* TURN LANES IN EXCESS OF 400' (120 m) IN LENGTH MAY HAVE AN ADDITIONAL SET OF ARROW - "ONLY" INSTALLED MIDWAY BETWEEN THE OTHER TWO SETS OF ARROW - "ONLY".

TYPICAL LEFT (OR RIGHT) TURN LANE

TYPICAL TURN LANE MARKING

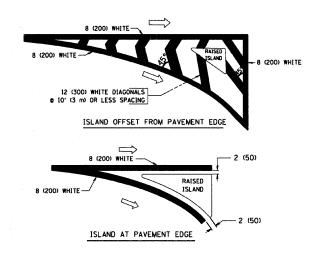

TYPICAL ISLAND MARKING

TYPE OF MARKING	WIDTH OF LINE	PATTERN	COLOR	SPACING / REMARKS
CENTERLINE ON 2 LANE PAVEMENT	4 (100)	SKIP-DASH	YELLOW	10' (3 m) LINE WITH 30' (9 m) SPACE
CENTERLINE ON MULTI-LANE UNDIVEDED PAVEMENT	2 @ 4 (100)	SOLID	YELLOW	11 (280) C-C
NO PASSING ZONE LINES: FOR ONE DIRECTION FOR BOTH DIRECTIONS	4 (100) 2 e 4 (100)	SOLID SOLID	YELLOW YELLOW	5½ (140) C-C FROM SKIP-DASH CENTERLINE 11 (280) C-C OMIT SKIP-DASH CENTERLINE BETWEEN
LANE LINES	4 (100) 5 (125) ON FREEWAYS	SKIP-DASH SKIP-DASH	WHITE WHITE	10' (3 m) LINE WITH 30' (9 m) SPACE
DOTTED LINES (EXTENSIONS OF CENTER, LANE OR TURN LANE MARKINGS)	SAME AS LINE BEING EXTENDED	SKIP-DASH	SAME AS LINE BEING EXTENDED	2' (600) LINE WITH 6' (1.8 m) SPACE
EDGE LINES	4 (100)	SOLID	YELLOW-LEFT WHITE-RIGHT	OUTLINE MOUNTABLE MEDIANS IN YELLOW: EDGE LINES ARE NOT USED NEXT TO BARRIER CURB
TURN LANE MARKINGS	6 (150) LINE; FULL SIZE LETTERS & SYMBOLS (8' (2,4m))	SOLID	WHITE	SEE TYPICAL TURN LANE MARKING DETAIL
TWO WAY LEFT TURN MARKING	2 0 4 (100) EACH DIRECTION	SKIP-DASH AND SOLID	YELLOW	10' (3 m) LINE WITH 30' (9 m) SPACE FOR SKIP-DASH; 5½ (140) C-C BETWEEN SOLID LINE AND SKIP-DASH LINE
	8' (2.4m) LEFT ARROW	IN PAIRS	WHITE	SEE TYPICAL TWO-WAY LEFT TURN MARKING DETAIL
CROSSWALK LINES (PEDESTRIAN) A. DIAGONALS (BIKE & EQUESTRIAN) B. LONGITUDINAL BARS (SCHOOL)	2 e 6 (150) 12 (300) e 45° 12 (300) e 90°	SOLID SOLID SOLID	WHITE WHITE WHITE	NOT LESS THAN 6' (1.8 m) APART 2' (500) APART 2' (500) APART SEE TYPICAL CROSSWALK MARKING DETAILS.
STOP LINES	24 (600)	SOLID	WHITE	PLACE 4' (1.2 m) IN ADVANCE OF AND PARALLEL TO CROSSWALK, IF PRESENT. OTHERWISE, PLACE AT DESIRED STOPPING POINT. PARALLEL TO CROSSROAD CENTERLINE, WHERE POSSIBLE
PAINTED MEDIANS	2 & 4 (100) WITH 12 (300) DIAGONALS	SOLID	YELLOW: TWO WAY TRAFFIC	11 (280) C-C FOR THE DOUBLE LINE
	NO DIAGONALS USED FOR 4' (1.2 m) WIDE MEDIANS		WHITE: ONE WAY TRAFFIC	SEE TYPICAL PAINTED MEDIAN MARKING.
GORE MARKING AND CHANNELIZING LINES	8 (200) WITH 12 (300) DIAGONALS @ 45°	SOLID	WHITE	DIACONALS: 15' (4,5 m) C-C (LESS THAN 30MPH (50 km/h)) 20' (6 m) C-C 30MPH (50 km/h) TO 45MPH (70 km/h)) 30' (9 m) C-C (OVER 45MPH (70 km/h))
RAILROAD CROSSING	24 (600) TRANSVERSE LINES; "RR" IS 6' (1.8 ml LETTERS; 16 (400) LINE FOR "X"	SOLID	WHITE	SEE STATE STANDARD 780001 AREA OF: "R"-3.6 SO. FT. (0.33 m ²) EACH "X"-54.0 SO. FT. (5.0 m ²)
SHOULDER DIAGONALS	12 (300) e 45°	SOLID	WHITE - RIGHT	50' (15 m) C-C (LESS THAN 30MPH (50 km/h)) 75' (25 m) C-C (30 MPH (50 km/h) TO 45MPH (70 km/h)) 1150' (45 m) C-C (0VER 45MPH (70 km/h))

FOR FURTHER DETAILS ON PAVEMENT MARKING REFER TO STANDARD SPECIFICATIONS FOR ROAD AND BRIDGE CONSTRUCTION AND STATE STANDARD 780001.

All dimensions are in inches (millimeters) unless otherwise shown.

FILE NAME =	USER NAME = \$USER\$	DESIGNED -	REVISED -T. RAMMACHER 10-27-94
sFILEL\$		DRAWN -	REVISED -C. JUCIUS 09-09-09
	PLOT SCALE = \$SCALE\$	CHECKED -	REVISED -
	PLOT DATE = \$DATE\$	DATE -	REVISED -


TYPICAL CROSSWALK MARKING


STATE OF ILLINOIS
DEPARTMENT OF TRANSPORTATION

DISTRICT ONE					SECTION	COUNTY	TOTAL SHEETS	SHEET NO.			
	TYPICAL PAVEMENT	0167	09-00366-00-RS	MCHENRY	19	17					
ITFIGAL PAYEMENT MANAINGS					TC-13 CONTRACT NO.						
SCALE: N.T.S.	SHEET NO. 1 OF 1 SHEETS	STA.	TO STA.	FED. ROAD DIST. NO. 1 ILLINOIS FED. AID PROJECT							

SIGNING FOR FLAGGING OPERATIONS AT WORK ZONE OPENINGS

WORK ZONE EXIT OPENING

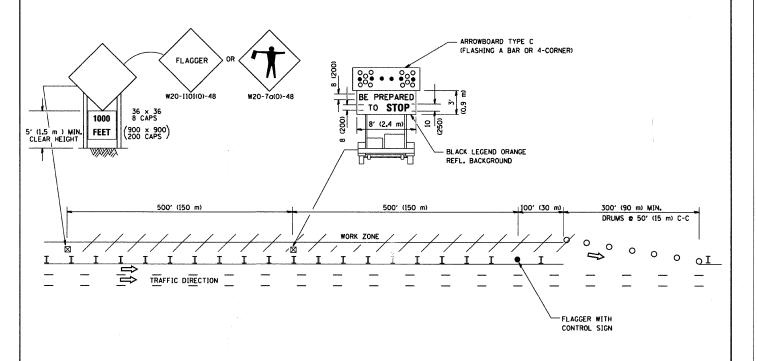

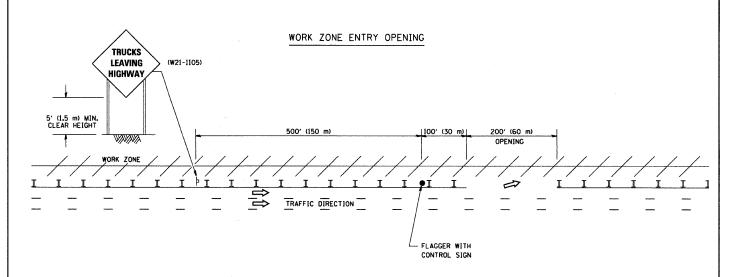

NOTES:


- The Arrowboard, the Flagger Ahead trailer mounted sign, and the Trucks Leaving Highway sign shall be removed or turned away from traffic and the exit and entry openings shall be closed when the flagging operation ceases.
- 2. Work Zone Exit Openings should be a minimum of one half mile apart.
- Exiting the work zone at any place other than at a Work Zone Exit Opening will be prohibited.
- All vehicles shall enter the work zone at entry openings, using their turn signals to warn motorists

ALL DIMENSIONS ARE IN INCHES (MILLIMETERS)
UNLESS OTHERWISE SHOWN

FILE NAME =	USER NAME = \$USER\$	DESIGNED -	REVISED	-	D.W.S. 08-98	
\$FILEL\$		DRAWN -	REVISED	-	J.A.F. 04-03	
	PLOT SCALE = \$SCALE\$	CHECKED -	REVISED	-	J.A.F. 02-06	
	PLOT DATE = \$DATE\$	DATE -	REVISED	-	S.P.B. 01-07	

STATE OF ILLINOIS DEPARTMENT OF TRANSPORTATION

	SIGNING FOR FLAGGING OPERATIONS AT WORK ZONE OPENINGS				SECTION	COUNTY	TOTAL SHEETS	SHEET NO.	
	AT WORK ZONE O	DENINGS		0167	09-00366-00-RS	MICHENRY	19	18	
	AT WORK ZONE OPENINGS				TC-18	CONTRACT	NO. 63	380	
CALE: N.T.S.	SHEET NO. 18 OF 20 SHEETS	STA.	TO STA.	FED. ROA	0167 09-00366-00-RS MCHENRY 19				

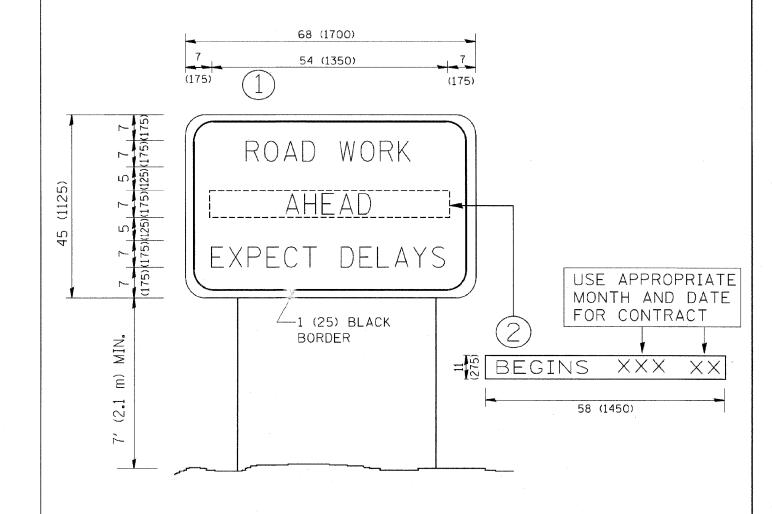

NOTES:

- 1. USE BLACK LETTERING ON ORANGE BACKGROUND.
- 2. ERECT SIGNS IN ADVANCE OF THE LOCATION FOR THE "ROAD CONSTRUCTION AHEAD" SIGN AT LOCATIONS AS DIRECTED BY THE ENGINEER.
- 3. ERECT SIGN (1) WITH INSTALLED PANEL (2) ONE WEEK PRIOR TO THE START OF CONSTRUCTION.
- 4. REMOVE PANEL 2 SOON AFTER THE START OF CONSTRUCTION.
- 5. SEE SPECIAL PROVISION FOR "TEMPORARY INFORMATION SIGNING" FOR ADDITIONAL INFORMATION.
- 6. ONE SIGN ASSEMBLY EQUALS 25.70 SQ. FT. (2.3 SQ. M.)
- 7. SHALL BE PAID FOR AS TEMPORARY INFORMATION SIGNING.

ALL DIMENSIONS ARE IN INCHES (MILLIMETERS)
UNLESS OTHERWISE SHOWN.

FILE NAME =	USER NAME = \$USER\$	DESIGNED -	REVISED - R. MIRS 09-15-97	7				ARTERIAL I	OAD		F.A.U.	SECTION	COUNTY	TOTAL SHEET
\$FILEL\$		DRAWN -	REVISED - R. MIRS 12-11-97		STATE OF ILLINOIS						0167	09-00366-00-RS	MCHENRY	19 19
	PLOT SCALE = \$SCALE\$	CHECKED -	REVISED -T. RAMMACHER 02-02	2-99	DEPARTMENT OF TRANSPORTATION	INFORMATION SIGN			0.01	TC-22	CONTRACT	T NO. 63380		
	PLOT DATE = \$DATE\$	DATE -	REVISED - C. JUCIUS 01-31-	-07	SCALE	SCALE: NONE	SHEET NO. 1 OF	F 1 SHEETS	STA.	TO STA.	FED. ROA	D DIST. NO. 1 ILLINOIS FED. A		