FOR INDEX OF SHEETS, SEE SHEET NO. 2

PROJECT LOCATED IN THE VILLAGE OF ADDISON

STATE OF ILLINOIS

DEPARTMENT OF TRANSPORTATION

DIVISION OF HIGHWAYS

PLANS FOR PROPOSED FEDERAL AID HIGHWAY

F.A.U. ROUTE 2625 MILL ROAD AND F.A.U. ROUTE 3884 ARMY TRAIL BOULEVARD (JOHN F. KENNEDY DRIVE)

STP RESURFACING AND WATER MAIN IMPROVEMENTS


SECTION: 09-00098-00-RS PROJECT NO.: M-9003 (474) JOB NO.: C-91-056-10

DuPage COUNTY

LOCATION MAP

MARILYM

TRAFFIC DATA MILL ROAD POSTED & DESIGN SPEED LIMIT = 30 MPH 2030 ADT - 13,000 VPD COLLECTOR ARMY TRAIL BOULEVARD (JOHN F. KENNEDY DRIVE) POSTED & DESIGN SPEED LIMIT = 30 - 35 MPH 2030 ADT - 21,000 VPD COLLECTOR

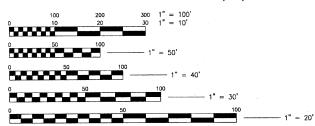

ENGINEERING SCALES. REDUCED SIZED PLANS WILL NOT



SEC. & 1/4 SEC. NO. = SEC. 20 SE 1/4, SEC. 28 NW 1/4 AND SEC. 29 NE 1/4, T40N-R11E

708.478.2090

Madison, Wisconsin

608.241.5481

PROJECT NUMBER: M-9003 (474)

FAU ROUTE 2625 MILL ROAD END IMPROVEMENTS STA 125+63

BEGIN IMPROVEMENTS STA 198+90

BEGIN IMPROVEMENTS STA 97+00

Burlington, Wisconsin 262.763.7834

Crystal Lake, Illinois 815.459.1260 (OFFICE WHICH PREPARED PLANS)

Consulting Engineers

DeKalb, Illinois



Chicago, Illinois 312.578.0500

630.773.1870


Plainfield, Illinois

815.609.7425

SECTION 09-00098-00-RS 69 FED. ROAD DIST. NO. C-91-056-10 ILLINOIS FED AID PROJECT M-9003(474

*3884 ARMY TRAIL BOULEVARD



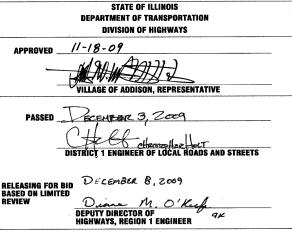

PRINTED BY THE AUTHORITY OF THE STATE OF ILLINOIS

B&W PROJECT NO.: 070142

DATE: 11-17-09

BAXTER & WOODMAN, INC. STATE OF ILLINOIS — PROFESSIONAL DESIGN FIRM LICENSE NO. — 184—001121 — EXPIRES 4/30/2011

FULL SIZE PLANS HAVE BEEN PREPARED USING STANDARD **CONFORM TO STANDARD SCALES. IN MAKING MEASUREMENTS** ON REDUCED SIZE PLANS, THE ABOVE SCALES SHALL BE USED.

J.U.L.I.E. DESIGN STAGE REQUEST DIG. No. 1190755

> CONTACT JULIE AT 811 OR 800-892-0123 COUNTY= DuPAGE CITY-TWNSHP. = ADDISON - ADDISON 48 HOURS(2 working days) BEFORE YOU DIG

Mokena, Illinois

815.787.3111

OAK S

847.223.5088

Itasca, Illinois

CONTRACT NO. 63427

PROJECT NUMBER: M-9003 (474) FAU ROUTE 3884 ARMY TRAIL BOULEVARD

CINIDIATILIN

PROJECT NUMBER: M-9003 (474) **ADDISON TOWNSHIP** FAU ROUTE 2625 GROSS LENGTH OF IMPROVEMENT = 6,200 LIN. FT. OR 1.174 MILES

NET LENGTH OF IMPROVEMENT = 6,200 LIN. FT. OR 1.174 MILES

Crayslake, Illinois

PROJECT NUMBER: M-9003 (474)

FAU ROUTE 3884 ARMY TRAIL BOULEVARD/ JOHN F KENNEDY DR

IN POWER POLE ON THE EAST SIDE OF MILL ROAD AT ENTRANCE TO #353 MILL ROAD APARTMENTS NEAR CREEK CROSSING. ELEVATION = 683.89 В.М. #6-

ON BASE OF TRAFFIC SIGNAL AT THE SOUTHWEST CORNER OF MILL ROAD AND ARMY TRAIL BOULEVARD. (DuPage COUNTY BM) в.м. #10-💠

B.M. #13-ON POWER POLE AT THE NORTHWEST CORNER OF HIGHVIEW BOULEVARD AND ARMY TRAIL BOULEVARD. ELEVATION = 698.01

ON POWER POLE 225 FT EAST OF LINCOLN AVENUE IN THE NORTH PARKWAY OF ARMY TRAIL BOULEVARD. B.M. #16-ELEVATION = 696.04

TOP OF SOUTHWEST CORNER OF SLAB FOR INDIAN TRAIL JUNIOR HIGH SCHOOL SIGN JUST SOUTH OF LAKE STREET ON WEST SIDE OF ARMY TRAIL ROAD.

ELEVATION = 691.61 В.М. #19-ф-

LEGEND

BUTT JOINT OR DRIVEWAY BUTT JOINT

HIGHWAY STANDARDS

	CTANDADD CVAIDOLO ADDDEVIATIONIC AND DATTEDNIC
000001-05	STANDARD SYMBOLS, ABBREVIATIONS AND PATTERNS
280001-05	TEMPORARY EROSION CONTROL SYSTEMS
424001-05	CURB RAMPS FOR SIDEWALK
442201-03	CLASS C AND D PATCHES
602001-01	CATCH BASIN TYPE A
602011-01	CATCH BASIN TYPE C
602301-02	INLET TYPE A
602401-02	MANHOLE TYPE A
602601-02	PRECAST REINFORCED CONCRETE FLAT SLAB TOP
602701-02	MANHOLE STEPS
604001-03	FRAME AND LIDS TYPE 1
604006-04	FRAME AND GRATE TYPE 3
604041-02	FRAME AND GRATE TYPE 9
604051-03	FRAME AND GRATE TYPE 11
604091-02	FRAME AND GRATE TYPE 24
606001-04	CONCRETE CURB TYPE B AND COMBINATION CONCRETE CURB AND GUTTER
606301-04	PC CONCRETE ISLANDS AND MEDIANS
606306-03	CORRUGATED PC CONCRETE MEDIANS
701101-02	OFF-ROAD OPERATIONS, MULTILANE, 15' TO 24" FROM PAVEMENT EDGE
701106-02	OFF-ROAD OPERATIONS, MULTILANE, MORE THAN 15' AWAY
701301-03	LANE CLOSURE, 2L, 2W, SHORT TIME OPERATIONS
701311-03	LANE CLOSURE, 2L, 2W, MOVING OPERATIONS - DAY ONLY
701501-05	URBAN LANE CLOSURE, 2L, 2W, UNDIVIDED
701601-06	URBAN LANE CLOSURE, MULTILANE, 1W OR 2W WITH NONTRAVERSABLE MEDIAN
701701-06	URBAN LANE CLOSURE, MULTILANE INTERSECTION
701801-04	LANE CLOSURE MULTILANE 1W OR 2W CROSSWALK OR SIDEWALK CLOSURE
701901-01	TRAFFIC CONTROL DEVICES
720001-01	SIGN PANEL MOUNTING DETAILS
720006-02	SIGN PANEL ERECTION DETAILS
720021-02	SIGN PANELS EXTRUDED ALUMINUM TYPE
728001-01	TELESCOPING STEEL SIGN SUPPORT
729001-01	APPLICATIONS OF TYPES A & B METAL POSTS (FOR SIGNS & MARKERS)
7810001-02	TYPICAL PAVEMENT MARKINGS
781001-03	TYPICAL APPLICATIONS RAISED REFLECTIVE PAVEMENT MARKERS
886001-01	DETECTOR LOOP INSTALLATIONS
886006-01	TYPICAL LAYOUTS FOR DETECTION LOOPS

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BENCHMARKS AND LEGEND

PROJECT NO: 070142 STA.

*3884 ARMY TRAIL BLVD. *2625 MILL ROAD

TOTAL SHEET NO. 69 2 SECTION COUNTY DuPage 09-00098-00-RS C-91-056-10 CONTRACT NO. 63427 FED. ROAD DIST. NO. 1 | ILLINOIS | FED. AID PROJECT M-9003 (474)

DESIGNED - MWP REVISED - VILLAGE REVIEW 9-08-09 DRAWN - UKB REVISED - VILLAGE REVIEW 11-05-09 CHECKED - RWL REVISED - IDOT REVIEW 11-17-09 DATE - 8-19-09 REVISED -

MILL ROAD AND ARMY TRAIL BOULEVARD STP IMPROVEMENTS

VILLAGE OF ADDISON, ILLINOIS

- 2. THE LOCATIONS OF PUBLIC OR PRIVATE UTILITIES SHOWN ON THE PLANS ARE APPROXIMATE AND THE VILLAGE DOES NOT GUARANTEE THEIR ACCURACY. THE CONTRACTOR SHALL HAVE THE RESPECTIVE UTILITY COMPANIES FIELD LOCATE ALL OF THEIR FACILITIES PRIOR TO BEGINNING CONSTRUCTION. THE CONTRACTOR SHALL ALSO VERIFY THE DEPTHS OF THE EXISTING UTILITIES IF NECESSARY. ANY RELOCATION OR LOWERING OF UTILITIES SHALL BE COORDINATED BY THE CONTRACTOR INCLUDING THE VILLAGE TRAFFIC SIGNAL CONTRACTOR AND STREET LIGHTING CONTRACTOR.
- THE CONTRACTOR SHALL BE RESPONSIBLE FOR THE PROTECTION OF ALL UNDERGROUND OR SURFACE UTILITIES EVEN THOUGH THEY MAY NOT BE SHOWN ON THE PLANS. ANY UTILITY THAT IS DAMAGED DURING CONSTRUCTION SHALL BE REPAIRED OR REPLACED AT THE CONTRACTOR'S EXPENSE TO THE SATISFACTION OF THE ENGINEER OR VILLAGE.
- 4. THE CONTRACTOR SHALL BE RESPONSIBLE FOR ANY DAMAGE OR DESTRUCTION OF PUBLIC OR PRIVATE UTILITIES, AND SHALL REPAIR ANY UTILITIES AT HIS OR HER OWN EXPENSE. COORDINATION OF ALL UTILITY WORK INVOLVED IN THE CONSTRUCTION AREA WILL BE DISCUSSED AT A PRECONSTRUCTION CONFERENCE. THE CONTRACTOR IS RESPONSIBLE FOR THE COORDINATION OF ANY UTILITY RELOCATIONS REQUIRED.
- 5. THE CONTRACTOR SHALL NOTIFY THE VILLAGE OF ADDISON PUBLIC WORKS AT (630) 620-2020 AT LEAST 48 HOURS IN ADVANCE OF BEGINNING WORK AND TO OBTAIN VILLAGE UTILITY LOCATIONS AND SHALL COORDINATE ALL CONSTRUCTION OPERATION WITH THE ENGINEER. SPECIAL ATTENTION IS CALLED TO SECTION 107 OF THE STANDARD SPECIFICATIONS AND THE SPECIAL PROVISIONS FOR TRAFFIC CONTROL AND PROTECTION. THE STORAGE OF EQUIPMENT AND/OR MATERIALS BEYOND LOCATIONS SHOWN IN THE PLANS, SHALL REQUIRE PRIOR APPROVAL OF THE ENGINEER.
- 6. DURING CONSTRUCTION STAGING OPERATIONS, THE ADDISON POLICE AND FIRE DEPARTMENTS SHALL BE NOTIFIED IN WRITING 48 HOURS PRIOR TO MAJOR LANE CLOSURES. EMERGENCY ACCESS SHALL BE ALLOWED AT ALL TIMES. NO OVERNIGHT LANE CLOSURES WILL BE ALLOWED BEYOND THOSE SHOWN IN THE CONSTRUCTION STAGING PLAN.
- 7. MATERIALS RESULTING FROM THE REMOVAL OF PAVEMENT, DRIVEWAYS, CURB AND GUTTER, HOT-MIX ASPHALT SURFACES, ETC. SHALL BE REMOVED AT THE END OF EACH DAY TO AN APPROVED SITE. IN THE JUDGMENT OF THE VILLAGE, SHOULD IT BE NECESSARY FOR VILLAGE PERSONNEL TO REMOVE SUCH MATERIALS. THE VILLAGE WILL HAVE THE MATERIAL REMOVED AND THE CONTRACTOR WILL BE BILLED (CHARGED) ACCORDINGLY.
- 8. THE CONTRACTOR MAY OBTAIN POTABLE MUNICIPAL WATER IN BULK, AT NO CHARGE, AS LONG AS THERE IS NOT A "WATERING BAN" IN EFFECT.
 THE CONTRACTOR MAY OBTAIN NON-POTABLE WATER IN BULK, AT NO CHARGE IF A "WATERING BAN" IS IN EFFECT. THE USE OF FIRE HYDRANTS IS
 STRICTLY PROHIBITED. WATER FOR CONSTRUCTION SHALL BE DISTRIBUTED BY THE VILLAGE. THE CONTRACTOR SHALL PROVIDE THE WATER TRUCK
 AND DRIVER REQUIRED TO OBTAIN AND TRANSPORT THIS WATER. THE VILLAGE RESERVES THE RIGHT TO RESTRICT OR REFUSE THE USE OF
 VILLAGE WATER IF DEEMED NECESSARY.
- 9. IT WILL BE THE CONTRACTOR'S RESPONSIBILITY TO NOTIFY RESIDENTS, BUSINESSES AND THE VILLAGE WHEN ACCESS TO DRIVEWAYS WILL BE TEMPORARILY CLOSED DUE TO CURB AND GUTTER AND/OR DRIVEWAY REPLACEMENT. THE CONTRACTOR SHALL DISTRIBUTE NOTICES PROVIDED BY THE VILLAGE TO RESIDENTS AND BUSINESSES. EVERY EFFORT SHALL BE MADE TO ACCOMMODATE ACCESS TO THESE PROPERTIES INCLUDING KNOCKING ON DOORS WHEN DRIVEWAYS ARE ABOUT TO BE CLOSED.
- 10. THE CONTRACTOR SHALL PROTECT AND CAREFULLY PRESERVE ALL SECTION OR SUBSECTION MONUMENTS OR PROPERTY OR REFERENCE MARKERS UNTIL THE OWNERS, THEIR AGENTS OR AN AUTHORIZED SURVEYOR HAS WITNESSED OR OTHERWISE REFERENCED THEIR LOCATIONS.
- 11. ACCESS TO ALL DRIVEWAYS SHALL BE PROVIDED AT ALL TIMES EXCEPT DURING ACTUAL CONSTRUCTION ADJACENT THERETO. TEMPORARY RAMPS UTILIZING AGGREGATE FOR TEMPORARY ACCESS SHALL BE CONSTRUCTED AS NEEDED TO PROVIDE SUCH ACCESS.
- 12. ANY SIGNS OR MAILBOXES THAT ARE IN CONFLICT WITH THE PROPOSED CONSTRUCTION SHALL BE REMOVED AND REPLACED IN ACCORDANCE WITH VILLAGE STANDARDS AND INCLUDED IN THE EARTH EXCAVATION PAY ITEM. MAIL SERVICE SHALL BE MAINTAINED AT ALL TIMES. ALL SIGNS SHALL BE REINSTALLED TO THE PROPER HEIGHT ACCORDING TO CURRENT VERSION OF THE MANUAL ON UNIFORM TRAFFIC CONTROL DEVICES (M.U.T.C.D.).
- 13. THE CONTRACTOR SHALL PROVIDE A REQUEST FOR MATERIAL TESTING TO THE ILLINOIS DEPARTMENT OF TRANSPORTATION BUREAU OF MATERIALS ORDER BOARD (PHONE (847) 705-4337) BY 4 PM, 24-HOURS IN ADVANCE OF CONSTRUCTION FOR INSPECTION OF ALL HOT-MIX ASPHALT AND CONCRETE MATERIALS USED ON THIS PROJECT.
- 14. EXISTING PAVEMENT, DRIVEWAY PAVEMENT, SIDEWALK AND CURB AND GUTTER TO REMAIN IN PLACE SHALL BE SAW CUT FULL DEPTH TO PROVIDE A NEAT VERTICAL FACE BETWEEN THE PROPOSED AND EXISTING AND SHALL BE INCLUDED IN THE COST OF THE APPROPRIATE REMOVAL PAY ITEM.
- 15. IN AREAS WHERE THE EXISTING DRIVEWAY, SIDEWALK OR CURB AND GUTTER IS TO BE REMOVED AND REPLACED, THE REMOVAL AND DISPOSAL OF ANY ADDITIONAL MATERIAL REQUIRED TO ESTABLISH THE PROPOSED DRIVEWAY, SIDEWALK OR CURB AND GUTTER SUBGRADE ELEVATION SHALL BE INCLUDED IN THE PAY ITEMS, DRIVEWAY PAVEMENT REMOVAL, SIDEWALK REMOVAL OR COMBINATION CONCRETE CURB AND GUTTER REMOVAL AND REPLACEMENT
- 16. ALL AGGREGATE USED ON THIS PROJECT SHALL BE CRUSHED MATERIAL.
- 17. THE CURB SHALL BE TAPERED TO THE GUTTER IN A THREE (3) FOOT LENGTH WHATEVER THE CURB AND GUTTER TERMINATES, WITH AN EXPANSION JOINT PLACED AT THE START OF THE TAPER.
- 18. CURB AND GUTTER SHALL BE DEPRESSED AT DRIVEWAYS AND SIDEWALK RAMPS IN ACCORDANCE WITH THE IDOT HIGHWAY STANDARDS. SIDEWALK RAMPS FOR ACCESS FOR THE DISABLED SHALL BE PROVIDED AT THE PROPOSED CROSSWALKS IN ACCORDANCE WITH THE IDOT HIGHWAY STANDARDS OR AS DETERMINED BY THE ENGINEER.
- 19. THE FINISHED HOT-MIX ASPHALT SURFACE SHALL BE CONSTRUCTED 0.25 INCH ABOVE THE GUTTER FLAG.
- 20. THE CONTRACTOR SHALL PROVIDE AND INSTALL TWO (2) WEIGHTED SANDBAGS ON EACH TYPE I OR TYPE II BARRICADE USED. ONE (1) WEIGHTED SANDBAG SHALL BE PLACED ACROSS EACH BOTTOM RAIL. ALL FLASHERS SHALL BE IN WORKING ORDER.
- 21. THE DAYS PAVING OPERATION SHOULD RESULT IN A SINGLE TRANSVERSE JOINT. ANY COLD LONGITUDINAL JOINTS WILL NOT BE ACCEPTED. PROVIDING A SINGLE TRANSVERSE JOINT SHALL BE ACCOMPLISHED BY PAVING ONE LANE OF SUFFICIENT LENGTH THAT WILL ALLOW FOR THE PAVING OF THE ADJACENT LANE IN THE SAME DAY.
- 22. A 1/2-INCH THICK EXPANSION JOINT SHALL BE PROVIDED AT THE JUNCTION OF THE DRIVEWAY APRON AND CURB AND AT THE JUNCTION OF THE DRIVEWAY APRON AND THE SIDEWALK DRIVEWAY REPLACEMENT PAY ITEM.
- 23. ALL POSTS, RAILROAD TIES, AND DECORATIVE TIMBER CONFLICT WITH THE PROPOSED IMPROVEMENTS SHALL BE REMOVED AND RELOCATED AS DETERMINED BY THE ENGINEER AT THE TIME OF CONSTRUCTION AND SHALL BE INCLUDED IN THE COST OF THE CONTRACT. EVERY EFFORT SHALL BE MADE BY THE CONTRACTOR WHEN REMOVING THESE ITEMS TO PRESERVE THEM FROM DAMAGE. ITEMS NOT RELOCATED SHALL BE PROPERLY DISPOSED OF BY THE CONTRACTOR.



- 24. FRAME ELEVATIONS GIVEN ON THE PLANS ARE ONLY TO ASSIST THE CONTRACTOR IN DETERMINING THE APPROXIMATE OVERALL HEIGHT OF THE STRUCTURE. FRAMES ON ALL NEW STRUCTURES SHALL BE ADJUSTED IN THE FINAL ELEVATION OF THE AREA IN WHICH THEY ARE LOCATED AS PART OF COST OF THE CONSTRUCTION.
- 25. A PORTABLE TOILET SHALL BE PLACED ON THE JOB SITE AND RELOCATED WHEN NECESSARY SO IT IS ACCESSIBLE TO WORKERS. IF WORK IS OCCURRING AT SEVERAL LOCATIONS, ONE PORTABLE TOILET SHALL BE PLACED AT EACH LOCATION WITHIN A REASONABLE DISTANCE FROM THE WORK AS DETERMINED BY THE ENGINEER. THIS SHALL BE INCLUDED IN THE PAY ITEM FOR MOBILIZATION.
- 26. PORTLAND CEMENT CONCRETE SIDEWALK SHALL BE THICKENED TO 6-INCHES AT LOCATIONS WHERE THE SIDEWALK CROSSES PRIVATE DRIVEWAYS AND 8-INCHES AT LOCATIONS WHERE THE SIDEWALK CROSSES COMMERCIAL DRIVEWAYS. TRANSVERSE EXPANSION JOINTS 3/4" SHALL BE PLACED EVERY 50 FEET OR AS DETERMINED BY THE ENGINEER. TRANSVERSE CONTRACTION JOINTS SHALL BE PLACED EVERY 5-FEET. INSTALL ON A 3" AGGREGATE BASE COURSE. ALL THE ABOVE SHALL BE INCLUDED IN THE PORTLAND CEMENT CONCRETE SIDEWALK 5 INCH PAY ITEM.
- 27. ANY DAMAGE DONE TO THE WATER MAIN, WATER SERVICES, SANITARY SEWER, OR SANITARY SEWER SERVICES NOT CONSIDERED IN CONFLICT WITH THE PROPOSED STORM SEWER SHALL BE REPAIRED BY THE CONTRACTOR AT NO ADDITIONAL EXPENSE.
- 28. CONNECTION OF PROPOSED STORM SEWER INTO EXISTING STORM SEWER OR EXISTING STORM SEWER STRUCTURES SHALL BE INCLUDED IN THE COST OF STORM SEWERS.
- 29. IF ANY STORM SEWER LATERALS ARE FOUND DURING CONSTRUCTION AND ARE NOT IDENTIFIED ON THE PLANS, THEY SHALL BE CONNECTED TO THE PROPOSED STORM SEWER SYSTEM AND INCLUDED IN THE COST OF THE STORM SEWER CONSTRUCTION.
- 30. STORM STRUCTURE OFFSET LOCATIONS ARE TO THE EDGE OF PAVEMENT IF THE STRUCTURE IS IN THE CURB LINE OR TO THE CENTER OF STRUCTURE IF THE STRUCTURE IS NOT IN THE CURBLINE.
- 31. IN ALL TRENCHES CROSSING DRIVEWAYS, SIDEWALKS, AND ALL PROPOSED AND EXISTING ROADWAYS, THE MATERIAL FOR THE TOP 12 INCHES SHALL BE CA-6 CRUSHED GRAVEL OR CRUSHED STONE AND BE INCLUDED IN THE PAY ITEM FOR TRENCH BACKFILL (SPECIAL). THE BACKFILL SHALL EXTEND TO AND BE MEASURED FOR PAYMENT TO THE EXISTING GROUND OR SURFACE ELEVATION.
- 32. THE PRIME COAT APPLICATION RATE SHALL BE APPROXIMATELY 0.1 GAL/S. THE MC-30 PRIME COAT APPLICATION RATE SHALL BE APPROXIMATELY 0.3 GAL/SY.
- 33. FOR STEEL BARS CERTIFICATION, PLEASE CONTACT IDOT BUREAU OF MATERIALS AT (847) 705-4337.
- 34. ALL OPEN TRENCHES SHALL BE FILLED AT THE END OF EACH DAY.
- 35. SUPPLEMENTAL WATERINGS MAY BE REQUIRED BEYOND THE FINAL COMPLETION DATE TO ENSURE SURVIVAL OF THE PROPOSED SEEDING RESTORATION. SAID WATERINGS SHALL BE COMPLETED IN THE MORNING OR EVENING HOURS AND SHALL BE COMPLETED AS DETERMINED BY THE VILLAGE OR ENGINEER.
- 36. THE CONTRACTOR WILL ONLY BE ALLOWED TO REMOVE AND REPLACE CURB AND GUTTER ON ONE SIDE OF THE ROAD AT A TIME TO MINIMIZE CONGESTION. REPLACEMENT MUST BE COMPLETE ON ONE SIDE OF THE ROAD BEFORE THE CONTRACTOR IS ALLOWED TO BEGIN REMOVING CURB AND GUTTER ON THE OTHER SIDE OF THE ROAD.
- 37. COMBINATION CONCRETE CURB AND GUTTER REMOVAL AND REPLACEMENT SHALL INCLUDE THE FOLLOWING; INSTALLATION OF TWO NO. 4 (1/2-INCH) REINFORCING BARS EXTENDING 5-FEET BEYOND ANY TRENCHES; SAW-CUTTING AND REMOVING THE EXISTING PAVEMENT MINIMUM OF 6-INCHES MEASURED FROM THE EXISTING EDGE OF PAVEMENT; FILLING THE 6" GAP WITH CLASS SI CONCRETE TO AN ELEVATION 4-1/2" BELOW THE PROPOSED CURB AND GUTTER FLAG, RESTORING DAMAGED PARKWAY, SEALING JOINTS WITH EITHER HOT-POURED. OR COLD-POURED JOINT SEALER AND PAINTING REPLACEMENT CURB AND GUTTER AT LOCATIONS WHERE THE EXISTING WAS PAINTED. IF THE CONCRETE IS PLACED HIGHER THAN 4-1/2" FROM THE GUTTER FLAG FOR STREETS TO BE RESURFACED, THE CONTRACTOR WILL BE REQUIRED TO GRIND ADDITIONAL CONCRETE TO THE REQUIRED 4-1/2" DEPTH. THE 6" WIDE BY 1/4" HIGH VOID BETWEEN THE GUTTER FLAG AND THE MILLED PAVEMENT SHALL BE FILLED WITH HOT-MIX ASPHALT PAVEMENT DURING RESURFACING OPERATIONS. THIS WORK SHALL BE INCLUDED IN THE COMBINATION CONCRETE CURB AND GUTTER REMOVAL AND REPLACEMENT PAY ITEM.
- 38. PORTIONS OF EXISTING PORTLAND CEMENT CONCRETE (INCLUDING CONCRETE MEDIAN AND CURB AND GUTTER) WITHIN THE PROJECT LIMITS
 ARE PAINTED. IF PAINTED PORTLAND CEMENT CONCRETE REQUIRES REMOVAL AND REPLACEMENT, THE REPLACEMENT PORTLAND CEMENT
 CONCRETE SHALL BE PAINTED TO MATCH THE COLOR OF THE PORTLAND CEMENT CONCRETE REMOVED. SAMPLES OF THE PAINT SHALL BE
 PROVIDED TO THE ENGINEER PRIOR TO APPLICATION TO ENSURE COMPLIANCE WITH THE MANUFACTURES RECOMMENDATIONS. NO PAINTING
 SHALL OCCUR UNTIL THE PAINT AND APPLICATION IS APPROVED BY THE ENGINEER. PAINTING SHALL BE INCLUDED IN THE REPLACEMENT PAY
 ITEM.
- 39. AT THE PRECONSTRUCTION CONFERENCE, THE CONTRACTOR SHALL FURNISH TWO (2) 24-HOUR CONTACT NAMES AND TELEPHONE NUMBERS, ONE PRIMARY AND ONE SECONDARY.
- 40. SAW CUTS MADE IN THE EXISTING PAVEMENT TO REMAIN FOR CONSTRUCTING UTILITIES SHALL BE INCLUDED IN CLASS D PATCHES.
- 41. RESERVED
- 42. ON STREETS TO BE FULL WIDTH MILLED (2" OR MORE), THE STRUCTURES IN THE PAVEMENT SHALL BE ADJUSTED. IN ACCORDANCE WITH THE HOOT DETAIL "DETAILS FOR FRAMES AND LIDS ADJUSTMENT WITH MILLING". THIS WORK SHALL BE PAID FOR AT THE CONTRACT UNIT PRICE FOR FRAMES AND LIDS TO BE ADJUSTED (SPECIAL).
- 43. THE CONTRACTOR SHALL UTILIZE A MECHANICAL SWEEPER TO CLEAN STREETS AFFECTED BY THE CONTRACTORS OPERATIONS, INCLUDING
 HAUL ROUTES, AT LEAST TWICE PER WEEK AND ADDITIONALLY AS DETERMINED BY THE ENGINEER. THIS WORK SHALL BE INCLUDED IN THE
 MOBILIZATION PAY ITEM.
- 44. A MINIMUM OF 7 WORKING DAYS PRIOR TO THE DETECTION REMOVAL THE CONTRACTOR SHALL NOTIFY THE VILLAGE TRAFFIC SIGNAL AND
 MAINTENANCE AND OPERATIONS ENGINEER AND THE VILLAGE ELECTRICAL MAINTENANCE CONTRACTOR AT WHICH TIME ARRANGEMENTS WILL BE
 MADE TO ADJUST THE TRAFFIC CONTROLLER TIMING TO COMPENSATE FOR THE ABSENCE OF DETECTION. THIS WORK SHALL BE INCLUDED
 IN THE COST OF CONSTRUCTION.

*3884 ARMY TRAIL BLVD.

V-VUDIVA VAVOT42-ANMY TRAIL-MILL LAFP & WATEK MAIN V-ADUAotted: 11/30/2009 8:32 AM By: 560KAR

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cense No. — 184-001121 — Expires 4—30—1:

- TEMPORARY EROSION CONTROL MEASURES SHALL BE INSTALLED AS REQUIRED. WHERE PARKWAYS ARE DISTURBED, TEMPORARY EROSION CONTROL MEASURES SHALL BE ESTABLISHED WITHIN 14 DAYS OF THE COMPLETION OF DISTURBANCE AND MAINTAINED TO THE SATISFACTION OF THE VILLAGE. THIS WORK, INCLUDING MAINTENANCE, SHALL BE INCLUDED IN THE TEMPORARY EROSION CONTROL SEEDING; MULCH
- 46. TEMPORARY PAVEMENT (6") SHALL BE INSTALLED AT LOCATIONS OPEN TO THRU TRAFFIC AND INTERSECTIONS AT THE END OF EACH DAY. MILLING OPERATIONS WILL REDUCE THE THICKNESS OF THE TEMPORARY PAVEMENT TO 1 1/2-INCHES. THE CONTRACTOR IS RESPONSIBLE TO INSPECT THE TEMPORARY PAVEMENT AS THE MILLING OPERATIONS OCCUR TO ENSURE THE TEMPORARY PAVEMENT IS SATISFACTORY FOR TRAFFIC. THE CONTRACTOR SHALL CONTINUE TO INSPECT AND MAINTAIN THE TEMPORARY PAVEMENT UNTIL THE PERMANENT PAVEMENT PATCH IS INSTALLED. ANY AND ALL MAINTENANCE TO THE TEMPORARY PAVEMENT SHALL BE COMPLETED IMMEDIATELY AND INCLUDED IN THE TEMPORARY PAVEMENT PAY ITEM.
- 47. WORK AND MATERIALS REQUIRED TO INSTALL 1-INCH UNIT DUCT SHALL BE INCLUDED IN THE PAY ITEM DETECTOR LOOP REPLACEMENT.
- 48. FRAME AND GRATES OR LIDS THAT ARE REPLACED AS PART OF ADJUSTMENT OR RECONSTRUCTION. OR REMOVED AS PART OF STRUCTURE REPLACEMENT, SHALL BE DELIVERED TO THE VILLAGE PUBLIC WORKS FACILITY. THIS WORK SHALL BE INCLUDED IN THE STRUCTURE ADJUSTMENT, STRUCTURE RECONSTRUCTION OR STRUCTURE REMOVAL PAY ITEM.
- 49. COORDINATE WITH UTILITY COMPANIES TO SUPPORT, PROTECT, OR REMOVE AND REPLACE ALL POWER POLES OR POLE ANCHORS THAT ARE EFFECTED BY THE CONSTRUCTION, EVEN WHERE SUPPORTS ARE NOT INDICATED ON THE DRAWINGS. THE COST OF THIS WORK IS INCLUDED IN THE COST OF THE CONTRACT.
- 50. DO NOT STORE MATERIALS, STRUCTURES, OR MACHINES WHERE THEY WILL OBSTRUCT STREET CROSSING OR DRIVEWAY SIGHTLINES.
- 51. ELEVATIONS SHALL BE ADJUSTED TO FINAL GRADE AT THE TIME OF FINAL PAVING OR LANDSCAPING. ADJUSTMENT OF NEW STRUCTURES TO FINAL GRADE IS INCLUDED IN THE NEW STRUCTURE PAY ITEM, REGARDLESS OF THE NUMBER OF TIMES THE ADJUSTMENTS MUST BE MADE.
- 52. ALL WATER MAIN MUST BE WRAPPED WITH POLYETHYLENE WRAPPING. WRAPPING IS INCLUDED IN THE WATER MAIN PAY ITEM
- 53. WATER MAIN MUST BE INSTALLED DEEPER THAN STANDARD IN SEVERAL LOCATIONS. DEEPER INSTALLATION IS CONSIDERED INCLUDED IN THE ITEM BEING INSTALLED, INCLUDING WATER MAIN, VALVE VAULTS, OR FIRE HYDRANTS. IN SOME AREAS NEW WATER MAIN WILL CROSS BELOW EXISTING MAINS AND IN SOME AREAS ABOVE EXISTING MAINS.
- 54. ALL FITTINGS AND VALVES SHALL HAVE RESTRAINED JOINTS WITH LOK-RING JOINTS BY AMERICAN CAST IRON PIPE, TR-FLEX OR FIELD LOK BY U.S. PIPE, MEG-A-LUGS BY EBAA IRON, OR APPROVED EQUAL. ALL WATER MAIN AND MATERIALS SHALL BE MADE IN THE UNITED STATES OF AMERICA. UNLESS OTHERWISE ON THE DRAWINGS, THE PIPE JOINT ADJACENT TO, AND ON EACH SIDE OF, A FITTING OR VALVE SHALL ALSO BE A RESTRAINED JOINT. THE DRAWINGS SHOW ADDITIONAL RESTRAINED JOINT PIPE TO BE INSTALLED AT THE LOCATIONS OF BEND FITTINGS.
- 55. THE CONTRACTOR SHALL BE RESPONSIBLE FOR LOCATING LAWN SPRINKLER SYSTEMS PRIOR TO REMOVAL AND/OR EXCAVATION OPERATIONS. ANY DAMAGE TO THE SYSTEMS SHALL BE REPAIRED BY THE CONTRACTOR AT NO ADDITIONAL COST TO THE CONTRACT
- ALL FRAMES WITH CLOSED LIDS TO BE FURNISHED AS PART OF THIS CONTRACT FOR CONSTRUCTION, ADJUSTMENT OR RECONSTRUCTION OF ANY MANHOLES, CATCH BASIN, INLET, VALVE VAULT, OR METER VAULT SHALL HAVE CAST INTO THE LID ONE OF THE FOLLOWING WORDS: ALL LIDS TO BE USED ON SANITARY SEWER STRUCTURES SHALL BEAR THE WORD "SANITARY". ALL THE LIDS TO BE USED ON WATER SYSTEM STRUCTURES SHALL BEAR THE WORD "WATER". ALL OPEN GRATES SHALL INCLUDE THE WORDS "DUMP NO WASTE, DRAINS TO WATERWAYS". THIS WORK WILL NOT BE PAID FOR SEPARATELY, BUT SHALL BE CONSIDERED INCIDENTAL TO THE FRAME AND GRATE OR FRAME AND CLOSED LID PROVIDED.

- 57. "DFW" NON-SHEAR" COUPLINGS AS MANUFACTURED BY NDS COMPANY OR APPROVED EQUAL SHALL BE USED FOR CONNECTIONS OF NEW PIPE TO EXISTING PIPE, AND WHERE DISSIMILAR PIPE AND JOINT MATERIALS ARE ENCOUNTERED. COUPLINGS SHALL BE A MINIMUM OF 8 INCHES LONG FOR CONNECTIONS OF 4-INCHES THROUGH 8-INCH PIPE AND A MINIMUM OF 12 INCHES LONG FOR CONNECTIONS ON LARGER PIPES (THESE ARE SPECIAL ORDER ITEMS). NO STAINLESS STEEL SHEAR RINGS WILL BE ALLOWED. THIS WORK WILL NOT BE PAID FOR SEPARATELY, BUT SHALL BE INCIDENTAL TO THE CONTRACT.
- 58. TEMPORARY FENCE SHALL BE ERECTED ALONG THE LIMITS OF THE CRITICAL ROOT ZONE OF TREES TO REMAIN WITHIN THE LIMITS OF CONSTRUCTION UNLESS OTHERWISE DETERMINED BY THE ENGINEER. AFTER TREES ARE SAFELY FENCED NOTHING IS TO BE STORED, DRIVEN OR DISTURBED INSIDE THE FENCE. REMOVE PROTECTIVE TEMPORARY FENCE ONLY AFTER ALL CONSTRUCTION WORK HAS BEEN COMPLETED.
- 59. CURB AND GUTTER AND DRIVEWAYS PROVIDING ACCESS SHALL BE REMOVED AND REPLACED WITHIN 3 DAYS.
- 60. REMOVAL AND REPLACEMENT OF CURB AND GUTTER AND DRIVEWAYS PROVIDING ACCESS FOR COMMERCIAL OR MULTIFAMILY DWELLINGS SHALL BE STAGED TO MAINTAIN CONTINUOUS ACCESS.
- THE CONTRACTOR MAY CONSIDER USING HIGH-EARLY STRENGTH CONCRETE FOR ALL CONCRETE CONSTRUCTION. THE USE OF HIGH-EARLY STRENGTH CONCRETE SHALL BE INCLUDED IN THE COST OF THE APPLICABLE CONCRETE PAY ITEM.
- 62. AGGREGATE BASE COURSE LESS THAN OR EQUAL TO 4 INCHES IN THICKNESS SHALL BE INCLUDED IN THE PORTLAND CEMENT CONCRETE DRIVEWAY PAVEMENT, 6 INCH OR PORTLAND CEMENT CONCRETE DRIVEWAY PAVEMENT, 8 INCH OR PORTLAND CEMENT CONCRETE SIDEWALK INCH OR COMBINATION CONCRETE CURB AND GUTTER REMOVAL AND REPLACEMENT OR CONCRETE CURB, TYPE B OR CONCRETE MEDIAN. TYPE SB-6.06 (SPECIAL) OR CORRUGATED MEDIAN (SPECIAL) PAY ITEM. AGGREGATE BASE COURSE REQUIRED UNDER TEMPORARY PAVEMENT SHALL BE INCLUDED IN THE TEMPORARY PAVEMENT PAY ITEM REGARDLESS OF THICKNESS.
- 63. TEMPORARY ACCESS SHALL ONLY BE PROVIDED WHEN THE DRIVEWAY IS TO BE REMOVED DUE TO WATER MAIN INSTALLATION, UNLESS OTHERWISE DETERMINED BY THE ENGINEER. AFTER HOT-MIX ASPHALT SURFACE REMOVAL, TEMPORARY RAMPS SHALL BE PROVIDED AT COMMERCIAL OR MULTIFAMILY DWELLINGS TO MAINTAIN CONTINUOUS ACCESS, TEMPORARY RAMPS SHALL NOT BE PROVIDED FOR RESIDENTIAL DRIVEWAYS. UNLESS OTHERWISE DETERMINED BY THE ENGINEER.
- 64. THE CONTRACTOR SHALL PROTECT ALL EXISTING TRAFFIC SIGNAL EQUIPMENT SHOWN TO REMAIN (CONDUITS, CABLES ETC.). ANY AND ALL DAMAGE TO EXISTING TRAFFIC SIGNAL EQUIPMENT SHALL BE REPAIRED OR REPLACED BY THE VILLAGE'S TRAFFIC SIGNAL MAINTENANCE CONTRACTOR OR AS DETERMINED BY THE ENGINEER OR VILLAGE. THE CONTRACTOR SHALL PAY THE VILLAGE'S TRAFFIC SIGNAL MAINTENANCE CONTRACTOR. ANY AND ALL REPAIR OR REPLACEMENT WORK WILL BE INCLUDED IN THE PAY ITEM WHICH CAUSED THE
- 65. ALL DRIVEWAYS TO BE REMOVED MUST BE APPROVED BY THE ENGINEER IN THE FIELD PRIOR TO REMOVAL.
- 66. TREE ROOT PRUNING SHALL BE USED ON EXISTING TREES TO PREVENT THE RIPPING UP OF ROOTS WHEN TRENCHING OR EXCAVATING WITHIN THE CRITICAL ROOT ZONE OF ADJACENT TREES TO REMAIN. SUPPLEMENTAL WATERING OF TREES SHOULD BEGIN IMMEDIATELY AFTER ROOT PRUNING OF TREES HAS OCCURRED.
- 67. SUPPLEMENTAL WATERING SHALL ALSO BE USED IMMEDIATELY AFTER TREE ROOT PRUNING AN EXISTING TREE TO REMAIN.

*2625 MILL ROAD SECTION COUNTY 09-00098-00-RS

*3884 ARMY TRAIL BLVD.

DESIGNED - JJS EVISED - VILLAGE REVIEW 9-08-09 RAWN - UKB VISED - VILLAGE REVIEW 11-05-09 CHECKED - SMV EVISED - IDOT REVIEW 11-17-09 - 8-19-09 VISED -

VILLAGE OF ADDISON, ILLINOIS MILL ROAD AND ARMY TRAIL BOULEVARD STP IMPROVEMENTS

	CODE	PAY ITEM	UNIT	TOTAL QUANTITY	ROADWAY 1000	NON-PARTICIPATING
	20100110	TREE REMOVAL (6 TO 15 UNITS DIAMETER)	UNIT	11	11	-
	20101000	TEMPORARY FENCE	FOOT	6,200	6,200	-
	20101200	TREE ROOT PRUNING	EACH	25	25	_
举	20101300	TREE PRUNING (1 TO 10 INCH DIAMETER)	EACH	18	18	-
*	20101350	TREE PRUNING (OVER 10 INCH DIAMETER)	EACH	7	7	_
*	20101700	SUPPLEMENTAL WATERING	UNIT	200	200	-
	20200100	EARTH EXCAVATION	CU YD	89	89	-
*	20201200	REMOVAL AND DISPOSAL OF UNSUITABLE MATERIAL	CU YD	135	35	100
*	20700420	POROUS GRANULAR EMBANKMENT, SUBGRADE	CU YD	135	35	100
*	20800250	TRENCH BACKFILL, SPECIAL	CU YD	6,070	700	5,370
	21001000	GEOTECHNICAL FABRIC FOR GROUND STABILIZATION	SQ YD	300	300	-
*	21300010	EXPLORATION TRENCH, SPECIAL	FOOT	100	_	100
*	25000110	SEEDING, CLASS 1A	ACRE	0.80	0.80	-
*	25000400	NITROGEN FERTILIZER NUTRIENT	POUND	78	78	-
*	25000500	PHOSPHORUS FERTILIZER NUTRIENT	POUND	78	78	_
*	25000600	POTASSIUM FERTILIZER NUTRIENT	POUND	78	78	-
*	25100 01	EXCELSIOR BLANKET, SPECIAL	SQ YD	3,700	3,700	-
	25200200	SUPPLEMENTAL WATERING	UNIT	93	93	-
*	25300600	TRANSPLANTED SALVAGED TREES	EACH	15	15	-
*	25300 00	TRANSPLANTED SALVAGED SHRUBS	EACH	15	15	
*	28000250	TEMPORARY EROSION CONTROL SEEDING	POUND	81	81	-
	28000\$10	INLET FILTERS	EACH	56	56	-
*	28000 00	MULCH, METHOD 1	ACRE	0.80	0.80	_
	35102000	AGGREGATE BASE COURSE, TYPE B 8"	SQ YD	1,016	1,016	_
	35102400	AGGREGATE BASE COURSE, TYPE B 12"	SQ YD	490	490	-
	40600 00	BITUMINOUS MATERIALS (PRIME COAT)	GALLON	6,688	6,688	-
	40600300	AGGREGATE (PRIME COAT)	TON	136	136	_
	40600400	MIXTURE FOR CRACKS, JOINTS, AND FLANGEWAYS	TON	19	19	-
	40600895	CONSTRUCTING TEST STRIP	EACH	1	1	-
* 18	40600982 IDICATES SPE	HOT-MIX ASPHALT SURFACE REMOVAL - BUTT JOINT	SQ YD	968	968	_

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WOODMAN
Consulting Engineers

 DESIGNED MWP
 REVISED VILLAGE REVIEW
 9-08-09

 DRAWN UKB
 REVISED VILLAGE REVIEW
 11-05-09

 CHECKED RWL
 REVISED IDOT REVIEW
 11-17-09

 DATE 8-19-09
 REVISED VILLAGE REVIEW
 12-07-09

VILLAGE OF ADDISON, ILLINOIS MILL ROAD AND ARMY TRAIL BOULEVARD STP IMPROVEMENTS

SUMMARY	0F	QUANTITIES

TO STA.

PROJECT NO: 070142 STA.

*3884 ARMY TRAIL BLVD. *2625 MILL ROAD

CODE				ROADWAY	NON PARTICIPATING
	PAY ITEM	UNIT	QUANTITY	1000	NON-PARTICIPATING
40600990	TEMPORARY RAMP	SQ YD	357	357	-
40603080	HOT-MIX ASPHALT BINDER COURSE, IL-19.0, N50	TON	48	48	-
40603085	HOT-MIX ASPHALT BINDER COURSE, IL-19.0, N70	TON	4,794	4,794	-
40603310	HOT-MIX ASPHALT SURFACE COURSE, MIX "C", N50	TON	119	119	-
40603340	HOT-MIX ASPHALT SURFACE COURSE, MIX "D", N70	TON	3,944	3,944	-
42001300	PROTECTIVE COAT	SQ YD	2,955	2,955	_
42300200	PORTLAND CEMENT CONCRETE DRIVEWAY PAVEMENT, 6 INCH	SQ YD	178	178	-
42300400	PORTLAND CEMENT CONCRETE DRIVEWAY PAVEMENT, 8 INCH	SQ YD	471	471	-
42400200	PORTLAND CEMENT CONCRETE SIDEWALK 5 INCH	SQ FT	13,000	13,000	-
42400800	DETECTABLE WARNINGS	SQ FT	866	866	-
44000157	HOT-MIX ASPHALT SURFACE REMOVAL, 2"	SQ YD	3,135	3,135	-
44000167	HOT-MIX ASPHALT SURFACE REMOVAL, 4 1/2"	SQ YD	30,305	30,305	-
44000200	DRIVEWAY PAVEMENT REMOVAL	SQ YD	2,100	2,100	-
44000300	CURB REMOVAL	FOOT	120	120	-
44000600	SIDEWALK REMOVAL	SQ FT	12,395	12,395	-
44001700	COMBINATION CONCRETE CURB AND GUTTER REMOVAL AND REPLACEMENT	FOOT	10,000	10,000	-
44003100	MEDIAN REMOVAL	SQ FT	1,900	1,900	-
44201737	CLASS D PATCHES, TYPE I, 8 INCH	SQ YD	190	190	_
44201741	CLASS D PATCHES, TYPE II, 8 INCH	SQ YD	439	439	_
44201745	CLASS D PATCHES, TYPE III, 8 INCH	SQ YD	1,353	1,353	
44201747	CLASS D PATCHES, TYPE IV, 8 INCH	SQ YD	5,800	5,800	-
44201785	CLASS D PATCHES, TYPE I, 12 INCH	SQ YD	10	10	-
44201789	CLASS D PATCHES, TYPE II, 12 INCH	SQ YD	20	20	-
44201794	CLASS D PATCHES, TYPE III, 12 INCH	SQ YD	40	40	-
44201796	CLASS D PATCHES, TYPE IV, 12 INCH	SQ YD	100	100	-
48102100	AGGREGATE WEDGE SHOULDER, TYPE B	TON	2	2	-
550A0030	STORM SEWERS, CLASS A, TYPE 1 8"	FOOT	111	111	
550A0040	STORM SEWERS, CLASS A, TYPE 1 10"	FOOT	65	65	-
550A0050	STORM SEWERS, CLASS A, TYPE 1 12"	FOOT	90	90	-
550A0340	STORM SEWERS, CLASS A, TYPE 2 12"	FOOT	416	416	_

* INDICATES SPECIALTY ITEM

REVISED - VILLAGE REVIEW 9-08-09 DESIGNED - MWP DRAWN - UKB REVISED - VILLAGE REVIEW 11-05-09 CHECKED - RWL REVISED - IDOT REVIEW 11-17-09 REVISED - VILLAGE REVIEW 12-07-09

VILLAGE OF ADDISON, ILLINOIS MILL ROAD AND ARMY TRAIL BOULEVARD STP IMPROVEMENTS

SUMMARY OF QUANTITIES

PROJECT NO: 070142 STA.

TO STA.

*3884 ARMY TRAIL BLVD. *2625 MILL ROAD

	CODE			TOTAL	ROADV		NON PARTICIPATING
NU	JMBER	PAY ITEM	UNIT	QUANTITY	1000		NON-PARTICIPATING
55	100300	STORM SEWER REMOVAL 8"	FOOT	99		99	· -
55	100400	STORM SEWER REMOVAL 10"	FOOT	389		389	-
55	100500	STORM SEWER REMOVAL 12"	FOOT	318		318	
* 56	103100	DUCTILE IRON WATER MAIN 8"	FOOT	3,670		-	3,670
* 56	103200	DUCTILE IRON WATER MAIN 10"	FOOT	2,160		-	2,160
* 56	200300	WATER SERVICE LINE 1"	FOOT	810		_	810
* 56	200500	WATER SERVICE LINE 1 1/2"	FOOT	430		-	430
* 56	200700	WATER SERVICE LINE 2"	FOOT	30		-	30
* 56	400820	FIRE HYDRANT WITH AUXILIARY VALVE AND VALVE BOX	EACH	16		-	16
59	300100	CONTROLLED LOW-STRENGTH MATERIAL	CU YD	90		_	90
60	200105	CATCH BASINS, TYPE A, 4'-DIAMETER, TYPE 1 FRAME, OPEN LID	EACH	1		1	-
60	200305	CATCH BASINS, TYPE A, 4'-DIAMETER, TYPE 3 FRAME AND GRATE	EACH	2		2	-
60	201105	CATCH BASINS, TYPE A, 4'-DIAMETER, TYPE 11 FRAME AND GRATE	EACH	3		3	-
60	207905	CATCH BASINS, TYPE C, TYPE 11 FRAME AND GRATE	EACH	2		2	-
60	218400	MANHOLES, TYPE A, 4'-DIAMETER, TYPE 1 FRAME, CLOSED LID	EACH	4		4	-
60	228100	MANHOLES, SANITARY, WITH TYPE 1 FRAME, CLOSED LID	EACH	1		. 1	-
60	234200	INLETS, TYPE A, TYPE 1 FRAME, OPEN LID	EACH	4	-	4	
60	235700	INLETS, TYPE A, TYPE 3 FRAME AND GRATE	EACH	6		6	-
60	236800	INLETS, TYPE A, TYPE 11 FRAME AND GRATE	EACH	6		6	-
60	250200	CATCH BASINS TO BE ADJUSTED	EACH	9		9	
60	0255500	MANHOLES TO BE ADJUSTED	EACH	9		9	-
60	260100	INLETS TO BE ADJUSTED	EACH	15		15	-
60	262700	INLETS TO BE RECONSTRUCTED	EACH	8	ı	8	
60	265700	VALVE VAULTS TO BE ADJUSTED	EACH	1		1	-
60	300310	FRAMES AND LIDS TO BE ADJUSTED (SPECIAL)	EACH	25		25	

* INDICATES SPECIALTY ITEM

DESIGNED - MWP REVISED - VILLAGE REVIEW 9-08-09 REVISED - VILLAGE REVIEW 11-05-09 DRAWN - UKB CHECKED - RWL REVISED - IDOT REVIEW 11-17-09 REVISED - VILLAGE REVIEW 12-07-09

VILLAGE OF ADDISON, ILLINOIS MILL ROAD AND ARMY TRAIL BOULEVARD STP IMPROVEMENTS

SUMMARY OF QUANTITIES PROJECT NO: 070142 STA.

*3884 ARMY TRAIL BLVD. *2625 MILL ROAD SECTION 09-00098-00-RS

 COUNTY
 TOTAL SHEETS NO.

 DuPage
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 7

 CONTRACT NO. 63427
 C-91-056-10 CONTRACT NO. 63427
FED. ROAD DIST. NO. 1 ILLINOIS FED. AID PROJECT M-9003 (474)

CODE			TOTAL	ROADWAY	NON DARTICIDATINO
NUMBER	PAY ITEM	UNIT	QUANTITY	1000	NON-PARTICIPATING
60404300	FRAMES AND GRATES, TYPE 3	EACH	12	12	-
60404600	FRAMES AND GRATES, TYPE 9	EACH	2	2	-
60404800	FRAMES AND GRATES, TYPE 11	EACH	11	11	1
60406000	FRAMES AND LIDS, TYPE 1, OPEN LID	EACH	3	3	-
60406100	FRAMES AND LIDS, TYPE 1, CLOSED LID	EACH	41	41	-
60500050	REMOVING CATCH BASINS	EACH	4	4	-
60500060	REMOVING INLETS	EACH	11	- 11	
60600605	CONCRETE CURB, TYPE B	FOOT	120	120	-
60619500	CONCRETE MEDIAN, TYPE SB-6.06 (SPECIAL)	SQ FT	1,100	1,100	-
60624700	CORRUGATED MEDIAN (SPECIAL)	SQ FT	800	800	_
66900450	SPECIAL WASTE PLANS AND REPORT	LSUM	1	•	1
66900500	BETX SOIL ANALYSIS	EACH	1	-	1
67100100	MOBILIZATION	LSUM	1	0.54	0.46
70102620	TRAFFIC CONTROL AND PROTECTION, STANDARD 701501	LSUM	1	0.54	0.46
70102630	TRAFFIC CONTROL AND PROTECTION, STANDARD 701601	LSUM	1	0.54	0.46
70102635	TRAFFIC CONTROL AND PROTECTION, STANDARD 701701	L SUM	1	0.54	0.46
70102640	TRAFFIC CONTROL AND PROTECTION, STANDARD 701801	L SUM	1	0.54	0.46
70106800	CHANGEABLE MESSAGE SIGN	CAL MO	25	25	
70300100	SHORT-TERM PAVEMENT MARKING	FOOT	17,650	17,650	
70300520	PAVEMENT MARKING TAPE, TYPE III 4"	FOOT	8,100	6,500	1,600
70300210	TEMPORARY ' PAVE MENT MARKING LETTERS AND SYMBOLS	SQ FT	1,150	1,150	-
7030020	TEMPORARY PAVEMENT MARKING LINE 4"	FOOT	46,400	46,400	-
70300Z40	TEMPORARY PAVEME NTMARKING LINE 6"	FOOT	1,920	1,920	_
70300740	TEMPORARY PAUS MEN'T MARKING LINE 12"	FOOT	1,350	1,350	-
70300 280	TEMPORARY PAVE COENT MARKING LINE 24"	FOOT	620	620	-

^{*} INDICATES SPECIALTY ITEM

*3884 ARMY TRAIL BLVD. *2625 MILL ROAD

B A X T E
W O O D M A
Consulting Engine

 DESIGNED - MWP
 REVISED - VILLAGE REVIEW 9-08-09

 DRAWN - UKB
 REVISED - VILLAGE REVIEW 11-05-09

 CHECKED - RWL
 REVISED - IDOT REVIEW 11-17-09

 DATE - 8-19-09
 REVISED - VILLAGE REVIEW 12-07-09

VILLAGE OF ADDISON, ILLINOIS MILL ROAD AND ARMY TRAIL BOULEVARD STP IMPROVEMENTS

PROJECT NO: 070142 STA. TO STA.

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	CODE NUMBER	PAY ITEM		UNIT	TOTAL QUANTITY	ROADWAY 1000	NON-PARTICIPATING
	70301000	WORK ZONE PAVEMENT MARKING REMOVAL		SQ FT	4,330	4,150	180
	72000100	SIGN PANEL - TYPE 1		SQ FT	4	4	-
	72800100	TELESCOPING STEEL SIGN SUPPORT	7. 2. 28. 31	FOOT	14	14	
*	78000100	THERMOPLASTIC PAVEMENT MARKING - LETTERS AND SYMBOLS		SQ FT	785	785	
*	78000200	THERMOPLASTIC PAVEMENT MARKING - LINE 4"		FOOT	9,200	9,200	-
*	78000400	THERMOPLASTIC PAVEMENT MARKING - LINE 6"	1 40	FOOT	3,970	3,970	
*	78000600	THERMOPLASTIC PAVEMENT MARKING - LINE 12"		FOOT	910	910	-
*	78000650	THERMOPLASTIC PAVEMENT MARKING - LINE 24"		FOOT	670	670	<u>-</u>
*	78100100	RAISED REFLECTIVE PAVEMENT MARKER	V 1	EACH	80	80	-
	78300100	PAVEMENT MARKING REMOVAL		SQ FT	1,273	1,273	· · · · · ·
*	78300200	RAISED REFLECTIVE PAVEMENT MARKER REMOVAL		EACH	80	80	
*	88600600	DETECTOR LOOP REPLACEMENT		FOOT	1,740	1,740	-
	Z0013798	CONSTRUCTION LAYOUT		L SUM	1	1	
Δ	Z0076600	TRAINEES		HOUR	1,000	1,000	
*	A2000118	TREE, ACER X FREEMANII AUTUMN BLAZE (AUTUMN BLAZE FREEMAN MAPLE), 3" CALIPER, BALLED ANI	D BURLAPPED	EACH	1	-	1
¥	66900200	NON-SPECIAL WASTE DISPOSAL		CU YD	320	_	320
	xx00 6119	TRAFFIC CONTROL AND PROTECTION (DETOUR)		L SUM	1	1	
*	XX005 07	7 SANITARY SEWER 8" TYPE 2, DUCTILE IRON, CLASS 52		FOOT	128	128	-
*		CONNECTIONS TO EXISTING WATER MAINS (NON-PRESSURE) - 8"		EACH	9	- -	9
*	XX003517	CONNECTIONS TO EXISTING WATER MAINS (NON-PRESSURE) - 6"		EACH	6	_	6
*	XX003518	CONNECTIONS TO EXISTING WATER MAINS (NON-PRESSURE) - 4"		EACH	1	_	1
*		DUCTILE IRON WATER MAIN FITTINGS - 8" X 6" REDUCER		EACH	4	_	4
*		WATER SERVICE CONNECTION 1"		EACH	39	- -	39
*				EACH	8	_	8
		DUCTILE IRON WATER MAIN FITTINGS 8" X 6" TEE		EACH	7		7
. i i i i	* INDICATES SE	PECIALTY ITEM		L/ 1011		<u> </u>	

D Y080

*3884 ARMY TRAIL BLVD. *2625 MILL ROAD

DESIGNED - MWP REVISED - VILLAGE REVIEW 9-08-09 DRAWN - UKB REVISED - VILLAGE REVIEW 11-05-09 CHECKED - RWL REVISED - IDOT REVIEW 11-17-09 REVISED - VILLAGE REVIEW 12-07-09

VILLAGE OF ADDISON, ILLINOIS MILL ROAD AND ARMY TRAIL BOULEVARD STP IMPROVEMENTS

SUMMARY OF QUANTITIES PROJECT NO: 070142 STA.

TO STA.

	CODE				ROADWAY	
	NUMBER	PAY ITEM	UNIT	QUANTITY	1000	NON-PARTICIPATING
*	XX003542	DUCTILE IRON WATER MAIN FITTINGS 6" 45 DEGREE BEND	EACH	7	-	7
*	XX003543	DUCTILE IRON WATER MAIN FITTINGS 8" 45 DEGREE BEND	EACH	25	-	25
*	XX003673	SANITARY SERVICE REPLACEMENT	EACH	8	-	8
*	XX003778	FLUOROCARBON RUBBER (VITON) GASKET	EACH	10	-	10
*	XX004997	WATER SERVICE CONNECTION 2"	EACH	3	=	3
*	XX005003	DUCTILE IRON WATER MAIN FITTING 10" X 6" TEE	EACH	6	-	6
*	XX005004	DUCTILE IRON WATER MAIN FITTING 10" X 6" HYDRANT TEE	EACH	3	, -	3
*	XX005005	DUCTILE IRON WATER MAIN FITTING 10" X 8" TEE	EACH	5	-	5
*	XX005010	DUCTILE IRON WATER MAIN FITTING - 4" X 6" REDUCER	EACH	1	-	1
	XX005221	TOPSOIL FURNISH AND PLACE (PULVERIZED) VARIABLE DEPTH	SQ YD	3,700	3,700	-
*	XX005477	DUCTILE IRON WATER MAIN 4" RESTRAINED JOINT TYPE	FOOT	30	-	30
*	XX005478	DUCTILE IRON WATER MAIN 6" RESTRAINED JOINT TYPE	FOOT	300	-	300
*	60249125	VALVE VAULTS, 6' DIAMETER	EACH	1	-	1
*	XX006878	DUCTILE IRON SOLID SLEEVE 4"	EACH	3	-	3
*	XX006879	DUCTILE IRON SOLID SLEEVE 6"	EACH	7	-	7
*	XX007220	PVC CASING PIPE 20"	FOOT	110	- -	110
	X0320591	SANITARY MANHOLES TO BE REMOVED	EACH	1	. 1	
	X0321556	SANITARY MANHOLES TO BE ADJUSTED	EACH	8	8	-
	X0322032	STORM SEWER (WATER MAIN REQUIREMENTS) 10 INCH	FOOT	376	376	
٠	X0322033	STORM SEWER (WATER MAIN REQUIREMENTS) 12 INCH	FOOT	461	461	-
	X0322124	STORM SEWER (WATER MAIN REQUIREMENTS) 8 INCH	FOOT	17	17	-
	X0322256	TEMPORARY INFORMATION SIGNING	SQ FT	364	364	-
*	X0323820	DUCTILE IRON WATER MAIN TEE, 8" X 8"	EACH	10		10
*	X0323821	DUCTILE IRON WATER MAIN REDUCER, 10" X 8"	EACH	1	-	1
*	X0324445 INDICATES SP	DUCTILE IRON WATER MAIN FITTINGS 8" 22.5 DEGREE BEND	EACH	2		2

DESIGNED - MWP REVISED - VILLAGE REVIEW 9-08-09 REVISED - VILLAGE REVIEW 11-05-09 DRAWN - UKB CHECKED - RWL REVISED - IDOT REVIEW 11-17-09 REVISED - VILLAGE REVIEW 12-07-09

VILLAGE OF ADDISON, ILLINOIS MILL ROAD AND ARMY TRAIL BOULEVARD STP IMPROVEMENTS

SUMMARY OF QUANTITIES PROJECT NO: 070142 STA.

TO STA.

*3884 ARMY TRAIL BLVD. *2625 MILL ROAD

	CODE NUMBER	PAY ITEM	UNIT	TOTAL	ROADWAY	NON-PARTICIPATING
	NOMBER	TAI II LIII	Onn			HOIL PARTIE ATTITUTE
*	X0324446	DUCTILE IRON WATER MAIN FITTINGS 10" 11.25 DEGREE BEND	EACH	2	-	2
*	X0324447	DUCTILE IRON WATER MAIN FITTINGS 10" 22.5 DEGREE BEND	EACH	1	-	1
*	X0324448	DUCTILE IRON WATER MAIN FITTINGS 10" 45 DEGREE BEND	EACH	6	-	6
*	X0324449	DUCTILE IRON WATER MAIN FITTINGS, MECHANICAL JOINT 8" X 6" HYDRANT TEE	EACH	3		3
*	X0324931	DUCTILE IRON SLEEVE, 8"	EACH	12	-	12
*	X0325012	CONNECTIONS TO EXISTING WATER MAINS (NON-PRESSURE) - 10"	EACH	1	-	1
*	X0325846	ABANDONMENT OF EXISTING WATER MAINS	L SUM	1	-	1
*	X0325885	STEEL CASING PIPE AUGERED AND JACKED 36"	FOOT	100	<u> </u>	100
*	X0326014	DUCTILE IRON WATER MAIN CUTTING-IN SLEEVE, 10"	EACH	2	-	2
	X0712400	TEMPORARY PAVEMENT	SQ YD	1,250	1,250	-
*	X0840000	SANITARY SEWER REMOVAL 8"	FOOT	243	243	-
	X4021000	TEMPORARY ACCESS (PRIVATE ENTRANCE)	EACH	33	33	_
	X4022000	TEMPORARY ACCESS (COMMERCIAL ENTRANCE)	EACH	20	20	_
*	XX008295	DUCTILE IRON WATER MAIN FITTINGS 4" 45 DEGREE BEND	EACH	·. 4	-	4
*	X0325950	GATE VALVE 8" WITH VAULT, 5" DIAMETER	EACH	10	-	10
*	xx00 8296	GATE VALVE 10" WITH VAULT, 5" DIAMETER	EACH	5	-	5
*	XX007226	GATE VALVE 6"WITH VAULT, 6' DIAMETER (VALVE ATTACHED TO LINE TEE)	EACH	3	-	3
*	XX007275	GATE VALVE 8" WITH VAULT, 6' DIAMETER (VALVE ATTACHED TO LINE TEE)	EACH	12	-	12
*	X0326417	DUCTILE IRON WATER MAIN FITTINGS 8" 11.25 DEGREE BEND	EACH	3	-	3
*	XX008297	DUCTILE IRON WATER MAIN TEE, 10" X 4"	EACH	y 7 : 1	-	1
*	XXC08298	TREE TUNNEL - 4" TO 12" DIAMETER PIPE	FOOT	150	-	150
*	XX008299	HORIZONTAL DIRECTIONALLY DRILLED DUCTILE IRON WATER MAIN - 8" RESTRAINED JOINT TYPE	FOOT	220	-	220
	XX006910	TREE PROTECTION SPECTAL	EACH	50	50	
	XXXXX 3668 NDICATES SPE	PRECONSTRUCTION VIDEO TAPING	LSUM	1	_	1

* INDICATES SPECIALTY ITEM

710/2009 10:56 AM By: 2310 2009, By Baxter & Woodma nois — Professional Design Fir — 184-001121 — Expires 1

B A X T E R
W O O D M A N
Consulting Engineers

DATE - 8	3-19-09	REVISED -	VILLAGE REVIEW	12-07-09
CHECKED - F	RML	REVISED -	IDOT REVIEW 11	-17-09
DRAWN - L	JKB	REVISED -	VILLAGE REVIEW	11-05-09
DESIGNED - N	/WP	REVISED -	VILLAGE REVIEW	9-08-09

VILLAGE OF ADDISON, ILLINOIS MILL ROAD AND ARMY TRAIL BOULEVARD STP IMPROVEMENTS

			2020	MILL NOAD		
SUMMARY OF QUANTITIES				SECTION	COUNTY	TOTAL SHEETS
			*	09-00098-00-RS	DuPage	69
			C-91	-056-10	CONTRACT NO.	63427
PROJECT NO: 070142	STA.	TO STA.	FED. RO	AD DIST. NO. 1 ILLINOIS FED. AIL	PROJECT M-9003	(474)

*3884 ARMY TRAIL BLVD.

HOT-MIX ASPHALT MIXTURE REQUIREMENTS

MIXTURE TYPE	AIR VOIDS @ Ndes
PAVEMENT RESURFACING	
HOT-MIX ASPHALT SURFACE COURSE, MIX "D", N70 (IL 9.5mm); 2"	4% ⊚ 70 Gyr.
HOT-MIX ASPHALT BINDER COURSE, IL-19, N70; 2 1/2"	4% @ 70 Gyr.
DRIVEWAYS	·
HOT-MIX ASPHALT SURFACE COURSE, MIX "C", N50, (IL-9.5mm); 2"	4% @ 50 Gyr.
HOT-MIX ASPHALT BINDER COURSE, IL-19.0, N50; 2 1/4"	4% @ 50 Gyr.
PATCHING	
CLASS D PATCHES (HMA BINDER IL-19mm); TYPE I - IV - 8 INCH, TYPE I - IV - 12 INCH	4% @ 70 Gyr.
TEMPORARY PAVEMENT	
TEMPORARY PAVEMENT (HMA BINDER IL-19 mm); 6"	4% @ 50 Gyr.

THE UNIT WEIGHT USED TO CALCULATE ALL HOT-MIX ASPHALT SURFACE MIXTURES IS 112 LBS/SQ. YD./IN THE "AC TYPE" FOR POLYMERIZED HMA MIXES SHALL BE "SBS/SBR PG 70-22" AND FOR NON-POLYMERIZED HMA MIXES THE "AC TYPE" SHALL BE "PG 64-22" UNLESS MODIFIED BY DISTRICT ONE SPECIAL PROVISIONS.

FOR "PERCENT OF RAP" SEE DISTRICT ONE SPECIAL PROVISIONS

EXISTING LEGEND

- (A) HOT-MIX ASPHALT SURFACE COURSE, 1"
- (B) HOT-MIX ASPHALT SURFACE COURSE, 1 1/4"
- (C) HOT-MIX ASPHALT SURFACE COURSE, 1 3/4"
- (D) HOT-MIX ASPHALT SURFACE COURSE, 2"
- (E) HOT-MIX ASPHALT SURFACE COURSE, 2 1/2"
- (F) AREA REFLECTIVE CRACK CONTROL TREATMENT (PETROMAT)
- G HOT-MIX ASPHALT BINDER COURSE, 1 3/4"
- (H) HOT-MIX ASPHALT BINDER COURSE, 2"
- J) HOT-MIX ASPHALT BINDER COURSE, 2 1/4"
- (K) HOT-MIX ASPHALT BASE COURSE, 5 1/4" 8 1/2"
- (L) HOT-MIX ASPHALT BASE COURSE, 6 1/4" 8 1/4"
- M) HOT-MIX ASPHALT BASE COURSE, 9 3/4"
- (N) CRUSHED LIMESTONE, 3 1/2" 14"
- (0) SUB-BASE GRANULAR MATERIAL, TYPE B, 12"
- (P) COMBINATION CONCRETE CURB AND GUTTER, TYPE B-6.12
- R COMBINATION CONCRETE CURB AND GUTTER, TYPE B-6.18
- (S) COMBINATION CONCRETE CURB AND GUTTER, TYPE B-6.24
- (T) EXISTING SIDEWALK
- (U) AGGREGATE BASE COURSE
- (V) EXISTING SUB-GRADE
- (W) GROUND SURFACE
- X HOT-MIX ASPHALT SURFACE REMOVAL, 2"
- Y HOT-MIX ASPHALT SURFACE REMOVAL, 4 1/2"
- Z COMBINATION CONCRETE CURB AND GUTTER REMOVAL AND REPLACEMENT
- BB AGGREGATE BASE COURSE REMOVAL (INCLUDED IN THE COST OF ITEM REMOVED ABOVE)
- PARKWAY REMOVAL (INCLUDED IN THE COST OF COMBINATION CONCRETE CURB AND GUTTER CC REMOVAL AND REPLACEMENT OR TOPSOIL FURNISH AND PLACE (PULVERIZED) VARIABLE DEPTH - 4" MIN)
- DD REMOVAL AND DISPOSAL OF UNSUITABLE MATERIALS **
- ITEM TO BE REMOVED


DESIGNED - MWP	REVISED - VILLAGE REVIEW 9-08-09
DRAWN - UKB	REVISED - VILLAGE REVIEW 11-05-09
CHECKED - RWL	REVISED - IDOT REVIEW 11-17-09
DATE - 8-19-09	REVISED ~

** POROUS CRANULAR EMBANKMENT, SUBGRADE (PGES) HAS BEEN PROVIDED FOR USE AT THE LOCATIONS INDICATED FOR SOILS THAT TEND TO BE UNSUITABLE OR UNSTABLE. THE ACTUAL NEED FOR REMOVAL AND REPLACEMENT WITH PGES WILL BE DETERMINED IN THE FIELD AT THE TIME OF CONSTRUCTION BY THE GEOTECHNICAL ENGINEER. ALL POTENTIALLY UNSTABLE SOILS SHOULD BE TESTED WITH A STATIC CONE PENETROMETER AND TREATED IN ACCORDANCE WITH ARTICLE 301.03 AND THE UNDERCUT GUIDELINES IN THE IDOT SUBGRADE STABILITY MANUAL. IF UNSTABLE AND/OR UNSUITABLE MATERIAL IS NOT ENCOUNTERED, THEN THE QUANTITY SHALL BE DEDUCTED AND NO ADDITIONAL COMPENSATION WILL BE DUE TO THE CONTRACTOR.

PROPOSED LEGEND

- 1) HCT-MIX ASPHALT SURFACE COURSE, MIX "D", N70 2"
- (2) HCT-MIX ASPHALT BINDER COURSE, IL-19.0, N70 2 1/2"
- (3) NCT USED
- (4) NCT USED
- (5) CLASS D PATCHES, TYPE I IV, 8 INCH
- (6) CLASS D PATCHES, TYPE I IV, 12 INCH
- (7) COMBINATION CONCRETE CURB AND GUTTER REMOVAL AND REPLACEMENT
- (8) PORTLAND CEMENT CONCRETE SIDEWALK 5 INCH
- (9) AGGREGATE BASE COURSE, TYPE B 4"
- (1) TCPSOIL FURNISH AND PLACE (PULVERIZED) VARIABLE DEPTH 4" MIN (SEE LEGEND NOTES 1 & 2 THIS SHEET)
- (SEE LEGEND NOTE 1 THIS SHEET)
- (12) POROUS GRANULAR EMBANKMENT, SUBGRADE** (AS DETERMINED BY THE ENGINEER)
- (13) EXCELSIOR BLANKET, SPECIAL
- (14) AGGREGATE BASE COURSE, TYPE B 3"


- PARKWAY DAMAGED BY COMBINATION CONCRETE CURB AND GUTTER REMOVAL AND REPLACEMENT SHALL BE RESTORED WITH PULVERIZED TOPSOIL, EXCELSION BLANKET, SPECIAL AND SEED FOR A MINIMUM DISTANCE OF 2' PERPENDICULAR TO THE BACK OF CURB. RESTORATION SHALL BE INCLUDED IN THE COMBINATION CONCRETE CURB AND GUTTER REMOVAL AND REPLACEMENT PAY ITEM.
- PARKWAY DAMAGED BY WATER MAIN INSTALLATION, DRIVEWAY OR SIDEWALK REMOVAL AND REPLACEMENT, OR SIDEWALK INSTALLATION SHALL BE PAID FOR SEPARATELY AS TOPSOIL FURNISH AND PLACE (PULVERIZED) VARIABLE DEPTH — 4" MIN; EXCELSIOR BLANKET, SPECIAL; AND SEEDING, CLASS 1A. THE AREA OF RESTORATION SHALL BE DETERMINED BY THE VILLAGE AND ENGINEER. ANY AND ALL RESTORATION BEYOND THESE LIMITS SHALL BE COMPLETED TO THE SATISFACTION OF THE VILLAGE AND ENGINEER AT THE
- 3. SIDEWALK REMOVAL AND REPLACEMENT LOCATIONS TO BE DETERMINED BY THE ENGINEER, UNLESS OTHERWISE SHOWN. MINIMUM SIDEWALK REMOVAL AND REPLACEMENT
- 4. CURB AND GUTTER REMOVAL AND REPLACEMENT LOCATIONS TO BE DETERMINED BY THE ENGINEER, UNLESS OTHERWISE SHOWN. MINIMUM CURB AND GUTTER REMOVAL AND REPLACEMENT SHALL BE 10 FT.

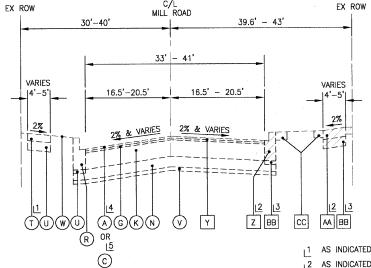

EXISTING TYPICAL SECTION MILL ROAD

STA. 97+00 TO STA. 119+53 (NOT TO SCALE)

- AS INDICATED IN PLANS
- AS INDICATED IN PLANS OR AS DETERMINED BY THE ENGINEER
- AS REQUIRED
- L4 LOCATED BETWEEN STA 97+00 TO STA 110+10
- LOCATED BETWEEN STA 110+10 TO STA 119+53

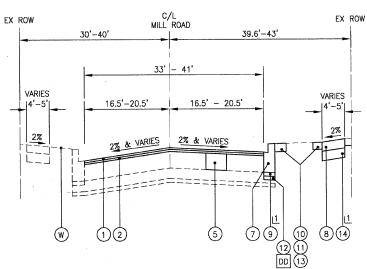


INCLUDED IN PAY ITEM ABOVE PROPOSED TYPICAL SECTION

MILL ROAD STA. 97+00 TO STA. 119+53

(NOT TO SCALE)

*3884 ARMY TRAIL BLVD. *2625 MILL ROAD									
TYPICAL SECTIONS AND		F.A.U. RTE.	SEC1	TION		COUNTY	TOTAL SHEETS	SHEET NO.	
		*	09-0009	8-00-RS		DuPage	69	12	
HOT-MIX ASPHALT MIXTURE REQUIREMENTS			C-91	-056-10			CONTRACT NO.	63427	
PROJECT NO: 070142	STA.	TO STA.	FED. ROA	AD DIST. NO. 1	ILLINOIS	FED. AI	PROJECT M-9003	(474)	

VILLAGE OF ADDISON, ILLINOIS MILL ROAD AND ARMY TRAIL BOULEVARD STP IMPROVEMENTS

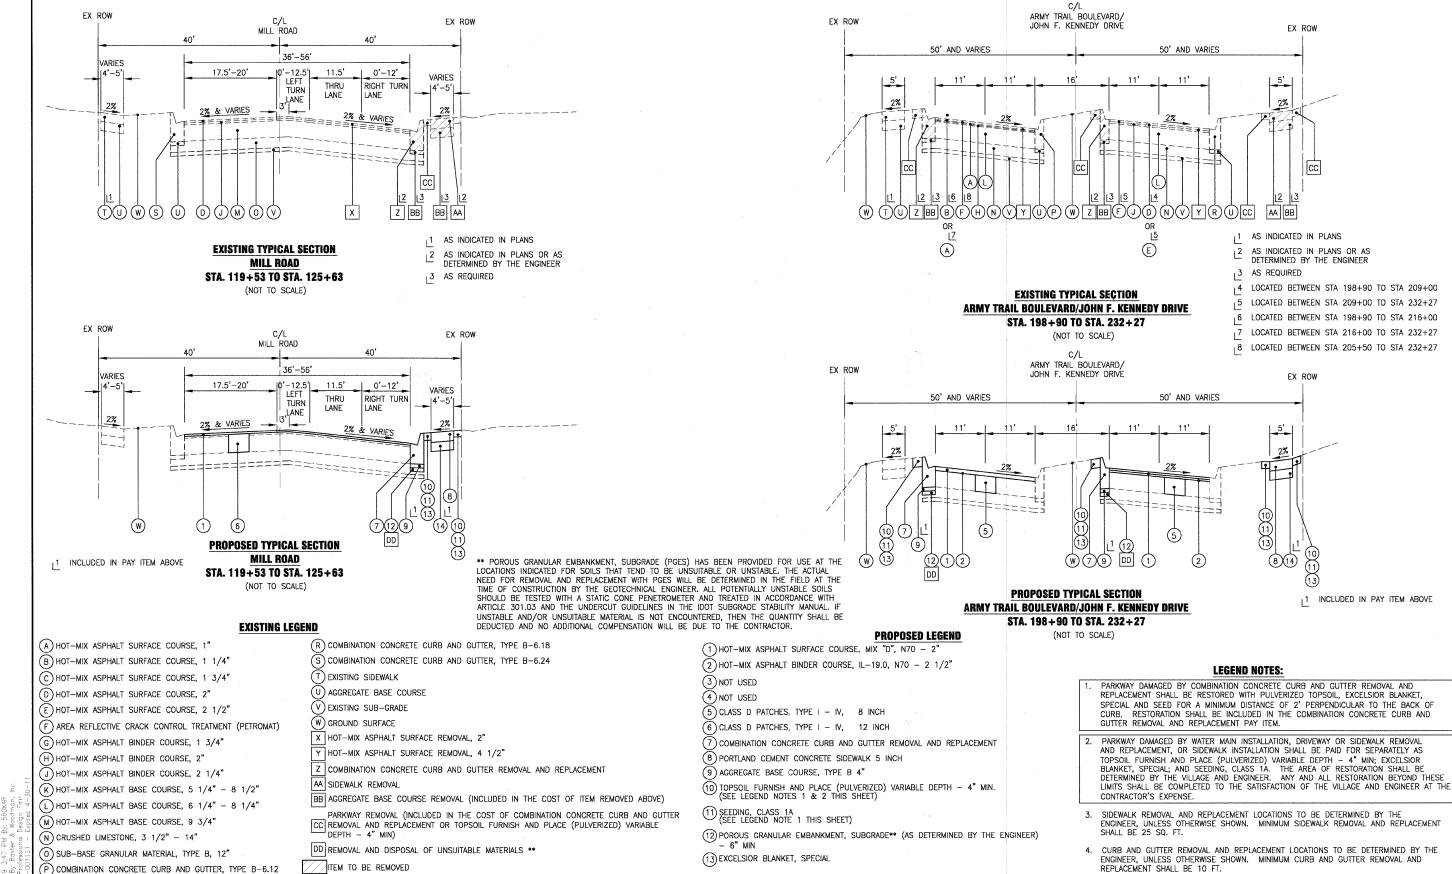

(14) AGGREGATE BASE COURSE, TYPE B 3"

VILLAGE OF ADDISON, ILLINOIS

MILL ROAD AND ARMY TRAIL BOULEVARD

STP IMPROVEMENTS

*3884 ARMY TRAIL BLVD.

SECTION

09-00098-00-RS

COLINITY

DuPage

CONTRACT NO. 63427

69

*2625 MILL ROAD

C-91-056-10

TYPICAL SECTIONS

PROJECT NO: 070142 STA

DESIGNED - MWP

RAWN - UKB

CHECKED - RWL

- 8-19-09

REVISED - VILLAGE REVIEW 9-08-09

EVISED - IDOT REVIEW 11-17-09

EVISED - VILLAGE REVIEW 11-05-09

LOCATION	SQ YD
MILL ROAD (STA 97+00)	55.00
W. STEVENS DR. (108+29, RT)	54.00
S. GREEN OAKS CT. (113+31, RT)	54.00
N. GREEN OAKS CT. (116+78, RT)	54.00
W. STONEMILL AVE. (118+70, LT)	40.00
MILL ROAD (STA 119+53)	59.00
MILL ROAD (STA 125+63)	97.00
ARMY TRAIL BOULEVARD (STA 198+90)	100.00
W. MEMORY LANE (STA 205+24, RT)	42.00
W. NATALIE LANE (STA 208+59, RT)	42.00
HIGHVIEW BLVD. (STA 213+59, LT)	40.00
N. LINCOLN AVE. (STA 220+29, RT)	52.00
W. ARMY TRAIL BOULEVARD (STA 401+35)	80.00
FRIENDSHIP PLAZA (STA 228+76, RT)	44.00
JOHN F. KENNEDY DRIVE (STA 232+27)	155.00
	968 00

BAXTER
WOODMAN
Consulting Engineers

 DESIGNED MWP
 REVISED VILLAGE
 REVIEW
 9-08-09

 DRAWN UKB
 REVISED VILLAGE
 REVIEW
 11-05-09

 CHECKED RWL
 REVISED IDOT
 REVIEW
 11-17-09

 DATE 8-19-09
 REVISED REVISED

VILLAGE OF ADDISON, ILLINOIS MILL ROAD AND ARMY TRAIL BOULEVARD STP IMPROVEMENTS

			F.A.U. RTE.	SECTI	ION	COUNTY	TOTAL SHEETS	SHEET NO.	
	•			*	09-00098	3-00-RS	DuPage	69	14
				C-91	I-056-10		CONTRACT NO.	63427	- 1
E:	PROJECT NO: 070142	STA.	TO STA.	FED. ROA	AD DIST. NO. 1	ILUNOIS FED. AID	PROJECT M-9003	(474)	

U.S. ROUTE 20 (LAKE STREET) END IMPROVEMENTS _ MILL ROAD STA. 125+63 PROJECT LIMITS 49' LT STONEMILL AVENUE PROJECT LIMITS 51' RT CONSTRUCTION -STORAGE AREA ROAD **GREEN OAKS COURT** 100 YR FLOODPLAIN BOUNDARY ELEV 684 (NAVD 88) GREEN OAKS COURT -PROJECT LIMITS 51' RT END IMPROVEMENTS JOHN F. KENNEDY DRIVE STA. 232+27 **WESTWOOD CREEK** PROJECT LIMITS
44' RT SCHOÖL DISTRICT 4 AG WILLIAM TRAIL JUNIOR HIGH) STEVENS DRIVE PROJECT LIMITS FUTURE ENTRANCE TO -51' RT COUNTRY CLUB MANOR SUBDIVISION (BY OTHERS) -100 YR FLOODPLAIN BOUNDARY Ç JOHN F KENNEDY STA 224+43.51
Ç ARMY TRAIL BOULEVARD 400+00.00 ELEV 684 (NAVD 88) STORAGE AREA SCHOOL DISTRICT 4
(ARMY TRAIL ELEMENTARY - CONSTRUCTION PROJECT LIMITS~ STORAGE AREA SCHOOL) **ARMY TRAIL BOULEVARD** ARMY TRAIL BOULEVARD BEGIN IMPROVEMENTS ARMY TRAIL BOULEVARD STA. 198+90 PROJECT LIMITS -88' RT -PROJECT LIMITS 75' RT MEMORY CONSTRUCTION— STORAGE AREA BEGIN IMPROVEMENTS MILL ROAD STA. 97+00

*3884 ARMY TRAIL BLVD. *2625 MILL ROAD

OVERALL LAYOUT		F.A.U. SECTION		COUNTY	TOTAL SHEETS	SHEE NO.	
		*	09-00098	3-00-RS	DuPage	69	15
		C-91	1-056-10		CONTRACT NO.	63427	
E: " HORIZ. 1"=200' PROJECT NO: 070142 STA.	TO STA.	FED. ROAD DIST. NO. 1 ILLINOIS FED. AID PROJECT M-9003 (474)					

riotted: 11/20/2009 6:16 Copyright © 2009, By Bax State of Illinois — Professi License No. — 184--00112

B A X T E R
W O O D M A N
Consulting Engineers

 DESIGNED - MWP
 REVISED - VILLAGE REVIEW 9-08-09

 DRAWN - UKB
 REVISED - VILLAGE REVIEW 11-05-09


 CHECKED - RWL
 REVISED - IDOT REVIEW 11-17-09

 DATE - 8-19-09
 REVISED

VILLAGE OF ADDISON, ILLINOIS
MILL ROAD AND ARMY TRAIL BOULEVARD
STP IMPROVEMENTS

FOR CONTINUATION SEE ARMY TRAIL BLVD. 1841. NO. 20 $\rightarrow \bigcirc \rightarrow Z$ BEGIN FUTURE CURB AND GUTTER (BY OTHERS) HOT-MIX ASPHALT SURFACE REMOVAL, 4 1/2"

8 2 1/2" HOT-MIX ASPHALT BINDER COURSE, IL-19.0, N70
2" HOT-MIX ASPHALT SURFACE COURSE, MIX "D", N70 STA. 100+16, 54' LT € MILL STREET STA. 100+00 © ARMY TRAIL BOULEVARD STA. 200+00 FUTURE RIGHT-OF-WAY TO STA, 119+53 BUTT JOINT-(BY OTHERS) DETECTABLE WARNINGS (TYP) EX 87' LT EOP TAPER **MILL ROAD** 99+00 98+00 CONC 60 Q EX ROW EX COMBINATION CURB AND GUTTER TO REMAIN SON +18 CE BEGIN IMPROVEMENTS MILL ROAD STA 97+00 √4" BLOCK HMA RETAINING WALL SIDEWALK REMOVAL EX 87' RT EOP TAPER PORTLAND CEMENT CONCRETE SIDEWALK 5 INCH (TYP) TRAIL V BLVD. SHT. COMBINATION CONCRETE CURB AND GUTTER REMOVAL AND REPLACEMENT (TYP) DRIVEWAY PAVEMENT REMOVAL
PORTLAND CEMENT CONCRETE DRIVEWAY PAVEMENT, 8 INCH - FUTURE CURB-(BY OTHERS) EX 66' LT EOP TAPER FUTURE RIGHT-OF-WAY END FUTURE CURB AND-(132:1) (BY OTHERS) GUTTER (BY OTHERS) EX ROW STA. 104+40, 21' LT TREE LINE 104+00 102+00 103+00 EX 66' RT EOP TAPER **MILL ROAD** (26.4:1) DETECTABLE WARNINGS SIDEWALK REMOVAL — PORTLAND CEMENT CONCRETE -EX COMBINATION CURB AND GUTTER TO REMAIN SIDEWALK 5 INCH (TYP) - COMBINATION CONCRETE CURB AND GUTTER CHURCH *3884 ARMY TRAIL BLVD. REMOVAL AND REPLACEMENT (TYP) *2625 MILL ROAD DESIGNED - MWP REVISED - VILLAGE REVIEW 9-08-09 SECTION COUNTY **VILLAGE OF ADDISON, ILLINOIS** PLAN DRAWN - UKB REVISED - VILLAGE REVIEW 11-05-09 09-00098-00-RS MILL ROAD AND ARMY TRAIL BOULEVARD DuPage MILL ROAD CHECKED - RWL REVISED - IDOT REVIEW 11-17-09 C-91-056-10 CONTRACT NO. 63427 STP IMPROVEMENTS TO STA. 105+00 PROJECT NO: 070142 STA. 96+50 HORIZ. 1"=20' ATF - 8-19-09 VISED - VILLAGE REVIEW 12-07-09 FED. ROAD DIST. NO. 1 ILLINOIS FED. AID PROJECT M-9003 (474)

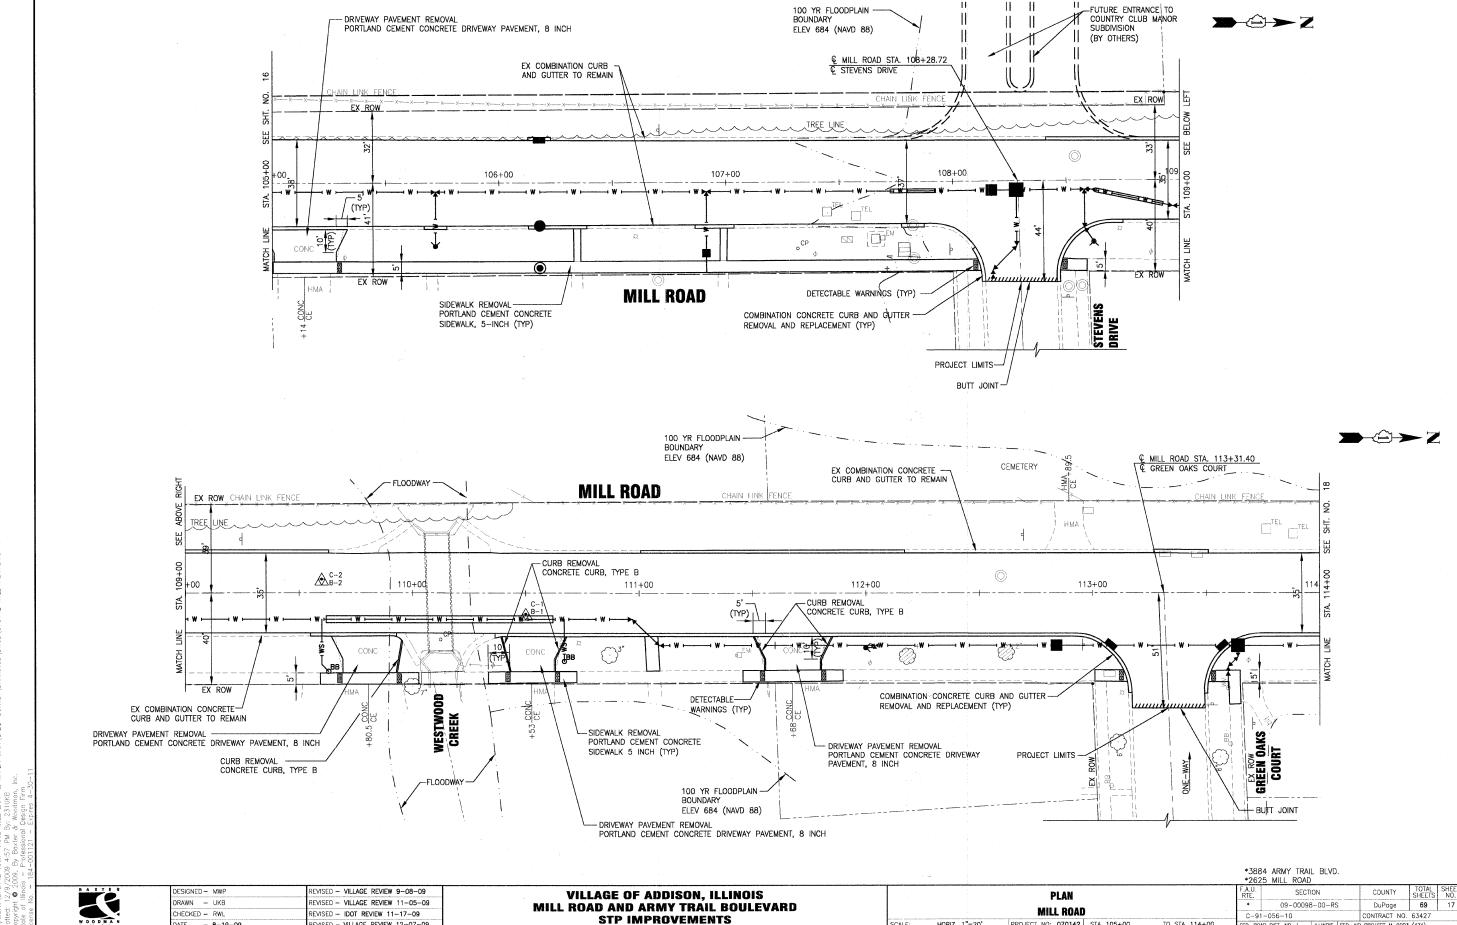


TO STA. 114+00

HORIZ. 1"=20"

PROJECT NO: 070142 STA. 105+00

OATE - 8-19-09

REVISED - VILLAGE REVIEW 12-07-09

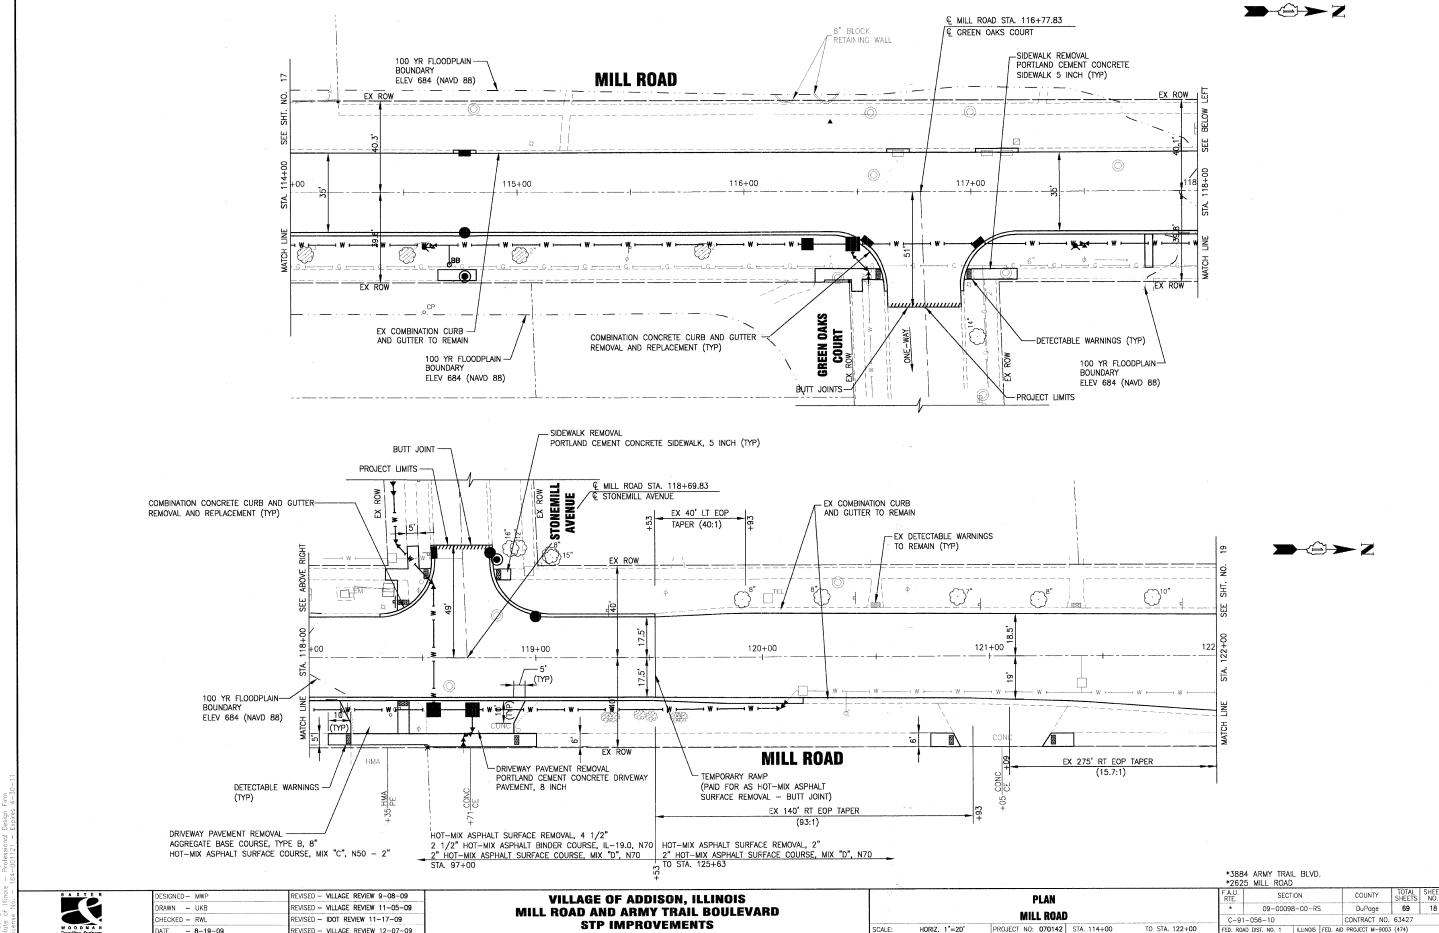

DATE - 8-19-09

REVISED - VILLAGE REVIEW 9-08-09 DESIGNED - MWP RAWN - UKB EVISED - VILLAGE REVIEW 11-05-09 CHECKED - RWL REVISED - IDOT REVIEW 11-17-09 DATE - 8-19-09

TO REMAIN (TYP)

EX 275' RT. EOP TAPER (15.7:1)

EX COMBINATION CURB — AND GUTTER TO REMAIN

VILLAGE OF ADDISON, ILLINOIS MILL ROAD AND ARMY TRAIL BOULEVARD STP IMPROVEMENTS

EX 270' LT EOP TAPER

DETECTABLE WARNINGS-

(45:1)

LCONC

124+00

PLAN MILL ROAD HORIZ. 1"=20' PROJECT NO: 070142 STA. 122+00

TO STA. 126+50

*3884 ARMY TRAIL BLVD. *2625 MILL ROAD SECTION 09-00098-00-RS

END IMPROVEMENTS

MILL ROAD

STA. 125+63 **MILL ROAD** EX CONCRETE PAVEMENT TO REMAIN

SIDEWALK REMOVAL
PORTLAND CEMENT CONCRETE
SIDEWALK 5 INCH (TYP)

-BUTT JOINT

126+00

HOT-MIX ASPHALT SURFACE REMOVAL, 2" / 2" HOT-MIX ASPHALT SURFACE COURSE, MIX "D", N70 TO STA. 119+53 /


125+00


123+00

COUNTY TOTAL SHEET NO.

DuPage 69 19 CONTRACT NO. 63427

© MILL ROAD STA. 126+83
© U.S. ROUTE 20 (LAKE STREET)

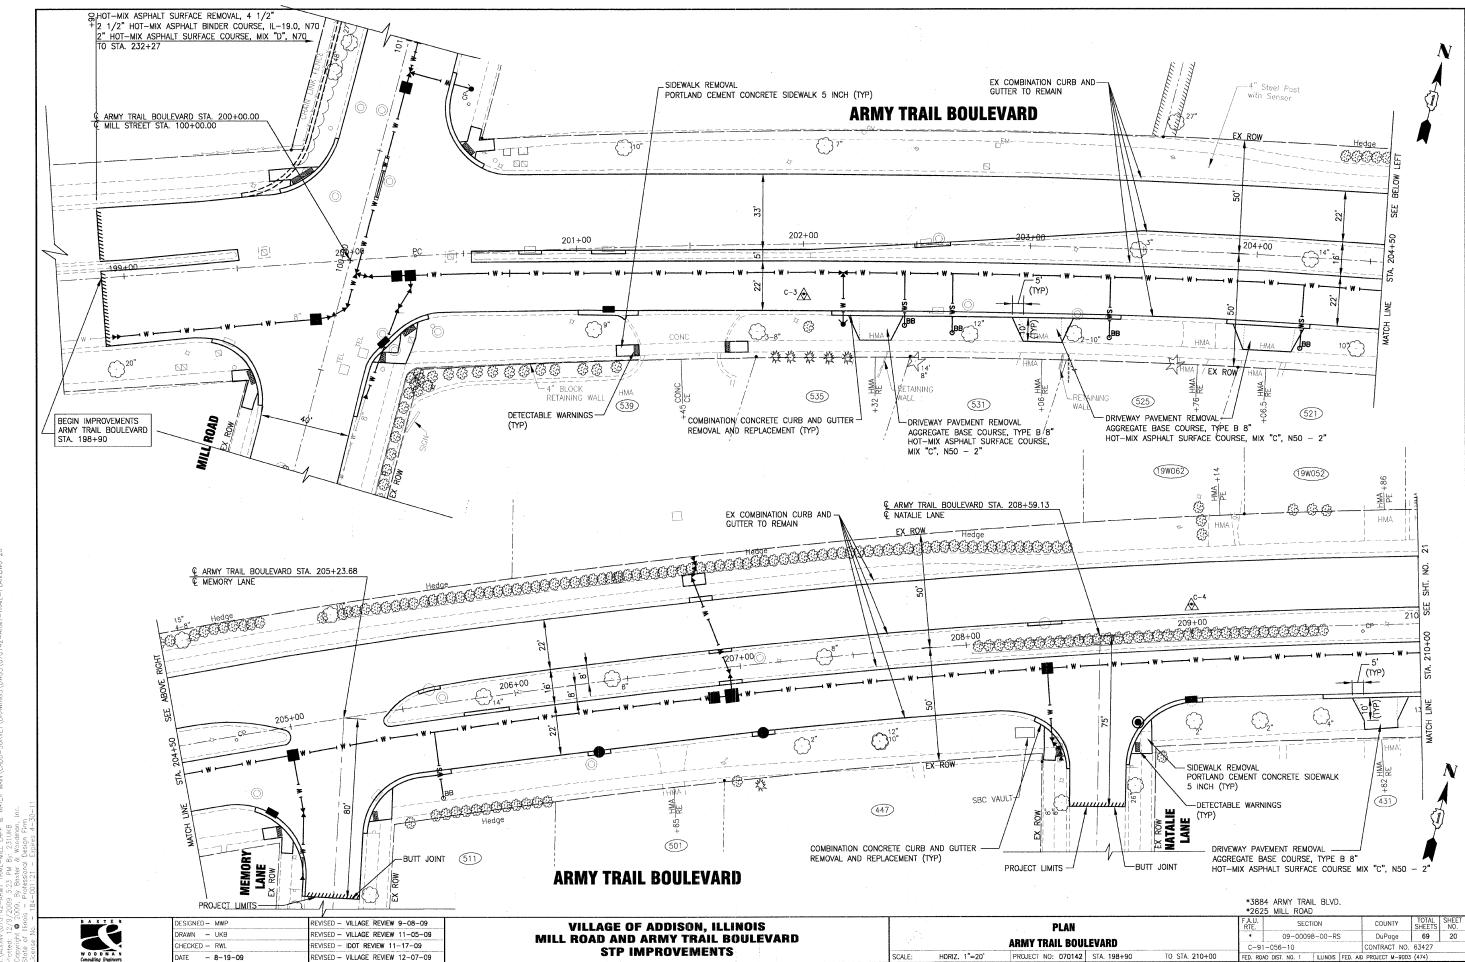

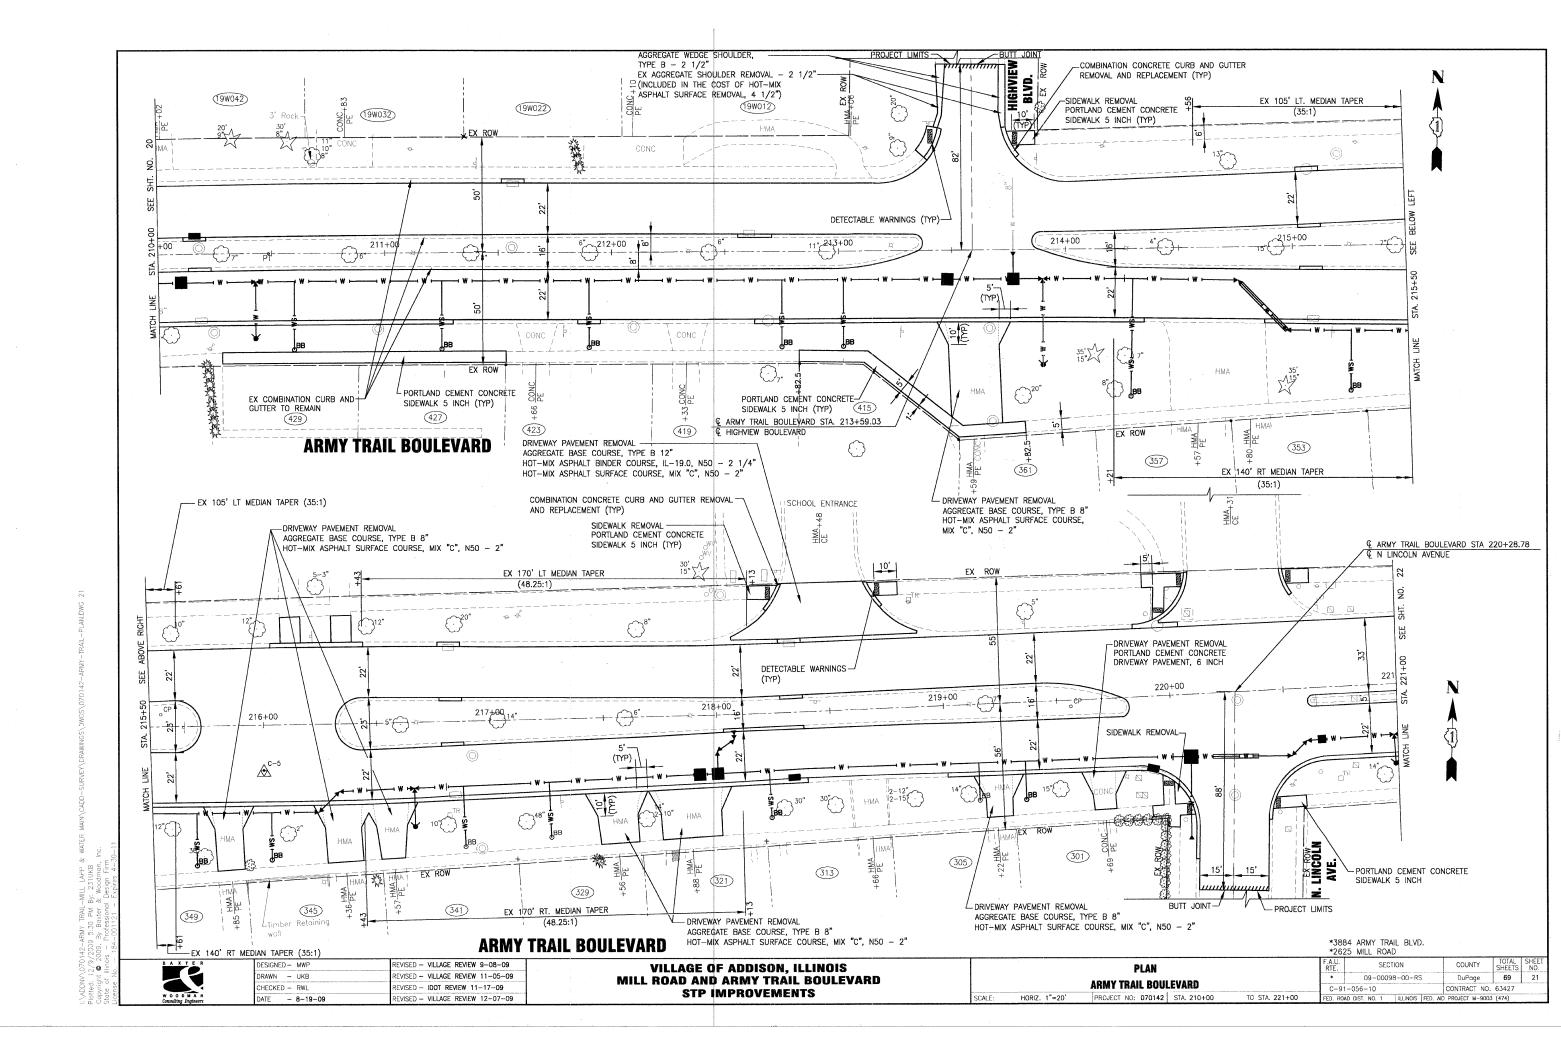


DESIGNED - MWP REVISED - VILLAGE REVIEW 9-08-09 DRAWN - UKB EVISED - VILLAGE REVIEW 11-05-09 EVISED - IDOT REVIEW 11-17-09

VILLAGE OF ADDISON, ILLINOIS **MILL ROAD AND ARMY TRAIL BOULEVARD** STP IMPROVEMENTS

ARMY TRAIL BOULEVARD/JOHN F KENNEDY DRIVE PROJECT NO: 070142 STA. 221+00

*3884 ARMY TRAIL BLVD. *2625 MILL ROAD TOTAL SHEET NO. 69 22 SECTION COUNTY DuPage 09-00098-00-RS CONTRACT NO. 63427 C-91-056-10

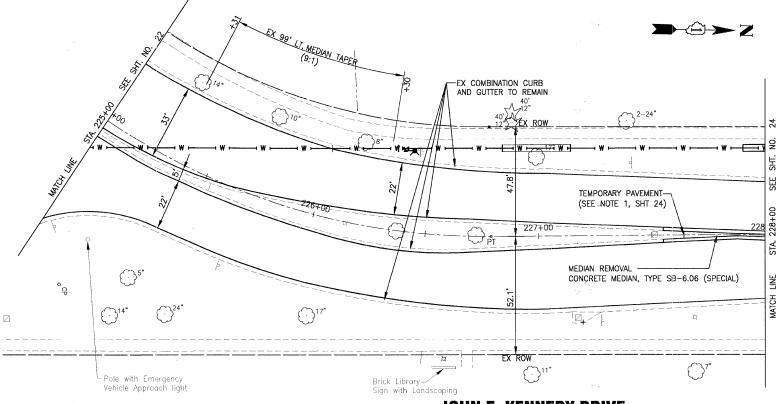

JOHN F. KENNEDY DRIVE

*3884 ARMY TRAIL BLVD. *2625 MILL ROAD



DESIGNED -	MWP	REVISED -	VILLA	GE RE	VIEW	9-08-09
DRAWN -	UKB	REVISED -	VILLA	GE RE	VIEW	11-05-0
CHECKED -	RWL	REVISED -	IDOT	REVIEW	V 11	-17-09
DATE -	8-19-09	REVISED -				

*3884 ARMY TRAIL BLVD. *2625 MILL ROAD

EVISED - VILLAGE REVIEW 9-08-09 RAWN - UKB EVISED - VILLAGE REVIEW 11-05-09 HECKED - RWL REVISED - IDOT REVIEW 11-17-09 ATE - 8-19-09 REVISED -

VILLAGE OF ADDISON, ILLINOIS MILL ROAD AND ARMY TRAIL BOULEVARD STP IMPROVEMENTS


COUNTY TOTAL SHEET NO.

DuPage 69 24 SECTION PLAN 09-00098-00-RS JOHN F. KENNEDY DRIVE PROJECT NO: 070142 STA. 228+00 TO STA. 233+00 HORIZ. 1"=20'

EMERGENCY ACCESS SHALL BE MAINTAINED AT ALL TIMES.

THE CONTRACTOR SHALL ADVISE ALL EMERGENCY RESPONDERS A MINIMUM OF 3 DAYS IN ADVANCE OF CONSTRUCTION ACTIVITIES WHICH IMPACT ALL EMERGENCY SERVICES. THIS WILL INCLUDE, BUT IS NOT LIMITED TO, THE ADDISON FIRE DEPARTMENT

- THE CONTRACTOR SHALL MAINTAIN EXISTING LANE WIDTHS FOR TRAFFIC FLOW THROUGHOUT THE DURATION OF THE CONTRACT UNLESS OTHERWISE DETERMINED BY THE ENGINEER
- ALL SIDE STREETS SHALL BE OPEN TO TRAFFIC THROUGHOUT THE DURATION OF THE CONTRACT UNLESS OTHERWISE NOTED IN THE SUGGESTED SEQUENCE OF CONSTRUCTION
- DURING MILL ROAD AND ARMY TRAIL BOULEVARD STAGE I AND II WATER MAIN WORK, THE VILLAGE WILL OPERATE THE MILL/ARMY TRAIL BOULEVARD AND LINCOLN/ARMY TRAIL BOULEVARD TRAFFIC SIGNALS IN FLASHING RED/STOP CONTROL MODE.
- THE CONTRACTOR SHALL NOTIFY THE VILLAGE A MINIMUM OF 72 HOURS PRIOR TO CONSTRUCTION OPERATIONS INVOLVING THE TEMPORARY CLOSING OF DRIVES OR THE ROADWAY. THE CONTRACTOR SHALL PROVIDE A 48-HOUR NOTICE TO AFFECTED PARTIES BY DISTRIBUTING WRITTEN NOTICES AND/OR POSTING SIGNS.
- BUSINESSES SHALL HAVE ACCESS TO THEIR DRIVES. THE SHELL GAS STATION ARMY TRAIL BOULEVARD DRIVEWAY SHALL BE CLOSED.
- THE ENGINEER SHALL BE INFORMED 72-HOURS IN ADVANCE OF ANY CHANGE IN CONSTRUCTION STAGING.
- TYPE I BARRICADES, BARRELS AND VERTICAL PANELS SHALL BE EQUIPPED WITH MONO-DIRECTIONAL STEADY BURN LIGHTS AND SHALL BE PLACED AT EITHER 25-FOOT OR 50-FOOT INTERVALS ALONG THE PROPOSED CONSTRUCTION ZONE PENDING LOCATION AND 20-FOOT INTERVALS WITHIN TAPER SECTIONS OR AS DETERMINED BY THE ENGINEER.
- LITHIZE TEMPORARY PAVEMENT MARKINGS ON MILL ROAD AND ARMY TRAIL BOLLEVARD. TEMPORARY PAVEMENT MARKINGS SHALL NOT DAMAGE EXISTING PAVEMENT MARKINGS TO REMAIN. ANY AND ALL REPLACEMENT OF EXISTING PAVEMENT MARKINGS, AS DETERMINED BY THE ENGINEER, SHALL BE INCLUDED IN THE COST FOR TRAFFIC CONTROL DETOUR.
- ALL TEMPORARY PAVEMENT MARKINGS SHOWING DETERIORATION SHALL BE REPLACED BY THE CONTRACTOR AS DETERMINED BY THE ENGINEER. ALL MARKINGS REQUIRING REPLACEMENT SHALL BE REPLACED BY THE CONTRACTOR AT THEIR
- THE FURNISHING, INSTALLING AND RELOCATION OF ALL TRAFFIC SIGNS SHALL BE INCLUDED IN THE COST FOR TRAFFIC CONTROL AND PROTECTION. ALL CONFLICTING TRAFFIC SIGNS AND TRAFFIC DETOUR SIGNS WHEN NOT IN USE ON MILL ROAD OR ARMY TRAIL BOULEVARD SHALL BE COVERED AS DETERMINED BY THE ENGINEER. THIS SHALL BE INCLUDED IN THE COST
- 11. CONTRACTOR SHALL INSTALL AND MAINTAIN SIGNAGE TO ESTABLISH A 20 MPH SPEED LIMIT THROUGHOUT THE CONSTRUCTION ZONE. SIGNAGE SHALL BE INCLUDED IN THE COST OF THE TRAFFIC CONTROL DETOUR. NUMBER AND PLACEMENT OF SIGNS SHALL BE AS DETERMINED BY THE ENGINEER AND VILLAGE.
- 12. ARMY TRAIL BOULEVARD IS DESIGNATED A "NO TRUCK ROUTE" FROM ROHLWING ROAD TO LAKE STREET. MILL ROAD AND ARMY TRAIL BOULEVARD ARE OFF LIMITS TO CONSTRUCTION TRUCK TRAFFIC EXCEPT WHERE THE WORK IS BEING PERFORMED. TRUCK TRAFFIC SHALL ONLY ACCESS THE JOBSITE THROUGH THE TWO INTERSECTIONS OF MILL ROAD AND JOHN F. KENNEDY DRIVE WITH LAKE STREET.

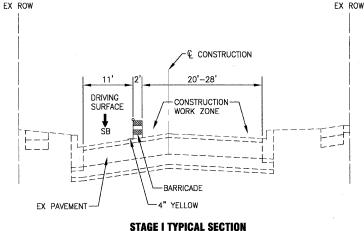

LOOKING NORTH (NOT TO SCALE)



EVISED - VILLAGE REVIEW 9-08-09 ESIGNED - MWI RAWN - UKB EVISED - VILLAGE REVIEW 11-05-09 HECKED - RWL EVISED - IDOT REVIEW 11-17-09 - 8-19-0 EVISED - VILLAGE REVIEW 12-07-09

VILLAGE OF ADDISON, ILLINOIS MILL ROAD AND ARMY TRAIL BOULEVARD STP IMPROVEMENTS

SUGGESTED SEQUENCE OF CONSTRUCTION

- 1. STAGE I CAN BEGIN ON OR AFTER JUNE 1, 2010.
 INSTALL TRAFFIC CONTROL SIGNAGE AND CHANGEABLE MESSAGE SIGNS. SET UP LANE CLOSURES AND SIGNAGE FOR ONE-WAY SOUTH BOUND STAGE I: MILL ROAD. REMOVE MEDIAN IN JOHN F. KENNEDY DRIVE AND REPLACE WITH TEMPORARY PAVEMENT AS SHOWN ON THE PLANS.
 - 2. ONE DAY PRIOR TO BEGINNING WATER MAIN AND STORM SEWER CONSTRUCTION, SHIFT ALL ARMY TRAIL BLVD. TRAFFIC TO THE EXISTING WESTBOUND PAVEMENT USING LANE CLOSURES IN THE HIGHWAY STANDARDS. ALLOW TRAFFIC TO TRAVEL IN ONE LANE IN EACH DIRECTION PER THE STAGE I TYPICAL SECTION. SET MILL ROAD AND ARMY TRAIL BOULEVARD AND LINCOLN AVENUE AND ARMY TRAIL BOULEVARD INTERSECTION TRAFFIC SIGNALS TO FLASHING RED/STOP CONTROL MODE.
 - 3. WATER MAIN AND STORM SEWER CONSTRUCTION SHALL NOT BEGIN UNTIL AFTER SCHOOL DISTRICT 4'S 2009/10 YEAR ENDS (JUNE 4, 2010, WINTER WEATHER PERMITTING).
 - 4. INSTALL WATER MAINS ALONG MILL ROAD AND ARMY TRAIL BOULEVARD. CONSTRUCT STORM SEWER ACROSS PORTIONS OF ROADWAYS CLOSED TO TRAFFIC ONLY. TEMPORARILY PLUG LATERALS TO BE EXTENDED IN FUTURE STAGE II. PROVIDE TEMPORARY PAVEMENT ON WATER MAIN AND STORM SEWER TRENCHES AT LOCATIONS OPEN TO TRAFFIC AND INTERSECTIONS AT THE END OF EACH DAY OR AS DETERMINED BY THE ENGINEER.
 - 5. ACTIVATE INSTALLED WATER MAIN. THE CONTRACTOR SHALL NOTIFY THE VILLAGE AND ENGINEER THREE (3) WEEKS PRIOR TO CLOSING THE MILL ROAD AND ARMY TRAIL BOULEVARD INTERSECTION FOR STAGE II.
 - 6. ONE WEEK PRIOR TO CLOSING THE MILL ROAD AND ARMY TRAIL BOULEVARD INTERSECTION (FOR STAGE II), BEGIN INSTALLING STAGE II DETOUR SIGNAGE AND COVER STAGE II SIGNS.
- 1. AFTER MONDAY EVENING RUSH HOUR TRAFFIC (OR AFTER 7:30 P.M. WHICH EVER IS LATER), CLOSE THE MILL ROAD AND ARMY TRAIL BOULEVARD INTERSECTION. UNCOVER STAGE II SIGNS AND COVER APPROPRIATE STAGE I SIGNS. TURN MILL ROAD AND ARMY TRAIL BOULEVARD INTERSECTION TRAFFIC SIGNALS OFF. MAINTAIN FLASHING RED/STOP CONTROL MODE AT ARMY TRAIL BOULEVARD AND LINCOLN AVENUE.


INSTALL REMAINING WATER MAIN AND STORM SEWER ON TUESDAY, WEDNESDAY AND THURSDAY. PROVIDE TEMPORARY PAVEMENT ON WATER MAIN AND STORM SEWER TRENCHES AT LOCATIONS OPEN TO TRAFFIC AND INTERSECTIONS AT THE END OF EACH DAY OR AS DETERMINED BY THE ENGINEER.

AFTER THURSDAY EVENING RUSH HOUR TRAFFIC (OR AFTER 7:30 P.M. WHICH EVER IS LATER), RETURN MILL ROAD AND ARMY TRAIL BOULEVARD TO STAGE I. COVER/REMOVE STAGE II SIGNS AND UNCOVER STAGE I SIGNS. SET MILL ROAD AND ARMY TRAIL BOULEVARD INTERSECTION TRAFFIC SIGNALS TO FLASHING RED/STOP CONTROL MODE.

(IF WATER MAIN TESTING FAILS, REPEAT STAGE I AND II AS NECESSARY AFTER COORDINATION WITH THE VILLAGE AND ENGINEER).

- 2. ACTIVATE REMAINING WATER MAIN. COMPLETION DATE AUGUST 20, 2010 (67 CALENDAR DAYS IF CONSTRUCTION BEGINS JUNE 14, 2010). ACTIVATION OF REMAINING WATER MAIN SHALL BE COMPLETED BEFORE SCHOOL DISTRICT 4'S 2010/11 YEAR BEGINS (THE WEEK OF AUGUST 23, 2010).
- 3. COMPLETE MILLING, PATCHING, AND CURB AND GUTTER REMOVAL AND REPLACEMENT.
- 4. REMOVE LANE CLOSURES AND SIGNAGE. RESTORE MILL ROAD AND ARMY TRAIL BOULEVARD AND LINCOLN AVENUE AND ARMY TRAIL BOULEVARD INTERSECTION TRAFFIC SIGNALS TO NORMAL OPERATION. OPEN ROADWAYS TO NORMAL LANE CONFIGURATIONS.

- COMPLETION: 1. COMPLETE RESURFACING AND PAVEMENT MARKINGS UNDER TRAFFIC.
 - 2. SUBSTANTIAL COMPLETION.
 - 3. CONDUCT WALK THROUGH INSPECTION WITH VILLAGE AND ENGINEER.
 - 4. COMPLETE PUNCH LIST ITEMS.
 - 5. REMOVE CHANGEABLE MESSAGE SIGNS.
 - 6. FINAL COMPLETION DATE IS OCTOBER 28, 2010 WHICH IS 136 CALENDAR DAYS AFTER JUNE 14, 2010.

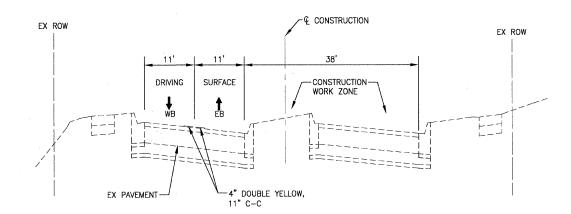

STAGE I TYPICAL SECTION ARMY TRAIL BOULEVARD/JOHN F. KENNEDY DRIVE


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*3884 ARMY TRAIL BLVD.


		*2625	5 MILL ROAD			
CONSTRUCTION STAGING		F.A.U. SECTION		COUNTY	TOTAL SHEETS	
			09-00098-00-RS	DuPage	69	
		C-91	-056-10	CONTRACT NO.	63427	
PROJECT NO: 070142 STA	TO STA	EED DO	ID DICT NO 1 PLINOIS SED	AID DROIECT M-0003	(474)	


MILL ROAD

25

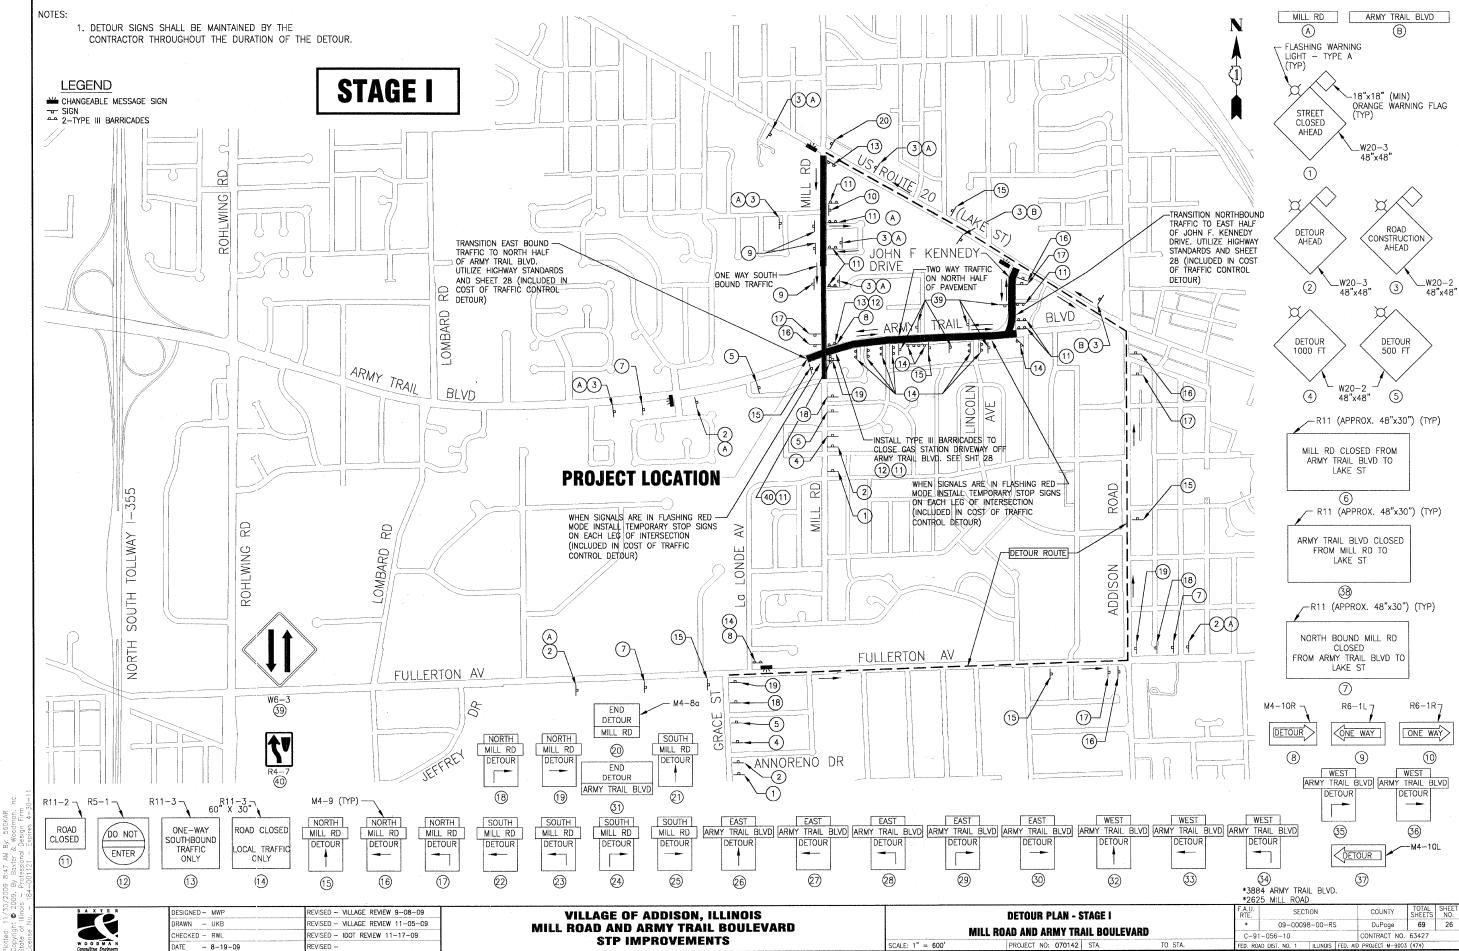

TRALL-MILL LAPP & WATER MAIN\CADD-SURVEY\DRAWINGS\DWGS\070142-DETOUR.DWG 26

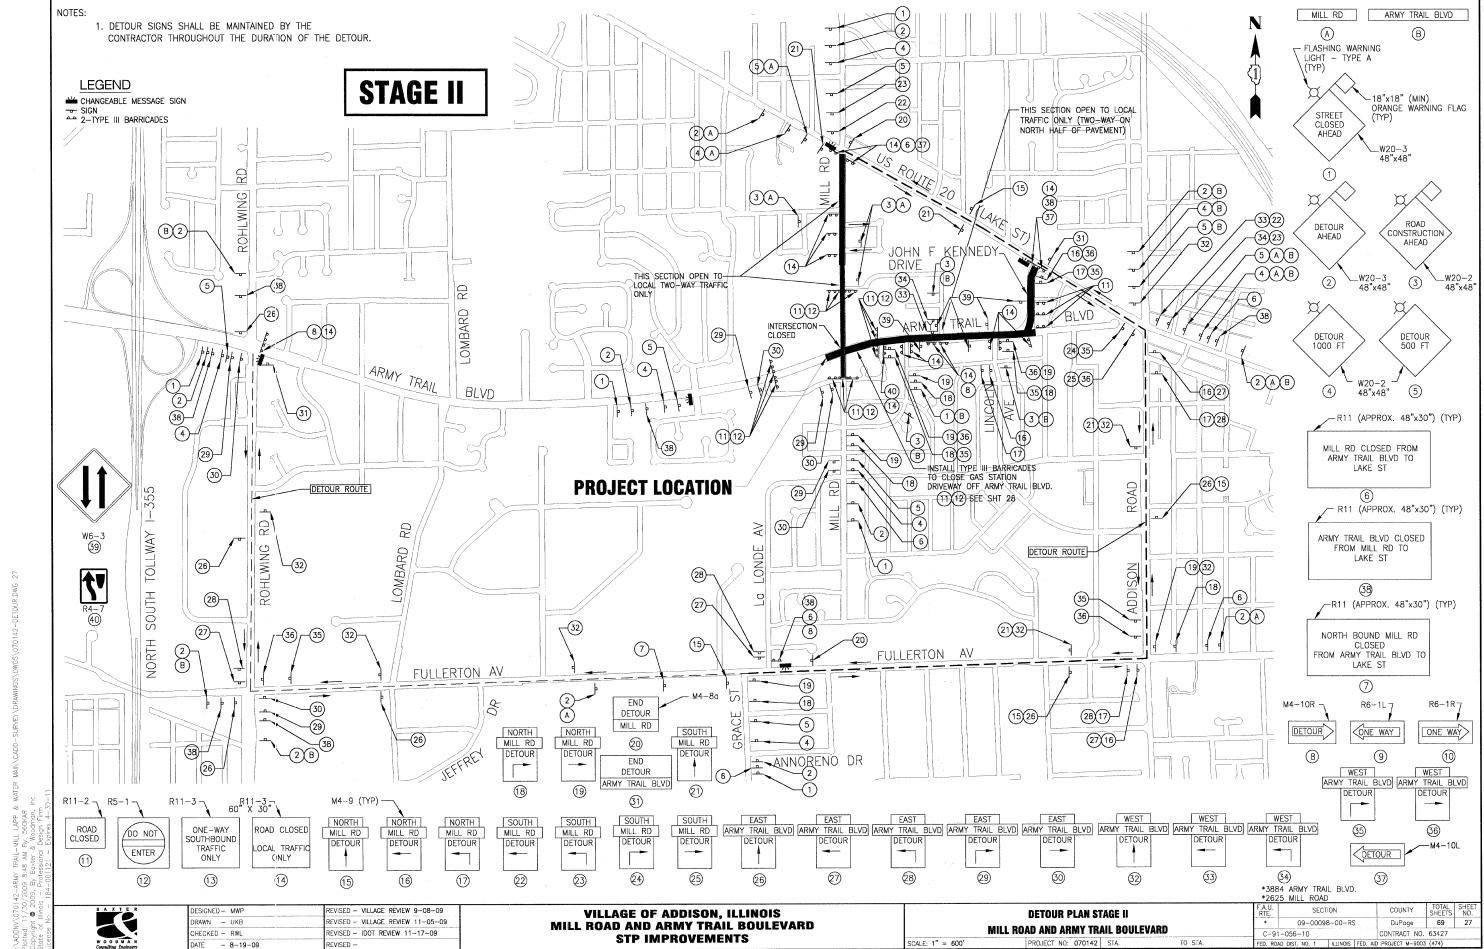


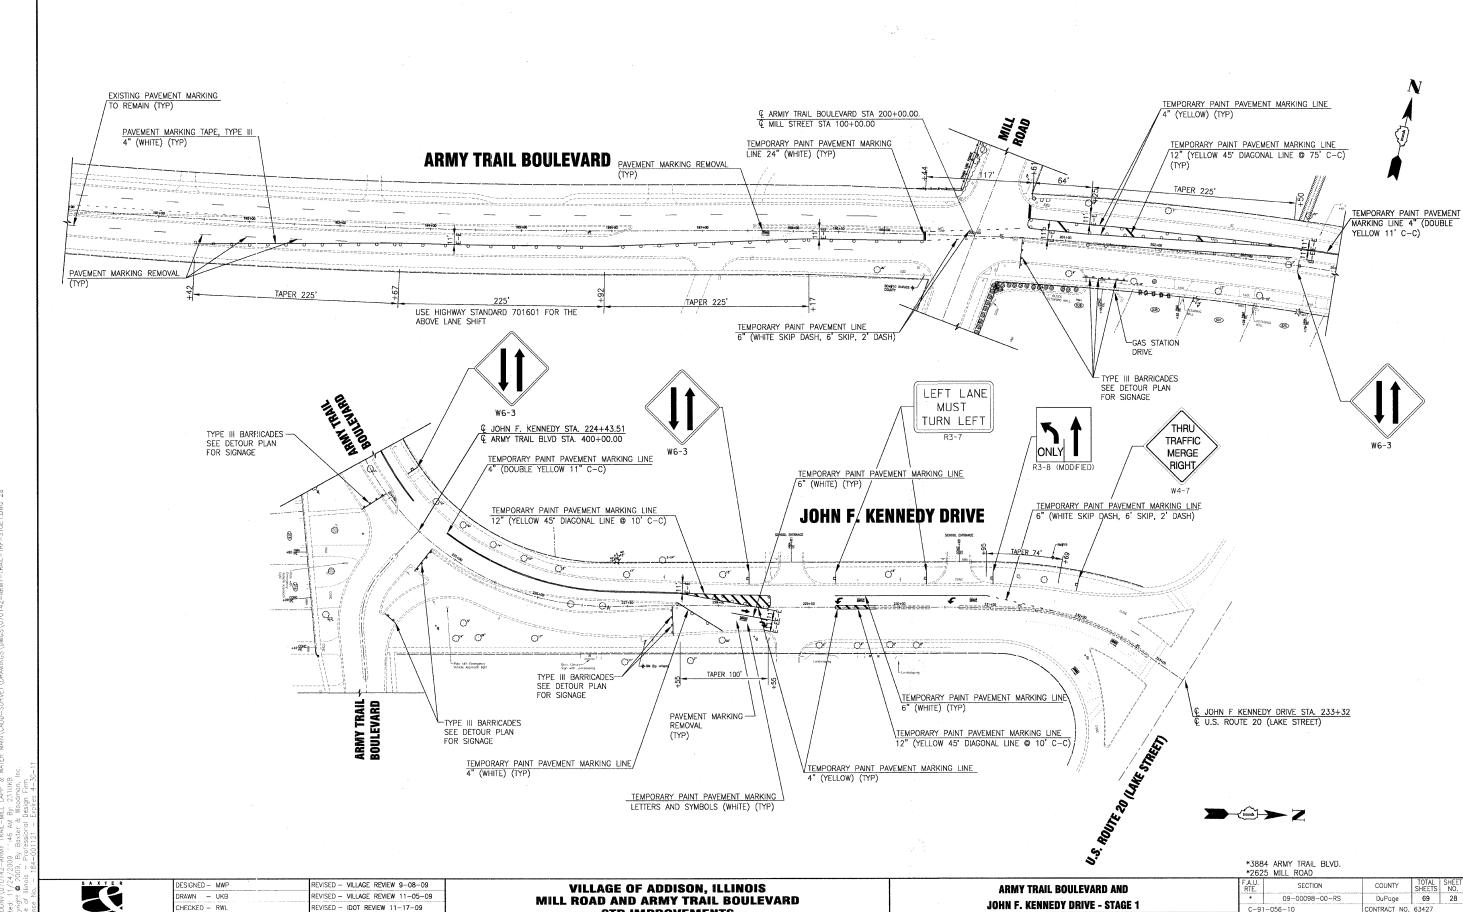



REVISED - IDOT REVIEW 11-17-09


STP IMPROVEMENTS


HORIZ. 1"=50' PROJECT NO: 070142 STA. 189+50 C-91-056-10

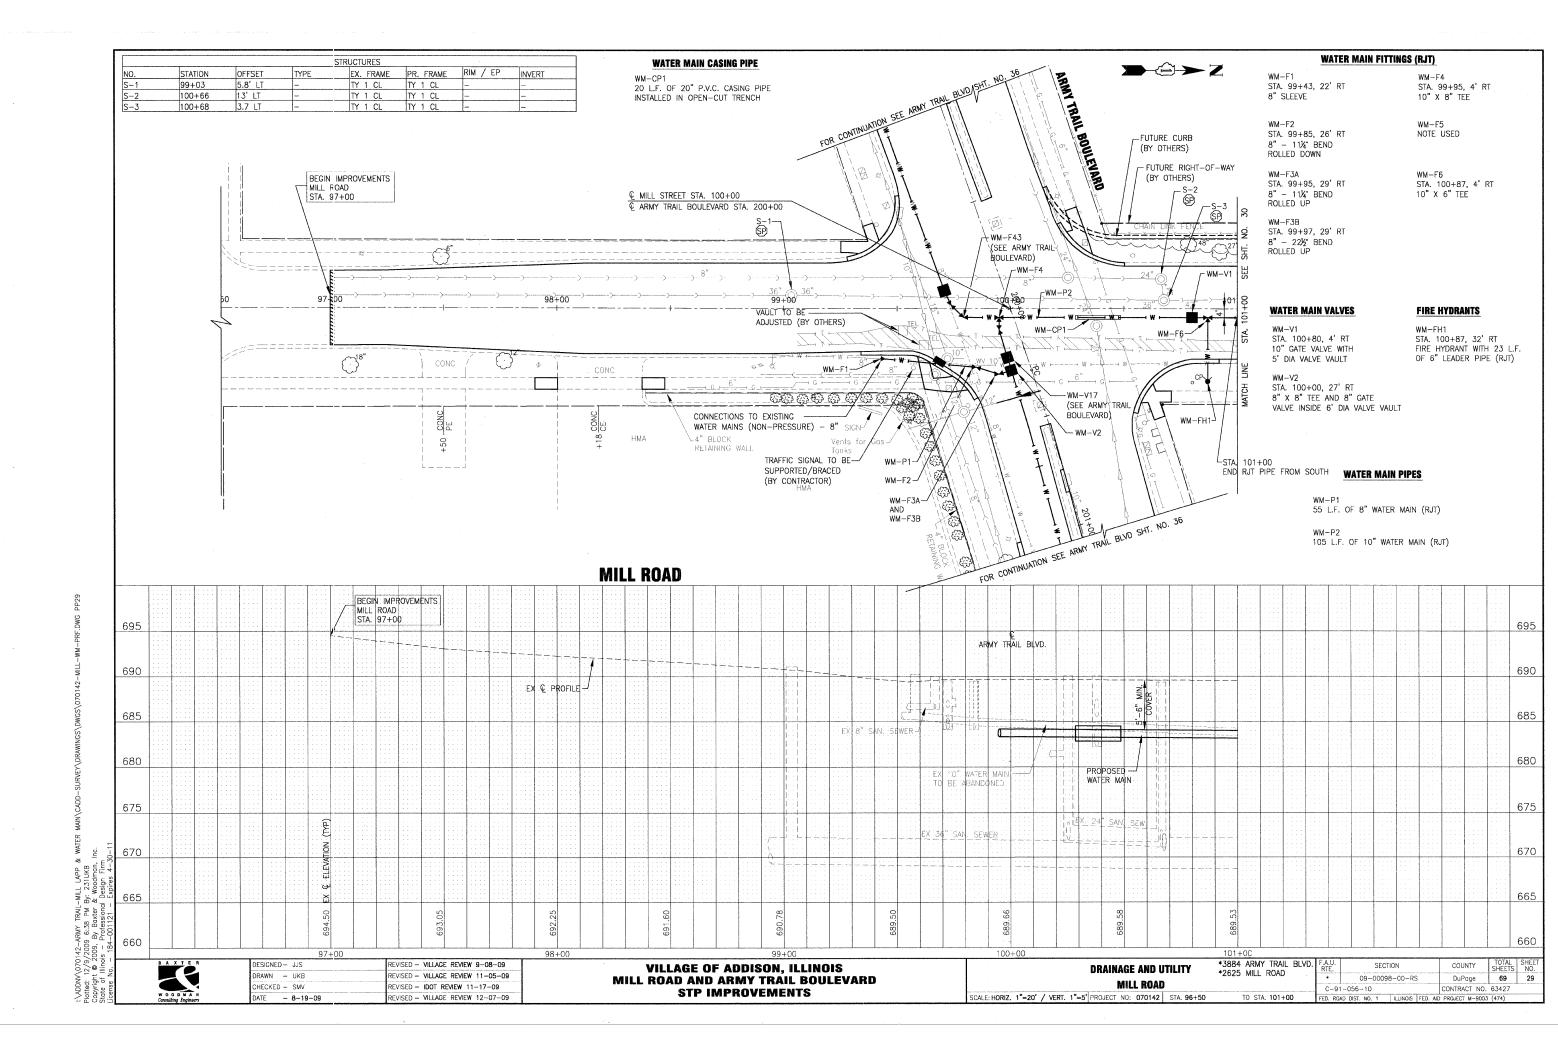


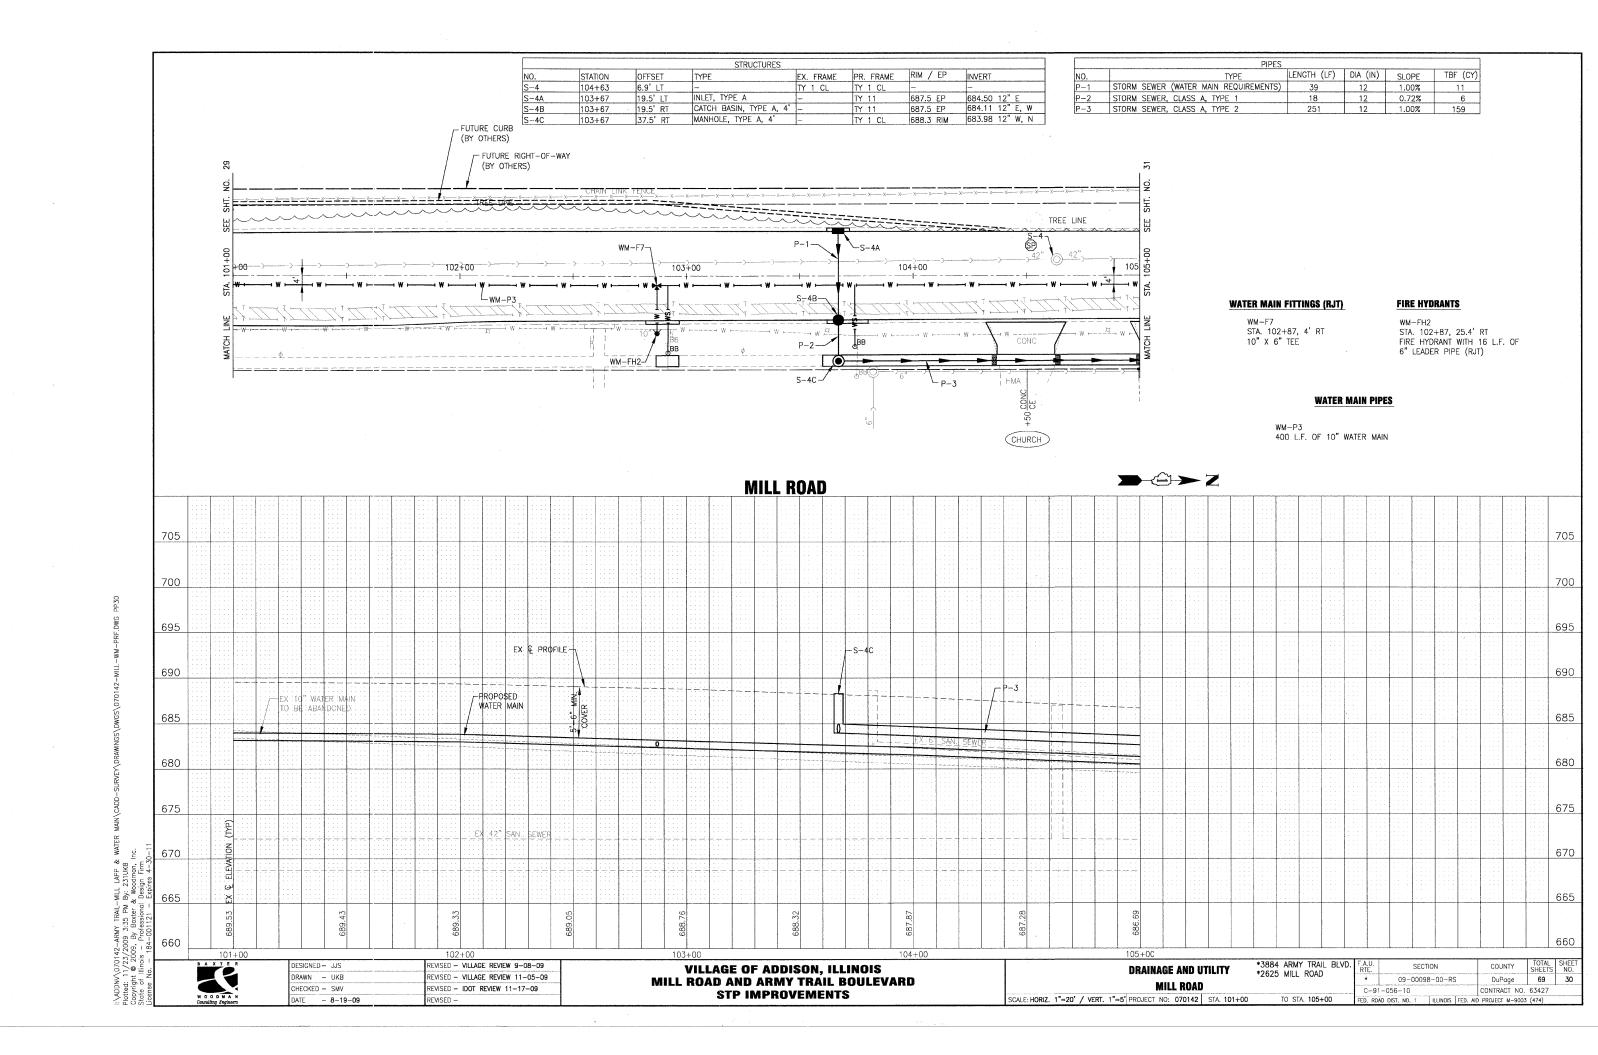

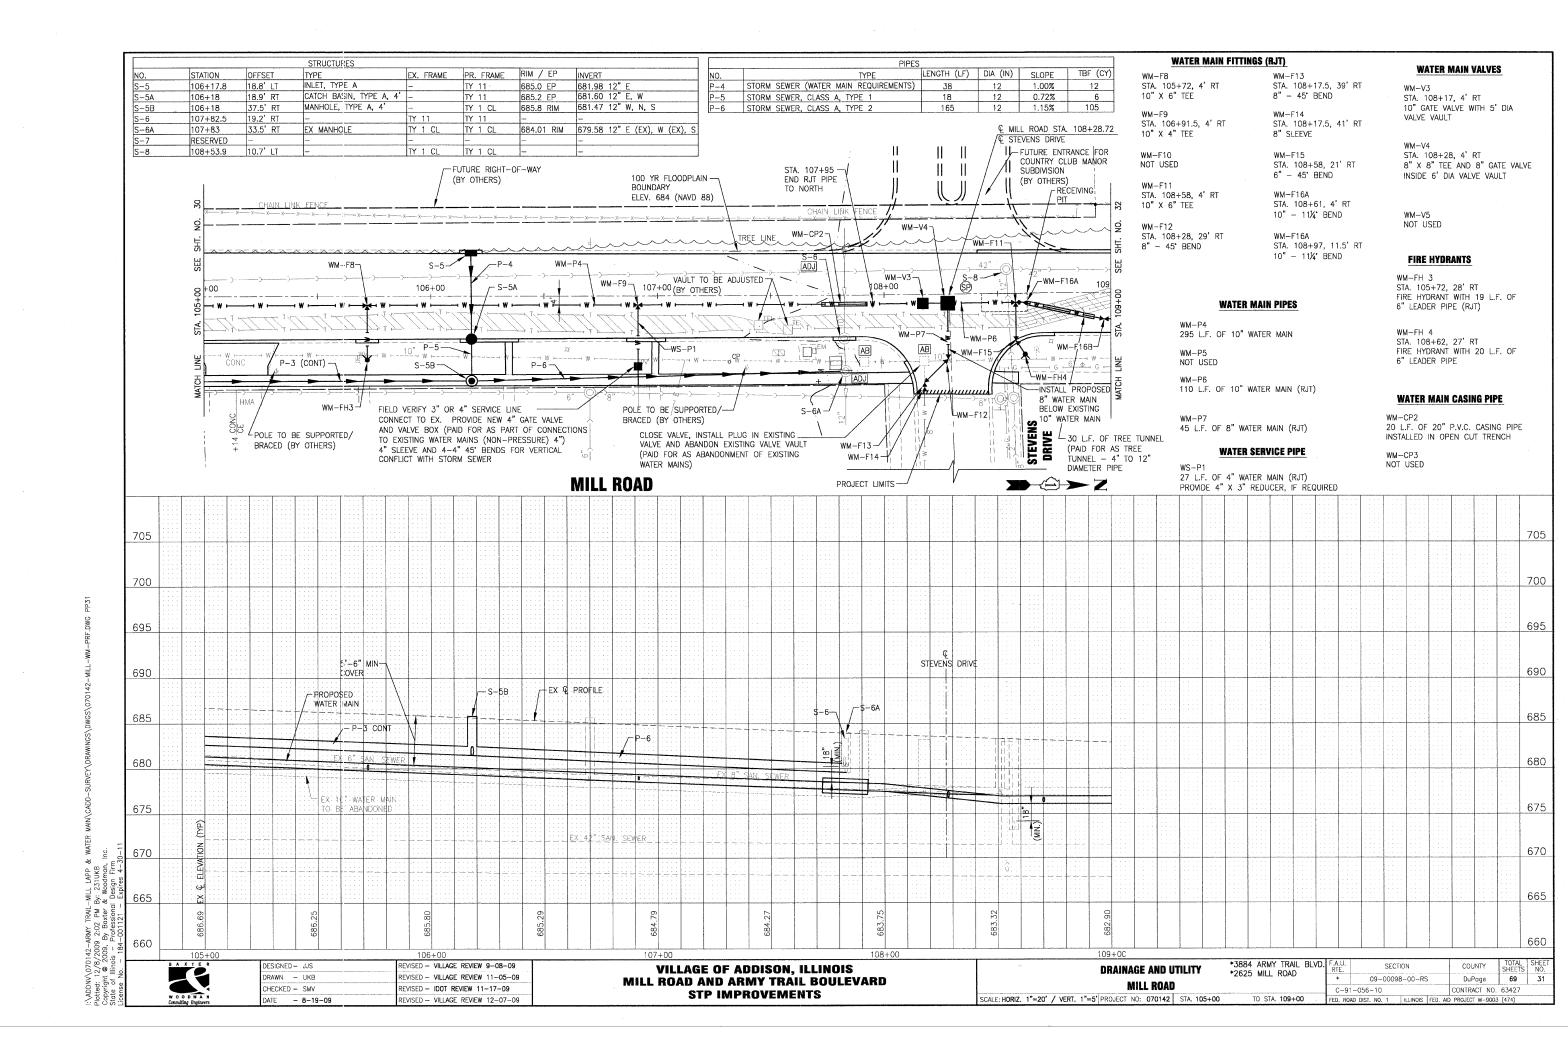

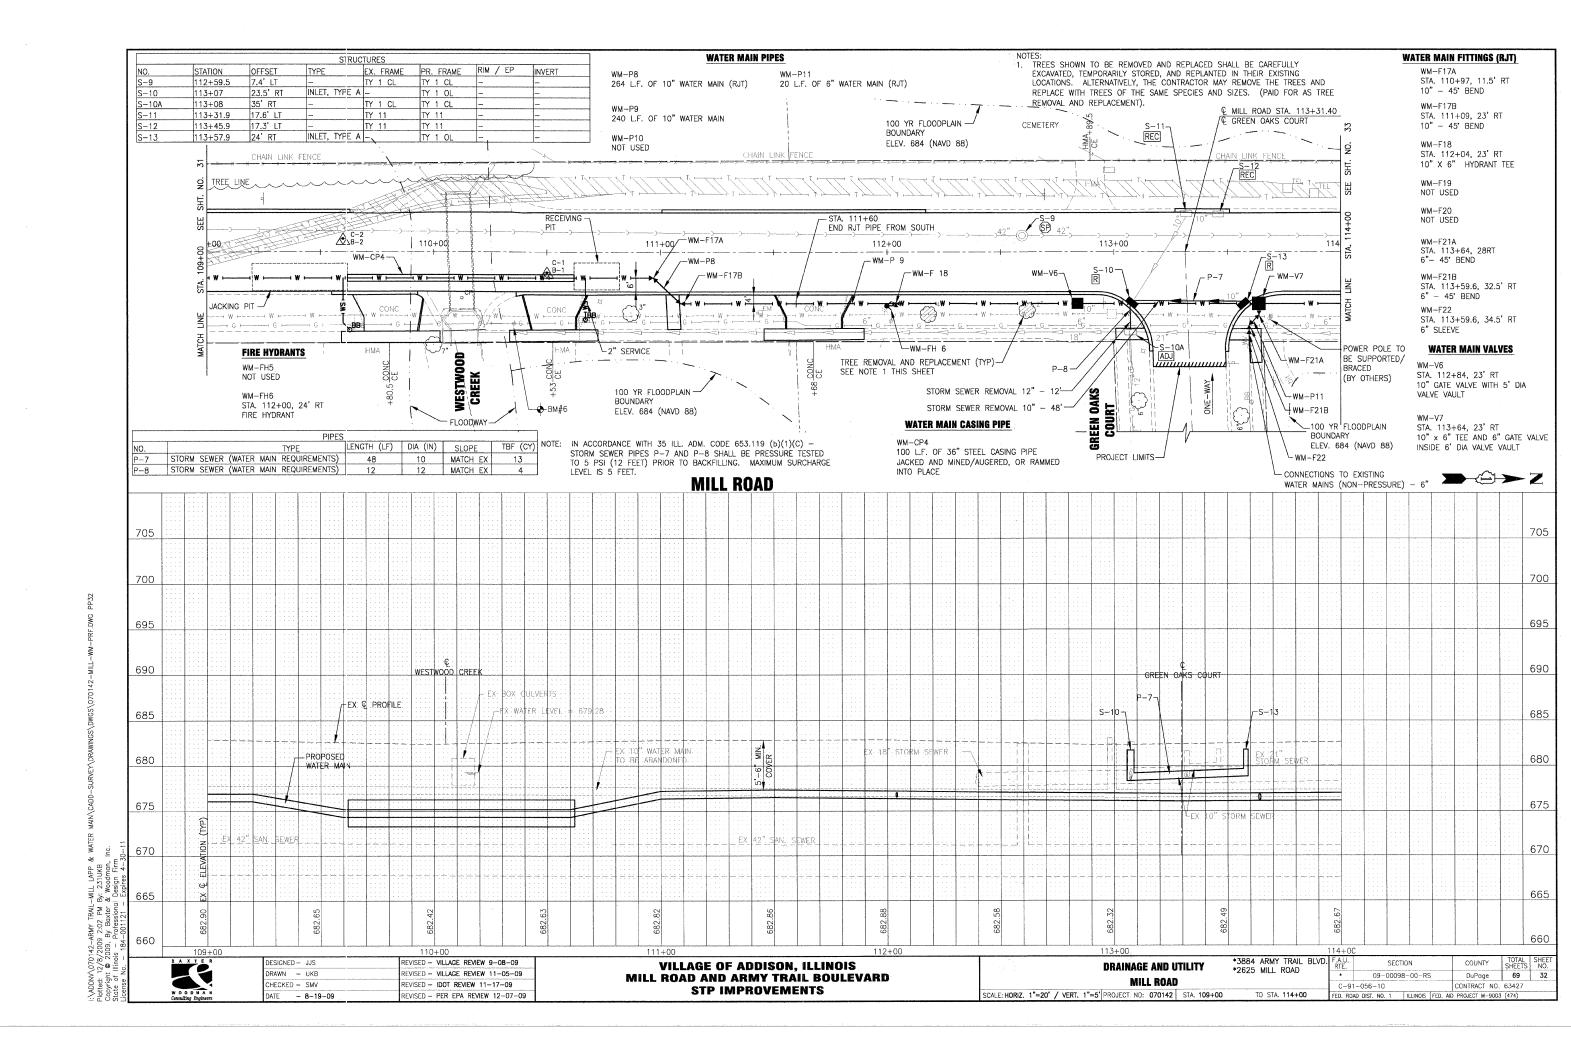


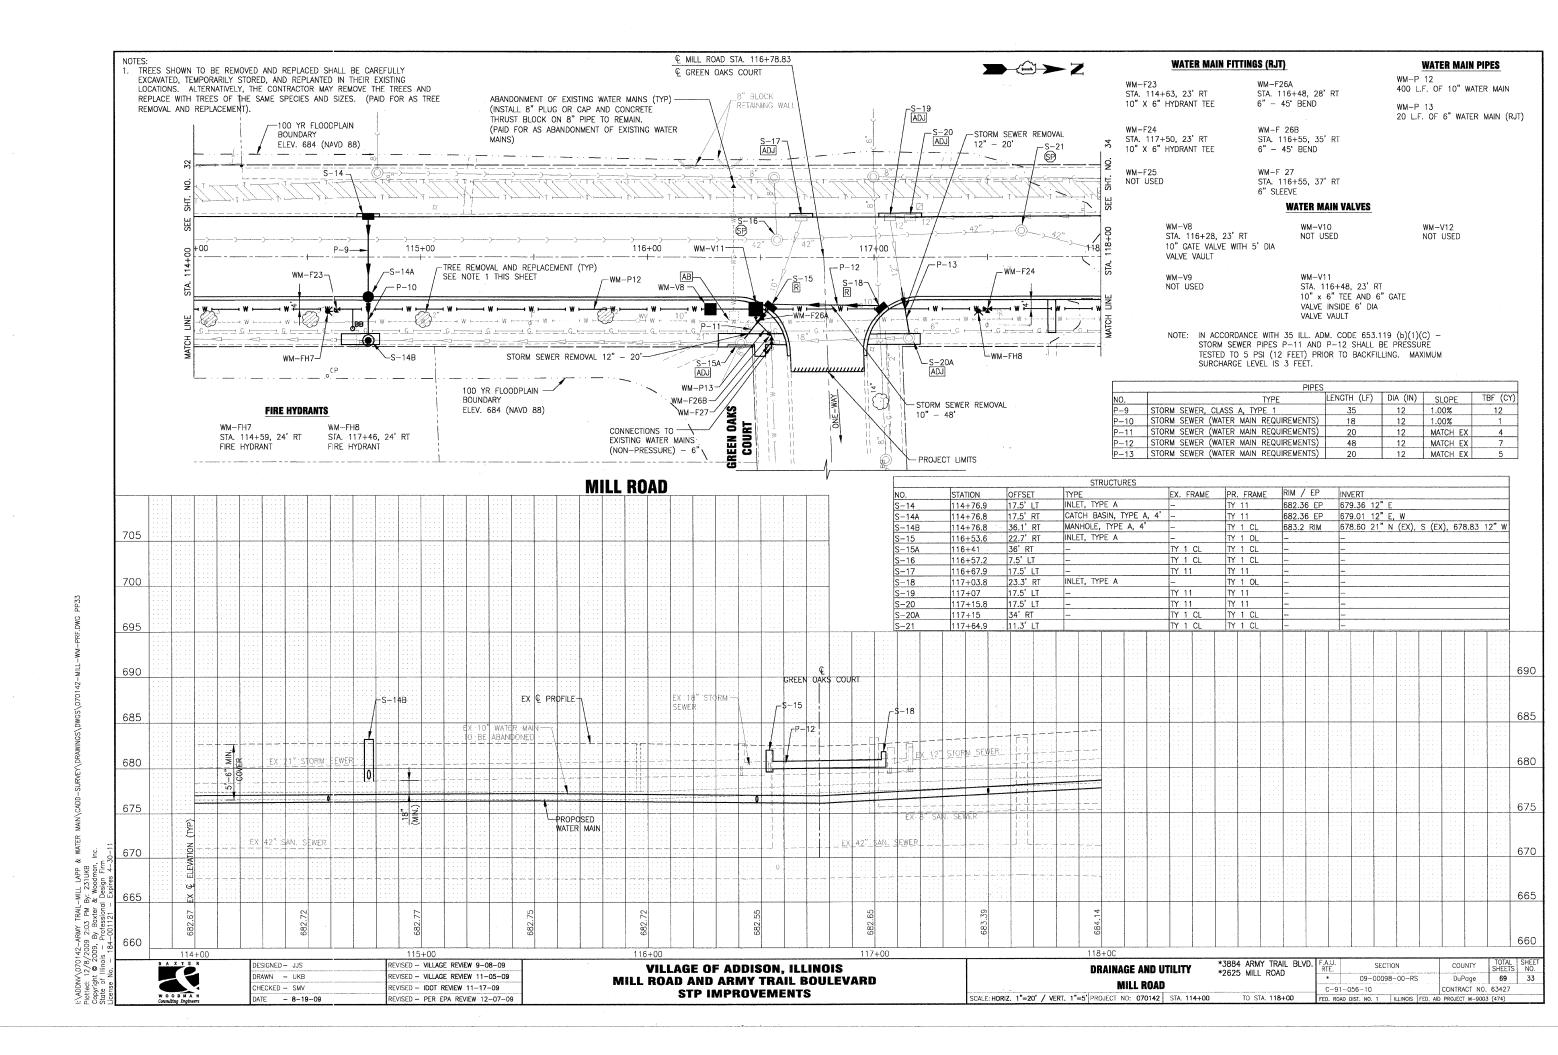


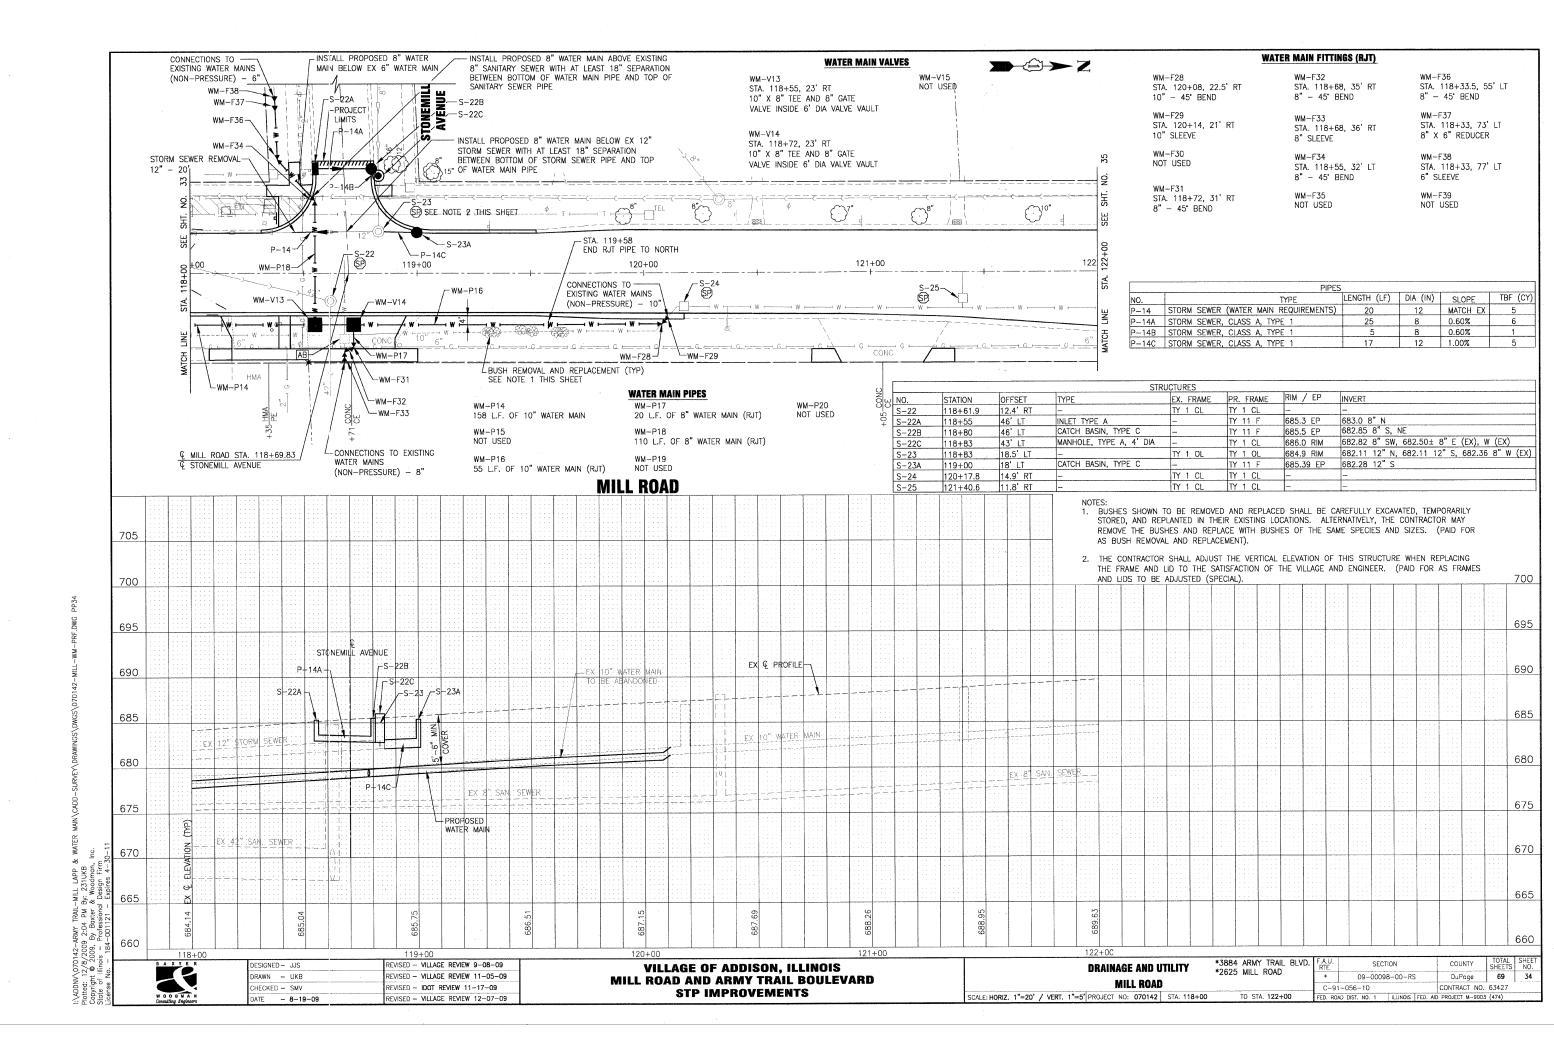


CONC END IMPROVEMENTS
MILL ROAD
STA. 125+63 S-26-SP 126+00 НМА 123+00 124+00 125+00 Q MILL ROAD STA. 126+88 Q U.S. ROUTE 20 (LAKE STREET) +38 CE HMA STRUCTURES RIM / EP NO. S-26 STATION OFFSET EX. FRAME PR. FRAME INVERT TY 1 CL 123+91.6 11.9' RT TY 1 CL 34' LT S-26A 123+63 **MILL ROAD** 705 705 700 700 END IMPROVEMENTS MILL ROAD STA. 125+63 695 695 EX & PROFILE -690 690 685 685 680 680 675 675 670 670 665 665 660 660 124+00 COUNTY TOTAL SHEET NO.


DuPage 69 35 *3884 ARMY TRAIL BLVD. F.A.U. *2625 MILL ROAD F.A.U. DESIGNED - JJS REVISED - VILLAGE REVIEW 9-08-09 VILLAGE OF ADDISON, ILLINOIS MILL ROAD AND ARMY TRAIL BOULEVARD SECTION DRAINAGE AND UTILITY DRAWN - UKB REVISED - VILLAGE REVIEW 11-05-09 09-00098-00-RS MILL ROAD CHECKED - SMV REVISED - IDOT REVIEW 11-17-09 CONTRACT NO. 63427 C-91-056-10 **STP IMPROVEMENTS** SCALE: HORIZ. 1"=20' / VERT. 1"=5' PROJECT NO: 070142 STA. 122+00 DATE - 8-19-09 TO STA. 125+63

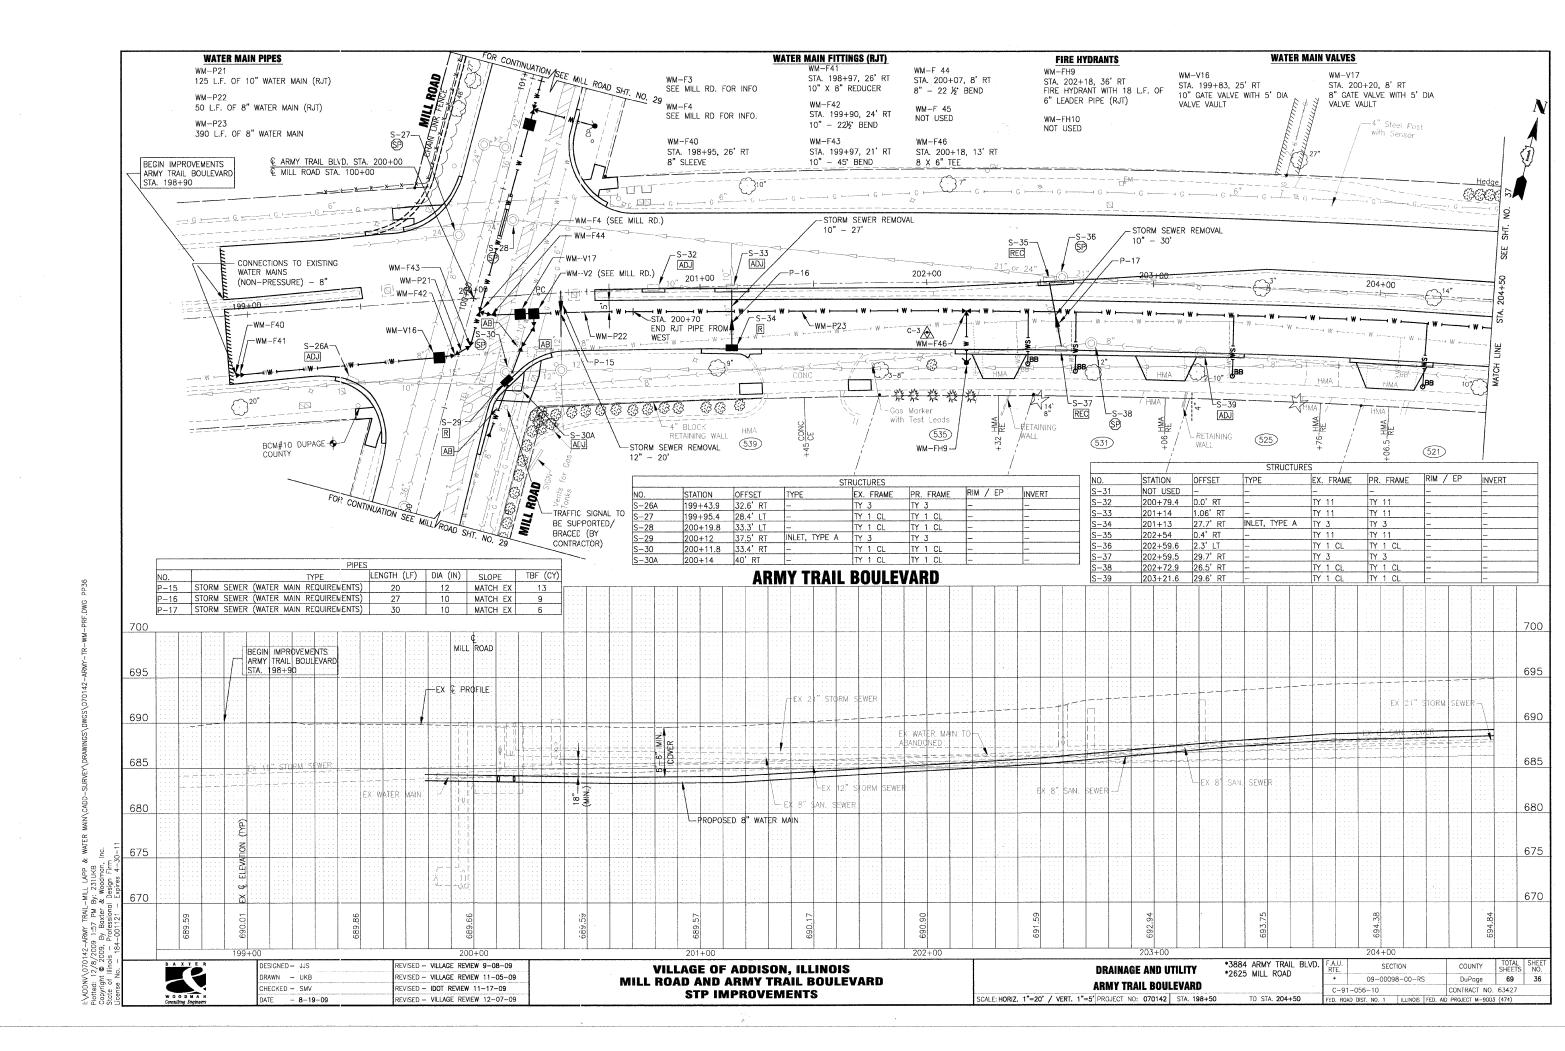


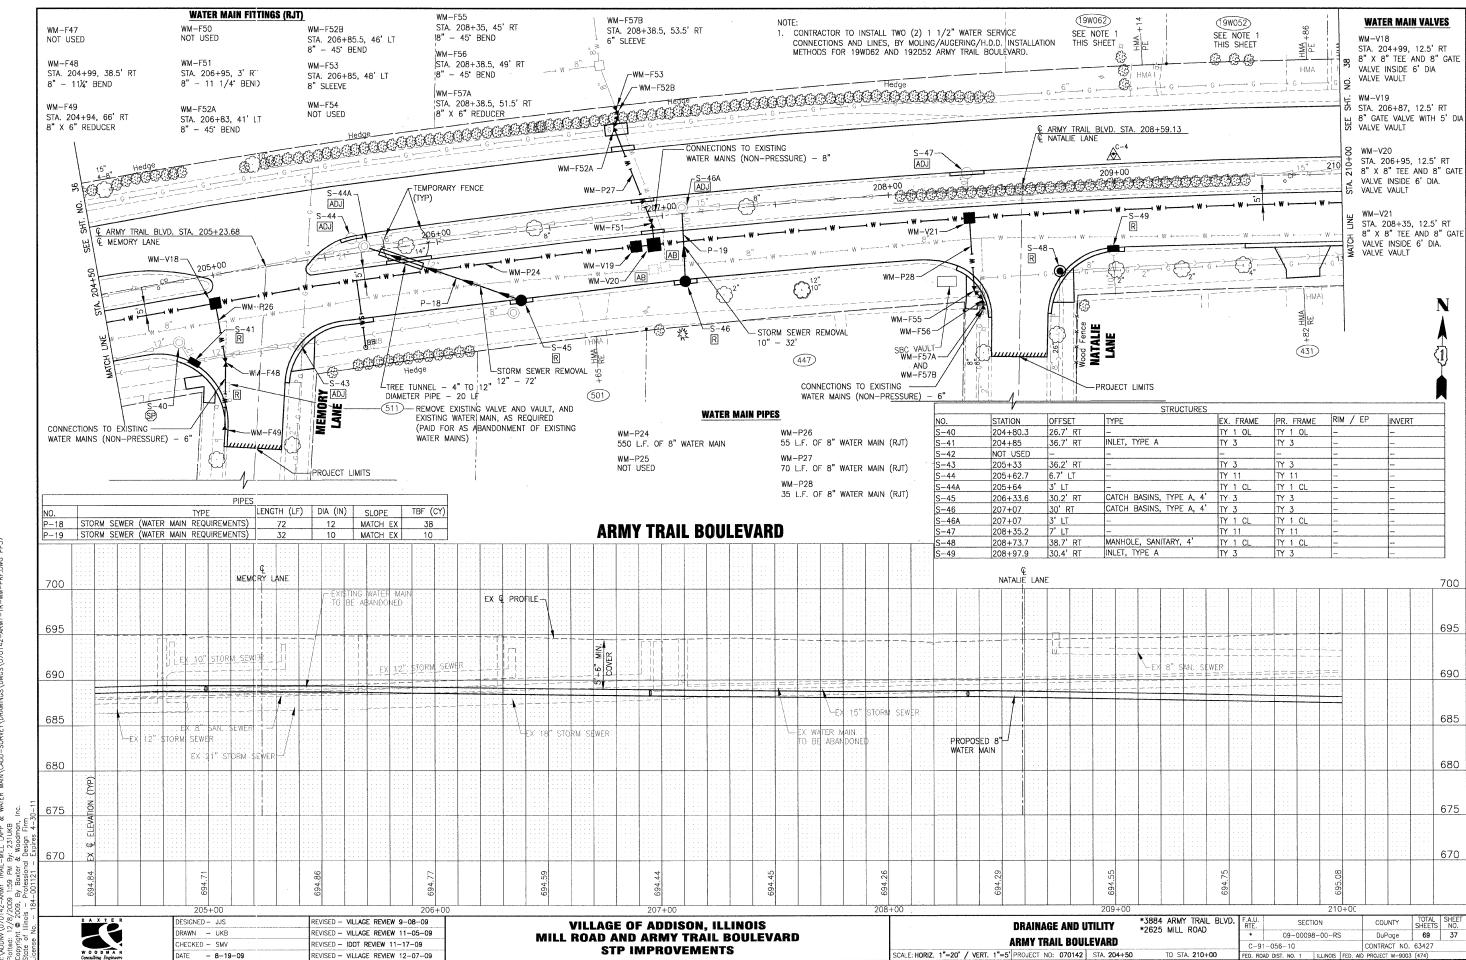

WATER MAIN PIPES FIRE HYDRANTS HIGHVIEW BLVD. © ARMY TRAIL BLVD. STA. 213+59.03 WM-P30 BM#13-WM-P29 WM--P31 WM-FH11 WM-FH12 WM-P33 NOT USED 131 L.F. OF 8" WATER MAIN (RJT) & HIGHVIEW BLVD. 426 L.F. OF 8" WATER MAIN 10 STA. 210+43, 37.5' RT STA. 213+90, 51' RT 15 L.F. OF 8" WATER MAIN (RJT) PROJECT LIMITS FIRE HYDRANT WITH 20 L.F. FIRE HYDRANT WITH 33 L.F (19W042) CONNECTIONS TO EXISTING (19W012) OF 6" LEADER PIPE (RJT) OF 6" LEADER PIPE (RJT) (19W022) WATER MAINS (NON-PRESSURE) - 8" SEE NOTE (19W032) NOT USED SEE NOTE 1 THIS SHEET SEE NOTE 1 THIS SHEET THIS SHEET SEE NOTE THIS SHEET STORM SEWER REMOVAL--P-22 -S-50 10" - 65' STORM SEWER REMOVAL -WM-F59 S-52 --ADJ 10" - 117' -S-52A /_WM-P33 STA. 214+26 END RJT PIPE TO EAST SANITARY SEWER REMOVAL STORM SEWER REMOVAL ADJ 8" - 20' P-21C ~215+00 214+00 212+90 11" 213+00 211+00 P-21B -WM-P31 REC ADJ ~wм_F61 -WM-P29 WM-F64-AB . ADJ P-20A-WM-V22-WM-CP6-S-54A WM-F66 IBB W HMA S-54B -WM-FH12 -SANITARY SEWER REMOVAL - SANITARY SEWER REMOVAL ∠wm-FH11 P-20 -8" - 20' 8" -- 20' 415 (427) WATER MAIN FITTINGS (RUT) (429) (423) WM-F65 WM-F58 WM-F62 STRUCTURES STA. 210+43, 12.5' RT NOT USED NOT USED SANITARY SEWER REMOVAL 353 RIM / EP 8" X 6" TEE STATION OFFSET EX. FRAME PR. FRAME INVERT 8" - 28' TY 11 210+14.5 S-50 WM-F59 WM-F63 WM-F66 (361) MOLE/AUGER SERVICE S-50A 210+15 TY 1 CL NOT USED STA. 214+97, 37' RT STA. 213+77, 3' RT **WATER MAIN CASING PIPE** BEYOND TREES 29.8' RT 210+18.9 WATER MAIN VALVES 8" SLEEVE 8" - 45° BEND 211+56.7 30.4' LT WM-V22 211+57 TY 1 CL WM-F64 WM-F60 STA. 210+10 12.5' RT STA. 213+77 13' RT NOT USED 212+60.7 7.8' LT TY 11 TY 11 STA. 214+76, 24.7' RT 8" X 8" TEE AND 8" GATE VALVE NOT USED 8" GATE VALVE WITH 5' DIA. 8" - 45' BEND 5-54 212+69 VALVE VAULT INSIDE 6' DIA. VALVE VAULT TY 1 CL -54A 213+67 35' RT WM-CP6 WM-F61 TY 1 CL 30 L.F. OF 20" P.V.C. CASING PIPE -54B 213+69 TY 1 CL STA. 213+90, 13' RT WM-V25 WM-V23 33.5' LT INSTALLED IN OPEN CUT TRENCH TY 3 215+06.7-55 8" X 6" TEE STA. 213+48 13' RT NOT USED S-56 215+08.8 32.5' RT ITY 3 8" GATE VALVE WITH 5' DIA. **ARMY TRAIL BOULEVARD** VALVE VAULT PIPES LENGTH (LF) DIA (IN) SLOPE TBF (CY) 1. CONTRACTOR TO INSTALL FOUR (4) 1 1/2" WATER SERVICE CONNECTIONS STORM SEWER (WATER MAIN REQUIREMENTS) MATCH EX AND LINES, BY MOLING/AUGERING/H.D.D. INSTALLATION METHODS FOR SANITARY SEWER (WATER MAIN REQUIREMENTS) MATCH EX 10 19W042, 19W032,19W022, AND 19W012 ARMY TRAIL BOULEVARD. STORM SEWER (WATER MAIN REQUIREMENTS) MATCH EX 38 P-21A SANITARY SEWER (WATER MAIN REQUIREMENTS) MATCH EX 10 HIGHVIEW BLVD. P-21B SANITARY SEWER (WATER MAIN REQUIREMENTS) 10 MATCH EX P-21C SANITARY SEWER (WATER MAIN REQUIREMENTS) MATCH EX 14 700 700 P-22 STORM SEWER, CLASS A, TYPE 10 MATCH EX EX & PROFILE -695 695 690 690 STORM SEWER LEX 8" SAN. SEWER 685 685 EX 12" STORM SEWER WATER MAIN 680 680 675 675 MY TRAIL-1:47 PM Baxter & *3884 ARMY TRAIL BLVD. F.A.U. RTE. DESIGNED - JJS EVISED - VILLAGE REVIEW 9-08-09 SECTION COUNTY **VILLAGE OF ADDISON, ILLINOIS DRAINAGE AND UTILITY** *2625 MILL ROAD DRAWN - UKB EVISED - VILLAGE REVIEW 11-05-09 09-00098-00-RS DuPage 69 38 MILL ROAD AND ARMY TRAIL BOULEVARD **ARMY TRAIL BOULEVARD** CHECKED - SMV EVISED - IDOT REVIEW 11-17-09 CONTRACT NO 63427 **STP IMPROVEMENTS** REVISED -SCALE: HORIZ. 1"=20' / VERT. 1"=5' PROJECT NO: 070142 STA. 210+00 TO STA. 215+50 ILLINOIS FED. AID PROJECT M-9003 (474) DATE - 8-19-09

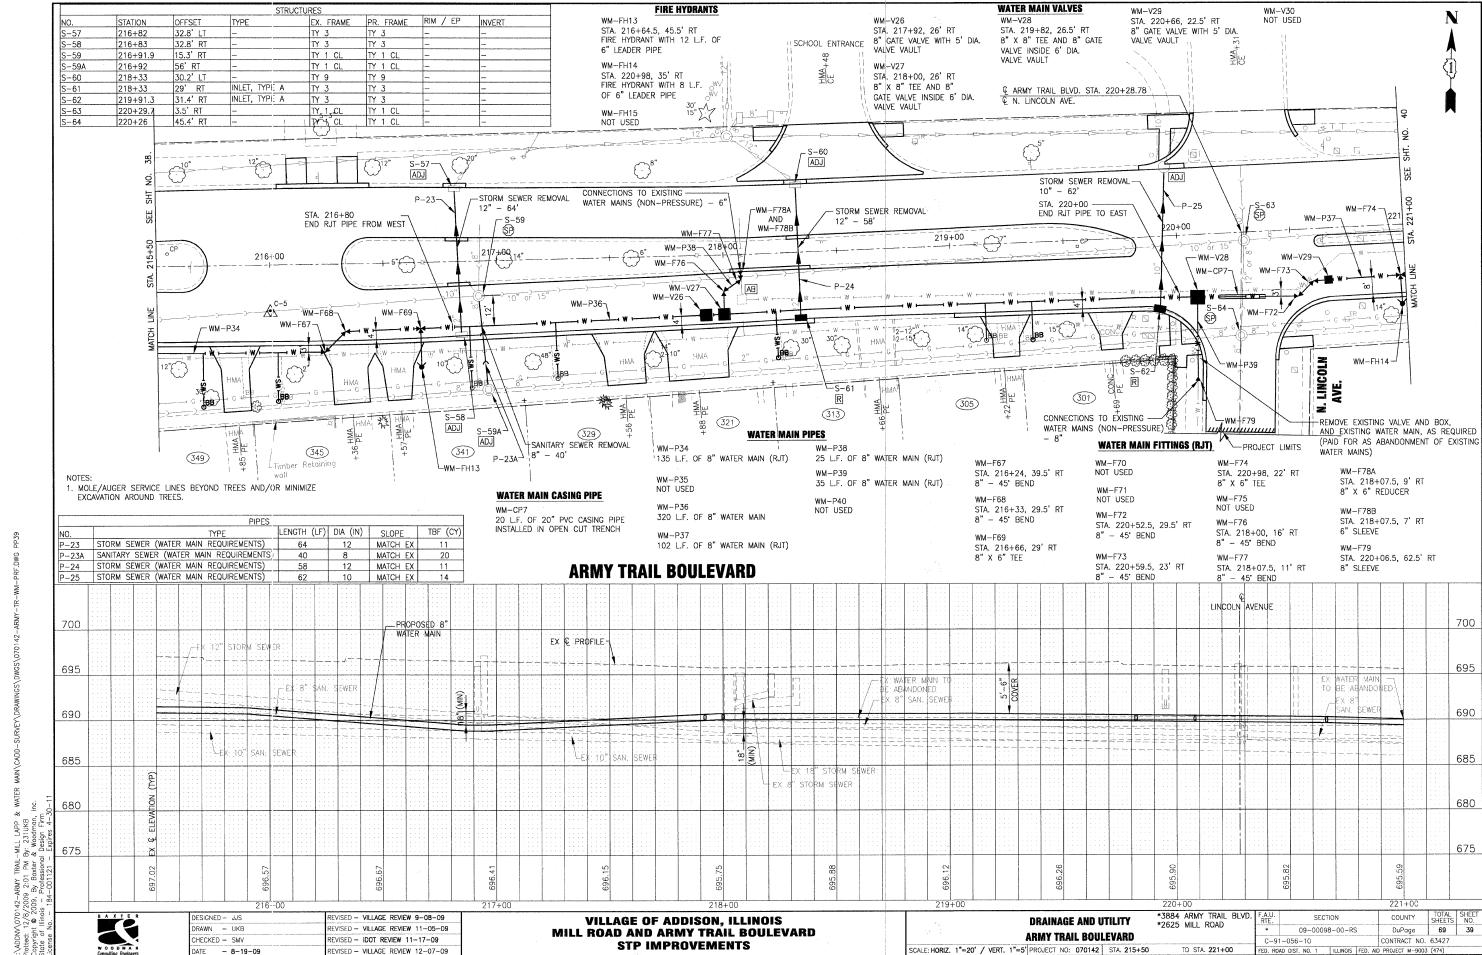


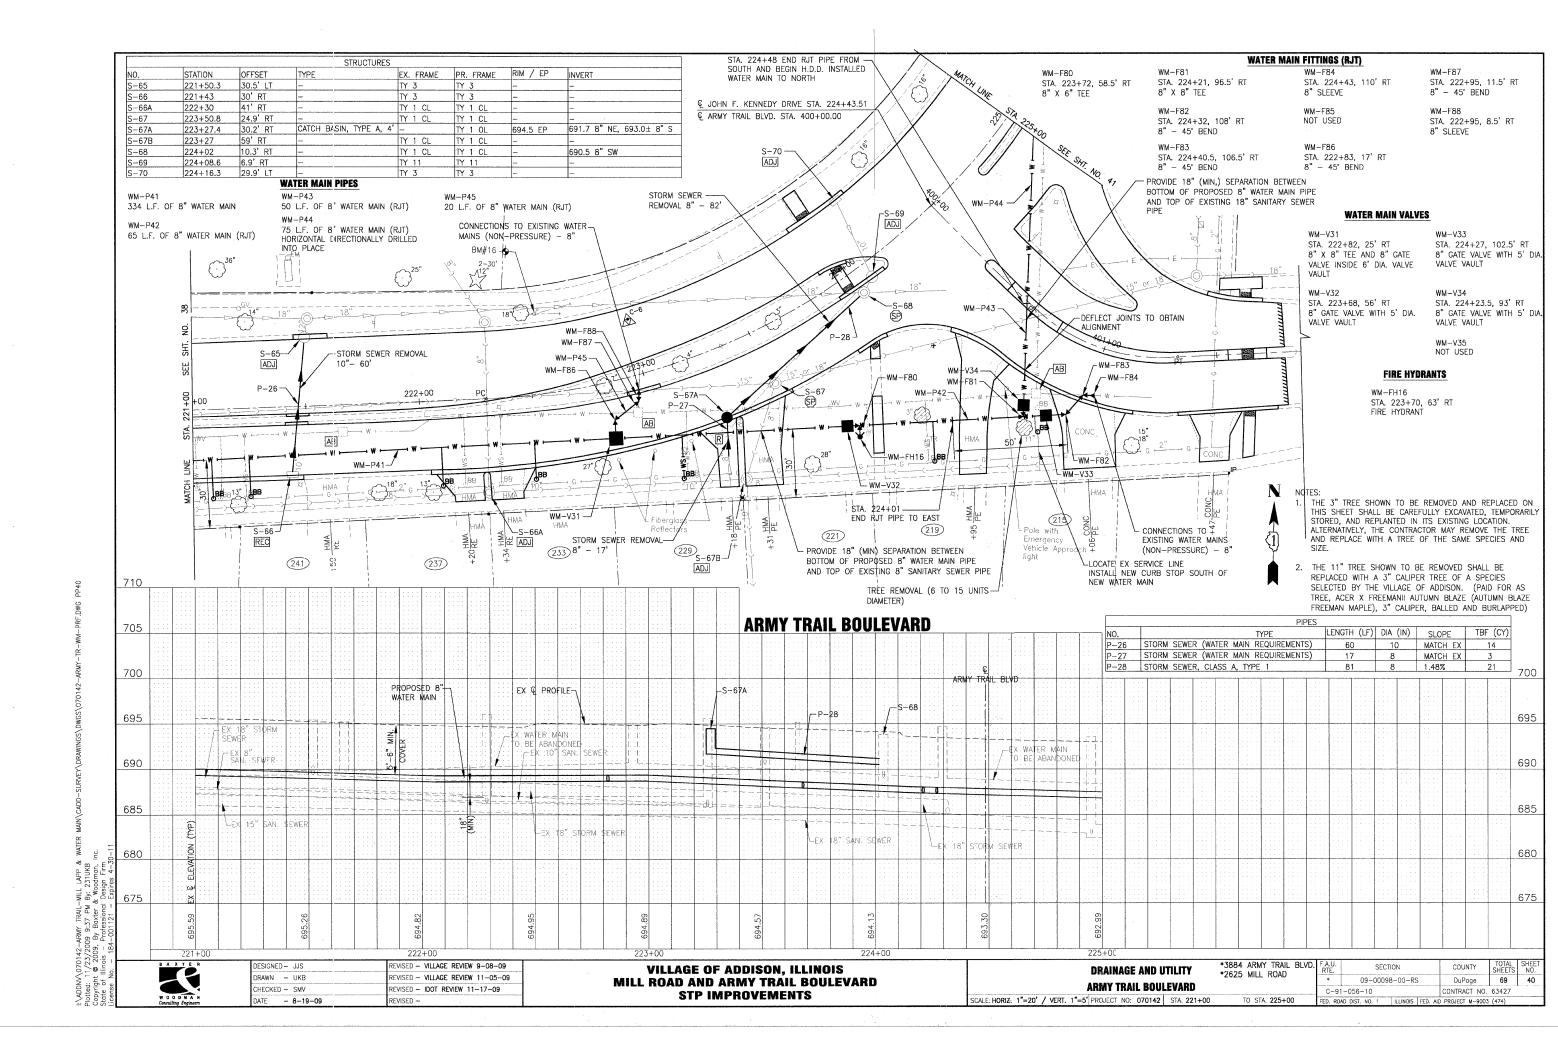


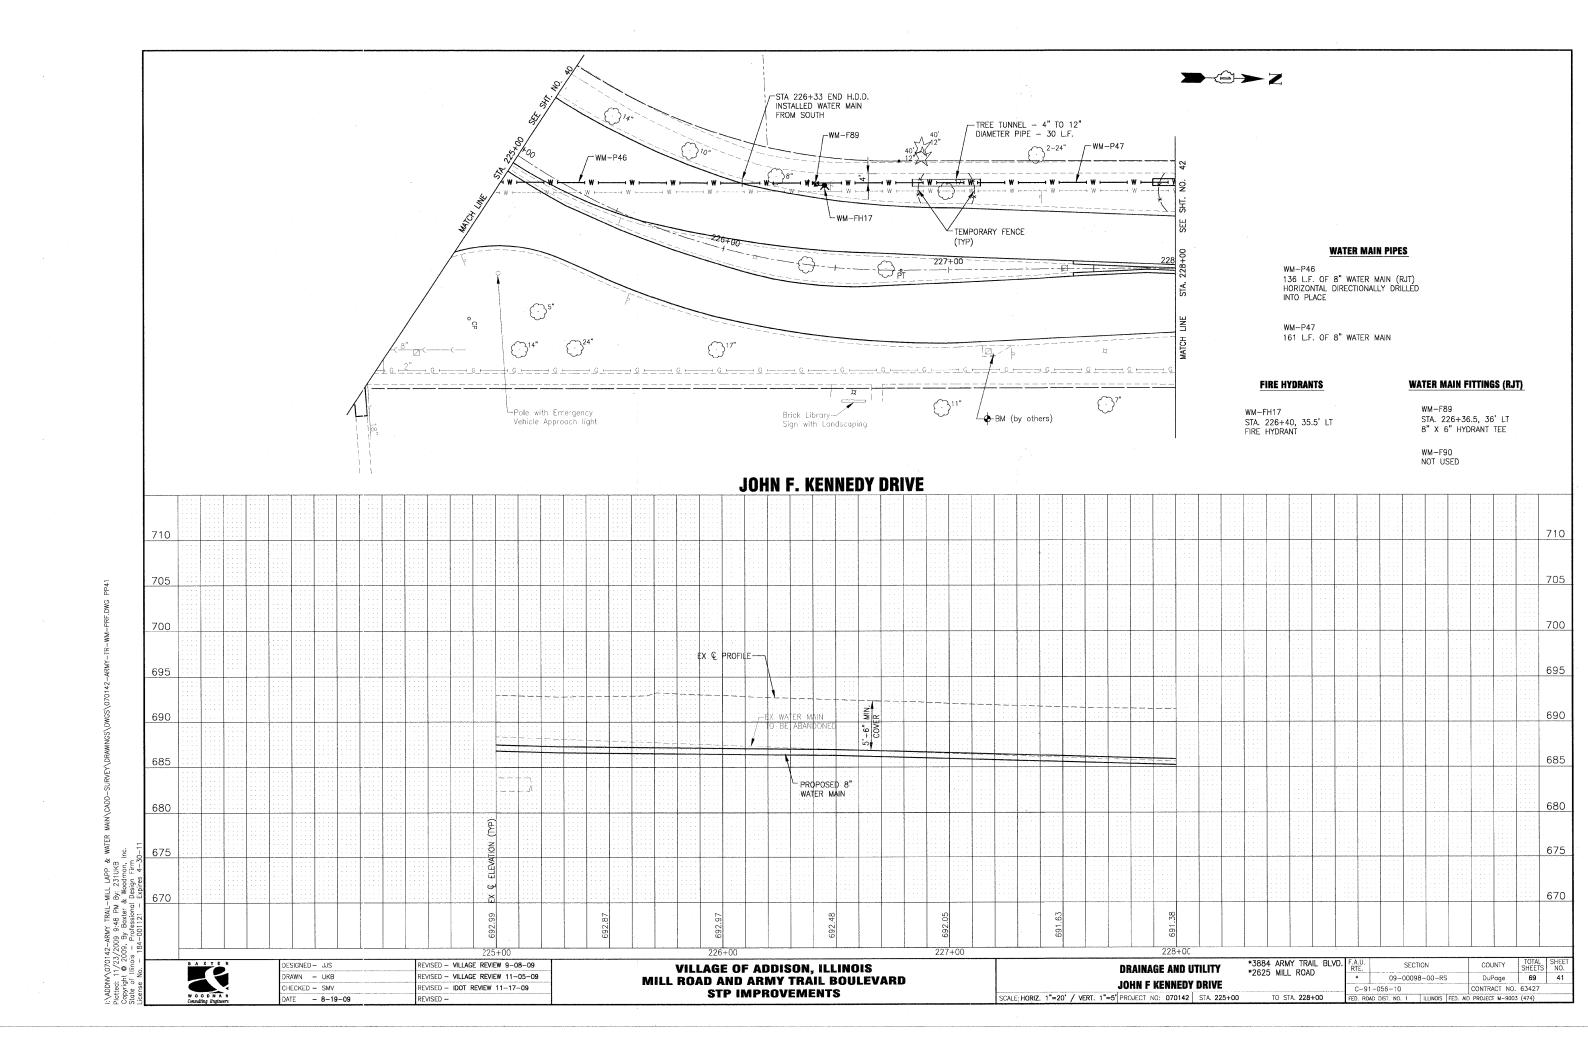


WATER MAIN VALVES SCHOOL ENTRANCE

TREE TUNNEL - 4" TO 12" WM-V37 WM-V40 -CONNECT TO EX 8" SCHOOL ENTRANCE STA. 228+46, 39.5' LT STA. 228+89, 40' LT NOT USED NOT USED WATER SERVICE 8" GATE VALVE WITH 5' DIA. VALVE VAULT WITH ADDITIONAL DIAMETER PIPE - 30 L.F. 8" X 8" TEE AND 8" GATE VALVE TREE TUNNEL - 4" TO 12" _BM#19 WM-CP8 INSIDE 6' DIA. VALVE VAULT -WM-F98 - WM-F91 VAULT WALL SECTION AS REQUIRED WM-V39 DIAMETER PIPE - 30 L.F. WITH ADDITIONAL VALUE WAL - WS-P2 FOR EXTRA DEPTH OF VAULT STA. 229+68, 40' LT -- WM-V39 SECTION AS REQUIRED FOR EXTRA WM-V36 -WM-F97 8" X 6" TEE AND 6" GATE VALVE TEMPORARY FENCE--WM-P48 DEPTH OF VAULT /-WM-V37 INSIDE 6' DIA. VALVE VAULT **FIRE HYDRANTS** --WM-F93 WM-FH18 WM-F94 STA. 229+54, 49' LT FIRE HYDRANT STA. 231+41 -WM-FH19 -TEMPORARY FENCE -WM-F96 TEMPORARY -WM-F101 S-77 STA. 231+88, 40.5' LT ADJ WM-FH18 -(TYP) FENCE (TYP) TO NORTH -WM-P49 CONNECTIONS TO EXISTING WATER MAINS FIRE HYDRANT -WM-F102 -WM-FH19 (NON-PRESSURE) - 8" 229+00 (VERIFY SIZE OF EX WATER MAIN PRIOR TO CONSTRUCTION) S-73-ADJ S-72-REC WM-F103A -END IMPROVEMENTS CONNECT TO EXISTING JOHN F KENNEDY DRIVE STA. 232+27 4" WATER SERVICE WATER MAIN FITTINGS (RJT) FRIENDSHIP PLAZA WM-F101 WM-F93 -S-74 STA. 229+68, 34' LT WATER MAIN CASING PIPE STA. 228+91, 48' LT STA. 229+58, 40' LT STA. 232+04, 43' LT JOHN F KENNEDY DRIVE STA. 233+32 PROJECT R © U.S. ROUTE 20 (LAKE STREET) 6" - 45' BEND 8" X 6" HYDRANT TEE 8" - 45' BEND 8" - 45° BEND LIMITS WM-CP 8 20 L.F. OF 20" P.V.C. CASING WM-F102 WM-F94 WM--F98 PIPE INSTALLED IN OPEN CUT STA. 229+62.5, 28.5' LT STA. 228+85.5, 53.5' LT STA. 231+91.5, 41.7' LT STA. 232+08.5, 39' LT TRENCH 6" - 45' BEND **→**©→Z 8" - 45" BEND 8" X 6" HYDRANT TEE 8" - 45' BEND WM-F103A WM-F99 WM-F95 NOT USED STA. 229+63.5, 41' RT STA. 228+85.5, 57' LT STRUCTURES WATER MAIN PIPES **WATER SERVICE PIPES** 6" X 4" REDUCER 8" SLEEVE RIM / EP STATION OFFSET EX. FRAME PR. FRAME INVERT WM-F96 28.4' RT TY 11 TY 1 OL 228+57.9 WM-F100 STA. 232+12.5, 40' LT 350 L.F. OF 8" WATER MAIN NOT USED 20 L.F. OF 8" WATER SERVICE (RJT) WM-F103B 228+77 TY 1 CL TY 1 CL NOT USED 8" SLEEVE STA. 229+63.5, 43' RT S-73 32' RT TY 1 CL TY 1 CL WS-P3 228+97 WM-P49 4" SLEEVE **JOHN F. KENNEDY DRIVE** INLET, TYPE A 85 L.F. OF 8" WATER MAIN (RJT) S-74 TY 11 90 L.F. OF 6" WATER SERVICE (RJT) 229+02 39' RT TY 1 OL TTY 1 OL 35.8' RT 229+51 S-76 TY 1 CL TY 1 CL 228+76 31' LT S-77 228+84 TY 1 CL 705 705 700 700 Ç FFIEND\$HIP PLAZA JOHN F. KENNEDY DRIVE STA. 232+27 695 695 EX & PROFILE 690 690 685 685 PROPOSED 8' TORM WATER MAIN 680 680 675 675 670 670 MY TRAIL-9:51 PW 691 *3884 ARMY TRAIL BLVD. EVISED - VILLAGE REVIEW 9-08-09 DESIGNED - JJS SECTION COUNTY **VILLAGE OF ADDISON, ILLINOIS DRAINAGE AND UTILITY** *2625 MILL ROAD DRAWN - UKB REVISED - VILLAGE REVIEW 11-05-09 69 42 09-00098-00-RS DuPage MILL ROAD AND ARMY TRAIL BOULEVARD JOHN F KENNEDY DRIVE CHECKED - SMV REVISED - IDOT REVIEW 11-17-09 C-91-056-10 CONTRACT NO. 63427 STP IMPROVEMENTS SCALE: HORIZ. 1"=20" / VERT. 1"=5" PROJECT NO: 070142 STA. 228+00 TO STA. 233+34

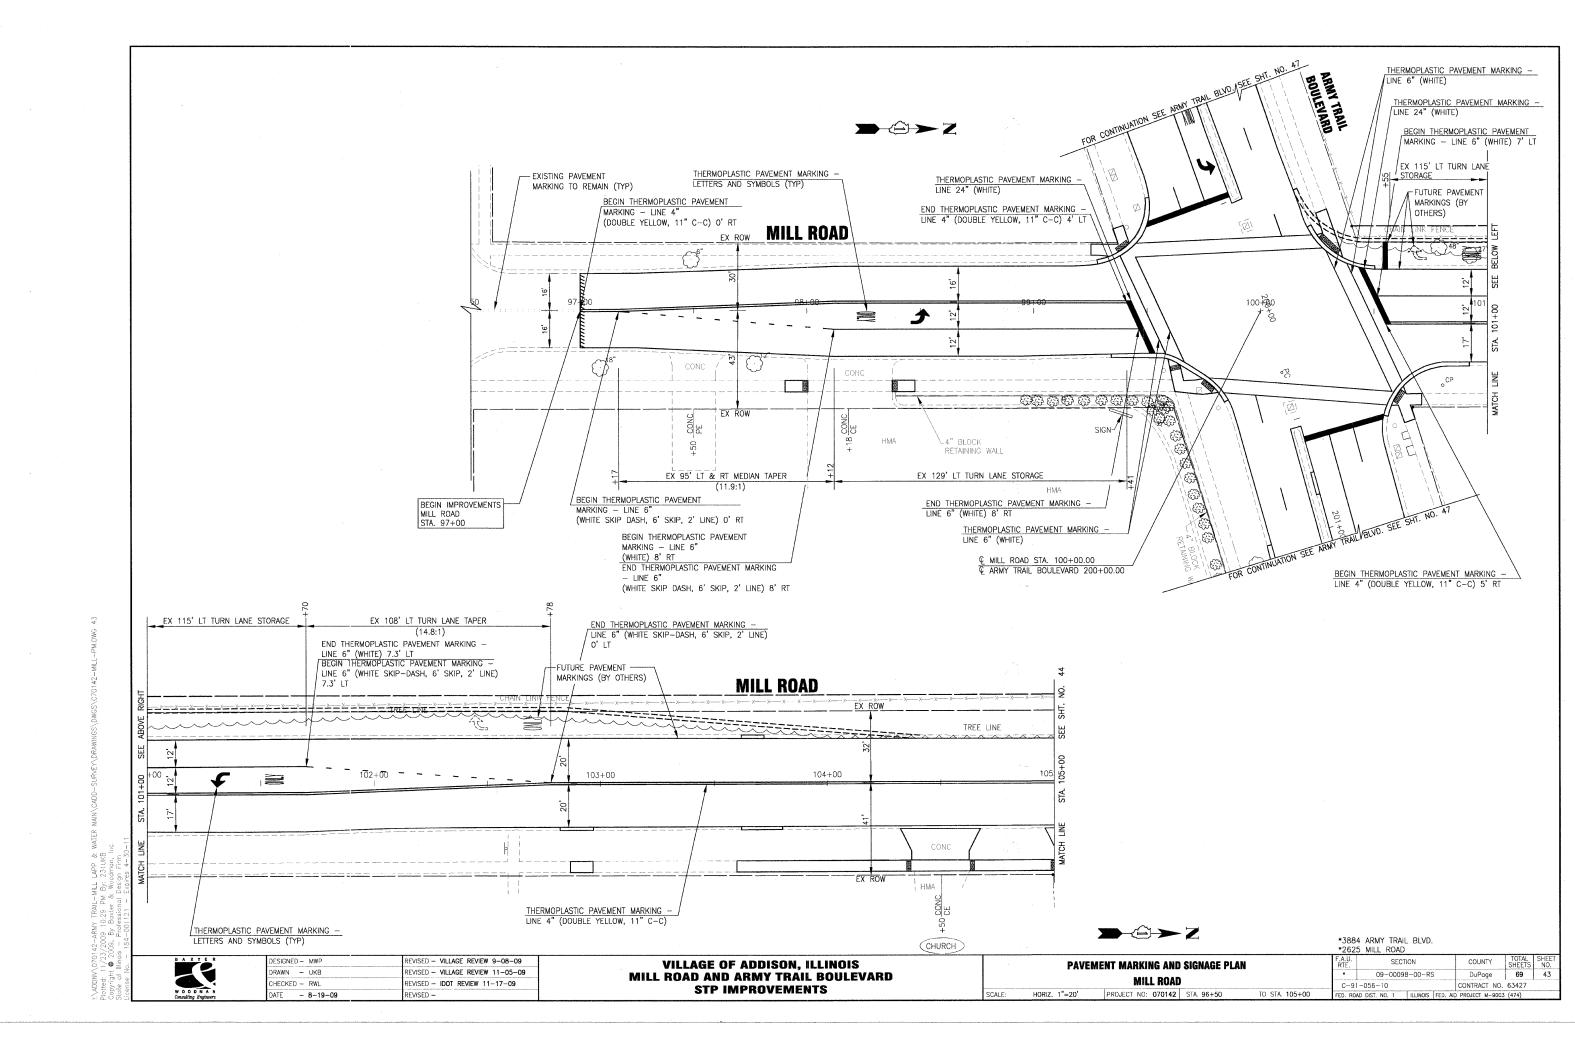

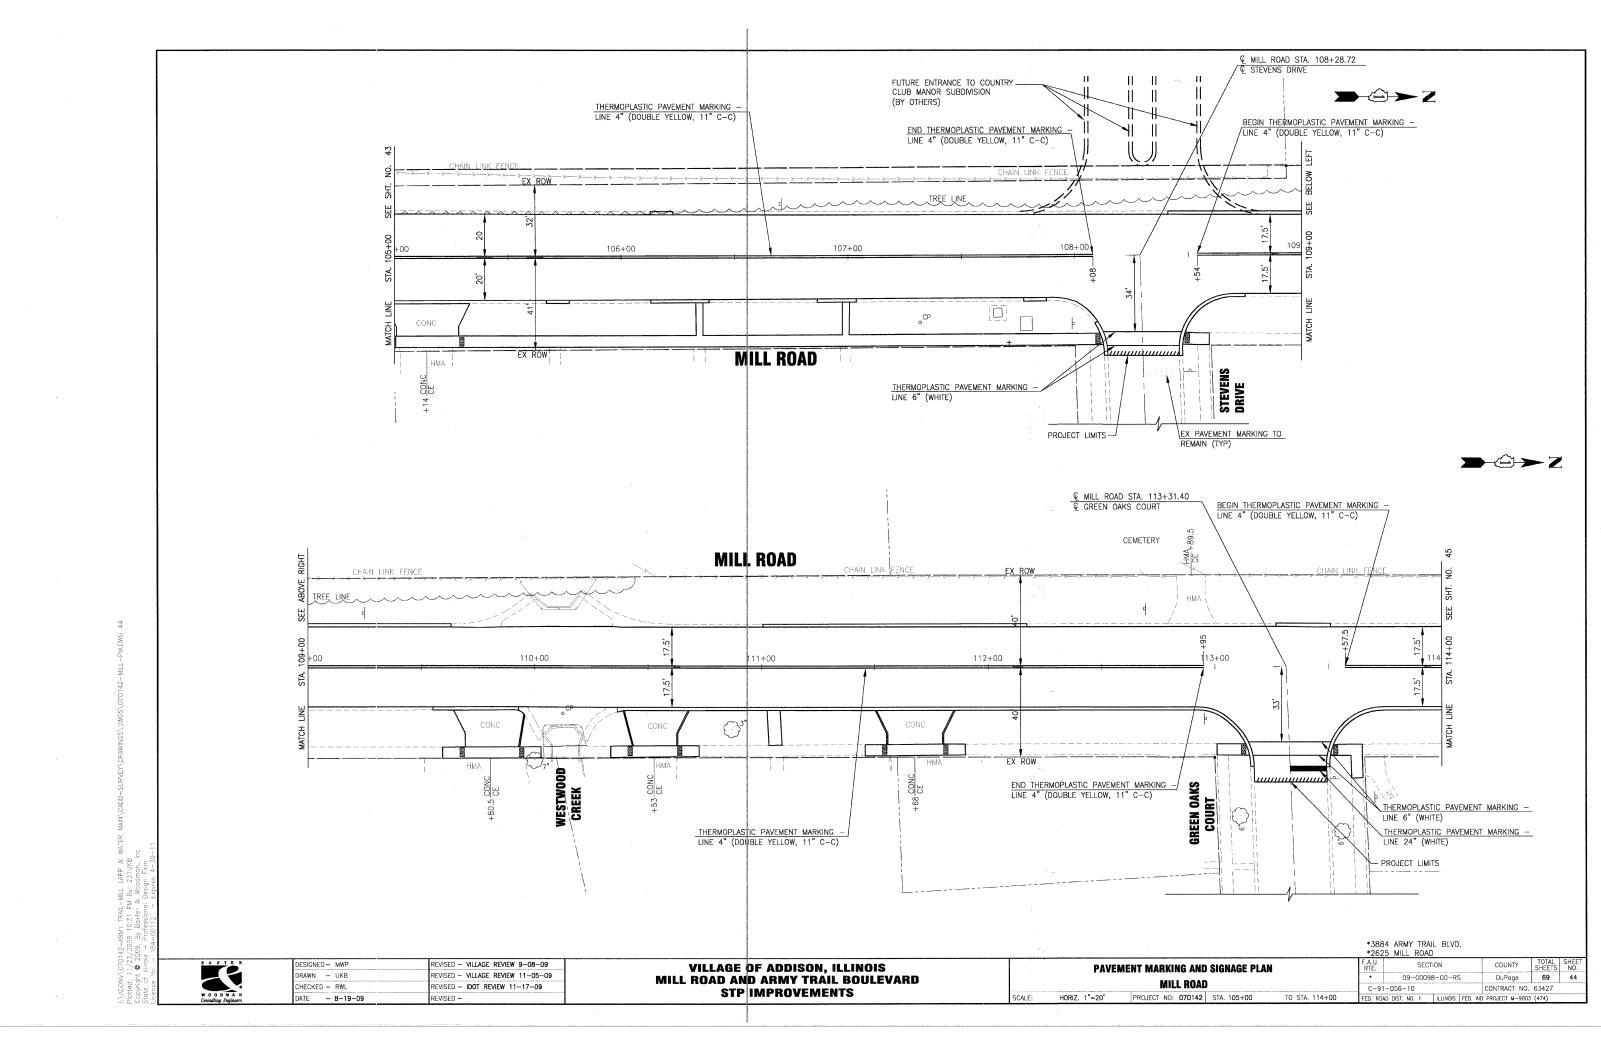

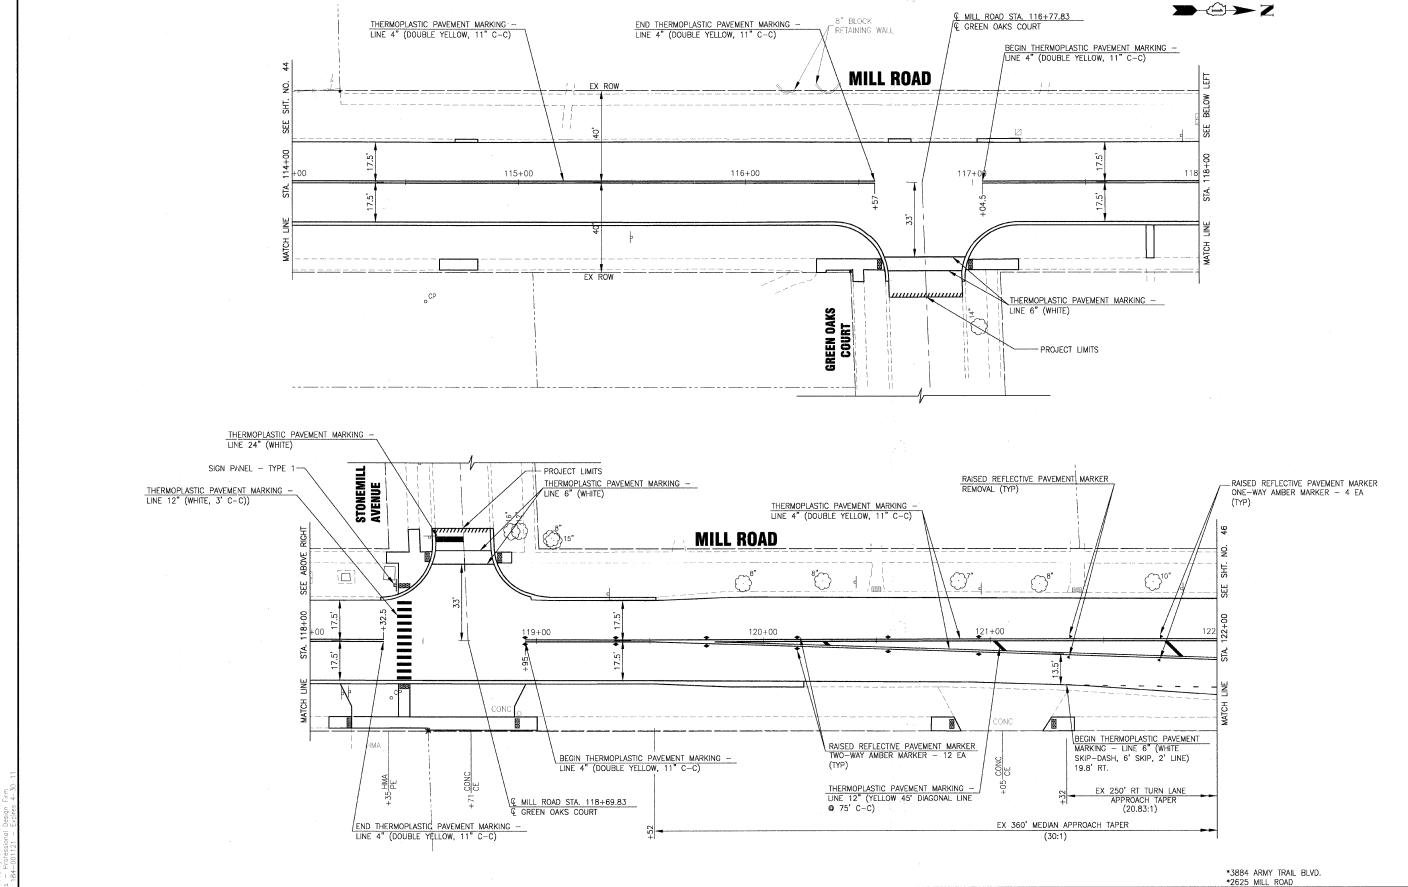

VILLAGE OF ADDISON. ILLINOIS

MILL ROAD AND ARMY TRAIL BOULEVARD

STP IMPROVEMENTS

SECTION

09-00098-00-RS

PAVEMENT MARKING AND SIGNAGE PLAN

MILL ROAD

HORIZ. 1"=20'

PROJECT NO: 070142 STA. 114+00

TO STA. 122+00

COUNTY

DuPage 69

CONTRACT NO. 63427

1)0142—ARMIN TAIL—LAFY & WAIEK MAIN\CADU—SURVEY\URAWINSS \UNW. 1)0142—ARMIN TAIL—LAFY & WAIEK MAIN\CADU—SURVEY\URAWINSS \UNW. 1)0142—1909 (0.53 PM B); 23148 B 102009, B BOXYET & Woodmon, Inc. Inc. — Professional Resign Enn, Inc.

| Totted: 17 22/2009 10:00 February | Copyright @ 2009, B Baxter & State of Illinois - Professional D License No. - 184-001121 - E

3

DRAWN - UKB

CHECKED - RWL

ATE - 8-19-09

REVISED - VILLAGE REVIEW 9-08-09

EVISED - VILLAGE REVIEW 11-05-09

REVISED - IDOT REVIEW 11-17-09

REVISED -

END THERMOPLASTIC PAVEMENT MARKING -LINE 4" (DOUBLE YELLOW, 11" C-C) 0' RT RAISED REFLECTIVE PAVEMENT MARKER REMOVAL (TYP)
RAISED REFLECTIVE PAVEMENT MARKER TWO-WAY AMBER MARKER - 8 EA EX 140' LT TURN STORAGE THERMOPLASTIC PAVEMENT MARKING LINE 12" (YELLOW 45' DIAGONAL LINE @ 75' C-C) EX 165' LT TURN LANE APPROACH TAPER (13.75:1) THERMOPLASTIC PAVEMENT MARKING -LETTERS AND SYMBOLS (TYP) RAISED REFLECTIVE PAVEMENT MARKER
ONE—WAY AMBER MARKER — 10 EA CONC CONC EX PAVEMENT MARKING TO REMAIN HMA 125+00 126+00 123+00 : []: END IMPROVEMENTS MILL ROAD STA. 125+63 **MILL ROAD** © MILL ROAD STA. 126+83
© U.S. ROUTE 20 (LAKE STREET) 8 EX 250' RT TURN LANE APPROACH TAPER (20.83:1) EX 220' RT TURN LANE STORAGE EX 360' MEDIAN APPROACH TAPER (30:1) ∠_{ATT} BEGIN THERMOPLASTIC PAVEMENT MARKING LINE 6" (WHITE SKIP DASH, 6' SKIP, 2' LINE) 12' RT END THERMOPLASTIC PAVEMENT MARKING —
LINE 6" (WHITE SKIP DASH, 6' SKIP, 2' LINE) 12' RT
BEGIN THERMOPLASTIC PAVEMENT MARKING — LINE 6" (WHITE) 12' RT END THERMOPLASTIC PAVEMENT MARKING -UNE 6" (WHITE SKIP DASH, 6' SKIP, 2' LINE) 24' RT. BEGIN THERMOPLASTIC PAVEMENT MARKING -RAISED REFLECTIVE PAVEMENT MARKER
REMOVAL (TYP)
RAISED REFLECTIVE PAVEMENT MARKER LINE 6" (WHITE) 24' RT ONE-WAY CRYSTAL MARKER - 8 EA (TYP) END THERMOPLASTIC PAVEMENT MARKING -LINE 6" (WHITE) 12' RT END THERMOPLASTIC PAVEMENT MARKING -LINE 6" (WHITE) 24' RT

VILLAGE OF ADDISON, ILLINOIS

MILL ROAD AND ARMY TRAIL BOULEVARD

STP IMPROVEMENTS

*3884 ARMY TRAIL BLVD. *2625 MILL ROAD

C-91-056-10

TO STA. 126+50

09-00098-00-RS

PAVEMENT MARKING AND SIGNAGE PLAN

HORIZ. 1"=20' PROJECT NO: 070142 STA. 122+00

COUNTY

DuPage

CONTRACT NO. 63427

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DESIGNED - MWP


DRAWN - UKB

CHECKED - RWL

REVISED - VILLAGE REVIEW 9-08-09

REVISED - IDOT REVIEW 11-17-09


REVISED - VILLAGE REVIEW 11-05-09

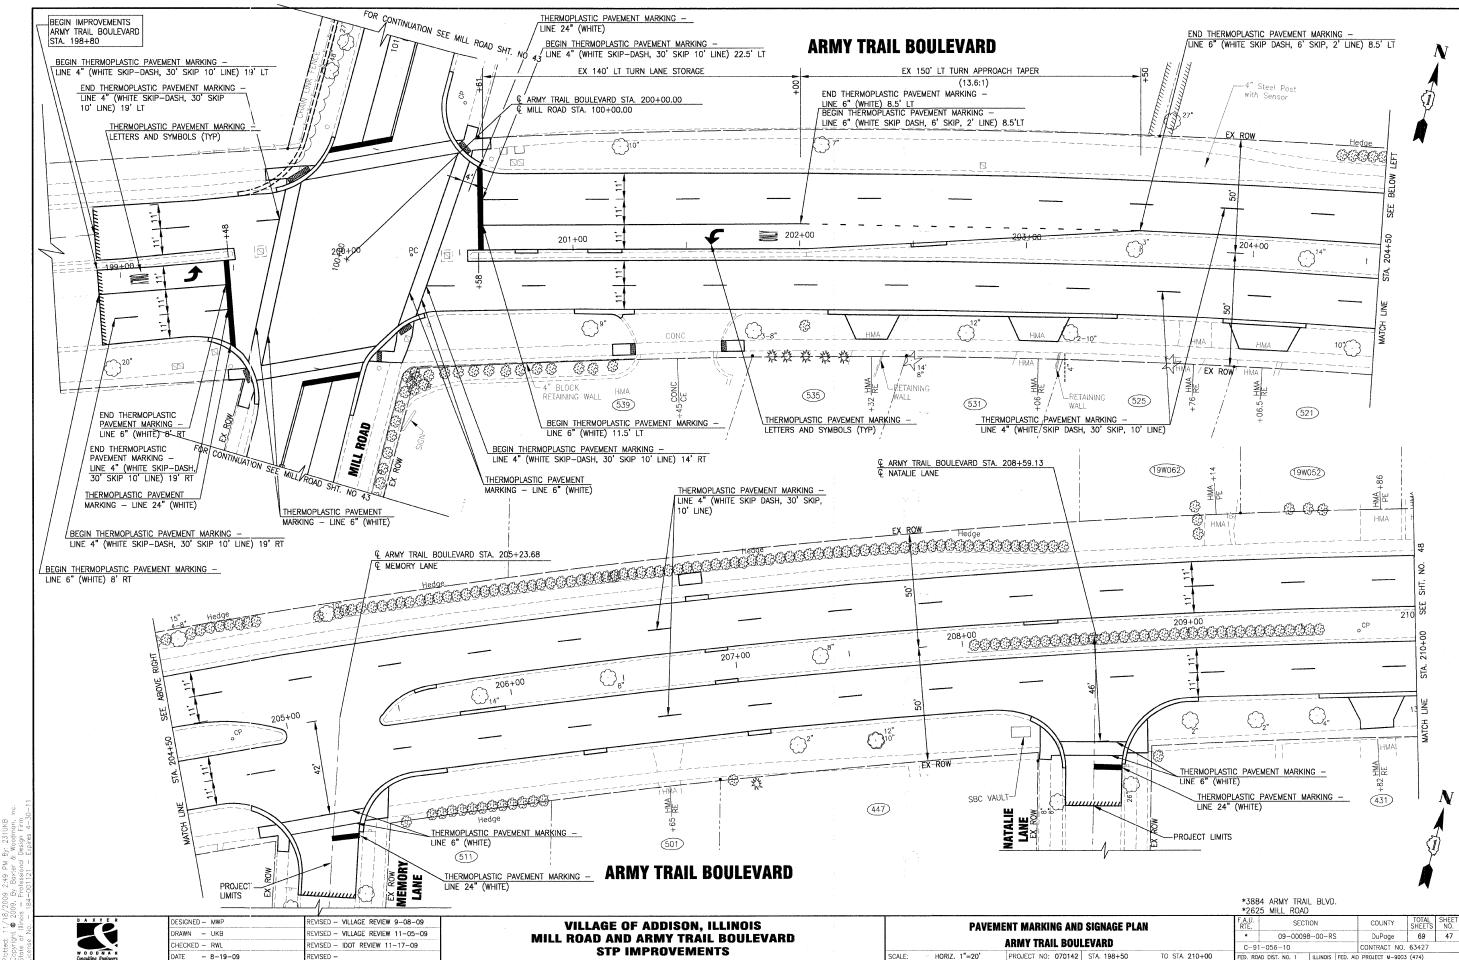


DATE - 8-19-09

STP IMPROVEMENTS

PROJECT NO: 070142 STA. 198+50

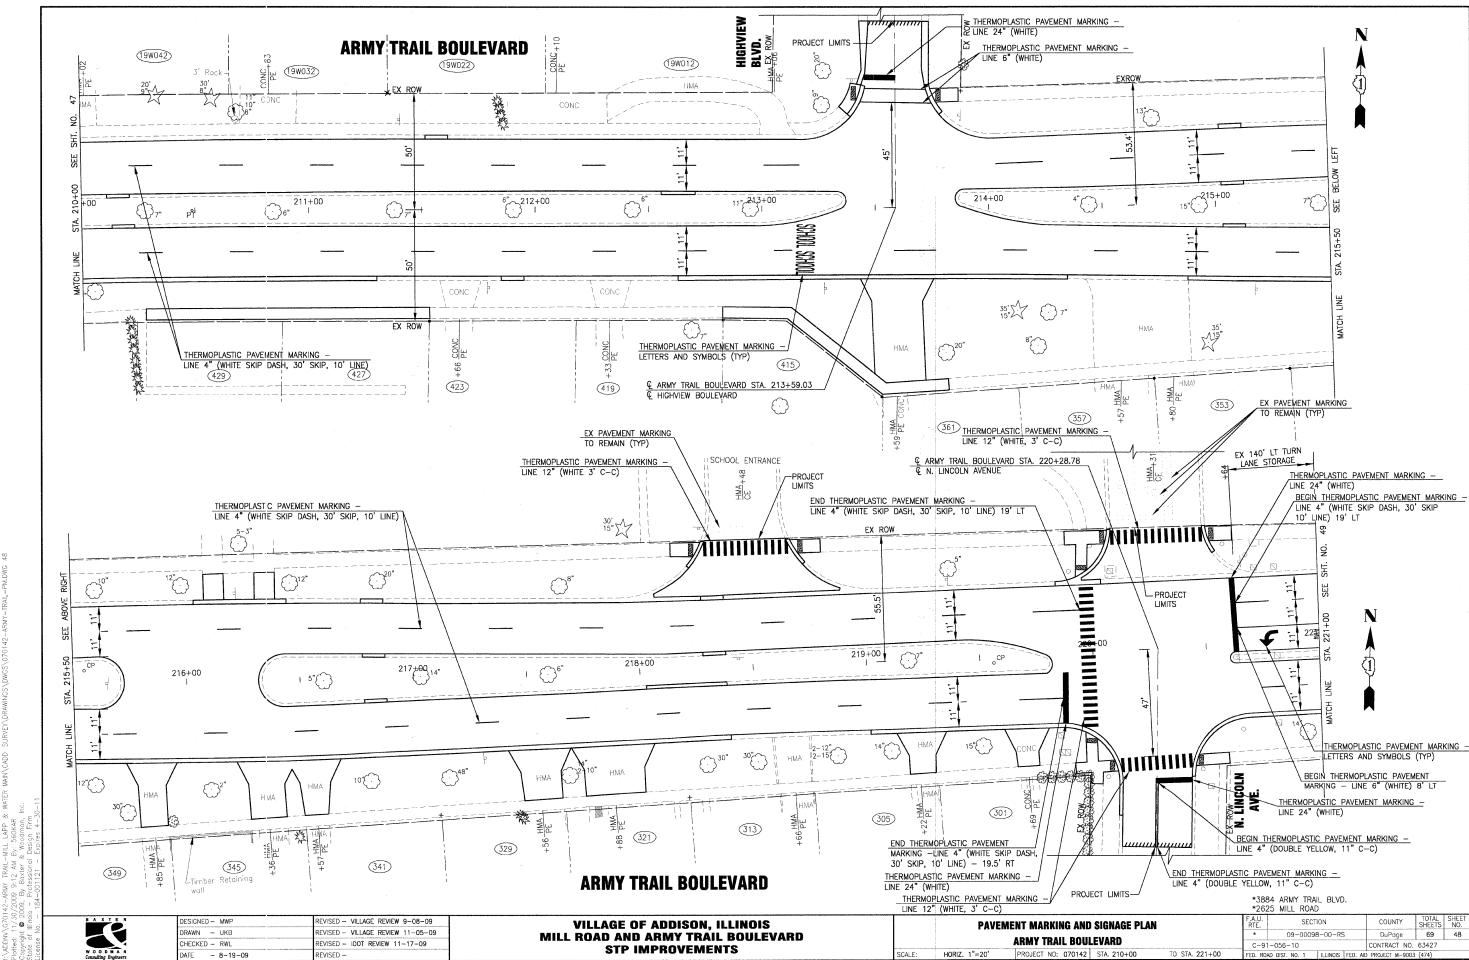

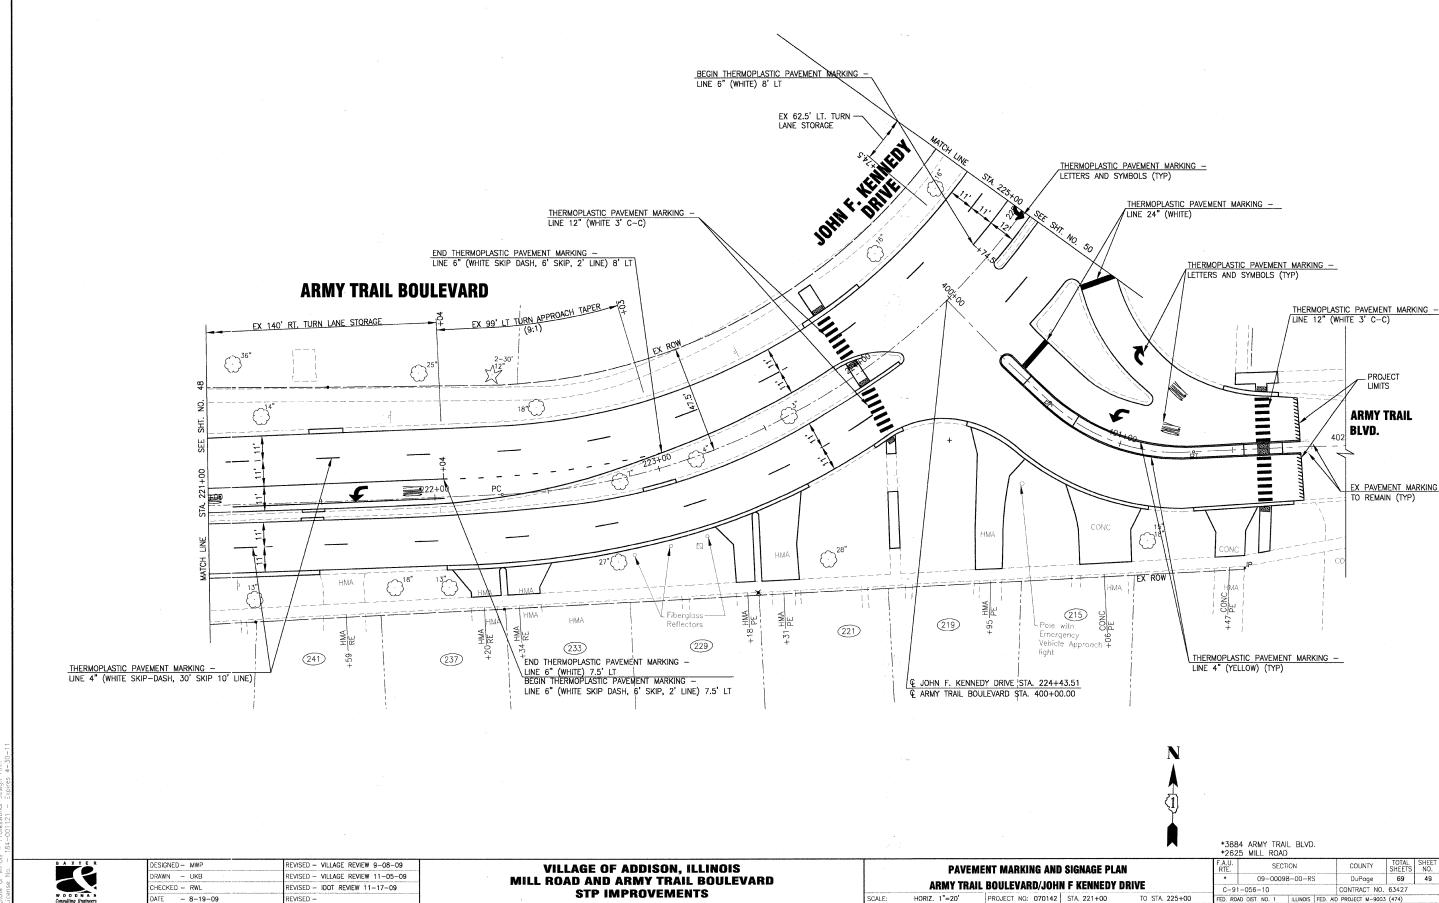

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JOHN F. KENNEDY DRIVE


*3884 ARMY TRAIL BLVD. *2625 MILL ROAD

REVISED - VILLAGE REVIEW 9-08-09 ESIGNED - MWP RAWN - UKB REVISED - VILLAGE REVIEW 11-05-09 CHECKED - RWL REVISED - IDOT REVIEW 11-17-09

VILLAGE OF ADDISON, ILLINOIS MILL ROAD AND ARMY TRAIL BOULEVARD STP IMPROVEMENTS

PAVEMENT MARKING AND SIGNAGE PLAN JOHN F KENNEDY DRIVE

COUNTY TOTAL SHEETS DuPage 69
CONTRACT NO. 63427 SECTION 09-00098-00-RS C-91-056-10

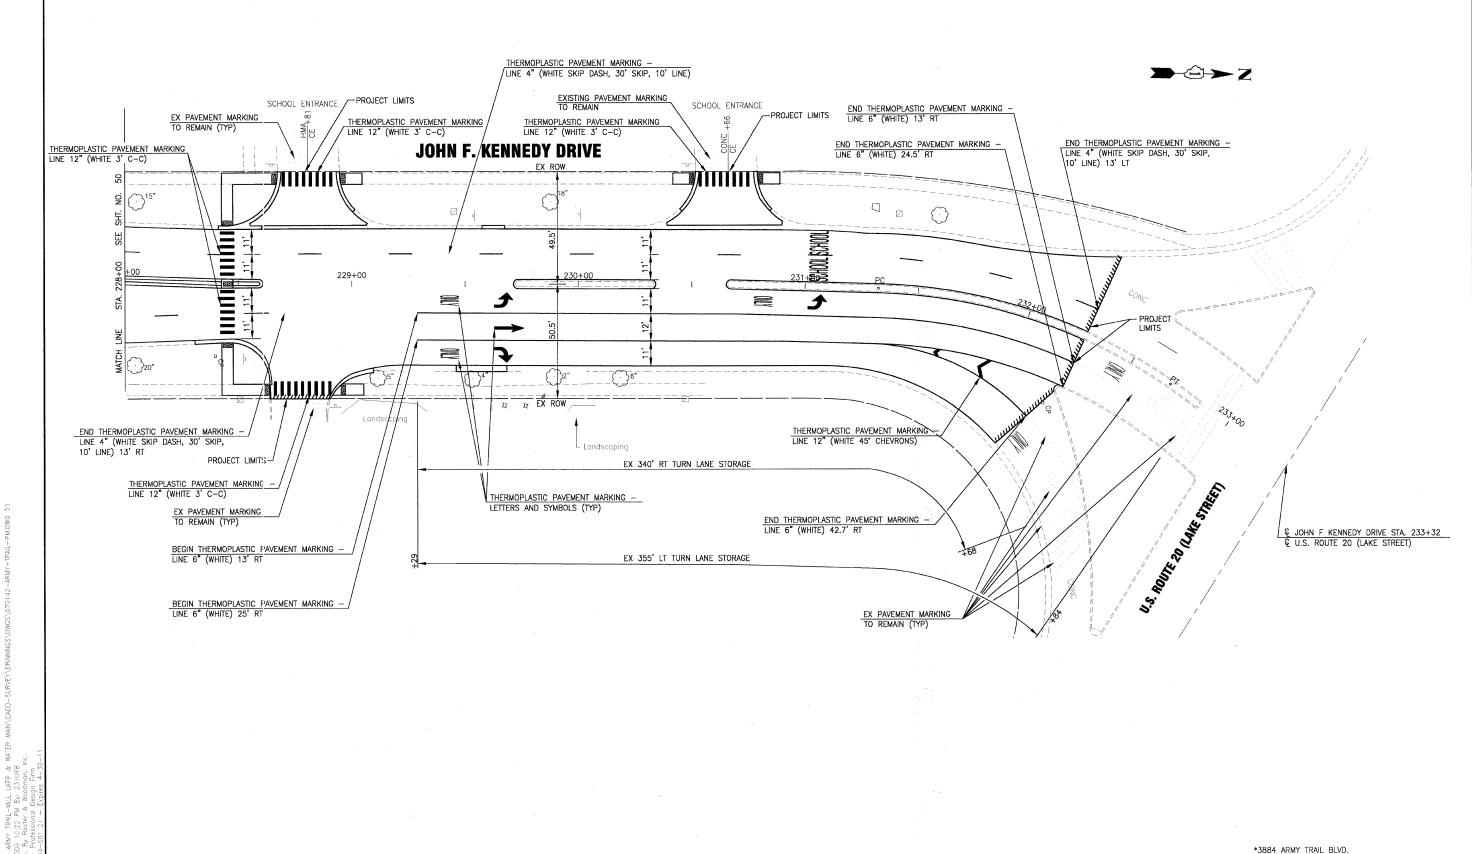

VILLAGE OF ADDISON, ILLINOIS

MILL ROAD AND ARMY TRAIL BOULEVARD

STP IMPROVEMENTS

*2625 MILL ROAD

TO STA. 233+34

PAVEMENT MARKING AND SIGNAGE PLAN

JOHN F. KENNEDY DRIVE

PROJECT NO: 070142 STA. 228+00

HORIZ. 1"=20"

SECTION

09-00098-00-RS

TOTAL SHEET SHEETS NO. 69 51

COUNTY

DuPage

REVISED - VILLAGE REVIEW 9-08-09

REVISED - VILLAGE REVIEW 11-05-09

REVISED - IDOT REVIEW 11-17-09


DESIGNED - MWP

DRAWN - UKB

CHECKED -- RWL

-- 1" UNIT DUCT (INCLUDED IN DETECTOR LOOP REPLACEMENT DETECTOR LOOP REPLACEMENT **MILL ROAD** СР 0 (TYP) 250' FROM STOP BAR 1" UNIT DUCT (INCLUDED -IN DETECTOR LOOP REPLACEMENT (TYP) Og DETECTOR LOOP-REPLACEMENT ARMY TRAIL BOULEVARD EDGE OF EX PAVEMENT EXTENDED DETECTOR LOOP . REPLACEMENT DETECTOR LOOP-REPLACEMENT -1" UNIT DUCT (INCLUDED IN DETECTOR LOOP REPLACEMENT (TYP) - DETECTOR LOOP REPLACEMENT (TYP) MILL ROAD *3884 ARMY TRAIL BLVD. *2625 MILL ROAD COUNTY TOTAL SHEET NO.

DuPage 69 52 REVISED - VILLAGE REVIEW 9-08-09 ESIGNED - MWP SECTION **VILLAGE OF ADDISON, ILLINOIS DETECTOR LOOP REPLACEMENT** WOODMAN RAWN - UKB EVISED - VILLAGE REVIEW 11-05-09 09-00098-00-RS MILL ROAD AND ARMY TRAIL BOULEVARD AT MILL ROAD AND ARMY TRAIL BOULEVARD REVISED - IDOT REVIEW 11-17-09 CHECKED - RWL CONTRACT NO. 63427 C-91-056-10 **STP IMPROVEMENTS** SCALE: 1" = 10' PROJECT NO: 070142 STA. ATE - 8-19-09

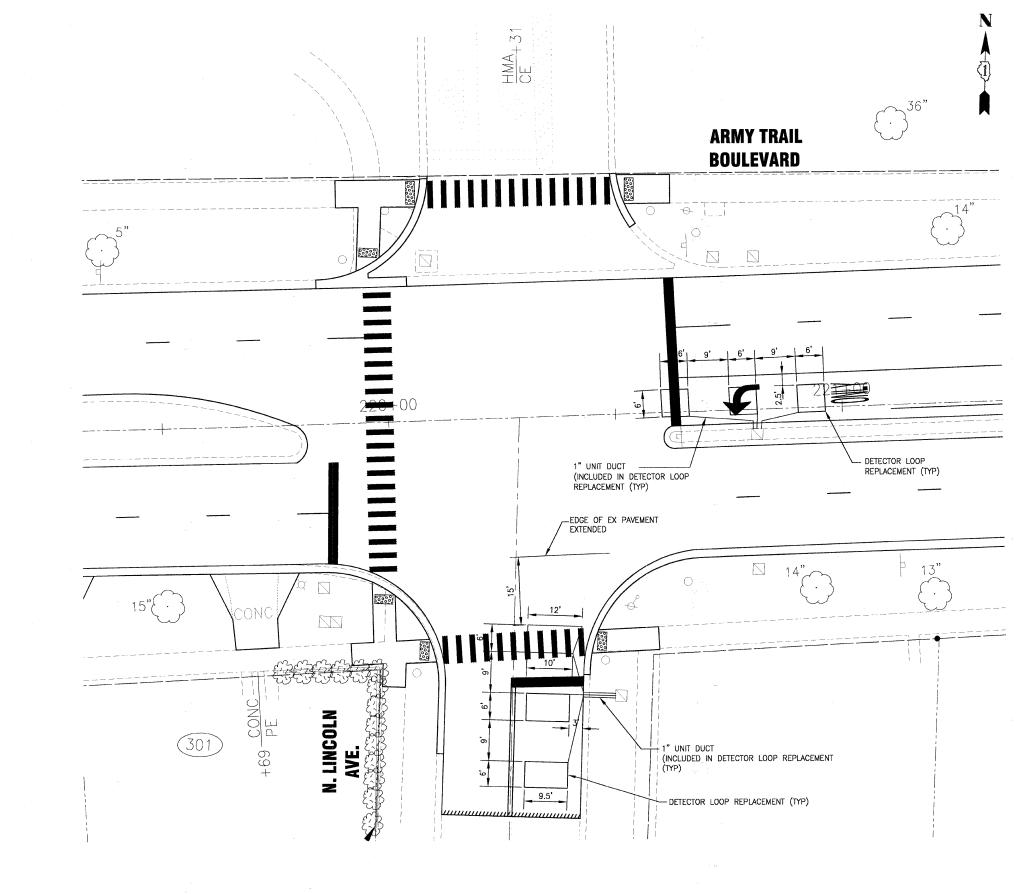


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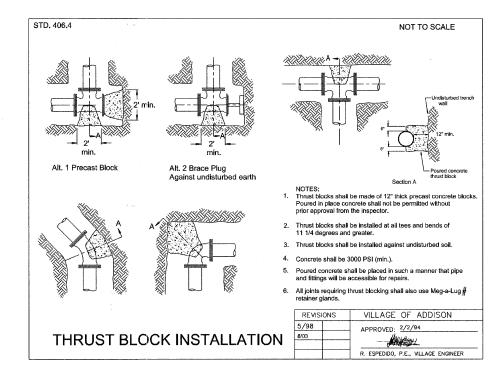
VILLAGE OF ADDISON, ILLINOIS MILL ROAD AND ARMY TRAIL BOULEVARD STP IMPROVEMENTS


DETECTOR LOOP REPLACEMENT AT ARMY TRAIL BOULEVARD AND N. LINCOLN AVENUE *3884 ARMY TRAIL BLVD. *2625 MILL ROAD TOTAL SHEET NO. 69 53 SECTION COUNTY 09-00098-00-RS DuPage C-91-056-10

CONTRACT NO. 63427

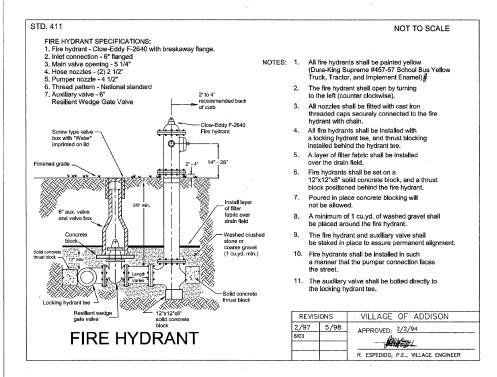

OR APPROVED EQUAL



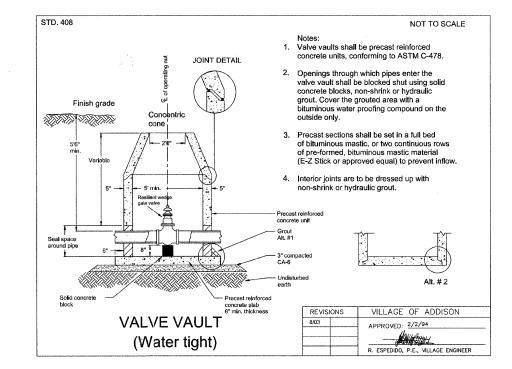

ESIGNED - JJS EVISED - VILLAGE REVIEW 9-08-09 RAWN - UKB EVISED - VILLAGE REVIEW 11-05-09 CHECKED - SMV EVISED - IDOT REVIEW 11-17-09 ATE - 8-19-09

VILLAGE OF ADDISON, ILLINOIS STP IMPROVEMENTS

WATER MAIN AND MISCELLANEOUS DETAILS PROJECT NO: 070142 STA.

09-00098-00-RS DuPage 69 C-91-056-10 CONTRACT NO. 63427 ED. ROAD DIST. NO. 1

*3884 ARMY TRAIL BLVD. *2625 MILL ROAD


TO STA.

MILL ROAD AND ARMY TRAIL BOULEVARD

COMPACTED SPECIAL GRANULAR BACKFILL MATERIAL

* FOR FLEXIBLE THERMOPLASTIC OR HDPE PIPE COMPLY WITH ASTM 2321, CLASS I OR II.

FOR RIGID PIPE COMPLY WITH ASTM C12, BEDDING CLASS B.

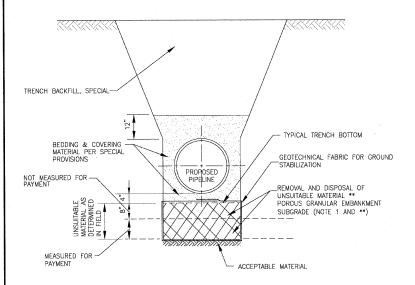


DETAIL NOTES:

POROUS MATERIAL FOR PIPELINE CONSTRUCTION SHALL BE I.D.O.T. CA-1.


** POROUS GRANULAR EMBANKMENT, SUBGRADE (PGES) HAS BEEN PROVIDED FOR USE AT THE LOCATIONS INDICATED FOR SOILS THAT TEND TO BE UNSUITABLE OR UNSTABLE. THE ACTUAL NEED FOR REMOVAL AND REPLACEMENT WITH PGES WILL BE DETERMINED IN THE FIELD AT THE TIME OF CONSTRUCTION BY THE GEOTECHNICAL ENGINEER. ALL POTENTIALLY UNSTABLE SOILS SHOULD BE TESTED WITH A STATIC CONE PENETROMETER AND TREATED IN ACCORDANCE WITH ARTICLE 301.03 AND THE UNDERCUT GUIDELINES IN THE 100T SUBGRADE STRAILITY MANUAL. IF UNSTABLE AND/OR UNSUITABLE MATERIAL IS NOT ENCOUNTERED, THEN THE QUANTITY SHALL BE DEDUCTED AND NO ADDITIONAL COMPENSATION WILL BE DUE TO THE CONTRACTOR.


> OPEN CUT PIPELINE INSTALLATION UNSUITABLE MATERIAL


NO SCALE

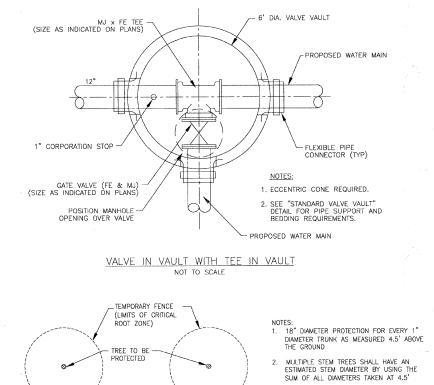

CRITICAL ROOT ZONE DETAIL FOR TEMPORARY FENCE, TREE PRUNING AND TREE ROOT PROTECTION NOT TO SCALE

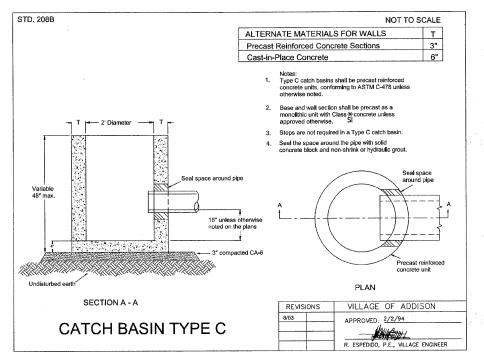

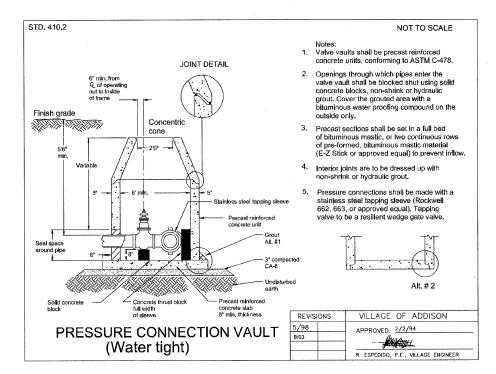

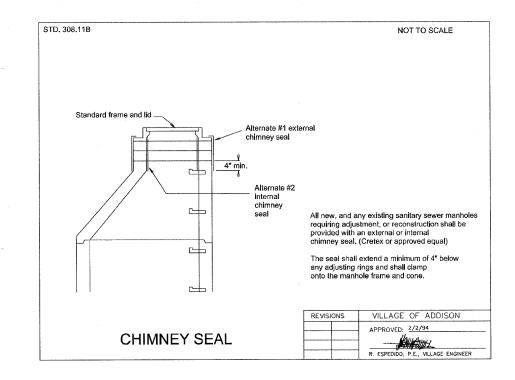

TO STA.

REMOVAL/REPLACEMENT DETAIL

PEVISED - VILLAGE REVIEW 9-08-09 FSIGNED - JJS RAWN - UKB EVISED - VILLAGE REVIEW 11-05-09 REVISED - IDOT REVIEW 11-17-09 CHECKED - SMV - 8-19-09

VILLAGE OF ADDISON, ILLINOIS MILL ROAD AND ARMY TRAIL BOULEVARD STP IMPROVEMENTS

WATER MAIN AND **MISCELLANEOUS DETAILS** PROJECT NO: 070142 STA

*2625 MILL ROAD SECTION COUNTY 09-00098-00-RS DuPage 69 CONTRACT NO. 63427 ILLINOIS FED. AID PROJECT M~9003 (474)

*3884 ARMY TRAIL BLVD.

STORM SANITARY **CURB AND GUTTER** Paved areas Neenah R-1031# Paved areas Neenah R-1712-B# M-3.12 Neenah R-3501-E2# Non-paved areas Neenah R-1060 # Non-paved areas Neenah R-1700 # M-6.12 Neenah R-3503-B# Neenah R-3525-L# M-6.18 B-6.12 B-6.18 Neenah R-3281-B WATER B-6.18 Neenah R-3525-L B-6.18* Paved areas Neenah R-1031# Paved areas Neenah R-1712-B# Neenah R-3278-AL PAVED AREAS Non-paved areas Neenah R-1060 # Non-paved areas Neenah R-1700 # Neenah R-1031 # Neenah R-1712-B # Closed lid Closed lid Sanitary and water lids shall be self-sealing with concealed pick holes. Neenah R-2031# Neenah R-2505 # Open grate **NON-PAVED AREAS** For sanitary and water structures subject to Neenah R-1060 # Closed lid prolonged standing water, use the following frames: Closed lid Neenah R-1700 # Open grate Water-tight: Neenah R-1755-B# Neenah R-1700 # Water-tight: Neenah R-1916-E# * Recommended for new construction All lids shall have the appropriate designation of water, storm, or sanitary cast into the lid. Closed lids shall have a Type "B" lid design.


Open grates shall have a Type "A" or "D" grate design. A Neenah R-4340-B frame#shall not be used on any restricted depth structure without the use of an adjusting ring, 4" minimum in size. FRAME, LID, AND VILLAGE OF ADDISON REVISIONS /98 APPROVED: 2/2/94 **GRATE SCHEDULE**


STD. 208.7A

OR APPROVED EQUAL

MARKETHE

R. ESPEDIDO, P.E., VILLAGE ENGINEER

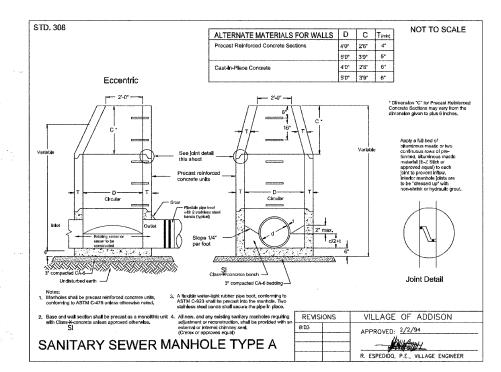

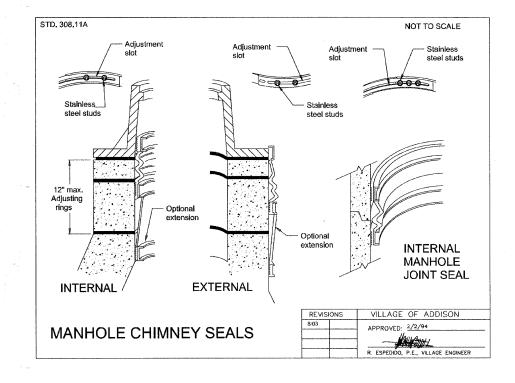

*3884 ARMY TRAIL BLVD.

ADDNV\Q70142—ARMY TRAIL—MILL LAPP & WATER WAIN thed: 11/23/2019 4:22 PM By: 660K4R pyright @ 2009. By Boxter & Woodmon, no. ote of linios — Professional Design Firm tense No. — 184—C01121 — Expires 4—30—11


 DESIGNED MWP
 REVISED VILLAGE REVIEW 9-08-09


 DRAWN UKB
 REVISED VILLAGE REVIEW 11-05-09


 CHECKED RWL
 REVISED IDOT REVIEW 11-17-09


 DATE 8-19-09
 REVISED

VILLAGE OF ADDISON, ILLINOIS MILL ROAD AND ARMY TRAIL BOULEVARD STP IMPROVEMENTS

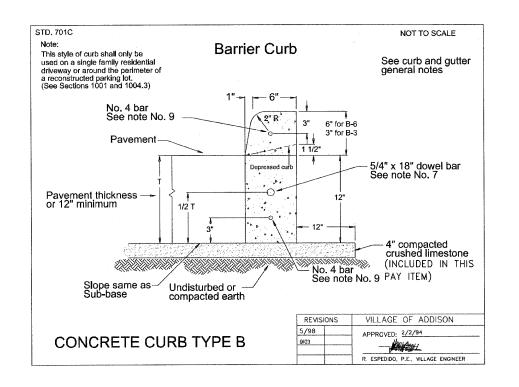

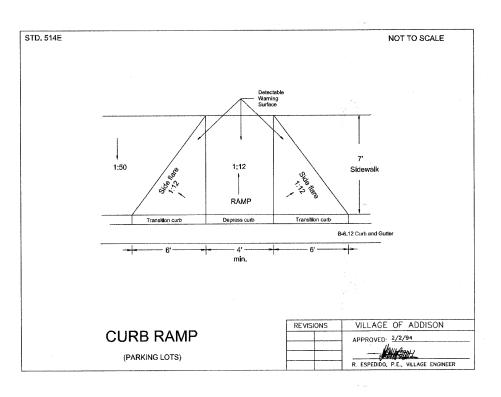

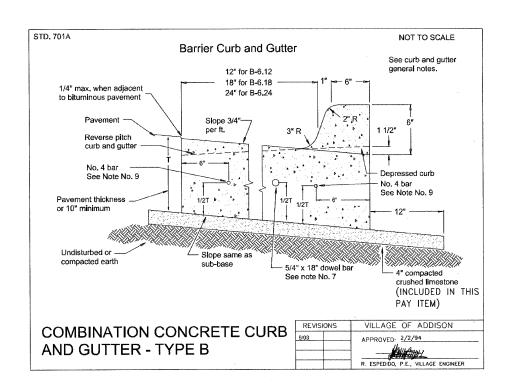

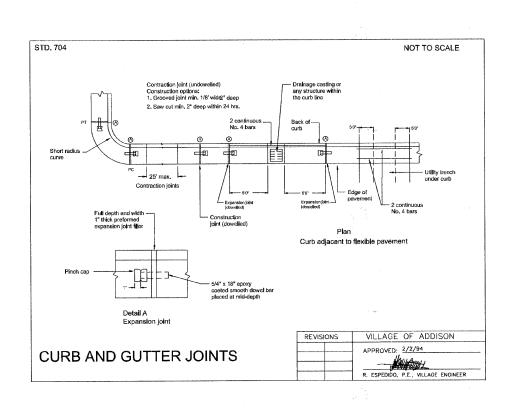

STD. 701D

CURB AND GUTTER GENERAL NOTES

- 1. Thickness: "T" = thickness of the curb or gutter
- Depressed curbs: The top of a curb shall be depressed where it is constructed across a sidewalk, driveway, or where directed by the Director of Community Development. The transition from full height curb to depressed curb shall be at the rate of 3" per foot.
- Sub-grade: Improved sub-grade shall extend 1' outside of the back of curb.
- Sub-base: The sub-base shall consist of 4" of compacted crushed limestone.
- Concrete: Shall be a 6 bag mix, attaining a strength of not less than 3500 P.S.I. in 28 days.
- Contraction joints: Maximum of 25' intervals, grooved or sawcut a minimum of 1/8" wide, and a minimum of 2" deep. Sawing shall be completed within 24 hours of the pour.
- 7. Expansion joints: 1" thick preformed joint filler with a single 5/4"x 18" epoxy coated smooth dowel bar, fitted with a pinch cap, installed 5' on either side of any structure within the curb line, at the PT and PC of a radius, and at the end of each concrete pour. Maximum spacing of 75'.
- Construction joints: Use whenever the placing of concrete is held up for 30 minutes or more. Construction joints shall be installed in the same manner as an expansion joint.

REVISI	ONS	VILLAGE OF ADDISON
		APPROVED: 2/2/94
		- MANNY
		R. ESPEDIDO, P.E., VILLAGE ENGINEER

*3884 ARMY TRAIL BLVD. *2625 MILL ROAD

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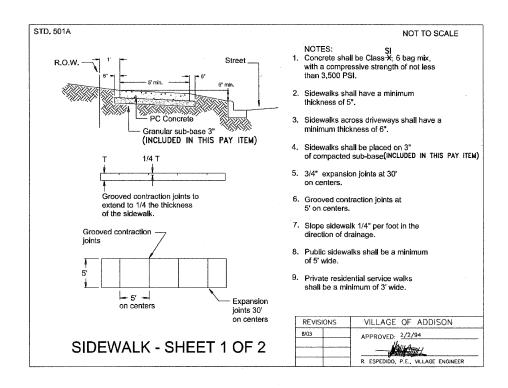
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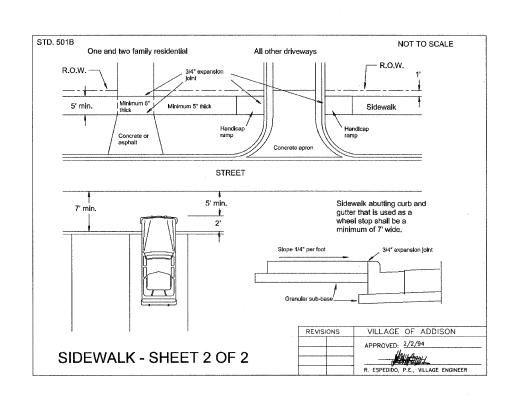
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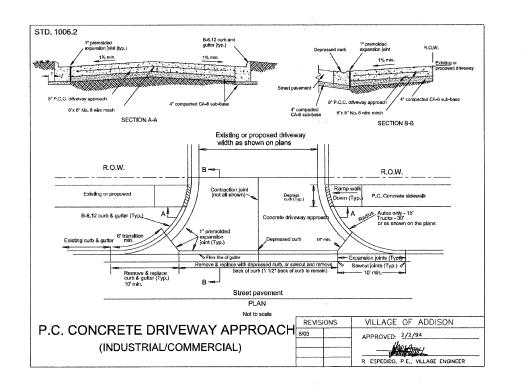
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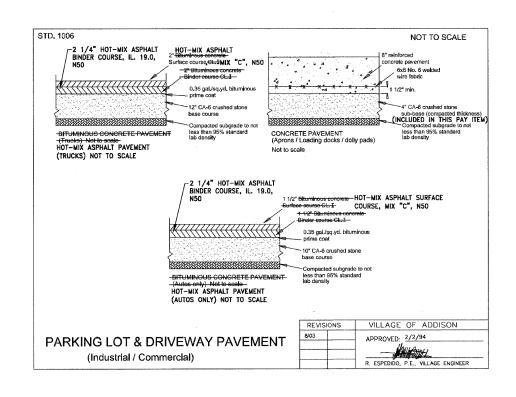
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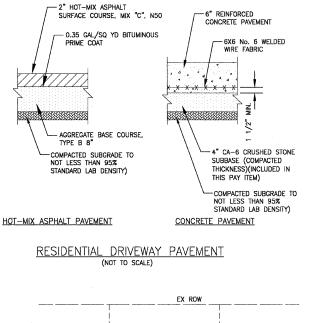
VILLAGE OF ADDISON, ILLINOIS
MILL ROAD AND ARMY TRAIL BOULEVARD
STP IMPROVEMENTS












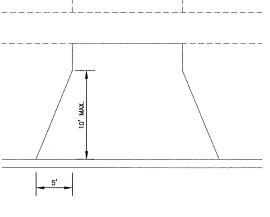

DRIVEWAY DETAIL

(NOT TO SCALE)

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B A X T E R
W O O D M A N
Consulting Engineers

EVISED - VILLAGE REVIEW 9-08-09
EVISED - VILLAGE REVIEW 11-05-09
EVISED - IDOT REVIEW 11-17-09
EVISED —

VILLAGE OF ADDISON, ILLINOIS MILL ROAD AND ARMY TRAIL BOULEVARD STP IMPROVEMENTS

	ADI	DISO	N DETA	AILS	
PF	ROJECT	NO:	070142	STA.	

TO STA.

*262	5 MILL	ROAD						
F.A.U. RTE.		SECT	ION		COUN	TY	TOTAL SHEETS	SHE
*	09	-0009	8-00-RS	3	DuPa	ge	69	5
C-91	-056-1	0			CONTRAC	T NO.	63427	
FED. RO	AD DIST. N	0. 1	ILLINOIS	FED. AII	PROJECT N	1-9003	(474)	

*3884 ARMY TRAIL BLVD.

8 WEST COLLEGE DRIV	File I E OFFICE: (847) 870-0544	No.: 19677
ARLINGTON HEIGHTS, IL	E OFFICE: (847) 870-0544 . 60004 FAX: (847) 870-0661	
	CORE LOG	
Client Baxter & Wo	odman, Inc. Reference Mill Rd. & Addison, IL	Army Trail Rd. Improveme
Core No: 1	Work Done By: AC & DA	
Location of Core:	Mill Road - Station 110+60 - 10' R.	
Description of Core Wa	all: Smooth	
(Depth, In.		Description
0-	Type of Material	Recovery
1	1-3/4" Bituminous concrete - surface	e Full
2-	1-3/4" Bituminous concrete - binder	Full
3	1 3/4 Directions Concrete Dimer	1022
4		
5-		
6 — 7 —	8-1/2" BBC	Ful1
8		
9		
10		
11		
12		
13		
14 —		
15	5-0" Crushed limestone	Partial
16		
17 E.O.C	Total 17-0"	
18		
19		
20		
G-333		

		BULTANTS, INC.	File No.: 19	677
8 WEST COLLEGE D ARLINGTON HEIGHTS		FICE: (847) 870-0544 FAX: (847) 870-0661		
		CORE LOG		
Client: Baxter &	Woodman, Inc	c. Reference Mills	Rd. & Army Tra	il Rd. Improveme
Core No: 2	Work	Done By: AC & DA	son, IL	
	W411	Road - Station 109+60 -	6' L.	
Location of Core:				
Description of Core	Wali: Smoot	th .		
Comments:		•		
(Depth,	in.)	Type of Material		Recovery
0	1-0		- eurfaca	Full
1-				
2	1-3.	/4" Bituminous concrete	- binder	Full
3				
4	-			
5	5-1	/4" BBC		Full
6				
8				
9				
10				
11				
12				
13				
14	14-0	" Large crushed limest	one & fines	Partial
15				
16				
17				
18				
19				
20				
22 E. G-333	O.C. Tota	sl 22-0"		

8 WEST COLLEGE DRIVE	OFFICE: (847) 870-0544	19677
ARLINGTON HEIGHTS, IL 600		
	CORE LOG	
Client: Baxter & Woodm	an, Inc. Reference Mill Rd. & Army Tr	rail Rd. Imp
Core No:3	Work Done By: AC & DA	
Location of Core:	Army Trail - Station 202+00 - 22 R. of BL	***
Description of Core Wall:	Smooth	
Comments:	*,	
	N. C.	
(Depth, In.)	Type of Material	0
c- [Type or Material	Recov
1	2-0" Bituminous concrete - surface	Fu13
2-	. .	
3	2-1/4" Bituminous concrete - binder	Full
4	-	
5	· · · · · · · · · · · · · · · · · · ·	
7	C 1/// 700	
8-	6-1/4" BBC	Fu11
B		
10 —	-	
11		
12	3-1/2" Crushed limestone	Part
13		rait
14- E.O.C.	Total 14-0"	
15		
16		
17		
18		
20		
]	

CORE LOG	SOIL AND MATERIAL	CONSULTANTS, INC.	
Section Baxter & Woodwart, Inc. Reference Mill Rd. & Army Trail Rd. Improve Addison, II.	8 WEST COLLEGE DRIVE ARLINGTON HEIGHTS, IL 600	OFFICE: (847) 870-0544	23077
Mork Done By AC & DA		CORE LOG	
Work Done By. AC & DA	Client: Baxter & Woodm		Trail Rd. Improv
Smooth S	Core No: 4	Work Done By: AC & DA	
Comments: Comm	Location of Core:	Army Trail - Station 209+00 - 12' L. of	BL
Comments: Comm	Description of Core Wall:	Smooth	
(Depth, in.) Type of Material 1-1/4" Bituminous concrete - surface Full 2 1-0" Bituminous concrete - surface Full 2-0" Bituminous concrete - binder 7 6 6 6 7 6-1/4" BEC Full 11- 12- 13- 14 15- 2.0.C. Total 14-1/4" Total 14-1/4" Total 14-1/4"			
Type of Material Recovery	John Market		
1-1/4" BEC Full 2	(Depth, In.)	The same of the sa	
FRESOMAT 2	0	7	
3 4 5 6 7 8 9 10 11- 12- 13- 14 15 16 17 18- 19	1	PETROMAT	
4 5 6 7 8 9 10 11 12 13 14 15 16 17 18 19 19 19 19 19	2-	1-0" Bituminous concrete - surface	Ful1
6 6 7 8 9 10 11 12 13 14 15 \$\overline{8.0.C.}\$ Total 14-1/4" Total 14-1/4" Total 14-1/4"	3	2-0" Bituminous concrete - binder	Ful1
6 7 8 9 10 11 12 13 14 15 17 18 19 19 19 19 16 19 16 19 16 19 16 19 16 19 16 19 16 19 16 19 16 19 16 19 16 19 16 19 16 17 18 19 17 18 19 17 18 19 17 18 19 17 18 19 17 18 19 17 18 19 19 18 19 19 18 19 19 19 18 19 18 19			
7 8 6-1/4" BEC Full 8 9 10 11 4-1/4" Crushed limestone Fartial 12 13 14 15 E.O.C. Total 14-1/4"			
8	-	6-1/4" PBC	Pu11
9 10 11 12 13 14 15 16 17 18 19 10 11 12 4-1/4" Crushed limestone Partial Part		0-174 BBC	rdii
10 11 12 13 14 15 16 17 18 19			
11 — 12 — 4-1/4" Crushed limestone Fartial 14 — 15 — 8.0.C. Total 14-1/4" 18 — 19 —		manufacture and the second sec	
12 — 13 — 4-1/4" Crushed limestone Fartial 14 — 15 — 2.0.C. Total 14-1/4"	ļ	†	
13 — 14 — 15 — 16 — 17 — 18 — 19 —	1		
15 16 17 18 19	13 —	4-1/4" Crushed limestone	Partial
16 s. U. U. 16 17 18 19	14		
17 18 19	15 - E.O.C.	Total 14-1/4"	
18	16		
19—	17		
	18		
20	19 —		
1 1	20		

SOIL AND MAI	ERIAL CONSULTANTS, INC.	File No.: 19	677
8 WEST COLLEGE I ARLINGTON HEIGHT	PRIVE OFFICE: (847) 870-0544 E, IL 80004 FAX: (847) 870-0661	- The state of the	
	CORE LO	<u>og</u>	
Client: Baxter &	Woodman, Inc. Reference	e Mill Rd. & Army Tr	ail Rd. Improves
Core No:	Work Done By:	Addison, IL	
Location of Core:_	Army Trail - Station 2	16+00 - 20' R. of BL	
Description of Core	Cmanth		
· ·			
Comments:			
(Depth			
0	Type of Mat	erial	Recovery
1	2-1/2" Bituminous con	icrete - surface	Full
2	PETROMAT		
3	2-1/4" Bituminous com	ncrete - binder	Full
4			
5			
6 7			
8	7-3/4" BBC		Full
9			
10			
11			
12 —			
13			
14	5-1/2" Crushed limes	tone	Partial
15			
17			
	Total 18-0"		
19			
20			
L			

ARLINGTON HEIGHTS, IL 600		
	CORE LOG	
Client: Bexter & Woodma	n, Inc. Reference Mill Rd. & Army To	ail Rd. Improvem
Core No: 6	Work Done By: AC & DA	
Location of Core:	Army Trail - Station 223+00 ~ 25' L. of BI	
Description of Core Wall:	Smooth	
Comments:		
odimiojio		
(Depth, In.)	T	Р.
0-	Type of Material 1-0" Bituminous concrete - surface	Recovery Full
1	PETROMAT 1-0" Bituminous concrete - surface	
2-	1-0 bituminous concrete - surface	Full
3	2-0" Bituminous concrete - binder	Full
4-	1	
5		
6		
7	8-1/4" BBC	Full
9		
10		
11		
12 —]	
13		
14 —		
15 —	4-3/4" Crushed limestone	Partial
16		
17 E.O.C.	Total 17-0"	
18		
19		
20]	

-	Arlington Heights, Illino	is (847) 8	70-054	4			Loggad		DA	7	je: 1 of	1
Client: Ba	axter & Woodman, Inc.	,					File No	. 19	677	Date Drille	d: 8/13	/09
A	111 Rd. & Army Trail ddison, IL			6			Drilled	By:	AC			
Comments: M	ill Road - Station 11	14-90, YO. K	••	E	quip	ment:	EXCME	45B	C) CME 55	□ Hand	Auger 🖸	Other
Elev., ft.	Description	Depth, ft.	0	s	Т	R	В	Ņ	Pen.	W	Uw	Qu
Bla cin Bla dam Bla san Dar san to	(SEE CORE LOG) Mn-gray clay, some sil d s gravel, damp, hard — do silt, some clay, tra dero, damp, maddum dams clay, tra dero, damp, maddum dams clay, tra p, loose (topsoil) k gray to brown-gray d & gravel, damp-very k gray to brown-gray d & gravel, damp-very tough	Fill ce sand & e - Fill ce sand, clsy,some damp,tough clay,some damp,stiff	5 5	3 4 5	SS SS	18" 18"	5 6 9 3 4 5 3 4 5 5 5 5 5	9 9	1.25	21.0 20.6 26.4 22.3 27.4	108.2	
	y clay,some silt,trac vel,damp,tough	e sand a	_	7	SS	18"	5	10	1.5	20.8	109.9	1.3
	End of Boring	- - - - - -	15		P. S. C.							

Client	Baxter & Woodman, Inc.						File No	. 19	677	Date Drille	a. 8/1	3/09
	Mill Rd. & Army Trail Rd. Addison, IL	Improv	enent	s			Drilled		AC	Pate Dille	u, 0/1	
Comments	: Mill Road - Station 109+6	0, 6' L	•		Equip	ment:	ER CME	45B	C3 CME 58	5 C3 Hand	Auger 🗆	Other
Elev., ft.	Description	Depth, ft.	0	s	т	R	В	N	Pen.	W	Uw	Q
_	(SEE CORE LOG)											
F	Crushed limestone,damp-sat	urnted	-									
	dense to medium dense - F									l		
_						L	17 17					L
		-		١,	88	18"	1.7	32		4.9		
\vdash			-	١.	35	1.8.	8	32		4.9		
							10					
			_ 5	_2	SS	14"	15	25		4.5		
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			士	l		1	7			l		
				١.			7	٠.				
			+	_3_	SS_	12"	7	14		5.7		
		-	_	1		1			1			
			\Box			l	8				l	ĺ
-	Brown-gray-black clay & si	le tree	- 40	4	SS	1.5"	7	10		8.7 27.7	l	l
	sand & gravel, very damp, me	dium de	nse		30	1		10.				
				6	1		2			20.1	ł	1
_	Brown clay, some silt, trace	sand &	-	١,	88	18"	5	9	3.5	18.3	111.9	3.
-	gravel,damp,very tough End of Boring			۱′	55	122		9	3.5	10.3	111.9	3.
	nut or porting					†			· · · · ·	<u> </u>		
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			record							operations (.	A.D.).	

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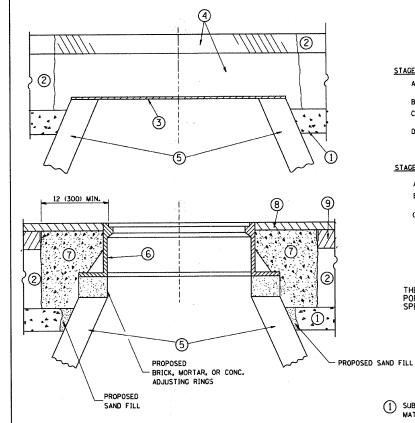
ESIGNED - JJS	REVISED - VILLAGE REVIEW 9-08-09
RAWN - UKB	REVISED - VILLAGE REVIEW 11-05-09
HECKED - SMV	REVISED - IDOT REVIEW 11-17-09
ATE - 8-19-09	REVISED -

VILLAGE OF ADDISON, ILLINOIS MILL ROAD AND ARMY TRAIL BOULEVARD STP IMPROVEMENTS

SOIL BORINGS AND **PAVEMENT CORES**

*3884 ARMY TRAIL BLVD. *2625 MILL ROAD

SCALE: HORIZ. 1"=20' / VERT. 1"=5' PROJECT NO: 070142 STA.



1 SUB-BASE GRANULAR MATERIAL

6 FRAME AND LID (SEE NOTES)

2 EXISTING PAVEMENT 3 36 (900) DIAMETER METAL PLATE CLASS SI CONCRETE.

HMA SURFACE COURSE OR

HMA BINDER COURSE

PROPOSED CRUSHED STONE AND HAMA SURFACE MIX

8 PROPOSED HMA SURFACE COURSE

5 EXISTING STRUCTURE

9 PROPOSED HMA BINDER COURSE

LOCATION OF STRUCTURES:

THE CONTRACTOR WILL BE REQUIRED TO KEEP A RECORD OF THE LOCATIONS OF THE BURIED STRUCTURES ACCORDING TO THE STATION AND DISTANCE LEFT OR RIGHT OF THE CENTERLINE OF PAVEMENT. UPON COMPLETION OF THE WORK, THE CONTRACTOR WILL DELIVER THE RECORD TO THE ENGINEER.

CONSTRUCTION PROCEDURES

A) REMOVE A MINIMUM OF 12 (300) OF THE PAVEMENT FROM AROUND THE STRUCTURE. B) REMOVE THE EXISTING FRAME AND LID FROM THE STRUCTURE. C) COVER THE STRUCTURE OPENING WITH A 36 (900) DIAMETER METAL PLATE.

D) BACKFILL WITH CRUSHED STONE AND A MINIMUM 11/2 (40) THICK HMA SURFACE MIX APPROVED BY THE ENGINEER.

A) REMOVE THE HMA SURFACE MIX AND CRUSHED STONE. B) INSTALL THE FRAME AND LID; ADJUST THE FRAME TO ITS FINAL SURFACE ELEVATION.

C) THE SURROUNDING SPACE SHALL BE FILLED WITH CLASS SI CONCRETE, OR HMA SURFACE COURSE OR HMA BINDER COURSE TO THE ELEVATION OF THE SURFACE OF THE EXISTING BASE COURSE OR THE BINDER COURSE.

LEGEND

THE PROCEDURE EXPLAINED ABOVE SHALL CONFORM TO THE APPLICABLE PORTIONS OF SECTIONS 353, 406, 602, AND 603 OF THE STANDARD SPECIFICATIONS.

STAGE 1 (BEFORE PAVEMENT MILLING)

STAGE 2 (AFTER PAVEMENT MILLING)

BASIS OF PAYMENT: THIS WORK WILL BE PAID FOR AT THE CONTRACT UNIT PRICE PER EACH FOR "FRAMES AND LIDS TO BE ADJUSTED, SPECIAL"

NEW FRAMES AND LIDS, WHEN SPECIFIED, WILL BE PAID FOR SEPARATELY.

DETAILS FOR FRAMES AND LIDS ADJUSTMENT WITH MILLING

- * 3884 ARMY TRAIL BOULEVARD * 2625 MILL ROAD

ALL DIMENSIONS ARE IN INCHES (MILLIMETERS) UNLESS OTHERWISE SHOWN

COUNTY

DuPAGE

REVISED - R. SHAH 03-10-95 DESIGNED - R. SHAH FILE NAME = USER NAME = gagl:anobt DRAWN REVISED - A. ABBAS 03-21-97 /:\d:ststd\22x34\bdØ8.dgr REVISED - R. WIEDEMAN 05-14-04 CHECKED -PLOT SCALE = 50.0000 '/ IN. REVISED - R. BORO 01-01-07 DATE - 10-25-94 PLOT DATE = 1/4/2008

STATE OF ILLINOIS **DEPARTMENT OF TRANSPORTATION**

NOTES:

EXISTING BROKEN FRAMES AND LIDS SHALL BE REMOVED AND DISPOSED OF BY THE CONTRACTOR AND SHALL BE REPLACED AS DIRECTED BY THE ENGINEER. REPLACEMENT FRAMES AND LIDS WILL BE PAID FOR IN ACCORDANCE WITH ARTICLE 109,04 OF THE STANDARD SPECIFICATIONS UNLESS A SEPARATE PAY ITEM HAS BEEN PROVIDED.

IF THE EXISTING LIDS ARE OPEN, THE FRAME WILL BE ADJUSTED TO THE ELEVATION OF THE MILLED PAVEMENT SURFACE PRIOR TO THE MILLING OPERATION. THE FRAME WILL NOT BE REMOVED AND COVERED BY THE METAL PLATE.

CITY OF CHICAGO CASTINGS ARE THE PROPERTY OF THE CITY AND THE CONTRACTOR SHALL NOTIFY THE CITY FOR REMOVAL AND DISPOSITION OF THE CASTINGS.

THE METAL PLATE USED TO COVER THE STRUCTURE SHALL REMAIN THE PROPERTY OF THE CONTRACTOR.


WHEN STRUCTURES ARE TO BE ADJUSTED OR RECONSTRUCTED.
THE LOWERING AND RAISING OF THE FRAMES AND LIDS WILL
NOT BE PAID FOR SEPARATELY BUT WILL BE INCLUDED IN THE
COST OF THE CORRESPONDING PAY ITEM.

DETAILS FOR FRAMES AND LIDS ADJUSTMENT WITH MILLING SHEET NO. 1 OF 1 SHEETS STA. SCALE: NONE

CONTRACT NO. 63427 BD600-03 (BD-8) AID PROJECT M-9003 (474) FED. ROAD DIST, NO. 1 ILLINOIS FED.

SECTION

C-91-056-10

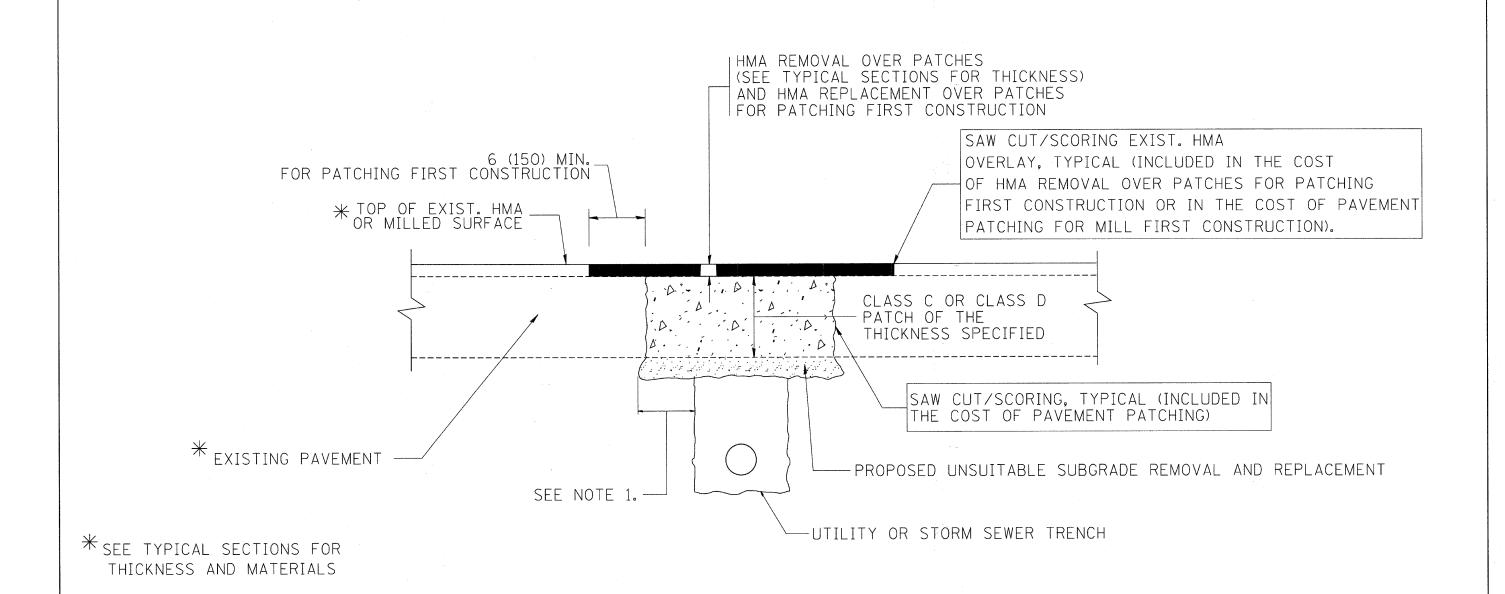

NOTES:

- 1. THE WIDTH OF THE FULL DEPTH PATCH OVER A TRENCH SHALL BE 12 (300) WIDER ON EACH SIDE OF THE TRENCH.
- 2. FOR METHOD OF MEASUREMENT AND BASIS OF PAYMENT, SEE RECURRING SPECIAL PROVISION "PATCHING WITH HOT-MIX ASPHALT OVERLAY REMOVAL".

SEQUENCE OF CONSTRUCTION (PATCHING FIRST)

- 1. REMOVE THE EXISTING HMA MATERIAL OVER THE AREA TO BE PATCHED.
- 2. REMOVE AND REPLACE WITH CLASS C OR D PATCH.
- 3. REPLACE HMA MATERIAL OVER THE AREA TO BE PATCHED.

SEQUENCE OF CONSTRUCTION (MILLING FIRST)

- 1. MILL HMA FIRST IF THERE IS AT LEAST $4\frac{1}{2}$ INCHES OR MORE OF HMA MATERIAL ON TOP OF THE EXISTING PAVEMENT OR IF THE PAVEMENT IS FULL DEPTH HMA. A MINIMUM OF 2 INCHES OF HMA MATERIAL SHALL BE IN PLACE AFTER MILLING.
- 2. REMOVE AND REPLACE WITH FULL DEPTH CLASS D PATCHES TO TOP OF MILLED SURFACE.


* 3884 ARMY TRAIL BOULEVARD

* 2625 MILL ROAD

ALL DIMENSIONS ARE IN INCHES (MILLIMETERS) UNLESS OTHERWISE SHOWN.


FILE NAME =	USER NAME = bauerdl	DESIGNED - R. SHAH	REVISED - A. ABBAS 04-27-98		V2 1	PAVEMENT PATCHING FOR	F	TE. SECTION	COUNTY SHEETS NO
c:\projects\diststd22x34\bd22.dgn		DRAWN -	REVISED - R. BORO 01-01-07	STATE OF ILLINOIS		HMA SURFACED PAVEMENT		* 09-00098-00-RS	DuPAGE 69 61
	PLOT SCALE = 50.000 '/ IN.	CHECKED ~	REVISED - R. BORO 09-04-07	DEPARTMENT OF TRANSPORTATION	,			BD400-04 (BD-22)	CONTRACT NO. 63427
	PLOT DATE = 10/27/2008	DATE - 10-25-94	REVISED ~ K. ENG 10-27-08		SCALE: NONE	SHEET NO. 1 OF 1 SHEETS STA.	TO STA.	ED. ROAD DIST. NO. 1 ILLINOIS FED. A	AID PROJECT M-9003 (474)

C-91-056-10

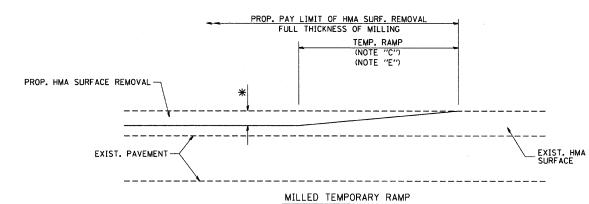


(FOR BUTT JOINT AND HMA TAPER SEE DETAIL BELOW)

OPTION 1

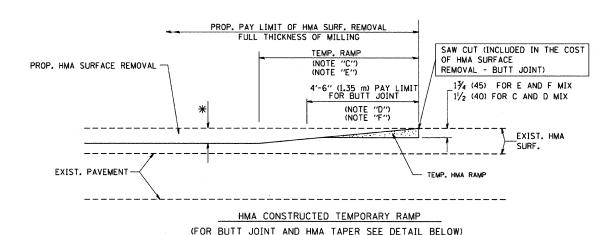

OPTION 2 TYPICAL TEMPORARY RAMP

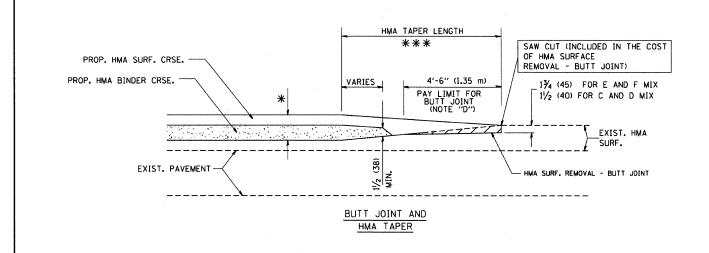

TYPICAL BUTT JOINT AND HMA TAPER FOR MILLING AND RESURFACING

FILE NAME = DESIGNED - M. DE YONG REVISED - R. SHAH 10-25-94 USER NAME = gaglianobt \diststd\22x34\bd32.dgn DRAWN REVISED - A. ABBAS 03-21-97 PLOT SCALE = 50.0000 '/ IN. CHECKED REVISED - M. GOMEZ 04-06-01 PLOT DATE = 1/4/2008 06-13-90 DATE REVISED - R. BORO 01-01-07


STATE OF ILLINOIS **DEPARTMENT OF TRANSPORTATION**


BUTT JOINT AND HMA TAPER DETAILS SHEET NO. 1 OF 1 SHEETS STA. TO STA. SCALE: NONE

* 2625 MILL ROAD ALL DIMENSIONS ARE IN INCHES (MILLIMETERS) UNLESS

OTHERWISE SHOWN. COUNTY TOTAL SHEE SHEETS NO. SECTION 09-00098-00-RS DuPAGE 69 62 CONTRACT NO. 63427 BD400-05 BD32

C-91-056-10

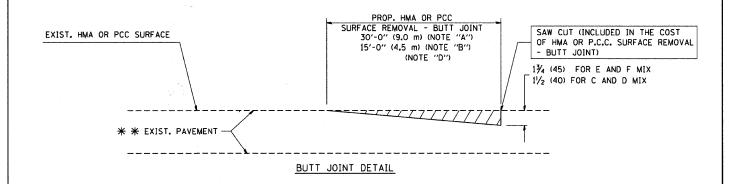

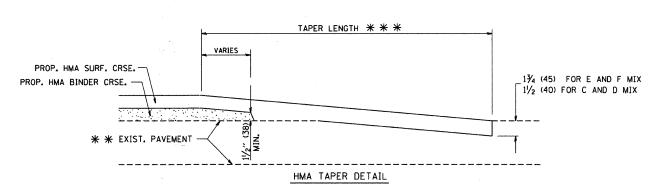

TYPICAL BUTT JOINT AND HMA TAPER FOR RESURFACING ONLY

* * PC CONCRETE, HMA OR HMA RESURFACED PAVEMENT.


NOTES

- A: MAINLINE ROADWAYS AND MAJOR SIDE ROADS.
- B: MINOR SIDE ROADS.
- C: THE TEMP. RAMP SHALL BE CONSTRUCTED IMMEDIATELY UPON REMOVAL OF THE EXISTING HMA SURFACE.
- D: THE BUTT JOINT SHALL BE CONSTRUCTED IMMEDIATELY PRIOR TO PLACING THE PROPOSED HMA COURSES.
- E: TAPER THE TEMP. RAMP AT A RATE OF 3'-0" (900 mm) PER 1 INCH (25 mm) OF MILLING THICKNESS.
- F: INSTALLATION AND REMOVAL OF THE 4'-6" (1.35 m) TEMP. RAMP IS INCLUDED IN COST OF HMA SURFACE REMOVAL - BUTT JOINT
- G: SEE ARTICLE 406.08 AND 406.14 OF THE STANDARD SPECIFICATIONS FOR "HMA AND/OR PCC SURFACE REMOVAL, BUTT JOINT".
- * SEE TYPICAL SECTIONS FOR MILLING THICKNESS.
- ** ** * 20'-0" (6.1 m) PER 1 (25) RESURFACING (NOTE "A") 10'-0" (3.0 m) PER 1 (25) RESURFACING (NOTE "B")

BASIS OF PAYMENT:

THE BUTT JOINT WILL BE PAID FOR AT THE CONTRACT UNIT PRICE PER SQUARE YARD (SQUARE METER) FOR "HOT-MIX ASPHALT SURFACE REMOVAL - BUTT JOINT" OR FOR "PORTLAND CEMENT CONCRETE SURFACE REMOVAL- BUTT JOINT".

* 3884 ARMY TRAIL BOULEVARD

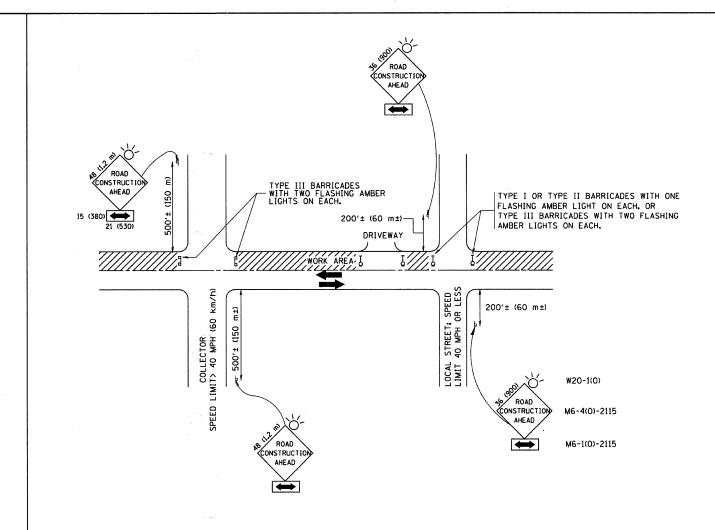

TRAFFIC CONTROL AND PROTECTION FOR SIDE ROADS, INTERSECTIONS, AND DRIVEWAYS

NOTES:

- A. FOR NO LANE RESTRICTION ON THE SIDE ROAD OR DRIVEWAYS
- 1. SIDE ROAD WITH A SPEED LIMIT OF 40 MPH (60 km/h) OR LESS AS SHOWN ON THE DRAWING AND AS DIRECTED BY THE ENGINEER:
- O) ONE ROAD CONSTRUCTION AHEAD SIGN 36 x 36 (900x900) WITH A FLASHER AND FLAG MOUNTED ON IT APPROXIMATELY 200' (60 m) IN ADVANCE OF THE MAIN ROUTE.
- b) THE CLOSED PORTION OF THE MAIN ROUTE SHALL BE PROTECTED BY BLOCKING WITH TYPE I, TYPE II OR TYPE III BARRICADES, 1/3 OF THE CROSS SECTION OF THE CLOSED PORTION.
- 2. SIDE ROAD WITH A SPEED LIMIT GREATER THAN 40 MPH (60 km/h)
 AS SHOWN ON THE DRAWING AND AS DIRECTED BY THE ENGINEER:
- O) ONE ROAD CONSTRUCTION AHEAD SIGN 48 × 48 (1.2 m × 1.2 m) WITH A FLASHER MOUNTEO ON 1T APPROXIMATELY 500' (150 m) IN ADVANCE OF THE MAIN ROUTE.
- b) THE CLOSED PORTION OF THE MAIN ROUTE SHALL BE PROTECTED BY BLOCKING WITH TYPE III BARRICADES, 1/2 OF THE CROSS SECTION OF THE CLOSED PORTION.
- WHEN THE SIDE ROAD LIES BETWEEN THE BECINNING OF THE MAINLINE SIGNING AND THE WORK ZONE, A SINGLE-HEADED ARROW (MG-1) SHALL BE USED IN LIEU OF THE DOUBLE HEADED ARROW (MG-4).

- B. FOR A LANE CLOSURE ON A SIDE ROAD OR DRIVEWAY:
- USE APPLICABLE PORTIONS OF THE TYPICAL APPLICATION OF TRAFFIC CONTROL DEVICES (STD. 701501, STD. 701606 OR THE APPROPRIATE STANDARD). THE SPACING OF SIGNS AND BARRICADES SHALL BE ADJUSTED FOR FIELD CONDITIONS AS DIRECTED BY THE ENGINEER. THE DIRECTIONAL ARROW SHALL BE COVERED OR REMOVED WHEN NO LONGER CONSISTENT WITH THE SIDE ROAD LANE CLOSURE.
- C. ADVANCE WARNING SIGNS ARE TO BE OMITTED ON DRIVEWAY UNLESS OTHERWISE NOTED.
- D. THE TRAFFIC CONTROL AND PROTECTION FOR SIDE ROADS, INTERSECTIONS, AND DRIVEWAYS SHALL BE INCIDENTAL TO THE COST OF SPECIFIED TRAFFIC CONTROL STANDARDS OR ITEMS.
 - * 3884 ARMY TRAIL BOULEVARD
 - * 2625 MILL ROAD

All dimensions are in millimeters (inches) unless otherwise shown.

FILE NAME = USER NAME = geglionobt DESIGNED - LHA REVISED - J. OBERLE 10-18-95
Windistatd\22x34\tcl0.dgn

| DRAWN - REVISED - A. HOUSEH 03-06-96
| PLOT SCALE = 50.000 '/ IN. CHECKED - REVISED - A. HOUSEH 10-15-96
| PLOT DATE = 1/4/2008 DATE - 06-89 REVISED - T. RAMMACHER 01-06-00

STATE OF ILLINOIS
DEPARTMENT OF TRANSPORTATION

TRAFFIC CONTROL AND PROTECTION FOR
SIDE ROADS, INTERSECTIONS, AND DRIVEWAYS


SCALE: NONE SHEET NO. 1 OF 1 SHEETS STA. TO STA.


F.A.^O, SECTION COUNTY SHEETS NO.


* 09-00098-00-RS DUPAGE 69 63

TC-10 CONTRACT NO. 63427


FED. ROAD DIST. NO. 1 | ILLINOIS | FED. AID | PROJECT | M-9003 (474) | C-91-056-10

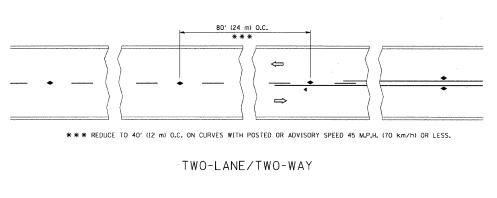


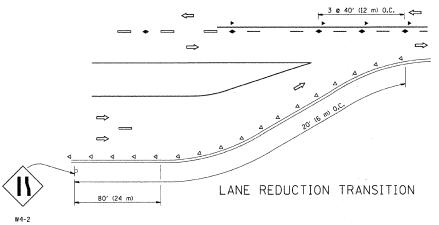

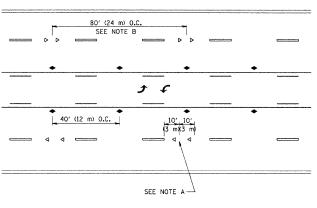

TWO-WAY LEFT TURN

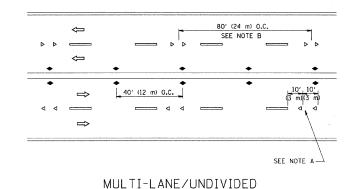

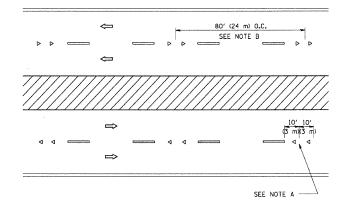

MULTI-LANE/DIVIDED

GENERAL NOTES

- 1. MARKERS USED WITH DASHED LINES SHALL BE CENTERED IN THE GAP BETWEEN SEGMENTS.
- 2. MARKERS USED ADJACENT TO SOLID LINES SHALL BE OFFSET 2 TO 3 (50 TO 75) TOWARD TRAFFIC AS SHOWN.
- 3. MARKERS THROUGH TANGENTS LESS THAN 500' (150 m) IN LENGTH BETWEEN CURVES SHALL BE INSTALLED AT THE LESSER OF THE TWO CURVE SPACINGS.

LANE MARKER NOTES


- A. USE DOUBLE LANE LINE MARKERS SPACED AS SHOWN.
- B. REDUCE TO 40' (12 m) O.C. ON CURVES WHERE ADVISORY SPEEDS ARE 10 M.P.H (20 km/h) LOWER THAN POSTED SPEEDS.

SYMBOLS

- ---- YELLOW STRIPE
- WHITE STRIPE
- ONE-WAY AMBER MARKER
- ONE-WAY CRYSTAL MARKER (W/O)
- ◆ TWO-WAY AMBER MARKER

DESIGN NOTES

- 1. DOUBLE LANE LINE MARKERS SHALL BE USED UNLESS SPECIFIED OTHERWISE.
- 2. EXCEPT AS SHOWN ON THE LANE REDUCTION TRANSITION AND FREEWAY EXIT RAMP DETAIL, MARKERS ARE NOT TO BE SPECIFIED ON RIGHT EDGE
- 3. THE EXACT MARKER LIMITS, SPACING, AND COLOR SHOULD BE INCLUDED IN THE PLANS.
- 4. MARKERS SHOULD NOT BE USED ALONGSIDE CURBS EXCEPT FOR EXTREMELY SHORT SECTIONS OF CURBS WHERE NOT MORE THAN TWO MARKERS WOULD BE INVOLVED.

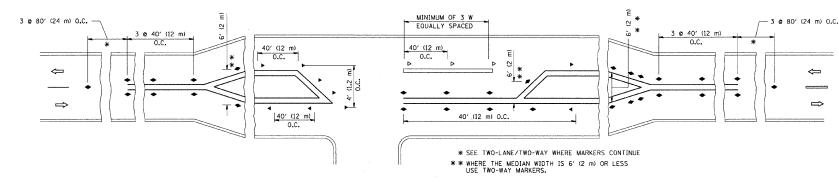

LEFT TURN

* 3884 ARMY TRAIL BOULEVARD

* 2625 MILL ROAD

All dimensions are in inches (millimeters)


	•					
TILE NAME =	USER NAME = drivakosgn	DESIGNED -	REVISED	-T. RAMMACHER	09-19-94	
:/pw_work/pwidot/drivakosgn/dØ108315/tc	1.dgn	DRAWN -	REVISED	-T. RAMMACHER	03-12-99	
	PLOT SCALE = 50.000 '/ IN.	CHECKED -	REVISED	T. RAMMACHER	01-06-00	
	PLOT DATE = 9/9/2009	DATE -	REVISED	- C. JUCIUS	09-09-09	


STATE OF ILLINOIS **DEPARTMENT OF TRANSPORTATION**

TYPICAL APPLICATIONS RAISED REFLECTIVE PAVEMENT MARKERS (SNOW-PLOW RESISTANT) SHEET NO. 1 OF 1 SHEETS STA.


unless otherwise shown. SECTION COUNTY 09-0098-00-RS DuPAGE

| TC-11 | CONTRACT NO. 63427 | FED. ROAD DIST. NO. 1 | ILLINOIS | FED. AID | PROJECT | M-9003 (474) C-91-056-10

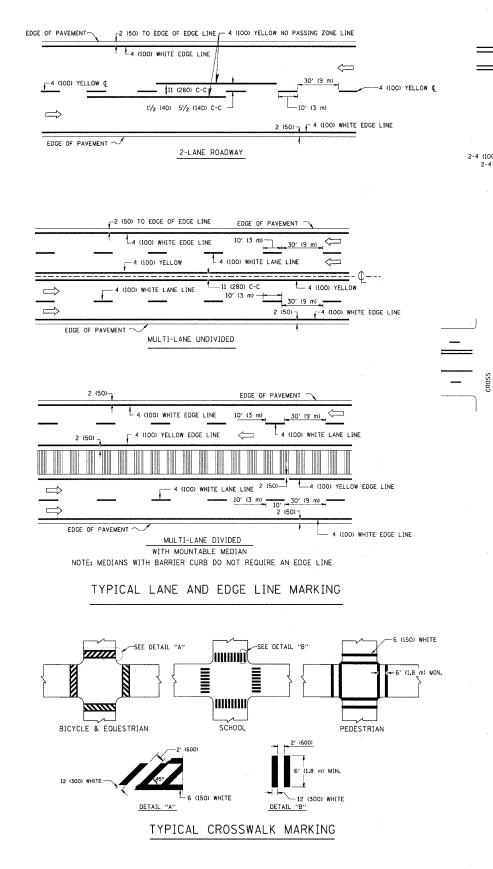

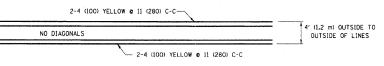


4' (1.2 m) WIDE MEDIANS ONLY

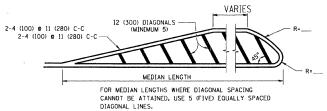


DIAGONAL LINE SPACING: 50' (15 m) C-C (LESS THAN 30MPH (50 km/h))
75' (25 m) C-C 30MPH (50 km/h) TO 45MPH (70 km/h))
150' (45 m) C-C (MORE THAN 45MPH (70 km/h))

MEDIANS OVER 4' (1.2 m) WIDE

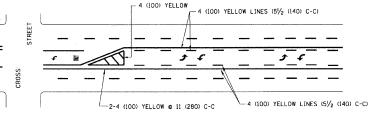


A MINIMUM OF TWO PAIRS OF TURN ARROWS SHALL BE USED, WHITE IN COLOR. ADDITIONAL PAIRS SHALL BE PLACED AT 200' (60 m) TO 300' (90 m) INTERVALS.

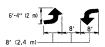

MEDIAN WITH TWO-WAY LEFT TURN LANE


TYPICAL PAINTED MEDIAN MARKING

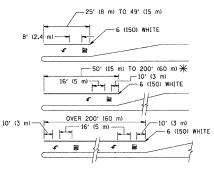

* TURN LANES IN EXCESS OF 400' (120 m) IN LENGTH MAY HAVE AN ADDITIONAL SET OF ARROW - "ONLY" INSTALLED MIDWAY BETWEEN THE OTHER TWO SETS OF ARROW - "ONLY".

TYPICAL LEFT (OR RIGHT) TURN LANE

TYPICAL TURN LANE MARKING

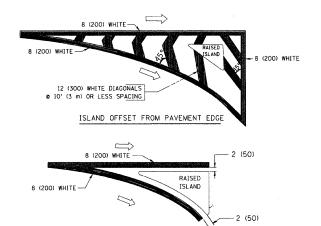

TYPICAL ISLAND MARKING

ISLAND AT PAVEMENT EDGE

				
TYPE OF MARKING	WIDTH OF LINE	PATTERN	COLOR	SPACING / REMARKS
CENTERLINE ON 2 LANE PAVEMENT	4 (100)	SKIP-DASH	YELLOW	10' (3 m) LINE WITH 30' (9 m) SPACE
CENTERLINE ON MULTI-LANE UNDIVIDED PAVEMENT	2 @ 4 (100)	SOLID	YELLOW	11 (280) C-C
NO PASSING ZONE LINES: FOR ONE DIRECTION FOR BOTH DIRECTIONS	4 (100) 2 © 4 (100)	SOLID SOLID	YELLOW YELLOW	5½ (140) C-C FROM SKIP-DASH CENTERLINE 11 (280) C-C OMIT SKIP-DASH CENTERLINE BETWEEN
LANE LINES	4 (100) 5 (125) ON FREEWAYS	SKIP-DASH SKIP-DASH	WHITE WHITE	10' (3 m) LINE WITH 30' (9 m) SPACE
DOTTED LINES (EXTENSIONS OF CENTER, LANE OR TURN LANE MARKINGS)	SAME AS LINE BEING EXTENDED	SKIP-DASH	SAME AS LINE BEING EXTENDED	2' (600) LINE WITH 6' (1.8 m) SPACE
EDGE LINES	4 (100)	SOLID	YELLOW-LEFT WHITE-RIGHT	OUTLINE MOUNTABLE MEDIANS IN YELLOW; EDGE LINES ARE NOT USED NEXT TO BARRIER CURB
TURN LANE MARKINGS	6 (150) LINE; FULL SIZE LETTERS & SYMBOLS (8' (2.4m))	SOLID	WHITE	SEE TYPICAL TURN LANE MARKING DETAIL
TWO WAY LEFT TURN MARKING	2 @ 4 (100) EACH DIRECTION	SKIP-DASH AND SOLID	YELLOW	10' (3 m) LINE WITH 30' (9 m) SPACE FOR SKIP-DASH; 5½ (140) C-C BETWEEN SOLID LINE AND SKIP-DASH LINE
	8' (2.4m) LEFT ARROW	IN PAIRS	WHITE	SEE TYPICAL TWO-WAY LEFT TURN MARKING DETAIL
CROSSWALK LINES (PEDESTRIAN) A. DIAGONALS (BIKE & EQUESTRIAN) B. LONGITUDINAL BARS (SCHOOL)	2 @ 6 (150) 12 (300) @ 45° 12 (300) @ 90°	SOLID SOLID SOLID	WHITE WHITE WHITE	NOT LESS THAN 6' (1.8 m) APART 2' (600) APART 2' (600) APART SEE TYPICAL CROSSWALK MARKING DETAILS.
STOP LINES	24 (600)	SOLID	WHITE	PLACE 4' (1.2 m) IN ADVANCE OF AND PARALLEL TO CROSSWALK, IF PRESENT. OTHERWISE, PLACE AT DESIRED STOPPING POINT. PARALLEL TO CROSSROAD CENTERLINE, WHERE POSSIBLE
PAINTED MEDIANS	2 @ 4 (100) WITH 12 (300) DIAGONALS	SOLID	YELLOW: TWO WAY TRAFFIC	11 (280) C-C FOR THE DOUBLE LINE
Maria Maria	NO DIAGONALS USED FOR 4' (1.2 m) WIDE MEDIANS		WHITE: ONE WAY TRAFFIC	SEE TYPICAL PAINTED MEDIAN MARKING.
GORE MARKING AND CHANNELIZING LINES	8 (200) WITH 12 (300) DIAGONALS @ 45°	SOLID	WHITE	DIAGONALS: 15' (4.5 m) C-C (LESS THAN 30MPH (50 km/h)) 20' (6 m) C-C 30MPH (50 km/h) TO 45MPH (70 km/h)) 30' (9 m) C-C (OVER 45MPH (70 km/h))
RAILROAD CROSSING	24 (600) TRANSVERSE LINES: "RR" IS 6' (1.8 ml LETTERS: 16 (400) LINE FOR "X"	SOLID	WHITE	SEE STATE STANDARD 780001 AREA OF: "R"=3.6 SO. FT. (0.33 m ²) EACH "X"=54.0 SO. FT. (5.0 m ²)
SHOULDER DIAGONALS	12 (300) @ 45°	SOLID	WHITE - RIGHT YELLOW - LEFT	50' (15 m) C-C (LESS THAN 30MPH (50 km/h)) 75' (25 m) C-C (30 MPH (50 km/h) TO 45MPH (70 km/h)) 150' (45 m) C-C (0VER 45MPH (70 km/h))

FOR FURTHER DETAILS ON PAVEMENT MARKING REFER TO STANDARD SPECIFICATIONS FOR ROAD AND BRIDGE CONSTRUCTION AND STATE STANDARD 780001.


All dimensions are in inches (millimeters) unless otherwise shown.


* 3884 ARMY TRAIL BOULEVARD

* 2625 MILL ROAD

STATE OF ILLINOIS
DEPARTMENT OF TRANSPORTATION

	DISTRICT OF			F.A RTE.	SECTION 09-00098-00-RS	COUNTY DuPAGE	TOTAL SHEETS 69	SHEET NO. 65
,	ITPICAL PAVENIENI	MARKINGS			TC-13	CONTRACT	NO. 63	427
SCALE: NONE	SHEET NO. 1 OF 1 SHEETS	STA.	TO STA.	FED. R	OAD DIST. NO. 1 ILLINOIS FED. A	ID PROJECT M-9	003(47	4)
				C-9:	1-056-10			

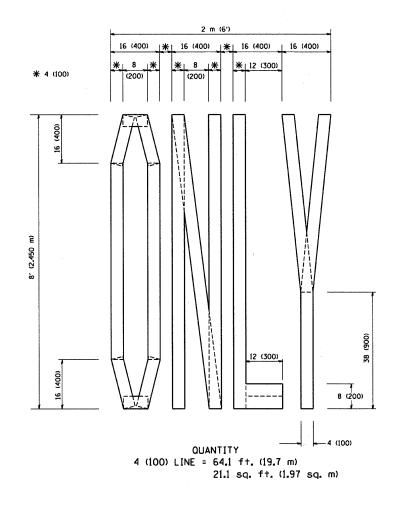

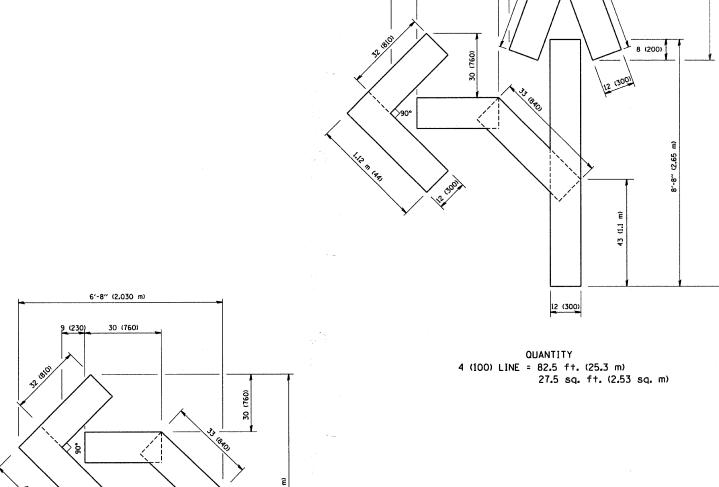

9 (230)

30 (800)

1'-8" (500)

OUANTITY 4 (100) LINE = 45.5 ft. (13.9 m) 15.2 sq. ft. (1.39 sq. m)

12 (300)

* 3884 ARMY TRAIL BOULEVARD * 2625 MILL ROAD

All dimensions are in inches (millimeters) unless otherwise shown.


FILE NAME =	USER NAME = gaglianobt	DESIGNED -	REVISED -T. RAMMACHER 06-05-96
W:\diststd\22x34\tc16.dgn		DRAWN -	REVISED -T. RAMMACHER 11-04-97
	PLOT SCALE = 50.0000 '/ IN.	CHECKED -	REVISED -T. RAMMACHER 03-02-98
	PLOT DATE = 1/4/2008	DATE ~ 09-18-94	REVISED - E. GOMEZ 08-28-00


STATE OF ILLINOIS
DEPARTMENT OF TRANSPORTATION

	PAVEMENT	MARKI	NG LETTER	RS AND	SYMBOLS							
FOR TRAFFIC STAGING												
SCALE: NONE	SHEET NO. 1	OF 1	SHEETS	STA.	TO STA.							

SIGNING FOR FLAGGING OPERATIONS AT WORK ZONE OPENINGS

WORK ZONE EXIT OPENING

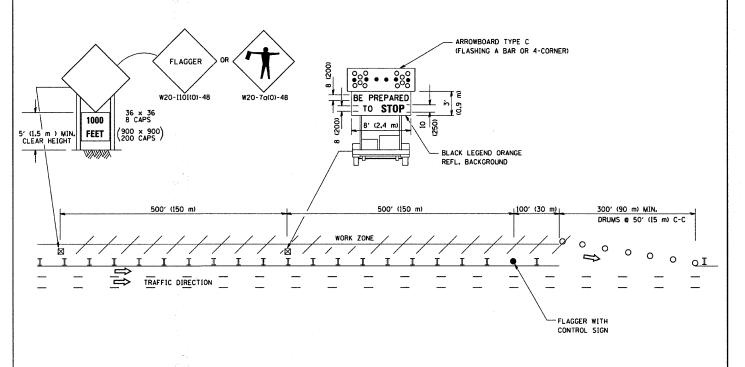

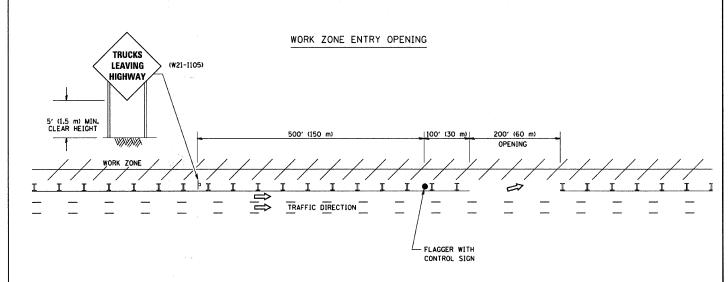


NOTES:

- The Arrowboard, the Flagger Ahead trailer mounted sign, and the Trucks Leaving Highway sign shall be removed or turned away from traffic and the exit and entry openings shall be closed when the flagging operation ceases.
- 2. Work Zone Exit Openings should be a minimum of one half mile apart.
- 3. Exiting the work zone at any place other than at a Work Zone Exit Opening will be prohibited.
- All vehicles shall enter the work zone at entry openings, using their turn signals to warn motorists
- * 3884 ARMY TRAIL BOULEVARD

* 2625 MILL ROAD

ALL DIMENSIONS ARE IN INCHES (MILLIMETERS)
UNLESS OTHERWISE SHOWN

FILE NAME =	USER NAME = gaglianobt	DESIGNED -	REVISED -	D.W.S. 08-98		· +/	SIGNING FOR FLAGGING OPERATIONS		F.A. U. RTE.	SECTION	COUNTY	TOTAL SHEET
W:\d:ststd\22x34\tc18.dgn		DRAWN -	REVISED -	J.A.F. 04-03	STATE OF ILLINOIS				*	09-00098-00-RS	DuPAGE	69 67
	PLOT SCALE = 50.000 '/ IN.	CHECKED -	REVISED -	J.A.F. 02-06	DEPARTMENT OF TRANSPORTATION	AT WORK ZONE OPENINGS				TC-18	CONTRACT	NO. 63427
	PLOT DATE = 1/4/2008	DATE -	REVISED -	S.P.B. 01-07		SCALE: NONE	SHEET NO. 1 OF 1 SHEETS STA.	TO STA.	FED. ROAD	DIST. NO. 1 ILLINOIS FED. A	ID PROJECT M-	003 (474)
							,		C-91	-056~10		

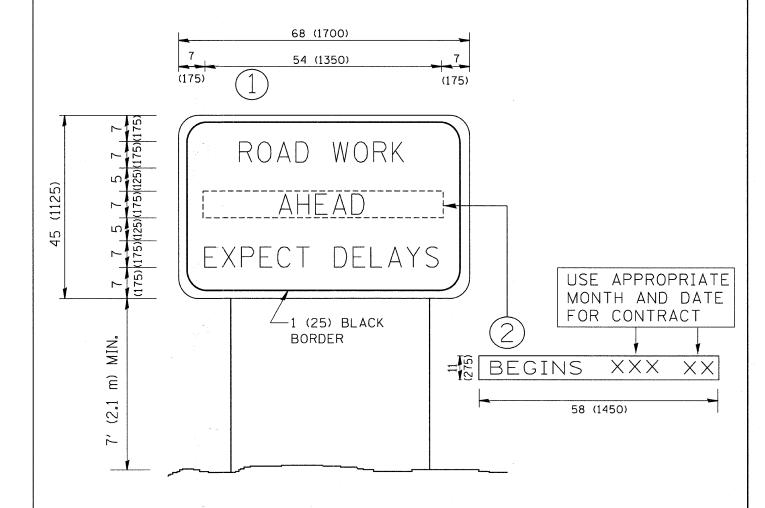

NOTES:

- 1. USE BLACK LETTERING ON ORANGE BACKGROUND.
- 2. ERECT SIGNS IN ADVANCE OF THE LOCATION FOR THE "ROAD CONSTRUCTION AHEAD" SIGN AT LOCATIONS AS DIRECTED BY THE ENGINEER.
- 3. ERECT SIGN (1) WITH INSTALLED PANEL (2) ONE WEEK PRIOR TO THE START OF CONSTRUCTION.
- 4. REMOVE PANEL (2) SOON AFTER THE START OF CONSTRUCTION.
- 5. SEE SPECIAL PROVISION FOR "TEMPORARY INFORMATION SIGNING" FOR ADDITIONAL INFORMATION.
- 6. ONE SIGN ASSEMBLY EQUALS 25.70 SQ. FT. (2.3 SQ. M.)
- 7. SHALL BE PAID FOR AS TEMPORARY INFORMATION SIGNING.

* 3884 ARMY TRAIL BOULEVARD

* 2625 MILL ROAD

ALL DIMENSIONS ARE IN INCHES (MILLIMETERS)
UNLESS OTHERWISE SHOWN.


FILE NAME =	USER NAME = gaglianobt	DESIGNED -	REVISED - R. MIRS 09-15-97			ARTERIAL ROAD	F.A.U. SECTION	COUNTY TOTAL SHEET
W:\diststd\22x34\tc22.dgn		DRAWN -	REVISED - R. MIRS 12-11-97	STATE OF ILLINOIS	*.	INFORMATION SIGN	* 09-00098-00-RS	DuPAGE 69 68
	PLOT SCALE = 50.000 ' / IN.	CHECKED -	REVISED -T. RAMMACHER 02-02-99	DEPARTMENT OF TRANSPORTATION	18. 2	INFURMATION SIGN	TC-22	CONTRACT NO. 63427
	PLOT DATE = 1/4/2008	DATE -	REVISED - C. JUCIUS 01-31-07		SCALE: NONE	SHEET NO. 1 OF 1 SHEETS STA. TO STA.	FED. ROAD DIST. NO. 1 ILLINOIS FED. A	ND PROJECT M-9003 (474)

PROVIDE A PAVEMENT REPLACEMENT NOTE WHICH SHOULD EQUAL 3' (900 mm) X WIDTH OF PAVED SHOULDER. PAVED OR NON-PAVED SHOULDER * = (600 mm) * * UNIT DUCT IS TO BE SHOWN ON PLAN SHEETS BUT SHALL NOT BE INCLUDED IN THE PAY ITEMS.

<u>LEFT TURN LANES WITH MEDIANS</u> VOLUME DENSITY ("FAR OUT" DETECTION) ON SAME APPROACH

(PROTECTED / PERMITTED LEFT TURN PHASING)

HANDHOLE LOCATION MAY VARY DEPENDING ON GEOMETRICS AND DESIGN OF TRAFFIC SIGNALS. HEAVY-DUTY HANDHOLES TO BE USED WHEN THE MEDIAN IS MOUNTABLE. REFER TO STANDARD 814001 TO ENSURE THAT HANDHOLE FITS IN MEDIAN.

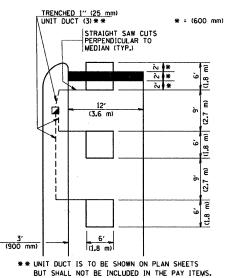


NOTE: DUAL LEFT TURNS NOT SHOWN REFER TO

PLAN SHEET FOR DETECTOR LOOP REPLACEMENT

LEFT TURN LANES WITHOUT MEDIANS
VOLUME DENSITY ("FAR OUT" DETECTION)
ON SAME APPROACH

(PROTECTED / PERMITTED LEFT TURN PHASING)

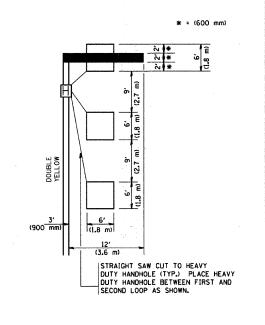



NOTE: DUAL LEFT TURNS NOT SHOWN REFER TO PLAN SHEET FOR DETECTOR LOOP REPLACEMENT

SCALE: NONE

ARTERIAL-VOLUME DENSITY ("FAR OUT" DETECTION)
CROSS STREET-VOLUME DENSITY ("FAR OUT" DETECTION)

ARTERIAL-VOLUME DENSITY ("FAR OUT" DETECTION)
CROSS STREET-NON VOLUME DENSITY ("UPTIGHT" PRESENCE DETECTION)

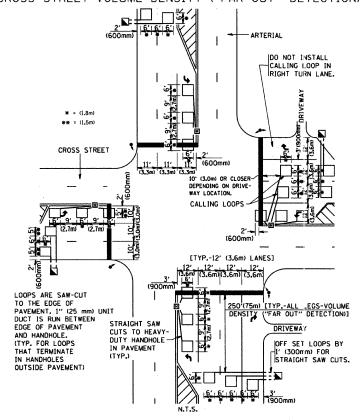

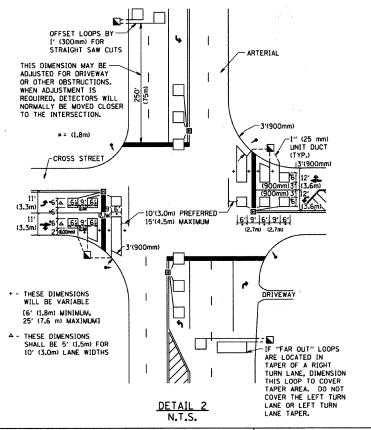

NOTE

VEHICLES LOOP DETECTORS

- * ALL LEAD IN CABLE SHALL BE TWO CONDUCTOR NO. 14 TWISTED, SHIELDED.
- * EACH DETECTOR LOOP SHALL HAVE ITS OWN SAW CUT FROM THE LOOP TO THE EDGE OF PAVEMENT OR TO A HANDHOLE IN THE PAVEMENT.
- * EACH DETECTOR LOOP SHALL HAVE ITS OWN ONE INCH (25 mm) UNIT DUCT BETWEEN THE EDGE OF PAVEMENT AND THE FIRST HANDHOLE OR JUNCTION BOX, EACH UNIT DUCT RUN SHALL BE SHOWN ON THE PLANS BY THE DESIGNER, BUT SHALL NOT BE PAID FOR SEPARATLY. THIS ITEM IS INCIDENTAL TO THE PAY ITEM FOR DETECTOR LOOPS.
- * ONE DIMENSION OF <u>ALL</u> DETECTOR LOOPS SHALL BE SIX FEET (1.8 m)
- * EACH LANE OF NON-LOCKING, PRESENCE DETECTION AND EACH LANE OF A DOUBLE LEFT TURN LANE REQUIRES A SEPARATE INDUCTIVE LOOP DETECTOR AND LEAD IN CABLE.
- * WHEN NON-LOCKING, PRESENCE DETECTION IS USED, MORE THAN ONE LOOP PER LANE IS REQUIRED BEHIND THE STOP BAR (1.e. 1-1/2, 1-3/4, 2).
- * WHEN SYSTEM LOOPS ARE REQUIRED ON AN APPROACH OF AN INTERSECTION, THE LOOPS USED FOR VOLUME DENSITY AND INTERSECTION TIMING SHALL ALSO BE USED AS SYSTEM DETECTORS. <u>EACH</u> ONE OF THESE TYPE OF LOOPS REQUIRES A <u>SEPARATE</u> TWO CONDUCTOR NO. 14 TWISTED SHIELDED CABLE AND A <u>SEPARATE</u> INDUCTIVE LOOP DETECTOR WHEN NEW CONTROLLERS ARE UTILIZED. THE DESIGNER SHALL LABEL THESE TYPES OF LOOPS AS "INTERSECTION AND SAMPLING (SYSTEM) DETECTORS" ON THE SIGNAL LAYOUT, THE INTERCONNECT PLAN AND THE SYSTEM CABLE PLAN. WHEN AN EXISTING CONTROLLER IS UTILIZED FOR THIS TYPE OF DETECTION, THE PAY ITEM "INDUCTIVE LOOP DETECTOR WITH SYSTEM OUTPUT" SHOULD BE USED.

PLACEMENT OF DETECTORS

THE FOLLOWING FIGURES REPRESENT THE MOST COMMON DETECTOR LOOP LOCATIONS AND SIZES. ADJUSTMENTS WILL BE NECESSARY FOR SPECIFIC GEOMETRIC CONSIDERATIONS.

LOCATIONS AND DEMENSIONS OF DETECTOR LOOPS ARE REQUIRED ON ALL SIGNAL LAYOUT PLAN SHEETS.

"FAR OUT" DETECTION REFERS TO LOCKING, PRESENCE TYPE DETECTION LOCATED IN THRU LANES, RIGHT TURN LANES, AND RIGHT TURN LANE TAPER AREAS (IF APPLICABLE), USUALLY 250' (75 m) IN ADVANCE OF STOP BARS. "UPTIGHT" DETECTION REFERS TO NON-LOCKING PRESENCE TYPE DETECTION LOCATED IN ALL LANES AND 10'-15' (3.0 m-4.5 m) BEHIND THE CROSSING STREET'S EDGE OF PAVEMENT EXTENDED.

NOTE:

ALL DETAILS AND NOTES SHOWN ARE FROM THE 1.D.O.T. DISTRICT 1
TRAFFIC SIGNAL DESIGN GUIDELINES DATED JANUARY 1995

THIS DRAWING HAS BEEN PREPARED TO ASSIST THE RESIDENT ENGINEER FOR ALL ROADWAY RESURFACING OR S.M.A.R.T. PROJECTS WHERE THE DIMENSIONS ARE NOT SHOWN ON THE PLANS AND THE FINAL LOCATIONS FOR CROSSWALKS OR STOP BARS ARE NOT DETERMINED.

* 3884 ARMY TRAIL BOULEVARD * 2625 MILL ROAD

DETAIL 1

STATE OF ILLINOIS
DEPARTMENT OF TRANSPORTATION

DISTRICT 1 - DETECTOR LOOP INSTALLATION
DETAILS FOR ROADWAY RESURFACING

SHEET NO. 1 OF 1 SHEETS STA. TO ST.

C-91-056-10