### 03-05-2021 LETTING ITEM 018

STATE OF ILLINOIS DEPARTMENT OF TRANSPORTATION

FOR INDEX OF SHEETS, SEE SHEET NO. 2 FOR HIGHWAY STANDARDS LIST, SEE SHEET NO. 2 FOR SUMMARY OF QUANTITIES, SEE SHEET NO. 3–5

### CURRENT TRAFFIC DATA

		FAP 71 (IL 54)
2020	ADT	2,200
2030	ADT	2,300
2040	ADT	2,400
2040	DHV (AM)	265
2040	DHV (PM)	280
	PU/PC%	87.7
	SU%	7.3
	MU%	5.0

### **DESIGN DESIGNATION**

**MINOR ARTERIAL** 

ENGINEERING SCALES. REDUCED SIZED PLANS WILL NOT CONFORM TO STANDARD SCALES. IN MAKING MEASUREMENTS ON REDUCED PLANS, THE ABOVE SCALES MAY BE USED.


J.U.L.I.E. JOINT UTILITY LOCATION INFORMATION FOR EXCAVATORS 1-800-892-0123 OR 811

### PROJECT ENGINEER TIM BRANDENBURG PROJECT MANAGER JEFF M. SHERER

# **PROPOSED** HIGHWAY PLANS

F.A.P. ROUTE 71 (IL 54) SECTION 15 BR-1 PROJECT STP-NP26(319) BRIDGE DECK OVERLAY DEWITT COUNTY

C-95-088-20

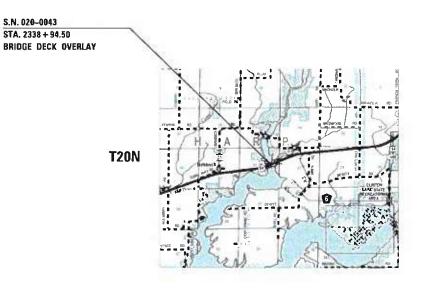


R3E

GROSS LENGTH = 236.50 FT. = 0.0826 MILE NET LENGTH = 236.50 FT. = 0.0826 MILE

0

0

0

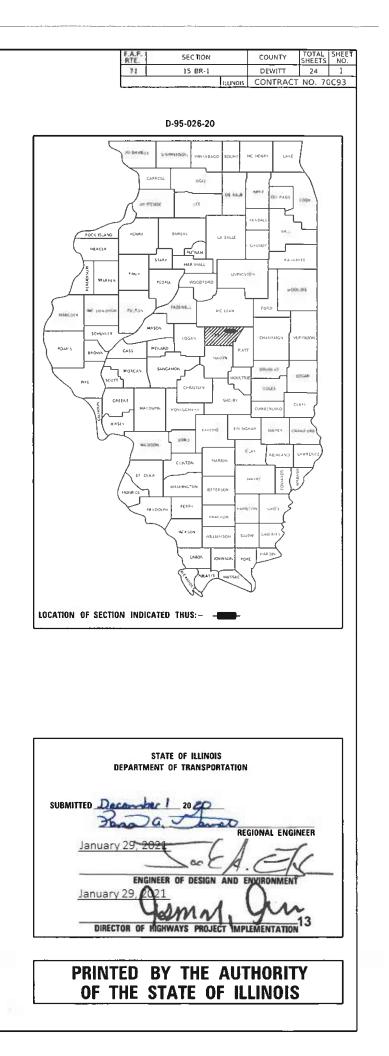

## **INDEX OF SHEETS**

# LIST OF STANDARDS

		STANDARD NO.	D
<u>SHEET NO.</u>	<u>ITEM</u>	000001-08	S
1	COVER SHEET	001001-02	A
2	INDEX OF SHEETS/ HIGHWAY STANDARDS/ GENERAL NOTES	001006	D
3-5	SUMMARY OF QUANTITIES	701001-02	0
6	EXISTING TYPICAL CROSS-SECTION	701006-05	0
7-9	STAGING DETAILS	701011-04	0
10	GENERAL PLAN AND ELEVATION SHEET	701201-05	L
11	EXPANSION JOINT DETAILS	701301-04	L/
12	DETAIL OF STRIP SEAL JOINT	701321-18	L/
13	BAR SPLICER AND MECHANICAL SPLICER DETAIL	701901-08	T!
14-16	DETAIL OF DRAINAGE STRUCTURES	704001-08	T
17	DETAIL OF WEARING SURFACE		
18	DETAIL OF COMPRESSION BLOCK REPAIRS		
19-20	FRP REPAIR DETAILS		
21	DETAIL OF STRUCTURAL REPAIR OF CONCRETE		
22-23	DETAIL OF EROSION REPAIR AT ABUTMENTS		
24	DETAIL OF TEMPORARY CONCRETE BARRIER		

### G.N.-100

ENGLISH UNITS OF MEASUREMENT SHALL GOVERN OVER AND SUPERSEDE ANY METRIC UNITS SHOWN IN THIS CONTRACT. WHERE INCLUDED, METRIC UNITS ARE FOR INFORMATION ONLY.

### G.N.-105.09

ALL ELEVATIONS SHOWN IN PLANS ARE BASED ON NORTH AMERICAN VERTICAL DATUM OF 1988 (NAVD 88).

### G.N.-406

THE QUANTITIES INCLUDED IN THE PLANS FOR HOT-MIX ASPHALT RESURFACING ARE INTENDED TO GIVE THE COVERAGE SHOWN ON THE TYPICAL CROSS SECTIONS. IT IS NOT INTENDED TO INCREASE THE THICKNESS OF THE HOT-MIX ASPHALT MIXTURE IN ORDER TO USE ALL OF THE QUANTITIES INCLUDED IN THE CONTRACT.

## **GENERAL NOTES**

### G.N. -406H

### MIXTURE REQUIREMENTS

THE FOLLOWING MIXTURE REQUIREMENTS ARE APPLICABLE FOR THIS PROJECT:

Location	IL 54
Mixture Use	Surface, Shoulder
AC/PG	PG 64-22
Design Air Voids	4.0% @ Ndes = 90
Mix Comp(Gradation)	IL 9.5
Friction Aggregate	Mix C
Mixture Weight	112
Quality Management Program	QC/QA
Sublot Size	N.A.

### G.N.-1004.01

COARSE AGGREGATE GRADATION CA-10 MAY BE USED WHENEVER COARSE AGGREGATE CA-6 IS SPECIFIED IN THE STANDARD SPECIFICATIONS.

THERE ARE NO COMMITMENTS ASSOCIATED WITH THIS PROJECT

USER NAME = shererJM	DESIGNED - JMS	REVISED -			INDEX O	F SHFF	TS/H	IGHW	AY STANDAR	ns.	F.A.P. BTE	SECTION	COUNTY	TOTAL SHEET
	DRAWN - JMS	REVISED -	STATE OF ILLINOIS		MDEX 0			L NO			71	15 BR-1	DEWITT	24 2
PLOT SCALE = 40.0000 ' / in.	CHECKED -	REVISED -	DEPARTMENT OF TRANSPORTATION			GEI	NEKA	AL NU	ГЭ				CONTRAC	T NO. 70C93
PLOT DATE = 10/28/2020	DATE - 031220	REVISED -		SCALE: NONE	SHEET 1	OF 3	1 S	SHEETS	STA.	TO STA.		ILLINOIS FED. AI	D PROJECT	

### DESCRIPTION

STANDARD SYMBOLS, ABBREVIATIONS AND PATTERNS AREAS OF REINFORCEMENT BARS DECIMAL OF AN INCH AND OF A FOOT OFF RD OPERATIONS, 2L, 2W, 15' FROM PAVEMENT EDGE OFF RD OPERATIONS, 2L, 2W, 15' TO 24" FROM PAVEMENT EDGE OFF RD MOVING OPERATION, 2L, 2W, DAY ONLY LANE CLOSURE, 2L, 2W, DAY ONLY FOR SPEEDS ≥ 45 MPH LANE CLOSURE, 2L, 2W, MOVING OPERATIONS LANE CLOSURE, 2L, 2W, BRIDGE REPAIR + BARRIER TRAFFIC CONTROL DEVICES TEMPORARY CONCRETE BARRIER

				DEWITT COUNTY FAP 71 (IL 54) RURAL TWO-LANE BRIDGE DECK OVERLA S.N. 020-0043 80% STATE 20% FED
CODE			TOTAL	0059
NO.	ITEM	UNIT	QUANTITY	
28100709	STONE DUMPED RIPRAP, CLASS A5	SQ YD	108.0	108.0
40600290	BITUMINOUS MATERIALS (TACK COAT)	POUND	440.0	440.0
40604050	HOT-MIX ASPHALT SURFACE COURSE, IL-9.5, MIX "C", N50	TON	49.0	49.0
44000155	HOT-MIX ASPHALT SURFACE REMOVAL, 1 1/2"	SQ YD	985.0	985.0
48203100	HOT-MIX ASPHALT SHOULDERS	TON	41.0	41.0
50102400	CONCRETE REMOVAL	CU YD	25.6	25.6
50157300	PROTECTIVE SHIELD	SQ YD	88.0	88.0
50300100	FLOOR DRAINS	EACH	14.0	14.0
50300255	CONCRETE SUPERSTRUCTURE	CU YD	27.8	27.8
50300260	BRIDGE DECK GROOVING	SQ YD	1,075.0	1,075.0
50300300	PROTECTIVE COAT	SQ YD	1,130.0	1,130.0
50900005		POUND	0.000.0	0.000.0
50800205	REINFORCEMENT BARS, EPOXY COATED		2,330.0	2,330.0
50800515	BAR SPLICERS	EACH	34.0	34.0
52000110	PREFORMED JOINT STRIP SEAL	FOOT	92.0	92.0
02000110			02.0	32.0
59300100	CONTROLLED LOW-STRENGTH MATERIAL	CU YD	7.2	7.2

USER NAME = shererJM	DESIGNED -	REVISED - 12-11-20 JMS								F.A.P. RTE	SECTION	COUNTY	TOTAL SHEET SHEETS NO.
	DRAWN -	REVISED -	STATE OF ILLINOIS					ANTITIES		71	15 BR-1	DEWITT	24 3
PLOT SCALE = 40.0000 ' / in.	CHECKED -	REVISED -	DEPARTMENT OF TRANSPORTATION									CONTRAC	CT NO. 70C93
PLOT DATE = 12/11/2020	DATE -	REVISED -		SCALE: NONE	SHEET 1	OF 3	SHEETS	STA.	TO STA.		ILLINOIS FED.	AID PROJECT	

				DEWITT COUNTY FAP 71 (IL 54) RURAL TWO-LANE BRIDGE DECK OVERLAY S.N. 020-0043 80% STATE 20% FED
CODE			TOTAL	0059
NO.	ITEM	UNIT	QUANTITY	
67000500	ENGINEER'S FIELD OFFICE, TYPE B	CAL MO	6.0	6.0
67100100	MOBILIZATION	L SUM	1.0	1.0
70100405	TRAFFIC CONTROL AND PROTECTION, STANDARD 701321	EACH	1.0	1.0
		-		-
70100450	TRAFFIC CONTROL AND PROTECTION, STANDARD 701201	L SUM	1.0	1.0
70106500	TEMPORARY BRIDGE TRAFFIC SIGNALS	EACH	1.0	1.0
70400100	TEMPORARY CONCRETE BARRIER	FOOT	762.5	762.5
70106700	TEMPORARY RUMBLE STRIPS	EACH	6.0	6.0
70400200	RELOCATE TEMPORARY CONCRETE BARRIER	FOOT	762.5	762.5
70600250	IMPACT ATTENUATORS, TEMPORARY (NON- REDIRECTIVE), TEST LEVEL 3	EACH	2.0	2.0
70600350	IMPACT ATTENUATORS, RELOCATE (NON- REDIRECTIVE), TEST LEVEL 3	EACH	2.0	2.0
X0325682	PUMPABLE CONCRETE MIX	CU FT	3.0	3.0
X0325748	ACRYLIC COATING	SQ YD	39.0	39.0
X0325749	FIBER WRAP	SQ FT	315.0	315.0
Z0004556	HOT-MIX ASPHALT SURFACE REMOVAL (DECK)	SQ YD	1,102.0	1,102.0
Z0006014	BRIDGE DECK LATEX CONCRETE OVERLAY, 2 1/2 INCHES	SQ YD	1,064.0	1,064.0
		1	, <del>.</del>	, <u>.</u>

USER NAME = shererJM DESIGNED -REVISED - 12-11-20 JMS STATE OF ILLINOIS DRAWN -REVISED -PLOT SCALE = 40.0000 ' / in. CHECKED -REVISED -DEPARTMENT OF TRANSPORTATION PLOT DATE = 12/11/2020 DATE REVISED -


						F.A.P. RTE	SECTION	COUNTY	TOTAL SHEETS	SHEET NO.
	ડા	JMMARY	OF QU	ANTITIES		71	15 BR-1	DEWITT	24	4
						_		CONTRAC	T NO. 70	0C93
SCALE: NONE	SHEET 2	OF 3	SHEETS	STA.	TO STA.		ILLINOIS FED.	AID PROJECT		

				DEWITT COUNTY FAP 71 (IL 54) RURAL TWO-LANE BRIDGE DECK OVERLAY S.N. 020-0043 80% STATE 20% FED
CODE			TOTAL	0059
NO.	ITEM	UNIT	QUANTITY	
Z0012130	BRIDGE DECK SCARIFICATION 3/4"	SQ YD	1,064.0	1,064.0
Z0012754	STRUCTURAL REPAIR OF CONCRETE (DEPTH EQUAL TO OR LESS THAN 5 INCHES)	SQ FT	33.4	33.4
Z0016002	DECK SLAB REPAIR (FULL DEPTH, TYPE II)	SQ YD	31.0	31.0
Z0018002	DRAINAGE SCUPPERS, DS-11	EACH	4.0	4.0
Z0043800	PRECAST PRESTRESSED CONCRETE I-BEAM REPAIR	SQ FT	303.0	303.0


SPECIALTY ITEMS

USER NAME = shererJM	DESIGNED -	REVISED -							F.A.P. RTE	SECTION	COUNTY	TOTAL SHEET SHEETS NO.
	DRAWN -	REVISED -	STATE OF ILLINOIS			JMMARY	<b>OF QUANTITIES</b>		71	15 BR-1	DEWITT	24 5
PLOT SCALE = 40.0000 ' / in.	CHECKED -	REVISED -	DEPARTMENT OF TRANSPORTATION								CONTRACT	F NO. 70C93
PLOT DATE = 12/7/2020	DATE -	REVISED -		SCALE: NONE	SHEET 3	OF 3	SHEETS STA.	TO STA.		ILLINOIS FED. A	ID PROJECT	

## EXISTING TYPICAL CROSS-SECTION (LOOKING EAST)

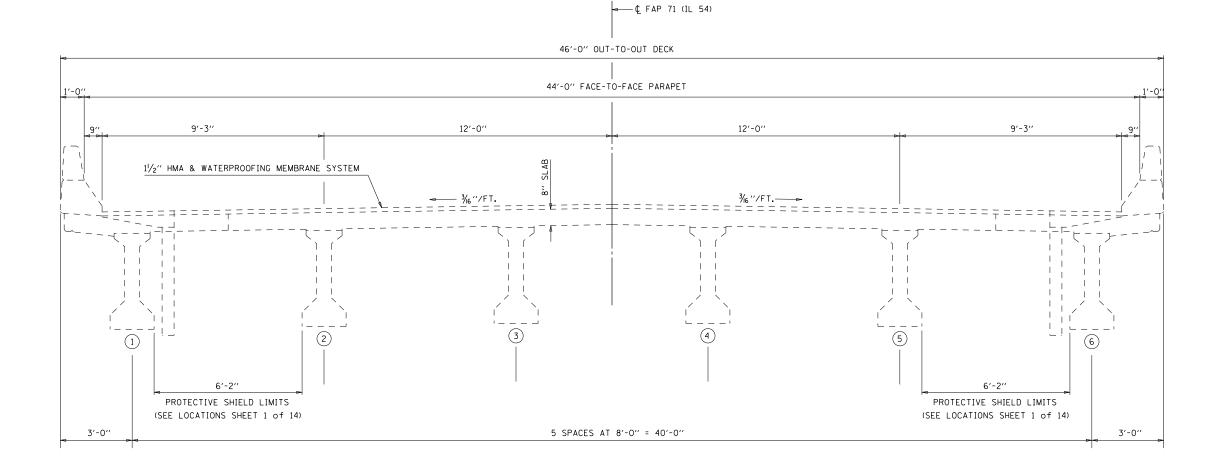


USER NAME = shererJM	DESIGNED - JMS	REVISED - 12-11-20 JMS		TYPICAL CROSS-SECTION	F.A.P. SECTION	COUNTY TOTAL SHEET SHEETS NO.
	DRAWN - JMS	REVISED -	STATE OF ILLINOIS		71 15 BR-1	DEWITT 24 6
PLOT SCALE = 40.0000 ' / in.	CHECKED -	REVISED -	DEPARTMENT OF TRANSPORTATION	S.N. 020–0043		CONTRACT NO. 70C93
PLOT DATE = 12/11/2020	DATE - 052020	REVISED -		SCALE: NONE SHEET 1 OF 1 SHEETS STA. TO STA.	ILLINOIS F	ED. AID PROJECT

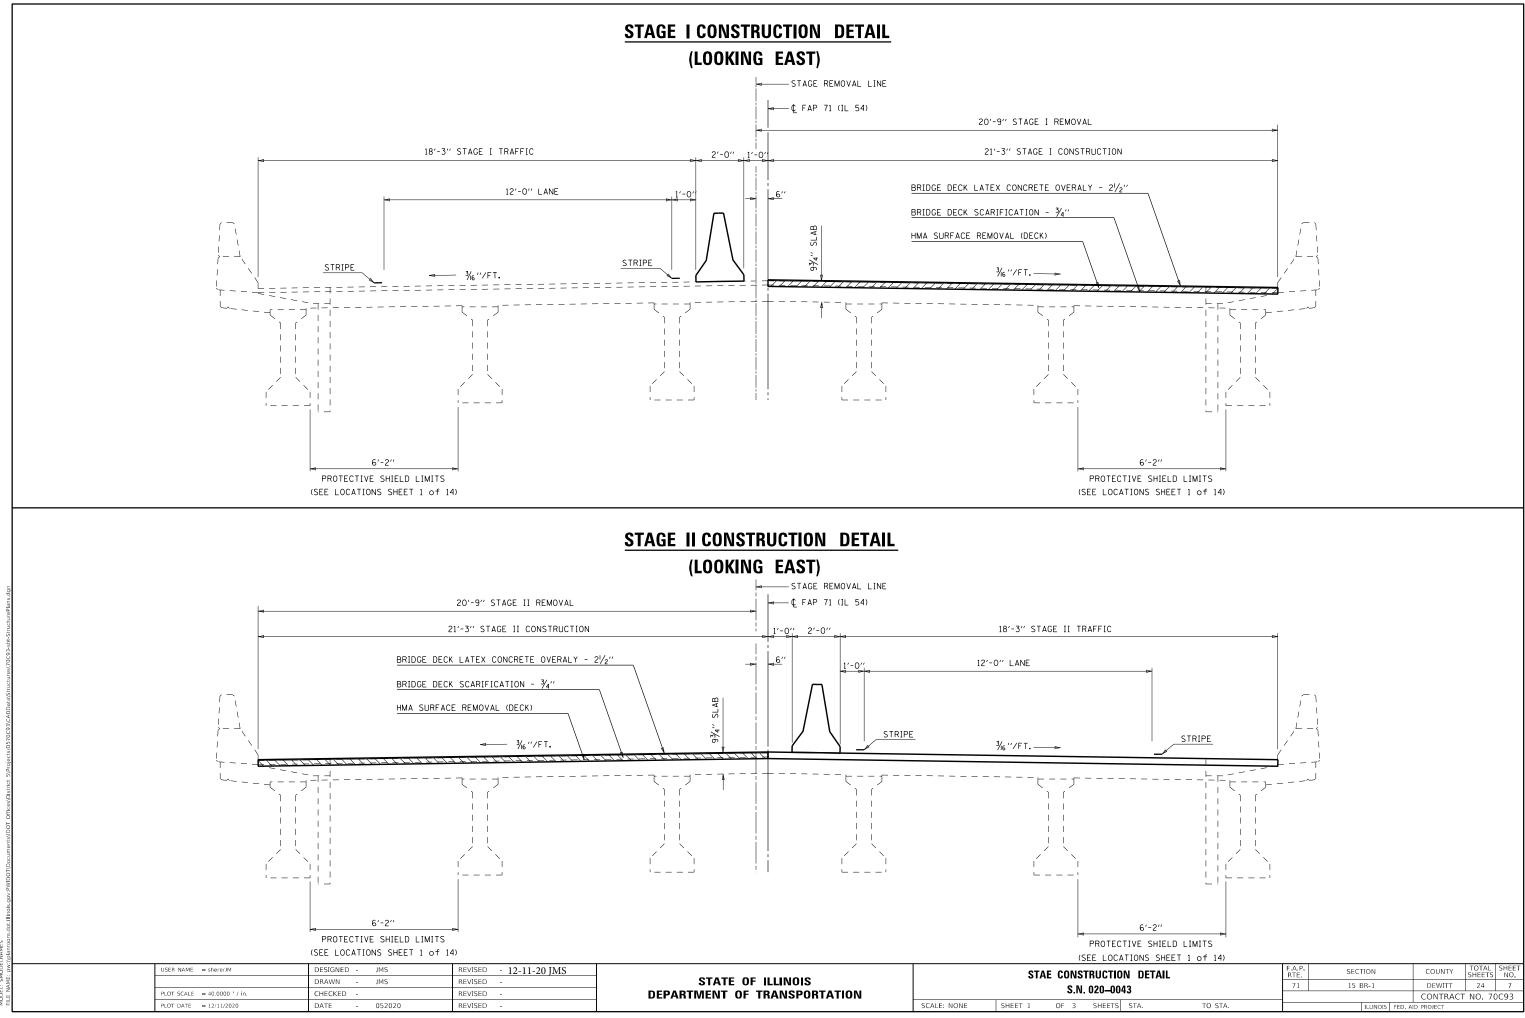

MODEL: \$MODI

## **STAGE I TEMPORARY CONCRETE BARRIER LAYOUT**

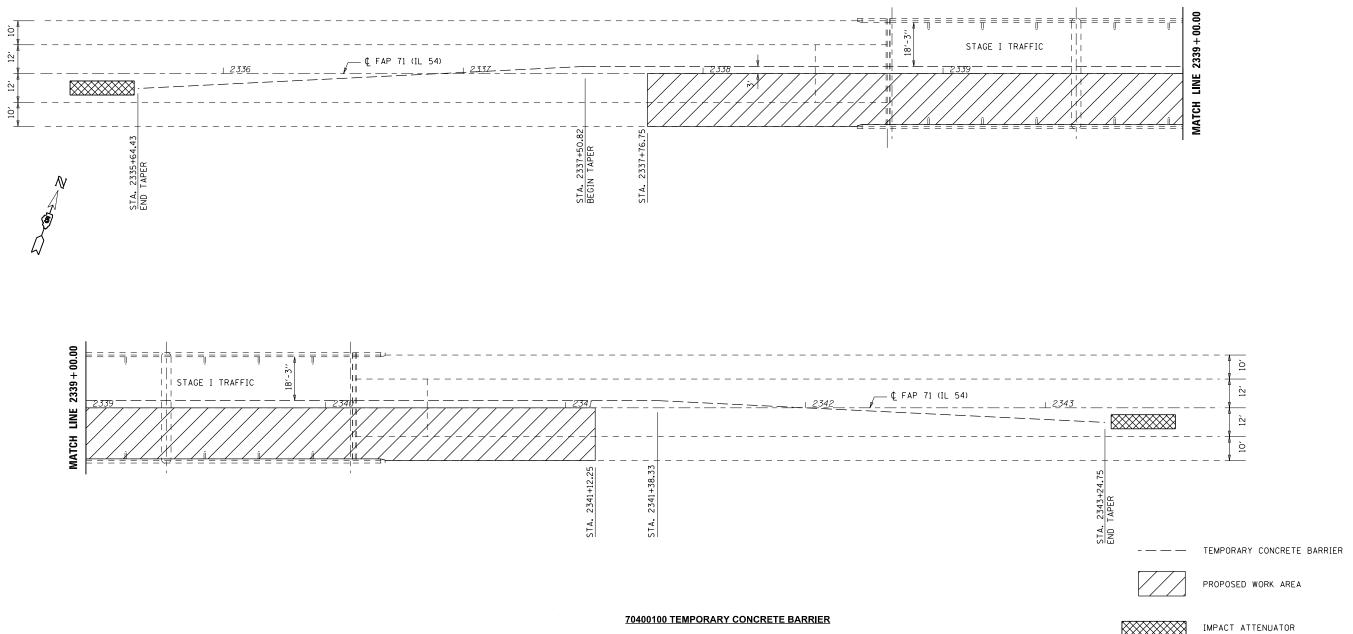

### PLAN NOTES:

ALL STAGING DETAILS SHALL BE IN ACCORDANCE WITH TRAFFIC CONTROL AND PROTECTION STANDARD 701321 AND PAID FOR AT THE CONTRACT UNIT PRICE PER EACH LOCATION.

ALL WORK WITHOUT TEMPORARY CONCRETE BARRIER IN PLACE SHALL BE IN ACCORDANCE WITH TRAFFIC CONTROL AND PROTECTION STANDARDS 701201, 701301 AND 701311.

FOR ADDITIONAL DETAILS ASSOCIATED WITH TEMORARY CONCRETE BARRIER, SEE HIGHWAY STANDARD 704001.

EXISTING OR TEMPORARY PAVEMENT MARKINGS SHALL BE ON BOTH SIDES OF THE OPEN LANE FROM STOP BAR TO STOP BAR. PAVEMENT MARKINGS THAT CONFLICT WITH STAGED TRAFFIC MARKINGS SHALL BE REMOVED. THIS WORK SHALL BE INCLUDED IN THE COST FOR TRAFFIC CONTROL AND PROTECTION STANDARD 701321.

REFLECTORS SHALL BE ATTACHED TO GUARDRAIL AND BARRIER WALL AT 25 FOOT CENTERS. COST INCLUDED WITH TRAFFIC CONTROL AND PROTECTION STANDARD 701321.


		STATION	<u>TO</u>		<b>STATION</b>	LENGTH
TAPER	RT	2335+64.43		RT	2337+50.82	187.5
	RT	2337+50.82		RT	2341+38.33	387.5
TAPER	RT	2341+38.33		RT	2343+24.75	187.5

SUB-TOTAL = 762.5

								_
USER NAME = shererJM	DESIGNED - JMS	REVISED -		Í	TEMPORA	av conc	RETE B	۲
	DRAWN - JMS	REVISED -	STATE OF ILLINOIS	1				
PLOT SCALE = 40.0000 ' / in.	CHECKED -	REVISED -	DEPARTMENT OF TRANSPORTATION	1		S.N. /	020-004	43
PLOT DATE = 11/5/2020	DATE - 052020	REVISED -		SCALE: 1" = 20'	SHEET 2	OF 3	SHEETS	ŝ

### BILL OF MATERIALS

		TTENUATOR T RECTIVE) TES	EACH	2.0		
					,	
BARRIER LA	YOUT	F.A.P. RTE	SECTION	COUNTY	TOTAL	SHEET NO.
	YOUT		SECTION 15 BR-1	COUNTY		
BARRIER LA	YOUT	RTE.		DEWITT	SHEETS	NO. 8

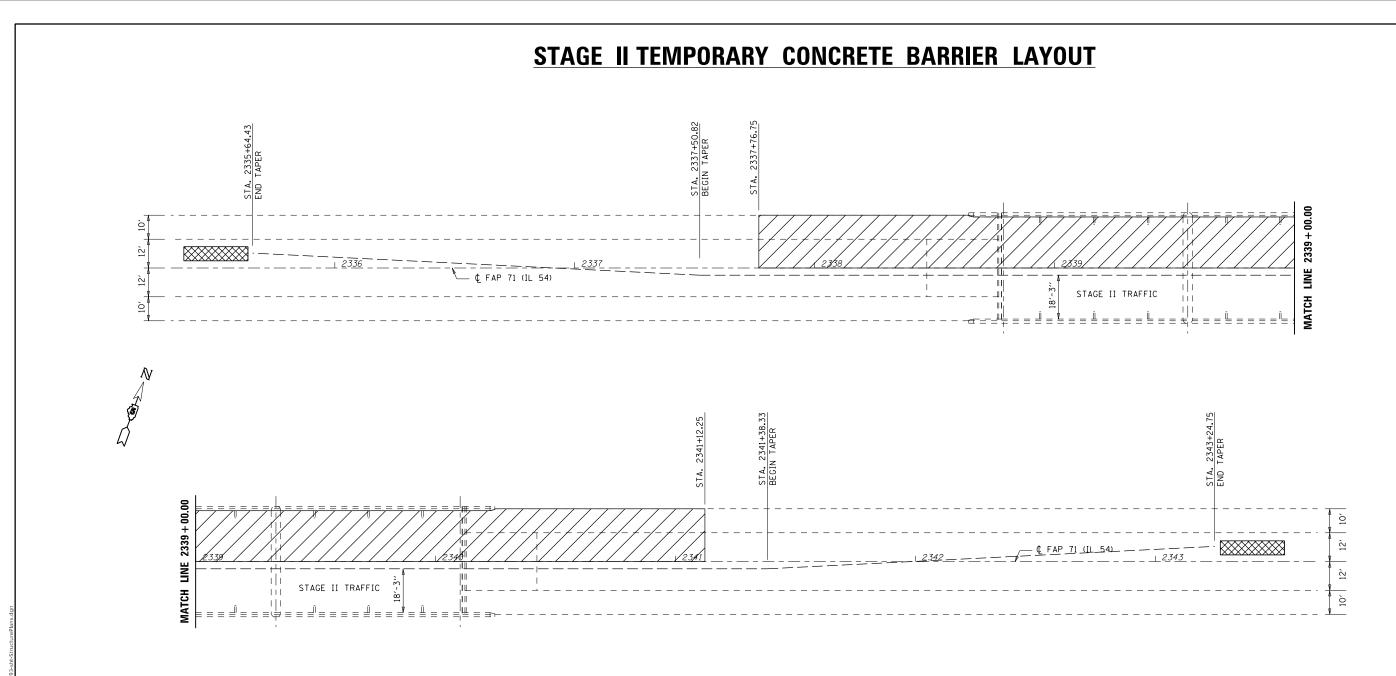

### PLAN NOTES:

ALL STAGING DETAILS SHALL BE IN ACCORDANCE WITH TRAFFIC CONTROL AND PROTECTION STANDARD 701321 AND PAID FOR AT THE CONTRACT UNIT PRICE PER EACH LOCATION.

ALL WORK WITHOUT TEMPORARY CONCRETE BARRIER IN PLACE SHALL BE IN ACCORDANCE WITH TRAFFIC CONTROL AND PROTECTION STANDARDS 701201, 701301 AND 701311.

FOR ADDITIONAL DETAILS ASSOCIATED WITH TEMORARY CONCRETE BARRIER, SEE HIGHWAY STANDARD 704001.

EXISTING OR TEMPORARY PAVEMENT MARKINGS SHALL BE ON BOTH SIDES OF THE OPEN LANE FROM STOP BAR TO STOP BAR. PAVEMENT MARKINGS THAT CONFLICT WITH STAGED TRAFFIC MARKINGS SHALL BE REMOVED. THIS WORK SHALL BE INCLUDED IN THE COST FOR TRAFFIC CONTROL AND PROTECTION STANDARD 701321.

REFLECTORS SHALL BE ATTACHED TO GUARDRAIL AND BARRIER WALL AT 25 FOOT CENTERS. COST INCLUDED WITH TRAFFIC CONTROL AND PROTECTION STANDARD 701321.

### 70400200 RELOCATE TEMPORARY CONCRETE BARRIER

STATION [	<u>TO</u>	STATION	<u>LENGTH</u>
335+64.43	LT	2337+50.82	187.5
337+50.82	LT	2341+38.33	387.5
341+38.33	LT	2343+24.75	187.5
	335+64.43 337+50.82	335+64.43 LT 337+50.82 LT	335+64.43 LT 2337+50.82 337+50.82 LT 2341+38.33

SUB-TOTAL = 762.5

-	USER NAME = shererJM	DESIGNED - JMS	REVISED -		TEMPORARY CONCRETE BARRIER LAYOUT     F.A.P. RTE.     SECTION 71       S.N. 020–0043     71     15 BR-1		F.A.P. RTE	SECTION	COUNTY	TOTAL SHEET SHEETS NO.			
		DRAWN - JMS	REVISED -	STATE OF ILLINOIS			71	15 BR-1	DEWITT	24 9			
	PLOT SCALE = 40.0000 ' / in.	CHECKED -	REVISED -	DEPARTMENT OF TRANSPORTATION				CONTRACT	Г NO. 70C93				
	PLOT DATE = 11/5/2020	DATE - 052020	REVISED -		SCALE: 1" = 20'	SHEET 3	OF 3	SHEETS STA.	TO STA.		ILLINOIS FED. A	D PROJECT	



TEMPORARY CONCRETE BARRIER




PROPOSED WORK AREA



IMPACT ATTENUATOR

### BILL OF MATERIALS

ITEM	UNIT	TOTAL
REL TEMPORARY CONCRETE BARRIER	FOOT	762.5
IMPACT ATTENUATOR RELOCATE (NON-REDIRECTIVE) TEST LEVEL 3	EACH	2.0

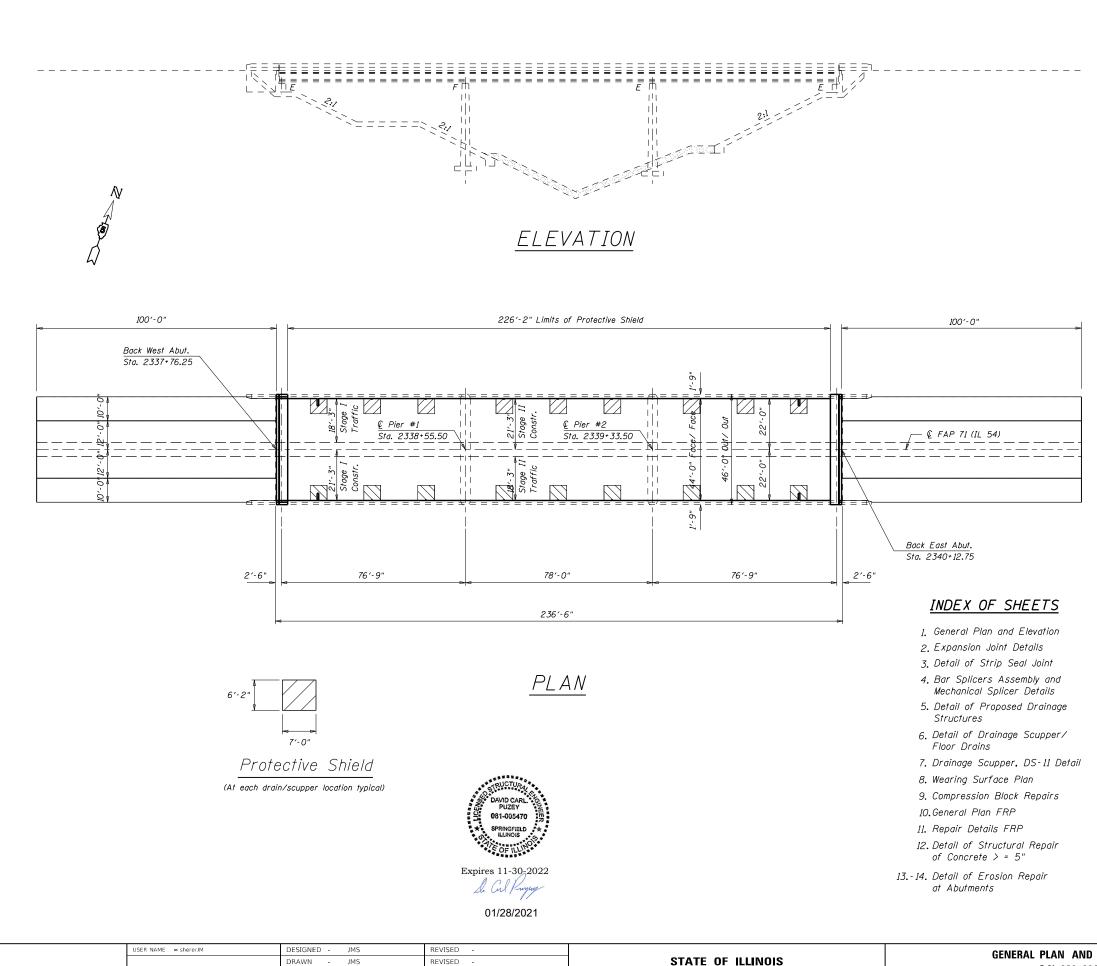

DRAWN JMS REVISED PLOT SCALE = 40.0000 ' / in. CHECKED REVISED LOT DATE = 1/27/2021 DATE REVISED 052020

S.N. 020-004 SCALE: 1" = 20' SHEET 1 OF 14 SHEETS

**DEPARTMENT OF TRANSPORTATION** 

Structure Number 020-0043 was built in 1976, Section 15BR at Station 2338+94.50 by the State of Illinois in Dewitt County. The structure is a three (3) span 7 1/2" thick reinforced concrete deck, Pre-Cast Concrete continuous stringer/multi-beam girder beam bridge on concrete spread footing supported abutments and steel and concrete pile supported piers.

The existing structure has a back-to-back abutment length of 236'-6", and out-to-out width of 46'-O", clear width of 42'-6", and an approach roadway width of 43'-O".

### PROPOSED WORK

- 1. Remove Existing HMA Wearing Surface
- 2. Remove Existing HMA Surface at Approach Pavements
- 3. Remove Concrete at Abutments
- 4. Remove Concrete at Deck Ends
- 5. Place New Preformed Joint Strip Seal
- 6. Place Concrete Superstructure at Abutments and Deck Ends
- 7. Remove and Replace Select Deck Drains
- 8. Repair Select Areas on PCC Beams
- 9. Place Latex Concrete Wearing Surface
- 10. Place HMA Surface at Approach Pavements
- 11. Place Protective Coat
- 12. Perform erosion control at abutments

### GENERAL NOTES

Plan dimensions and details relative to existing plans are subject to nominal construction variations. The contractor shall field verify existing dimensions and details affecting new construction and make necessary approved adjustments prior to construction or ordering of materials. Such variations shall not be cause for additional compensation for a change in scope of work, however the contractor will be paid for the quantity actually furnished at the unit price bid for the work.

Reinforcement Bars Designated (E) Shall be Epoxy Coated.

The Contractor shall use extreme care during concrete removal so as not to damage the PPC I-Beam.

Joint Openings shall be adjusted according to article 520.04 of the Standard Specifactions. When the deck is poured at an ambient temperature of 50° F.


Existing reinforcement bars extending into the removal area shall be cleaned, straightened and incorporated into the new construction, cost included with Deck Slab Repair.

Areas of repairs shown are estimated. The Engineer shall show actual locations of the repairs on AS-BUILT PLANS.


Protective coat shall be applied to the top and inside face of parapets and deck surface of new concrete adjacent to joints and the new overlay.

	<u> 7</u>	OTAL BILL OF MA	TERIAL	:	
		ITEM	UNIT	TOTAL	]
	Protective S	hield	Sq. Yd.	88.0	1
	Concrete Re	moval	Cu. Yd.	25.6	1
	Floor Drains		Each	14.0	1
	Concrete Su	perstructure	Cu. Yd.	27.8	1
	Bridge Deck		Sq. Yd.	1,075.0	]
	Protective C	oat	Sq. Yd.	1,130.0	]
	Reinforceme	nt Bars, Epoxy Coated	Pound	2,330.0	
	Bar Splicers	Each	34.0		
	Preformed J	oint Strip Seal	Foot	92.0	
	Controlled Lo	Cu. Yd.	7.2		
	Pumpable Co	Cu. Ft.	3.0		
	Acrylic Coat	Sq. Yd.	39.0		
	Fiber Wrap		Sq. Ft.	315.0	
		e Removal (Deck)	Sq. Yd.	1,102.0	
	Bridge Deck	Latex Concrete Overlay 2 <sup>1</sup> / <sub>2</sub>	" Sq. Yd.	1,064.0	
	Bridge Deck	Scarification <sup>3</sup> 4"	Sq. Yd.	1,064.0	
	Structural R	epair of Conc. Dpth. =< 5"	Sq. Ft.	33.4	
	Deck Slab R	epair (Full Depth, Type II)	Sq. Yd.	31.0	
	Drainage Sc	uppers, DS-11	Each	4.0	
	Prec. Prestr	. Concrete I-Beam Repair	Sq. Ft.	303.0	J
ELEVATION		F.A.P. SECTION	COUNTY	TOTAL SHE SHEETS N	EET O.
13		71 15 BR-1	DEWITT	24 1	0
				NO. 70C9	3
STA.	TO STA.	ILLINOIS FED. AII	PROJECT		

## TOTAL DILL OF MATERIA

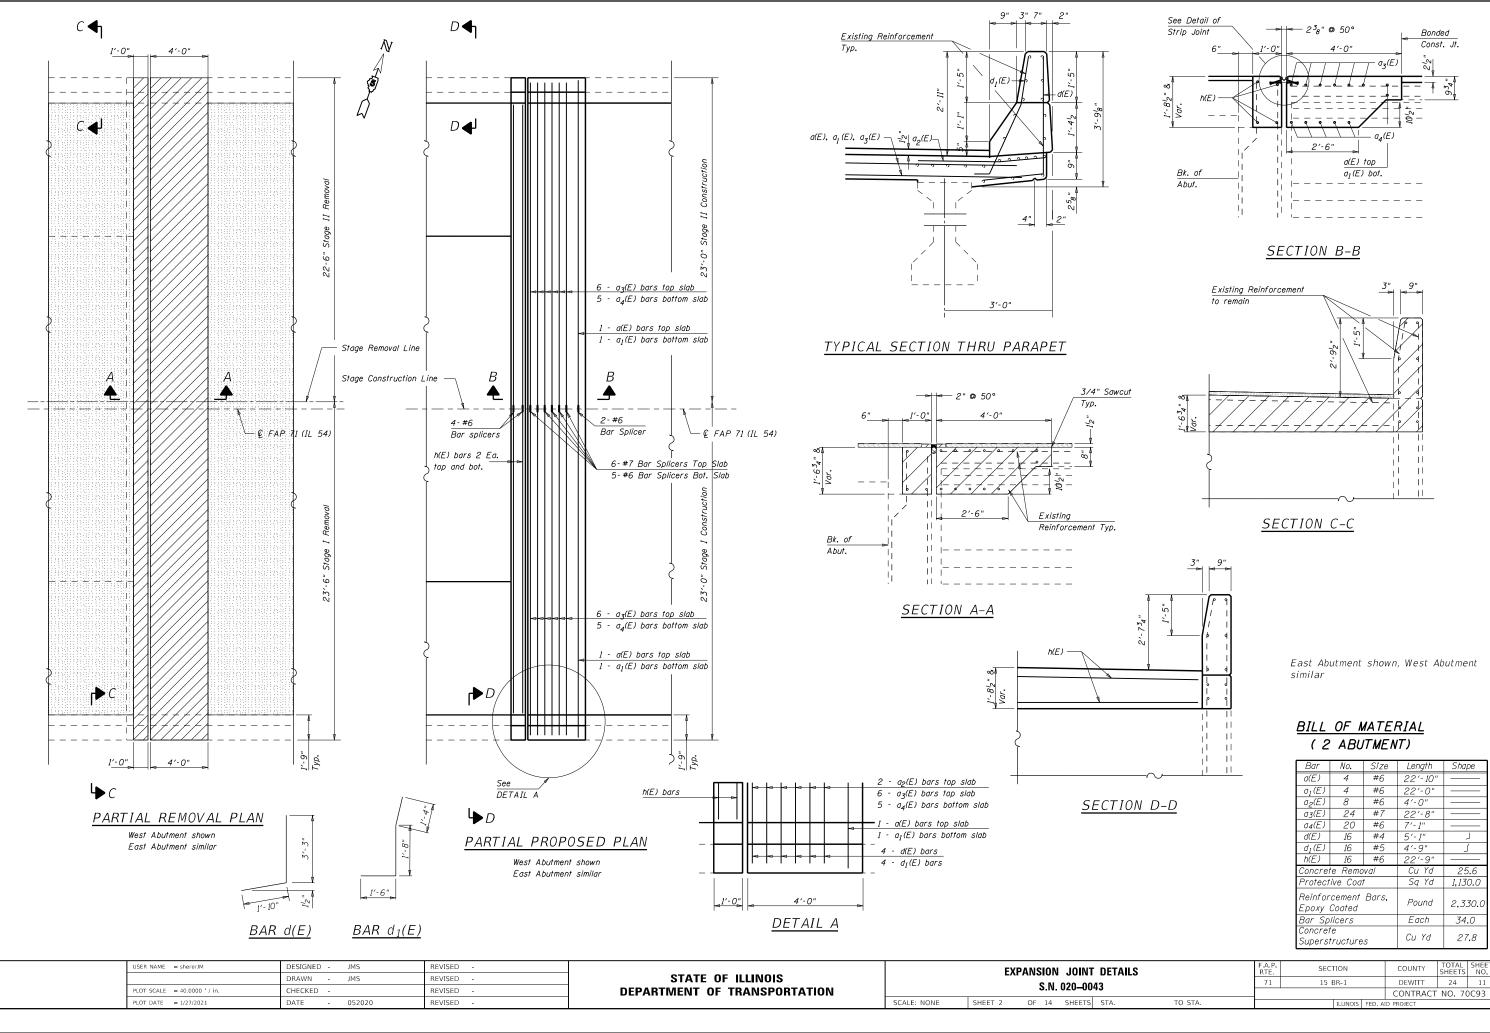

USER NAME = shererJM	DESIGNED - JMS	REVISED -			FXP	EXPANSION JOIN			
	DRAWN - JMS	REVISED -	STATE OF ILLINOIS						
PLOT SCALE = 40.0000 ' / in.	CHECKED -	REVISED -	DEPARTMENT OF TRANSPORTATION	S.N. 020–0					
PLOT DATE = 1/27/2021	DATE - 052020	REVISED -		SCALE: NONE	SHEET 2	OF 14 SHEET			

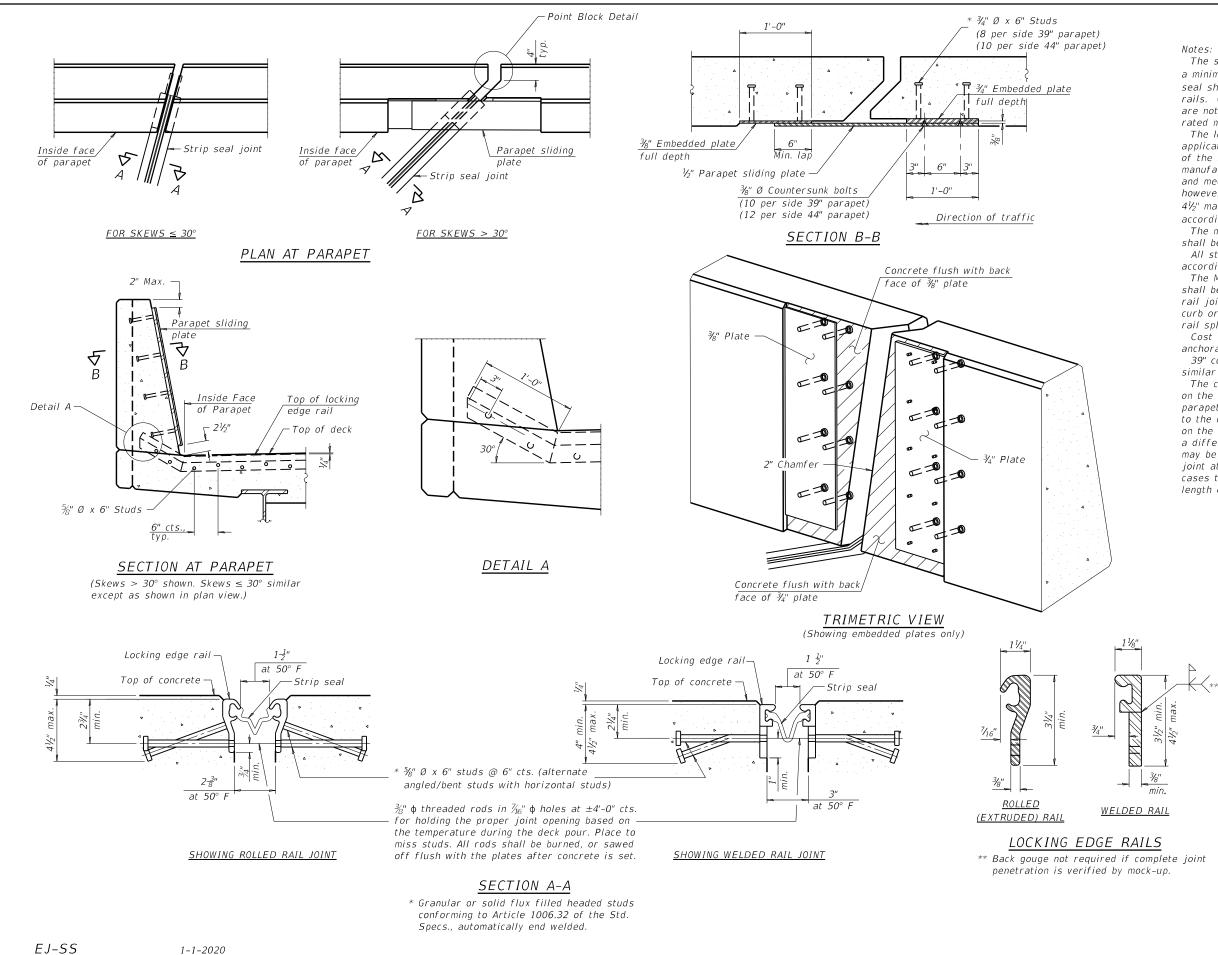

FILE NAME USER NAME = shererJM DESIGNED - JMS REVISED - 12-11-20 JMS DETAIL OF STRIP S STATE OF ILLINOIS ow://planroom.dot.illinois.gov:PWIDOT/Doc ents\IDOT\_Offices\District\_5\Projects\D570C**H3)RAWD**sta\Structur**HAKS**70C93-sht-StructurePIB55**X**555D S.N. 020-00 PLOT SCALE = 40.0000 '/ 10. CHECKED REVISED **DEPARTMENT OF TRANSPORTATION** SCALE: NONE SHEET NO. 3 OF 14 SHEETS PLOT DATE = 12/11/2020 DATE - 070620 REVISED

The strip seal shall be made continuous and shall have a minimum thickness of  $\frac{1}{4}$ ". The configuration of the strip seal shall match the configuration of the locking edge rails. Open or "webbed" strip seal gland configurations are not permitted. The gland shall be sized for a maximum rated movement of 4 inches.

The locking edge rails depicted are configured for typical applications and are conceptual only. The actual configuration of the locking edge rails and matching strip seal may vary from manufacturer to manufacturer provided they fit the application and meet the minimum anchorage shown. Flanged edge rails, however, will not be allowed. Locking edge rails may exceed the 4<sup>1</sup>/<sub>2</sub>" maximum depth provided the anchorage system is revised according to the manufacturer's recommendation.

The manufacturer's recommended installation methods shall be followed


All steel components shall be galvanized after fabrication according to Article 520.03 of the Standard Specifications.

The Maximum space between locking edge rail segments shall be  $\frac{3}{16}$ " and sealed with a suitable sealant; however, any rail joint within 10' measured perpendicular to the face of the curb or parapet shall be welded as shown in the locking edge rail splice detail.

Cost of parapet sliding plates, embedded plates, and

anchorage studs included with Preformed Joint Strip Seal. 39" constant slope barrier shown, 44" constant slope barrier similar as noted.

The concrete opening below the strip seal will vary based on the locking edge rail chosen by the Contractor. Deck and parapet lengths shown elsewhere in the plans are dimensioned to the concrete opening, not the joint opening, and are based on the rolled locking edge rail. If the Contractor elects to use a different locking edge rail, dimensional adjustments may be required. One exception to this would be the strip seal joint at the end of the precast bridge approach slab. For these cases the pavement connector length shall be adjusted, not the length of the bridge approach slab.

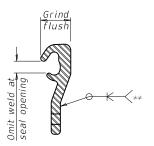


### LOCKING EDGE RAIL SPLICE

The inside of the locking edge rail groove shall be free of weld residue. Rolled rail shown, welded rail similar

### BILL OF MATERIAL

Item	Unit	Total
Preformed Joint Strip Seal	Foot	92.0


SEAL JOINT 043		F.A.I. RTE.	SECTION	COUNTY	TOTAL SHEETS	SHEET NO.		
		71 15 BR-1				24	12	
				CONTRACT	NO. 7	0C93		
	STA.	TO STA.		ILLINOIS FED. A	ID PROJECT			

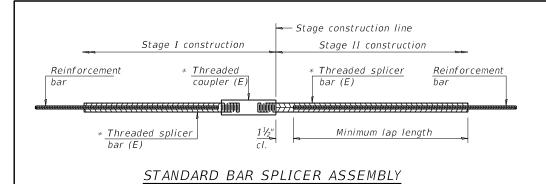

Threaded splicer bar length = min. lap length +  $1\frac{1}{2}$ " + thread length

\* Epoxy not required on Bar Splicer Assembly components used in conjunction with black bars.

Location	Bar size	No. assemblies required	Minimum Iap length
East Abutment	#6	4.0	4'-0"
East Deck	#6	7.0	4'-0''
East Deck	#7	6.0	4'-8"
West Abutment	#6	4.0	4'-0''
West Deck	#6	7.0	4'-0''
West Deck	#7	6.0	4'-8"

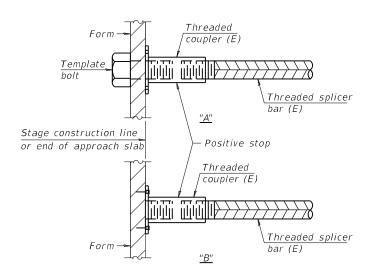


### INSTALLATION AND SETTING METHODS

"A" : Set bar splicer assembly by means of a template bolt.


"B" : Set bar splicer assembly by nailing to wood forms or cementing to steel forms.

(E) : Indicates epoxy coating.

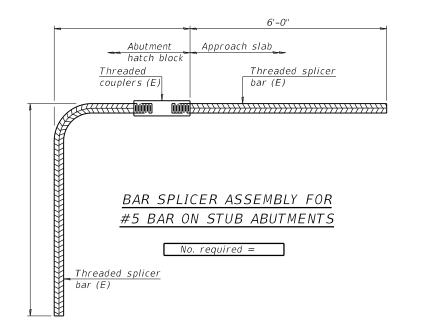

2-17-2017

USER NAME = shererJM	DESIGNED -	JMS	REVISED - 12-11-20 JMS		BAR SPLICER ASSEMBLY AND MECHANICAL SPLICER DETAILS		BAR SPLICER ASSEMBLY AND MECHANICAL SP		F.A.I BTE	SECTION	COUNTY	TOTAL	SHEET NO.	
	DRAWN -	JMS	REVISED -	STATE OF ILLINOIS						71	15 BR-1	DEWITT	24	13
PLOT SCALE = 40.0000 ' / in.	CHECKED -		REVISED -	DEPARTMENT OF TRANSPORTATION	S.N. 020–0043					CONTRACT NO. 7		)C93		
PLOT DATE = 12/11/2020	DATE -	070620	REVISED -		SCALE: NONE	SHEET 4	OF 14 SH	EETS STA.	TO STA.		ILLINOIS FED.	AID PROJECT		

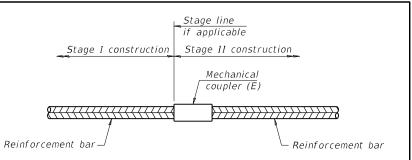


### STANDARD MECHANICAL SPLICER

I a a a tú a a	Bar	No. assemblies
Location	size	required
		1

<u>NOTES</u>

Splicer bars shall be deformed with threaded ends and have a minimum 60 ksi yield strength.


All reinforcement shall be lapped and tied to the splicer bars. Bar splicer assemblies shall be epoxy coated according to the requirements for reinforcement bars. See Section 508 of the Standard Specifications. See approved list of bar splicer assemblies and mechanical splicers for alternatives.

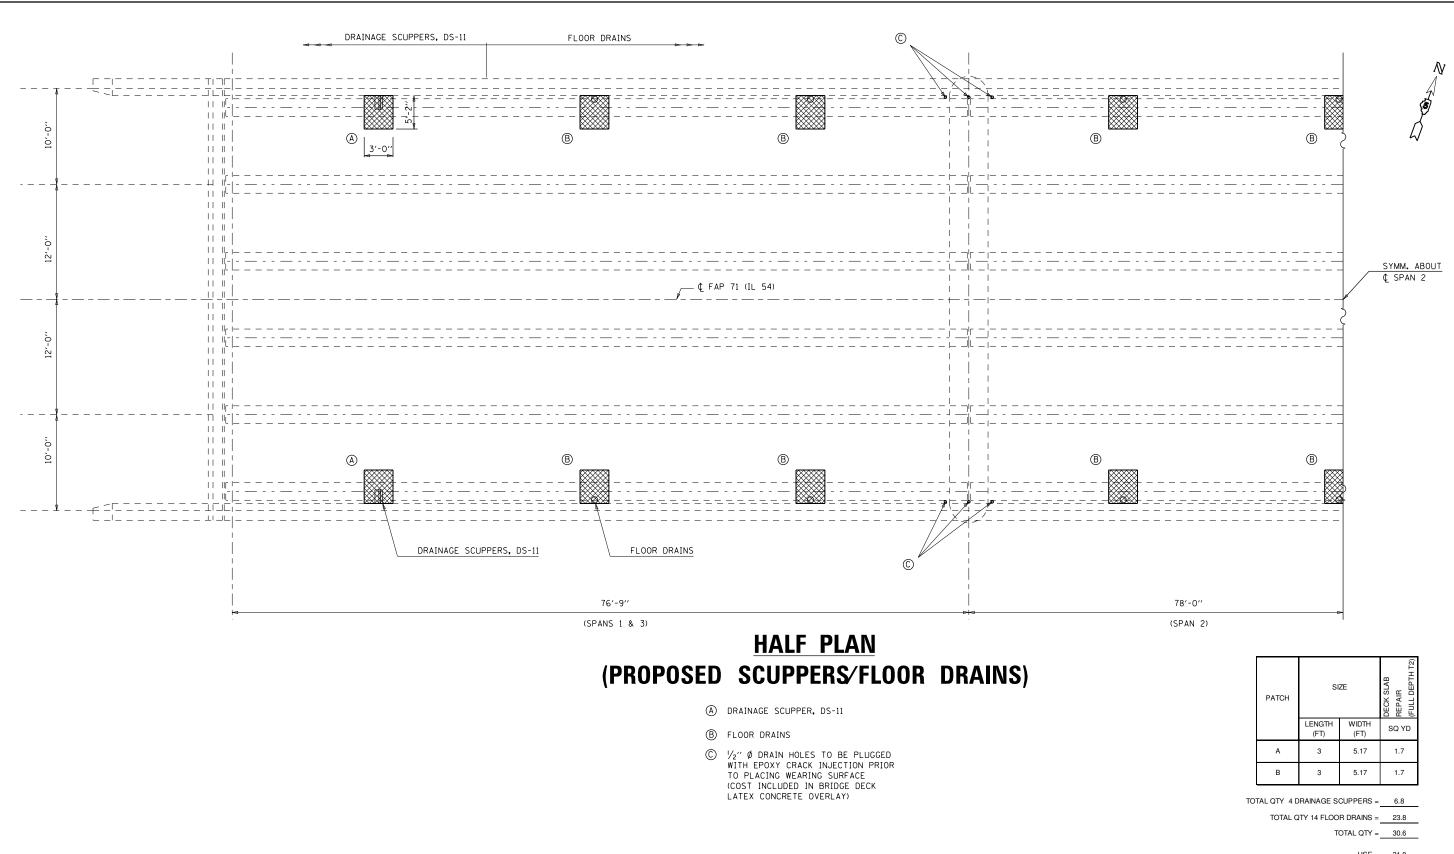

					ITEM		UNI	T TOTAL
					DECK SLAB REF	PAIR (FULL DEPTH	TYPE II) SQ Y	YD 31.0
USER NAME = shererJM	DESIGNED - JMS	REVISED -			1	-A.P.	COUNTY	TOTAL   SHEET
	DRAWN - JMS	REVISED -	STATE OF ILLINOIS	DETAIL OF PROPOSED DRAINAGE STRUCTURES	-	71 SECTION	COUNTY	SHEETS NO. 24 14
PLOT SCALE = 40.0000 ' / in.	CHECKED -	REVISED -	DEPARTMENT OF TRANSPORTATION	S.N. 020–0043		11 15 01(-1	CONTRAC	
PLOT DATE = 11/5/2020	DATE - 052020	REVISED -		SCALE: NONE SHEET 5 OF 14 SHEETS STA. TO	STA.	ILLIN	DIS FED. AID PROJECT	

USE = 31.0

### BILL OF MATERIALS

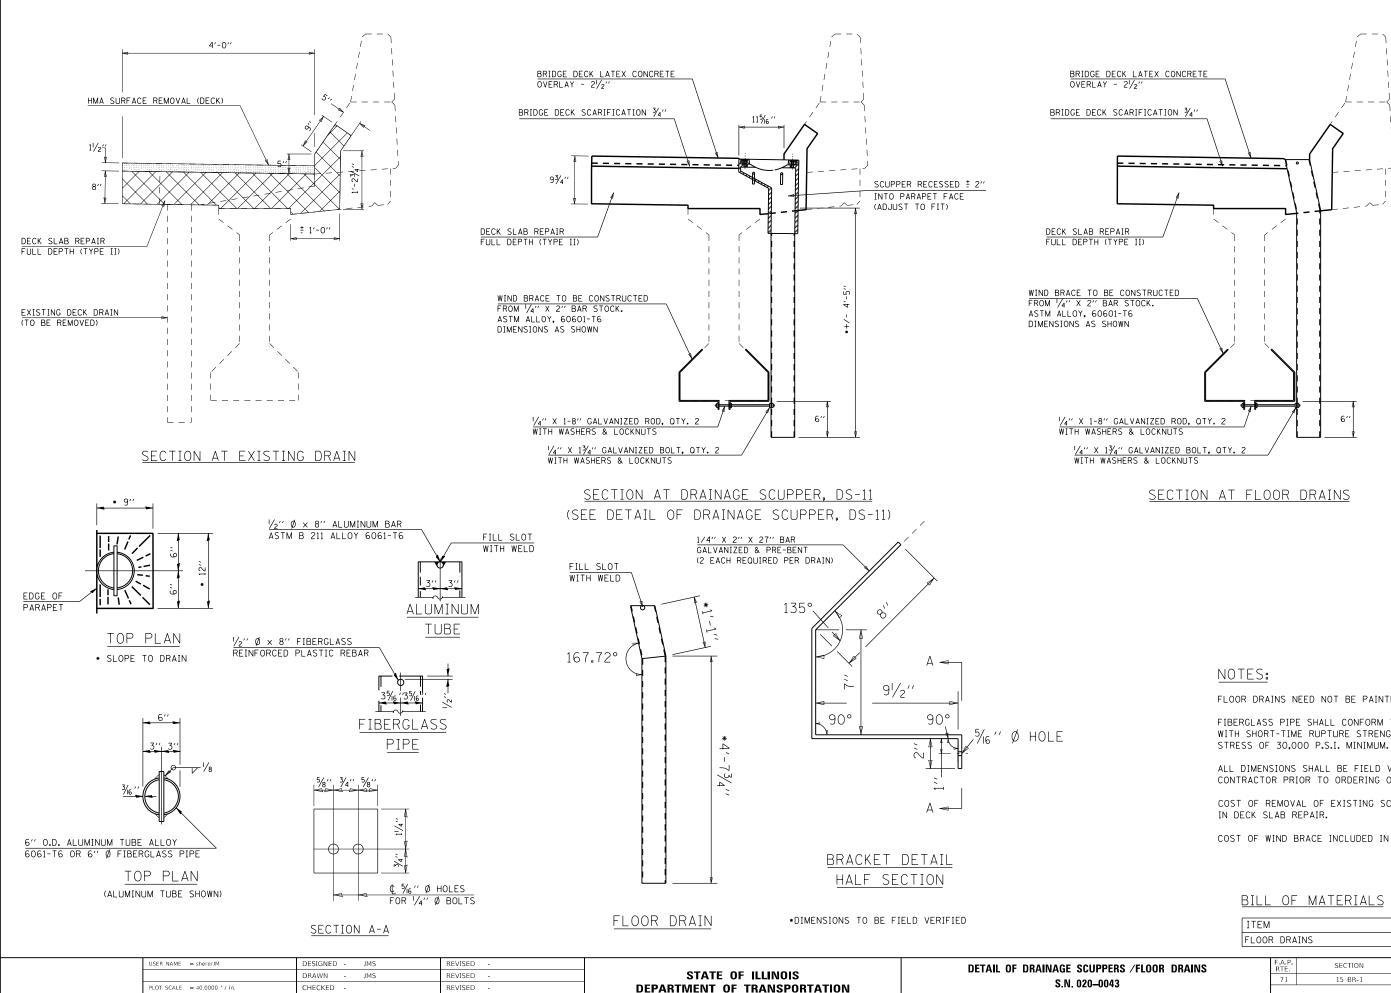

REVISED

LOT DATE = 11/5/2020

DATE

052020

SHEET 6 OF 14 SHEETS SCALE: NONE

FLOOR DRAINS NEED NOT BE PAINTED.

FIBERGLASS PIPE SHALL CONFORM TO ASTM D 2996. WITH SHORT-TIME RUPTURE STRENGTH HOOP TENSILE


ALL DIMENSIONS SHALL BE FIELD VERIFIED BY THE CONTRACTOR PRIOR TO ORDERING OF MATERIALS.

COST OF REMOVAL OF EXISTING SCUPPERS IS INCLUDED

COST OF WIND BRACE INCLUDED IN FLOOR DRAINS.

|--|

		ITEM						UNIT	TOT	AL	
FLOOF			r dra	INS				EACH	14.	.0	
ERS /FLOO	R DRAINS		F.A.P. RTE	SEC	TION		CC	DUNTY	TOTAL SHEETS	SHEE NO	
43			71	15	BR-1		D	WITT	24	15	
							CO	NTRACT	NO. 70	0C93	_
STA.	TO STA.				ILLINOIS	FED, AI	D PRO	IECT			_

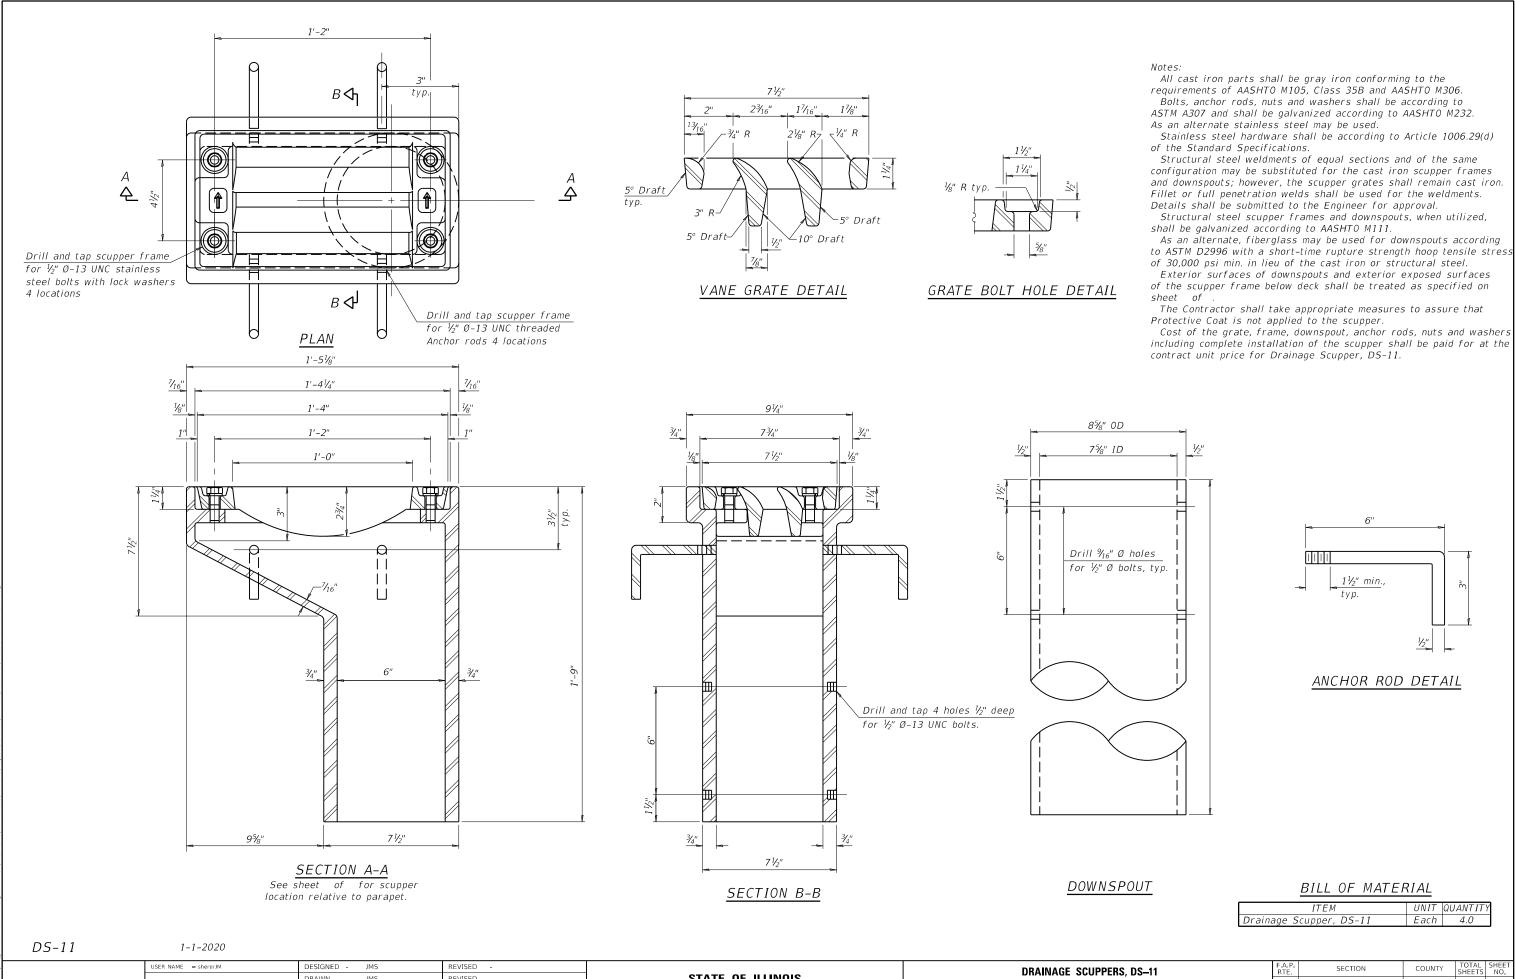


STATE OF ILLINOIS DRAWN -JMS REVISED S.N. 020-00 CHECKED REVISED **DEPARTMENT OF TRANSPORTATION** SCALE: NONE SHEET 7 OF 14 SHEETS DATE REVISED 052020

PLOT SCALE = 40.0000 ' / in.

PLOT DATE = 11/5/2020

SPUUT	BILL OF MALEF	<u>{ AL</u>	
	ITEM	UNIT	QUANTITY
	Drainage Scupper, DS-11	Each	4.0


PERS, DS-11 0043		SECT	SECTION		COUNTY	TOTAL SHEETS	SHEET NO.
		71 15 BR-1		DEWITT	24	16	
					CONTRACT	NO. 70	C93
S STA. TO STA.	ILLINOIS FED. AID PROJECT						

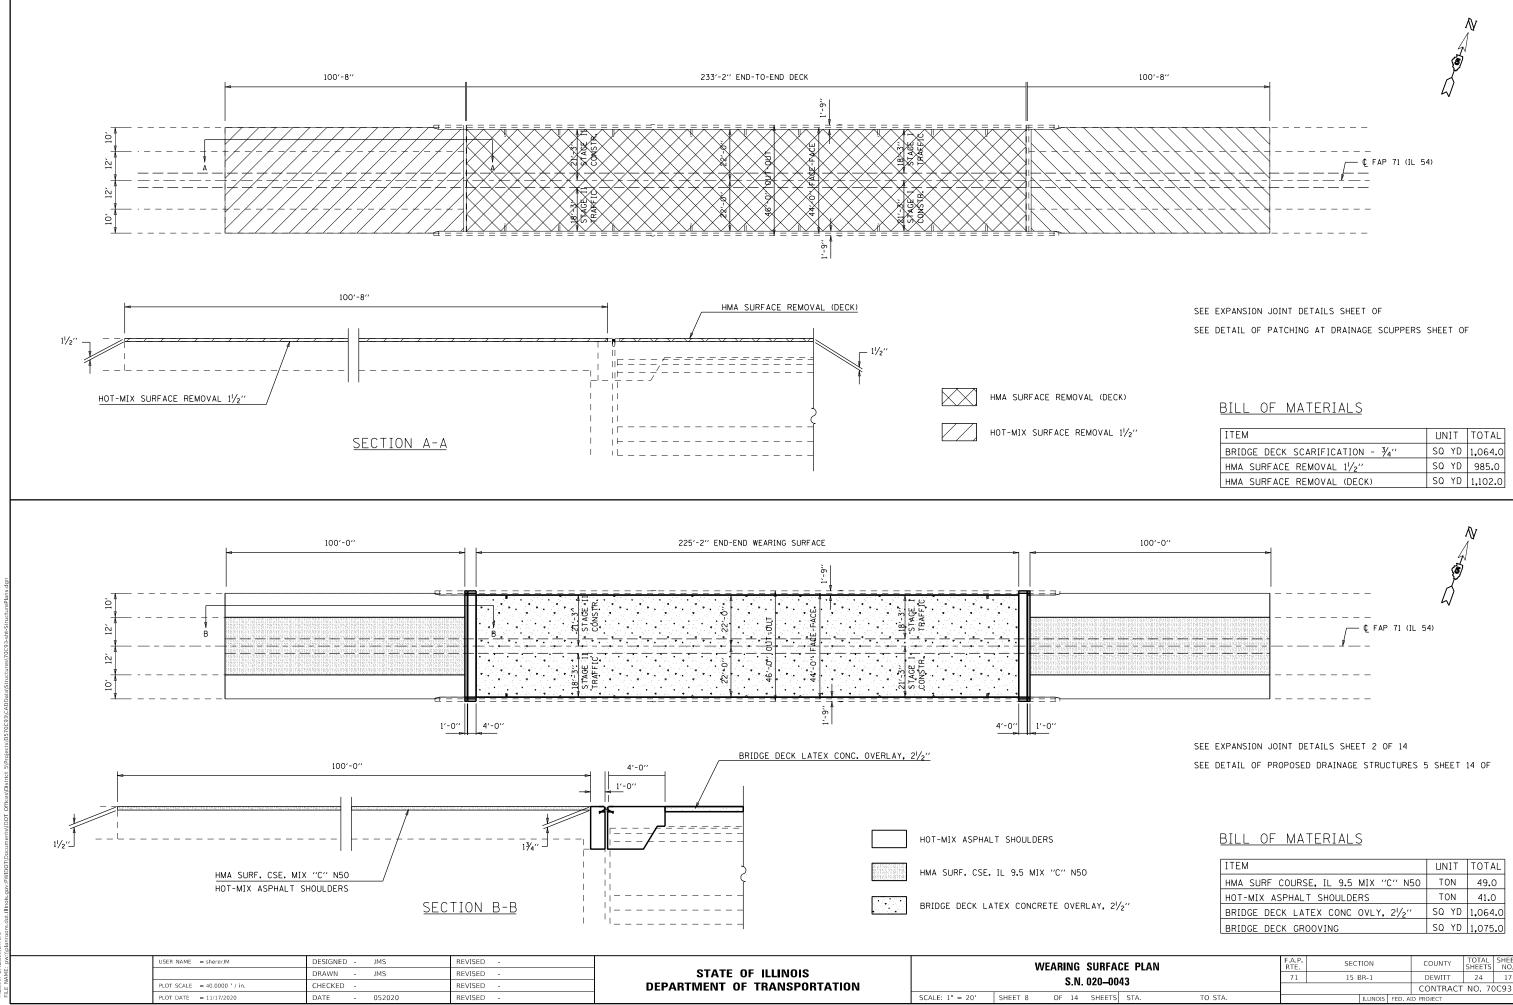

ITEM	UNIT	TOTAL
BRIDGE DECK SCARIFICATION - 3/4"	SQ YD	1,064.0
HMA SURFACE REMOVAL 11/2"	SQ YD	985.0
HMA SURFACE REMOVAL (DECK)	SQ YD	1,102.0

HMA SURF COURSE, IL 9.5 MIX "C" N50TON49.0HOT-MIX ASPHALT SHOULDERSTON41.0BRIDGE DECK LATEX CONC OVLY, 2 <sup>1</sup> / <sub>2</sub> "SQ YD1,064.0BRIDGE DECK GROOVINGSQ YD1,075.0	ITEM	UNIT	TOTAL
BRIDGE DECK LATEX CONC OVLY, 21/2" SQ YD 1,064.0	HMA SURF COURSE, IL 9.5 MIX "C" N50	TON	49.0
	HOT-MIX ASPHALT SHOULDERS	TON	41.0
BRIDGE DECK GROOVING SO YD 1 075 0	BRIDGE DECK LATEX CONC OVLY, 21/2"	SQ YD	1,064.0
	BRIDGE DECK GROOVING	SQ YD	1,075.0

ACE PLAN 0043		SECTION		COUNTY	TOTAL SHEETS	SHEET NO.	
		71 15 BR-1			DEWITT	24	17
					CONTRACT	NO. 70	)C93
TS STA. TO STA.	ILLINOIS FED. AID PROJECT						

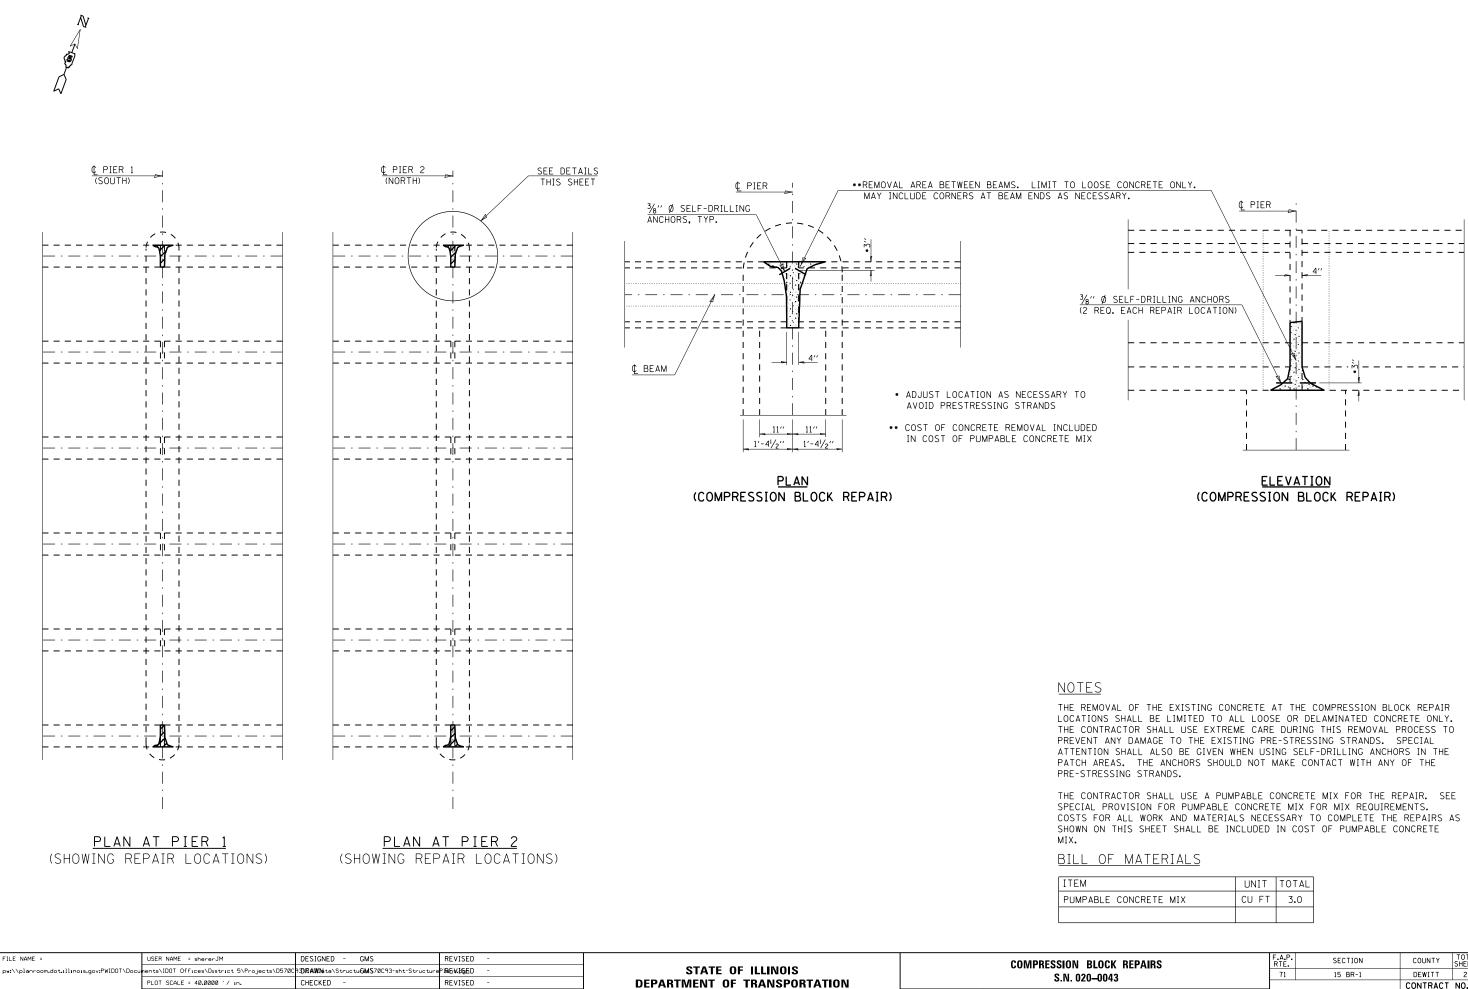

DATE

PLOT DATE = 11/5/2020


REVISED

SCALE: NONE

SHEET NO. 9 OF 14 SHEETS

	UNIT	TOTAL
LE CONCRETE MIX	CU FT	3.0


OCK REPAIRS 0043		F.A.P. RTE.	SEC	TION	COUNTY	TOTAL SHEETS	SHEET NO.	
		71	71 15 BR-1		DEWITT	24	18	
					CONTRACT	NO. 70	0C931	
	STA.	TO STA.	FED. RC	AD DIST. NO.	ILLINOIS FED. AI	D PROJECT		

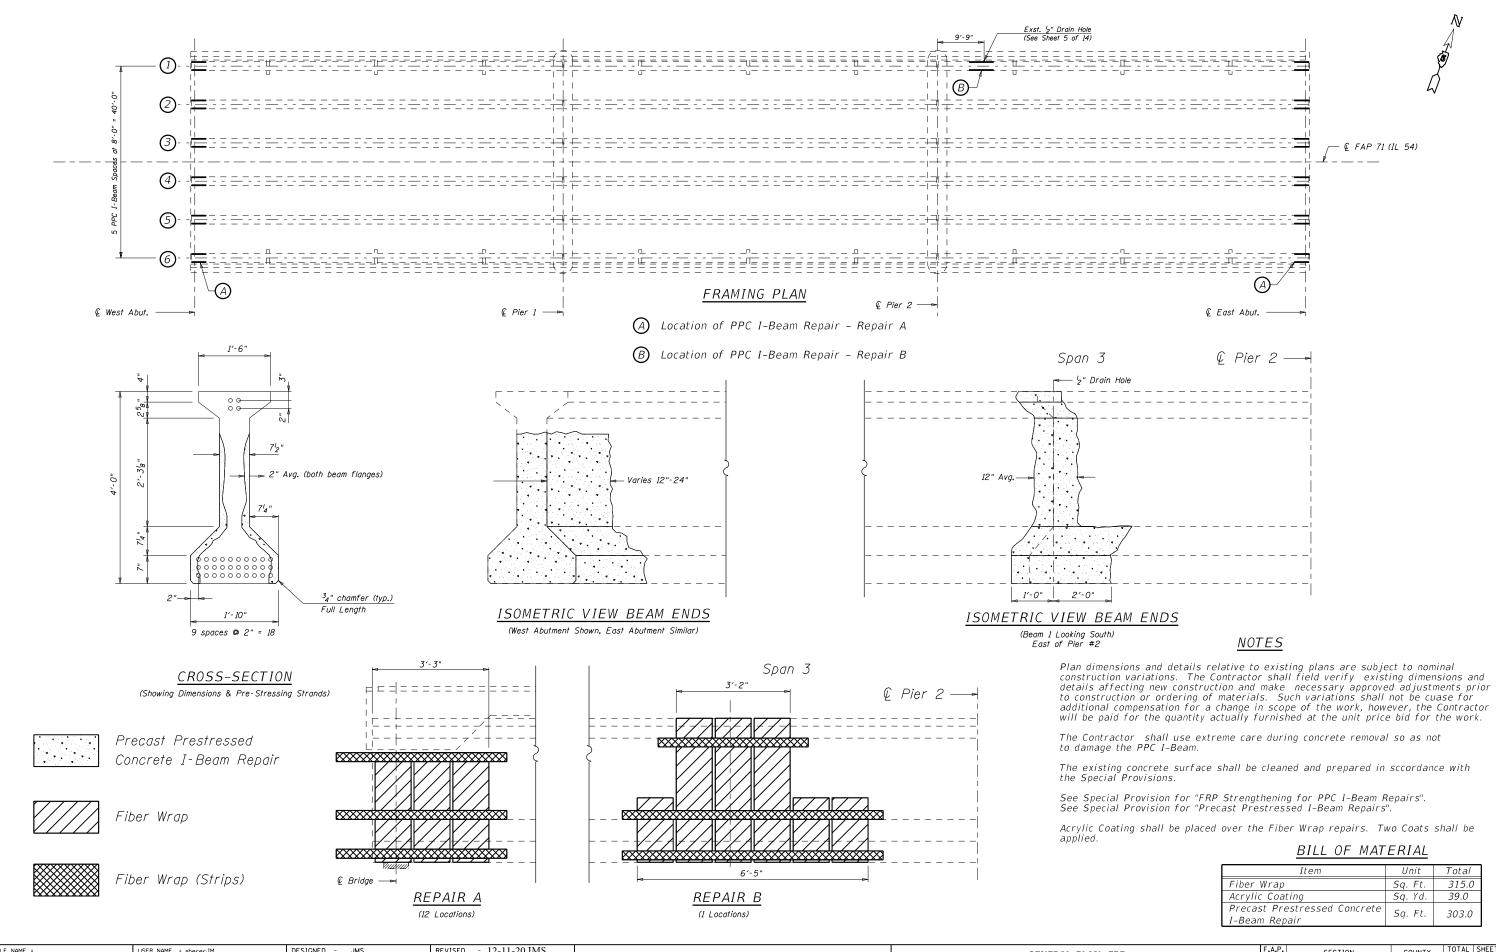



FILE NAME = DESIGNED - JMS REVISED - 12-11-20 JMS USER NAME = shererJM **GENERAL PLAI** STATE OF ILLINOIS w:\\planroom.dot.illing ents\IDOT\_Offices\District\_5\Projects\D570C**P3)RAWD**ita\Structur**WAS**70C93-sht-Structur PIBE¥.65ED v:PWIDOT\D S.N. 020-0 PLOT SCALE = 40.0000 '/ in. CHECKED REVISED **DEPARTMENT OF TRANSPORTATION** REVISED SCALE: NONE SHEET NO. 10 OF 14 SHEETS PLOT DATE = 12/11/2020 DATE 030518


Item	Unit	Total
Fiber Wrap	Sq. Ft.	315.0
Acrylic Coating	Sq. Yd.	39.0
Precast Prestressed Concrete I-Beam Repair	Sq. Ft.	303.0

AN FRP 0043		SECTION	COUNTY	TOTAL SHEETS	SHEET NO.
		15 BR-1	DEWITT	24	19
J0+J	CONTRACT NO. 7003			0C93	
STA. TO STA.	ILLINOIS FED. AID PROJECT				

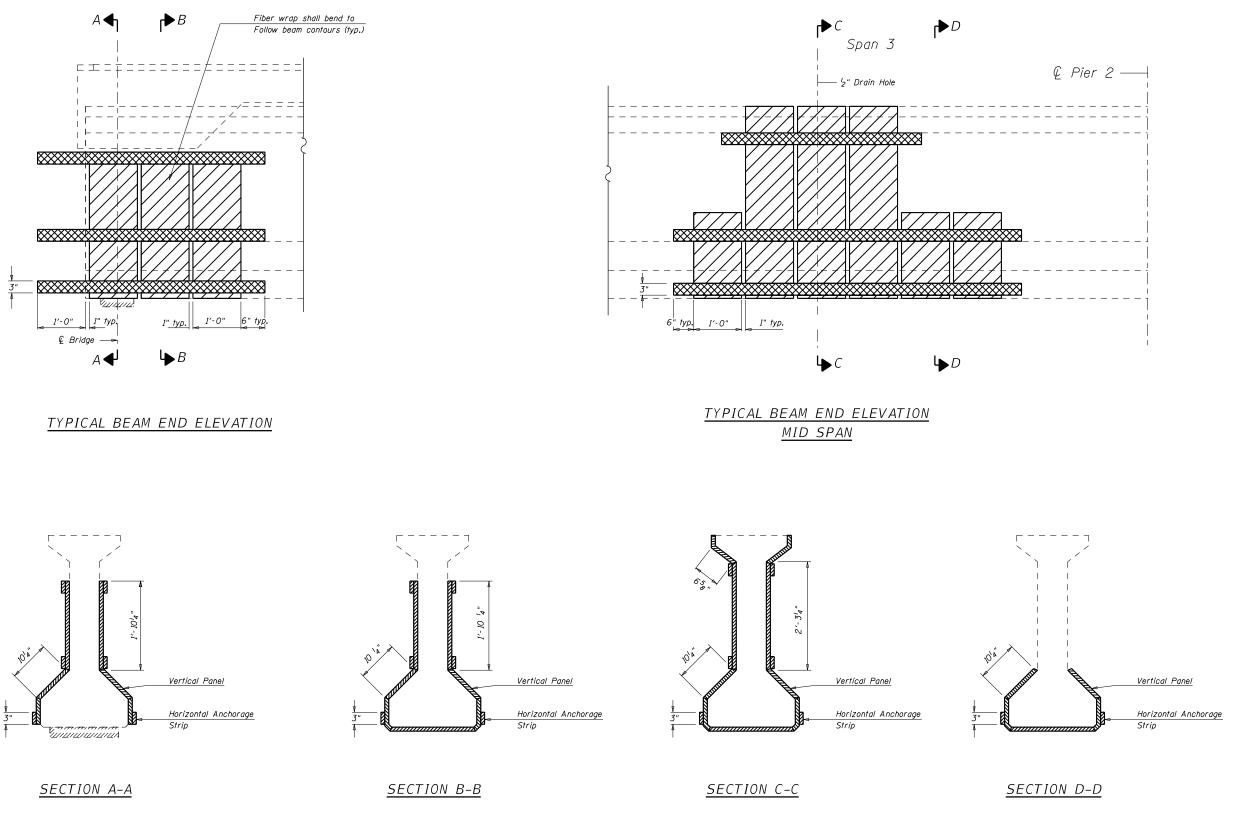


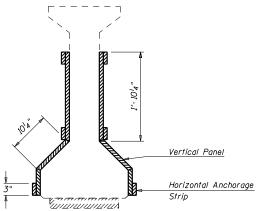

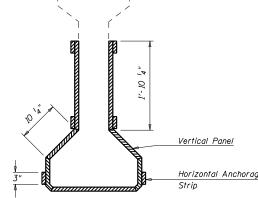

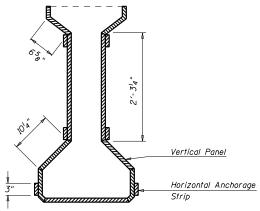


FILE NAME =	USER NAME = shererJM	DESIGNED - JMS	REVISED - 12-11-20 JMS		REPAIR DETAILS FRP S.N. 020–0043		F.A.P.	SECTION	COUNTY	TOTAL SHEET		
pw://planroom.dot.illinois.gov:PWIDOT/Docu	nents\IDOT_Offices\District_5\Projects\D570C	33DRAWINita\Structures70C93-sht-Structure	P18-6¥-b§-ED -	STATE OF ILLINOIS			71	15 BR-1	DEWITT	24 20		
	PLOT SCALE = 40.0000 '/ in.	CHECKED -	REVISED -	DEPARTMENT OF TRANSPORTATION						CONTRACT	T NO. 70C93	
	PLOT DATE = 12/11/2020	DATE - 030518	REVISED -		SCALE: NONE	SHEET NO. 11 OF 14 SHEETS	STA.	TO STA.		ILLINOIS FED. A	ID PROJECT	

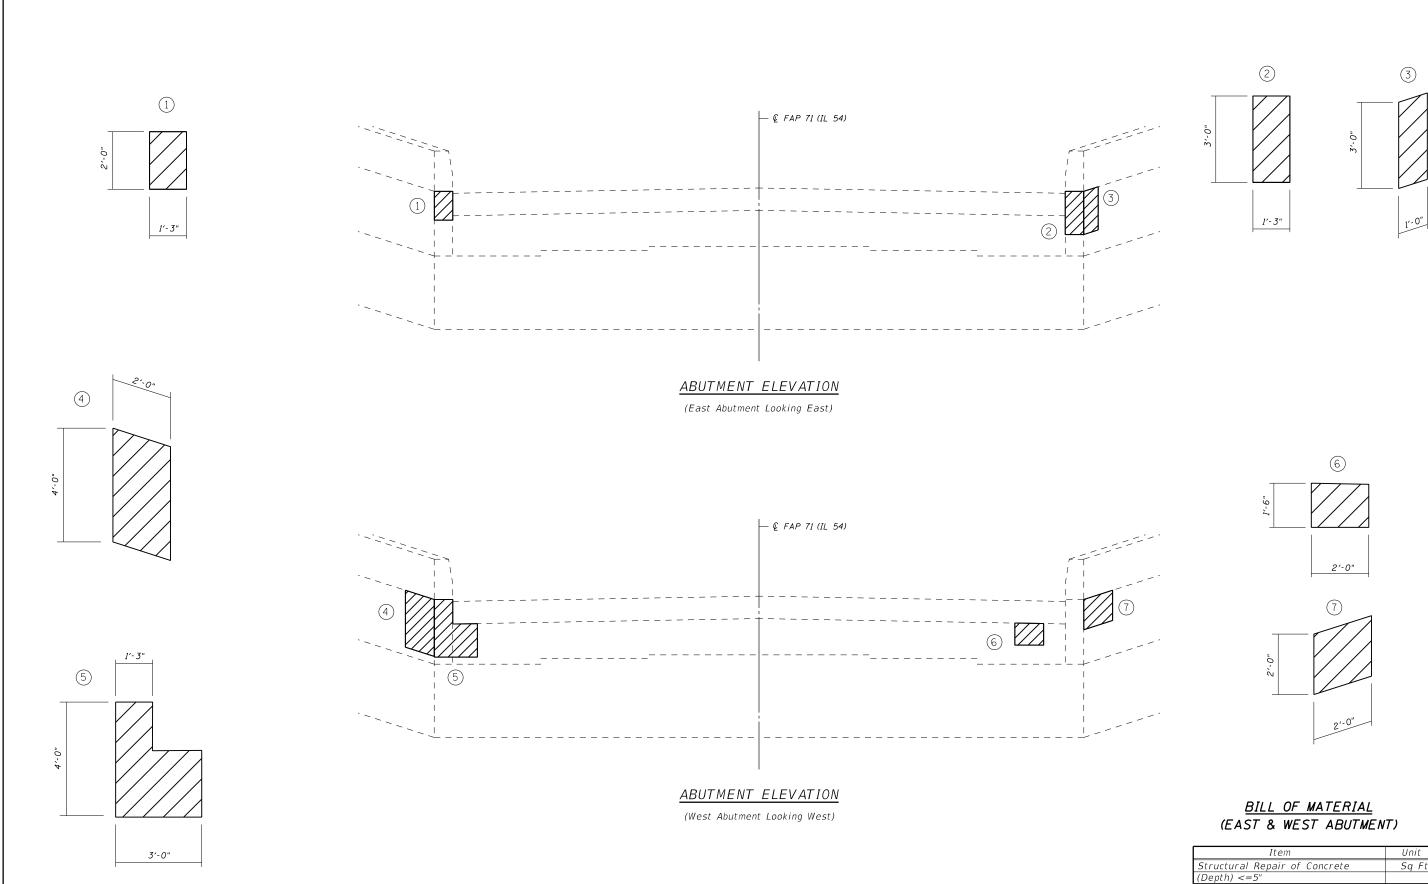

Ī	FILE NAME =	USER NAME = shererJM	DESIGNED - JMS	REVISED -			DETAIL OF STRUCTURAL REPAIR		F.A.P.	SECTION	COUNTY TOTAL	SHEET
	pw://planroom.dot.illinois.gov:PWIDOT/Docu	ents\IDOT Offices\District 5\Projects\D570C	93 <b>DRAWIN</b> ta\Structu <b>UAAS</b> 70C93-sht-Structur	eP1R6¥J6g6D -	STATE OF ILLINOIS	OF CONCRETE         S.N. 020-0043           SCALE: NONE         SHEET NO. 12 OF 14 SHEETS         STA.         TO STA.		71	15 BR-1	DEWITT 24	21	
		PLOT SCALE = 40.0000 ' / in.	CHECKED -	REVISED -	DEPARTMENT OF TRANSPORTATION			143			CONTRACT NO. 7	0C93
		PLOT DATE = 11/5/2020	DATE - 030518	REVISED -					ILLINOIS FED.	AID PROJECT		


Item	Unit	Total
Structural Repair of Concrete	Sq Ft	33.4
(Depth) <=5"		

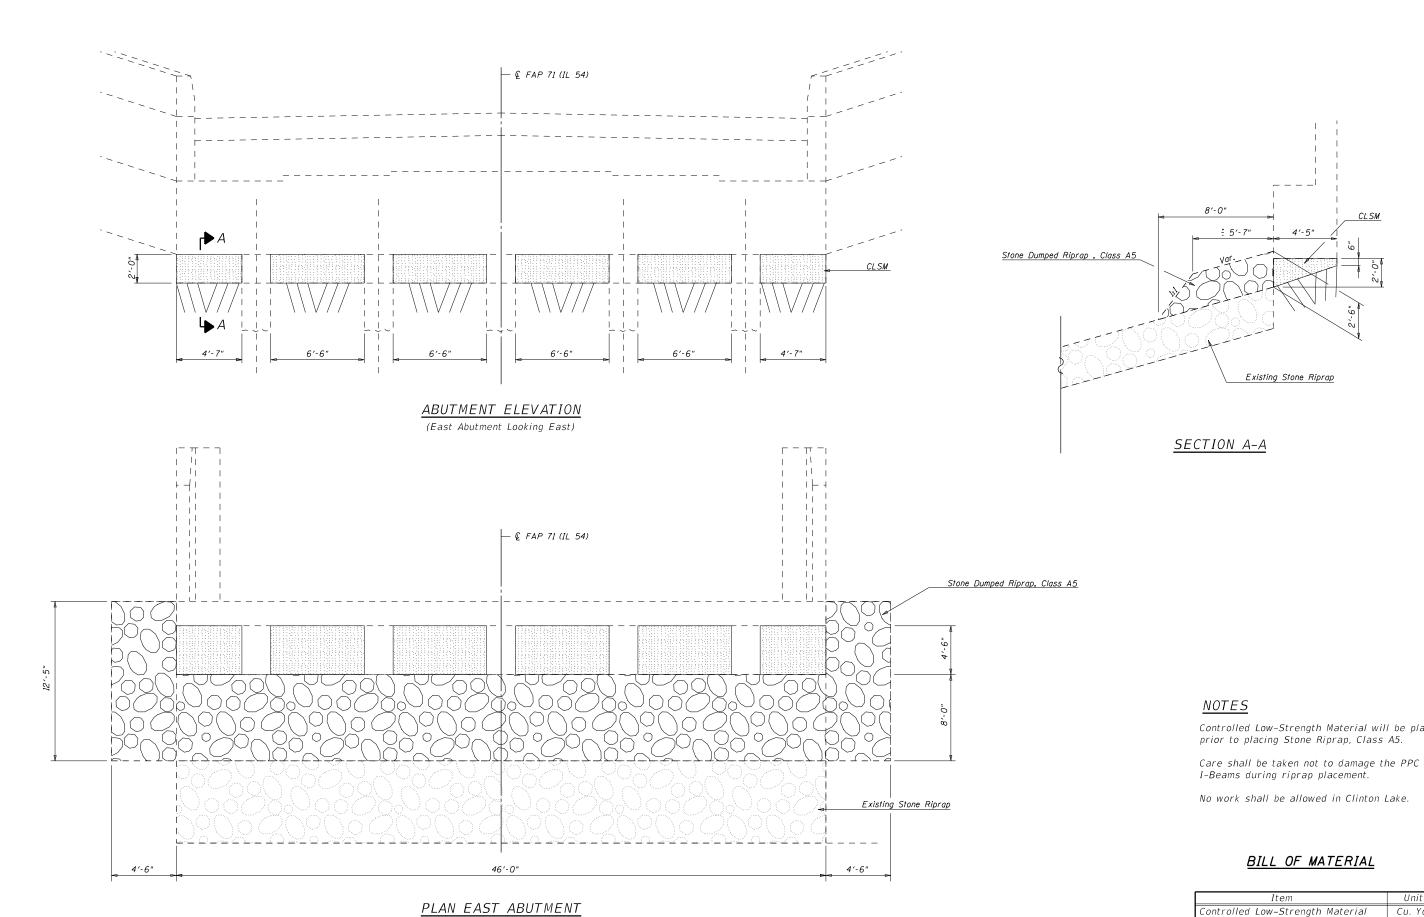

FILE NAME =	USER NAME = shererJM	DESIGNED - JMS	REVISED -		DETAIL OF EROSION REPAIR AT ABUTMENTS           S.N. 020-0043           SCALE: NONE         SHEET NO. 13 OF 14 SHEETS         STA.         TO STA.		F.A.P. RTE.	SECTION	COUNTY	TOTAL SHEET SHEETS NO.	
pw://planroom.dot.illinois.gov:PWIDOT/Docu			ePla6¥.b§6D -	STATE OF ILLINOIS			71	15 BR-1	DEWITT	24 22	
	PLOT SCALE = 40.0000 '/ in.	CHECKED -	REVISED -	DEPARTMENT OF TRANSPORTATION						CONTRACT	NO. 70C93
	PLOT DATE = 11/5/2020	DATE - 030518	REVISED -					ILLINOIS FED. A	D PROJECT		

Controlled Low-Strength Material will be placed prior to placing Stone Riprap, Class A5.

Item	Unit	Total
Controlled Low-Strength Material	Cu. Yd.	7.2
Stone Dumped Rip Rap, Class A5	Sq. Yd.	54.0

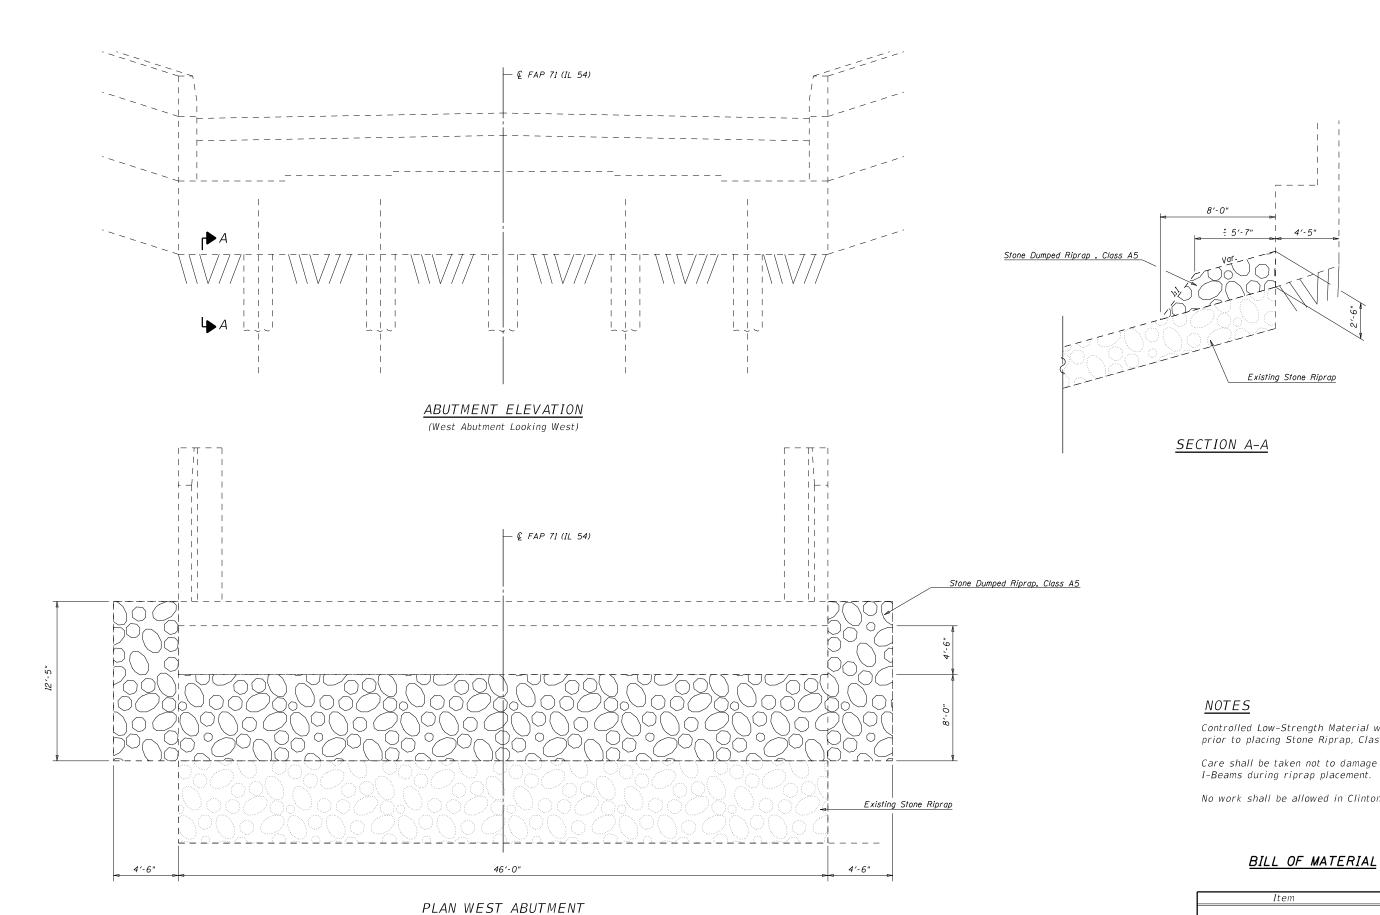


	USER NAME = shererJM	DESIGNED - JMS	REVISED -			DETAIL OF EROSION REPAIR	R /
pw://planroom.dot.illinois.gov:PWIDDT/Documents/IDDT Offices/District 5/Projects/D570CP <b>3DRAWD</b> /ta/Structud <b>WS</b> 70C93-sht-Structure PLOT SCALE = 40.0000 '/ in. CHECKED -		P1&aG¥ubGgED - REVISED -	STATE OF ILLINOIS DEPARTMENT OF TRANSPORTATION	S.N. 020–0043			
	PLOT DATE = 11/5/2020	DATE - 030518	REVISED -	DEFAITMENT OF THANSFORTATION	SCALE: NONE	SHEET NO. 14 OF 14 SHEETS	ST

Controlled Low-Strength Material will be placed prior to placing Stone Riprap, Class A5.

Care shall be taken not to damage the PPC I-Beams during riprap placement.

No work shall be allowed in Clinton Lake.

STA.	TO STA.		ILLINOIS FED.	AID PROJECT		
				CONTRAC	T NO. 7	0C93
)43		71	15 BR-1	DEWITT	24	23
R AT ABUT	MENTS	F.A.P. RTE.	SECTION	COUNTY	TOTAL SHEETS	SHEET NO.
						_
	Stone D	umped Rip	o Rap, Class A5	Sq. Yd.	54.0	
		Iter	Unit	Total		

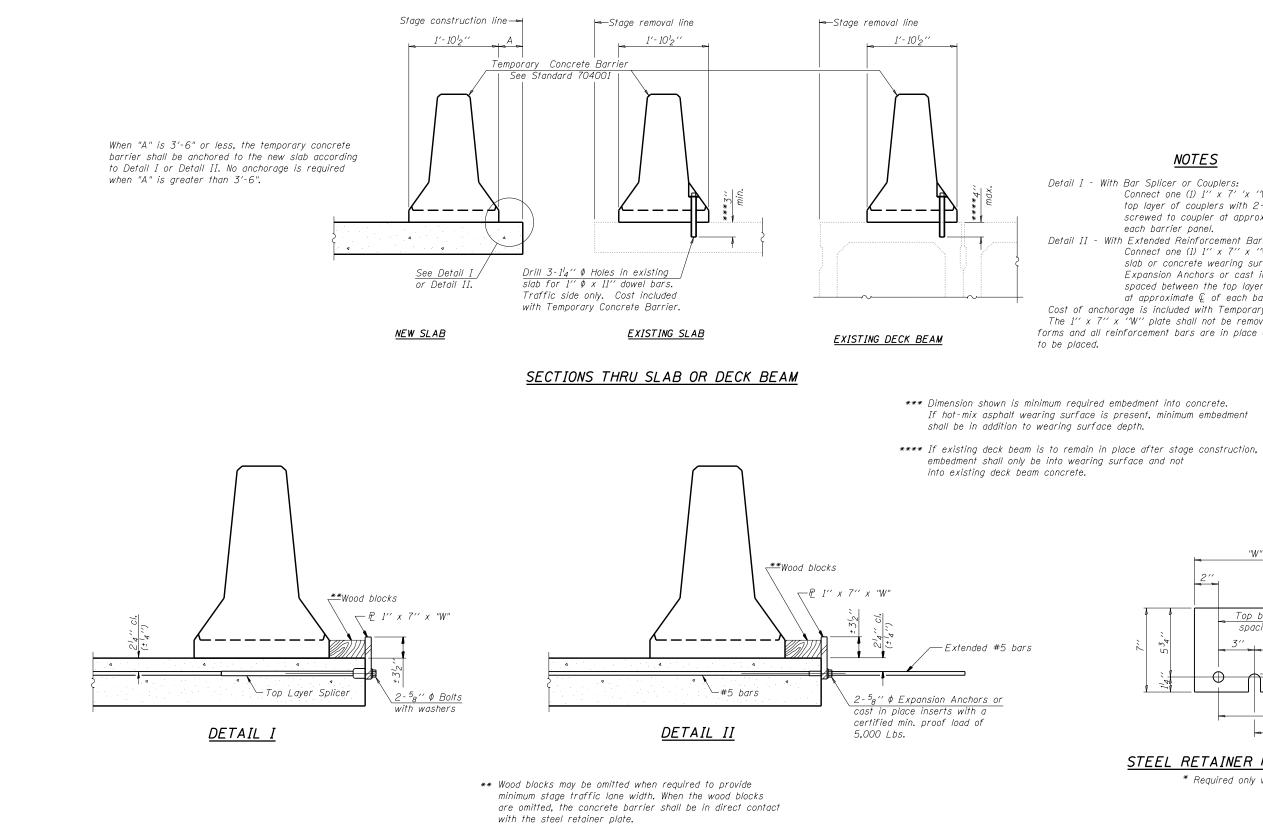

"W" = Top bars spacing + 4"


R-27

7-1-10

FILE NAME =	USER NAME = shererJM	DESIGNED -	REVISED -		TEMPORARY CONCRETE BARRIER FOR STAGE CONSTRUCTION S.N. 020–0043		F.A.P.	SECTION	COUNTY TOTAL SHEET	
pw://planroom.dot.illinois.gov:PWIDOT/Docu	nents\IDOT_Offices\District_5\Projects\D5700	93DRAWNsta\Structures\70C93-sht-Structure	PI&E¥J&ED -	STATE OF ILLINOIS			71	15 BR-1	DEWITT 24 24	
	PLOT SCALE = 40.0000 ' / in.	CHECKED -	REVISED -	DEPARTMENT OF TRANSPORTATION					CONTRACT NO. 70C93	
	PLOT DATE = 11/5/2020	DATE -	REVISED -		SCALE: None	SHEET 1 OF 1 SHEETS STA.	TO STA.		ILLINOIS FED. AI	ID PROJECT

### NOTES

Detail I - With Bar Splicer or Couplers: Connect one (1) 1'' x 7' 'x 'W'' steel ₽ to the top layer of couplers with 2-5<sub>8</sub>'' ¢ bolts screwed to coupler at approximate ♀ of each barrier panel. Detail II - With Extended Reinforcement Bars: Connect one (1) 1" x 7" x "W" steel P to the concrete slab or concrete wearing surface with 2-58" \$ Expansion Anchors or cast in place inserts spaced between the top layer of reinforcement at approximate Q of each barrier panel. Cost of anchorage is included with Temporary Concrete Barrier. The 1" x 7" x "W" plate shall not be removed until stage II construction forms and all reinforcement bars are in place and the concrete is ready

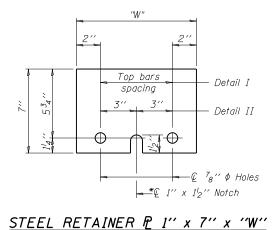

\* Required only with Detail II