## STATE OF ILLINOIS

## **DEPARTMENT OF TRANSPORTATION**

## D-98-011-20

(101.102)85-4


MADISON JILLINOIS CONTRACT NO. 76M84 **★** 40 + 1 = 41 TOTAL SHEETS

604



**FUNCTIONAL CLASSIFICATION** MINOR ARTERIAL 2020 ADT: 5850 (ACTUAL) 2021 ADT: 5900 (ESTIMATED) SU = 3.4% MU = 2.9%

LOCATION OF SECTION INDICATED THUS: -

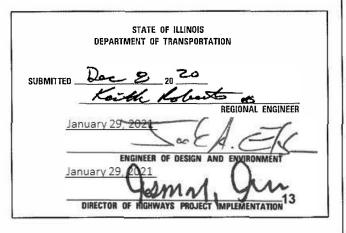

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### INDEX OF SHEETS

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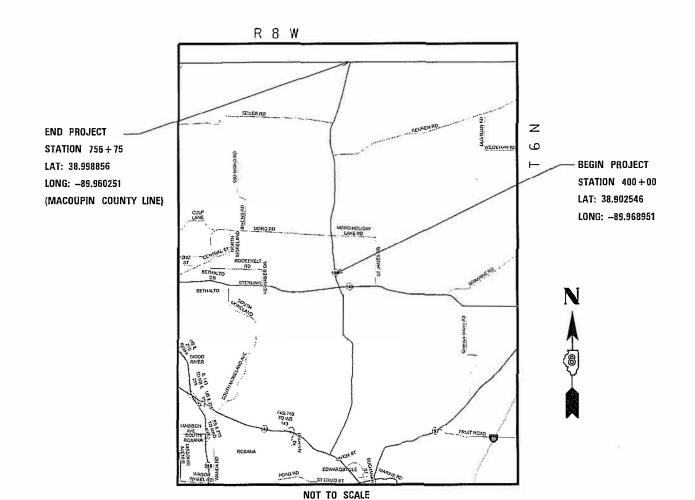
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- HIGHWAY STANDARDS, GENERAL NOTES & COMMITMENTS
- SUMMARY OF QUANTITIES
- 9-13 TYPICAL SECTIONS
- SCHEDULES OF QUANTITIES 14-22
- **LOCATION MAP** 23
- STAGING AND TRAFFIC CONTROL 24-31
- DETECTOR LOOP DETAILS 32-33
- CULVERT DETAILS 34-35
- MISCELLANEOUS DETAILS 36-37
- PAVEMENT MARKING

# **PROPOSED** HIGHWAY PLANS

**FAP ROUTE 604 (IL 159) SECTION (101,102)RS-4** PROJECT STP-08Q4(157) RESURFACING - 3P - STANDARD OVERLAY **MADISON** COUNTY

C-98-025-20



GROSS LENGTH = 35,675 FT. = 6,76 MILE

NET LENGTH = 35.675 FT. = 6.76 MILE

FULL SIZE PLANS HAVE BEEN PREPARED USING STANDARD ENGINEERING SCALES. REDUCED SIZED PLANS WILL NOT CONFORM TO STANDARD SCALES, IN MAKING MEASUREMENTS ON REDUCED PLANS, THE ABOVE SCALES MAY BE USED.

JOINT UTILITY LOCATION INFORMATION FOR EXCAVATORS 1-800-892-0123

OR 811

PROJECT ENGINEER: HERVÉ GELIN (618) 346-3179 PROJECT MANAGER: BILLIE OWEN (618) 346-3209

CONTRACT NO. 76M84

REV. - MS

#### **GENERAL NOTES**

1. THE FOLLOWING UTILITIES KNOWN TO HAVE FACILITIES WITHIN THE PROJECT AREA ARE AS FOLLOWS:

\*AMEREN ILLINOIS \*AT&T ILLINOIS \*CHARTER COMMUNICATIONS, INC. \*FOSTERBURG WATER DISTRICT \*HOLIDAY SHORES SANITARY DISTRICT \*MARATHON PIPE LINE LLC

\*RUCKEYE PARTNERS L.P.--WOOD RIVER PIPELINE \*NORTHEAST CENTRAL COUNTY PUBLIC WATER DISTRICT \*EXPLORER PIPELINE COMPANY \*FRONTIER COMMUNICATIONS \*MADISON TELEPHONE COMPANY

\*SOUTHWESTERN ELECTRIC COOPERATIVE, INC.

- 2. NO SURVEY WAS PERFORMED FOR THIS PROJECT. THE PLANS WERE CREATED USING MICROFILM AND FIELD MEASUREMENTS.
- 3. THE PAVEMENT MARKING SHOWN IN THE PLANS IS APPROXIMATE. THE LOCATIONS OF THE PROPOSED PAVEMENT MARKING SHOULD MATCH EXISTING FIELD CONDITIONS
- 4. ONLY SHORT-TERM PAVEMENT MARKING REMOVAL FROM THE FINAL SURFACE SHALL BE PAID FOR AS "SHORT-TERM PAVEMENT MARKING REMOVAL".
- 5. THE DEPARTMENT STRONGLY ENCOURAGES THE PRIME CONTRACTOR AND THEIR APPROVED SUB -CONTRACTORS TO HIRE MINORITY, WOMEN AND DISADVANTAGED INDIVIDUALS FROM ITS FEDERALLY FUNDED HIGHWAY CONSTRUCTION CAREERS TRAINING PROGRAM (HCCTP) TO HELP MEET WORK FORCE AND TRAINEE GOALS. THIS PROGRAM IS TRAINING MINORITIES, WOMEN AND DISADVANTAGED INDIVIDUALS IN HIGHWAY CONSTRUCTION -RELATED SKILLS, E.G., MATH FOR THE TRADES, JOB READINESS, TECHNICAL SKILLS COURSE WORK (CARPENTRY, CONCRETE FLATWORK, BLUEPRINT READING, SITE PLANS, SITE WORK, TOOLS USE, ETC.) AND OSHA 10 HOUR CERTIFICATION, TO PREPARE THEM FOR A CAREER IN THE HIGHWAY CONSTRUCTION TRADES. GRADUATES ARE WELL- TRAINED AND READY TO BECOME PRODUCTIVE ENTRY-LEVEL CONSTRUCTION WORKERS. CONTACT THE DISTRICT 8 EEO OFFICE AT 618-346-3360 AND/OR THE HCCTP COORDINATOR AT 618-874-6528 TO LEARN MORE ABOUT THE PROGRAM AND FOR ASSISTANCE IN MEETING WORK FORCE AND TRAINEE GOALS.
- 6. ALL PATCHING ON THIS PROJECT SHALL BE COMPLETED PRIOR TO BITUMINOUS SURFACE REMOVAL.
- 7. OVERNIGHT LANE CLOSURES WILL NOT BE ALLOWED EXCEPT FOR THE MORO ROAD INTERSECTION RECONSTRUCTION.
- 8. IF THE CONTRACTOR, FOR HIS CONSTRUCTION ACTIVITY, REMOVES TREES WITHIN THE RIGHT-OF-WAY LIMITS WHICH ARE NOT DESIGNATED ON THE PLANS FOR REMOVAL, I.E. IN ORDER TO GAIN ACCESS TO THE PROJECT SITE; IT WILL BE HIS RESPONSIBILITY TO REPLACE THE TREES AT A 1:1 RATIO. THE TREES WILL BE REPLACED WITH A 1 GALLON NATIVE ILLINOIS TREE SPECIES AND SHALL BE APPROVED BY THE ENGINEER. THE TREE REMOVAL AND TREE REPLACEMENT WILL BE AT THE CONTRACTOR'S EXPENSE, AND NO ADDITIONAL COMPENSATION WILL BE ALLOWED.

THE RESIDENT ENGINEER SHALL VERIFY THE EXISTENCE OF HIGHWAY LIGHTING AND/OR INTELLIGENT TRANSPORTATION SYSTEMS (I.T.S.) UTILITIES WITHIN THE PROJECT LIMITS. IF HIGHWAY LIGHTING AND/OR I.T.S. EXISTS WITHIN THE PROJECT LIMITS, AND IF THESE ITEMS REQUIRE LOCATING, THE CONTRACTOR SHALL BE DIRECTED TO DO SO ACCORDING TO SECTION 803 OF THE STANDARD SPECIFICATIONS. THIS WORK SHALL BE PAID FOR ACCORDING TO ARTICLE 109.04 OF THE STANDARD SPECIFICATIONS.

- 9. ALL DISTURBED EMBANKMENT AREAS SHALL BE SEEDED WITH CLASS 2 SEED, FERTILIZED AND MULCHED AS PER SECTION 250.04 OF THE STANDARD SPECIFICATIONS AND AS DIRECTED BY THE ENGINEER. THE COST FOR PERFORMING THIS WORK SHALL BE CONSIDERED INCLUDED IN THE UNIT PRICE BID FOR THE ITEM OF WORK INITIATING THE DISTURBANCE.
- 10. THE CONTRACTOR SHALL PROVIDE POSITIVE AND ADEQUATE DRAINAGE AT ALL TIMES.
- 11. IF THE PROPOSED SURFACE REMOVAL ON THIS PROJECT PRODUCES A MILLED EDGE NEAR CENTERLINE GREATER THAN 1.5 INCHES OR IF THE PROPOSED RESURFACING RESULTS IN AN ELEVATION DIFFERENCE GREATER THAN 2 INCHES NEAR THE CENTERLINE BETWEEN ADJACENT OPEN LANES OF TRAFFIC, ONE OF THE FOLLOWING SHALL APPLY:
  - \*THE CONTRACTOR SHALL ORGANIZE THE WORK TO AVOID THE ELEVATION DIFFERENCES MENTIONED ABOVE.
  - \*THE CONTRACTOR SHALL CONSTRUCT A TEMPORARY HOT MIX ASPHALT WEDGE ALONG THE CENTERLINE TO AVOID THE ELEVATION DIFFERENCES MENTIONED ABOVE
  - \*THE CONTRACTOR SHALL CONSTRUCT A MILLED SLOPE EDGE (MINIMUM 1:3) ALONG THE CENTERLINE TO AVOID THE ELEVATION DIFFERENCES MENTIONED ABOVE.

THE COST OF THIS WORK SHALL BE INCLUDED IN THE COST PER SQUARE YARD FOR HOT-MIX ASPHALT SURFACE REMOVAL OF THE DEPTH SPECIFIED OR IN THE COST PER TON FOR THE HOT-MIX ASPHALT RESURFACING MIXES SPECIFIED IN THE PLANS.

#### MIXTURE REQUIREMENTS

MIXTURE USE	SURFACE	BINDER	PATCHING	MIXTURE USE	SHOULDERS (LOWER)	SHOULDERS (SURFACE)
AC/PG	PG 64-22	PG 64-22	PG 64-22	AC/PG	PG 64-22	PG 64-22
RAP % (MAX)	SEE SPECIAL PROVISION	SEE SPECIAL PROVISION	SEE SPECIAL PROVISION	RAP % (MAX)	SEE SPECIAL PROVISION	SEE SPECIAL PROVISION
DESIGN AIR VOIDS	4.0% @ Ndes=70	4.0% @ Ndes=70	4.0% @ Ndes=70	DESIGN AIR VOIDS	4.0% @ Ndes=30	4.0% @ Ndes=30
MIX COMPOSITION (GRADATION MIXTURE)	IL 9.5	IL 9.5 FG	IL 19.0	MIX COMPOSITION (GRADATION MIXTURE)	IL 19.0L	IL 9.5L
FRICTION AGG	MIXTURE "D"	MIXTURE "C"	MIXTURE "B"	FRICTION AGG		
QUALITY MGMT PROGRAM	QCP	QCP	QC/QA	QUALITY MGMT PROGRAM	QC/QA	QC/QA

PLAN QUANTITIES FOR HMA SURFACE COURSE ITEMS ARE CALCULATED USING A UNIT WEIGHT OF 112 LB/SQ YD/IN (59.8 KG/SQ M/25 MM THICKNESS).

HIGHWAY STANDARDS

STANDARD SYMBOLS, ABBREVIATIONS AND PATTERNS
AREAS OF REINFORCEMENT BARS
DECIMAL OF AN INCH AND OF A FOOT
PAVEMENT JOINTS
24' (7.2 m) JOINTED PCC PAVEMENT
HMA SHOULDER ADJACENT TO RIGID PAVEMENT
HMA SHOULDER STRIPS/SHOULDERS WITH RESURFACING OR WIDENING AND RESURFACING PROJECTS
CONCRETE END SECTIONS FOR PIPE CULVERTS 15' (375 MM) THRU 84" (2100 MM) DIAMETER
SHOULDER RUMBLE STRIPS, 8 IN
OFF-RD OPERATIONS, 2L, 2W, MORE THAN 15' (4.5m) AWAY
OFF-RD OPERATIONS, 2L, 2W, 15' (4.5m) TO 24" (600mm) FROM PAVEMENT EDGE
OFF-RD MOVING OPERATIONS, 2L, 2W, DAY ONLY
LANE CLOSURE, 2L, 2W, DAY ONLY, FOR SPEEDS $\geq$ 45 MPH
LANE CLOSURE, 2L, 2W, SHORT TIME OPERATIONS
LANE CLOSURE, 2L, 2W, SLOW MOVING OPERATIONS DAY ONLY FOR SPEEDS $\geq$ 45 MPH
LANE CLOSURE 2L, 2W, MOVING OPERATIONS- DAY ONLY
LANE CLOSURE, 2L, 2W, BRIDGE REPAIR SPEEDS $\geq$ 45 MPH
Lane closure 2L, 2W, pavement widening, for speeds $\geq$ 45 mph
Lane closure 2L, 2W, work areas in series, for speeds $\geq$ 45 MPH
URBAN LANE CLOSURE, MULTILANE INTERSECTION

TYPICAL APPLICATIONS RAISED REFLECTIVE PAVEMENT MARKERS

**COMMITMENTS** 

TRAFFIC CONTROL DEVICES

TYPICAL PAVEMENT MARKINGS

URBAN LANE CLOSURE, 2L, 2W, UNDIVIDED

701901-08

780001-05

781001-04

701501-06

REV. - MS

				_						
USER NAME = chalanderske	DESIGNED -	REVISED -		HIGHWAY STANDARDS, GENERAL NOTES,	F.A.P	SECTION	COUNTY	TOTAL SH	HEET	
	DRAWN -	REVISED -	STATE OF ILLINOIS			604	(101,102)RS-4	MADISON	40	2
PLOT SCALE = 100.0000 ' / in.	CHECKED -	REVISED -	DEPARTMENT OF TRANSPORTATION		AND CUMMITMENTS		, , , , , , , , , , , , , , , , , , , ,	CONTRAC	T NO. 76M8	84
PLOT DATE = 12/11/2020	DATE -	REVISED -		SCALE: NONE	SHEET 1 OF 1 SHEETS STA. TO STA.		ILLINOIS FED.	AID PROJECT		

				0011011100	
				ROADWAY	ROADWAY
CODE			TOTAL	0005	0005
NO.	ITEM	UNIT	QUANTITY	URBAN	RURAL
NO.	I   L M	ONTT	QUANTITI	ORBAN	NONAL
20200100	EARTH EXCAVATION	CU YD	412	387	25
20200600	EXCAVATING AND GRADING EXISTING SHOULDER	UNIT	690	278.5	411.5
20800150	TRENCH BACKFILL	CU YD	5	2 . 5	2.5
30300001	AGGREGATE SUBGRADE IMPROVEMENT	CU YD	784	784	
31100100	SUBBASE GRANULAR MATERIAL, TYPE A	TON	311	311	
31200100	STABILIZED SUBBASE 4"	SQ YD	1120	1120	
40201000	AGGREGATE FOR TEMPORARY ACCESS	TON	221	98	123
40600290	BITUMINOUS MATERIALS (TACK COAT)	POUND	90149	35962	54187
40600982	HOT-MIX ASPHALT SURFACE REMOVAL - BUTT JOINT	SQ YD	1411	536	875
40602970	HOT-MIX ASPHALT BINDER COURSE, IL-9.5FG, N70	TON	6660	2748	3912
40604062	HOT-MIX ASPHALT SURFACE COURSE, IL-9.5, MIX "D", N70	TON	8113	3418	4695
40800029	BITUMINOUS MATERIALS (TACK COAT)	POUND	1488	953	535
40800050	INCIDENTAL HOT-MIX ASPHALT SURFACING	TON	262	170	92
42000405	PORTLAND CEMENT CONCRETE PAVEMENT 9 1/4"	SQ YD	1120	1120	

MODEL: Default

 USER NAME
 = challandeske
 DESIGNED
 REVISED

 DRAWN
 REVISED

 PLOT SCALE
 = 100.0000 ' / in.
 CHECKED
 REVISED

 PLOT DATE
 = 12/11/2020
 DATE
 REVISED

STATE OF ILLINOIS
DEPARTMENT OF TRANSPORTATION

CONSTRUCTION CODE

SUMMARY OF QUANTITIES	F.A.P RTE	SECTION	COUNTY	TOTAL SHEETS	SHEET NO.
	604	(101,102)RS-4	MADISON	40	3
			CONTRACT	NO. 76	M84
SCALE: NONE   SHEET 1 OF 7 SHEETS STA. TO STA.		ILLINOIS FE	ED. AID PROJECT		

				0011011100	
				ROADWAY	ROADWAY
CODE			TOTAL	0005	0005
1	I.T.				
NO.	ITEM	UNIT	QUANTITY	URBAN	RURAL
44000100	PAVEMENT REMOVAL	SQ YD	1120	1120	
44000153	HOT-MIX ASPHALT SURFACE REMOVAL, 1"	SQ YD	1570	1556	14
44000158	HOT-MIX ASPHALT SURFACE REMOVAL, 2 1/4"	SQ YD	96023	40137	55886
44000169	HOT-MIX ASPHALT SURFACE REMOVAL, 5"	SQ YD	538	538	
44000200	DRIVEWAY PAVEMENT REMOVAL	SQ YD	393	185	208
44004250	PAVED SHOULDER REMOVAL	SQ YD	67	67	
44200180	PAVEMENT PATCHING, TYPE II, 15 INCH	SQ YD	183	89	94
44200184	PAVEMENT PATCHING, TYPE III, 15 INCH	SQ YD	200	108	92
44200186	PAVEMENT PATCHING, TYPE IV, 15 INCH	SQ YD	261	77	184
44200208	PAVEMENT PATCHING, TYPE II, 18 INCH	SQ YD	16		16
44200211	PAVEMENT PATCHING, TYPE IV, 18 INCH	SQ YD	522	123	399
44201839	CLASS D PATCHES, TYPE II, 16 INCH	SQ YD	10		10
44300200	STRIP REFLECTIVE CRACK CONTROL TREATMENT	FOOT	71350	29436	41914
48101200	AGGREGATE SHOULDERS, TYPE B	TON	54	42	12

MODEL: Default

STATE OF ILLINOIS
DEPARTMENT OF TRANSPORTATION

SCALE: NONE

CONSTRUCTION CODE

SUMMARY OF	F.A.P RTE	SECTION		COUNTY	TOTAL SHEETS	SHEET NO.		
				(101,102)RS-4		MADISON	40	4
						CONTRACT	Γ NO. 76	5M84
SHEET 2 OF 7 SH	ETS STA.	TO STA.		ILLINOIS	EED. A	ID PROJECT		

#### \* SPECIALTY ITEM

USER NAME = challandeske	DESIGNED -	REVISED -
	DRAWN -	REVISED -
PLOT SCALE = 100.0000 ' / in.	CHECKED -	REVISED -
PLOT DATE = 12/11/2020	DATE -	REVISED -

STATE OF ILLINOIS
DEPARTMENT OF TRANSPORTATION

CONSTRUCTION CODE

SUMMARY OF QUANTITIES	F.A.P RTE	SECTION	COUNTY	TOTAL SHEETS	SHEET NO.
	604	(101,102)RS-4	MADISON	40	5
			CONTRACT	NO. 76	5M84
SCALE: NONE   SHEET 3 OF 7 SHEETS STA. TO STA.		ILLINOIS FE	D. AID PROJECT		

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CODE	LTEM	IIII	TOTAL	ROADWAY 0005	ROADWAY 0005
NO.	ITEM	UNIT	QUANTITY	URBAN	RURAL
66901006	REGULATED SUBSTANCES MONITORING	CAL DA	2	2	
67000400	ENGINEER'S FIELD OFFICE, TYPE A	CAL MO	9	3.5	5.5
67100100	MOBILIZATION	L SUM	1	0.4	0.6
					1
70100450	TRAFFIC CONTROL AND PROTECTION, STANDARD 701201	L SUM	1	0.4	0.6
70100455	TRAFFIC CONTROL AND PROTECTION, STANDARD 701206	L SUM	1	0.4	0.6
70100460	TRAFFIC CONTROL AND PROTECTION, STANDARD 701306	L SUM	1	0.4	0.6
70100500	TRAFFIC CONTROL AND PROTECTION, STANDARD 701326	L SUM	1	0.4	0.6
70100600	TRAFFIC CONTROL AND PROTECTION, STANDARD 701336	L SUM	1	0.4	0.6
70102620	TRAFFIC CONTROL AND PROTECTION, STANDARD 701501	L SUM	1	1	
70102635	TRAFFIC CONTROL AND PROTECTION, STANDARD 701701	L SUM	1	1	
70103815	TRAFFIC CONTROL SURVEILLANCE	CAL DA	20	20	
70106700	TEMPORARY RUMBLE STRIPS	EACH	12	12	
70.05.					
70107004	PAVEMENT MARKING BLACKOUT TAPE, 4"	FOOT	7662	7662	
70107008	PAVEMENT MARKING BLACKOUT TAPE, 8"	FOOT	470	470	
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### \* SPECIALTY ITEM

USER NAME = challandeske	DESIGNED -	REVISED -
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PLOT SCALE = 100.0000 ' / in.	CHECKED -	REVISED -
PLOT DATE = 12/11/2020	DATE -	REVISED -

	SI	JMMARY	OF QU	ANTITIES		F.A.P RTE	SECTION	COUNTY	TOTAL SHEETS	SHEET NO.
						604	(101,102)RS-4	MADISON	40	6
								CONTRACT	NO. 70	5M84
SCALE: NONE	SHEET 4	OF 7	SHEETS	STA.	TO STA.		ILLINOIS FE	ED. AID PROJECT		

#### \* SPECIALTY ITEM

USER NAME = challandeske	DESIGNED -	REVISED -	
	DRAWN -	REVISED -	
PLOT SCALE = 100.0000 ' / in.	CHECKED -	REVISED -	
PLOT DATE = 12/11/2020	DATE -	REVISED -	

CONSTRUCTION CODE

SUMMARY OF QUANTITIES	F.A.P RTE	SECT	ПОИ		COUNTY	TOTAL SHEETS	SHEET NO.	
	604	(101,10	02)RS-4		MADISON	40	7	
					CONTRACT	Γ NO. 70	6M84	
SCALE: NONE SHEET 5 OF 7 SHEETS STA. TO STA.			ILLINOIS	FED. Al	D PROJECT			

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	CODE NO .	ITEM	UNIT	TOTAL QUANTITY	ROADWAY 0005 URBAN	ROADWAY 0005 RURAL
k _	78000650	THERMOPLASTIC PAVEMENT MARKING - LINE 24"	FOOT	96	96	
k	78001100	PAINT PAVEMENT MARKING - LETTERS AND SYMBOLS	SQ FT	63	63	
k 7	78001110	PAINT PAVEMENT MARKING - LINE 4"	FOOT	1024	1024	
	70001110	TAINT TAVEMENT MANKING - LINE 4	1 001	1024	1024	
k 7	78001140	PAINT PAVEMENT MARKING - LINE 8"	FOOT	127	127	
k	78001180	PAINT PAVEMENT MARKING - LINE 24"	FOOT	48	48	
k 7	78100100	RAISED REFLECTIVE PAVEMENT MARKER	EACH	989	431	558
-	78300200	RAISED REFLECTIVE PAVEMENT MARKER REMOVAL	EACH	989	431	558
<b>k</b> 8	80300100	LOCATING UNDERGROUND CABLE	FOOT	50	50	
k 8	88600600	DETECTOR LOOP REPLACEMENT	FOOT	944	944	
	X0900064	MEMBRANE WATERPROOFING SYSTEM FOR BURIED STRUCTURES	SQ YD	5.5	5.5	
			,			
>	X7010200	TRAFFIC CONTROL AND PROTECTION, STANDARD 701316 (SPECIAL)	EACH	1	1	
>	X7016500	TEMPORARY BRIDGE TRAFFIC SIGNALS (SPECIAL)	EACH	1	1	
>	X7030005	TEMPORARY PAVEMENT MARKING REMOVAL	SQ FT	35591	15183	20408
	Z0012754	STRUCTURAL REPAIR OF CONCRETE (DEPTH EQUAL TO OR LESS THAN 5 INCHES)	SQ FT	12		12

#### **★** SPECIALTY ITEM

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						F.A.P RTE	SEC.	TION		COUNTY	TOTAL SHEETS	SHEET NO.	
						604	(101,1	02)RS-4		MADISON	40	8	
											CONTRACT	NO. 76	5M84
	SCALE: NONE	SHEET 6	OF 7	SHEETS	STA.	TO STA.			ILLINOIS	FED. A	ID PROJECT		

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	CODE			I TOTAL	ROADWAY	ROADWAY
	CODE			TOTAL	0005	0005
	NO .	ITEM	UNIT	QUANTITY	URBAN	RURAL
	70022700	LONGITUDINAL JOINT SEALANT	FOOT	35675	14718	20957
	20033700	LONGITODINAL JOINT SEALANT	FOOT	55075	14/10	20937
	70004405	MATERIAL TRANSFER REVICE	TON	1.4650	6660	7000
	20034105	MATERIAL TRANSFER DEVICE	TON	14652	6660	7992
٨	70076600					
Ø	Z0076600	TRAINEES	HOUR	2000	2000	
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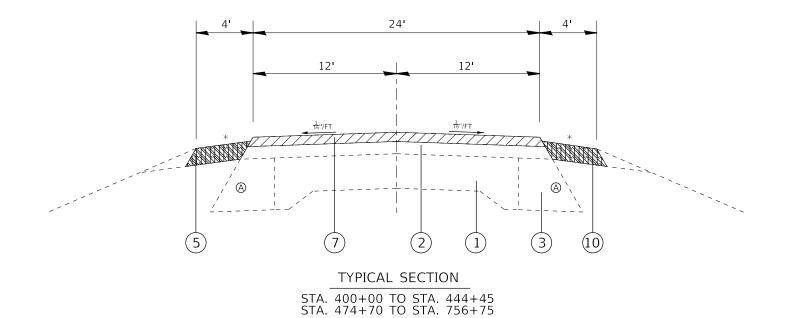
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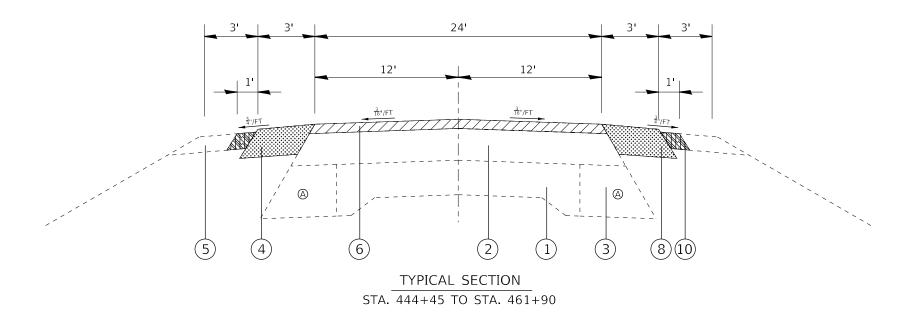
REV. - MS

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= 12/11/2020	DATE -	REVISED -
	= 100.0000 ' / in.	DRAWN - = 100.0000 ' / in. CHECKED -

CONSTRUCTION CODE

						RTE.	SECTION		COUNTY	SHEETS	NO.
						604	(101,102)RS-4		MADISON	40	8A
									CONTRACT	NO. 76	6M84
SCALE: NONE	SHEET 7	OF 7	SHEETS	STA.	TO STA.	ILLINOIS FED. AID PROJECT					





LEGEND

- 1) EXISTING 9-7-9 CONCRETE PAVEMENT
- 2) EXISTING HMA RESURFACING VARIES 2 1/2" TO 25"
- (3) EXISTING HMA WIDENING A=11"/B=10 3/4"
- 4) EXISTING HMA SHOULDERS 8"
- 5) EXISTING AGGREGATE SHOULDER
- 6) PROPOSED HMA SURFACE REMOVAL, 2 1/4"
- 7) PROPOSED PAVEMENT REMOVAL
- 8) PROPOSED PAVED SHOULDER REMOVAL
- 9) PROPOSED EARTH EXCAVATION 12"
- (10) PROPOSED EX. AND GRADING EXISTING SHOULDERS
- (11) PROPOSED BITUMINOUS MATERIAL (TACK COAT)
- (12) PROPOSED HMA BINDER COURSE, IL-9.5FG, N70, 1 1/4"
- (13) PROPOSED HMA SURFACE COURSE, IL-9.5, MIX "D", N70, 1 1/2"
- (14) PROPOSED FULL DEPTH HMA SHOULDER W/ RUMBLE STRIPS, 8".
- (15) PROPOSED HMA SHOULDER W/ RUMBLE STRIPS
- (16) PROPOSED AGGREGATE SHOULDER WEDGE, TYPE B
- (17) PROPOSED AGGREGATE SHOULDER, TYPE B
- (18) PROPOSED STRIP REFLECTIVE CRACK CONTROL
- (19) PROPOSED LONGITUDINAL JOINT SEALANT
- (20) PROPOSED PCC PAVEMENT 9 1/4"
- (21) PROPOSED STABILIZED SUBBASE 4"
- (22) PROPOSED SUBBASE GRANULAR MATERIAL, TY A 4 3/4"
- (23) PROPOSED AGGREGATE SUBGRADE IMPROVEMENT 12"

HMA SURFACE REMOVAL



PAVED SHOULDER REMOVAL



EX. AND GRADING EXISTING SHOULDERS


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	DRAWN -	REVISED -
PLOT SCALE = 40.0000 / in.	CHECKED -	REVISED -
PLOT DATE = 11/30/2020	DATE -	REVISED -

STATE OF ILLINOIS **DEPARTMENT OF TRANSPORTATION** 

**EXISTING TYPICALS** (101,102)RS-4 CONTRACT NO. 76M84 SCALE: NO SCALE SHEET 1 OF 4 SHEETS STA.



TYPICAL SECTION

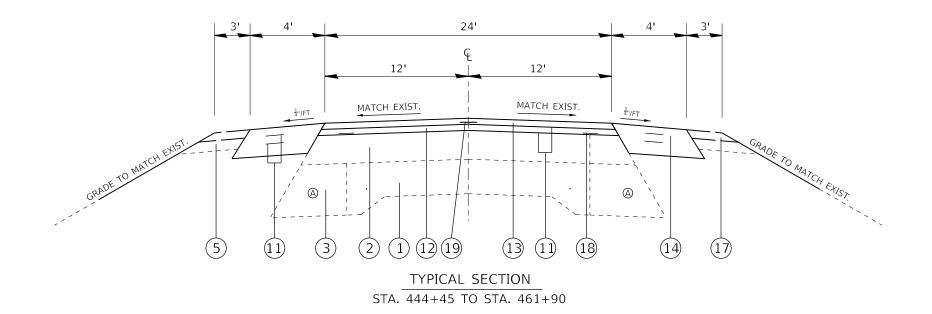


#### LEGEND

- (1) EXISTING 9-7-9 CONCRETE PAVEMENT
- (2) EXISTING HMA RESURFACING VARIES 2 1/2" TO 25"
- (3) EXISTING HMA WIDENING A=11"/B=10 3/4"
- (4) EXISTING HMA SHOULDERS 8"
- 5) EXISTING AGGREGATE SHOULDER
- 6) PROPOSED HMA SURFACE REMOVAL, 2 1/4"
- 7) PROPOSED PAVEMENT REMOVAL
- (8) PROPOSED PAVED SHOULDER REMOVAL
- (9) PROPOSED EARTH EXCAVATION 12"
- (10) PROPOSED EX. AND GRADING EXISTING SHOULDERS
- (11) PROPOSED BITUMINOUS MATERIAL (TACK COAT)
- (12) PROPOSED HMA BINDER COURSE, IL-9.5FG, N70, 1 1/4"
- (13) PROPOSED HMA SURFACE COURSE, IL-9.5, MIX "D", N70, 1 1/2"
- (14) PROPOSED FULL DEPTH HMA SHOULDER W/ RUMBLE STRIPS, 8"
- (15) PROPOSED HMA SHOULDER W/ RUMBLE STRIPS
- (16) PROPOSED AGGREGATE SHOULDER WEDGE, TYPE B
- (17) PROPOSED AGGREGATE SHOULDER, TYPE B
- (18) PROPOSED STRIP REFLECTIVE CRACK CONTROL
- (19) PROPOSED LONGITUDINAL JOINT SEALANT
- (20) PROPOSED PCC PAVEMENT 9 1/4"
- (21) PROPOSED STABILIZED SUBBASE 4"
- (22) PROPOSED SUBBASE GRANULAR MATERIAL, TY A 4 3/4"
- (23) PROPOSED AGGREGATE SUBGRADE IMPROVEMENT 12"


DESIGNED -REVISED DRAWN REVISED HECKED REVISED LOT DATE = 11/30/2020

STATE OF ILLINOIS **DEPARTMENT OF TRANSPORTATION** 

SECTION PROPOSED TYPICALS 604 (101,102)RS-4 MADISON 40 10 CONTRACT NO. 76M84 SCALE: NO SCALE SHEET 2 OF 4 SHEETS STA. TO STA.

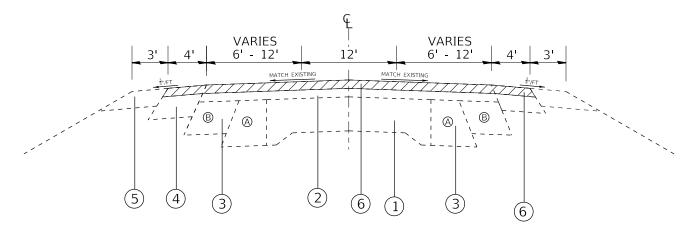

EXISTING TYPICAL SECTION STA. 461+90 TO STA. 466+90 STA. 469+70 TO STA. 474+70

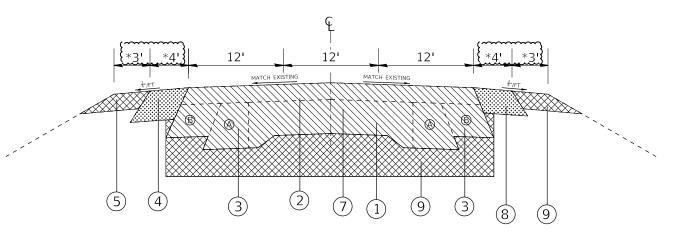

EXISTING TYPICAL SECTION STA. 466+90 TO STA. 469+70



PAVEMENT REMOVAL



HMA SURFACE REMOVAL



PAVED SHOULDER REMOVAL



EARTH EXCAVATION

USER NAME = manntm	DESIGNED -	REVISED -
	DRAWN -	REVISED -
PLOT SCALE = 40.0000 / in.	CHECKED -	REVISED -
PLOT DATE = 1/12/2021	DATE -	REVISED -

STATE OF ILLINOIS
DEPARTMENT OF TRANSPORTATION

PAVEMENT RECONSTRUCTION
TYPICALS AT IL 159/MORO


SCALE: NO SCALE SHEET 1 OF 2 SHEETS STA.

LEGEND

- (1) EXISTING 9-7-9 CONCRETE PAVEMENT
- (2) EXISTING HMA RESURFACING VARIES 2 1/2" TO 25"
- (3) EXISTING HMA WIDENING A=11"/B=10 3/4"
- (4) EXISTING HMA SHOULDERS 8"
- (5) EXISTING AGGREGATE SHOULDER
- (6) PROPOSED HMA SURFACE REMOVAL, 2 1/4"
- (7) PROPOSED PAVEMENT REMOVAL
- (8) PROPOSED PAVED SHOULDER REMOVAL
- (9) PROPOSED EARTH EXCAVATION 12"
- (10) PROPOSED EX. AND GRADING EXISTING SHOULDERS
- (11) PROPOSED BITUMINOUS MATERIAL (TACK COAT)
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- (20) PROPOSED PCC PAVEMENT 9 1/4"
- (21) PROPOSED STABILIZED SUBBASE 4"
- (22) PROPOSED SUBBASE GRANULAR MATERIAL, TY A 4 3/4"
- (23) PROPOSED AGGREGATE SUBGRADE IMPROVEMENT 12"

\*EXISTING SHOULDER WIDTH IS 7' HMA IN THE RADIUS RETURN

EXISTING TYPICAL SECTION STA. 461+90 TO STA. 466+90 STA. 469+70 TO STA. 474+70

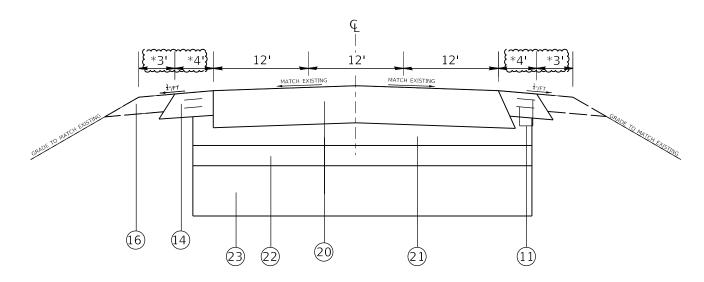

PROPOSD TYPICAL SECTION STA. 466+90 TO STA. 469+70

#### LEGEND

- 1) EXISTING 9-7-9 CONCRETE PAVEMENT
- 2) EXISTING HMA RESURFACING VARIES 2 1/2" TO 25"
- (3) EXISTING HMA WIDENING A=11"/B=10 3/4"
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- 5) EXISTING AGGREGATE SHOULDER
- 6) PROPOSED HMA SURFACE REMOVAL, 2 1/4"
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- 8) PROPOSED PAVED SHOULDER REMOVAL
- 9) PROPOSED EARTH EXCAVATION 12"
- (10) PROPOSED EX. AND GRADING EXISTING SHOULDERS
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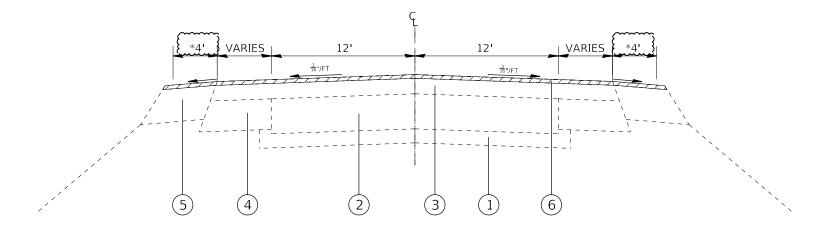
\*PROPOSED SHOULDER WIDTH IS 7' HMA IN THE RADIUS RETURN

DESIGNED -REVISED DRAWN REVISED LOT SCALE = 40.0000 ' / in. HECKED REVISED


STATE OF ILLINOIS **DEPARTMENT OF TRANSPORTATION** 

PAVEMENT RECONSTRUCTION TYPICALS AT IL 159/MORO SCALE: NO SCALE SHEET 1 OF 2 SHEETS STA.

SECTION (101,102)RS-4 CONTRACT NO. 76M84



EXISTING TYPICAL SECTION MORO ROAD

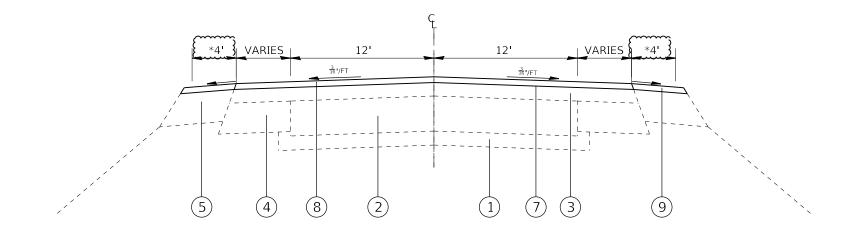

EXISTING TYPICAL SECTION MORO ROAD

#### LEGEND

- (1) EXISTING SUBBASE-4"
- 2 EXISTING 9-6-9 CONCRETE PAVEMENT
- (3) EXISTING HMA RESURFACING 5 1/2"
- (4) EXISTING HMA WIDENING 11"
- (5) EXISTING HMA SHOULDERS 8"
- (6) PROPOSED HMA SURFACE REMOVAL, 1"
- (7) PROPOSED BITUMINOUS MATERIAL (TACK COAT)
- (8) PROPOSED HMA SURFACE COURSE, IL-9.5, MIX "D", N70, 1 1/2"
- (9) PROPOSED HMA SHOULDER W/ RUMBLE STRIPS
  - \*SHOULDER IS 7' HMA IN THE RADIUS RETURN
  - \*PROPOSED SHOULDER WIDTH IS 7' HMA IN THE RADIUS RETURN

USER NAME = manntm	DESIGNED -	REVISED -	
	DRAWN -	REVISED -	
PLOT SCALE = 40.0000 ' / in.	CHECKED -	REVISED -	
PLOT DATE = 1/12/2021	DATE -	REVISED -	

STATE	E 01	FILLINOIS
DEPARTMENT	0F	<b>TRANSPORTATION</b>

		OSED T	YPICALS	F.A.P RTE	SECT	ION		COUNTY		SHEET NO.		
						604	(101,10	2)RS-4		MADISON	40	13
										CONTRACT	NO. 76	5M84
O SCALE	SHEET 2	OF 4	SHEETS	STA.	TO STA.	ILLINOIS FED. AID PROJECT						

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MODEL: \$MODELNAME\$

#### MAINLINE PAVEMENT SCHEDULE

			HMA	НМА		HMA	STRIP	1	
1.0	CATI	ON	SURFACE	BINDER	BITUMINOUS	SURFACE	REFLECTIVE	LONGITUDINAL	
LC	CATI	ON	REMOVAL,	COURSE,	MATERIAL	COURSE, IL-9.5,	CRACK CONTROL	JOINT	COMMENT
			2 1/4"	IL-9.5FG, N70	(TACK COAT)	MIX "D", N70	TREATMENT	SEALANT	
STA.	ТО	STA.	SQ YD	TON	POUND	TON	FOOT	FOOT	
400+00	ТО	430+98	8261.3	578.3	5576.4	694.0	6196	3098	OAK DRIVE
430+98	ТО	468+31	9954.7	696.8	6719.4	836.2	7466	3733	MORO ROAD
468+31	ТО	497+81	7866.7	550.7	5310.0	660.8	5900	2950	HIGH STREET
497+81	ТО	501+34	941.3	65.9	635.4	79.1	706	353	MIDWAY DRIVE
501+34	ТО	521+18	5290.7	370.3	3571.2	444.4	3968	1984	UNTERBRINK RD
521+18	ТО	547+18	6933.3	485.3	4680.0	582.4	5200	2600	YORKVILLE RD
547+18	ТО	564+90	4725.3	330.8	3189.6	396.9	3544	1772	SAWMILL RUN
564+90	ТО	599+79	9304.0	651.3	6280.2	781.5	6978	3489	RENKEN RD
599+79	ТО	611+78	3197.3	223.8	2158.2	268.6	2398	1199	MAPLE DRR
611+78	ТО	615+07	877.3	61.4	592.2	73.7	658	329	PROJECT DR
615+07	ТО	625+48	2776.0	194.3	1873.8	233.2	2082	1041	MAPLE DRR
625+48	ТО	653+08	7360.0	515.2	4968.0	618.2	5520	2760	SEILER RD
653+08	ТО	717+59	17202.7	1204.2	11611.8	1445.0	12902	6451	N DEER PARK RD
717+59	ТО	756+75	10442.7	731.0	7048.8	877.2	7832	3916	STIEGLITZ RD
-	TOTAL	:	95133.3	6659.3	64215.0	7991.2	71350.0	35675.0	
ROUNE	DED T	OTAL:	95134	6660	64215	7992	71350	35675	

STATION 466+90 TO STATION 469+70 NOT INCLUDED IN THIS SCHEDULE. SEE PAVEMENT RECONSTRUCTION SCHEDULE FOR THOSE QUANTITIES.

#### APPLICATION RATES

<u>THICKNESS</u>

BINDER = 1.25 INCHES
SURFACE COURSE = 1.50 INCHES

		PIPE CULVERT REMO	OVAL AND REPLACEMENT			
CLASS D PAVT	EARTH	PIPE CULVERT	18" CONCRETE	TRENCH	FURNISHED	CULVERT END
PATCHES, TY II - 16"	EXCAVATION	REMOVAL	CULVERT, CL3, TY2	BACKFILL	EXCAVATION	SECTIONS
SQ YD	CUY	FT	FT	CUY	CUY	EACH
9.8	10.2	48	48	1.7	4.3	2

#### IL159/MORO ROAD STAGE CONSTRUCTION SHOULDER WORK

				HMA SURFACE	HMA SURF. CSE.,	
				REMOVAL - 4"	IL-9.5, MIX D, N70	
LT/RT	STATION	ТО	STATION	SQ YD	TON	COMMENT
ΙT	466+89.00	TO	467+05.00	8.9	2.0	II 159
RT	466+89.00	TO	467+43.00	30.0	6.7	IL 159
RT	238+38.25	ТО	239+59.75	108.1	24.2	MORO RD
LT	238+38.25	ТО	239+60.00	97.3	21.8	MORO RD
LT	469+16.50	ТО	469+72.00	30.8	6.9	IL 159
RT	469+32.00	ТО	469+72.00	22.2	5.0	IL 159
LT	239+96.50	ТО	241+20.00	161.3	36.1	MORO RD
RT	239+96.50	ТО	241+20.00	78.9	17.7	MORO RD
	SUB - TO	OTAL		537.6	120.4	
	ROUNDED	TOTAL		538	121	

USER NAME = challandeske	DESIGNED -	REVISED -	
	DRAWN -	REVISED -	
PLOT SCALE = 100.0000 / in.	CHECKED -	REVISED -	
PLOT DATE = 12/11/2020	DATE -	REVISED -	

SCHEDULES								F.A.P SECTION		COUNTY	TOTAL SHEETS	
				604	(101,102)RS-4		MADISON	40	14			
										CONTRACT	NO. 76	5M84
SCALE: NA	SHEET :		F 9	SHEETS	STA.	TO STA.	ILLINOIS FED. AID PROJECT					

#### SHOULDER SCHEDULE

STA. TO 400+00 TO 431+38 TO 440+45 TO 469+16 TO 474+70 TO	STA. 431+38 440+45 469+16 474+70 498+07	REMOV ML -2 1/4" SQ YD	SR - 1" SQ YD 13.3 0.0 123.2	HMA SHOULDER 8" SQ YD 2753.8 806.2	RUMBLE STRIPS - 8" FT 6276.0	& GRADING EX SHLDRS UNIT 62.0	SHOU ML TON	LDER SR TON	BIT MAT'L (TACK COAT) POUND	SHOULDER, TYPE B TON	SHOULDER TYPE B TON	SIDEROAD
400+00 TO 431+38 TO 440+45 TO 469+16 TO	431+38 440+45 469+16 474+70	SQ YD	SQ YD 13.3 0.0	SQ YD 2753.8	FT 6276.0	UNIT	l		1 ' '		1	SIDEROAD
400+00 TO 431+38 TO 440+45 TO 469+16 TO	431+38 440+45 469+16 474+70		13.3	2753.8	6276.0		TON	TON	POUND	TON	TON	
431+38 TO 440+45 TO 469+16 TO	440+45 469+16 474+70	444.4	0.0			62.0						1
440+45 TO 469+16 TO	469+16 474+70	444.4		806.2	10110			1.1	2484.4	602.4	0.9	OAK DRIVE
469+16 TO	474+70	444.4	123.2		1814.0	18.1		0.0	725.6	176.4	0.0	
		444.4		0.0	6019.3	46.8		10.4	55.5	503.3	16.5	MORO DRIVE
474+70 TO	498+07		113.4	0.0	1363.1	6.1	68.4	9.5	251.0	107.7	0.0	
		444.4	0.0	2054.2	4622.0	46.2	68.4	0.0	2048.8	449.3	1.3	HIGH STREET
498+07 TO	501+66		0.0	290.7	654.0	6.5		0.0	261.6	63.6	1.3	MIDWAY DRIVE
501+66 TO	521+18		0.0	1735.1	3904.0	39.0		0.0	1561.6	379.5	1.3	UNTERBRINK RD
521+18 TO	547+56		0.0	2311.6	5201.0	52.0		0.0	2080.4	505.6	2.0	YORKVILLE RD
547+56 TO	564+90		0.0	1541.3	3468.0	34.7		0.0	1387.2	337.1	0.0	SAWMILL RUN
564+90 TO	600+33		0.0	3057.3	6879.0	68.8		0.0	2751.6	668.8	2.0	RENKEN RD
600+33 TO	612+04		0.0	1017.8	2290.0	22.9		0.0	916.0	222.6	1.3	MAPLE DR
612+04 TO	615+34		0.0	269.3	606.0	6.1		0.0	242.4	58.9	1.3	PROJECT DRIVE
615+34 TO	625+76		0.0	901.8	2029.0	20.3		0.0	811.6	197.3	1.3	MAPLE DR
625+76 TO	653+38		13.3	2374.2	5342.0	53.4		1.1	2142.8	519.3	2.0	SEILER RD
653+38 TO	717+93		0.0	5708.0	12843.0	128.4		0.0	5137.2	1248.6	2.0	N DEER PARK RD
717+93 TO	740+46		0.0	1968.4	4429.0	44.3		0.0	1771.6	430.6	2.0	STIEGLITZ RD
740+46 TO	756+75		0.0	1448.0	3258.0	32.6		0.0	1303.2	316.7	0.0	
SUB TOTA	.L :	888.9	263.2	28237.8	70997.3	688.2	136.9	22.1	25932.4	6787.7	35.2	ĺ
TOTAL:		889	264	28238	70998	689	15	5 9	25933	6788	36	

#### **APPLICATION RATES:**

BITUMINOUS: 0.056 TONS/SQ YD/IN

AGGREGATE: 0.05833 TONS/SQ YD/IN

(1st Pass)TACK COAT : 0.05 LBS/SQ FT

(2nd Pass)TACK COAT : 0.025 LBS/SQ FT

#### THICKNESS:

MAINLINE (ML) HMA: 2.75"

SIDEROAD (SR) HMA: 1.25"

MAINLINE (ML) = 2.75"

SIDEROAD (SR) = 1.25"

AGGREGATE WEDGE: 6.00"

AGGREGATE: 2.75"

#### PAVEMENT PATCHING 18" SCHEDULE

				FAVLIVILI	II PAICHING	19 SCHEDOLE			
			LENGTH	WIDTH	QUANTITY	TYPE I	TYPE II	TYPE III	TYPE IV
STAT	IONING	NB/SB	(FT)	(FT)	(SQ YDS)	(SQ YDS)	(SQ YDS)	(SQ YDS)	(SQ YDS)
STA.	468+64	SB	80	12	106.7				106.7
STA.	700+96	SB	5	12	6.7		6.7		
STA.	727+36	SB	20	12	26.7				26.7
STA.	743+20	SB	20	12	26.7				26.7
STA.	700+96	NB	5	12	6.7		6.7		
STA.	709+94	NB	200	6	133.3				133.3
STA.	732+64	NB	40	6	26.7				26.7
STA.	740+56	NB	200	6	133.3				133.3
		S	UBTOTALS:		0.0	13.3	0.0	453.3	
	#15% ADD	OITION FO	DR WINTER [	DETERIORAT	0	2.0	0.0	68.0	
		ROU	NDED TOTAL	_S:	0	16	0	522	

 USER NAME
 = challandeske
 DESIGNED REVISED 

 DRAWN REVISED 

 PLOT SCALE
 = 100,0000 '/ in.
 CHECKED REVISED 

 PLOT DATE
 = 12/11/2020
 DATE REVISED

STATE OF ILLINOIS
DEPARTMENT OF TRANSPORTATION

#### PAVEMENT PATCHING 15" SCHEDULE

			LENGTH	WIDTH	QUANTITY	TYPE I	TYPE II	TYPE III	TYPE IV
STAT	IONING	NB/SB	(FT)	(FT)	(SQ YDS)	(SQ YDS)	(SQ YDS)	(SQ YDS)	(SQ YDS)
STA.	400+00								
STA.	410+56	SB	6	12	8.0		8.0		
STA.	415+84	SB	4	12	5.3		5.3		
STA.	426+40	SB	4	12	5.3		5.3		
STA.	429+56	SB	4	12	5.3		5.3		
STA.	429+57	SB	30	12	40.0				40.0
STA.	436+96	SB	14	12	18.7			18.7	
STA.	437+49	SB	4	12	5.3		5.3		
STA.	438+02	SB	10	12	13.3		13.3		
STA.	438+54	SB	4	12	5.3		5.3		
STA.	505+60	SB	13	12	17.3			17.3	
STA.	527+25	SB	20	12	26.7				26.7
STA.	563+68	SB	15	12	20.0			20.0	
STA.	564+21	SB	4	12	5.3		5.3		
STA.	568+96	SB	5	12	6.7		6.7		
STA.	574+24	SB	5	12	6.7		6.7		
STA.	574+77	SB	8	12	10.7		10.7		
STA.	595+36	SB	70	12	93.3				93.3
STA.	632+32	SB	7	12	9.3		9.3		
STA.	632+85	SB	4	12	5.3		5.3		
STA.	410+56	NB	6	12	8.0		8.0		
STA.	415+84	NB	4	12	5.3		5.3		
STA.	426+40	NB	4	12	5.3		5.3		
STA.	431+68	NB	4	12	5.3		5.3		
STA.	438+54	NB	4	12	5.3		5.3		
STA.	505+60	NB	13	12	17.3			17.3	
STA.	526+72	NB	30	6	20.0			20.0	
STA.	527+25	NB	15	12	20.0			20.0	
STA.	563+68	NB	15	12	20.0			20.0	
STA.	564+21	NB	4	12	5.3		5.3		
STA.	568+96	NB	5	12	6.7		6.7		
STA.	574+24	NB	5	12	6.7		6.7		
STA.	574+77	NB	8	12	10.7		10.7		
STA.	614+90	NB	30	6	20.0			20.0	
STA.	632+32	NB	6	12	8.0		8.0		
STA.	641+83	NB	30	6	20.0			20.0	
STA.	695+68	NB	100	6	66.7				66.7
		S	UBTOTALS:			0.0	158.7	173.3	226.7
	#15% ADD	ITION FO	DR WINTER D	DETERIORAT	ION:	0.0	23.8	26.0	34.0
			TOTALS:			0	183	200	261

USER NAME = challandeske	DESIGNED -	REVISED -
	DRAWN -	REVISED -
PLOT SCALE = 100.0000 ' / in.	CHECKED -	REVISED -
PLOT DATE = 12/11/2020	DATE -	REVISED -

	F.A.P RTE. SECTION			COUNTY	TOTAL SHEETS	SHEET NO.					
						604	(101,102)RS-4		MADISON	40	16
				CONTRACT	NO. 76	5M84					
SCALE: NA	SHEET 3	OF 9	SHEETS	STA.	TO STA.	ILLINOIS FED. AID PROJECT					

#### PAVEMENT MARKING SCHEDULE

			THER	MOPLASTIC P	AVEMENT MAR	KING	TEMPORARY	SHORT TERM	SHORT TERM			
CTA-	TIONI	NC	&	TEMPORARY PA	AVEMENT MARK	ING	PAVEMENT	PAVEMENT	PAVEMENT		RRPM	
STA	TIONI	NG	4" YELLOW	4" YELLOW	4" WHITE	12" WHITE	MARKING	MARKING	MARKING	RRPM	TWO-WAY	COMMENT
			SKIP DASH	SOLID	SOLID	SOLID	REMOVAL	(3 LIFTS)	REMOVAL	REMOVAL	AMBER	
STA.	ТО	STA.	FOOT	FOOT	FOOT	FOOT	SQ FT	FOOT	SQ FT	EACH	EACH	
400+00	ТО	453+86	1347		10772		4040	1469	163	135	135	PZ
453+86	ТО	461+11	181	725	1450		785	198	22	18	18	NPZ NB
461+11	ТО	462+31		240	240		160	33	4	3	3	NPZ
462+31	ТО	475+11			SEE IL 1	59/MORO RD FOR	INTERSECTION P.	AVEMENT MARKING	G DETAILS		-	Gap for IL 159/Moro Rd
475+11	ТО	476+11		200	200		133	27	3	3	3	NPZ
476+11	ТО	481+11	125	500	1000		542	136	15	13	13	N PZ SB
481+11	ТО	486+81	143		1140		428	155	17	14	14	PZ
486+81	то	495+51	218	870	1740		943	237	26	22	22	NPZ NB
495+51	ТО	497+41	48		380		143	52	6	5	5	PZ
497+41	ТО	506+66	231	925	1850		1002	252	28	23	23	N PZ SB
506+66	ТО	542+36	893		7140		2678	974	108	89	89	PZ
542+36	ТО	548+11	144	575	1150		623	157	17	14	14	NPZ NB
548+11	ТО	553+01	123		980		368	134	15	12	12	PZ
553+01	ТО	555+46	61	245	490		265	67	7	6	6	N PZ SB
555+46	ТО	558+76		660	660		440	90	10	8	8	NPZ
558+76	ТО	561+16	60	240	480		260	65	7	6	6	NPZ NB
561+16	ТО	567+31	154		1230		461	168	19	15	15	PZ
567+31	ТО	583+21	398	1590	3180		1723	434	48	40	40	N PZ SB
583+21	ТО	588+16		990	990		660	135	15	12	12	NPZ
588+16	ТО	599+31	279	1115	2230		1208	304	34	28	28	N P Z S B
599+31	ТО	628+31	725		5800	22	2197	791	88	73	73	PZ
628+31	ТО	639+91	290	1160	2320		1257	316	35	29	29	NPZ NB
639+91	ТО	642+41		500	500		333	68	8	6	6	NPZ
642+41	ТО	653+36	274	1095	2190		1186	299	33	27	27	N PZ SB
653+36	ТО	654+51		230	230		153	31	3	3	3	NPZ
654+51	ТО	664+51	250	1000	2000	30	1113	273	30	25	25	NPZ NB
664+51	ТО	665+51	25		200		75	27	3	3	3	PZ
665+51	ТО	675+76	256	1025	2050		1110	280	31	26	26	N PZ SB
675+76	ТО	750+74	1875		14996		5624	2045	227	187	187	PZ
750+74	ТО	757+49	169	675	1350		731	184	20	17	17	NPZ NB
757+49	ТО	762+09	115		920		345	125	14	12	12	PZ
762+09	ТО	768+99	173	690	1380		748	188	21	17	17	NPZ SB
768+99	ТО	771+00	50		402		151	55	6	5	5	PZ
ROUND	ED T	DTAL		95493		52	31883	9769	1085	896	896	

USER NAME = challandeske	DESIGNED -	REVISED -
	DRAWN -	REVISED -
PLOT SCALE = 100.0000 ' / in.	CHECKED -	REVISED -
PLOT DATE = 12/11/2020	DATE -	REVISED -

				SCHEDI	JLES		F.A.P RTE	SECTION	COUNTY	TOTAL SHEETS	SHEET NO.
							604	(101,102)RS-4	MADISON	40	17
									CONTRACT	NO. 76	5M84
SCALE: NA SHEET 4 OF 9 SHEETS STA. TO STA.								ILLINOIS FED	. AID PROJECT		

#### THERMOPLASTIC PAVEMENT MARKING SCHEDULE FOR IL 159/MORO ROAD

					ТНІ	FRMOPLASTIC	PAVEMENT MA	RKING			RF	RPM	TEMPORARY	SHORT TERM	SHORT TERM
	NOITATE				&	TEMPORARY	PAVEMENT MAR	KING			REMOVAL AND	INSTALLATION	PAVEMENT	PAVEMENT	PAVEMENT
1	STATION	ı	4" WHITE	4" YELLOW	4" WHITE	8" WHITE	12" YELLOW	12" WHITE	24" WHITE	LETTERS &	ONE - WAY	TWO-WAY	MARKING	MARKING	MARKING
			SKIP DASH	SOLID	SOLID	SOLID	SOLID	SOLID	SOLID	SYMBOLS	CRYSTAL	AMBER	REMOVAL	(3 LIFTS)	REMOVAL
STA.	ТО	STA.	FOOT	FOOT	FOOT	FOOT	FOOT	FOOT	FOOT	SQ FT	EACH	EACH	SQ FT	FOOT	SQ FT
461+90.00	то	466+50.00	36.0	1831.0	920.0	0.0	141.6	0.0	0.0	0.0		24.0	929.0	125.5	13.9
466+50.00	ТО	469+50.00	4.0	52.2	19.1	70.6	4.5	146.7	0.0	46.8	23.0	6.0	265.7	10.9	1.2
238+61.00	ТО	240+86.25	0.0	288.0	567.6	271.9	0.0	289.7	60.0	46.8	24.0	4.0	923.0	50.5	5.6
469+50.00	ТО	474+70.00	42.0	1919.0	959.0	0.0	129.1	0.0	0.0	31.2	1.0	25.0	1004.5	141.8	15.8
	ROUN	DED TOTAL		6638		343	7	12	60	125	79	13	3123	411	137

#### PAINT PAVEMENT MARKING SCHEDULE FOR IL 159/MORO ROAD

				PAINT	PAVEMENT MA	ARKING		TEMPORARY	SHORT TERM	SHORT TERM
	TATIC	NA I		& TEMPORA	ARY PAVEMEN	T MARKING		PAVEMENT	PAVEMENT	PAVEMENT
3	TATIC	) N	4" WHITE	4" YELLOW	8" WHITE	24" WHITE	LETTERS &	MARKING	MARK I NG	MARKING
			SOLID	SOLID	SOLID	SOLID	SYMBOLS	REMOVAL	(3 LIFTS)	REMOVAL
STA.	ТО	STA.	FOOT	FOOT	FOOT	FOOT	SQ FT	SQ FT	FOOT	SQ FT
466+90.00	ТО	469+70.00	526.0	498.0	127.0	48.0	62.4	584.4	76.4	8.5
	RO	UNDED TOTAL	10	24	127	48	63	585	77	9

#### BLACKOUT TAPE - IL 159/MORO ROAD

				·			
			PAVFMFNT	PAVFMFNT	PAVEMENT	PAVFMFNT	SHORT TERM
			MARKING	MARKING	MARK I NG	MARK I NG	PAVEMENT
			BLACKOUT	BLACKOUT	BLACKOUT	BLACKOUT	MARKING
			TAPE, 4"	TAPE, 8"	TAPE, 12"	TAPE, 24"	REMOVAL
STATION	ТО	STATION	FOOT	FOOT	FOOT	FOOT	SQ FT
461+90	ТО	466+50	2787	0	142	0	1071
466+50	ТО	469+50	899	198	152	84	752
238+61	ТО	240+86	856	272	290	60	877
469+50	ТО	474+70	3120	0	130	0	1170
		SUBTOTAL	7662	470	714	144	3869

#### PAVEMENT RECONSTRUCTION SCHEDULE AT MORO ROAD

				PCC	STABILIZED	SUBBASE	AGGREGATE	НМА	AGGREGATE		PAVED		EXCAVATING &	SHOULDER
	L	OCATIO	N	PAVEMENT	SUBBASE	GRAN. MAT'L	SUBGRADE	SHOULDER	SHOULDER	PAVEMENT	SHOULDER	EARTH	GRADING	RUMBLE
	STA. TO STA.		9 1/4"	4 INCHES	TYPE A	IMPROVEMENT	8 INCHES	TYPE B	REMOVAL	REMOVAL	EXCAVATION	EX SHOULDERS	STRIPS-8"	
S	STA.	ТО	STA.	SQ YD	SQ YD	TON	TON	SQ YD	TON	SQ YD	SQ YD	CUY	UNIT	FOOT
466-	+90.00	TO	469+70.00	1120.0	1120.0	310.3	784.0	66.6	17.5	1120.0	66.6	381.7	1.50	149.8
		ROU	JNDED TOTAL	1120.0	1120.0	311.0	784.0	67.0	18.0	1120.0	67.0	382.0	1.5	150.0

#### APPLICATION RATES

HMA = 0.056 TONS/SQ YD/IN

AGGREGATE = 0.05833 TONS/SQ/IN

(1ST PASS)TACK COAT = .050 LB/SQ FT

(2ND PASS)TACK COAT = .025 LB/SQ FT

#### **THICKNESS**

SUBBASE GRANULAR MATERIAL TYPE A = 4 3/4 IN AGGREGATE SUBEGRADE IMPROVEMENT = 12 IN

USER NAME = challandeske	DESIGNED -	REVISED -	
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PLOT DATE = 12/11/2020	DATE -	REVISED -	

				SCHEDU	LES		F.A.P RTE	SECTION	COUNTY	TOTAL SHEETS	SHEET NO.
							604	(101,102)RS-4	MADISON	40	18
									CONTRACT	NO. 76	5M84
SCALE: NA SHEET 5 OF 9 SHEETS STA. TO STA.								ILLINOIS FED. A	ID PROJECT		

#### SIDEROADS AND ENTRANCES SCHEDULE

				AGG FC	R TEMP	DR I VEWAY		INCIDENTAL	INCIDENTAL	HMA	
					ESS	PAVEMENT	HMA SURFACE	HMA	BIT. MAT'L	SURFACE REM	
				ENT		-	REM1"			l	COMMENT
			l		MBTO	REMOVAL		SURFACING	(TACK COAT)	BUTT JOINT	
STATION	LT/RT	ENT/ SR	MAT'L	TONS	TONS	SQ YD	SQ YD	TONS	POUND	SQ YD	
400+00											BEGIN PROJECT
411+50	RT	PE	AGG	0.6	1.0						
411+88	LT	FE	AGG	0.5	1.0						
415+92	LT	PE	AGG	0.6	1.0						
419+52	LT	PE	HMA		1.0	9.8		0.8	6.6		
422+04	LT	PE	HMA		1.0	8.9		0.7	6.0		
427+88	LT	PE	AGG	0.6	1.0						
429+93	LT	PE	HMA		1.0	13.3		1.1	9.0		
430+98	RT	SR	HMA					7.7	41.3	91.7	OAK DRIVE
432+87	LT	PE	HMA		1.0	25.8		2.2	17.4		
433+99	RT	PE	AGG	0.9	1.0						
436+91	RT	PE	HMA		1.0	8.9		0.7	6.0		
437+98	LT	PE	AGG	0.8	1.0						
438+80	RT	PE	AGG	0.6	1.0						
439+41	RT	PE	AGG	0.4	1.0						
439+97	RT	CE	AGG	0.8	1.0						
441+70	RT	PE	AGG	0.9	1.0						
442+30	RT	PE	HMA		1.0	14.2		1.2	9.6		
447+15	RT	CE	HMA		1.0	16.0		1.3	10.8		
449+24	RT	PE	AGG	0.8	1.0						
451+72	RT	PE	AGG	0.6	1.0						
452+34	RT	PE	AGG	0.5	1.0						
453+93	RT	FE	AGG	0.5	1.0						
454+86	RT	PE	AGG	0.7	1.0						
457+17	RT	PE	AGG	0.7	1.0						
458+09	RT	PE	AGG	0.7	1.0						
460+11	RT	PE	HMA		1.0	12.9		1.1	8.7		
461+13	RT	PE	AGG	1.1	1.0						
464+82	RT	PE	AGG	1.0	1.0						
466+13	RT	PE	AGG	1.0	1.0						
468+31	LT	SR	HMA				691.1	62.6	335.3	54.1	MORO RD
468+31	RT	SR	HMA				614.1	55.8	299.2	50.7	MORO RD
470+76	RT	CE	AGG	0.7	1.0						
484+82	RT	FE	AGG	0.5	1.0						
486+14	RT	PE	AGG	1.7	1.0						
488+07	LT	FE	AGG	0.3	1.0						
488+07	RT	PE	AGG	0.4	1.0						
489+35	RT	CE	AGG	0.7	1.0						
490+52	RT	PE	AGG	0.4	1.0						
491+77	RT	PE	AGG	0.4	1.0						
424+43	RT	PE	AGG	0.3	1.0						
493+73	RT	PE	AGG	0.4	1.0						
494+69	LT	CE	AGG	1.0	1.0						
495+65	RT	PE	HMA		1.0	5.3		0.4	3.6		
133103	1		SUBTOTAL	21.1	40.0	115.1	1305.1	135.8	753.4	196.5	

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PLOT DATE = 12/11/2020	DATE -	REVISED -

			SCHEDU	LES		F.A.P RTE	SEC <sup>-</sup>	TION	COUNTY	TOTAL SHEETS	SHEET NO.
						604	(101,10	02)RS-4	MADISON	40	19
									CONTRACT	Γ NO. 70	6M84
SCALE: NA	SHEET 6	OF '	9 SHEETS	STA.	TO STA.			ILLINOIS FED	. AID PROJECT		

#### SIDEROADS AND ENTRANCES SCHEDULE

497+81 499+95 500+10 500+26 501+20 501+34 502+30 502+55	LT/RT  RT  RT  RT  LT  RT  LT  RT	ENT / SR  SR  FE  PE  PE  PE	MAT ' L HMA AGG HMA	ENT TONS	MBTO TONS	REMOVAL SQ YD	REM1"	SURFACING	(TACK COAT)	BUTT JOINT	COMMENT
497+81 499+95 500+10 500+26 501+20 501+34 502+30 502+55	RT RT RT RT LT RT	SR FE PE PE	HMA AGG			SQ YD					
497+81 499+95 500+10 500+26 501+20 501+34 502+30 502+55	RT RT RT LT RT	FE PE PE	AGG	0.3	1.0		SQ YD	TONS	POUND	SQ YD	
499+95 500+10 500+26 501+20 501+34 502+30 502+55	RT RT LT RT	PE PE		0.3				6.0	32.3	71.7	HIGH STREET
500+10 500+26 501+20 501+34 502+30 502+55	RT LT RT	PE	HMA		1.0						
500+26 501+20 501+34 502+30 502+55	LT RT				1.0	4.9		0.4	3.3		
501+20 501+34 502+30 502+55	RT	PE	HMA		1.0	4.9		0.4	3.3		
501+34 502+30 502+55			AGG	0.8	1.0						
502+55	LT	SR	HMA					6.5	34.9	77.5	MIDWAY DRIVE
		PE	AGG	0.9	1.0						
	LT	PE	AGG	0.4	1.0						
503+48	LT	PE	AGG	0.7	1.0						
503+61	RT	CE	HMA		1.0	16.4		1.4	11.1		
504+35	RT	CE	HMA		1.0	18.2		1.5	12.3		
508+45	LT	PE	AGG	0.5	1.0						
511+85	LT	CE	AGG	1.9	1.0						
512+98	RT	PE	AGG	0.5	1.0						
514+14	RT	PE	HMA		1.0	10.9		0.9	7 . 4		
520+21	RT	PE	AGG	0.6	1.0						
521+10	RT	PE	HMA		1.0	14.2		1.2	9.6		
521+18	LT	SR	HMA					8.2	43.9	97.5	UNTERBRINK RD
521+18	RT	PE	AGG	0.8	1.0						
527+62	RT	PE	AGG	0.8	1.0						
534+13	LT	PE	AGG	0.6	1.0						
534+14	RT	FE	AGG	0.4	1.0						
537+27	LT	PE	AGG	1.0	1.0						
540+06	RT	PE	AGG	0.8	1.0						
540+46	LT	PE	AGG	1.0	1.0						
543+30	LT	FE	AGG	0.3	1.0						
547+18	RT	SR	HMA					7.8	41.6	92.5	YORKVILLE RD
547+52	LT	FE	AGG	0.9	1.0						
550+53	LT	PE	AGG	0.8	1.0						
555+77	RT	PE	AGG	0.6	1.0						
557+55	RT 	PE 	AGG	0.4	1.0						
559+05	RT	PE	HMA		1.0	5.8		0.5	3.9		
560+28	RT	PE	HMA		1.0	8.2		0.7	5 . 6		
560+42	LT	PE	AGG	1.0	1.0						
564+36	LT	PE	AGG	0.5	1.0						CAMBALL BURE
564+90	RT	PE	AGG	0.6	1.0	11 1		0.0	7 -		SAWMILL RUN*
567+42	LT	PE	HMA	0.5	1.0	11.1		0.9	7 . 5		HIDDEN LAKE DE
569+25	LT RT	PE PE	AGG	0.5	1.0						HIDDEN LAKE DR
571+23			AGG								
571+81	LT	PE	AGG AGG	0.3	1.0						
573+16	LT RT	PE PE		0.6	1.0						
575+64	RT	PE PE	AGG AGG	0.6	1.0						
575+81	RT RT	PE PE	AGG	0.4	1.0						
577+34	U.I.		SUBTOTAL	20.6	41.0	94.7	0.0	36.4	216.5	339.2	

 USER NAME
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STATE OF ILLINOIS
DEPARTMENT OF TRANSPORTATION

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#### SIDEROADS AND ENTRANCES SCHEDULE

				AGG FO	R TEMP	DR I VEWAY	1	INCIDENTAL	INCIDENTAL	HMA	
					ESS	PAVEMENT	HMA SURFACE	HMA	BIT. MAT'L	SURFACE REM	
				ENT	МВТО	REMOVAL	REM1"	SURFACING		BUTT JOINT	COMMENT
	   T / D T	ENT / CD	NAA T. I. I		l		1		(TACK COAT)		
STATION	LT/RT			TONS	TONS	SQ YD	SQ YD	TONS	POUND	SQ YD	
580+39	RT	PE	HMA		1.0	10.4		0.9	7 . 1		
580+75	LT	PE 	AGG	0.7	1.0						
581+38	LT	PE	AGG	0.4	1.0						
582+57	RT	PE	AGG	0.8	1.0						
587+71	LT	PE	HMA	0.0	1.0	9.8		0.8	6.6		
588+50	RT	PE	AGG	0.8	1.0						
589+01	LT	FE	AGG	0.4	1.0						
591+71	LT	PE	AGG	0.4	1.0						
593+08	RT	PE	AGG	0.4	1.0						
593+62	LT	FE	AGG	0.5	1.0						
595+16	RT	PE	AGG	0.5	1.0						
598+09	RT	PE	AGG	0.4	1.0			0.2	40 5	110.0	DENKEN DD
599+79	LT	SR	HMA					9.2	49.5	110.0	RENKEN RD
599+79	RT	SR	HMA	0 5	1 0			10.0	53.6	119.2	RENKEN RD
607+29	RT RT	PE SR	AGG HMA	0.5	1.0			5 . 4	28.9	64.2	MAPLE DR
611+78		PE			1.0	6.7		0.6	4.5	04.2	MAPLE DR
614+88	LT	SR	HMA HMA		1.0	6.7		6.9	36.8	81.7	PROJECT DR
615+07	RT			0.4	1 0			0.9	30.0	01.7	PROJECT DR
616+38	RT LT	PE FE	AGG EARTH	0.4	1.0						
616+80	RT	PE	AGG	0.3	1.0						
619+58	RT	PE	AGG	0.7	1.0						
620+41	LT	FE	AGG	0.7	1.0						
620+85	RT	SR	HMA	0.3	1.0			5 . 6	30.0	66.7	MAPLE DR
625+48	RT	PE	AGG	0.8	1.0			3.0	30.0	00.7	IVIATEL DIX
627+22	RT	PE	AGG	0.6	1.0						
628+88	RT	PE	AGG	1.0	1.0						PADDOCK HILLS LANE
630+37	LT	PE	AGG	1.0	1.0						TABBOOK TITLES LANE
635+90	LT	PE	AGG	1.2	1.0						
647+60	RT	PE	AGG	1.1	1.0						
651+35 653+08	LT	SR	HMA	1.1	1.0			13.4	71.6	159.2	SEILER RD
653+08	RT	SR	HMA					6.7	35.6	79.2	SEILER RD
659+30	LT	PE	AGG	0.6	1.0			V . /		73.2	JETELK NO
660+21	RT	PE	AGG	0.6	1.0						
660+21	LT	PE	AGG	0.9	1.0						
662+74	RT	PE	AGG	0.6	1.0						
666+39	RT	PE	AGG	0.3	1.0						
666+49	LT	CE	CONCRETE	<u> </u>	1.0	31.1		2.6	21.0		
668+53	RT	CE	AGG	0.9	1.0						
671+44	LT	FE	EARTH	0.3	1.0						
672+85	RT	PE	HMA		1.0	12.4		1.0	8.4		
673+21	LT	PE	HMA		1.0	12.4		1.0	8.4		
675+60	RT	PE	AGG	1.0	1.0						
678+77	RT	PE	HMA	= . 0	1.0	14.2		1.2	9 . 6		
370+77	<u> </u>		SUBTOTAL	18.9	37.0	97.1	0.0	65.3	371.6	680.0	
			- 3 3				1 2.0	55.5	2.1.0	1 220.0	<u> </u>

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			SCHEDU	LES		F.A.P RTE	SEC <sup>-</sup>	ΓΙΟΝ		COUNTY	TOTAL SHEETS	SHEET NO.
						604	(101,10	02)RS-4		MADISON	40	21
										CONTRAC	Γ NO. 70	6M84
SCALE: NA	SHEET 8	OF 9	9 SHEETS	STA.	TO STA.			ILLINOIS	FED. A	ID PROJECT		

	1	ı				DEROADS AND	J ENIKANCE			.,,,,,,,,,,,,,,,,,,,,,,,,,,,,,,,,,,,,,,	
					OR TEMP	DR I VEWAY	HMA	INCIDENTAL	INCIDENTAL	INCIDENTAL	
				ACC	ESS	PAVEMENT	SURFACE	HMA	BIT. MAT'L	BIT. MAT'L	COMMENT
				ENT	MBTO	REMOVAL	REM1"	SURFACING	(TACK COAT)	(TACK COAT)	
STATION	LT/RT	ENT/ SR	MAT ' L	TONS	TONS	SQ YD	SQ YD	TONS	POUND	POUND	
679+23	LT	CE	CONCRETE		1.0	14.2		1.2	9.6		
686+39	RT	PE	AGG	0.8	1.0						
686+39	LT	PE	AGG	1.0	1.0						
689+80	RT	PE	AGG	0.4	1.0						
692+38	RT	PE	AGG	1.3	1.0						
697+06	RT	PE	AGG	0.5	1.0						
698+87	RT	CE	HMA		1.0	14.2		1.2	9.6		
699+48	RT	CE	AGG	0.7	1.0						
700+11	RT	CE	AGG	0.4	1.0						
702+56	LT	PE	AGG	1.3	1.0						
703+08	RT	PE	AGG	0.4	1.0						
706+82	RT	FE	EARTH	0.3	1.0						
707+80	RT	PE	HMA		1.0	7 . 1		0.6	4.8		
713+21	RT	FE	EARTH	0.3	1.0						
714+76	LT	CE	AGG	0.3	1.0						
714+83	RT	CE	AGG	0.4	1.0						
717+46	LT	CE	AGG	0.3	1.0						
717+59	RT	SR	HMA					6.9	37.1	82.5	N DEER PARK DR
719+33	LT	FE	AGG	0.4	1.0						
724+89	RT	PE	HMA		1.0	21.3		1.8	14.4		
726+25	RT	CE	HMA		1.0	17.8		2.1	12.0		
726+25	LT	CE	AGG	0.4	1.0						
729+24	RT	PE	AGG	0.7	1.0						
735+34	LT	FE	AGG	0.3	1.0						
736+22	RT	PE	AGG	0.8	1.0						
738+97	LT	PE	AGG	0.5	1.0						
740+07	RT	SR	HMA		0.0			9.5	50.6	112.5	STIEGLITZ RD
740+92	RT	PE	AGG	0.8	1.0						
743+97	RT	PE	HMA		1.0	11.1		0.9	7.5		
751+63	LT	CE	AGG	1.2	1.0						
756+75											END PROJECT
	•	•	SUBTOTAL	13.8	28.0	85.8	0.0	24.1	145.7	195.0	
			TOTAL	22	0 . 4	392.7	1305.1	261.7	1487.2	1410.7	
		ROUND	ED TOTAL	22	1.0	393.0	1306.0	262.0	1488.0	1411.0	

#### <u>THICKNESS</u>

INCIDENTAL RESURFACING THICKNESS = AVG 1" FOR ENTRANCES AND 1 1/2" FOR SIDEROADS


#### APPLICATION RATES

TACK COAT = 0.05 LBS/SQ FT BITUMINOUS = .056


MBTO: MAILBOX TURNOUT

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PLOT SCALE = 100.0000 ' / in.	CHECKED -	REVISED -
PLOT DATE = 12/11/2020	DATE -	REVISED -

		SCHE	DULES			F.A.P RTE	SECTIO	N	COUNTY	TOTAL SHEETS	SHEET NO.
						604	(101,102)	RS-4	MADISON	40	22
									CONTRACT	NO. 76	6M84
SCALE: NA	SHEET 9	OF 9	SHEETS	STA.	TO STA.		ILL	LINOIS FED. AII	D PROJECT		

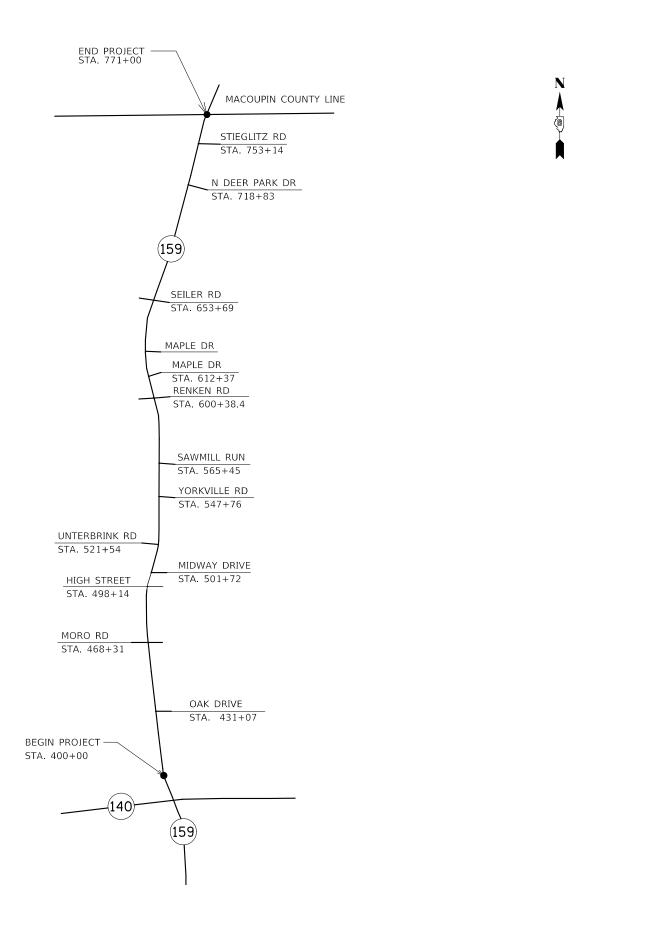

HMA BUTT JOINT DETAIL

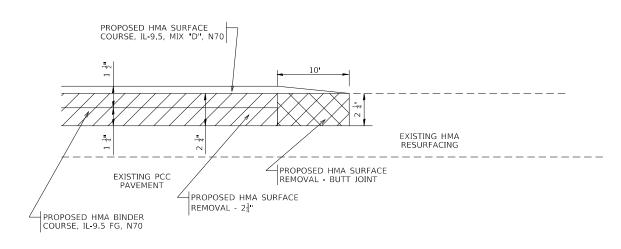


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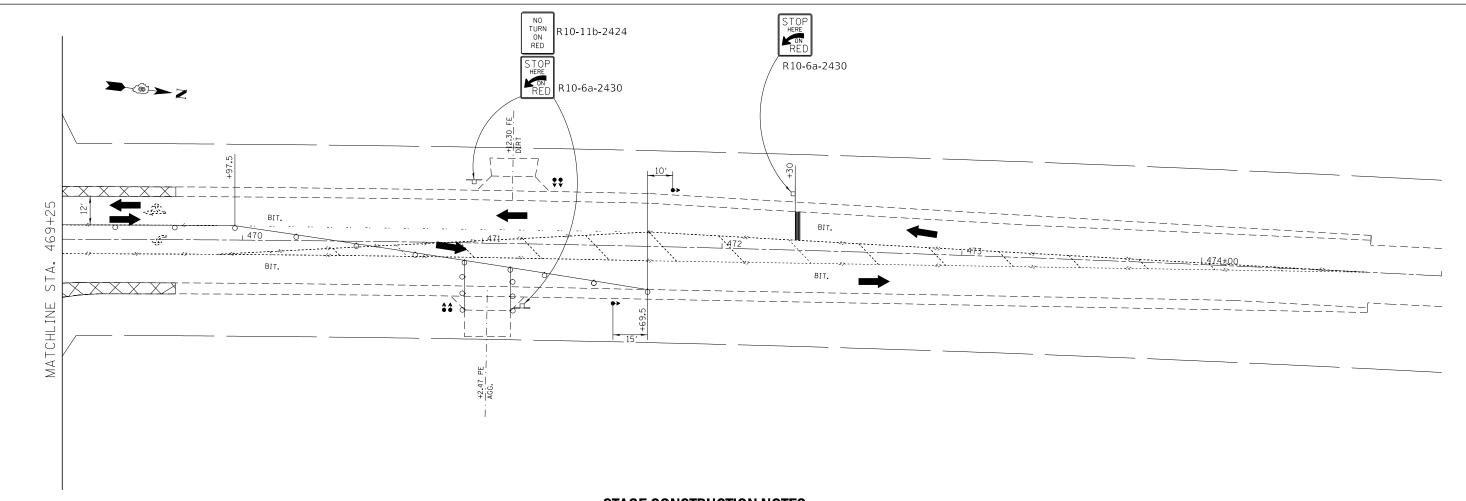
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 PLOT DATE
 = 12/11/2020
 DATE
 REVISED

	SITE MAP	AND		F.A.P RTE	SEC <sup>-</sup>	ПОИ		COUNTY	TOTAL SHEETS	SHEET NO.
	BUTT JOIN	T DETAIL		604	(101,10	02)RS-4		MADISON	40	23
	DOTT JOIN	I DEIAIL						CONTRACT	Γ NO. 76	5М84
SCALE: NONE SHEET 1	OF 1 SHEETS	STA.	TO STA.			ILLINOIS	FED. AI	D PROJECT		





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SCALE: 1"=20"
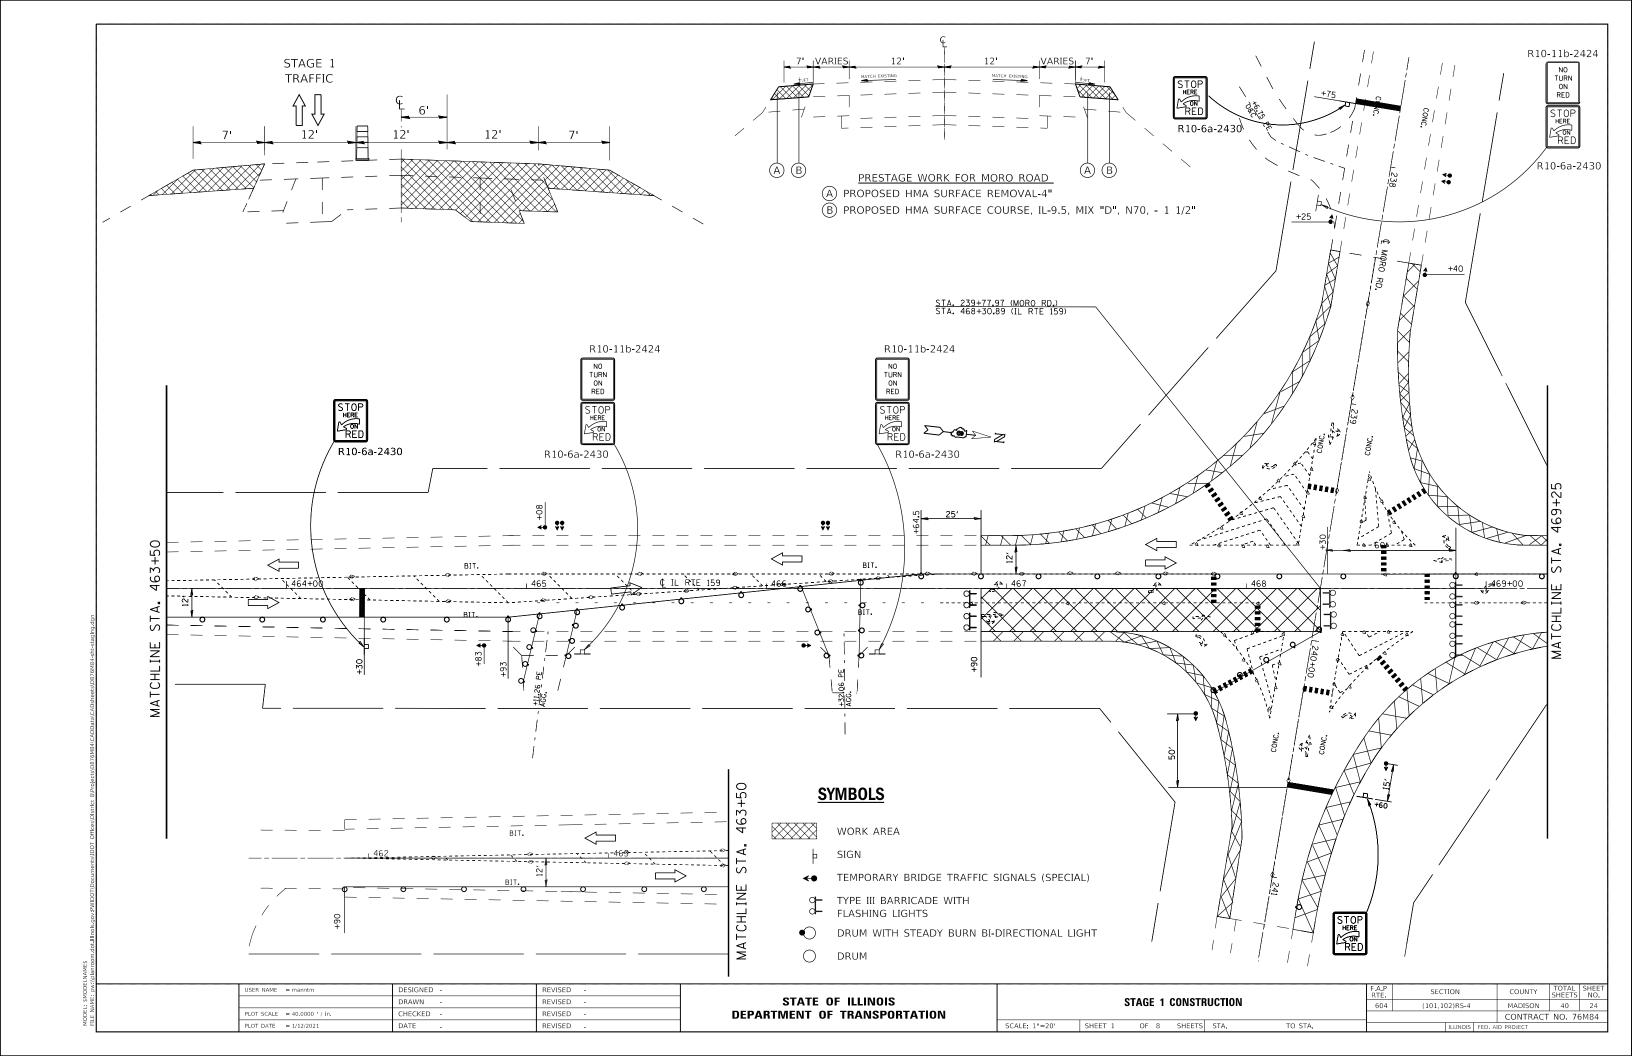
#### USER NAME = challandeske DESIGNED REVISED DRAWN REVISED HECKED REVISED

DATE

REVISED

STATE OF ILLINOIS
STATE OF ILLINOIS
DEPARTMENT OF TRANSPORTATION
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							F.A.P RTE	SECTION	COUNTY	TOTAL SHEETS	
		STAGE	: 1	CONSTR	UCTION		604	(101,102)RS-4	MADISON	40	25
									CONTRACT	NO. 76	5M84
SHEET	2	OF	4	SHEETS	STA.	TO STA.		ILLINOIS FED. A	AID PROJECT		

DRUM

SIGN

**SYMBOLS** 


WORK AREA


TEMPORARY BRIDGE TRAFFIC SIGNALS (SPECIAL)

TYPE III BARRICADE WITH FLASHING LIGHTS

DRUM WITH STEADY BURN BI-DIRECTIONAL LIGHT

PLOT DATE = 12/11/2020

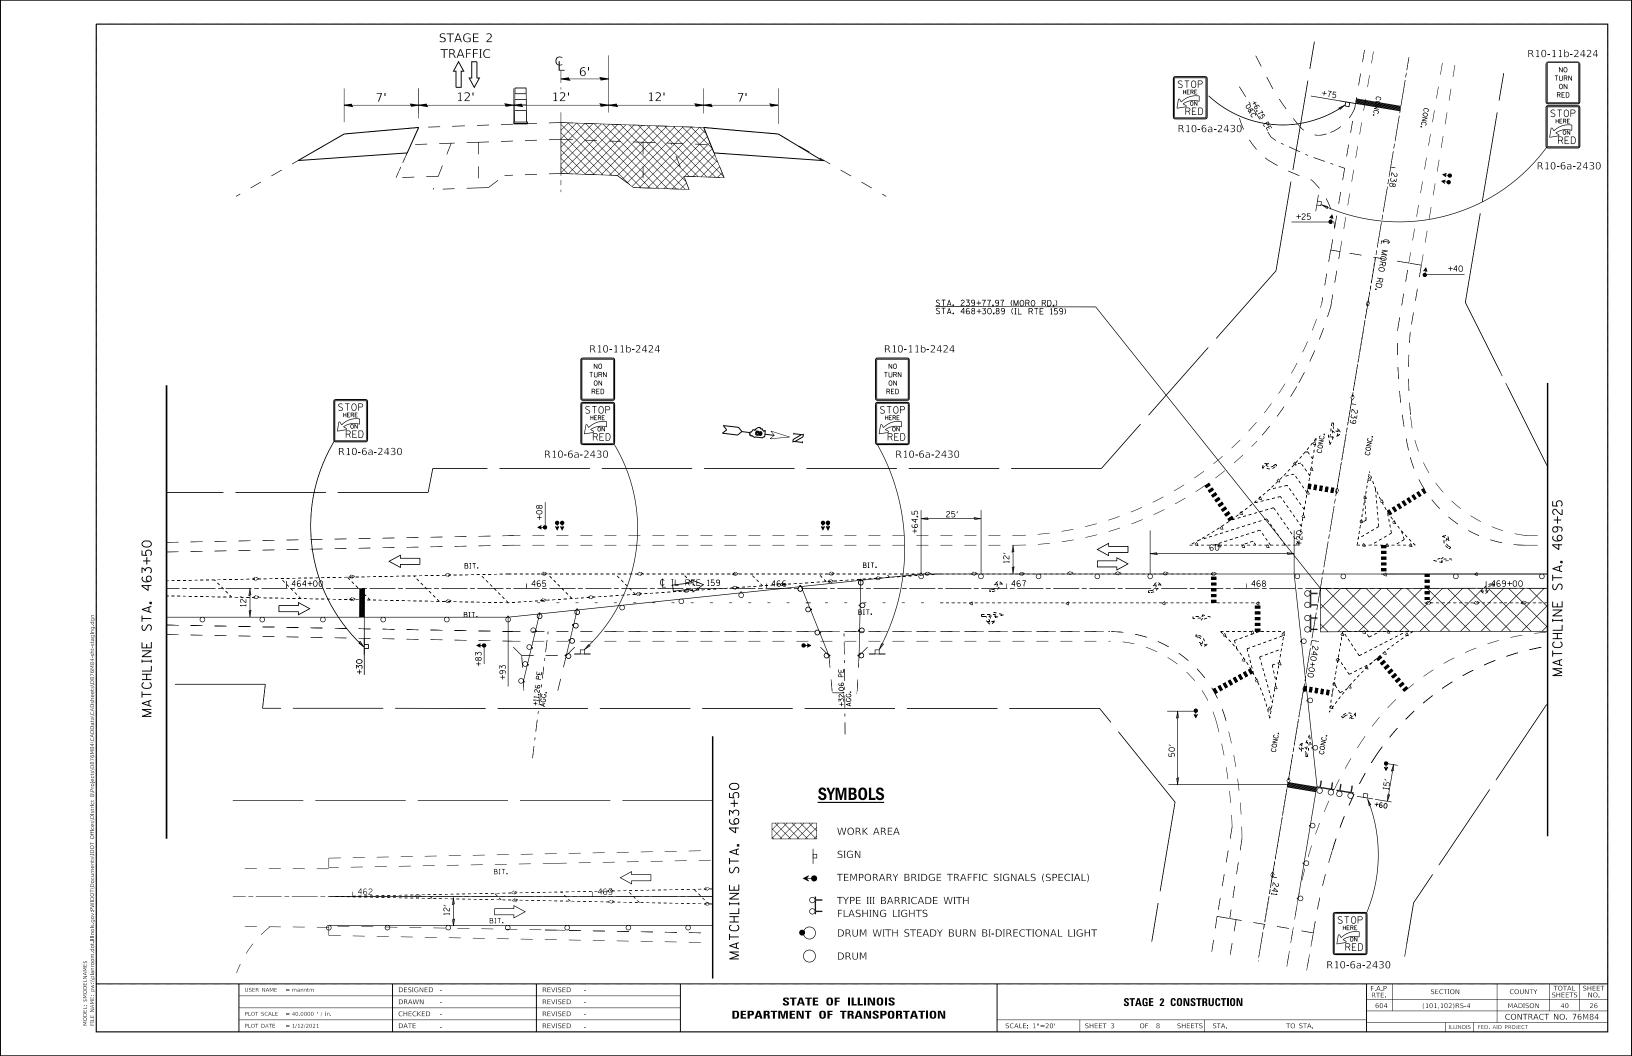

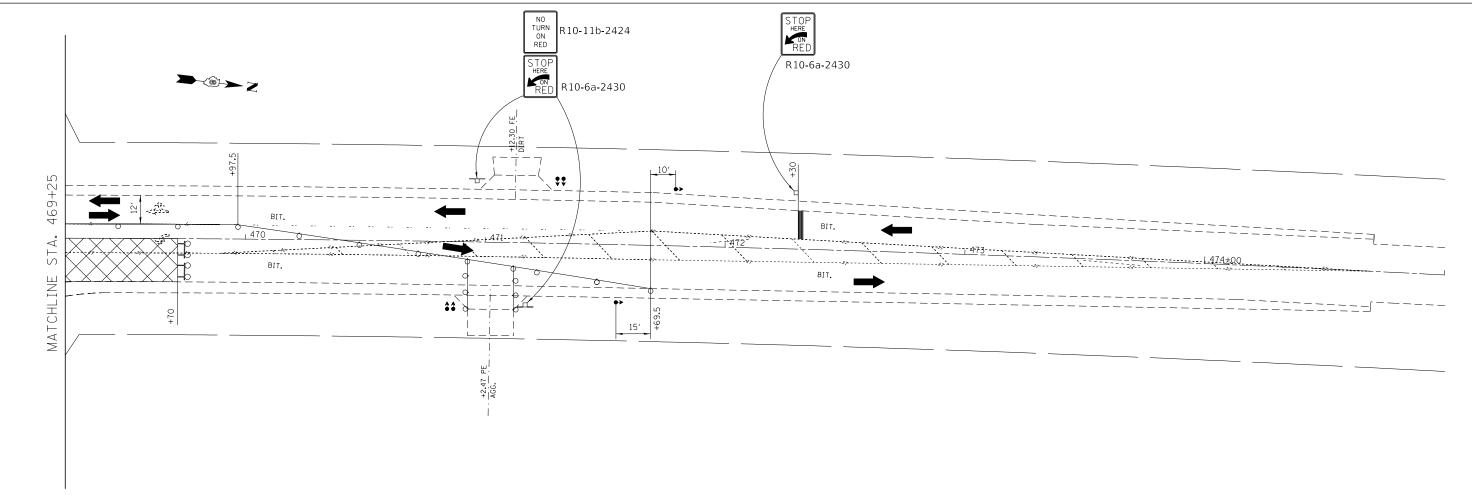

#### **SYMBOLS**



WORK AREA

□ SIGN

TEMPORARY BRIDGE TRAFFIC SIGNALS (SPECIAL)

TYPE III BARRICADE WITH FLASHING LIGHTS

◆ DRUM WITH STEADY BURN BI-DIRECTIONAL LIGHT

O DRUM

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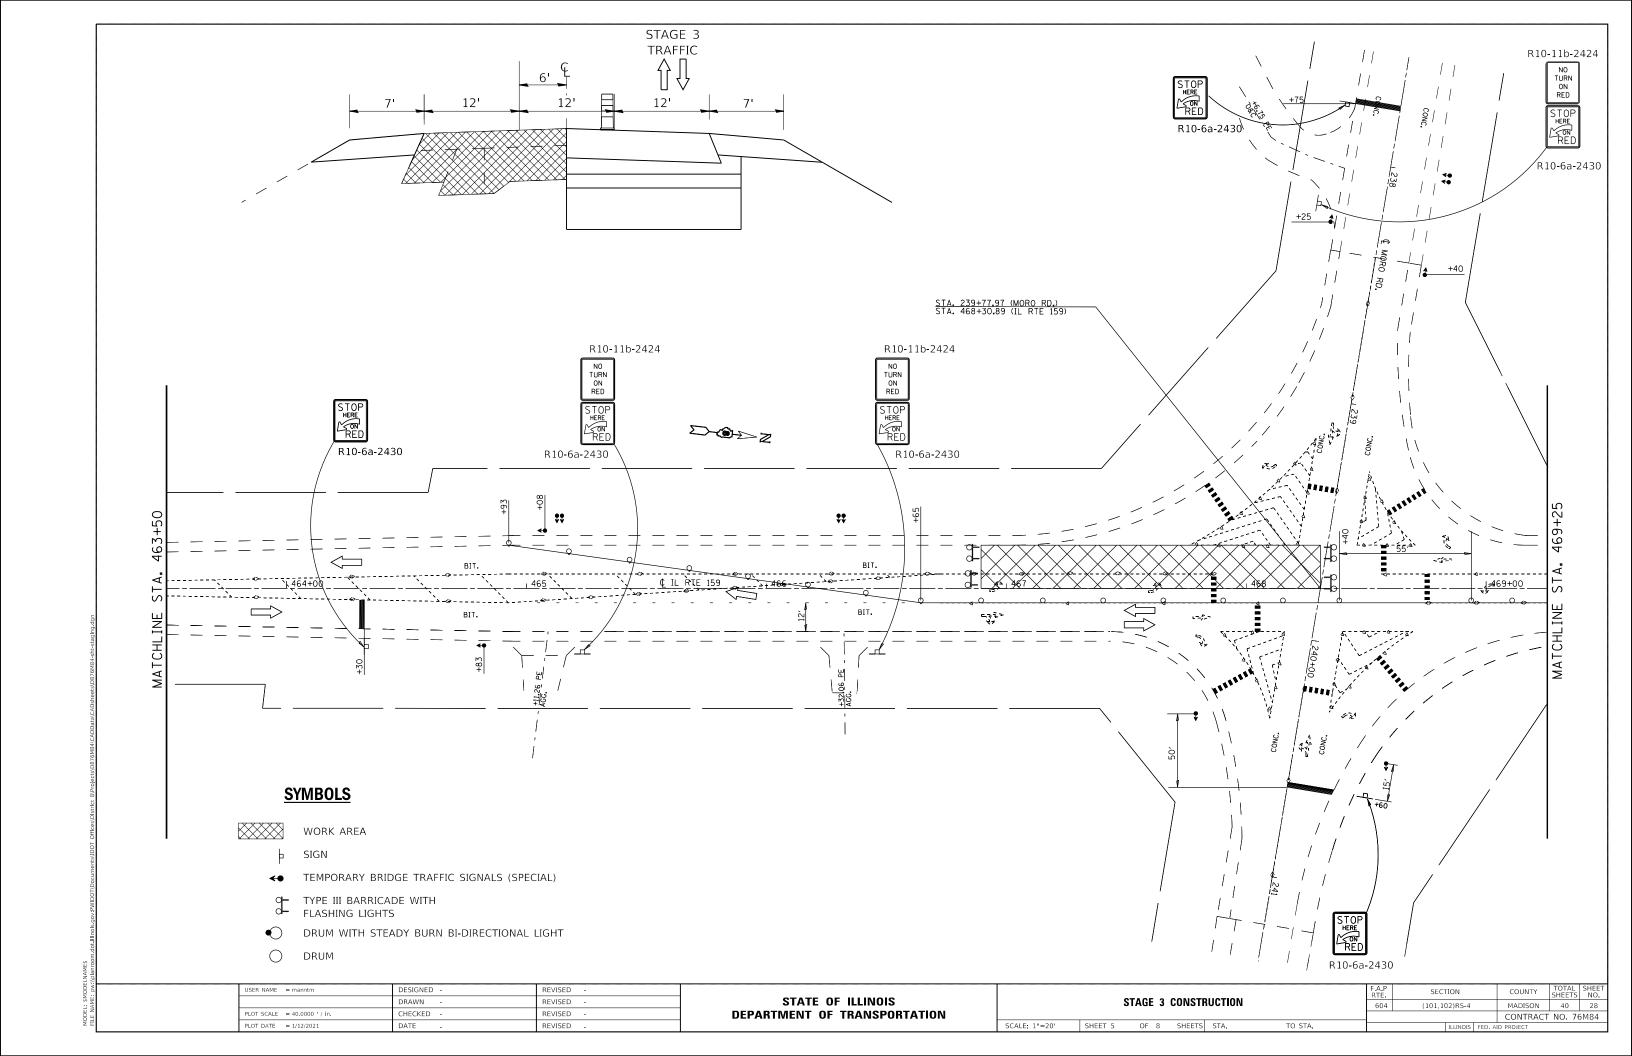
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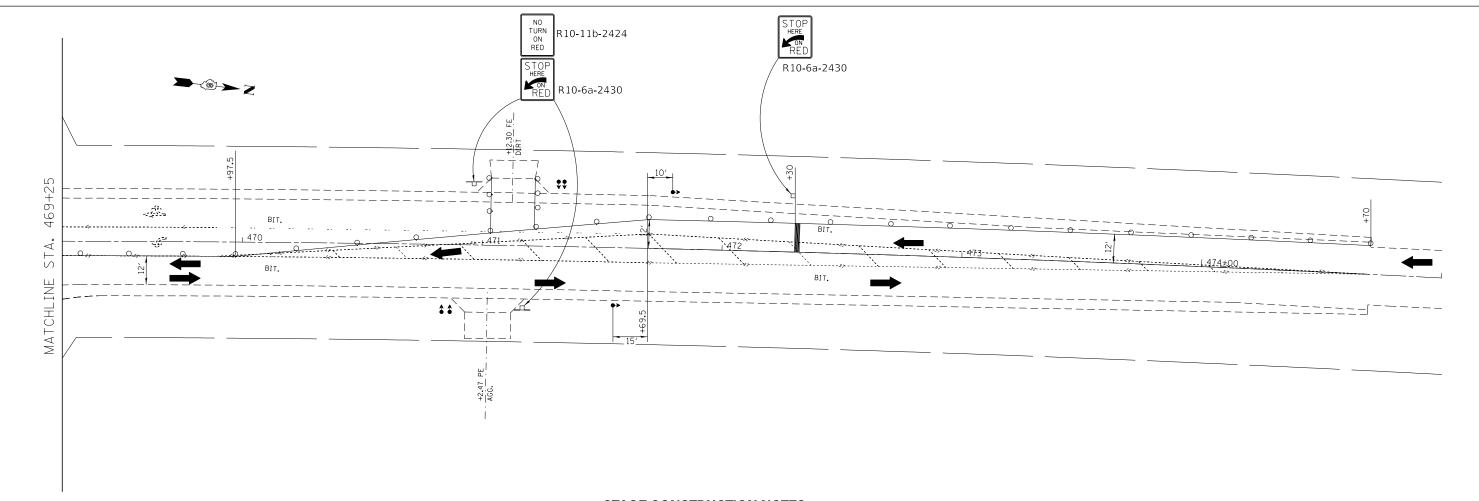
SCALE: 1"=20"

USER NAME = challandeske	DESIGNED -	REVISED -	
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PLOT SCALE = 40.0000 / in.	CHECKED -	REVISED -	
PLOT DATE = 12/11/2020	DATE -	REVISED -	

STATE OF ILLINOIS	
DEPARTMENT OF TRANSPORTATION	

							F.A.P RTE.	SECTION	COUNTY	TOTAL SHEETS	
	STAGE 2 CONSTRUCTION						604	(101,102)RS-4	MADISON	40	27
									CONTRACT	NO. 70	5M84
SHEET	4	OF	8	SHEETS	STA.	TO STA.		ILLINOIS FED	. AID PROJECT		





#### SIGNS TO BE PROVIDED BY IDOT

NO RIGHT TURN NO LEFT TURN

R3-1-2424 (2 EACH)

R3-2-2424 (2 EACH)

#### **SYMBOLS**



WORK AREA

□ SIGN

← TEMPORARY BRIDGE TRAFFIC SIGNALS (SPECIAL)

TYPE III BARRICADE WITH FLASHING LIGHTS

• DRUM WITH STEADY BURN BI-DIRECTIONAL LIGHT

O DRUM

#### **STAGE CONSTRUCTION NOTES**


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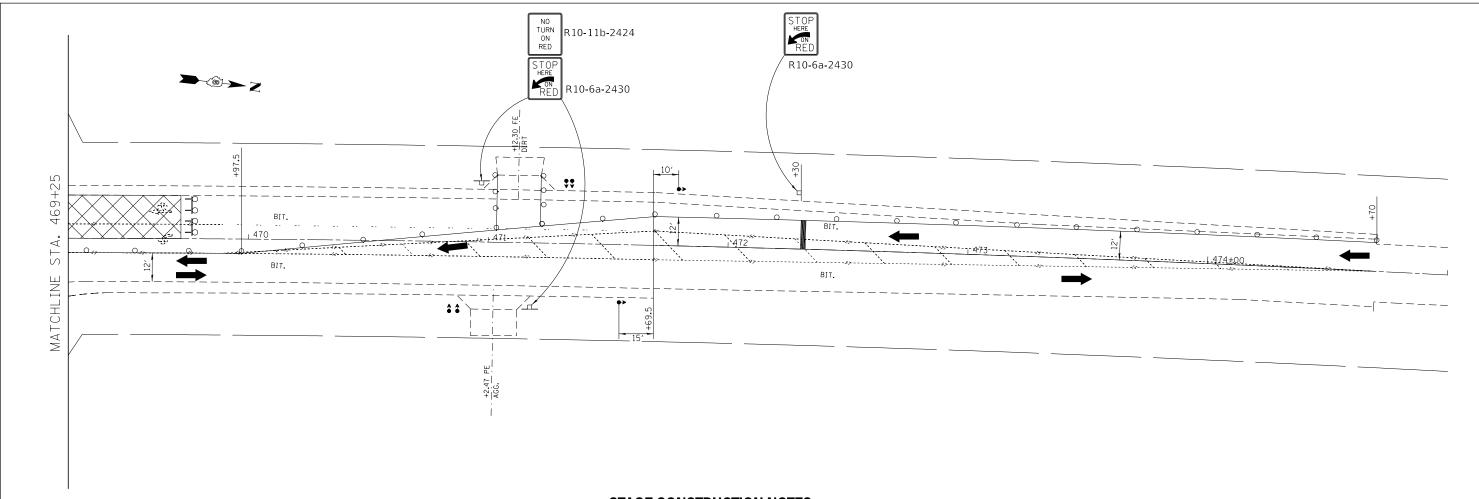
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PLOT SCALE = 40.0000 / in.	CHECKED -	REVISED -	
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DEPARTMENT OF TRANSPORTATION	

OTAGE & CONGERUGATION					F.A.P RTE				COUNTY TOTAL SHEETS				
	STAGE 3 CONSTRUCTION					604	604 (101,102)RS-4		MADISON	40	29		
										CONTRACT	NO. 76	5M84	
	SHEET 6	OF	8	SHEETS	STA.	TO STA.	ILLINOIS FED. AID			D PROJECT	Г		





#### **SYMBOLS**

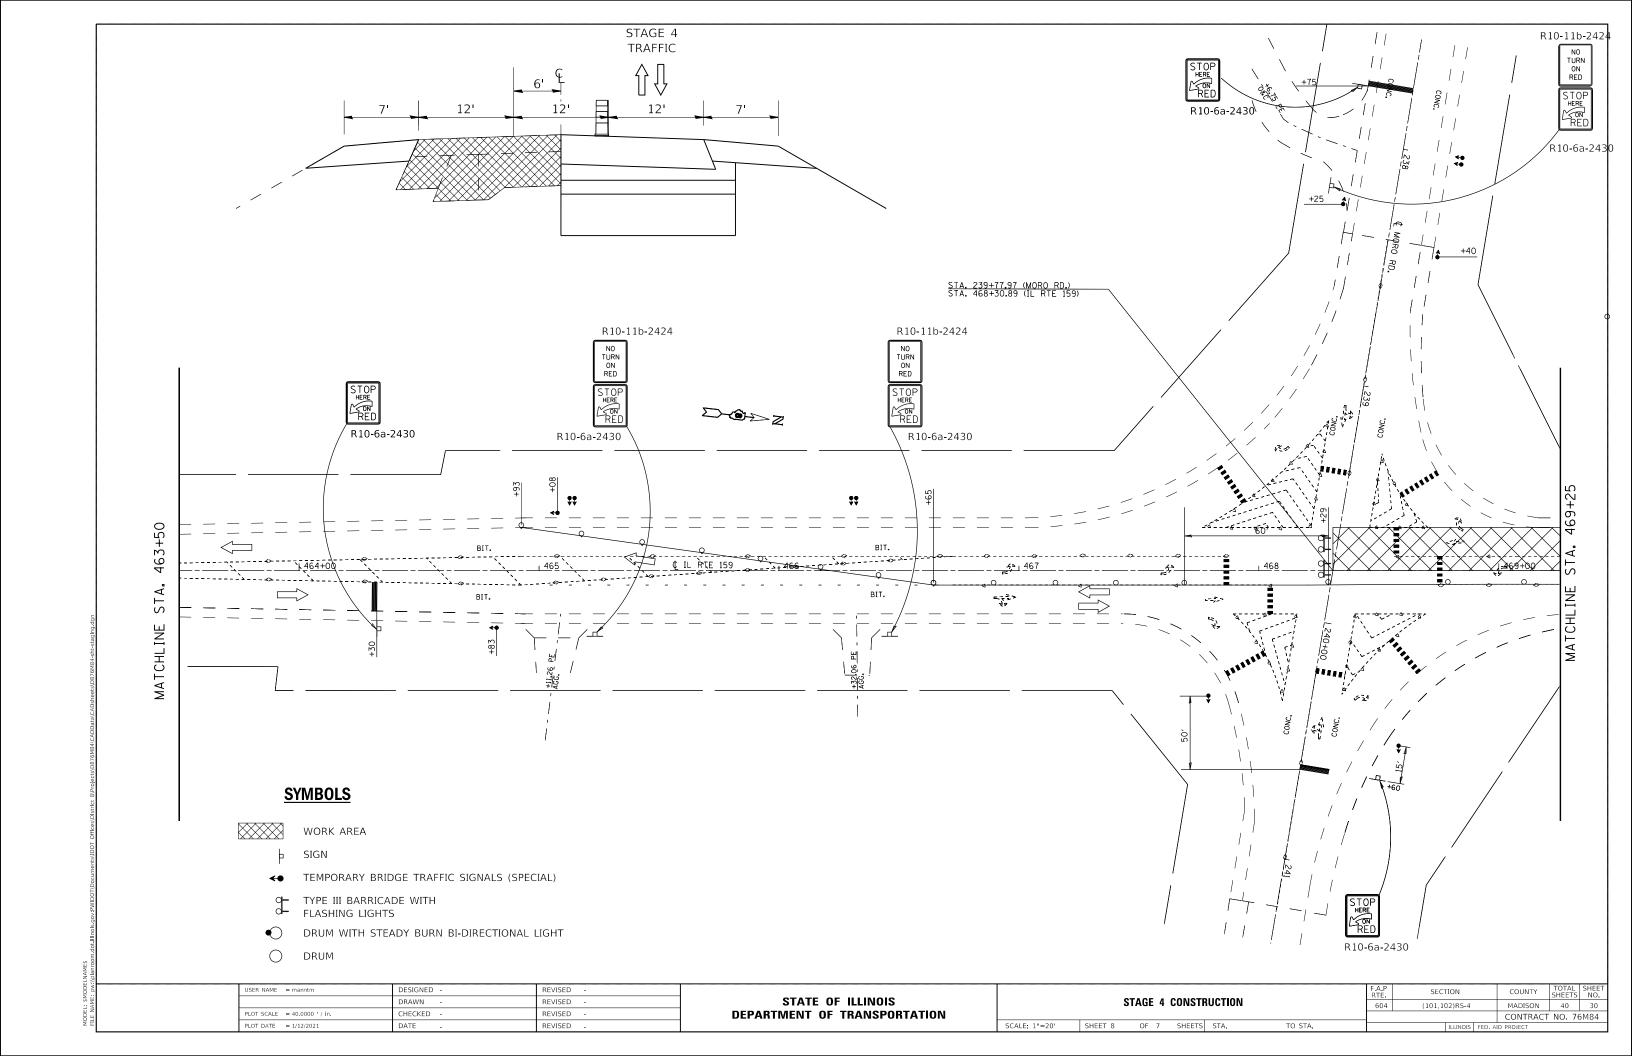

WORK AREA

□ SIGN

TEMPORARY BRIDGE TRAFFIC SIGNALS (SPECIAL)

TYPE III BARRICADE WITH FLASHING LIGHTS

● DRUM WITH STEADY BURN BI-DIRECTIONAL LIGHT

O DRUM

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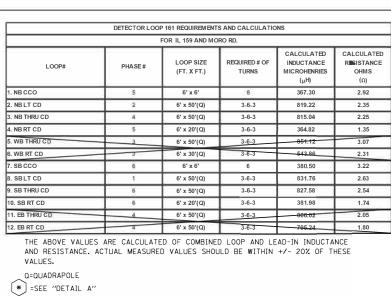
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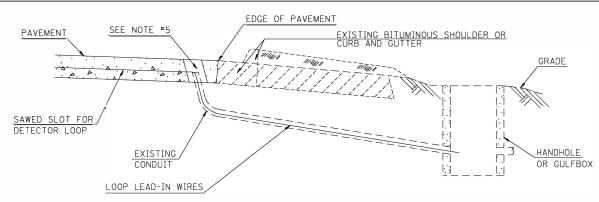
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	DRAWN -	REVISED -	
PLOT SCALE = 40.0000 ' / in.	CHECKED -	REVISED -	
PLOT DATE = 12/11/2020	DATE -	REVISED -	

STATE OF ILLINOIS	
DEPARTMENT OF TRANSPORTATION	

						F.A.P RTE	SECTION	COUNTY	TOTAL SHEETS	
	3	SIAGE	4 CONSTE	IUCTION		604	(101,102)RS-4	MADISON	40	31
								CONTRACT	NO. 76	5M84
SCALE: 1"=20"	SHEET 8	OF 8	SHEETS	STA.	TO STA.		ILLINOIS FED. A	ID PROJECT		



# EXHDHH07 STA. 468+30.89 (IL RTE 159) STA. 239+77<sub>9</sub>97 (MORO RD) EXDHHO 50 EXHDHH03 EXHDHH04 SEE TABLE "DETECTOR LOOP REQUIREMENTS AND CALCULATIONS" FOR LOOP SIZE AND CALCULATED NUMBER OF TURNS. SEE "DETAIL A" FOR INSTALLING DETECTOR LOOP WIRES IN EXISTING CONDUITS. IL 159 SCHEDULE OF QUANTITIES



#### DETAIL A (NO SCALE)

#### INSTALLING DETECTOR LOOP WIRES IN EXISTING CONDUIT

- 1. DRILL OUT PAVEMENT SEALANT AND CLEAN EXISTING CONDUIT.
- 2. REMOVE EXISTING DETECTOR LOOP WIRES TO HANDHOLE OR GULFBOX.
- 3. INSTALL NEW LOOP LEAD-IN WIRES IN EXISTING CONDUIT.
- 4. SPLICE NEW DETECTOR LOOP WIRES TO EXISTING LOOP LEAD-IN CABLE IN HANDHOLE OR GULFBOX.
- 5. FILL HOLE WITH APPROVED SEALER. PREVENT SEALER FROM ENTERING INTO CONDUIT.
- 6. LOCATING UNDERGROUND CABLE WILL BE PAID FOR SEPARATELY.

NOT A PAY ITEM. THE COST OF THIS WORK SHALL BE INCLUDED IN THE PAY ITEM "DETECTOR LOOP REPLACEMENT"


#### DETECTOR LOOP REPLACEMENT LEGEND

☑ EX. HANDHOLE

EX. DETECTOR LOOP 🖂 EX. TRAFFIC SIGNAL CONTROLLER

EXISTING CONDUIT PROPOSED DETECTOR LOOP

				QUANTITIES		
-	CODE NO	ITEM	UNIT	QUANTITIES	MORO RD.	
	80300100	LOCATING UNDERGROUND CABLE	FOOT	50	5	
	88600680	DETECTOR LOOP REPLACEMENT	FOOT	944	94	

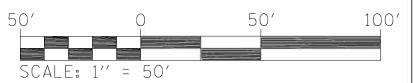

USER NAME = prestonme DESIGNED REVISED DRAWN REVISED CHECKED REVISED PLOT SCALE = 40.0000 ' / in. PLOT DATE = 10/26/2020 DATE REVISED

STATE OF ILLINOIS

+50

469

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MATCHLINE

SCALE: 1"=50'


		RD./IL			F.A.I RTE
DETECTO			CEMEN	I PLAN	60
	1	OF 2			
CHEET 1	05 3	CHEETC	CTA	TO CTA	


COUNTY TOTAL SHEET NO.

MADISON 40 32 SECTION (101,102)RS-4 CONTRACT NO. 76M84


NOTES:

**DEPARTMENT OF TRANSPORTATION** 

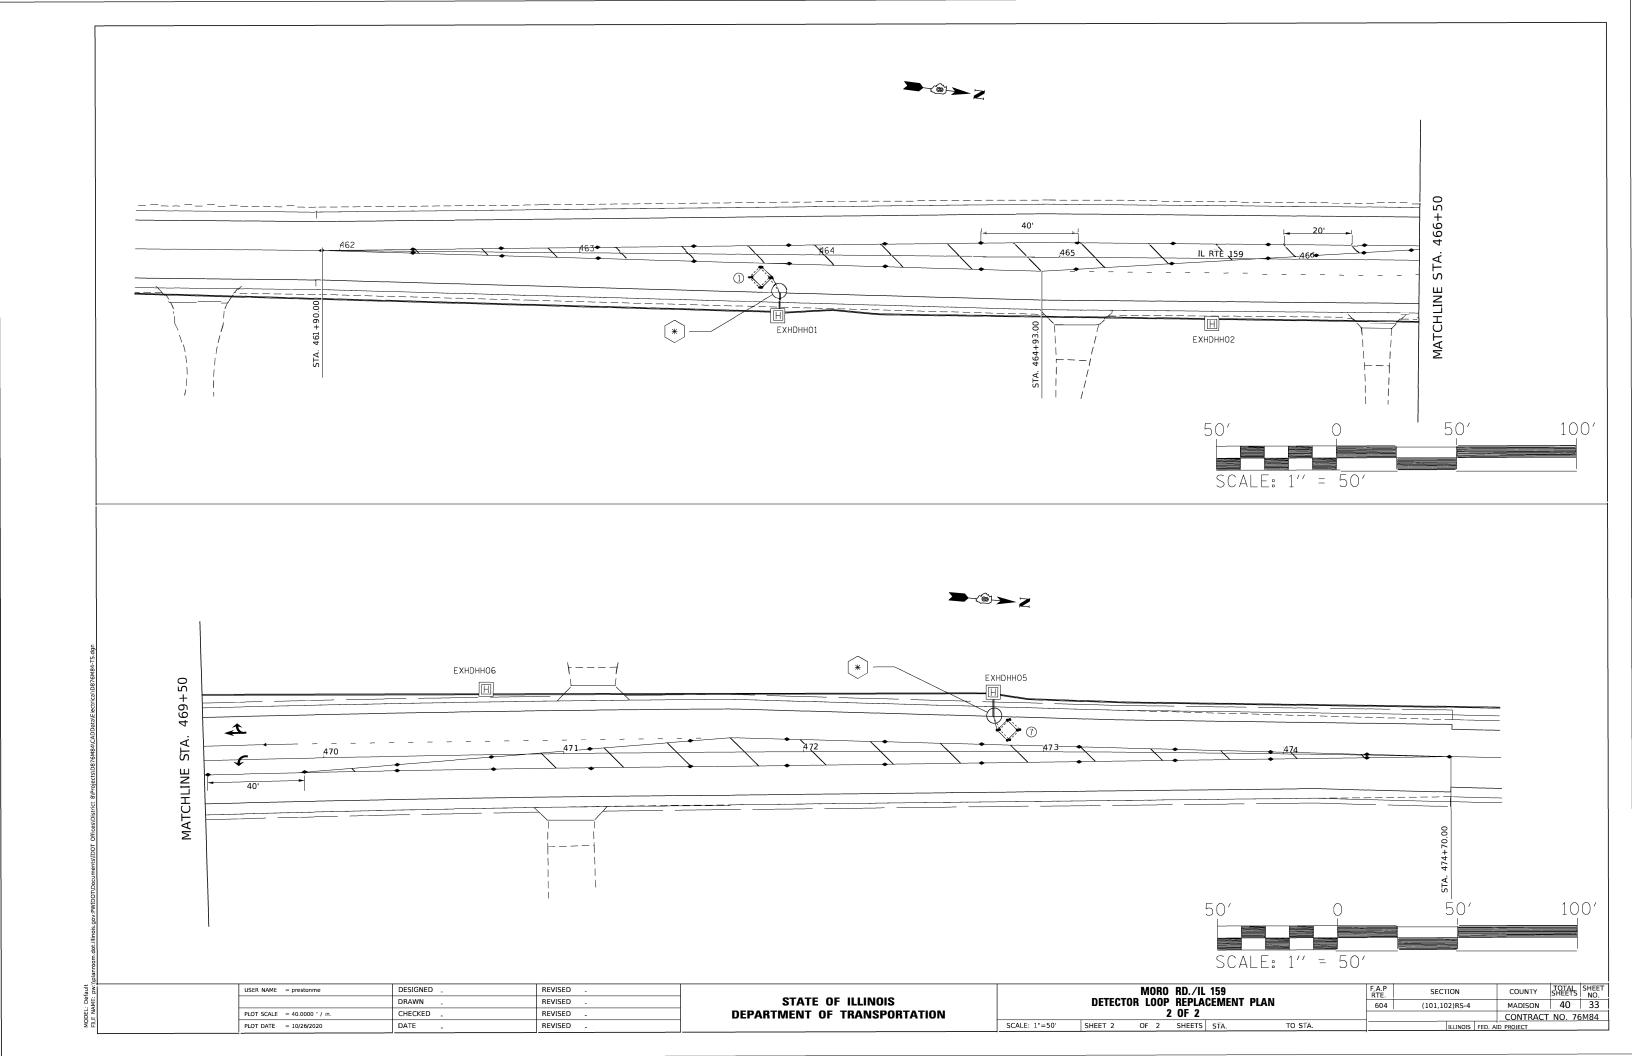


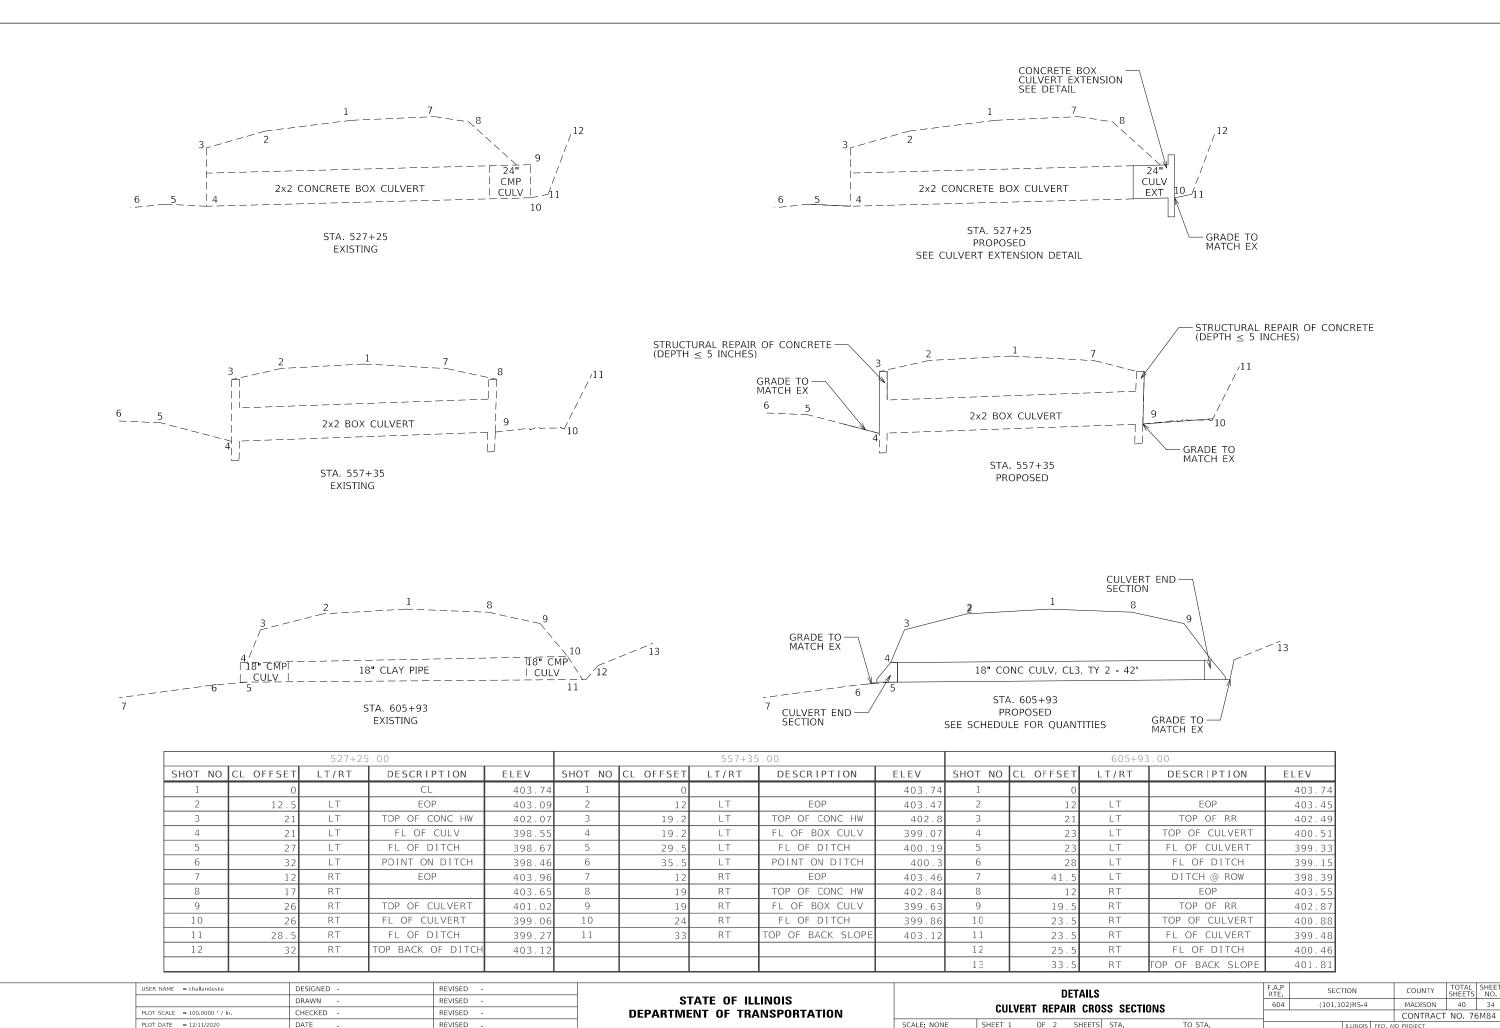

MODEL: Default

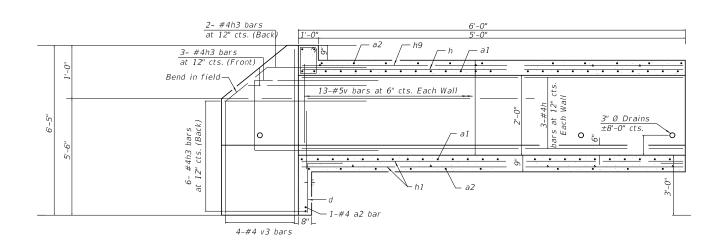


#### LONGITUDINAL SECTION (LOOKING SOUTH)

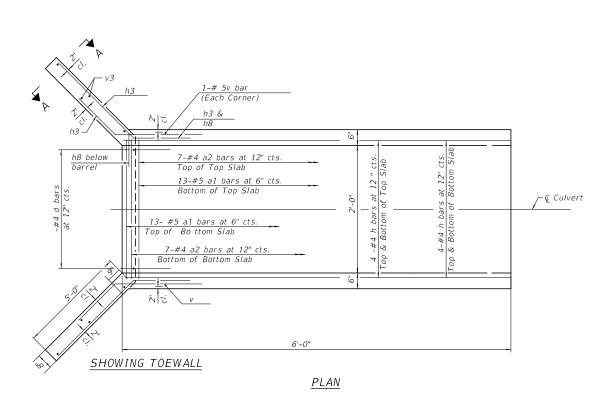


The barrel shall be poured monolithically with the wingwalls. Bars indicated thus 12 x 4-#5 etc. indicates 12 lines of bars with 4 lengths per line.



So Cal Kuyug

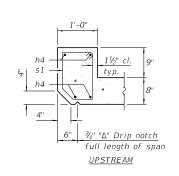

#### SECTION THRU HEADWALL

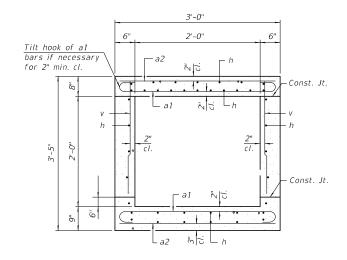

SECTION THRU BARREL

BILL OF MATERIAL


#4 4'-5"

#4 8'-0" #6

#4

Concrete Box Culverts Cu. Yd. 6.8


h3 22 h4 4

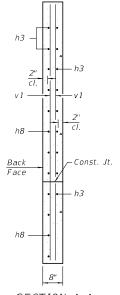


SECTION	A-A

BAR a1

BAR d

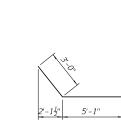

BARS h3

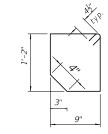

BAR s1




01/14/2021

8-23-2020

USER NAME = challandeske	DESIGNED -	REVISED -
	DRAWN -	REVISED -
PLOT SCALE = 100.0000 / in.	CHECKED -	REVISED -
PLOT DATE = 12/11/2020	DATE -	REVISED -

DETAILS	F.A.P RTE	SECT	ION		COUNTY	TOTAL SHEETS	SHEET NO.
BOX CUVERT EXTENSION	604	(101,10	)2)RS-4		MADISON	40	35
DOX GOVERN EXTENSION					CONTRACT	NO. 76	5M84
SCALE: NONE SHEET 2 OF 2 SHEETS STA. TO STA.			ILLINOIS	FED. AI	D PROJECT		

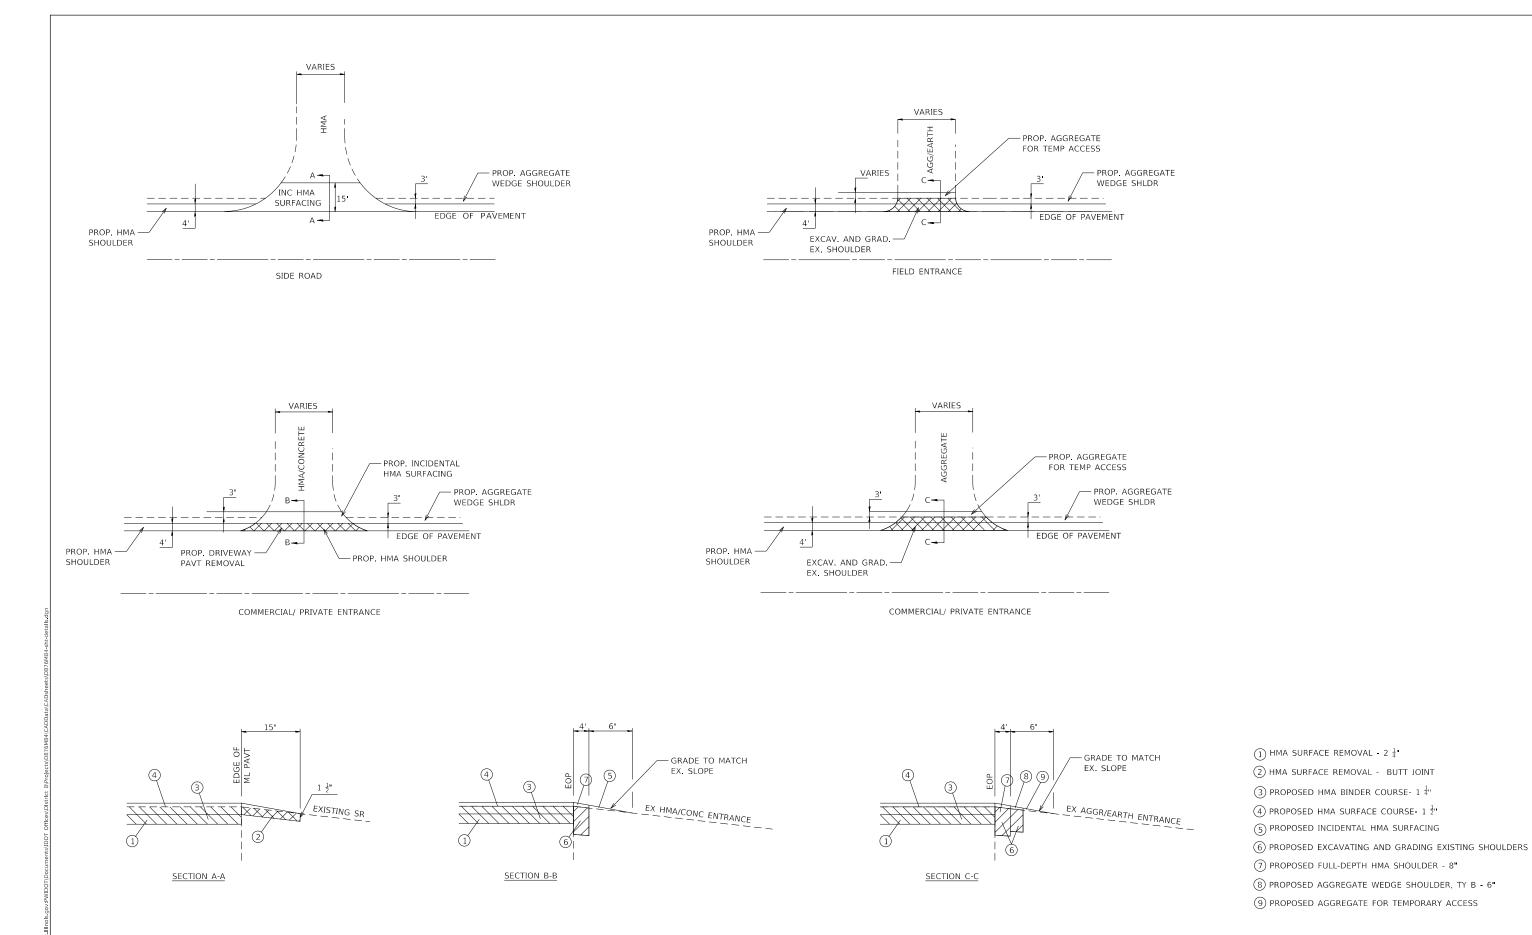

USER NAME = challandeske DESIGNED -REVISED SECTION DETAILS STATE OF ILLINOIS DRAWN REVISED 604 (101,102)RS-4 MADISON 40 36 **ENTRANCE AND SIDE ROAD** PLOT SCALE = 100.0000 ' / in. CHECKED REVISED **DEPARTMENT OF TRANSPORTATION** CONTRACT NO. 76M84 PLOT DATE = 12/11/2020 REVISED SCALE: NONE SHEET 1 OF 2 SHEETS STA. TO STA. DATE

PROPOSED AGGREGATE — SHOULDER - PROPOSED AGGREGATE SHOULDER PROPOSED HMA SHOULDER-STA. 239+77.97 (MORO RD.) STA. 464+30.89 (IL RTE 159) - PROPOSED PORTLAND CEMENT CONCRETE PAVEMENT- 91/4" - PROPOSED HMA SHOULDER-8 - PROPOSED AGGREGATE SHOULDER <del>गेंगामं</del> ड्रॅ -- PROPOSED HMA SHOULDER- 2¾" PROPOSED HMA SHOULDER- 23/4"-PROPOSED HMA RESURFACING- 23/4" PROPOSED HMA RESURFACING- 23/4" MAT( PROPOSED AGGREGATE -SHOULDER PROPOSED HMA SHOULDER-8' /////// PROPOSED HMA SHOULDER-8" PE AGGR PROPOSED HMA SHOULDER- 23/4" PROPOSED HMA SHOULDER- 23/4" - PROPOSED AGGREGATE SHOULDER PROPOSED AGGREGATE SHOULDER NOTES: 1. PROPOSED CONCRETE PAVEMENT-9/4"
-PAVEMENT REMOVAL- 18"
-EARTH EXCAVATION-12"
-PORTLAND CEMENT CONCRETE PAVEMENT- 9<sup>1</sup>/<sub>4</sub>"
-STABILIZED SUBBASE- 4"
-SUBBASE GRANULAR MATERIAL TYPE B- 4<sup>3</sup>/<sub>4</sub>"
-AGGREGATE SUBGRADE IMPROVEMENT- 12" - PROPOSED HMA SHOULDER PROPOSED HMA SHOULDER-PROPOSED AGGREGATE SHOULDER 2. PROPOSED HMA RESURFACING-2¾"
-HMA SURFACE REMOVAL- 2¼"
-HMA BINDER COURSE, IL-9.5FG, N7O- 1¼"
-HMA SURFACE COURSE, IL-9.5, MIX "D", N7O- 1½" 3. PROPOSED INCIDENTAL HMA RESURFACING- 11/2"
-HMA SURFACE REMOVAL- 1"
-INCIDENTAL HMA RESURFACING- 11/2" 4. SEE PAVEMENT MARKING DETAIL FOR PAVEMENT MARKING. PAVEMENT REMOVAL PAVED SHOULDER REMOVAL HMA SURFACE REMOVAL - 1" DESIGNED -REVISED USER NAME = challandeske PAVEMENT RECONSTRUCTION AND STATE OF ILLINOIS DRAWN REVISED 40 37 604 (101,102)RS-4 MADISON SPECIAL MILLING DETAIL

**DEPARTMENT OF TRANSPORTATION** 

SCALE: 1"=50

SHEET 2 OF 2 SHEETS STA.


CONTRACT NO. 76M84

PLOT SCALE = 40.0000 ' / in.

CHECKED

REVISED

REVISED

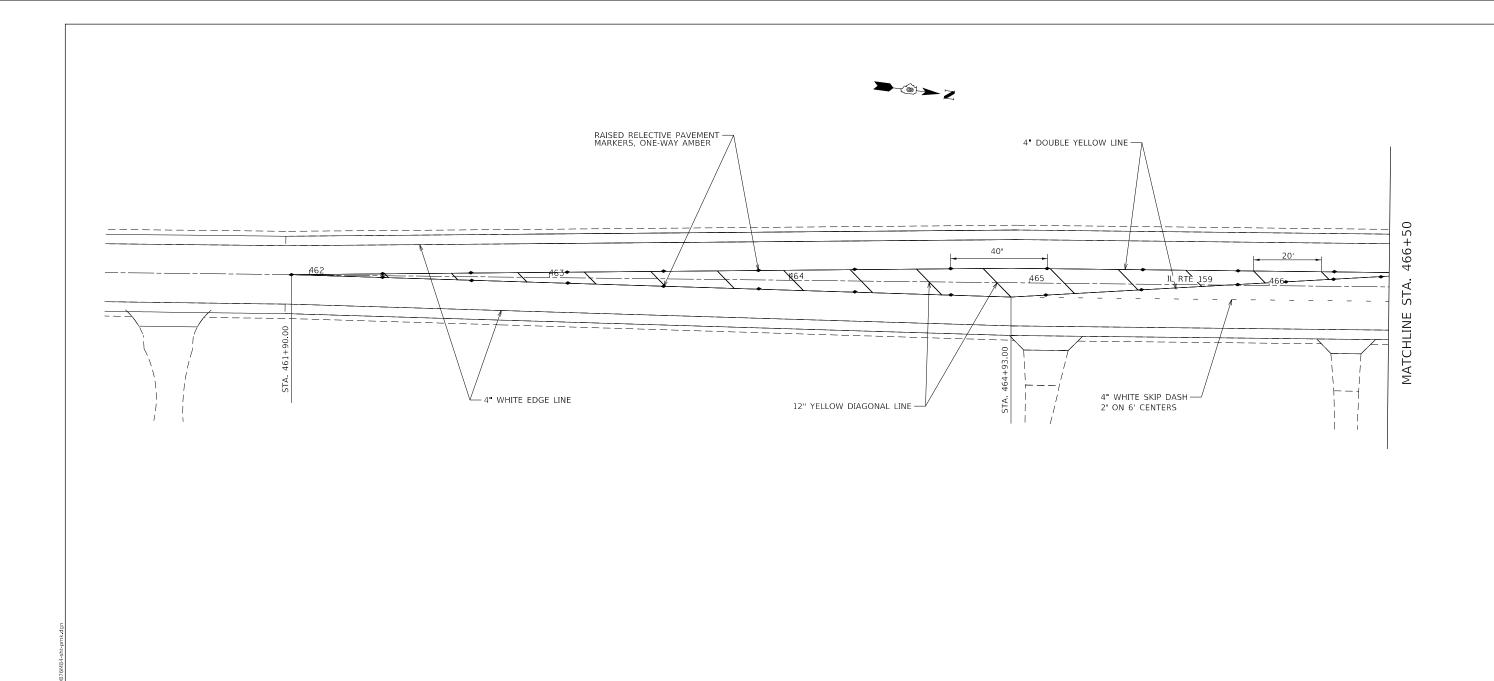


USER NAME = challandeske DESIGNED -REVISED -DRAWN REVISED -PLOT SCALE = 40.0000 ' / in. CHECKED -REVISED PLOT DATE = 12/11/2020 DATE REVISED

STATE OF ILLINOIS **DEPARTMENT OF TRANSPORTATION** 

**DETAILS** MORO RD/IL 159 PAVEMENT MARKING SCALE: 1"=50" SHEET 1 OF 3 SHEETS STA.

F.A.P RTE. COUNTY TOTAL SHEET NO.

MADISON 40 38 SECTION (101,102)RS-4 CONTRACT NO. 76M84

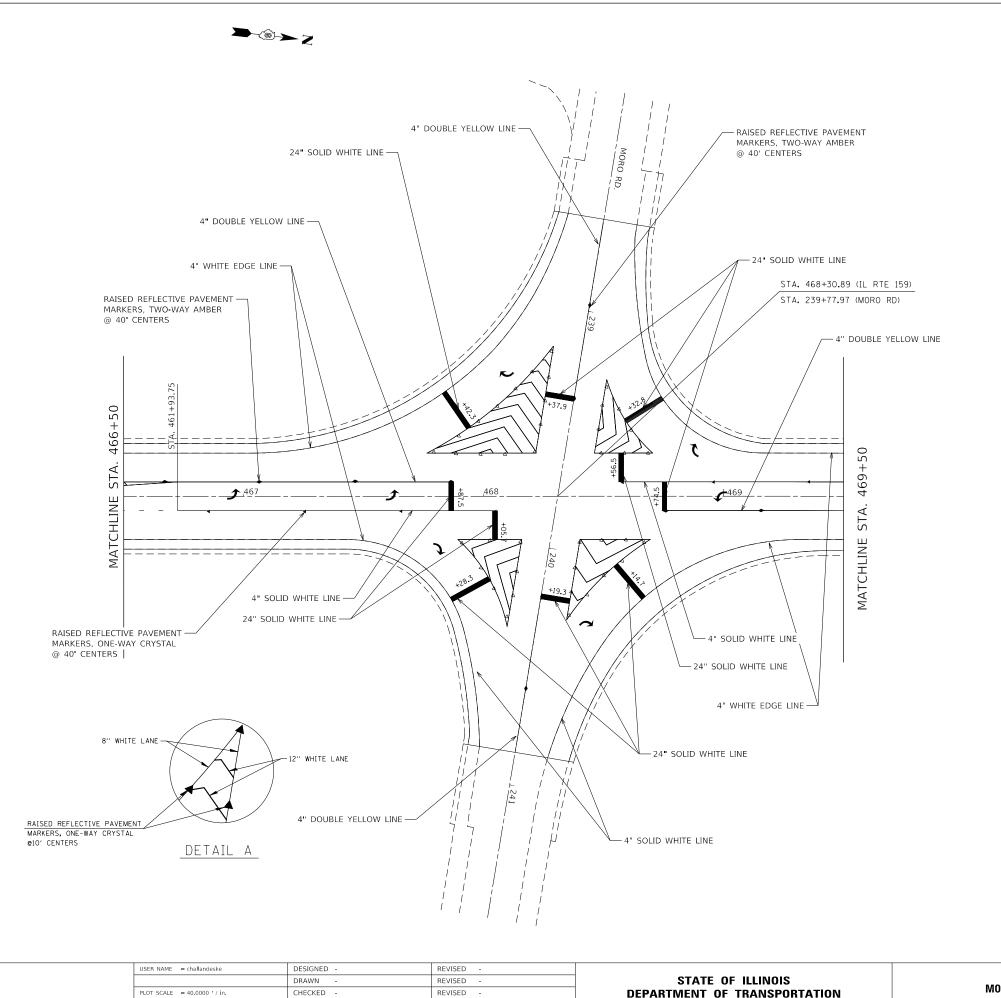


REVISED

PLOT DATE = 12/11/2020

DATE

**DEPARTMENT OF TRANSPORTATION** SCALE: 1"=50"

SECTION COUNTY DETAILS 604 (101,102)RS-4 MADISON 40 39 MORO RD/IL 159 PAVEMENT MARKING CONTRACT NO. 76M84 SHEET 2 OF 3 SHEETS STA.

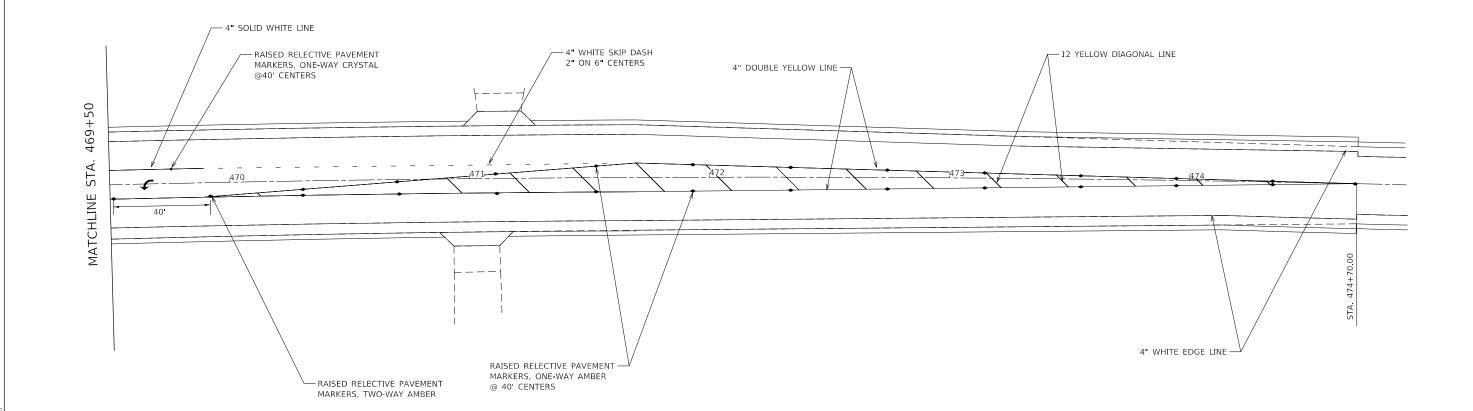

USER NAME = challandeske	DESIGNED -	REVISED -
	DRAWN -	REVISED -
PLOT SCALE = 40.0000 ' / in.	CHECKED -	REVISED -
PLOT DATE = 12/11/2020	DATE -	REVISED -
1201 01112 22/12/2020	B/TIE -	1101300 -

STATE OF ILLINOIS								
DEPARTMENT OF	TRANSPORTATION							

SCALE: 1"=50'

							F.A.P RTE	SECTION			COUNTY	TOTAL SHEETS	SHEE NO.	
MORO RD/L 159 PAVEMENT MARKING					604	(101,102)RS-4		MADISON	40	40				
WONG HERE 133 I AVENERY WANKING						CONTRACT NO. 7						5M84		
ı	SHEET	3	OF	3	SHEETS	STA.	TO STA.	ILLINOIS FED A			FED. AI	ID PROJECT		